

And the second s



A. FUTURE DEVELOPMENT ON THE VACANT PORTION OF THIS LOT SHALL ADHERE TO

THE SAME DESIGN CONCEPTS SET FORTH IN THIS SUBMITTAL B. ALL SUBDIVIDED LOTS IN THIS SUBMITTAL SHALL NOT EXCEED 0.35 F.A.R. MAX.

C. MAXIMUM BUILDING HEIGHT AND SETBACKS PER SU2 FOR M-1 ZONE, ALAMEDA DESIGN OVERLAY, AND NORTH 1-25 SECTOR PLAN. THE MAX. HEIGHT FOR THIS BUILDING IS 27'-0".

KEYED NOTES O

PROPOSED PROPERTY LINE THROUGH EXISTING LOT 30-A
 LANDSCAPED AREA

3. AUTOMOBILE DISPLAY AREA

4. NEW 6'-O" WIDE CONCRETE SIDEMALK

5. NOT USED 6. MONUMENT SIGN, 48 SF SURFACE AREA MAX.

7. ASPHALT PAVING

8. TRASH ENCLOSURE PER COA STANDARDS. 9. EXISTING CONCRETE SIDEMALK TO REMAIN

10. EXISTING CONCRETE CURB TO REMAIN 11. UNUSED PORTION OF PROPERTY NOT BEING DEVELOPED UNDER

THIS CONTRACT

12. REMOVE EXISTING CONCRETE CURB AND SIDEWALK

13. REMOVE EXISTING ASPHALT CURB 14. PROPOSED DECEL LANE FOR WEST BOUND TRAFFIC

15. NEW CONCRETE CURB

16. 6' MIDE CONCRETE WALKWAY

17. EXISTING STUCCO WALL 18. EXISTING FIRE HYDRANT

19. EXISTING UTILITY POLE 20. CONCRETE WHEEL STOPTY?

21. LIGHT POLE TYP.; 4" ALUMINUM POLE, 20'-0" HIGH MAX. 22. CONCRETE RETAINING WALL, NOT TO EXCEED 3'-0" IN HEIGHT TYP.

23. RAISED PEDESTRIAN WALKWAY 24. BIKE RACK

25. EXISTING CONCRETE SIDEMALK RAMP.

26. 6'-O" LANDSCAPE SETBACK

27. 10'-0" BUILDING SETBACK 28. NEW CONCRETE SIDEWALK RAMP, SLOPE 1:12 MIN.

29. NEW FIRE HYDRANT. 30. ACCESSIBLE PARKING SIGN

31. 10'-0" PUBLIC UTILITY EASEMENT

32. CONCRETE PATIO

33. WATER DETENTION POND AREA

34. DRIVEWAY ACCESS EASEMENT
35. PUBLIC WATER + SANTORY SEVER EASEMENT

SITE INFORMATION

LEGAL DESCRIPTION: LOT 30-A, BLOCK 11, TRACT A, UNIT B, NORTH ALBUQUERQUE ACRES, CITY OF ALBUQUERQUE, BERNALILLO COUNTY, NM

ZONE: SU2 FOR M-1

GROSS BUILDING SQUARE FOOTAGE: 1,965 SF

TOAL SITE AREA:36,533 SF / 0.84 ACRES

F.A.R.: 0.053

BUILDING USE: CAR DEALERSHIP INCLUDING

ADMINISTRATIVE OFFICE SPACE AFD Plans Checking Office 924-3611 HYDRANTS ONLY
Hydrants shall be installed prior to construction

R. C. Sange 9-9-04 Signature & Date

PROJECT NUMBER:

1003372 04-01234 APPLICATION NUMBER:

Is an Infrastructure List required? (X) Yes () No If yes, then a set of approved DRC plans with a work order is required for any construction within Public Right-of-Way or for construction of public improvements.

DRB SITE DEVELOPMENT PLAN SIGNOFF APPROVAL: 11.3-04 TRAFFICENGINEERING, TRAIGPORTATION DIVISION DATE UTILITIES DEVÉLOPMENT 11/3/04 PARKS AND RECREATION DEPARTMENT DATE 11/3/04 DATE

* ENVIRONMENTAL HEALTH DEPARTMENT (CONDITIONAL)

Michael Holton 9-9-04 SOLID WASTE MANAGEMENT

DATE

DATE

* Environmental Health, If necessary

1" = 20'-0"

SCALE: 1" = 20'-0"

CĠ

09/10/04

04042

DRAWN BY

DATE

REVIEWED BY

PROJECT NO.

DRAWING NAME

SITE PLAN FOR

SUBDIVISION

architecture

interiors

planning

6801 Jefferson

505 761-9700

fax 761-4222

Albuquerque, NM 🔀

dps@dpsabq.com 🕽


لىر vard ir

Boulev w Mexi


Alameda erque, Nev

Suite 100

PLANT LEGEND

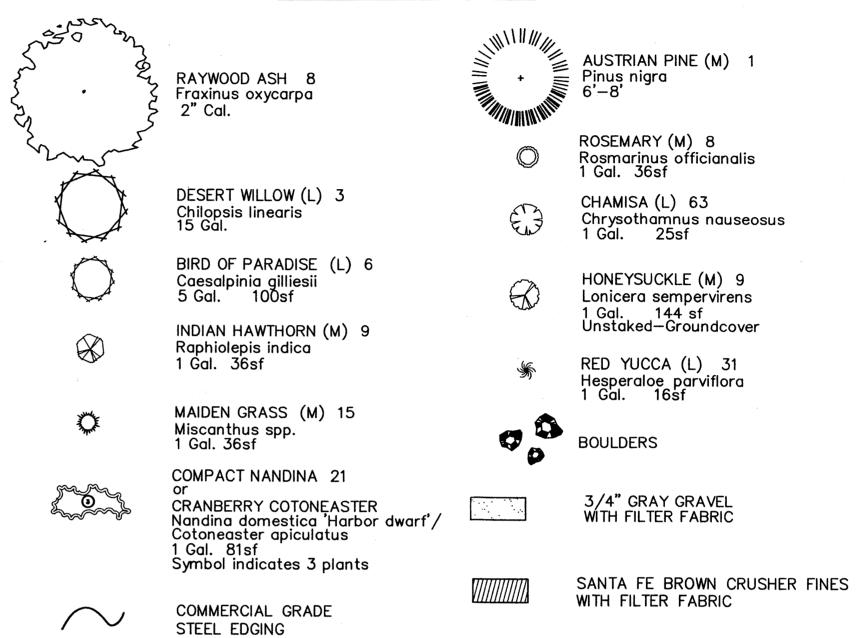

GRAVEL ACCENT DETAIL

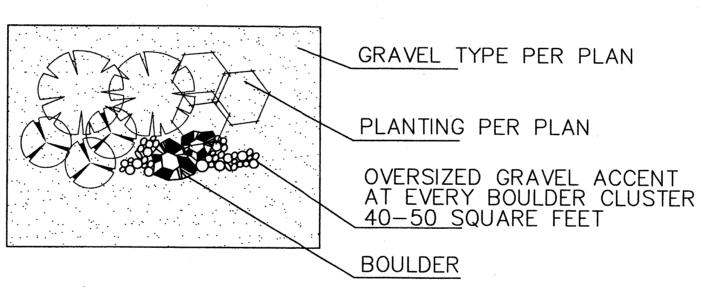

LANDSCAPE NOTES:

Landscape maintenance shall be the responsibility of the Property Owner.

It is the intent of this plan to comply with the City Of Albuquerque Water Conservation Landscaping and Water Waste Ordinance planting restriction approach.

Approval of this plan does not constitute or imply exemption from water waste provisions of the Water Conservation Landscaping and Water Waste Ordinance. Water management is the sole responsibility of the Property Owner.

All landscaping will be in conformance with the City of Albuquerque Zoning Code, Street Tree Ordinance, Pollen Ordinance, and Water Conservation Landscaping and Water Waste Ordinance. In general, water conservative, environmentally sound landscape principles will be followed in design and installation.

Plant beds shall achieve 75% live ground cover at maturity.

3/4" Gray Gravel over Filter Fabric shall be placed in all landscape areas which are not designated to receive native seed.

IRRIGATION NOTES:

Irrigation shall be a complete underground system with Trees to receive (5) 1.0 GPH Drip Emitters and Shrubs to receive (2) 1.0 GPH Drip Emitters. Drip and Bubbler systems to be tied to 1/2" polypipe with flush caps at each end.

Run time per each drip valve will be approximately 15 minutes per day, to be adjusted according to the season.

Point of connection for irrigation system is unknown at current time and will be coordinated in the field.

Irrigation will be operated by automatic controller. Location of controller to be field determined and power source for controller to be provided by others.

Irrigation maintenance shall be the responsibility of the Property Owner.

STREET TREE REQUIREMENTS


Street trees required under the City Of Albuquerque Street Tree Ordinance are as follows:

Name of Alameda Blvd. Required 7 Provided 7

FINAL LANDSCAPING LAYOUT AND DESIGN TO BE DETERMINED UPON RECEIPT OF FINAL GRADING PLAN.

LANDSCAPE CALCULATIONS

TOTAL LOT AREA TOTAL BUILDINGS AREA OFFSITE AREA NET LOT AREA	36533 1965 465 34103	square square square square	feet feet	
LANDSCAPE REQUIREMENT TOTAL LANDSCAPE REQUIREMENT	15% 5115	square	feet	
TOTAL BED PROVIDED GROUNDCOVER REQ. TOTAL GROUNDCOVER REQUIREMENT TOTAL GROUNDCOVER PROVIDED	8460 75% 6346 6577	square square square square	feet feet	
TOTAL SOD PROVIDED TOTAL NATIVE SEED PROVIDED TOTAL LANDSCAPE PROVIDED	0 0 8460	square square square	feet	

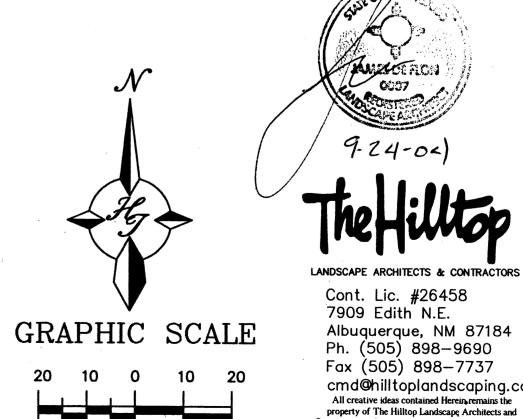

SCALE: 1"=20'



planning

6801 Jefferson NE Suite 100 Albuquerque, NM 87109 505 761-9700 fax 761-4222 dps@dpsabq.com

ARCHITECT


Used Auto-Dealership 5301 Alameda Boulevard N Albuquerque, New Mexico 87 shi

REVISIONS

DRAWN BY REVIEWED BY CMD DATE 09/23/04 PROJECT NO. 04042 DRAWING NAME

Landscape plan

SHEET NO.

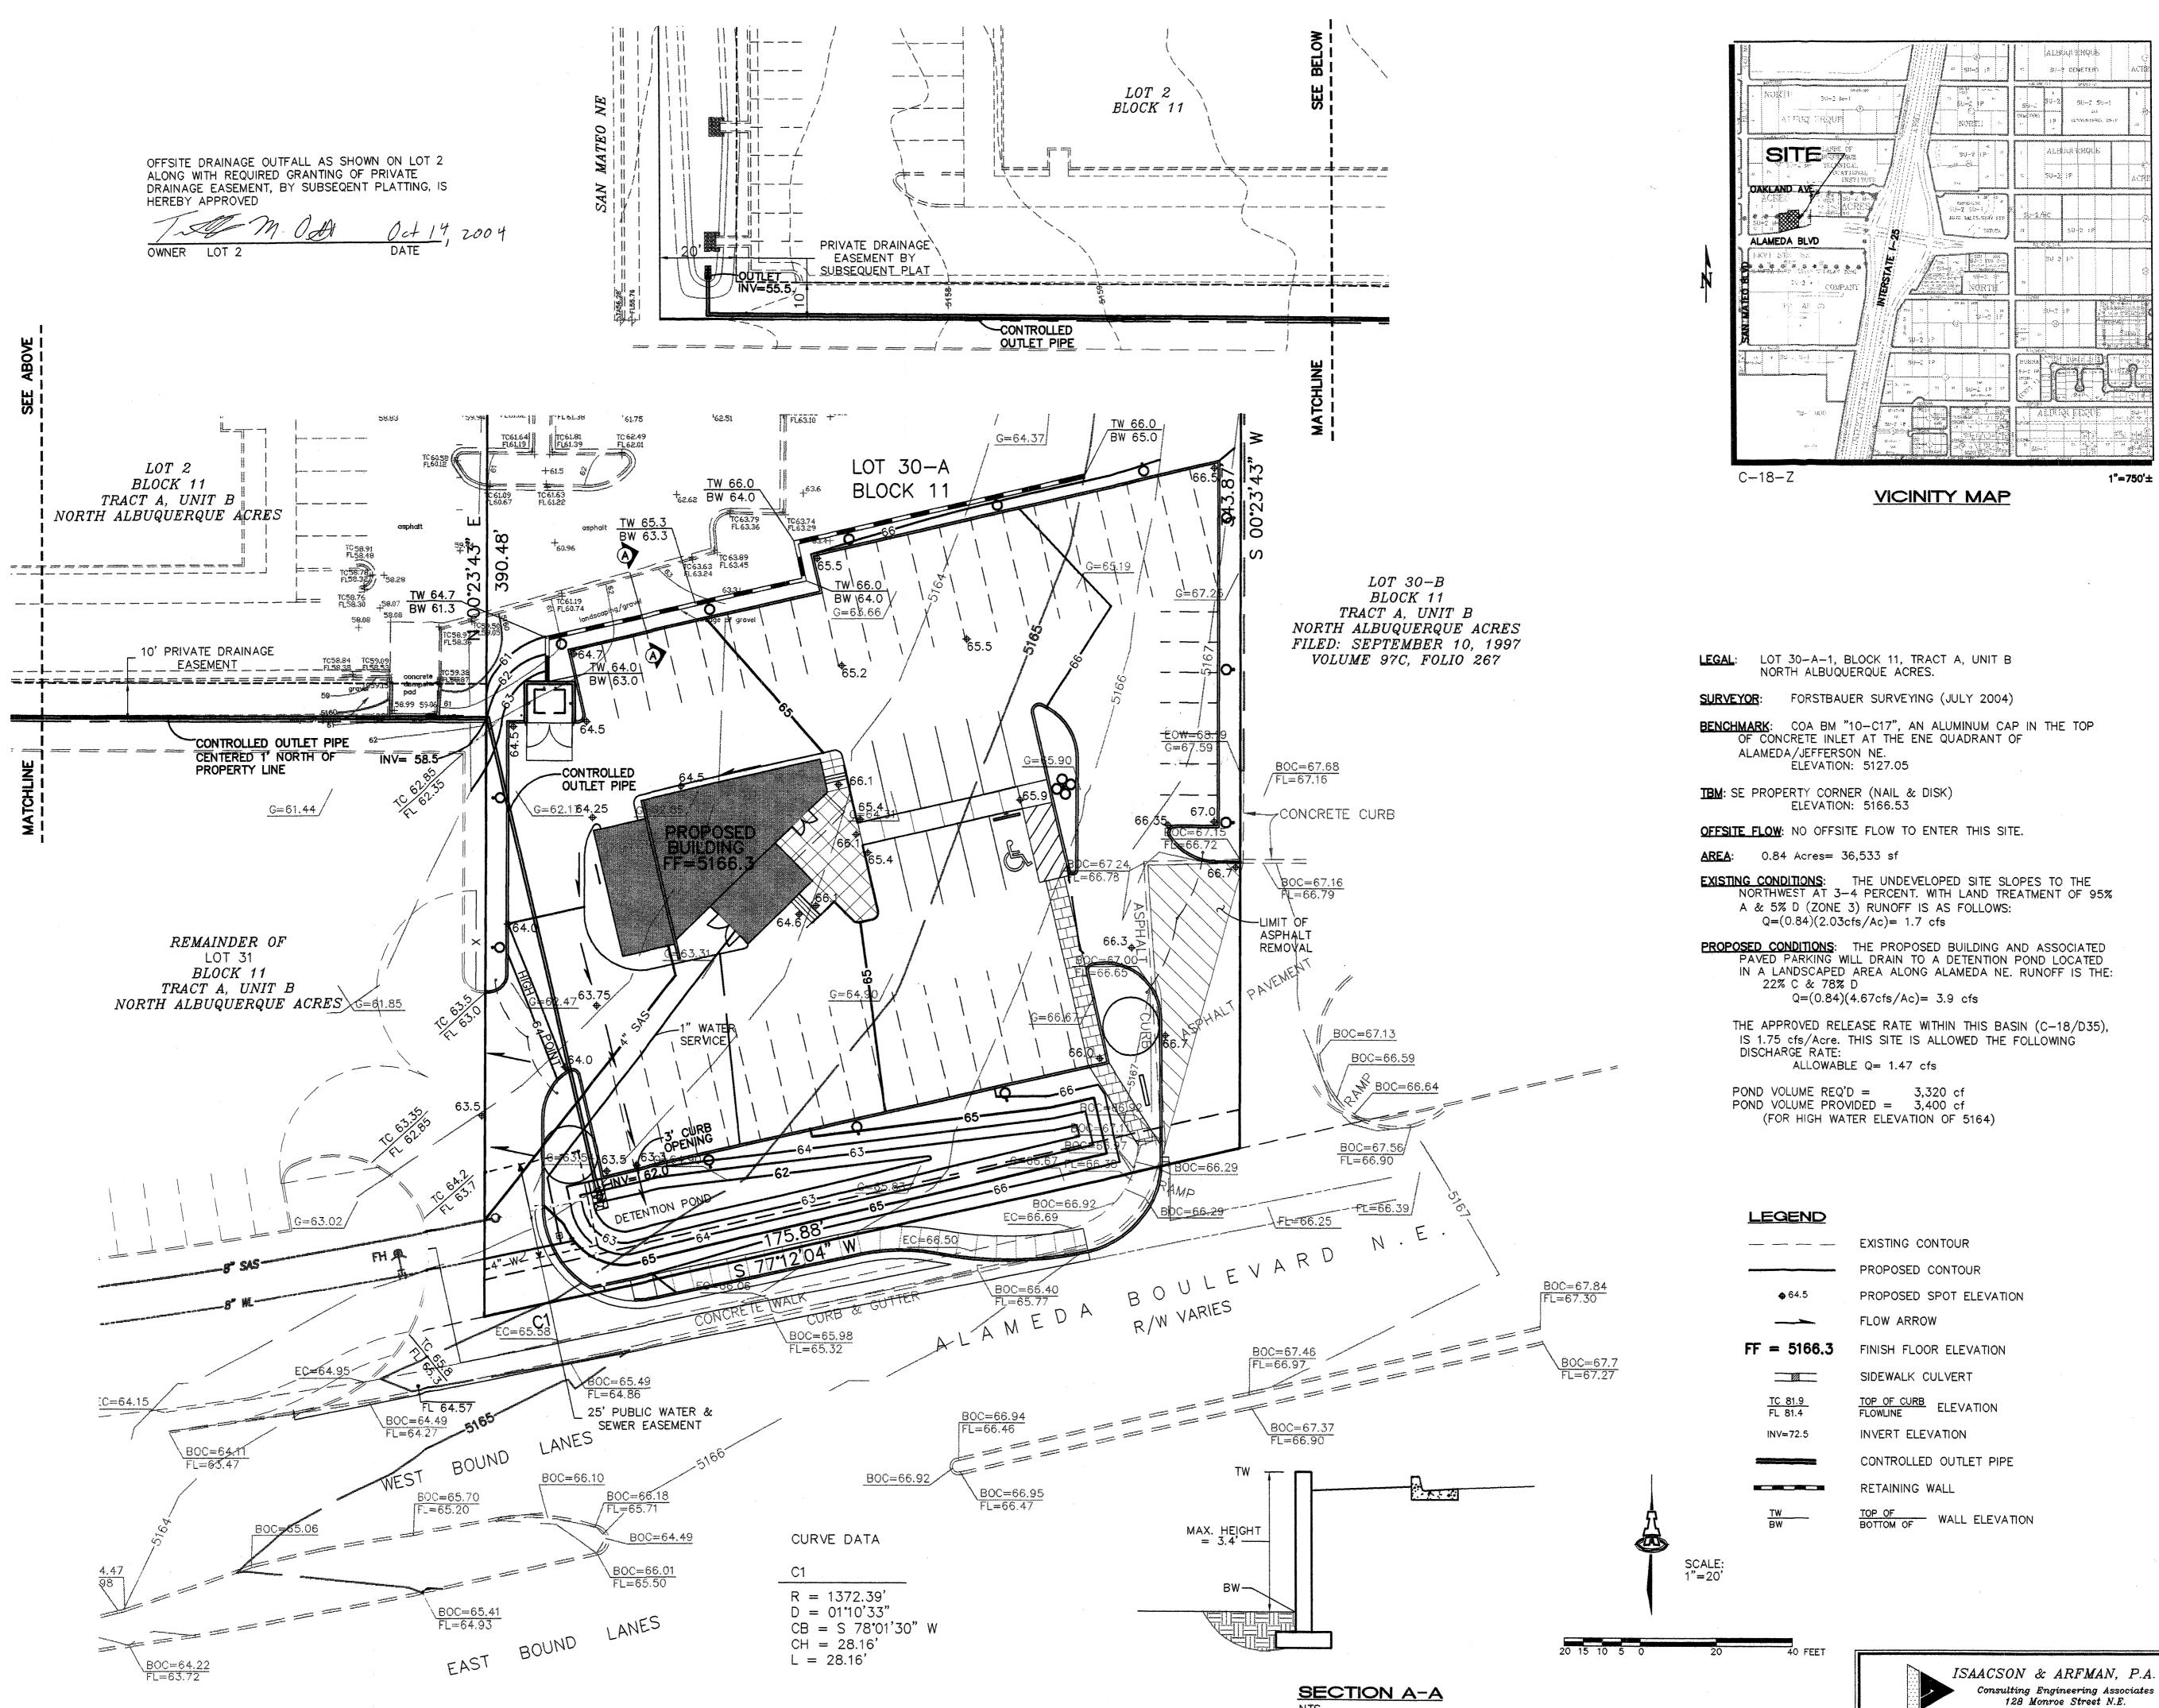

architecture interiors planning engineering

Dekker Perich Sabatini

> 6801 Jefferson NE Suite 100 Albuquerque, NM 87109 505761-9700 fax 761-4222 dps@dpsabq.com

ADOLUTECT



PROJECT

Sed Auto-Dealership 11 Alameda Boulevard NE onergue, New Mexico 8711.

DRAWN BY	thor
REVIEWED BY	SMM
DATE	07/30/04
PROJECT NO.	
DRAWING NAME	

CONCEPTUAL GRADING & UTILITY PLAN

SH

New Mexico

10.05.04

1356GRD.DWGthor

SHEET NO.