

GENERAL SHEET NOTES

- 1. THESE PLANS HAVE BEEN DEVELOPED BASED ON THE GUIDELINES ESTABLISHED IN THE SUBDIVISION PLAN FOR FOUNTAIN HILLS PLAZA DATED SEPT 4, 2007.
- THIS SUBMITTAL ILLUSTRATES THE DESIGN INTENT FOR A NEW HOTEL TO BE CONSTRUCTED ON TRACT D OF THE SHERATON OLD TOWN INN COMPLEX (#1000318), ALONG WITH ASSOCIATED SITE, LANDSCAPE, GRADING, AND UTILITIES IMPROVEMENTS.
- THE PRIMARY REASON FOR REMOVING TRACT D IS TO ESTABLISH SEPARATE ZONING THAT IS MORE ALIGNED WITH THE NEW HOTEL OBJECTIVES.

- THE ENCLOSED SERVICE YARD AREA. GROUND-MOUNTED EQUIPMENT SCREENING WILL BE DESIGNED TO ALLOW FOR ACCESS TO UTILITY FACILITIES. ALL SCREENING AND VEGETATION SURROUNDING GROUND-MOUNTED TRANSFORMERS AND UTILITY PADS ARE TO ALLOW 10' OF CLEARANCE IN FRONT OF EQUIPMENT DOOR, AND 5-6' OF CLEARANCE ON REMAINING THREE SIDES.

○ SHEET KEYED NOTES

- NEW TURN LANE
 LANDSCAPE AREA
- 3. PEDESTRIAN PATHWAY
- 5. BUILDING SETBACK MINIMUM
- 6. BUILDING SETBACK MAXIMUM
- 7. EXISTING RETENTION POND 8. PATIENT DROP-OFF
- 9. FREESTANDING MONUMENT SIGN 10.PARKING SETBACK
- 11.DUMPSTER ENCLOSURE
- 14.MOTORCYCLE PARKING

LEGEND

PROPERTY LINE

EXISTING EASEMENT (ALL EASEMENTS ARE EXISTING)

RETAINING WALL

36" PARKING SCREEN WALLS

72" PLAZA WALLS

42" GUARD RAILS

6'-0" WIDE CONCRETE CROSSWALK

SIDEWALK RAMP(ARROW POINTS DOWN)

20'-0" POLE LIGHT, FULL CUT-OFF WITH (2) LED LIGHT



FIRE DEPARTMENT ACCESS PATH

FIRE HYDRANT (2 NEW AND 4 EXISTING)

PROJECT NUMBER: 1000318

APPLICATION NUMBER: DRB Site Development Plan-Building Permit

Is an Infrastructure List Required? (x) Yes () No If yes, then a set of approved DRC plans with a work order is required for any construction within Public Right-of-Way or for construction of

DRB SITE DEVELOPMENT PLAN APPROVAL

public improvements.

CITY ENGINEER

DATE TRAFFIC ENGINEER, TRANSPORTATION DIVISION DATE **UTILITIES DIVISION** DATE PARKS AND RECREATION DEPARTMENT

DATE SOLID WASTE MANAGEMENT

DATE

DATE FIRE MARSHALL

DATE DRB CHAIRPERSON, PLANNING DEPARTMENT

PROJECT DATA

BUILDING AREA
PHASE 1: 25,762 SF (INCLUDING TRICORE AREA 3,505 SF)
PHASE 2: 9,050 SF

FULL BUILD OUT AREA: 34,812 SF

CONSTRUCTION TYPE: IIB OCCUPANCY TYPE: B

AN AUTOMATIC SPRINKLER AND SMOKE DETECTION SYSTEM SHALL BE INSTALLED THROUGHOUT THE BUILDING. SPRINKLER CONTRACTOR TO SUBMIT SHOP DRAWINGS TO THE AUTHORITY HAVING JURISTICTION. FIRE ALARM SYSTEM TO BE PROVIDED.

PARKING CALCULATIONS

PARKING PROVIDED PER PROVIDER. CLINICAL PROVIDERS INCLUDE: DOCTORS OF MEDICINE, MEDICAL/PHYSICIAN ASSISTANTS, NURSE PRACTITIONERS, PHLEBOTOMISTS OR LAB TECHNICIANS, NUTRITIONISTS AND BEHAVIOR HEALTH PROFESSIONALS.

PHASE 1 PHASE 2 URGENT CARE TRICORE LABS TOTAL

28 PROVIDERS AT 5 SPACES/ PROVIDER = 140 SPACES + 14 SPACES = 154 SPACES **TOTAL MAX PARKING PHASE 1**

FULL BUILD OUT 38 PROVIDERS AT 5 SPACES/ PROVIDER = 190 SPACES +10% + 19 SPACES
TOTAL MAX PARKING FULL BUILD OUT = 209 SPACES

ACCESSIBLE PARKING: PHASE 1: 154 SPACES, 10% (16) REQUIRED 16 SPACES PROVIDED:12 ACCESSIBLE SPACES / 4 VAN SPACES


FULL BUILD OUT = TOTAL 208 SPACES, 10% (21) REQUIRED 21 SPACES PROVIDED:17 ACCESSIBLE SPACES / 4 VAN SPACES MOTORCYCLE SPACES
5 REQUIRED FOR 151-300 SPACES (BOTH PHASE ONE AND FULL BUILD OUT)

5 PROVIDED AT PHASE ONE

BICYCLE PARKING

1 PER 20 PARKING SPACES REQUIRED FOR AUTOMOBILES.

208 SPACES AT FULL BUILD OUT = 11 BICYCLE SPACES REQUIRED AT FULL BUILD OUT 12 PROVIDED AT PHASE ONE

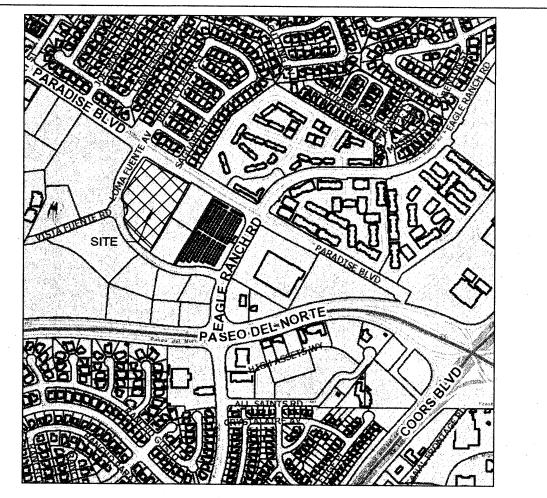



ARCHITECTURE / DESIGN / INSPIRATION

DEKKER PERICH SABATINI

PARADI 4588 PARADISE BLV ALBUQUERQUE, NN

REVISIONS


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REVIEWED BY 06/25/2015

15-0028

PROJECT NO. DRAWING NAME

SITE PLAN

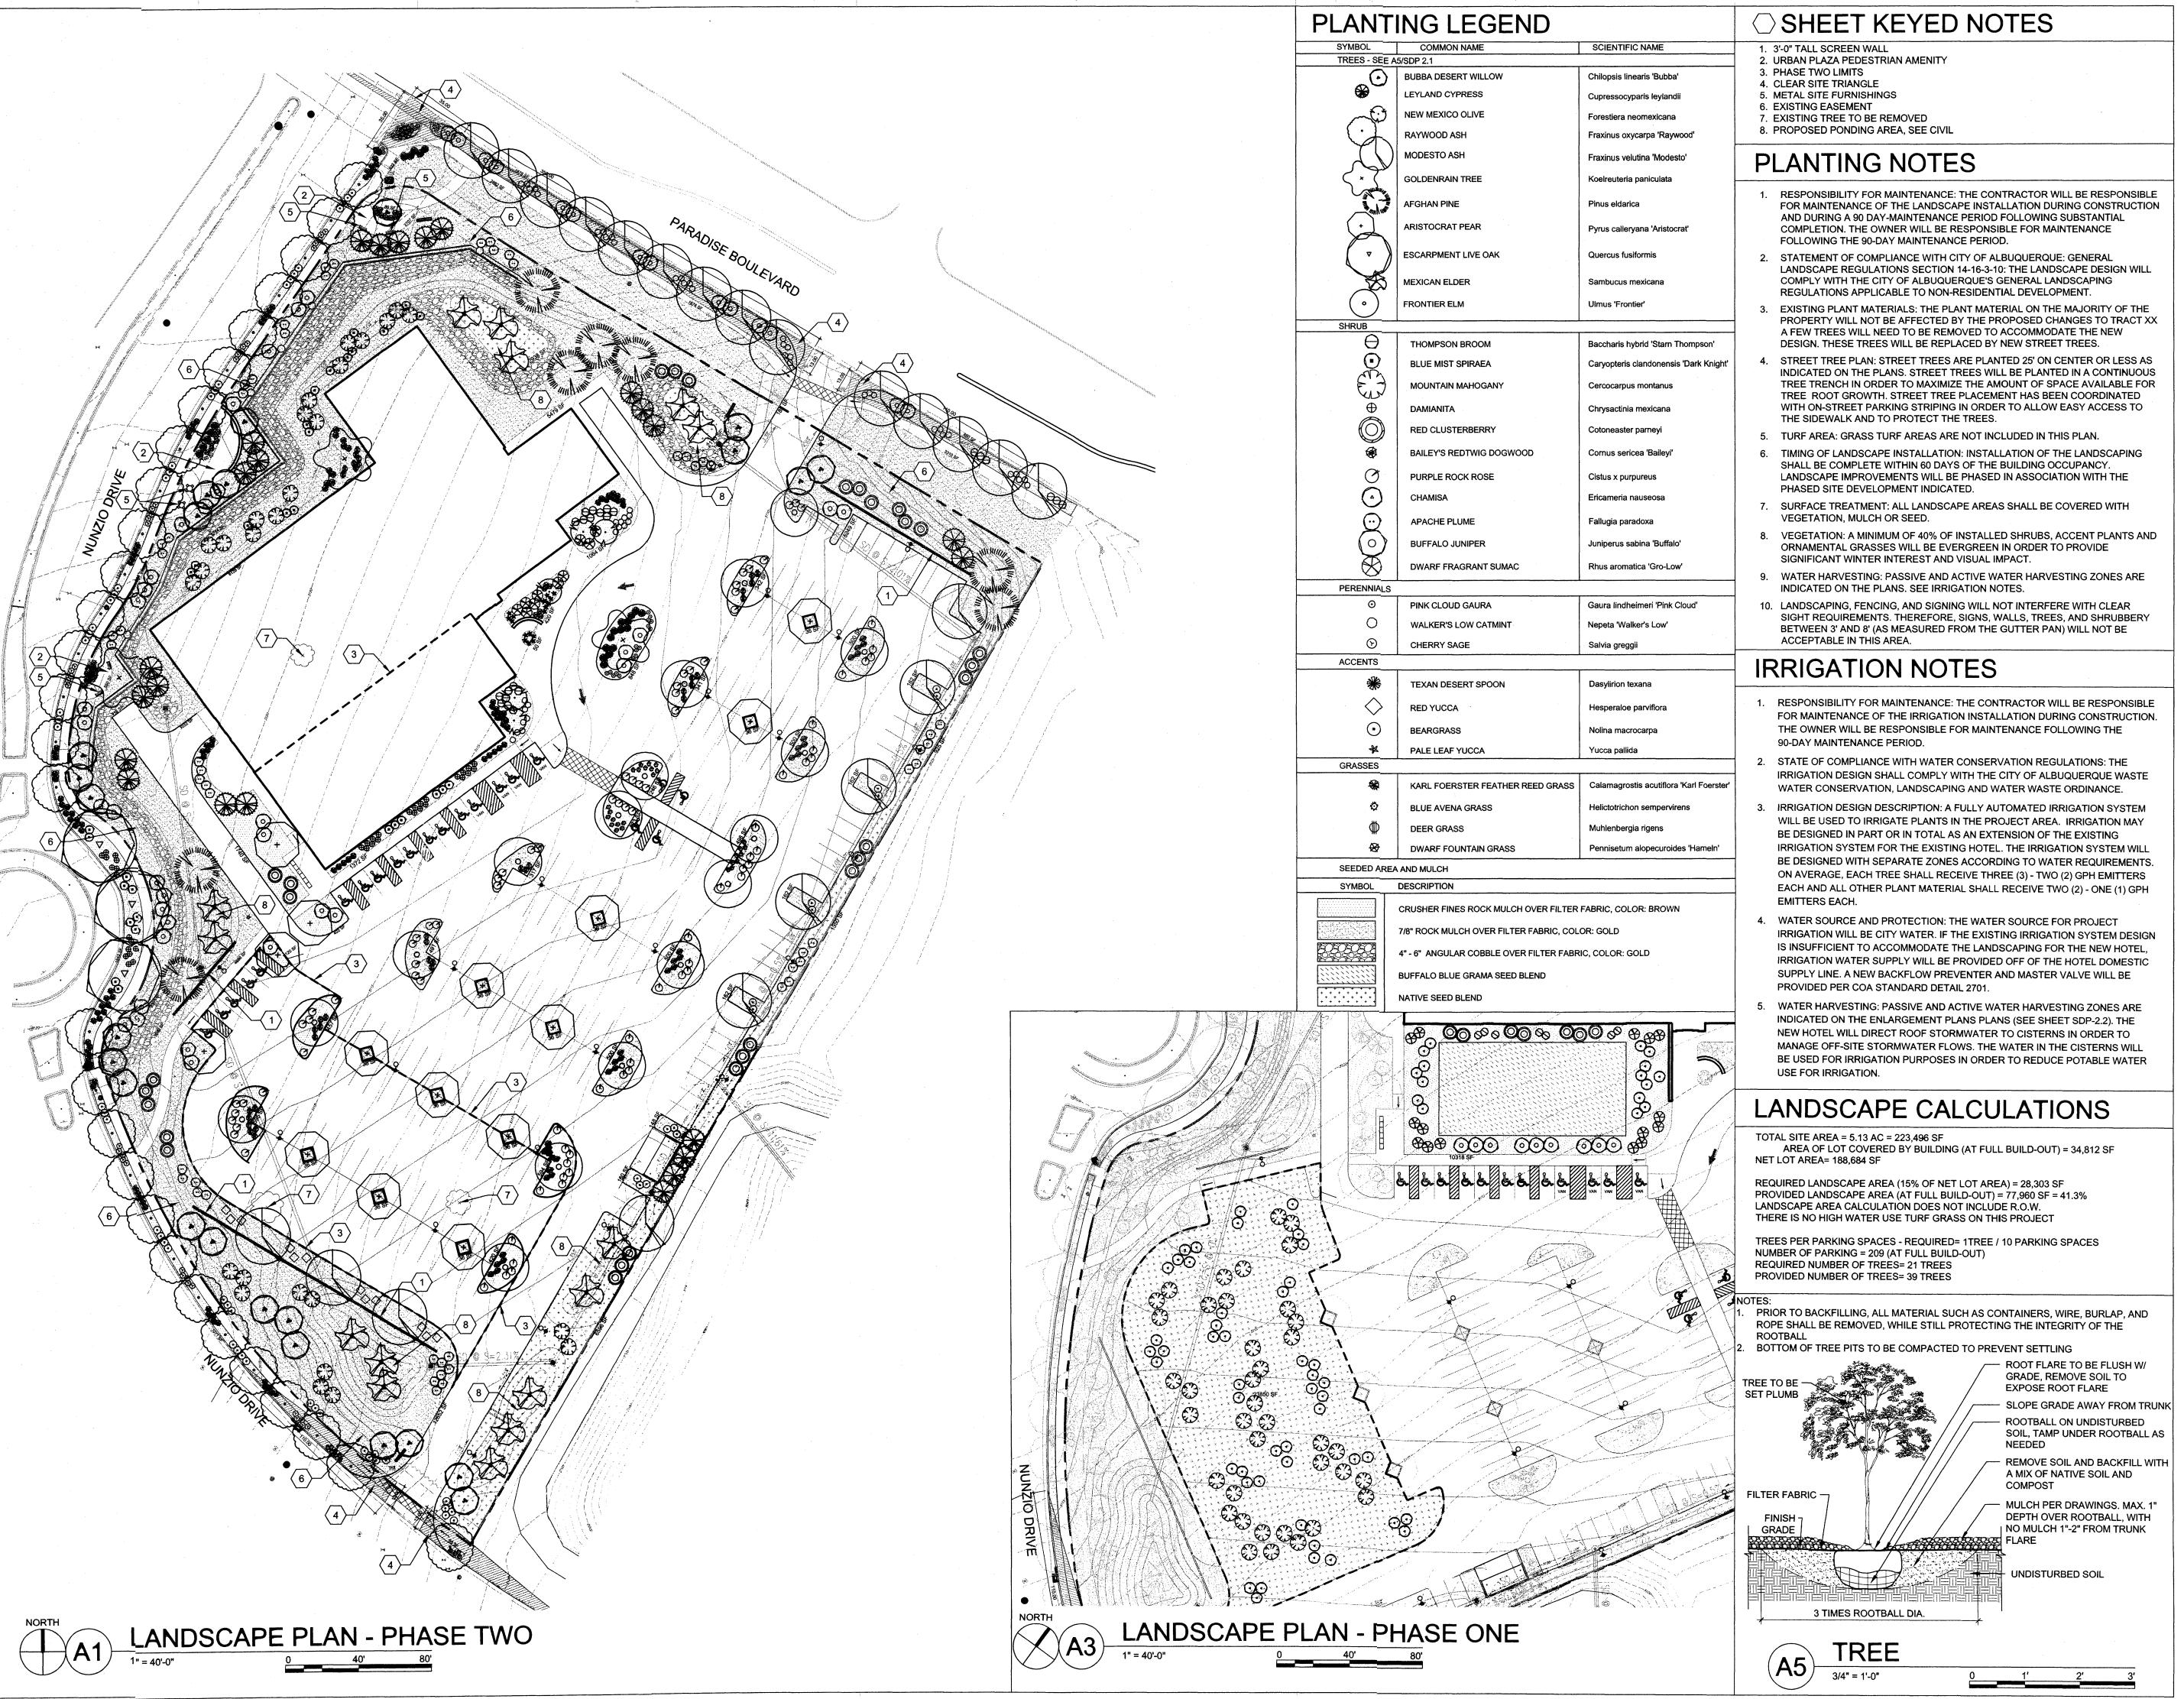

ARCHITECTURE / DESIGN / INSPIRATION

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ARCHITECT

ENGINEER

4588 PARADISE BLY ALBUQUERQUE, N

PROJECT

REVISIONS

DRAWN BY

DATE

REVIEWED BY

PROJECT NO.

DRAWING NAME

SHEET NO.

LANDSCAPE PLAN

06/25/2015

15-0028

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SABATINI

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ARCHITECT

ENGINEER

PROJECT

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REVIEWED BY GSB
DATE 06/25/2015
PROJECT NO. 15-0028
DRAWING NAME

GRADING & DRAINAGE PLAN

SHEET NO.

Bohannan A Huston

800.877.5332

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UTILITY NOTES

- 1. THIS CONTRACTOR SHALL BE RESPONSIBLE FOR THE COMPLETE INSTALLATION OF ALL WORK RELATED TO MECHANICAL UTILITIES AS SHOWN ON THIS PLAN INCLUDING: TRENCHING, BACKFILL, SUPPORTS, CLEANOUT PADS, SERVICE STOPS AND BOXES, SERVICE LINES, TESTING, CLEANING, AND STERILIZING. ANY WORK NOT ACCEPTED BY THE ARCHITECT OR ENGINEER DUE TO IMPROPER WORKMANSHIP OR LACK OF PROPER COORDINATION SHALL BE REMOVED AND CORRECTLY INSTALLED AT THE CONTRACTOR'S EXPENSE, AS DIRECTED.
- 2. MINIMUM DEPTHS OF COVER SHALL BE: 36" FOR WATERLINES AND 48" FOR SEWER, EXCEPT AT BUILDING CONNECTION.
- 3. ALL WORK DETAILED ON THESE PLANS TO BE PERFORMED UNDER CONTRACT SHALL, EXCEPT AS OTHERWISE STATED OR PROVIDED OF HEREON, BE CONSTRUCTED IN ACCORDANCE WITH THE IAPMO UNIFORM PLUMBING CODE & NFPA 24, LATEST EDITION.
- 4. UTILITY LINES SHALL BE INSTALLED PRIOR TO PAVEMENT, CURB AND GUTTER, AND/OR SIDEWALK, AS APPLICABLE.
- 5. ROUGH GRADING OF SITE (±0.5') SHALL BE COMPLETED PRIOR TO INSTALLATION OF UTILITY LINES
- 6. CONTRACTOR WILL BE RESPONSIBLE FOR CONNECTIONS TO BUILDING DRAIN LINES AND ALL NECESSARY FITTINGS.
- 7. ALL VALVES SHALL BE ANCHORED PER COA STANDARD DWG. 2333.
- 8. FIRE LINES SHALL USE PIPE MATERIALS UNDERWRITERS LABORATORIES LISTED AND APPROVED FOR FIRE SERVICE.
- 9. CONTRACTOR SHALL BE RESPONSIBLE FOR ALL WATER METER, FIRE LINE, AND SEWER HOOKUP FEES FOR INSTALLATIONS. OWNER SHALL BE RESPONSIBLE FOR UTILITY EXPANSION CHARGES, PRORATA AND OTHER SPECIAL ASSESSMENTS.
- 10. CONTRACTOR SHALL VERIFY INVERTS AND LOCATIONS OF EXISTING WATER/SAS LINES PRIOR TO BEGINNING WORK. ALL CONFLICTS SHALL BE BROUGHT TO ATTENTION OF THE ENGINEER AND RESOLVED PRIOR TO BEGINNING WORK.
- 11. CONTRACTOR SHALL NOTIFY THE AUTHORITY HAVING JURISDICTION PRIOR TO INSTALLATION OF FIRE SERVICE LINES, AND PRIOR TO TESTING OF ALL WATERLINES. CONTRACTOR SHALL COMPLETE, SIGN, AND SUBMIT THE "CONTRACTOR'S MATERIAL & TEST CERTIFICATE FOR UNDERGROUND PIPING" IN ACCORDANCE WITH NFPA 24.

○ KEYED NOTES

- 1. 6" FIRE LINE.
- 2. 8" FIRE LINE.
- 3. 8" GATE VALVE WITH POST INDICATOR.
- 4. 8"x8"x8" TEE & 8" GATE VALVE WITH BOX & LID.
- 5. 8"x8"x6" TEE, 6" GATE VALVE WITH BOX & LID AND 1 FIRE
- 6. 12"x12"x6" TEE, 6" GATE VALVE WITH BOX AND LID AND 1 FIRE
- HYDRANT.
- 7. 8"x6" REDUCER.
- 8. 6" FIRE PROTECTION REDUCED PRESSURE BACKFLOW PREVENTER AND 2" DOMESTIC REDUCED PRESSURE BACKFLOW PREVENTER IN SINGLE HEATED ENCLOSURE.
- 9. REMOTE FIRE DEPARTMENT CONECTION (FDC) AND CHECK VALVE TO BE INSTALLED DOWNSTREAM OF 6" REDUCED PRESSURE BACKFLOW PREVENTER AND MOUNTED TO THE HEATED ENCLOSURE.
- 10. 6" SANITARY SEWER SERVICE LINE.
- 11. SANITARY SEWER CLEANOUT.

PROPOSED WATER METER

12. REMOVE & REPLACE EXISTING ASPHALT PAVEMENT AND CONCRETE CURB & GUTTER FOR UTILITY TRENCH. MATCH EXISTING.

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PRESBYTERIAN PARADISE

4588 PARADISE BLVD

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DATE 06/25/2015
PROJECT NO. 15-0028
DRAWING NAME

SITE UTILITY PLAN

SHEET NO.

C-200

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REVISIONS

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PROJECT NO.

06/25/2015

15-0028

DRAWING NAME

EXTERIOR ELEVATIONS

AE-20

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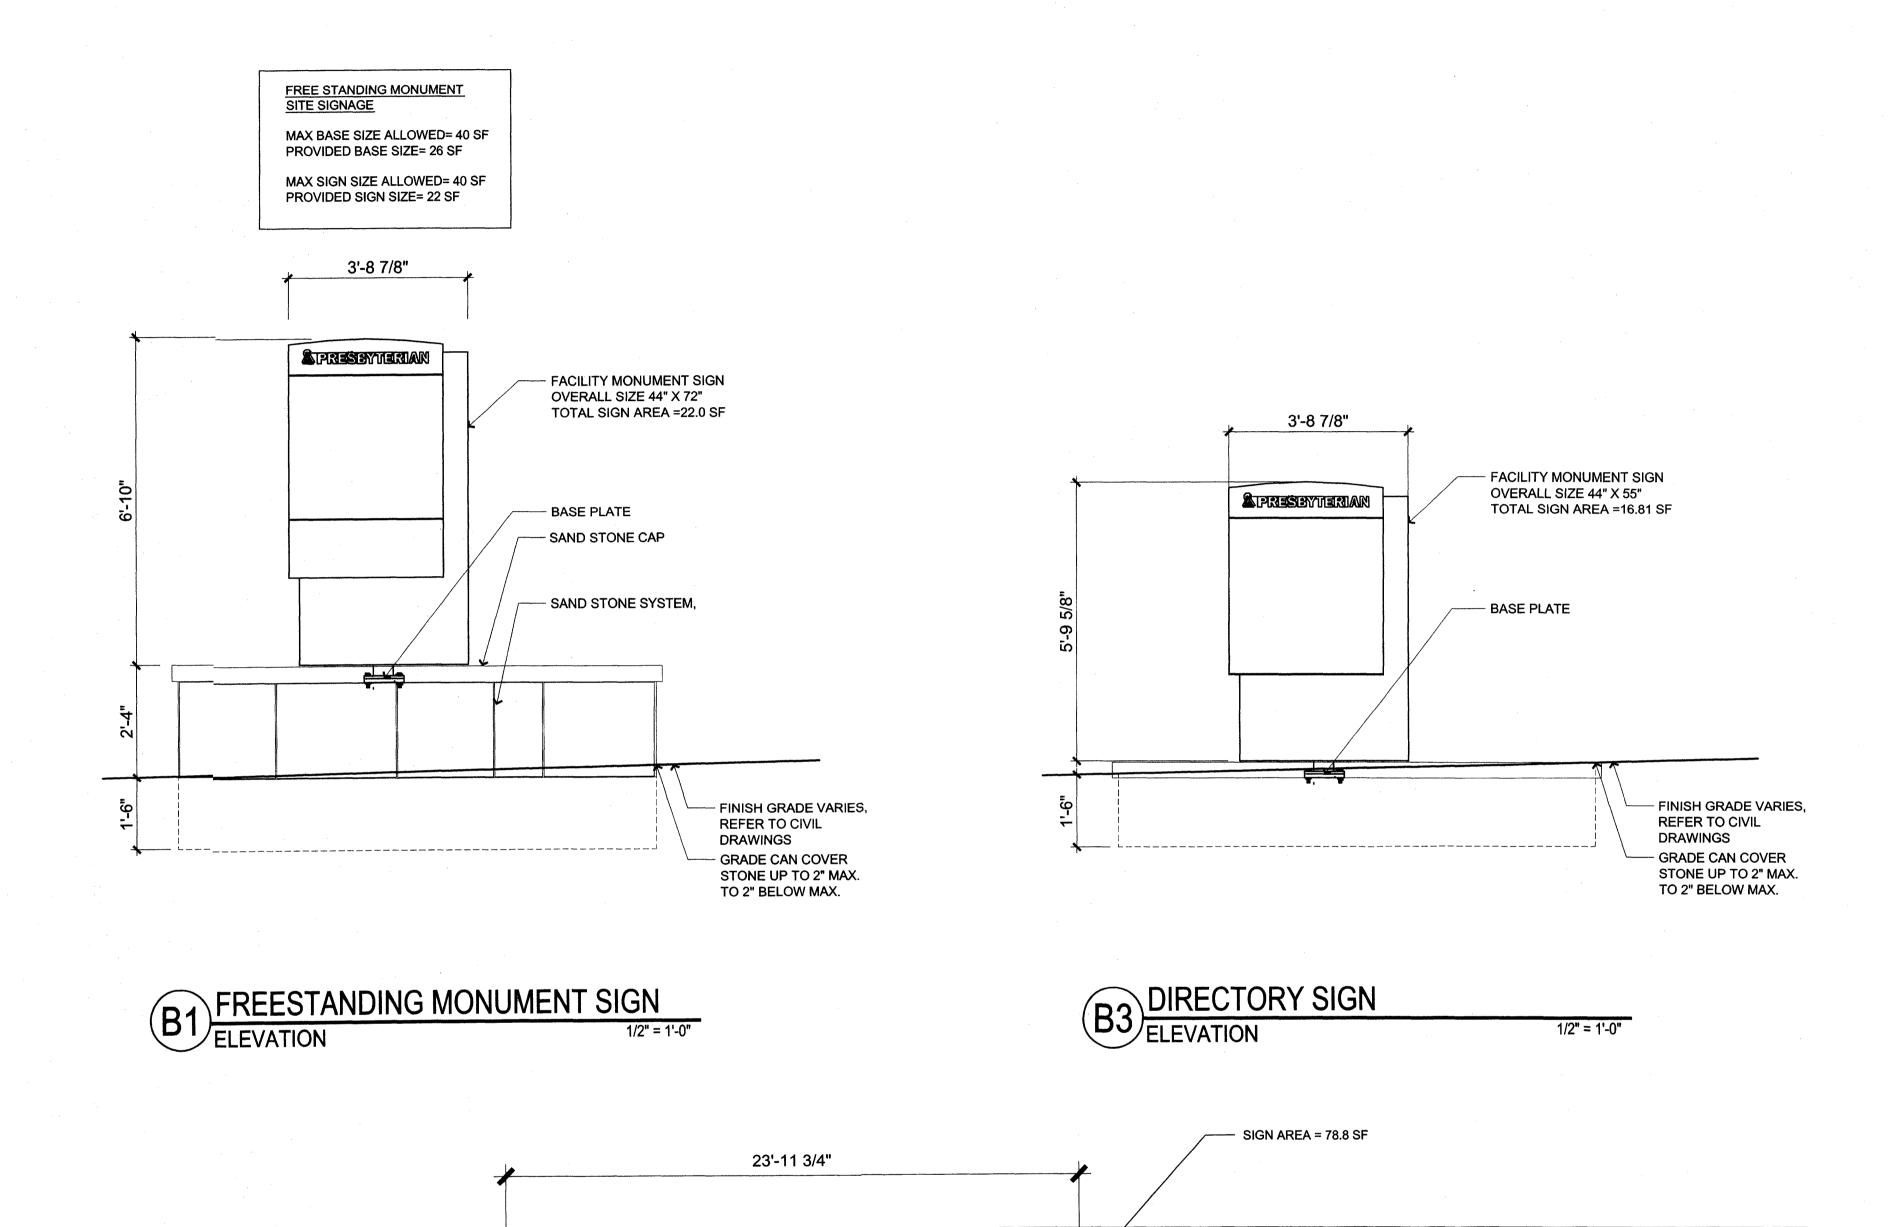
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DATE 06/25/2015

PROJECT NO.

SIGN ELEVATIONS

SI-501



ILLUMINATED BUILDING SIGN

1/4" = 1'-0"

0 2' 4' 8'

102-2A

SITE DETAILS

DRAWING NAME 15-0028 PROJECT NO. 06/25/2015 **BTAQ** *BENIEMED BA* Ya nwaad

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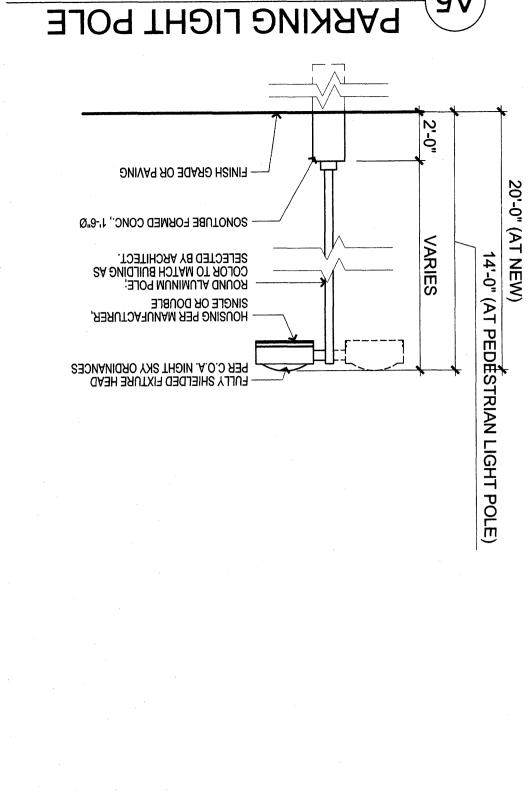
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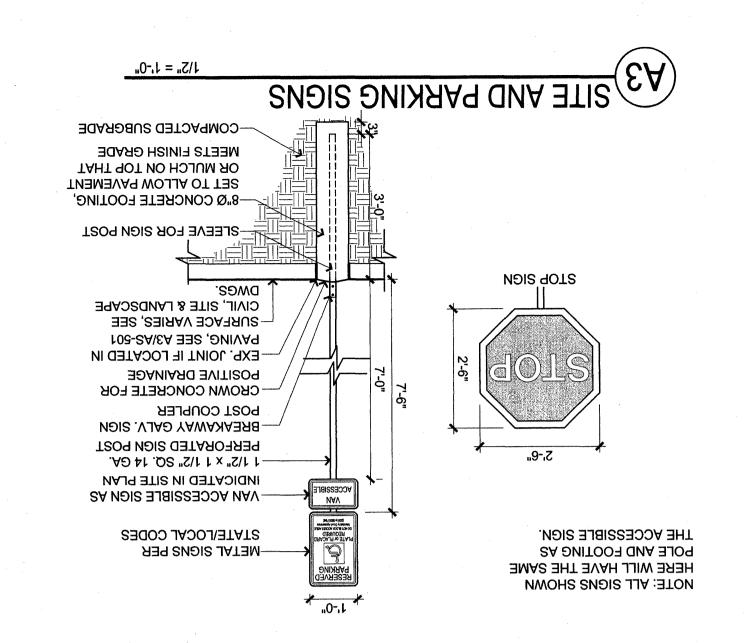
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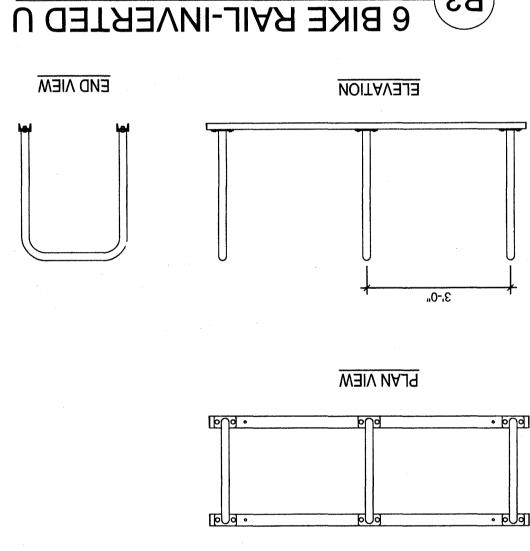
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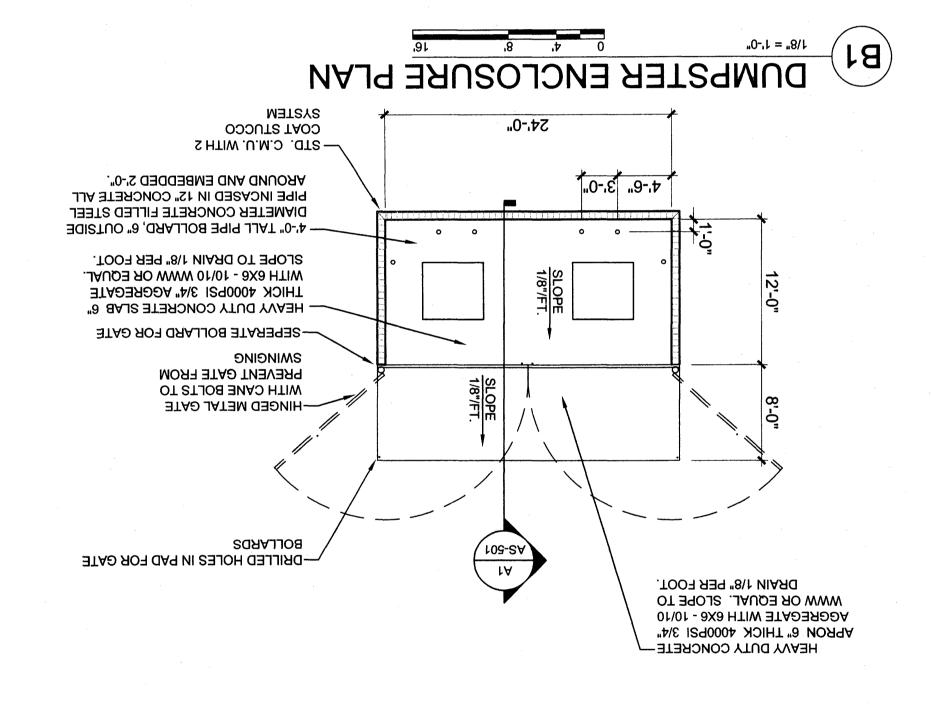
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..0-.9

1/5" = 1'-0"



1/5" = 1'-0"

ENCLOSURE SECTION

NOTE: CONTINUE CMU WALL AT AROUND COOLING UNIT. SEE SITE PLAN

M\(S)-#4 CONT.

SLOPE MIN.

_102-2A\4A

CONCRETE, SEE

YTUQ YVA3H

ТООЯ "%

WALL BEYOND

- СОИС. ТИВИРОМИ

CONT. AND #4@16"

-- 火" EXP. JOINT ---

—(1) #2 IN KNOCK ONT

SOLID, FULL HEIGHT

(1) #2 IN KNOCK ONT

Matsys occurs tacc -

8" STD. CMU WITH TWD

TO BE SELECTED BY ARCH SOLID CMU CAP

GROUT ALL CMU

DUMPSTER ONLY

TA GRAJJOB 3919 — -


— #2 @ 35" O.C.


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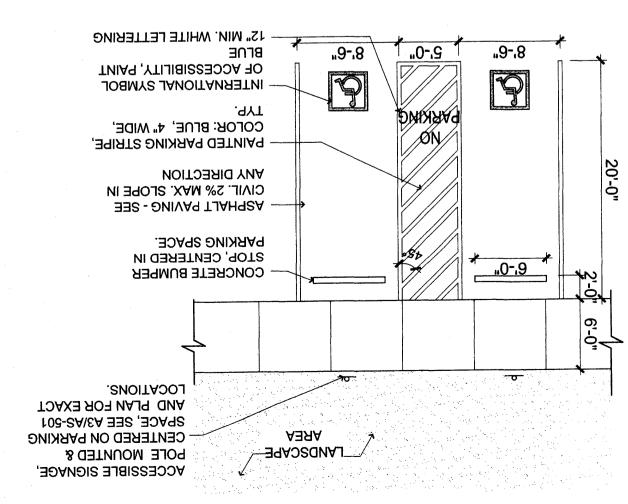
BOND BEAM


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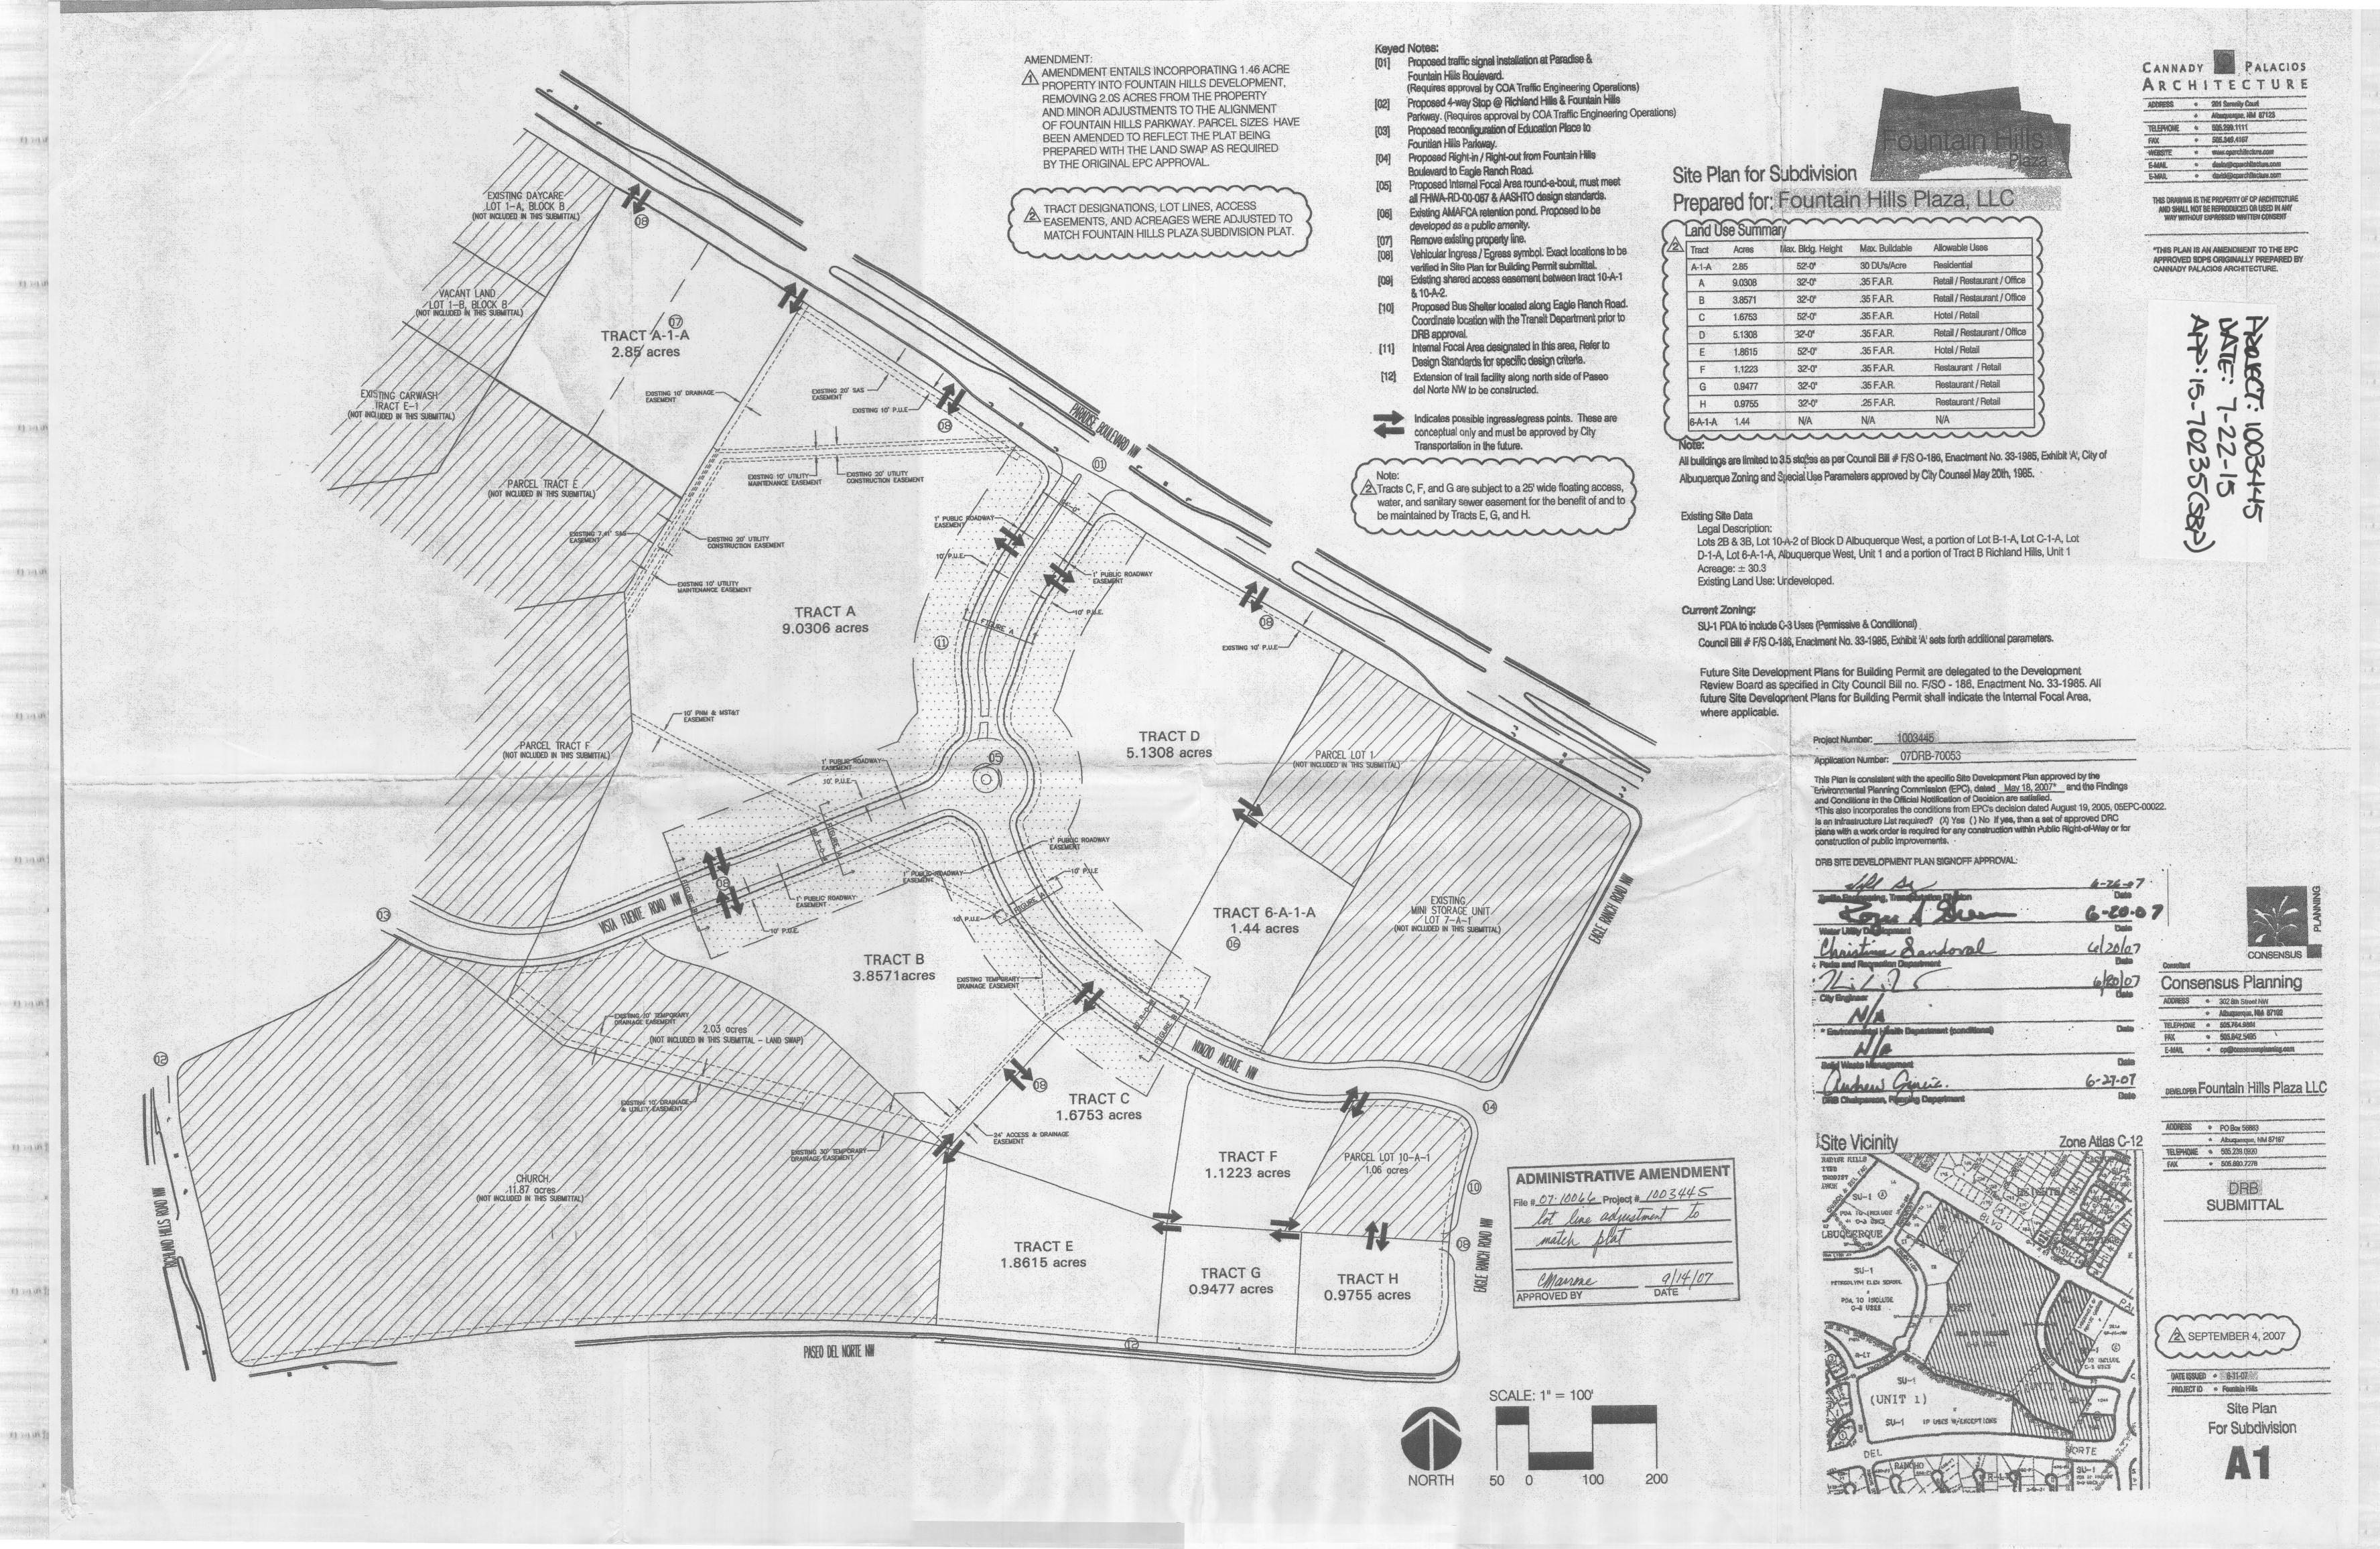






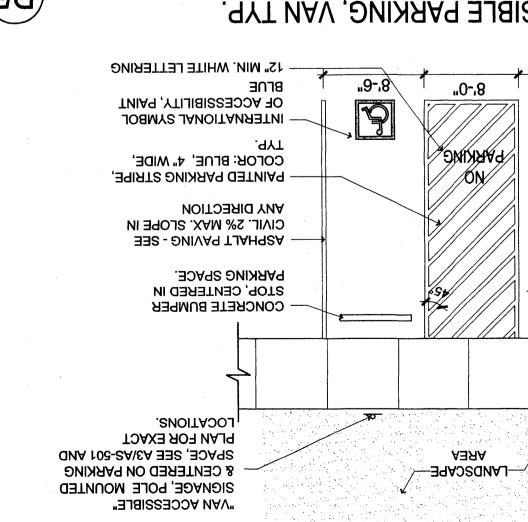

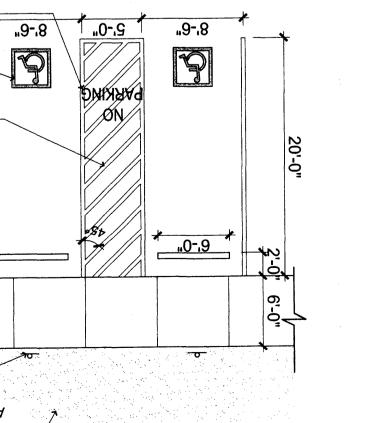

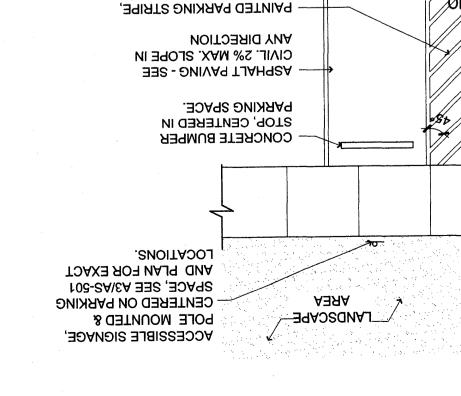

Design Guidelines & Standards

The purpose of these Design Guidelines is to provide a framework to assist developers and designers in understanding the development goals and objectives for the Fountain Hills mixed-use development. These guidelines address the issues of streetscape, road design, pedestrian circulation, setbacks, parking, lighting, signage, site layout, architecture, landscape and transit opportunities. Each category is organized in terms of Standards (Items that are required), and Guidelines (Items that are encouraged). Where there is a conflict between City Codes or Ordinances and the Design Guidelines & Standards, the more restrictive requirement shall be applicable.

The Design Standards shall be used to facilitate the design of buildings which respect the natural conditions of the site, maintain and highlight the spectacular views of the Sandia and Manzano Mountains and to provide a clustered building design that breaks up large parking areas into an integrated pedestrian center.

Site Plan Submittals:

Site Development Plans for Building Permit for all Tracts shall be reviewed and approved by the Development Review Board (DRB) in accordance with the provisions set forth in Council Bill # F/S O-186, Enactment No. 33-1985, Exhibit 'A', City of Albuquerque Zoning and Special Use Parameters approved by City Counsel May 20th, 1985.

The proposed site consists of approximately 31 acres of undeveloped land bounded by Paradise Blvd to the North, Eagle Ranch Rd to the East, Paseo Del Norte to the South & Education Pl to the West.

Land Use Concept:

The land use concept is an integrated, Mixed-use Office / Commercial / Retail & Service Center, adjacent to a Designated Community Activity Center per the City of Albuquerque Comprehensive Plan. The character developed within the center is a pedestrian friendly environment consisting of areas for displays & seating. The design criteria encourages the use of small and large scale plazas and patios to create outdoor public / private space. The street layout encourages this type of activity by providing an Internal Focal Area around which buildings are oriented, providing slower moving pedestrian friendly traffic conditions in high congestion areas. On-street parking, pedestrian nodes and an integrated internal street system will work toward creating a community identity.

C-3 Permissive & Conditional uses including package liquor for off-site consumption, unless otherwise restricted below.

Automotive Engine Mfg.

Tire recapping or re-treading

Bulk Fuel Storage & Sales

On-Site Dry Cleaning Plant

Cold Storage Plant

Welding

Ice Plant

Kennel

Warehousing

Auto Dismantling

Prohibited Uses:

- Adult Amusement Establishment or Adult Store
- Mfg., assembling, treating, repairing, or rebuilding of products
- Printing, publishing, lithography, or blueprinting
- Sheet metal working
- Upholstering
- Contractor's yard
- Equipment rental, sales, display and repair
- Antenna (without height limitation)
- Operative contractor's equipment and heavy farm equipment sales
- Railroad right-of-way and incidental facilities
- Outdoor building material storage or sales unless unless incidental to retail sales and adequately screened Specific uses restricted by Council Bill # F/S O-186, Enactment No. 33-1985, annexation agreement

Adjacent Land Uses (Zoning):

- North Single Family Residential (R-1, SU-1 & RT)
- Multi-Family Residential Apartments (SU-1, C-2 & R-2)
- Undeveloped Land (SU-1 IP w/ Exceptions per the Riverview Sector Development Plan)
- Single Family Residential (R-LT)
- Commercial (SU-1 PDA to include C-3 Uses)
- Multi-Family Residential Apartments (SU-1)
- Petroglyph Elementary School (SU-1 PDA to include C-3 Uses)
 - Commercial (SU-1)

Site / Edge Design

Landscape buffers shall include trees spaced a minimum of 30 feet on center and include a minimum of 25% coniferous trees. Parking provided adjacent to Paradise Boulevard, Eagle Ranch, and Paseo Del Norte shall be screened by short walls and/or landscaping to a height of 3 feet. A 6 foot sidewalk shall be provided within these right-of-ways to provide pedestrian access.

- The Internal Focal Area shall be defined by a vehicular round-a-bout and parallel parking within the public right-of-way. The area immediately adjacent to the round-a-bout shall be constructed of materials that distinguish it from typical roadway materials, such as integrally colored and/or stamped concrete, brick forms or pavers of various sizes.
- Amenities that cater to pedestrians, bicyclists, transit users and motorists shall be provided within the Internal Focal Area. (i.e. seating, bicycle parking, outdoor display, newspaper kiosks, etc.)
- The project edge along Paradise Boulevard, Eagle Ranch Road & Paseo Del Norte shall include at least a 10 foot landscape setback from property line to provide a buffer to the adjacent properties.
- Street edges adjacent to Tract A-1-A shall utilize a combination of walls, decorative fencing, and landscaping to provide for a secure residential environment. The material treatments shall be compatible with adjacent buildings and consist of materials specified in the Perimeter Walls & Screening section provided in this document.

Public Right-of-Way

All Access Points provided on the site plan are for illustrative purposes only and are subject to change.

- The Site Plan shall comply and be designed per DPM Standards.
- The Internal Focal Area is proposed as a 60 foot public right-of-way as shown in Figure A & Figure D.
- The streets outside of the Internal Focal Area are proposed as a 60 foot public right-of-way as shown in Figure B.

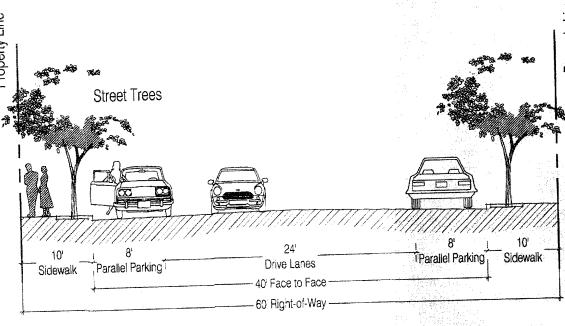


Figure A: Internal Focal Area Minimum Street Section

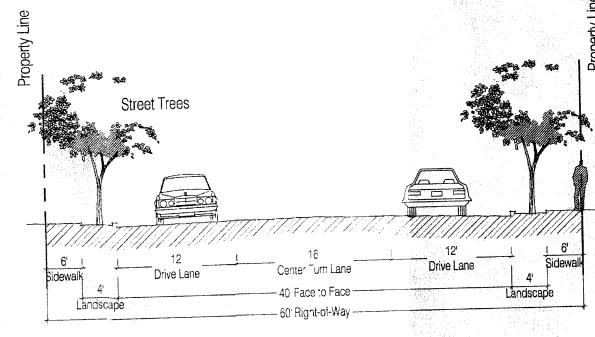


Figure B: Right-of-Way Minimum Street Section

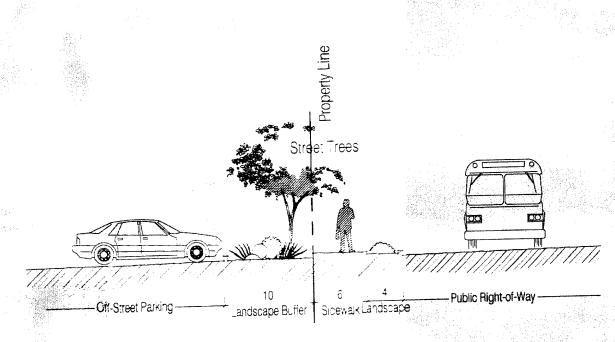


Figure C: Off-Street Parking Minimum Section

- All intersections shall have pedestrian crosswalks that are a minimum of 6 feet wide. These crosswalks shall be constructed of materials that distinguish it from the roadway materials, such materials shall consist of integrally colored and/or stamped concrete, brick forms or pavers of various sizes.
- Provide cross access to all properties adjacent to the proposed development.
- Fountain Hills Drive shall provide access from Fountain Hills Boulevard (Nunzio Avenue) to Parcel H-4.
- The round-a-bout shall be designed per FHWA & AASHTO Standards, including on-street parking in and around this
- Fountain Hills Boulevard (Nunzio Avenue) & Eagle Ranch snail be restricted to a Right-in Right-out intersection.


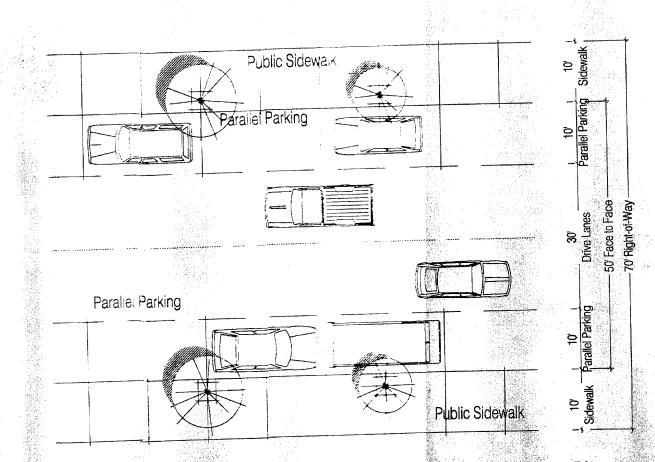



Figure D: Internal Focal Area Street Plan

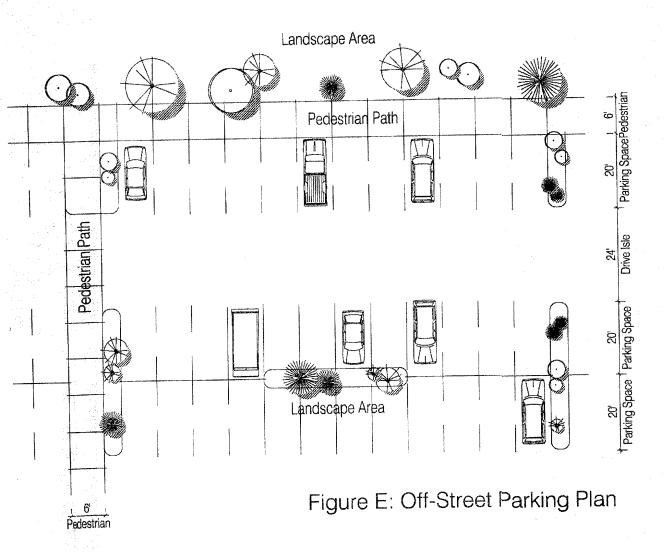

Off-Street Parking

In order to support the goals for the property regarding pedestrian accessibility, careful attention shall be paid to the parking design. An effort shall be made to lessen the impact of parking facilities on the land through landscaping, site location and arrangement. In order to lessen the visual impact of parking areas, parking facilities shall be broken up into a series of smaller areas.

- All Off-Street parking shall comply with Section 14-16-3-1 of the Comprehensive Zoning Code.
- The maximum amount of parking provided shall meet parking requirements in the City Zoning Code, plus 10 percent.
- Parking areas shall be designed to include a 6 foot wide pedestrian link to buildings. This linkage shall be constructed of materials that distinguish it from the roadway materials, such materials shall consist of integrally colored and/or stamped concrete, brick forms or pavers of various sizes.
- Parking areas shall be setback a minimum of 10 feet from adjacent property lines and/or private drive easements.
- Barrier curbs shall be provided around all parking areas in order to protect landscaping from vehicles. These barriers shall provide waer runoff openings to allow surface drainage into the landscaped areas.
- Parking shall be distributed among several parking areas on each site to limit large expanses of parking lots. Parking shall be placed behind buildings or be screened from surrounding neighborhoods by means of walls and/or landscaping. Walls shall be architecturally compatible with the surrounding buildings.
- Bicycle parking shall be provided pursuant to City Zoning Code. To encourage non-vehicular travel, provisions for convenient on-site bicycle lockers and/or secure bicycle storage areas shall be provided adjacent to building entrances.
- Off-street parking areas shall not be permitted adjacent to Fountain Hills Boulevard (Nunzio Avenue) or Fountain Hills Parkway within the Internal Focal Area.
- Motorcycle parking shall be provided at 2 spaces per building. The motorcycle parking is not required to be located. next to the building.

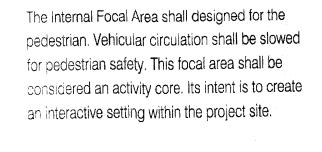

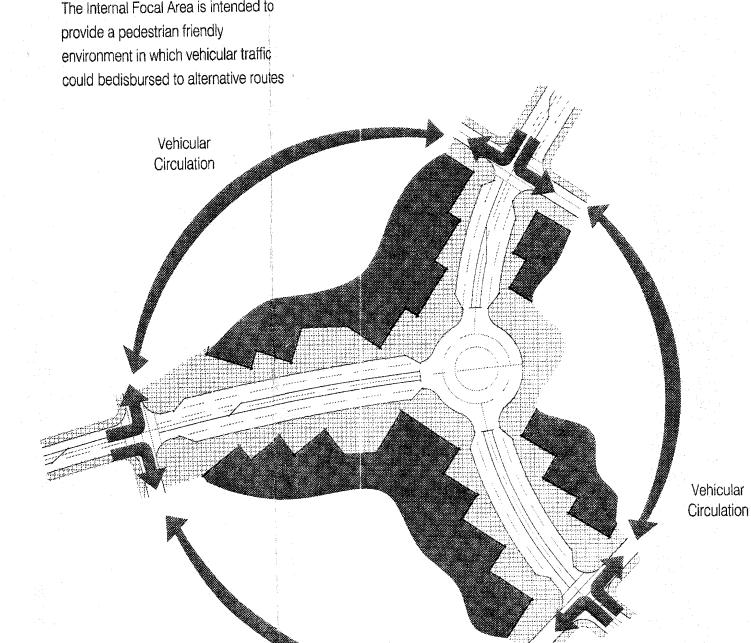


Figure F: Alternative Traffic Circulation

Building Setbacks

Circulation

The following setback requirements serve to create a variety of pedestrian experiences: an urban formal experience throughout the Commercial / Retail tracts; and an informal experience throughout the Office / Multi-family Residential

Standards


- All building setbacks shall be compliant with the C-3 zoning requirements provided in the City of Albuquerque Comprehensive City Zoning Code and the following:
- Building setbacks adjacent to Fountain Hills Boulevard (Nunzio Avenue) and Fountain Hills Parkway within the Internal Focal Area shall be a minimum of 15 feet and a maximum of 20 feet from the property line to produce an urban streetscape. Building overhangs, pate walls, and patios / plazas and other private amenities intended for use by patrons shall be permitted within this setback to allow for public and/or private nodes for building tenants
- Building setbacks adjacent to Paradise Boulevard shall be a maximum of 85 feet from the property line. The intent is to provide limited off-street parking within this setback, while avoiding large expanses of off-street parking adjacent to the street. Building overhangs, patio walk and patios / plazas shall be permitted within this setback to allow for private and/or public areas.

Public Art

The center of the internal Focal Area shall provide an identifying structure that enhances the design of the development. This structure shall be Public Art, or a Fountain Element to provide an ambiance within the Internal Focal Area.

Standards

- The Identifying Structure shall comply with the City's Zoning Regulations and any applicable City Ordinances.
- The Identifying Structure shall be maintained by the building Owner's (Commercial Owner's Association).

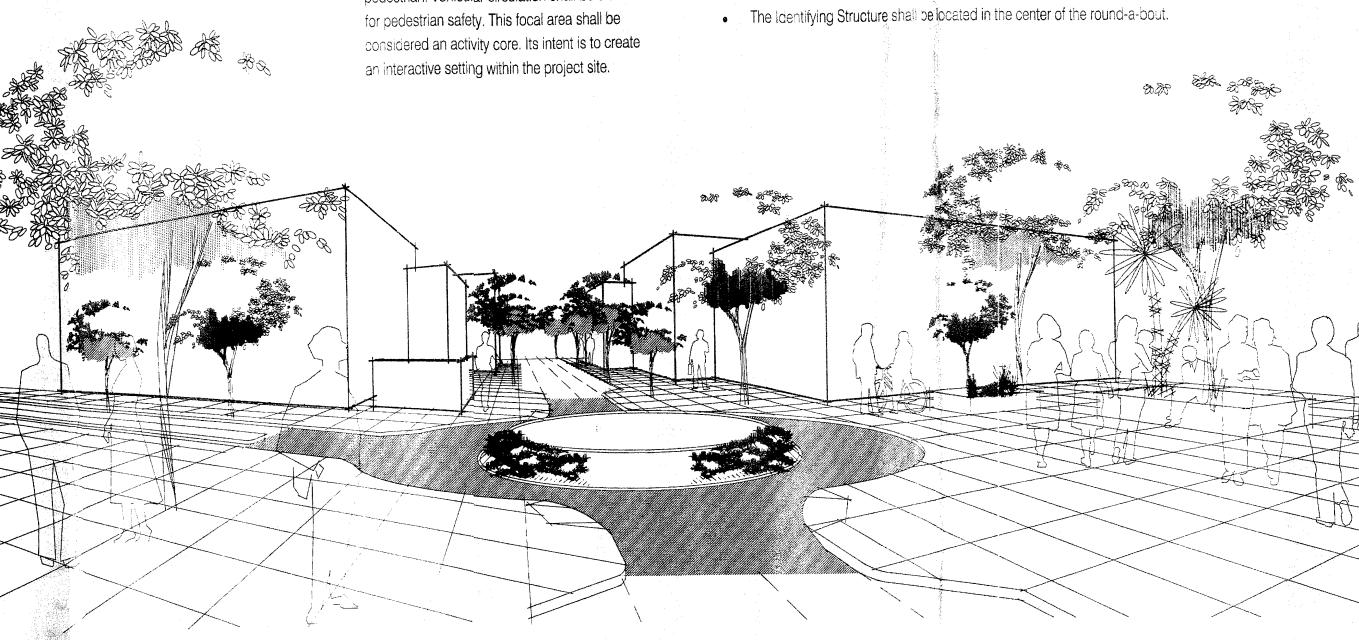



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cp@consensusplanning.com

CANNADY PALACIOS

ARCHITECTURE

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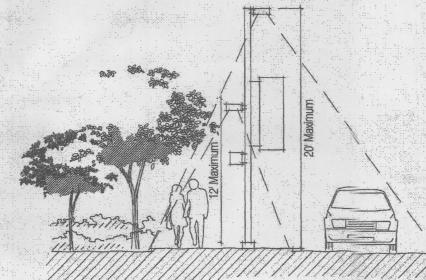
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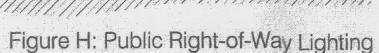
PROJECT ID

Fountain Hills

Site Plan For Subdivision

A2





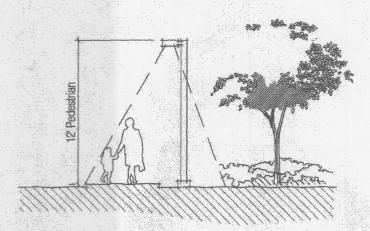


Figure J.: Pedestrian Lighting

Site / Building Lighting

In order to enhance the safety, security, and visual aesthetics, careful consideration must be given to both the daytime and night-time appearance of the lighting design and fixtures. The primary design objective of the site lighting system shall be to maximize public safety while not affecting adjacent properties, buildings, or roadways with unnecessary glare or reflection.

Standards

- All lighting shall comply with Section 14-16-3-9, Area Lighting Regulations of the Comprehensive City Zoning Code.
 Placement of fixtures and standards shall conform to the State of New Mexico Night Sky Protection Act.
- All free-standing lights shall be of a consistent design throughout the site.
- All free-standing lights shall adhere to the detail drawings submitted by this plan.
- Sodium & Cobra lighting shall not be permitted.
- The location of light fixtures shall be identified on subsequent Site Plans for Building Permits.

Site Lighting

Standards

- The height of Street lights and Off-Street Parking area lights shall not exceed 20 feet.
- All lights shall be a shielded source to prevent spillage onto adjoining properties or public right-of-way.

Pedestrian Lighting

Standards

- The height of Pedestrian lighting shall not exceed 12 feet.
- Pedestrian lighting shall conform to all State & Local safety & illumination levels.

Guidelin

- Tree Canopy lighting is encouraged to accent & enhance the pedestrian corridor and the streetscape.
- The use of spread lighting fixtures are encouraged to accent landscape and walkways.

Building Lighting

Standards

 Exterior elevations of any building fronting a street are encouraged to be feature lighted to enhance the identity of the building and accentuate pedestrian circulation.

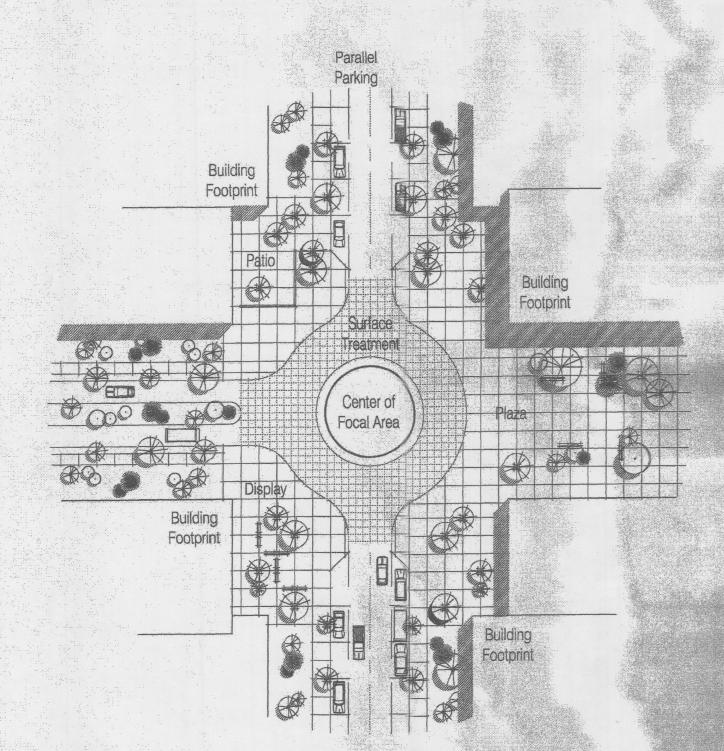


Figure G: Internal Focal Area

Signage & Graphics

Figure I: Parking / Pedestrian Lighting

The following signage and graphic criteria creates a sense of arrival to the development and establishes a quality visual impact. Subdivision signage for this development shall be consistent with Section 14-16-3-5 (C) of the Comprehensive City Zoning Code. Where there is a conflict between these guidelines and the City Regulations, the more restrictive shall apply.

Site Signage

Standards

- All signage shall comply with Section 14-16-3-5, General Sign Regulations of the Comprehensive City Zoning Code.
- Free standing signs shall be designed that do not require any external bracing, angle-iron supports, guy wires or similar devices.
- No signage is allowed that uses moving parts, makes audible sounds, or has blinking or flashing lights.
- Signs shall not overhang into the public right-of-way or extend above the building roof line.
- Off-premise signs and portable signs are prohibited.
- Four Monument Signs shall be provided for the entire development.
- Multi-tenant directory signs shall be provided at access / ingress locations as shown on the site plan. This sign shall be coordinated to have the same appearance (height, size, color, material, text height, style, etc.) at all locations.

avidelines

• Signs which are directly spotlighted may be used provided there is no glare on the street or upon adjacent property or that the light does not distract motorists.


Building Mounted Signage

Standards

- The colors, materials, size of letters & lighting shall be specified for building mounted signs throughout the project
- Building-mounted signage shall identify the name and business of the occupant or of those offering the premises for sale or lease.
- Building-mounted signs shall have a significant contrast between the background and the text in order to ensure readability.
- No building-mounted sign shall intrude upon any architectural features, including windows, columns, moldings or any decorative features.

Landmark

One "landmark" shall be permitted identifying the Commercial Center. This landmark may be a sculpture, tower, etc.
 and shall not exceed a height of 32 feet.

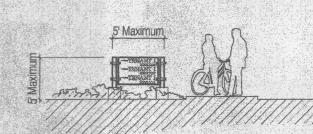

Fountain Hills

Figure K: Multi-Tenant Directory Sign

Figure L: Freestanding Monument Sign



Figure M: Freestanding Monument Sign


Pedestrian Connections & Trails

Pedestrian pathways will depend on creative site design and will be a primary design objective. Objectives to achieve this goal include maintaining a high quality and consistency in style for site amenities including benches, plazas, walkways, lighting, etc: providing shaded walkways; and creating seperate vehicular and pedestrian circulation systems throughout the project.

Pedestrian Connections provide direct access between land uses within the development and to the surrounding neighborhoods. The following criteria serves to create a pedestrian friendly environment and promote alternative modes of travel.

Standards

- All pedestrian paths shall be built to City Standards, per the City's Trail & Bikeways facility plan, as well as in accordance with Section 14-16-3-1(G) of the Zoning Code.
- Pedestrian linkages shall be provided between all tracts affected by this development pursuant to Section 14-16-3-1(G)(3) of the City Zoning Code.
- All soft-surface shall be of a consistent design throughout the entire site, color shall be compatible with the building materials. Material shall be of crusher fines or similar.
- All hard-surface pedestrian sidewalks shall be of a consistent design throughout the entire site, color shall be compatible with the building materials.
- All pedestrian paths shall be designed to be handicapped accessible (see Americans with Disabilities Act Criteria for Barrier-free Design), except where topography makes this unfeasible.
- The use of asphalt paving for pedestrian trails is prohibited. Concrete or compacted decomposed granite with stabilizer are acceptable materials.
- Pedestrian crossings shall be clearly demarcated with special paving treatment where they cross vehicular entrances
 and drive aisles and where City trails cross streets. Such materials shall consist of integrally colored and/or stamped
 concrete, brick forms or pavers of various sizes.
- Pedestrian connections shall be provided to the required bus shelter at Eagle Ranch Road.
- Minimum 6 foot sidewalks shall be provided along public right-of-ways around the perimeter of the development.

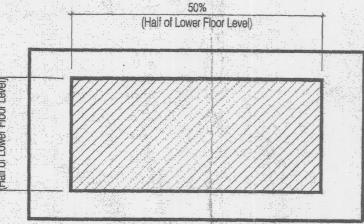

50% Floor Area Below

Note:

The diagrams are for illustrative purposes only. The upper floor mass shall be located anywhere within the lower floor footprint.

Height Summary:

Maximum building height is 3.5 stories per

Council Bill F/S 0-186, Enactment 33-1985.

Allowable building height shall equate to 52

feet (13' + 13' + 13' + 13' of which the top

floor is 50% floor area of the floor below).

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(Half of Lower Floor Level) | The control of the c


Proposed Vertical Building Height Restrictions:


The City of Albuquerque Comprehensive Zoning Code states that SU-1 height requirements shall be regulated by the R-2 zone unless modified by the Planning Commission (14-16-2-22 (D). The R-2 zone states "the height and width of the structure over 26 feet shall fall within 45° angle planes drawn from the horizontal at the mean grade along each internal boundary of the premises....".

In defining a Half-Story, the definition from the Dictionary of Architecture & Construction is used, which describes a half-story as "A story within a sloping roof; usually having dormer windows and occupying about half the area of the floor or floors below". Through this definition, the top floor area is limited to this ratio of 50% of the floor area below. This massing enhances the Architectural Expression and minimizes the massing of the highest floor.

The City Zoning Code does not establish a physical height for a "story" within a building. The City's Zoning Code does establish a 26 foot height limitation in various zones. Common architectural practice can design 2 stories within this 26 foot height. Therefore, 1 story is interpreted as being 13 feet in height. 4 stories is interpreted as 52 feet measured from Finished Floor elevation to the Heighest point of the building.

Figure H: Pedestrian Corridor Plan

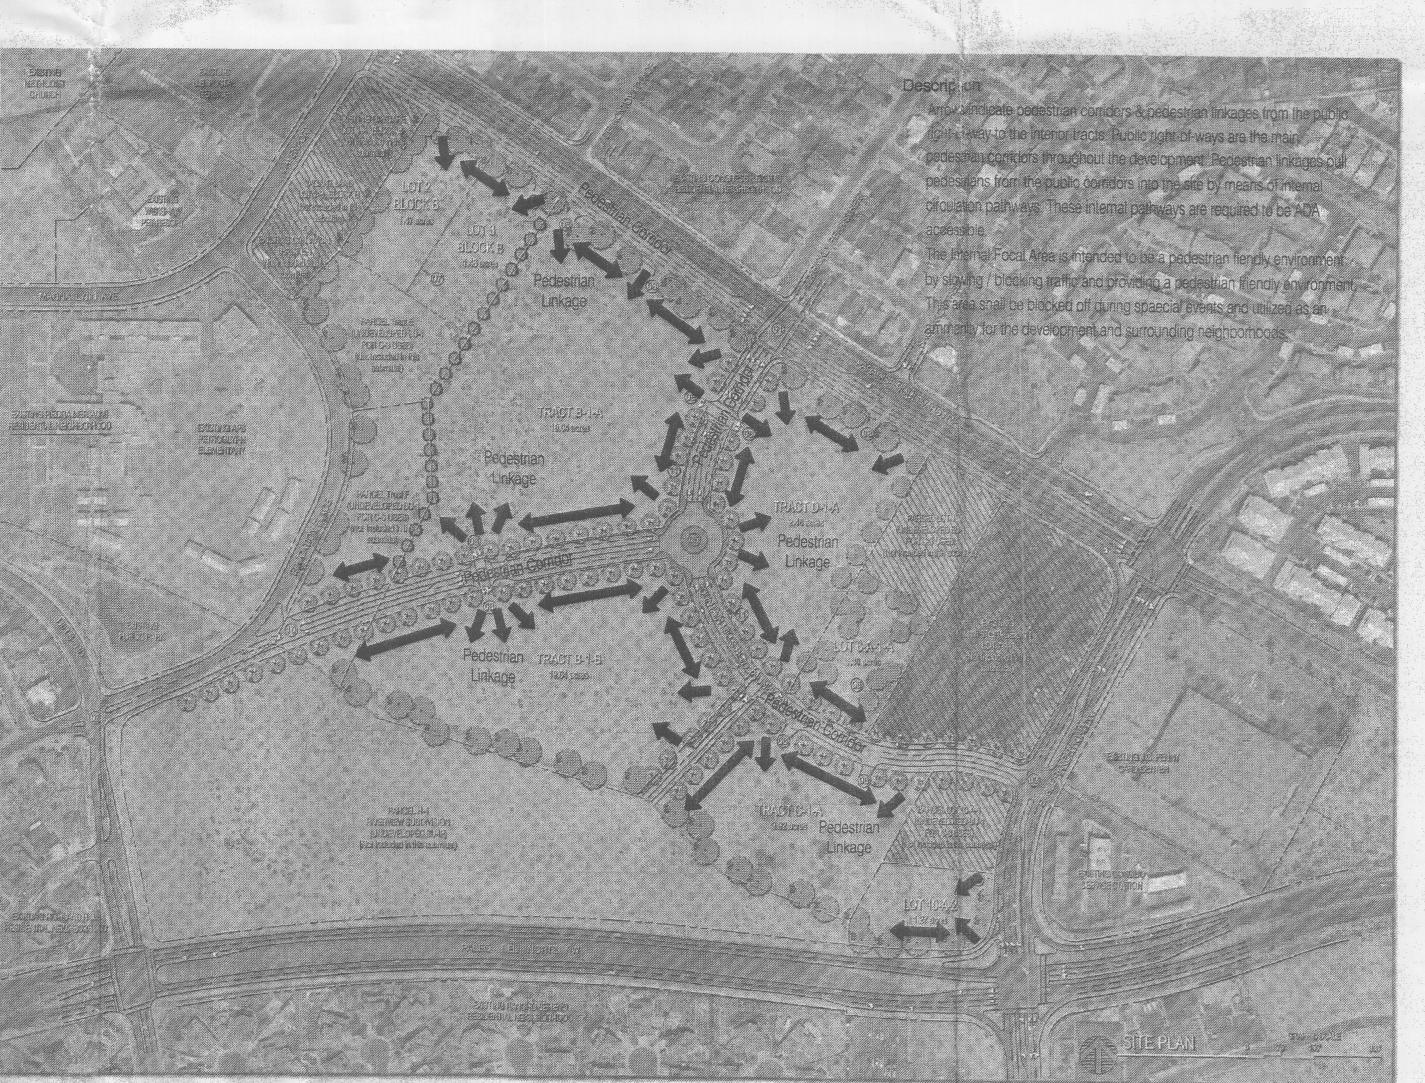

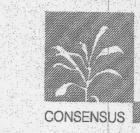

Consensus Planning

DEVELOPER

EPC SUBMITTAL

DATE ISSUED

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Site Plan For Subdivision

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nitectural Expression

All development shall comply with General Building & Site Regulations of the City Zoning Code (14-16-3-18).

The Architectural Expression is to incorporate traditional Southwestern Characteristics with a Contemporary Southwestern Expression. In order to achieve this effect, the following concepts shall be expressed:

- Massing of building facades shall be varied in height, width & depth.
- All buildings shall consist of 'flat roofs' with perimeter parapets.
- Main Entrances & Glass Display Areas adjacent to the public right-of-way shall be recessed a minimum of 12" to create a sense of depth and mass.
- Soft rounded corners and tapered parapets shall be prohibited.

Building Form

Standards

- Building elements within the commercial tracts such as glazing, displays and entries shall be oriented both externally to the streetscape and internally towards public parking in order to promote an urban pedestrian experience.
- Buildings shall employ a variety of structural forms to create visual character and interest. Long, unarticulated facades shall be avoided. Facades shall have varied front setbacks, with wall planes not running in one continuous direction without a change in architectural treatment (i.e. offset, fenestration, material change, etc.).
- Restaurants, if proposed by subsequent Site Plans for Building Permits, shall provide outdoor patios and shall be shaded by trees and/or a shade structure that is architecturally integrated with the buildings theme. These spaces shall be a minimum of 100 square feet.

Guidelines

- It is encouraged to produce sloped/pitched roofs that overhang entry points, fenestration, and patios/plazas in order to provide shelter for the users.
- Columns, arcades, corner articulation, overhangs, awnings, marquees, gutters and scuppers, breezeways and soffits shall be carefully dimensioned and detailed to provide a human scale and visual interest.
- It is encouraged to include trellis, awnings, etc. over pedestrian circulation to enhance the urban environment.
- Public areas from Multi-Family Residential & Service uses, such as balconies and patios, shall be oriented and relate to pedestrian streets and pathways.
- It is encouraged to articulate Residential entryways with low walls, gateways and garden courts.

Building Materials

Standards

- The predominant Building Material shall be stucco. Reveals shall be incorporated to be functional as well as aesthetic enhancements.
- Materials used to enhance the predominant building materials shall be: Integrally Colored Concrete, Stacked Stone, Architectural Finished CMU, or similar. These materials will enhance entry points and add character to the building facades.
- Materials prohibited as the main architectural feature include the following: Exposed Grey Concrete, Natural Grey Cmu Block, Traditional Red Brick, Corrugated Metal Siding.
- All Glazing shall be of the same material & color on all buildings to create a cohesive theme. Reflective & Patterned glazing shall be prohibited.
- The predominant Portal Material shall be clay tile and/or Metal Roofing. Awnings & Portals shall utilize Metal Roofing, Fabric, etc.
- Trellis shall consist of Painted Metal, Sealed / Stained Wood, etc. and shall be consistent with the character of the building facades.

Building Colors

Standards

- Predominant building field colors shall be of Natural Earthtones unique to the desert landscape, and shall include light to medium tones.
- Accent colors shall enhance building functions and articulate entry points and/or points of interest. These colors shall be deeper shades of color. No more than 3 accent colors shall be used on any building.

- The use of contrasting colors between roofs and walls is encouraged to further differentiate the planes of building
- It is encouraged to differentiate building masses by color variations or texture changes. Recesses and punch-outs may be differentiated by tone, as well as change in material
- Accented colors should bring out detailing to better articulate or give scale to a building mass. Accent colors at stairs, balconies and perimeter walls should be compatible with building materials.

Accessory Materials

Standards

- Railings defining Patio / Plaza space shall be of Lightweight Railing Systems. These are intended to define the semi-public space from the public space.
- Walls defining Patio / Plaza space shall be consistent with building materials.

Perimeter Walls / Fencing

The effective use of screening devices for parking lots, loading areas, refuse collection, and delivery / storage areas is essential to limit their adverse visual impact on the property. The site orientation of these elements shall be away from any street or pedestrian area. The standards established in the landscape and setback sections will provide the main objective to screening unattractive elements and activities.

- All walls including screen walls, perimeter walls and retaining walls shall be similar in materials and color of building. elements, to create a cohesive theme.
- Materials acceptable for screen walls, perimtere walls and retaining walls are Integrally colored concrete or concrete masonry and shall be finished to match adjacent exterior buildings.
- The maximum height of perimeter walls and retaining walls is 8 feet. Areas requiring greater retainage are required to be terraced and landscaped.
- Unfinished block walls and barbed wire, chain link, concertina wire, and plastic / vinyl fencing are prohibited.


Screening

Standards

- Parking areas shall be screened with landscaping and/or walls. The screen walls for parking areas shall be of the same material & color as the perimeter & retaining walls for the entire site. Such screening shall have a minimum height of 3 feet.
- All outdoor refuse containers shall be screened within a minimum 6 foot tall enclosure which is large enough to contain all trash generated between collections. Trash enclosures shall be consistent with the architectural theme and materials of adjacent buildings.
- All mechanical equipment shall meet the screening requirements of Section 14-16-3-18(C)(5) of the Comprehensive City Zoning Code. All mechanical equipment shall be screened from public view by materials of the same nature as the adjacent buildings.
- All roof-mounted mechanical equipment shall be screened on all sides by a screen wall. The screen wall shall be placed immediately adjacent to the mechanical equipment.

Walls / Fencing

- Walls and fences shall comply with Section 14-16-3-19, General Height & Design Regulations for Walls, Fences, and
- Perimeter walls shall include pedestrian openings at key locations within the development to ensure convenient access to other tracts within the development.
- Private Secure areas shall have a fence not less that 6 feet high for privacy and security. The material and finish shall be similar in materials and color to create a cohesive theme. Wrought Iron and/or Steel Framed elements are acceptable provided they are similar in materials and color of building elements, to create a cohesive theme.

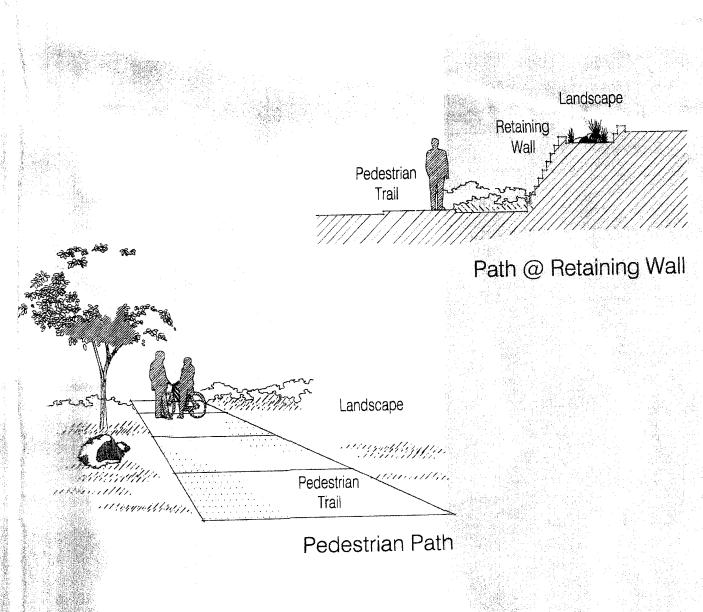

The landscape environment serves to enhance the visual dynamic of the development and aid in reinforcing the street edge and the pedestrian environment. The intent is to provide for year-round color and interest, and reflect the natural beauty of New Mexico. Landscape elements, such as street furniture, lighting, bollards, and graphic pylons shall be used to reinforce the street edge. The intent is to provide a clear theme and image for the development, by suggesting consistent paving materials, plantings, signage, etc.

- Landscape plans must comply with the City's Water Conservation Ordinance and Pollen Ordinance.
- A minimum of 20% of the site area (minus building square footage) shall be devoted to landscape materials.
- A mixture of drought tolerant species and lawn areas shall be used at landscape areas. Live plant materials shall cover a minimum of 75% of all landscaped areas.
- Landscape headers shall be used to separate turf and planting beds. Headers may be concrete, brick, or other similar material.

- Gravel, mulch, cobble, bark, and other similar materials are acceptable as a top dressing for landscape areas, however, they are not to be considered a focal landscape element. Gravel shall be 1-1/2" maximum, the color is to be compatible with the Soft-Surface paths selection.
- An automatic underground irrigation system is required to support all site landscaping. The system shall be designed to avoid over-spraying onto walks, buildings, fences, etc. Irrigation components shall be checked periodically to ensure maximum efficiency.
- All plant material shall be maintained by the Owner in a living, attractive condition. All areas shall be maintained free
- Minimum plant material sizes at the time of installation shall be as follows:

- 2" Caliper balled & burlapped Canopy Trees 10' Minimum Height Evergreen Trees 1-1/2" Caliper balled & burlapped Accent Trees 1 Gallon Minimum Shrubs & Groundcovers

- Low water use turf shall be provided at a maximum of 40% of the landscape area. High water use turf, if used, shall be limited to no greater than 20% of the provided landscape area.
- Street trees shall be provided as per the Street Tree Ordinance (6-6-2-1 et seq., Street Trees)
- Fountain Hills Boulevard (Nunzio Avenue) & Fountain Hills Parkway are proposed pedestrian corridors, providing circulation throughout the varous tracts. These street trees shall be regularly placed to enhance the streetscape and provide a sense of the urban environment and shall include the following or similar trees:
 - Chilopsis linearis 'Lucretia Hamilton' / Desert Willow
 - Chitalpa tashkentensis 'Pink Dawn' / Chitalpa
 - Fraxinus oxycarpa 'Raywood' / Raywood Ash
- The perimeter of the site shall consist of randomly placed street trees providing a buffer to surrounding neighborhoods. These street trees shall consist of the following or similar trees:
 - Pyrus calleryana 'Cleveland' / Flowering Pear Robinia ambigua / Purple Robe Locust
 - Crataegus crus-galli / Cockspur Hawthorn
 - Fraxinus velutina 'Modesto' / Modesto Ash
- 75% of the required parking areas trees shall be deciduous and have a mature height and canopy of at least 25

Internal Focal Area

- Landscaping shall not be provided as a continuous buffer strip for the sides of lots immediately adjacent to Fountain Hills Boulevard & Fountain Hills Parkway within the Internal Focal Area. This standard does not preclude the provision of landscaping within the Internal Focal Area.
- Landscaping shall be provided randomly to accent the pedestrian corridor and provide a buffer between public / private areas.
- Street trees shall be provided within tree wells at regularly spaced intervals to reinforce the street edge and the pedestrian corridor. The tree well shall be a minimum of 36 square feet. Trees shall be spaced 20-25 feet on center.
- In addition to Paradise Boulevard, Eagle Ranch Road & Paseo Del Norte, street trees shall also be required along the entire length of the proposed local public streets (Fountain Hills Boulevard & Fountain Hills Parkway) in accordance with the provisions of the City of Albuquerque Street Tree Ordinance (6-6-2-1).
- Accent plans shall be provided to enhance the environment within this node. The palette in the Internal Focal Area shall consist of the following or similar plants:
- Shrubs / Groundcovers
- Artemisia Powis Castle! / Powis Castle Sage
- Caryopteris clandonensis / Blue Mist - Cytisus x lena! / Lena's Broom
- Lagerstromia indica / Crape Myrtle
- Liatris purctata / Gayfeather
- Potential tuticosa / Shrubby Cinquefoil
- Salvia greggii / Cherry Sage Zauschneia arizonica / Hummingbird Trumpet
- Ornanental Grasses
- Nassella tunuissima / Threadgrass
- Nolina mirrocarpa / Bear Grass - Agave ha ardiana / Harvard's Century Plant
- Dasylirionwheeleri / Sotol
- Hesperake parviflora / Red/Yellow Flowering Yucca

Irrigation Systen

- The irrigation sistem serving the streetscape and other common areas shall be a fully automated systems with a centralized conputer controls. Irrigation components shall be selected for use with non-potable water sources to allow for future connection to potential treated water systems. Backflow prevention shall be provided per local codes to protect the potable water system from the irrigation system.
- Turf areas shallbe irrigated with pop-up rotary sprinklers with high efficiency nozzles. Trees, shrubs and groundcovers shall be irrigated with a combination of hard pipe and poly pipe feeding single and multi-outlet drip emitters. The entire irrigation system shall be designed to maximize water efficiency.

Landscape Mantenance

The landscape for he streetscape and common areas shall be designed to require minimal levels of maintenance. Plant materials shall be rative or adapted to the region, requiring minimal water and maintenance. All plantings and landscape elements Maintenance, such as benches, litter receptacles, signs, etc., within these areas shall be responsibility of the building Owners.

Site Topography

The existing topography consists of approximately 80 feet of vertical drop from West to East. Retaining walls shall be required in several locations to provide acceptable pad sites & parking. The intent for clustering of buildings as well as parking nodes will help mediate the retainage required and allow for a stepping of the overall site.

- Avoid long unarticulated expanses of retaining wall. Walls shall have varied setbacks with planes not running in one continuous direction without a change in height and setback.
- Retaining walls that are not screened by buildings or landscaping shall employ a variety of patterns and colors to create visual character and interest.
- Trails and paths shall be integrated into retaining wall locations where applicable to allow for pedestrians access to both elevations adjacent to the retaining wall.

Grading & Drainage

The existing site topography slopes from the West to the East at approx. 3% - 5% slope. There is a steep embankment from Education's Place as well as a steep drop to Eagle Ranch Road. The site takes on 2 off-site drainage flows from natural swales. Drainage from Paradise Boulevard is transported to an existing AMAFCA retention pond located within the site boundaries. Off-site drainage from Education Boulevard is transported through a drainage channel that runs along the southern property line of the project site and outfalls into the same AMAFCA pond.

The AMAFCA pond site currently houses a standpipe that allows for discharge of drainage into the existing storm drainage system located in Paradise Boulevard / Eagle Ranch. This discharge is controlled at a rate of 56 cubic feet per second. Discharge shall be restricted to the existing 30" storm drain system and the existing standpipe located in the

Standards

- Site ponding shall be integral with the lancscape plan.
- All measures shall be taken to provide public safety at the pond location.
- Grading & Drainage plans must comply with the City of Albuquerque regulations and ordinances.
- The AMAFCA pond shall be considered an opportunity to provide a public amenity when not in use for drainage

Site Utilities

To ensure the overall aesthetic quality of the property and the natural environmentm the visual impact of utilities and equipment shall be minimized by the following:

- All new electric distribution lines shall be placed underground.
- Transformers, utility pads, and telephone boxes shall be appropriately screened with walls and/or vegetation when viewed from public right-of-way.
- When an above-ground backflow prevention device is required by the City of Albuquerque, the heated enclosure shall be constructed of materials compatible with the architectural materials used as the main element of the building. If pre-fabricated fiberglass enclosures are used, they shall be appropriately screened from view by walls and/or
- Alleys shall be used for dry utilities and sewer, whenever possible
- Utility easements shall be a minimum of 7.5 feet in width and may be spot easements instead of continuous easements for above ground structures.

Existing Conditions:

- There are no utilities currently located in Fountain Hills Boulevard (Nunzio Avenue) due to street being unbuilt.
- There is a regional electrical service easement down the center of Tract B-1-A that will need to be addressed. Developers shall be required to work with PNM on this issue.
- Fire flows and hydrant locations shall be reviewed and approved at the site plan for building permit stage.



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PROJECT ID

Fountain Hills

> Site Plan For Subdivision