

GENERAL NOTES

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[B] ALL WATER METERS & WATERS SERVICE SYSTEMS SHALL BE INSTALLED AS PER C.O.A. UITLITY DEVELOPMENT STANDARDS & REQUIREMENTS.

[C] ALL SEWER, WATER & GAS PIPING SYSTEMS SHALL BE INSTALLED AS PER '97 MECHANICAL CODE REQUIREMENTS.

[D] P.N.M. SHALL PROVIDE PRIMARY ELECTRIC SERVICE & TRANSFORMER AS WELL AS GAS PIPE TO BUILDING SERVICE METERS

KEYED NOTES

[1] EXISTING VACANT WATER METER BOX WITH 1-1/2" SERVICE CAPACITY, PROVIDE ONE CITY WATER METER.

[2] FIND EXISTING 6" SEWER STUB INSIDE LOT LINE. SEE C.O.A. AS-BUILT DATABASE FOR COMPLETE INVERT INFORMATION.

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[4] EXTEND 1 1/2" WATER SERVIVE MAIN TO RISER & PROVIDE GATE VALVE INSIDE BUILDING SUITE. SEE TENANT FLOOR PLANS FOR RISER & GATE VALVE LOCATION.

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[6] PROVIDE DOUBLE CLEANOUT AT SEWERLINE EXIT FROM BUILDING, SET AT FINISH GRADE WITH 8" MIN. CONCRETE APRON.

[7] GAS METER LOCATION. PROVIDE 2 METERS, ONE SYSTEM FOR EACH OF TWO SUITES. EXTEND GAS PIPE THROUGH WALL AT METER AND ROUTE WITHIN WALL FRAME OR CLOSET TO ROOFTOP. LOCATE DISTRIBUTION PIPE LINES INSIDE OF MECHANICAL SCREEN BOUNDARY. GAS PIPE SIZE AS PER MECHANICAL CONTRACTOR.

[8] ELECTRIC & TELEPHONE EXTERIOR EQUIPMENT LOCATION. EXTEND ALL DISTRIBUTION CONDUIT BELOW SLAB TO INTERIOR SUITE PANELS.

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Journal Center 2
7430 Washingto

SHEET TITLE:
SITE UTILITIES PLAN

ов NUMBER 0348

DATE:

5/12/04

REVISIONS: DATE:


A.R.C. PHASE 1 3/26/04

A.R.C. PHASE 2 4/28/04

DRB 5/12/04

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Planning

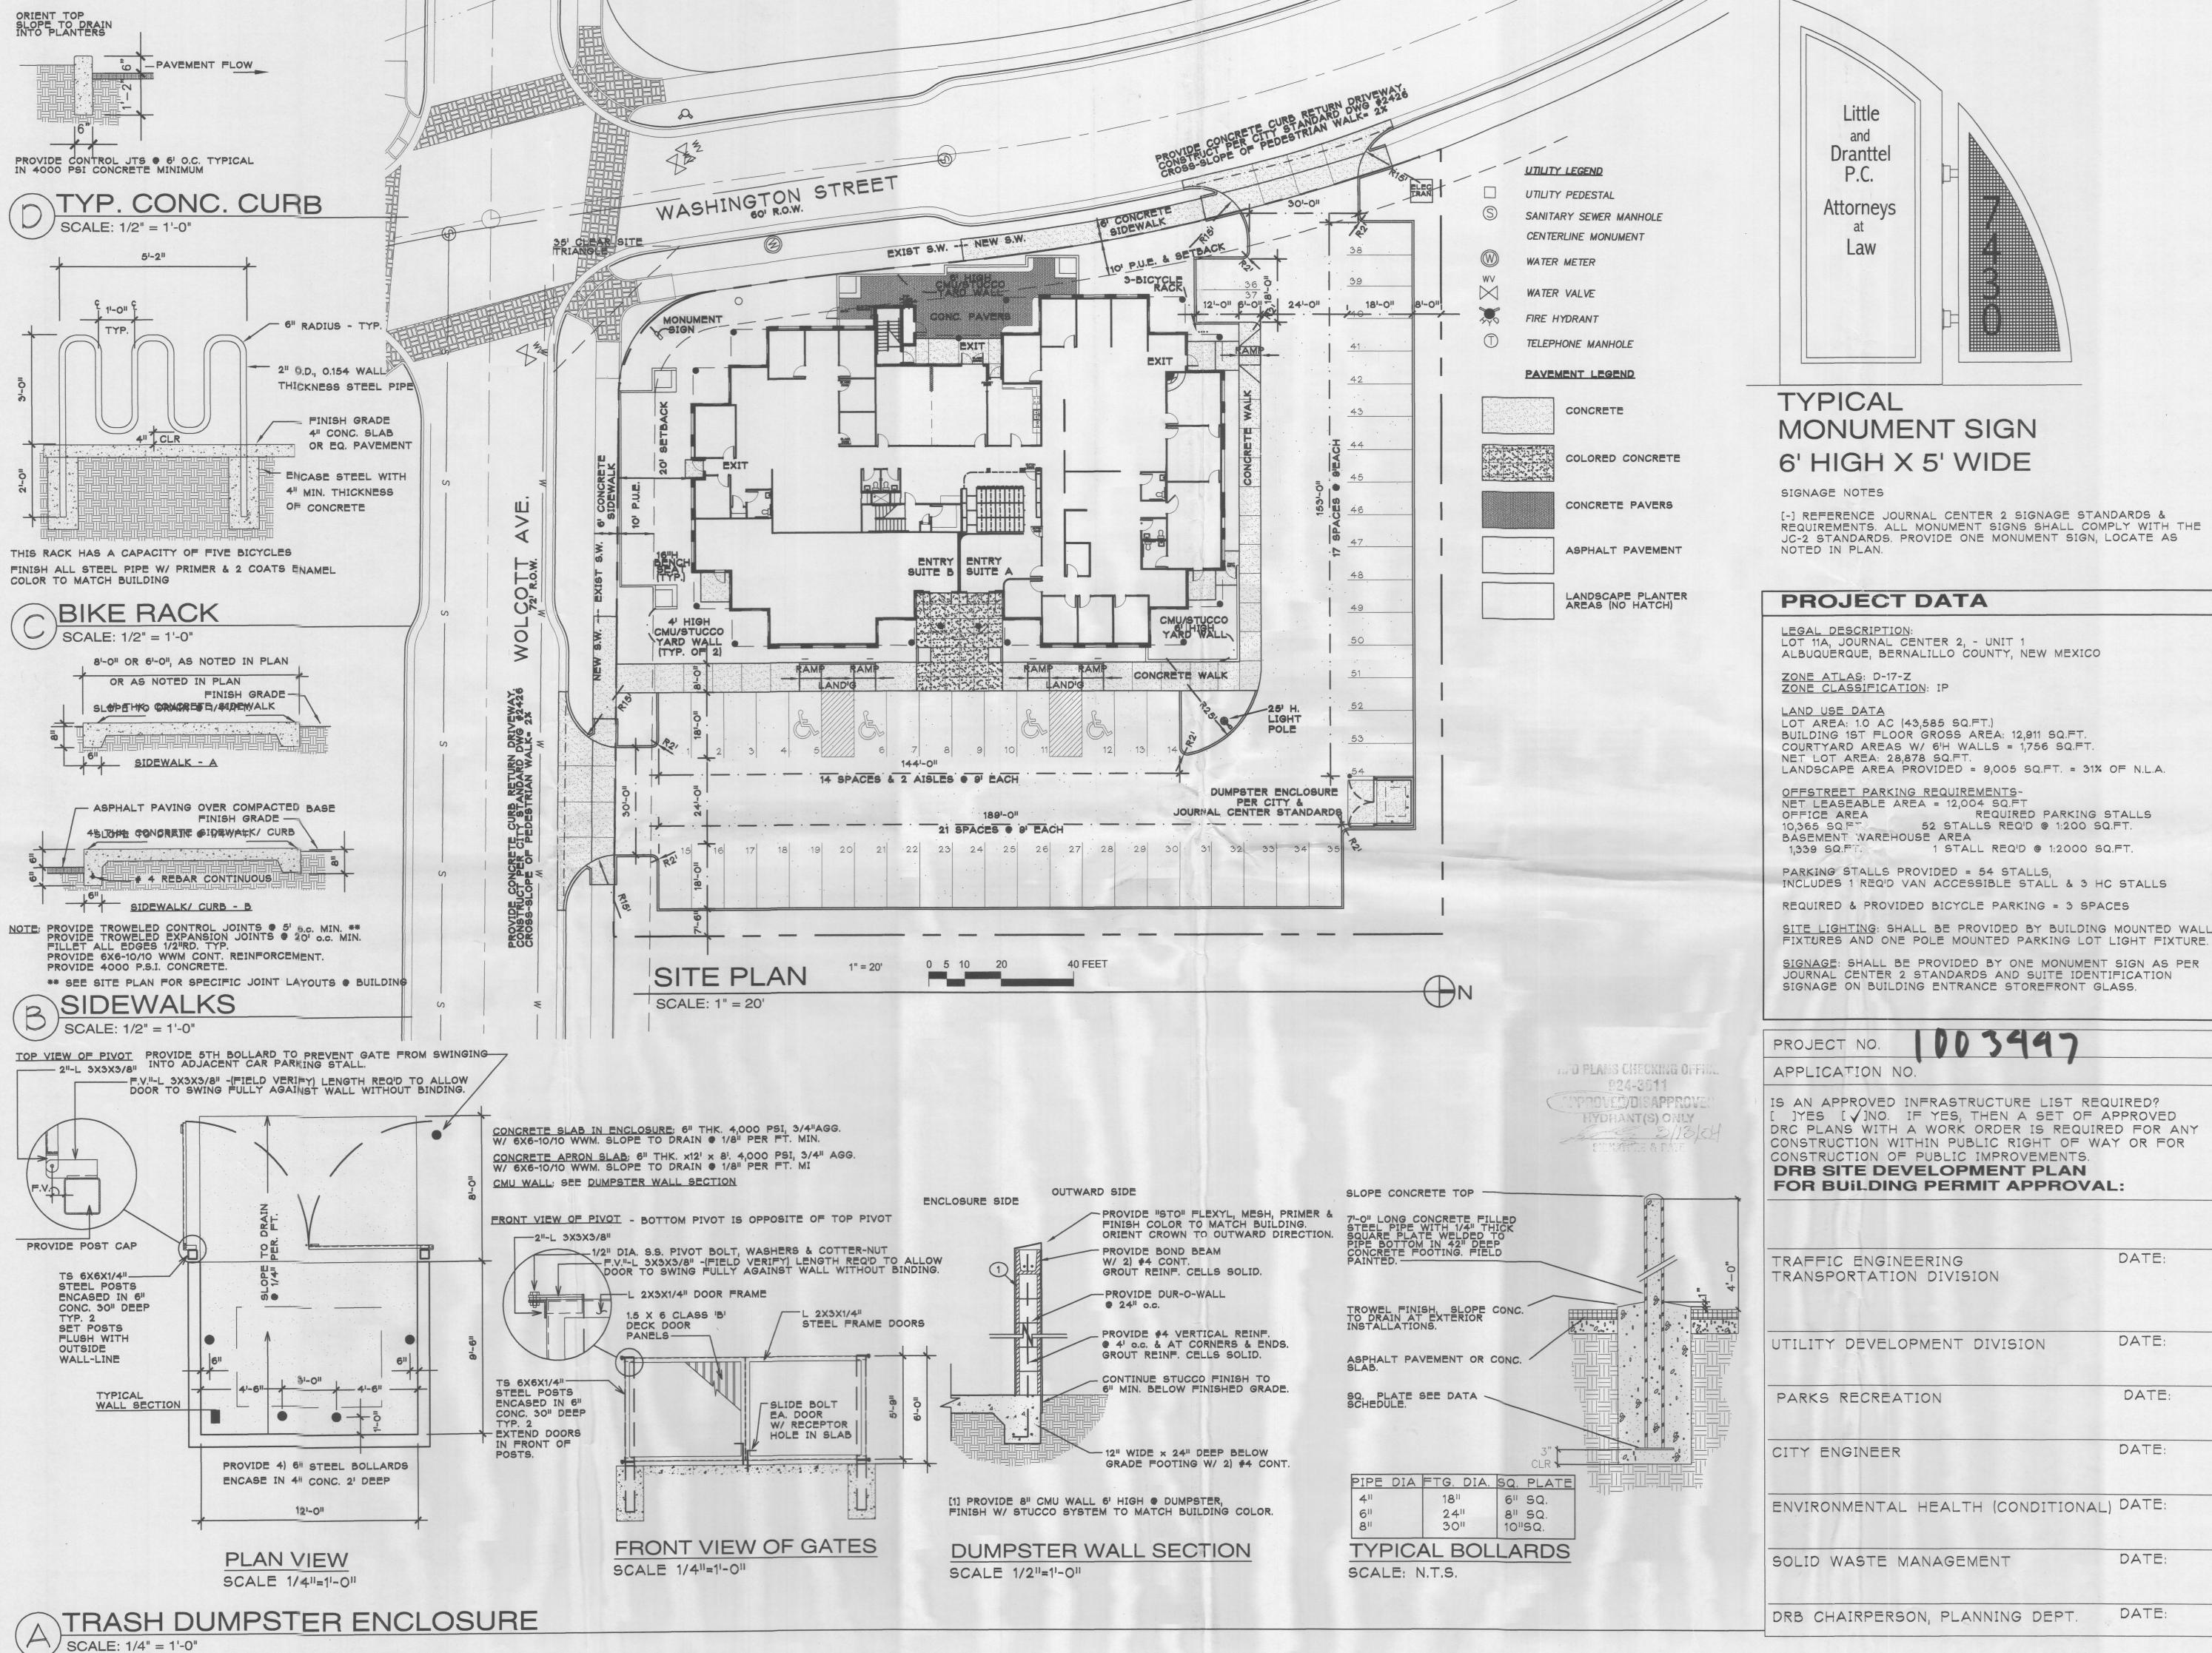

MONUMENT SIGN 6' HIGH X 5' WIDE

[-] REFERENCE JOURNAL CENTER 2 SIGNAGE STANDARDS & REQUIREMENTS. ALL MONUMENT SIGNS SHALL COMPLY WITH THE JC-2 STANDARDS. PROVIDE ONE MONUMENT SIGN, LOCATE AS

LEGAL DESCRIPTION:
LOT 11A, JOURNAL CENTER 2, - UNIT 1
ALBUQUERQUE, BERNALILLO COUNTY, NEW MEXICO

LOT AREA: 1.0 AC (43,585 SQ.FT.) BUILDING 1ST FLOOR GROSS AREA: 12,911 SQ.FT. COURTYARD AREAS W/ 6'H WALLS = 1,756 SQ.FT.

NET LOT AREA: 28,878 SQ.FT. LANDSCAPE AREA PROVIDED = 9,005 SQ.FT. = 31% OF N.L.A.

REQUIRED PARKING STALLS

52 STALLS REQID @ 1:200 SQ.FT. 1 STALL REQ'D @ 1:2000 SQ.FT

INCLUDES 1 REQ'D VAN ACCESSIBLE STALL & 3 HC STALLS

REQUIRED & PROVIDED BICYCLE PARKING = 3 SPACES

SIGNAGE: SHALL BE PROVIDED BY ONE MONUMENT SIGN AS PER

JOURNAL CENTER 2 STANDARDS AND SUITE IDENTIFICATION SIGNAGE ON BUILDING ENTRANCE STOREFRONT GLASS.

IS AN APPROVED INFRASTRUCTURE LIST REQUIRED?]YES [✓]NO. IF YES, THEN A SET OF APPROVED DRC PLANS WITH A WORK ORDER IS REQUIRED FOR ANY CONSTRUCTION WITHIN PUBLIC RIGHT OF WAY OR FOR CONSTRUCTION OF PUBLIC IMPROVEMENTS DRB SITE DEVELOPMENT PLAN

FOR BUILDING PERMIT APPROVAL:

TRANSPORTATION DIVISION

DATE:

DATE:

DATE:

DATE:

SOLID WASTE MANAGEMENT

DATE:

DATE:

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SITE PLAN

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5/12/04


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A.R.C. PHASE 1 3/26/04

DATE:

4/28/04

5/12/04

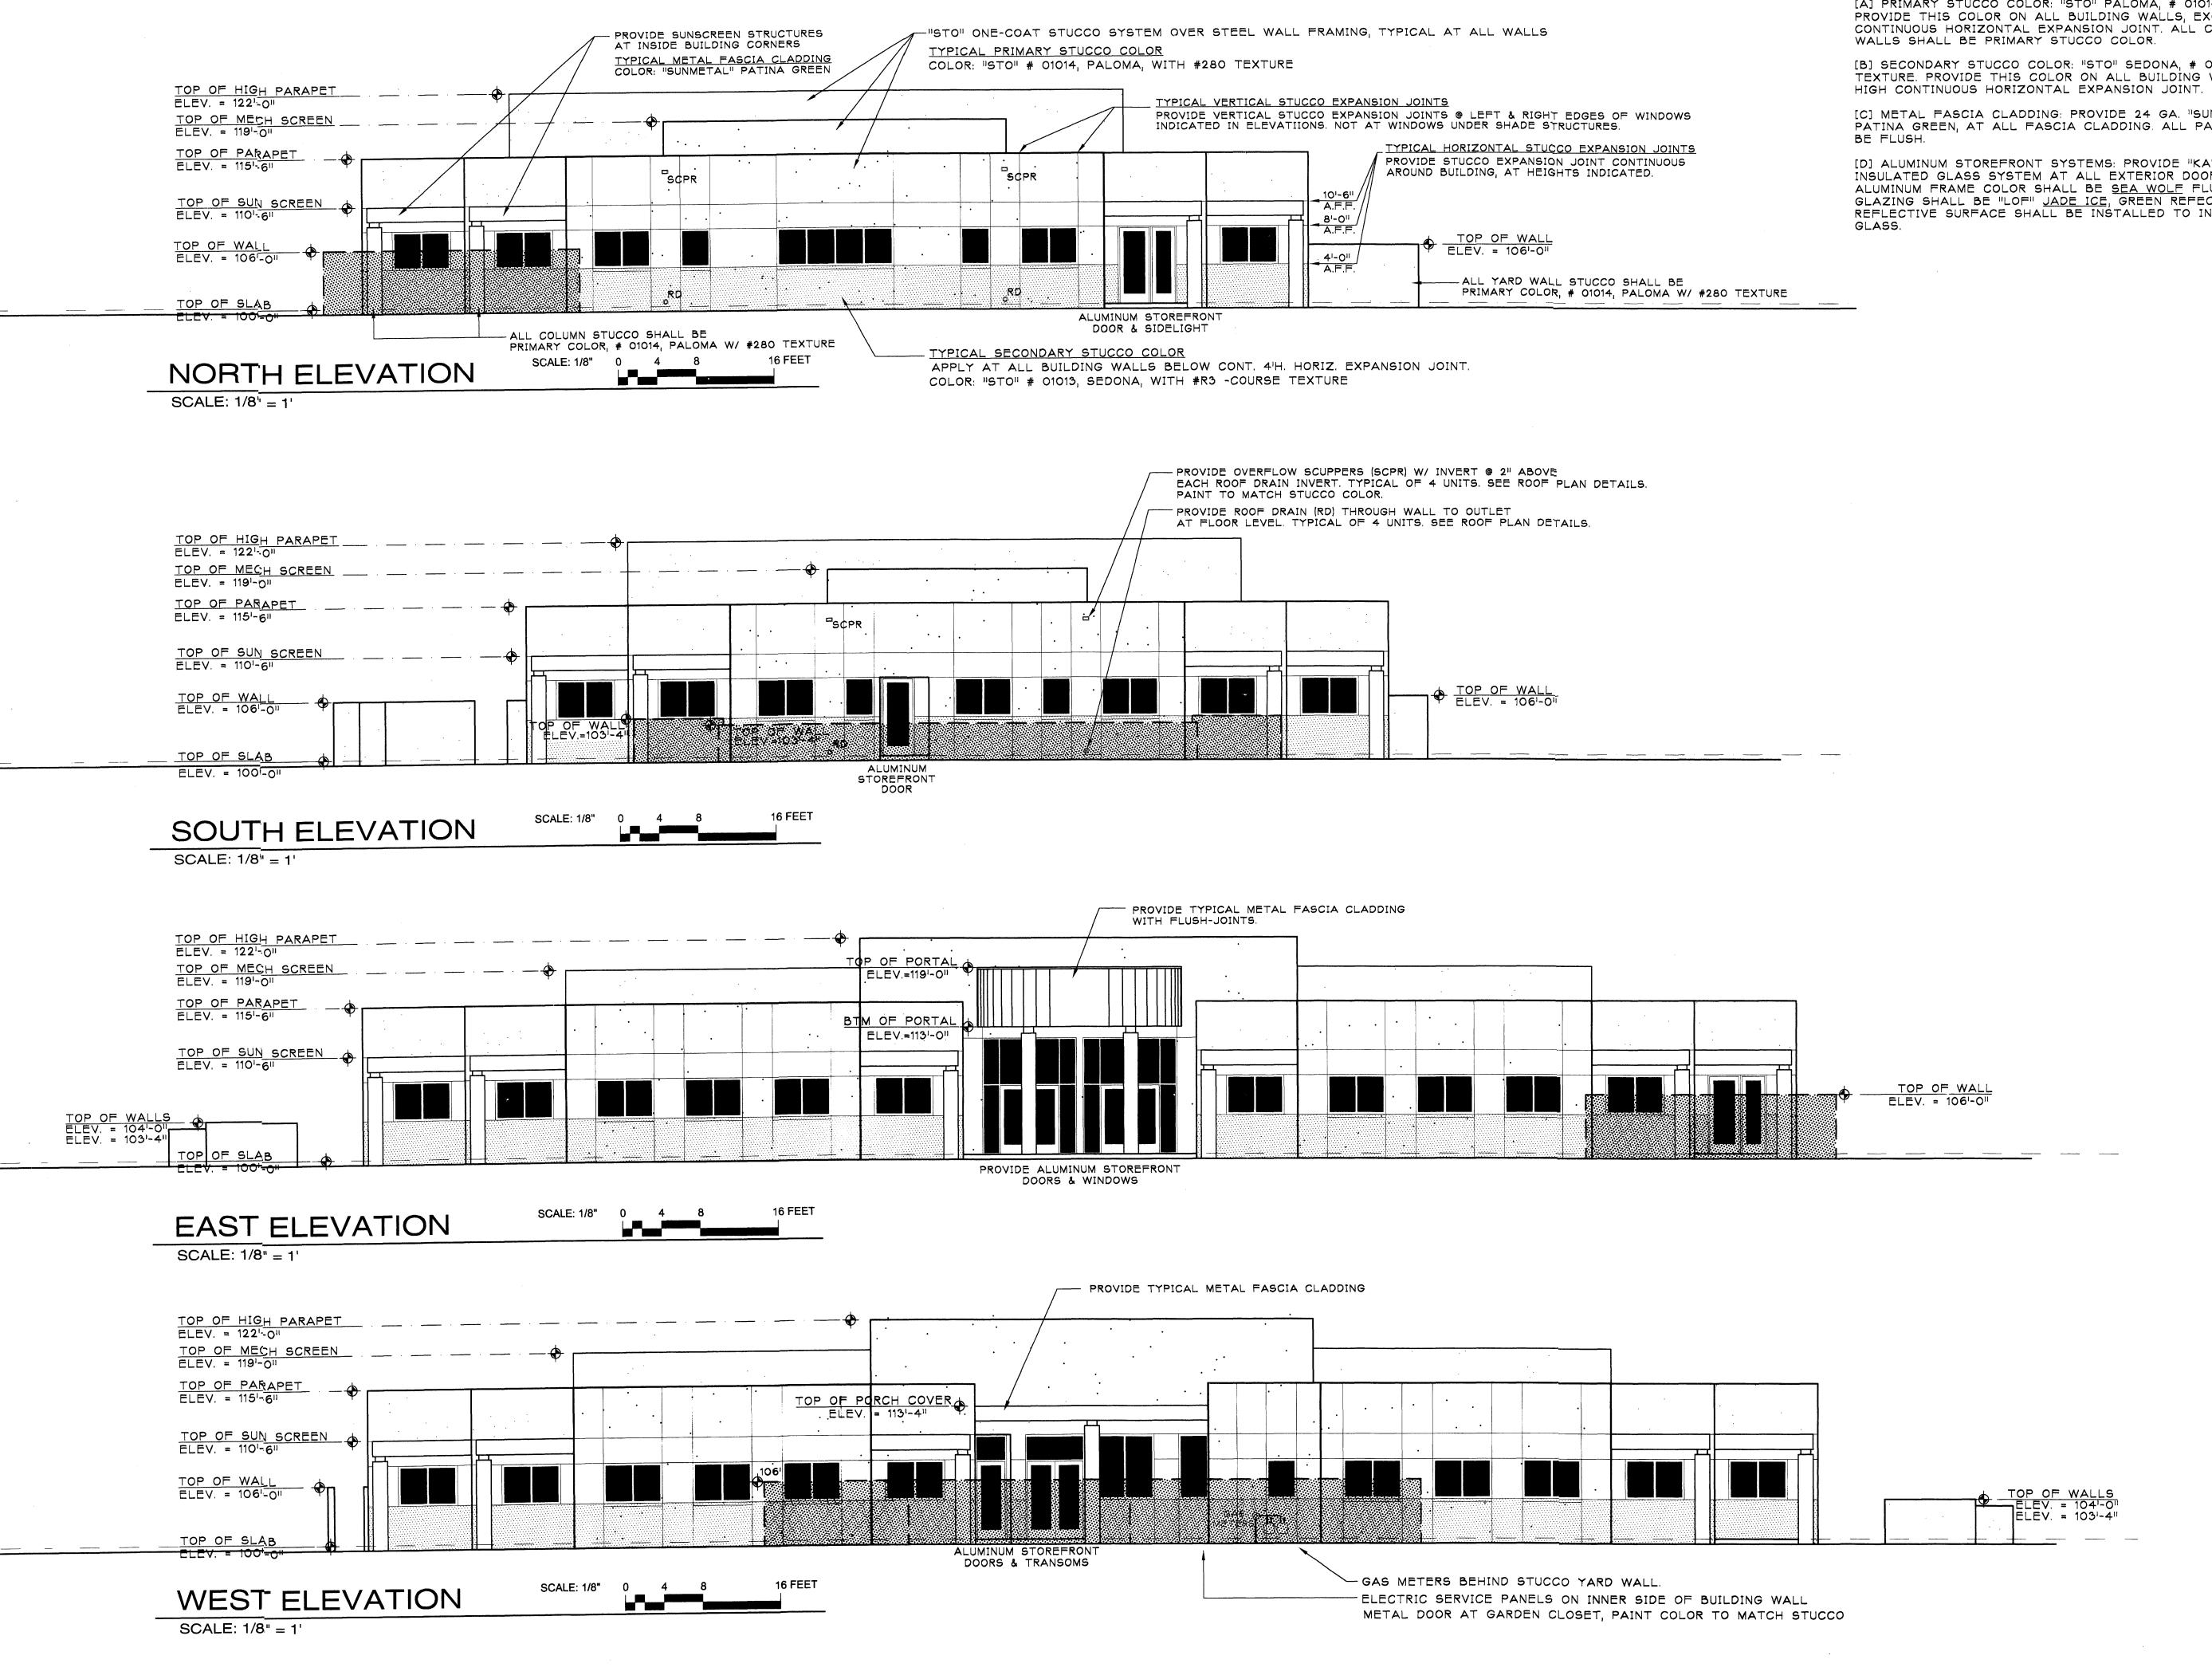

GENERAL NOTES

TYPICAL BUILDING MATERIALS & COLORS ARE AS FOLLOWS:

[A] PRIMARY STUCCO COLOR: "STO" PALOMA, # 01014, W/ 280 TEXTURE. PROVIDE THIS COLOR ON ALL BUILDING WALLS, EXCEPT BELOW 4' HIGH CONTINUOUS HORIZONTAL EXPANSION JOINT, ALL COLUMNS & YARD

[B] SECONDARY STUCCO COLOR: "STO" SEDONA, # 01013, W/ R3-COURSE TEXTURE PROVIDE THIS COLOR ON ALL BUILDING WALLS BELOW THE 4'

[C] METAL FASCIA CLADDING: PROVIDE 24 GA. "SUNMETAL", COLOR: PATINA GREEN, AT ALL FASCIA CLADDING. ALL PANEL JOINTS SHALL

[D] ALUMINUM STOREFRONT SYSTEMS: PROVIDE "KAWNEER" TRIFAB VG451 INSULATED GLASS SYSTEM AT ALL EXTERIOR DOORS & WINDOWS. ALUMINUM FRAME COLOR SHALL BE <u>SEA WOLF</u> FLUROPON FINISH. ALL GLAZING SHALL BE "LOF" <u>JADE ICE</u>, GREEN REFECTIVE GLASS.
REFLECTIVE SURFACE SHALL BE INSTALLED TO INTERIOR SIDE OF GLASS.

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BUILDING **ELEVATIONS**

0348

5/12/04

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A.R.C. PHASE 2	4/28/04
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A-2. 4 OF 30

TOTAL LOT AREA	43179	square	feet
TOTAL BUILDINGS AREA	11465	square	feet
OFFSITE AREA	0	square	feet
NET LOT AREA	31714	square	feet
LANDSCAPE REQUIREMENT	15%		
TOTAL LANDSCAPE REQUIREMENT	T 4757	square	feet
TOTAL BED PROVIDED	8004	square	feet
GROUNDCOVER REQ.	75%	square	feet
TOTAL GROUNDCOVER REQUIREME	NT 6003	square	feet
TOTAL GROUNDCOVER PROVIDED	8004	square	feet
TOTAL SOD PROVIDED	782	square	feet
TOTAL NATIVE SEED PROVIDED	0	square	feet
TOTAL LANDSCAPE PROVIDED	8786	square	feet

STEEL EDGE

SOD

SANTA ANNA TAN GRAVEL WITH FILTER FABRIC

SANTA FE BROWN GRAVEL WITH FILTER FABRIC

EXISTING LANDSCAPING IN SIDEWALK PLANTER, INSTALLED BY JOURNAL CENTER WITH ORIGINAL LOT DEVELOPMENT

FLAGSTONE IN MORTAR

FINAL LANDSCAPING LAYOUT AND DESIGN TO BE DETERMINED UPON RECEIPT OF FINAL GRADING PLAN.

LANDSCAPE NOTES:

Landscape maintenance shall be the responsibility of the Property Owner.

It is the intent of this plan to comply with the City Of Albuquerque Water Conservation Landscaping and Water Waste Ordinance planting restriction approach.

Approval of this plan does not constitute or imply exemption from water waste provisions of the Water Conservation Landscaping and Water Waste Ordinance. Water management is the sale responsibility of the Property Owner.

All landscaping will be in conformance with the City of Albuquerque Zoning Code, Street Tree Ordinance, Pollen Ordinance, and Water Conservation Landscaping and Water Waste Ordinance. In general, water conservative, environmentally sound landscape principles will be followed in design and installation.

Plant beds shall achieve 75% live ground cover

Santa Ana Tan Gravel over Filter Fabric shall be placed in all landscape areas which are not designated to receive native seed.

IRRIGATION NOTES:

Irrigation shall be a complete underground system with Trees to receive (5) 1.0 GPH Drip Emitters and Shrubs to receive (2) 1.0 GPH Drip Emitters. Drip and Bubbler systems to be tied to 1/211 polypipe with flush caps at each end.

Run time per each drip valve will be approximately 15 minutes per day, to be adjusted according to the season.

Point of connection for irrigation system is unknown at current time and will be coordinated in the field.

Irrigation will be operated by automatic controller. Location of controller to be field determined and power source for controller to be provided by others.

Irrigation maintenance shall be the responsibility of the Property Owner.

Irrigation to New Street Trees shall be tied in to existing Irrigation System for Existing Street Trees.

CONTRACTOR NOTE:

At the time irrigation is connected to the Journal Center 2 common area irrigation system, contractor must contact the developer, Tiburon Investment LLC. 13000 Academy Road NE, Alb., NM 87111 (505) 823-9360

Cont. Lic. #26458 7909 Edith N.E. Albuquerque, NM 87184 Ph. (505) 898-9690 Fax (505) 898-7737 cmd@hilltoplandscaping.com All creative ideas contained Herein remains the

property of The Hilltop Landscape Architects and Contractors and are protected by copyright laws. This is an original design and must not be released or copied unless applicable fees have been paid or job order

GRAPHIC SCALE

SCALE: 1"=20'

0348

Building

Office

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7430 BUQ

5/12/04

REVISIONS: A.R.C. PHASE 1 3/26/04 A.R.C. PHASE 2 4/28/04

LANDSCAPE PLAN

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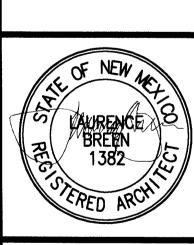
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Journal Center 2, Lot 11a

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Journal Center 2, Lot 11a 7430 Washington St. NE




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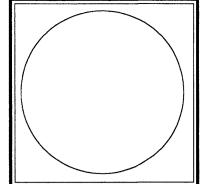
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JOB NO: 02.00012

DATE: 5/12/04

REVISIONS

GRADING & DRAINAGE PLAN

LITTLE/DRANTTEL OFFICE COMPLEX
7430 Washington St. NE
ALBUQUERUE, NEW MEXICO

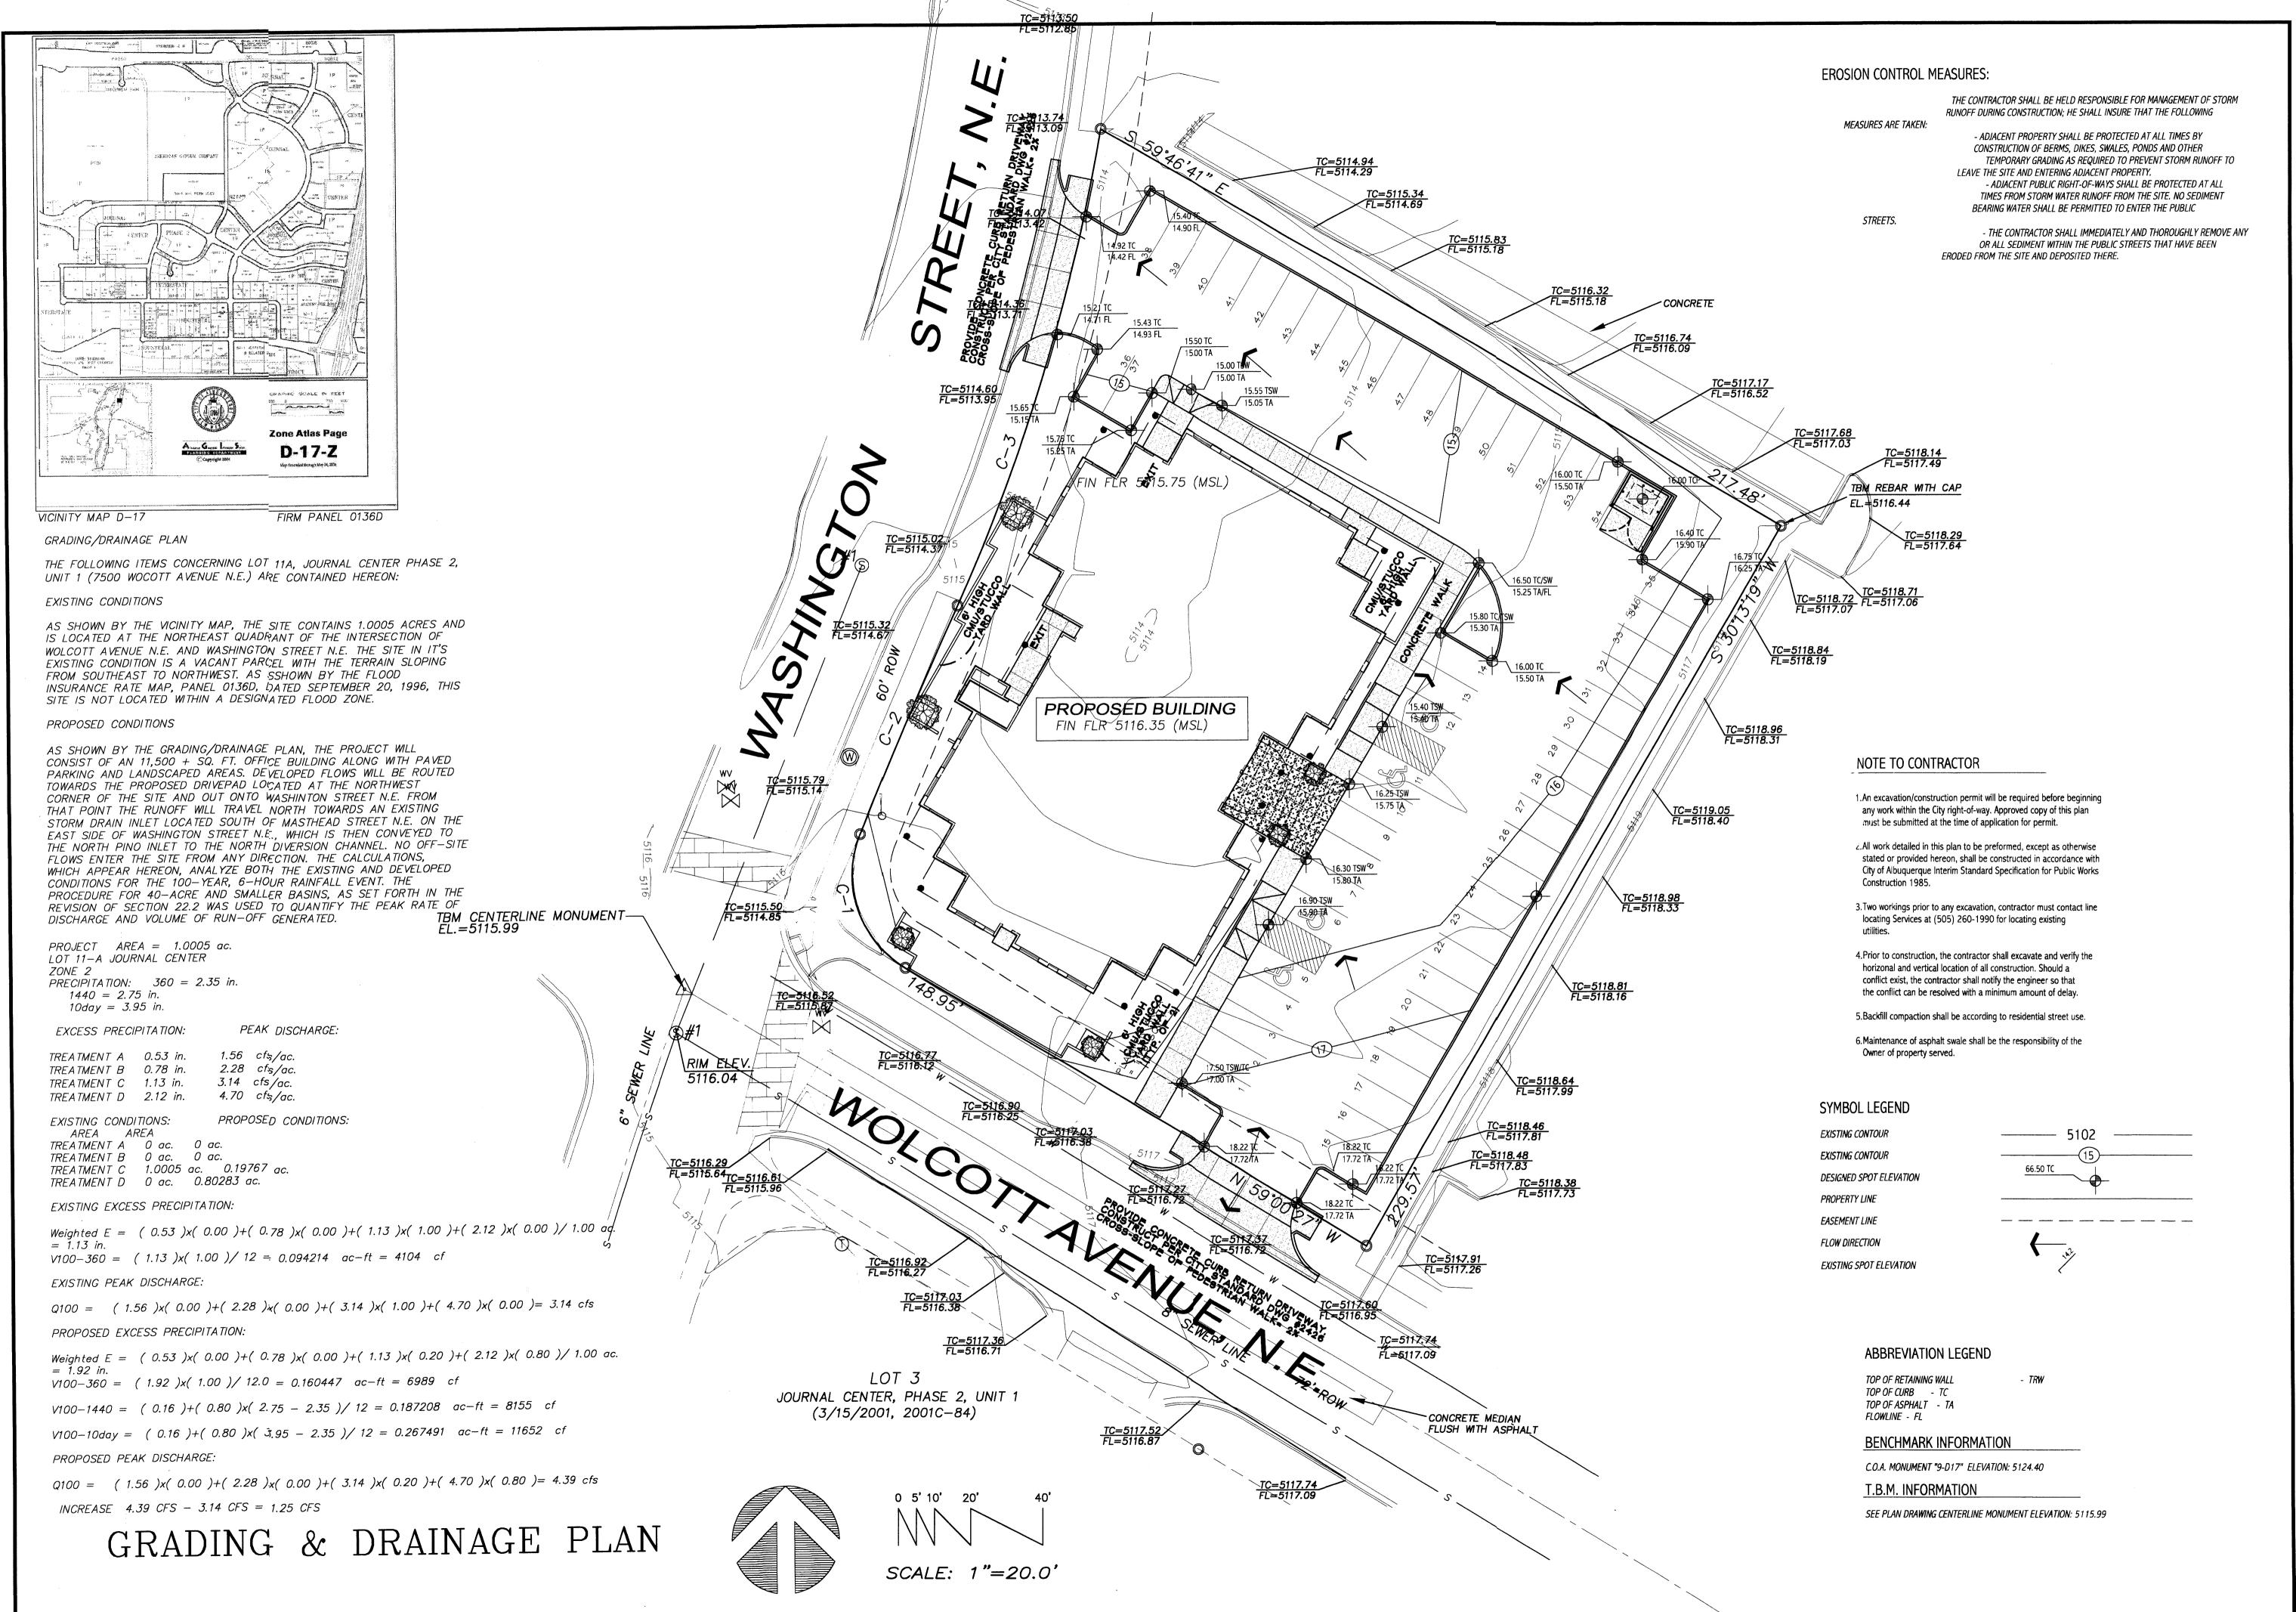SHEET NO.

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