

1/2" = 1'-0"

architecture landscape engineering

7601 Jefferson NE Suite 100 Albuquerque, NM 87109 505 761-9700 fax 761-4222 dps @ dpsdesign.org

ARCHITECT

EXISTING SIDEWALK—— 1/2" EXPANSION JOINT-6" WIDE CONCRETE-HEAVY BROOM FINISH PERPENDICULAR TO SLOPE OF RAMP. JOINTING PER PLAN. NEW CONCRETE—SIDEWALK EXISTING SIDEWALK RAMP _ EXISTING SIDEWALK RAMP LANDING WITH TACTILE WARNING STRIP -



FORMER PROJECT NUMBER: PROJECT NUMBER: APPLICATION NUMBER: Is an Infrastructure List Required? (X) Yes () No If yes, then a set of approved DRC plans with a work order is required for any construction within Public Right-of-Way or for construction of public improvem DRB SITE DEVELORMENT PLAN APPROVAL: DATE TRAFFIC ENGINEER, TRANSPORTATION DAYSION **ABCWUA** DATE PARKS AND RECREATION DEPARTMENT DATE CITY ENGINEER

SOLID WASTE MANAGEMENT

DRB CHAIRPERSON, PLANNING DEPARTMENT

REVISIONS


DRAWN BY DPS **REVIEWED BY** DPS 01.21.2011 PROJECT NO. 10-0138 DRAWING NAME

SITE **DETAILS** FOR **BUILDING PERMIT**

SHEET NO.

DATE

DATE

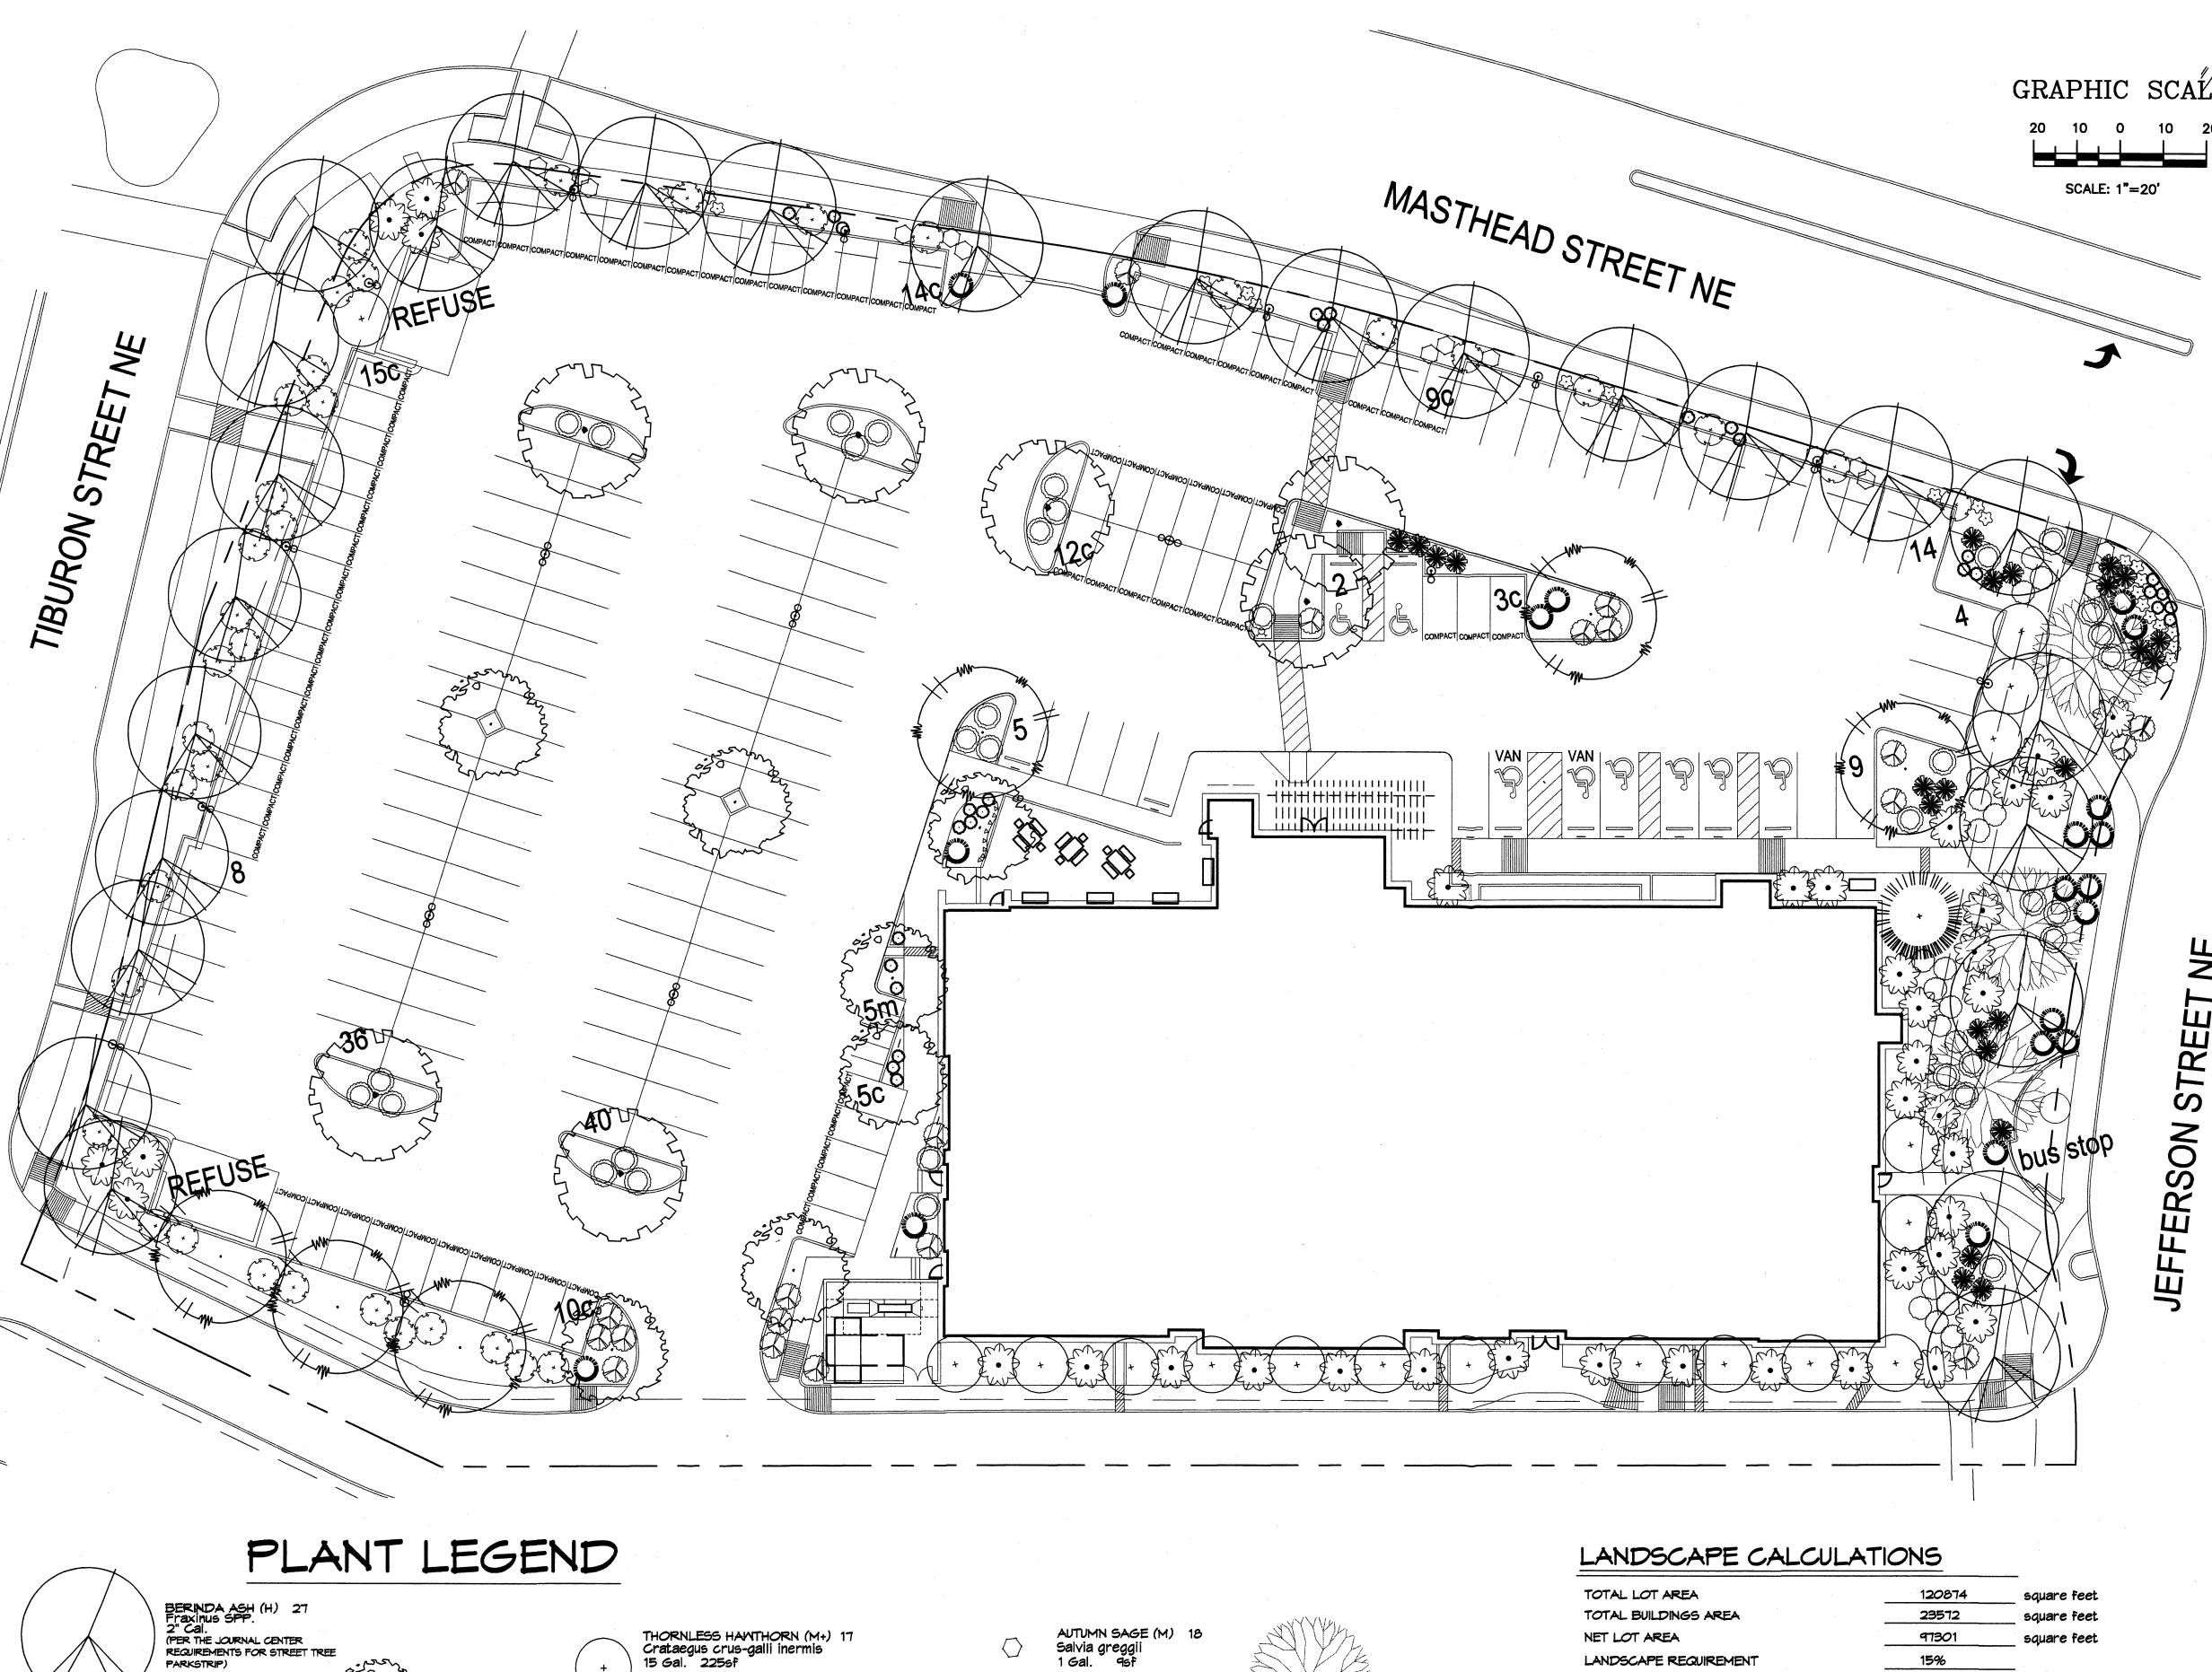

GREYLEAF COTONEASTER 39 Cotoneaster buxifolius 5 Gal. 81sf

APACHE PLUME (L) 18 Fallugia paradoxa 5 Gal. 42sf

ARP ROSEMARY (M) 34

PONIS CASTLE SAGE (L) 21 Artimesia x powis castle 5 Gal. 25sf

RESTRESS

Rosmarinus officianalis 5 Gal. 36sf

LAVENDER (M) 29 Lavandula angustifolia 1 Gal. 9sf

THREADGRASS (M) 22 Stipa tennuisima 1 Gal. 4sf

LADY BANKS ROSE (M) 1 Rosa banksiae 5 Gal.

REQUIREMENTS FOR STREET TREE PARKSTRIP)

CHINESE PISTACHE (M) Pistachia chinensis 2" Cal.

OAK (M) 6 Quercus spp. 2" Cal.

REDBUD (M) 7 Cercis reniformis 2" Cal.

AUSTRIAN PINE (M) 1 Pinus nigra 6'-8'

SOTOL 24 Dasylirion wheeleri 5 Gal. 36sf

MUGO PINE (M) 30 Pinus mugo 5 Gal. 36sf

CURLLEAF MTN MAHOGANY (L) 39 Carcorpus ledfolius 5 Gal. 1005F

LANDSCAPE CALCULAT	TIONS	
TOTAL LOT AREA	120874	- square feet
TOTAL BUILDINGS AREA	23572	_ square feet
NET LOT AREA	97301	square feet
LANDSCAPE REQUIREMENT	15%	
TOTAL LANDSCAPE REQUIREMENT	14595	_ square feet
TOTAL BED PROVIDED	19776	_ square feet
GROUNDCOVER REQ.	75%	_ square feet
TOTAL GROUNDCOVER REQUIREMENT	14832	_ square feet
TOTAL GROUNDCOVER PROVIDED	16265 (82%)	_ square feet
TOTAL PONDING AREA		_ square feet
TOTAL SOD AREA		square feet
(max. 20% of landscape required)		<u> </u>
TOTAL NATIVE SEED AREA	0	_ square feet

TOTAL LANDSCAPE PROVIDED

19776 (20%) square feet

EXISTING TREE TO REMAIN

SANTA ANA TAN GRAVEL WITH FILTER FABRIC

GRAPHIC SCALE LANDSCAPE NOTES:

Landscape maintenance shall be the responsibility of the Property Owner. The Property Owner shall maintain street trees in a living, healthy, and attractive condition.

> It is the intent of this plan to comply with the City Of Albuquerque Water Conservation Landscaping and Water Waste Ordinance planting restriction approach. Approval of this plan does not constitute or imply exemption from water waste provisions of the Water Conservation Landscaping and Water Maste Ordinance.

Water management is the sole responsibility of the Property Owner. All landscaping will be in conformance with the City of Albuquerque Zoning Code, Street Tree Ordinance, Pollen Ordinance, and Water Conservation Landscaping and Water Waste Ordinance. In general, water conservative, environmentally sound landscape principles will be followed in design and

Plant beds shall achieve 75% live ground cover at maturity.

_____ Gravel over Filter Fabric to a minimum depth of 3" shall be placed in all landscape areas which are not designated to receive native seed.

IRRIGATION NOTES:

Irrigation shall be a complete underground system with Trees to receive 1 Netafim spiral (50' length) with 3 loops at a final radius of 4.5' from tree trunk, pinned in place. Netafim shall have emitters 12" o.c. with a flow of .6 gph. Shrubs to receive (2) 1.0 GPH Drip Emitters. Drip and Bubbler systems to be tied to 1/2" polypipe with flush caps at each end. Trees and shrubs shall be on separate valves.

Run time per each shrub drip valve will be approximately 15 minutes per day. Tree drip valve shall run 1.5 hours, 3 times per week. Run time will be adjusted according to the season.

Point of connection for irrigation system is unknown at current time and will be coordinated in the field. Irrigation will be operated by automatic

Location of controller to be field determined and power source for controller to be provided by others.

Irrigation maintenance shall be the responsibility of the Property Owner.

Mater and Power source shall be the responsibility of the Developer/Builder.

STREET TREE REQUIREMENTS - Minimum 2" Caliper

Street trees required under the City Of Albuquerque Street Tree Ordinance are as follows:

Name of Street: JEFFERSON

Provided 8

Name of Street: MASTHEAD Required 13 Provided 12

Name of Street: TIBURON Required 9 Provided 9

PARKING LOT TREE REQUIREMENTS - Minimum 2" Caliper

Shade trees required under the City Of Albuquerque Parking Lot Tree Ordinance are as follows:

\$hade tree per 10 spaces

Required 20 Provided 20

NOTE TO CLIENT: Should The Hilltop not receive a Grading and Drainage plan during the design process or the on-site grades differ from the Grading and Drainage plan received, The Hilltop reserves the right to apply slope stabilization materials where the specified gravel will not be suitable. Gravel smaller than 2-4" cobblestone will not stay on a slope greater than 3:1. If the grades are greater than what was originally designed, we will request an infield change-order to lay cobblestone or rip-rap, in lieu of the specified gravel, to stabilize the slope. All vegetative material shall remain per plan.




landscape planning engineering

architecture

7601 Jefferson NE Suite 100 Albuquerque, NM 87109 505 761-9700

fax 761-4222 dps@dpsdesign.org

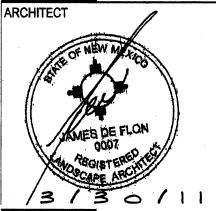

Building fferson NE Jew Mexico

DRAWING NAME

4 cmj 3-15-11 tree vs. lighting /3\ cmj 2-15-11 revised site plan

/2 cmj 1-24-11 ex. trees located <u>/5</u> cmj 3-30-11 rev. site € no-sod

DRAWN BY	cmj
REVIEWED BY	df
DATE	1-11-11
PROJECT NO.	-

Contractors and are protected by copyright laws. This is an original design and must not be released or copied unless applicable fees have been paid or job order placed. All plants shall be sized per American Standard for Nursery Stock. SHEET NO.

LANDSCAPE ARCHITECTS & CONTRACTORS


Albuquerque, NM 87184 Ph. (505) 898-9690

cmj@hilltoplandscaping.com

All creative ideas contained Herein remains the property of The Hilltop Landscape Architects and

Fax (505) 898-7737

Cont. Lic. #26458 7909 Edith N.E.

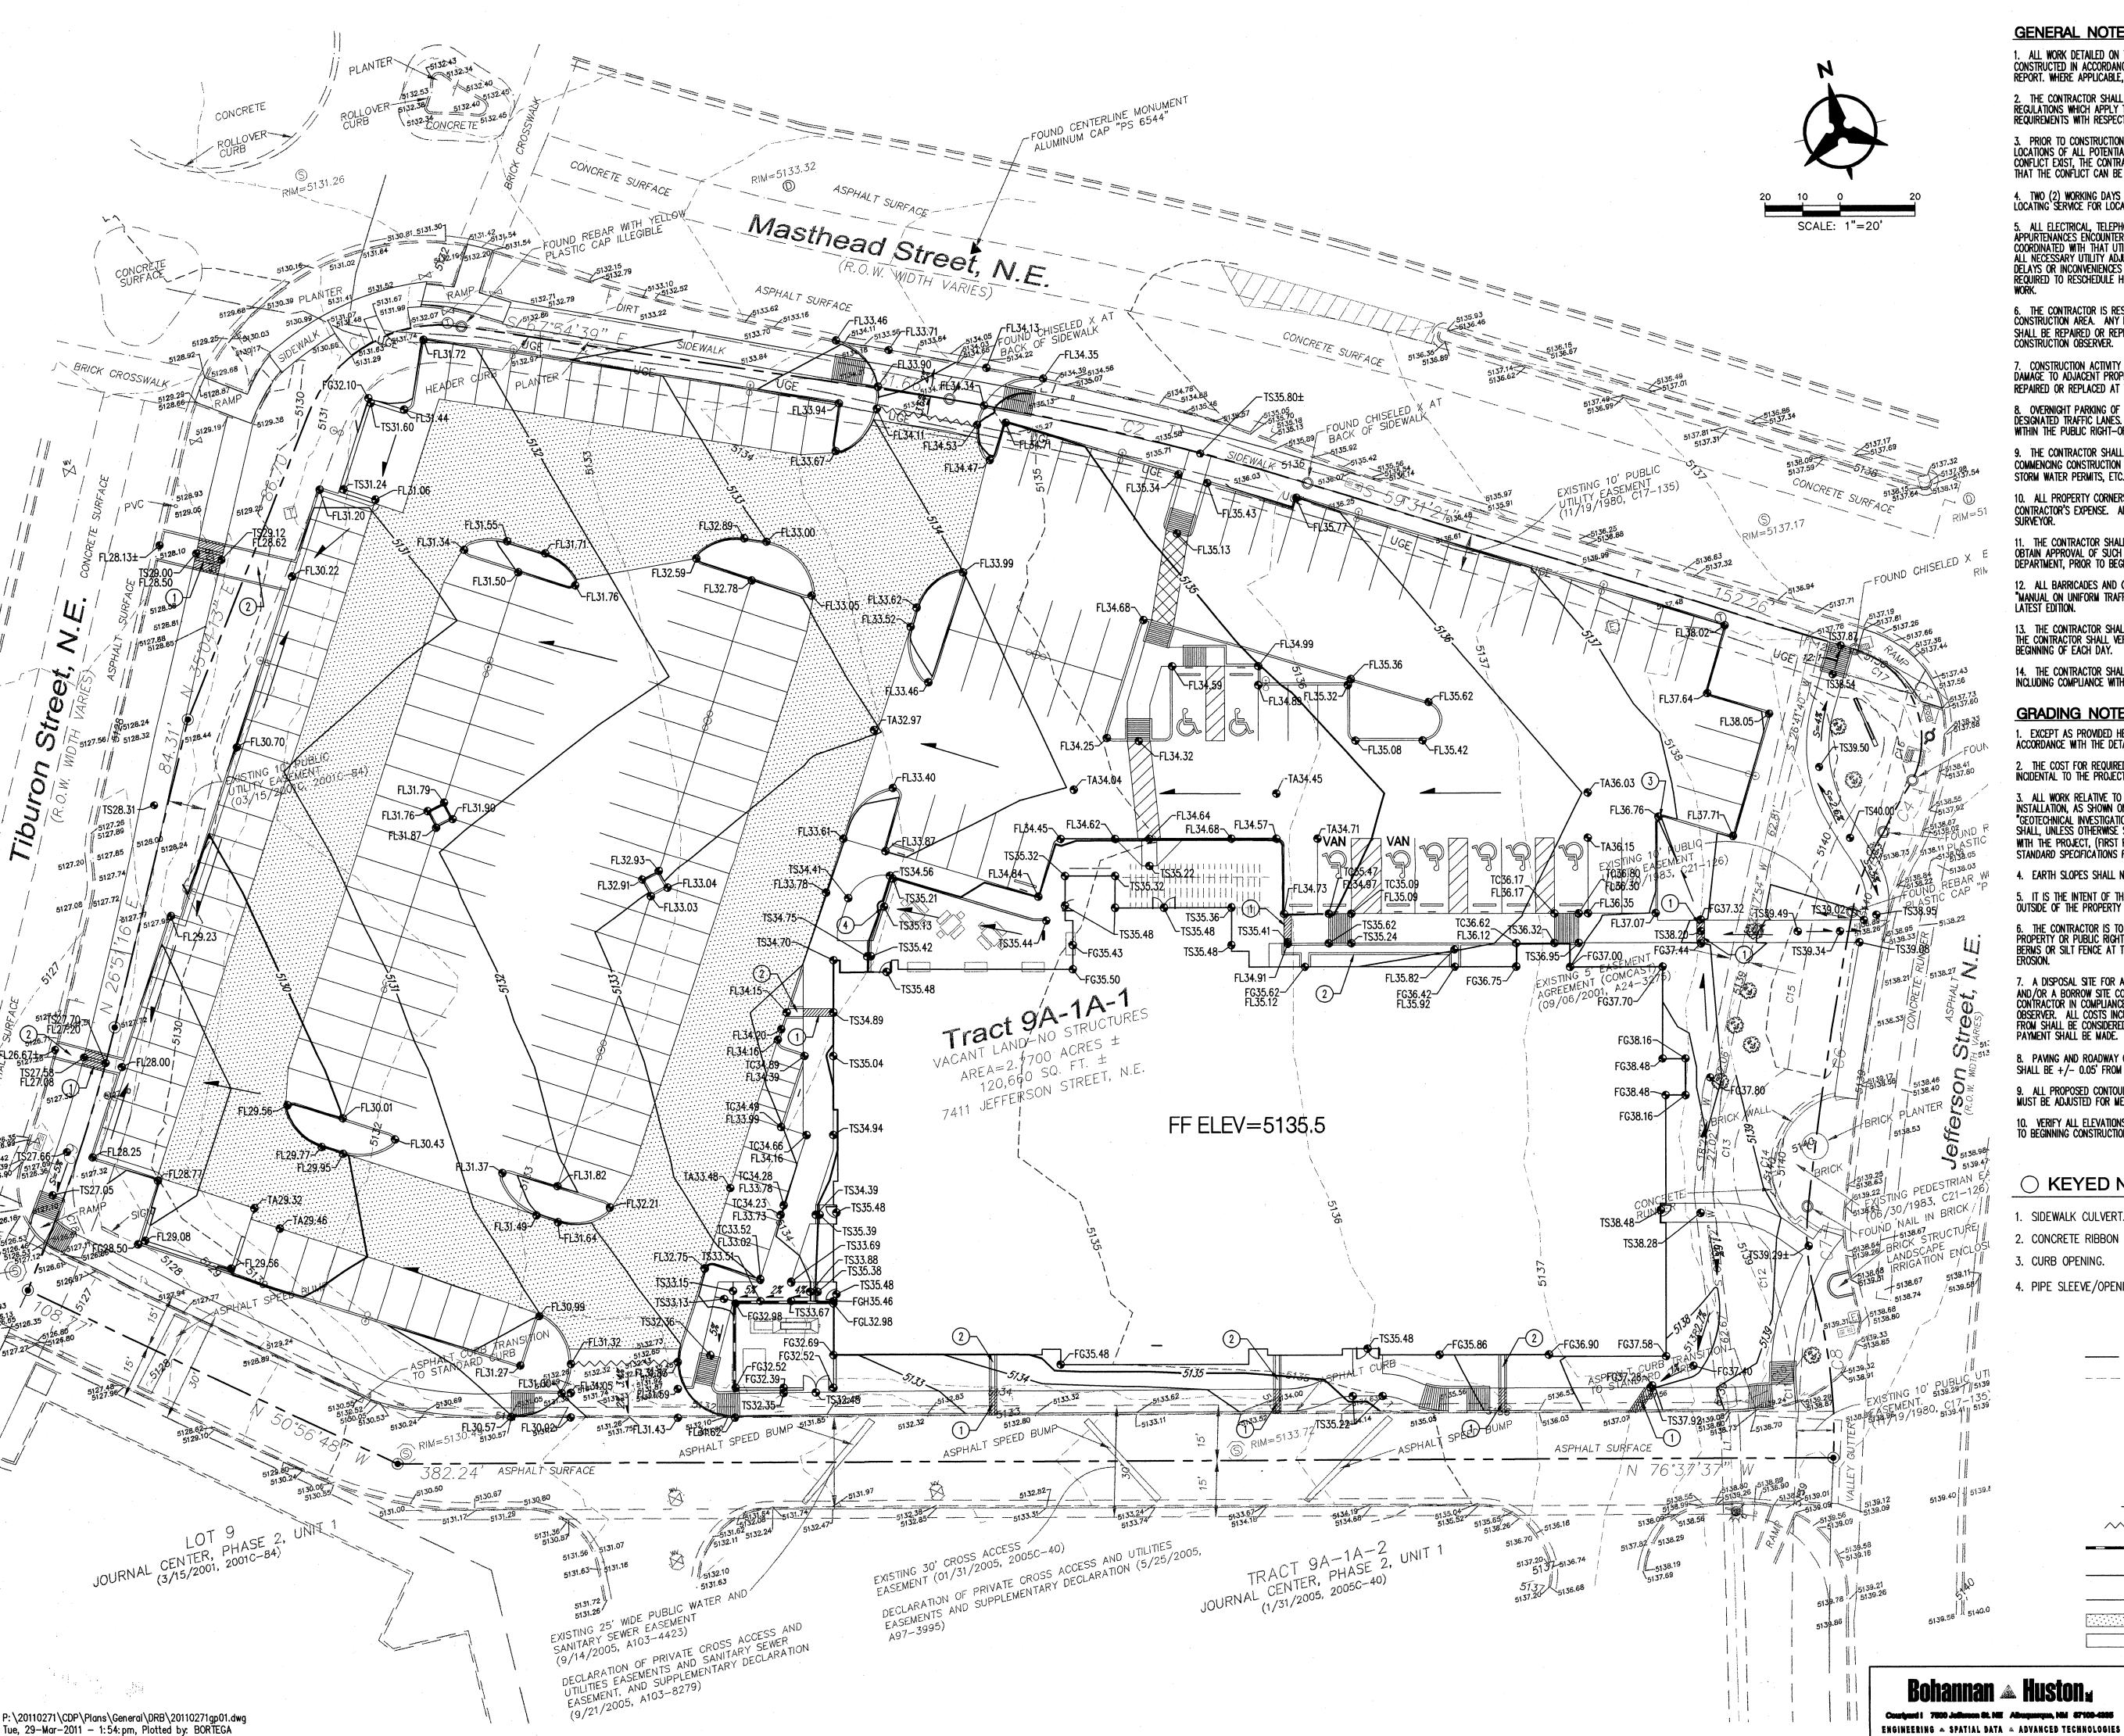

GENERAL NOTES

1. ALL WORK DETAILED ON THESE PLANS AND PERFORMED UNDER THIS CONTRACT SHALL BE CONSTRUCTED IN ACCORDANCE WITH THE PROJECT SPECIFICATIONS AND THE PROJECT GEOTECHNICAL REPORT. WHERE APPLICABLE, CITY OF ALBUQUERQUE PUBLIC WORKS STANDARDS SHALL APPLY.

2. THE CONTRACTOR SHALL ABIDE BY ALL LOCAL, STATE, AND FEDERAL LAWS, RULES AND REGULATIONS WHICH APPLY TO THE CONSTRUCTION OF THESE IMPROVEMENTS, INCLUDING EPA REQUIREMENTS WITH RESPECT TO STORM WATER DISCHARGE.

3. PRIOR TO CONSTRUCTION, THE CONTRACTOR SHALL FIELD VERIFY THE HORIZONTAL AND VERTICAL LOCATIONS OF ALL POTENTIAL OBSTRUCTIONS INCLUDING ALL UNDERGROUND UTILITIES. SHOULD A CONFLICT EXIST, THE CONTRACTOR SHALL NOTIFY THE CONSTRUCTION OBSERVER OR ENGINEER SO THAT THE CONFLICT CAN BE RESOLVED WITH A MINIMUM AMOUNT OF DELAY.

4. TWO (2) WORKING DAYS PRIOR TO ANY EXCAVATION, THE CONTRACTOR SHALL CONTACT LINE LOCATING SERVICE FOR LOCATION OF EXISTING UTILITIES.

5. ALL ELECTRICAL, TELEPHONE, CABLE TV, GAS AND OTHER UTILITY LINES, CABLES, AND APPURTENANCES ENCOUNTERED DURING CONSTRUCTION THAT REQUIRE RELOCATION, SHALL BE COORDINATED WITH THAT UTILITY. THE CONTRACTOR SHALL BE RESPONSIBLE FOR COORDINATION OF ALL NECESSARY UTILITY ACCUMENTS. NO ADDITIONAL COMPENSATION WILL BE CANTENATED TO THE CONTRACTOR MAY BE CONTRACTOR. DELAYS OR INCONVENIENCES CAUSED BY UTILITY COMPANY WORK CREWS. THE CONTRACTOR MAY BE REQUIRED TO RESCHEDULE HIS ACTIVITIES TO ALLOW UTILITY CREWS TO PERFORM THEIR REQUIRED

6. THE CONTRACTOR IS RESPONSIBLE FOR PROTECTING ALL EXISTING UTILITY LINES WITHIN THE CONSTRUCTION AREA. ANY DAMAGE TO EXISTING FACILITIES CAUSED BY CONSTRUCTION ACTIVITY SHALL BE REPAIRED OR REPLACED AT THE CONTRACTOR'S EXPENSE AND APPROVED BY THE CONSTRUCTION OBSERVER.

7. CONSTRUCTION ACTIVITY SHALL BE LIMITED TO THE PROPERTY AND/OR PROJECT LIMITS. ANY DAMAGE TO ADJACENT PROPERTIES RESULTING FROM THE CONSTRUCTION PROCESS SHALL BE REPAIRED OR REPLACED AT THE CONTRACTOR'S EXPENSE.

8. OVERNIGHT PARKING OF CONSTRUCTION EQUIPMENT SHALL NOT OBSTRUCT DRIVEWAYS OR DESIGNATED TRAFFIC LANES. THE CONTRACTOR SHALL NOT STORE ANY EQUIPMENT OR MATERIAL

9. THE CONTRACTOR SHALL OBTAIN ALL THE NECESSARY PERMITS FOR THE PROJECT PRIOR TO COMMENCING CONSTRUCTION (I.E., BARRICADING, TOPSOIL DISTURBANCE, EXCAVATION PERMITS, EPA STORM WATER PERMITS, ETC.).

10. ALL PROPERTY CORNERS DESTROYED DURING CONSTRUCTION SHALL BE REPLACED AT THE CONTRACTOR'S EXPENSE. ALL PROPERTY CORNERS MUST BE RESET BY A REGISTERED LAND

1. THE CONTRACTOR SHALL PREPARE A CONSTRUCTION TRAFFIC CONTROL AND SIGNING PLAN AND OBTAIN APPROVAL OF SUCH PLAN FROM THE CITY OF ALBUQUERQUE, TRAFFIC ENGINEERING DEPARTMENT, PRIOR TO BEGINNING ANY CONSTRUCTION WORK ON OR ADJACENT TO EXISTING STREETS. 12. ALL BARRICADES AND CONSTRUCTION SIGNING SHALL CONFORM TO APPLICABLE SECTIONS OF THE "MANUAL ON UNIFORM TRAFFIC CONTROL DEVICES" (MUTCD), US DEPARTMENT OF TRANSPORTATION, LATEST EDITION.

13. THE CONTRACTOR SHALL MAINTAIN ALL CONSTRUCTION BARRICADES AND SIGNING AT ALL TIMES. THE CONTRACTOR SHALL VERIFY THE PROPER LOCATION OF ALL BARRICADING AT THE END AND

14. THE CONTRACTOR SHALL TAKE ALL STEPS NECESSARY TO CONFORM WITH EPA REQUIREMENTS, INCLUDING COMPLIANCE WITH NPDES PHASE 2 REQUIREMENTS.

GRADING NOTES

. EXCEPT AS PROVIDED HEREIN, GRADING SHALL BE PERFORMED AT THE ELEVATIONS AND IN ACCORDANCE WITH THE DETAILS SHOWN ON THIS PLAN.

2. THE COST FOR REQUIRED CONSTRUCTION DUST AND EROSION CONTROL MEASURES SHALL BE INCIDENTAL TO THE PROJECT COST.

3. ALL WORK RELATIVE TO FOUNDATION CONSTRUCTION, SITE PREPARATION, AND PAVEMENT INSTALLATION, AS SHOWN ON THIS PLAN, SHALL BE CONSTRUCTED IN ACCORDANCE WITH THE GEOTECHNICAL INVESTIGATION," AS PROVIDED BY THE ARCHITECT OR OWNER. ALL OTHER WORK SHALL, UNLESS OTHERWISE STATED OR PROVIDED FOR HEREON, BE CONSTRUCTED IN ACCORDANCE WITH THE PROJECT, (FIRST PRIORITY) SPECIFICATIONS, AND/OR THE CITY OF ALBUQUERQUE (COA) STANDARD SPECIFICATIONS FOR PUBLIC WORKS (SECOND PRIORITY).

4. EARTH SLOPES SHALL NOT EXCEED 3 HORIZONTAL TO 1 VERTICAL UNLESS SHOWN OTHERWISE. 5. IT IS THE INTENT OF THESE PLANS THAT THIS CONTRACTOR SHALL NOT PERFORM ANY WORK OUTSIDE OF THE PROPERTY BOUNDARIES EXCEPT AS REQUIRED BY THIS PLAN.

6. THE CONTRACTOR IS TO ENSURE THAT NO SOIL ERODES FROM THE SITE ONTO ADJACENT PROPERTY OR PUBLIC RIGHT-OF-WAY. THIS SHOULD BE ACHIEVED BY CONSTRUCTING TEMPORARY BERMS OR SILT FENCE AT THE PROPERTY LINES AND WETTING THE SOIL TO PROTECT IT FROM WIND

. A DISPOSAL SITE FOR ANY & ALL EXCESS EXCAVATION MATERIAL, AND UNSUITABLE MATERIAL AND/OR A BORROW SITE CONTAINING ACCEPTABLE FILL MATERIAL SHALL BE OBTAINED BY THE CONTRACTOR IN COMPLIANCE WITH APPLICABLE ENVIRONMENTAL REGULATIONS AND APPROVED BY THE OBSERVER. ALL COSTS INCURRED IN OBTAINING A DISPOSAL OR BORROW SITE AND HAUL TO OR FROM SHALL BE MADE.

8. PAVING AND ROADWAY GRADES SHALL BE +/- 0.1' FROM PLAN ELEVATIONS. PAD ELEVATION SHALL BE +/- 0.05' FROM BUILDING PLAN ELEVATION.

9. ALL PROPOSED CONTOURS REFLECT TOP OF PAVEMENT ELEVATIONS IN THE PARKING AREA AND MUST BE ADJUSTED FOR MEDIANS AND ISLANDS.

KEYED NOTES

- 2. CONCRETE RIBBON CHANNEL.
- 3. CURB OPENING.
- 4. PIPE SLEEVE/OPENING IN WALL.

LEGEND

----- PROPERTY LINE ----5301--- Existing contours EXISITNG ELECTRICAL POLE PROPOSED SPOT ELEVATION TC=TOP OF CURB, FL=FLOW LINE TS=TOP OF SIDEWALK, TA=TOP OF ASPHALT EX=EXISTING, FG=FINISHED GRADE FGH=FINISHED GRADE HIGH FGL=FINISHED GRADE LOW PROPOSED DIRECTION OF FLOW S=2.0% WATER BLOCK **^** PROPOSED RETAINING WALL

LIGHT DUTY ASPHALT PAVEMENT

PROPOSED INTER CONTOURS

HEAVY DUTY ASPHALT PAVEMENT





planning engineering

architecture

interiors

landscape

7601 Jefferson NE Suite 100 Albuquerque, NM 87109 505 761-9700 fax 761-4222 dps@dpsdesign.org

ARCHITECT

Buildin

Son

effer

10. VERIFY ALL ELEVATIONS SHOWN ON PLAN FROM BASIS OF ELEVATION CONTROL STATION PRIOR TO BEGINNING CONSTRUCTION.


. SIDEWALK CULVERT.

DRAWN BY **REVIEWED BY** DATE

BO GSB 3/29/2011 PROJECT NO. DRAWING NAME

CONCEPTUAL **GRADING &** DRAINAGE PLAN

SHEET NO.

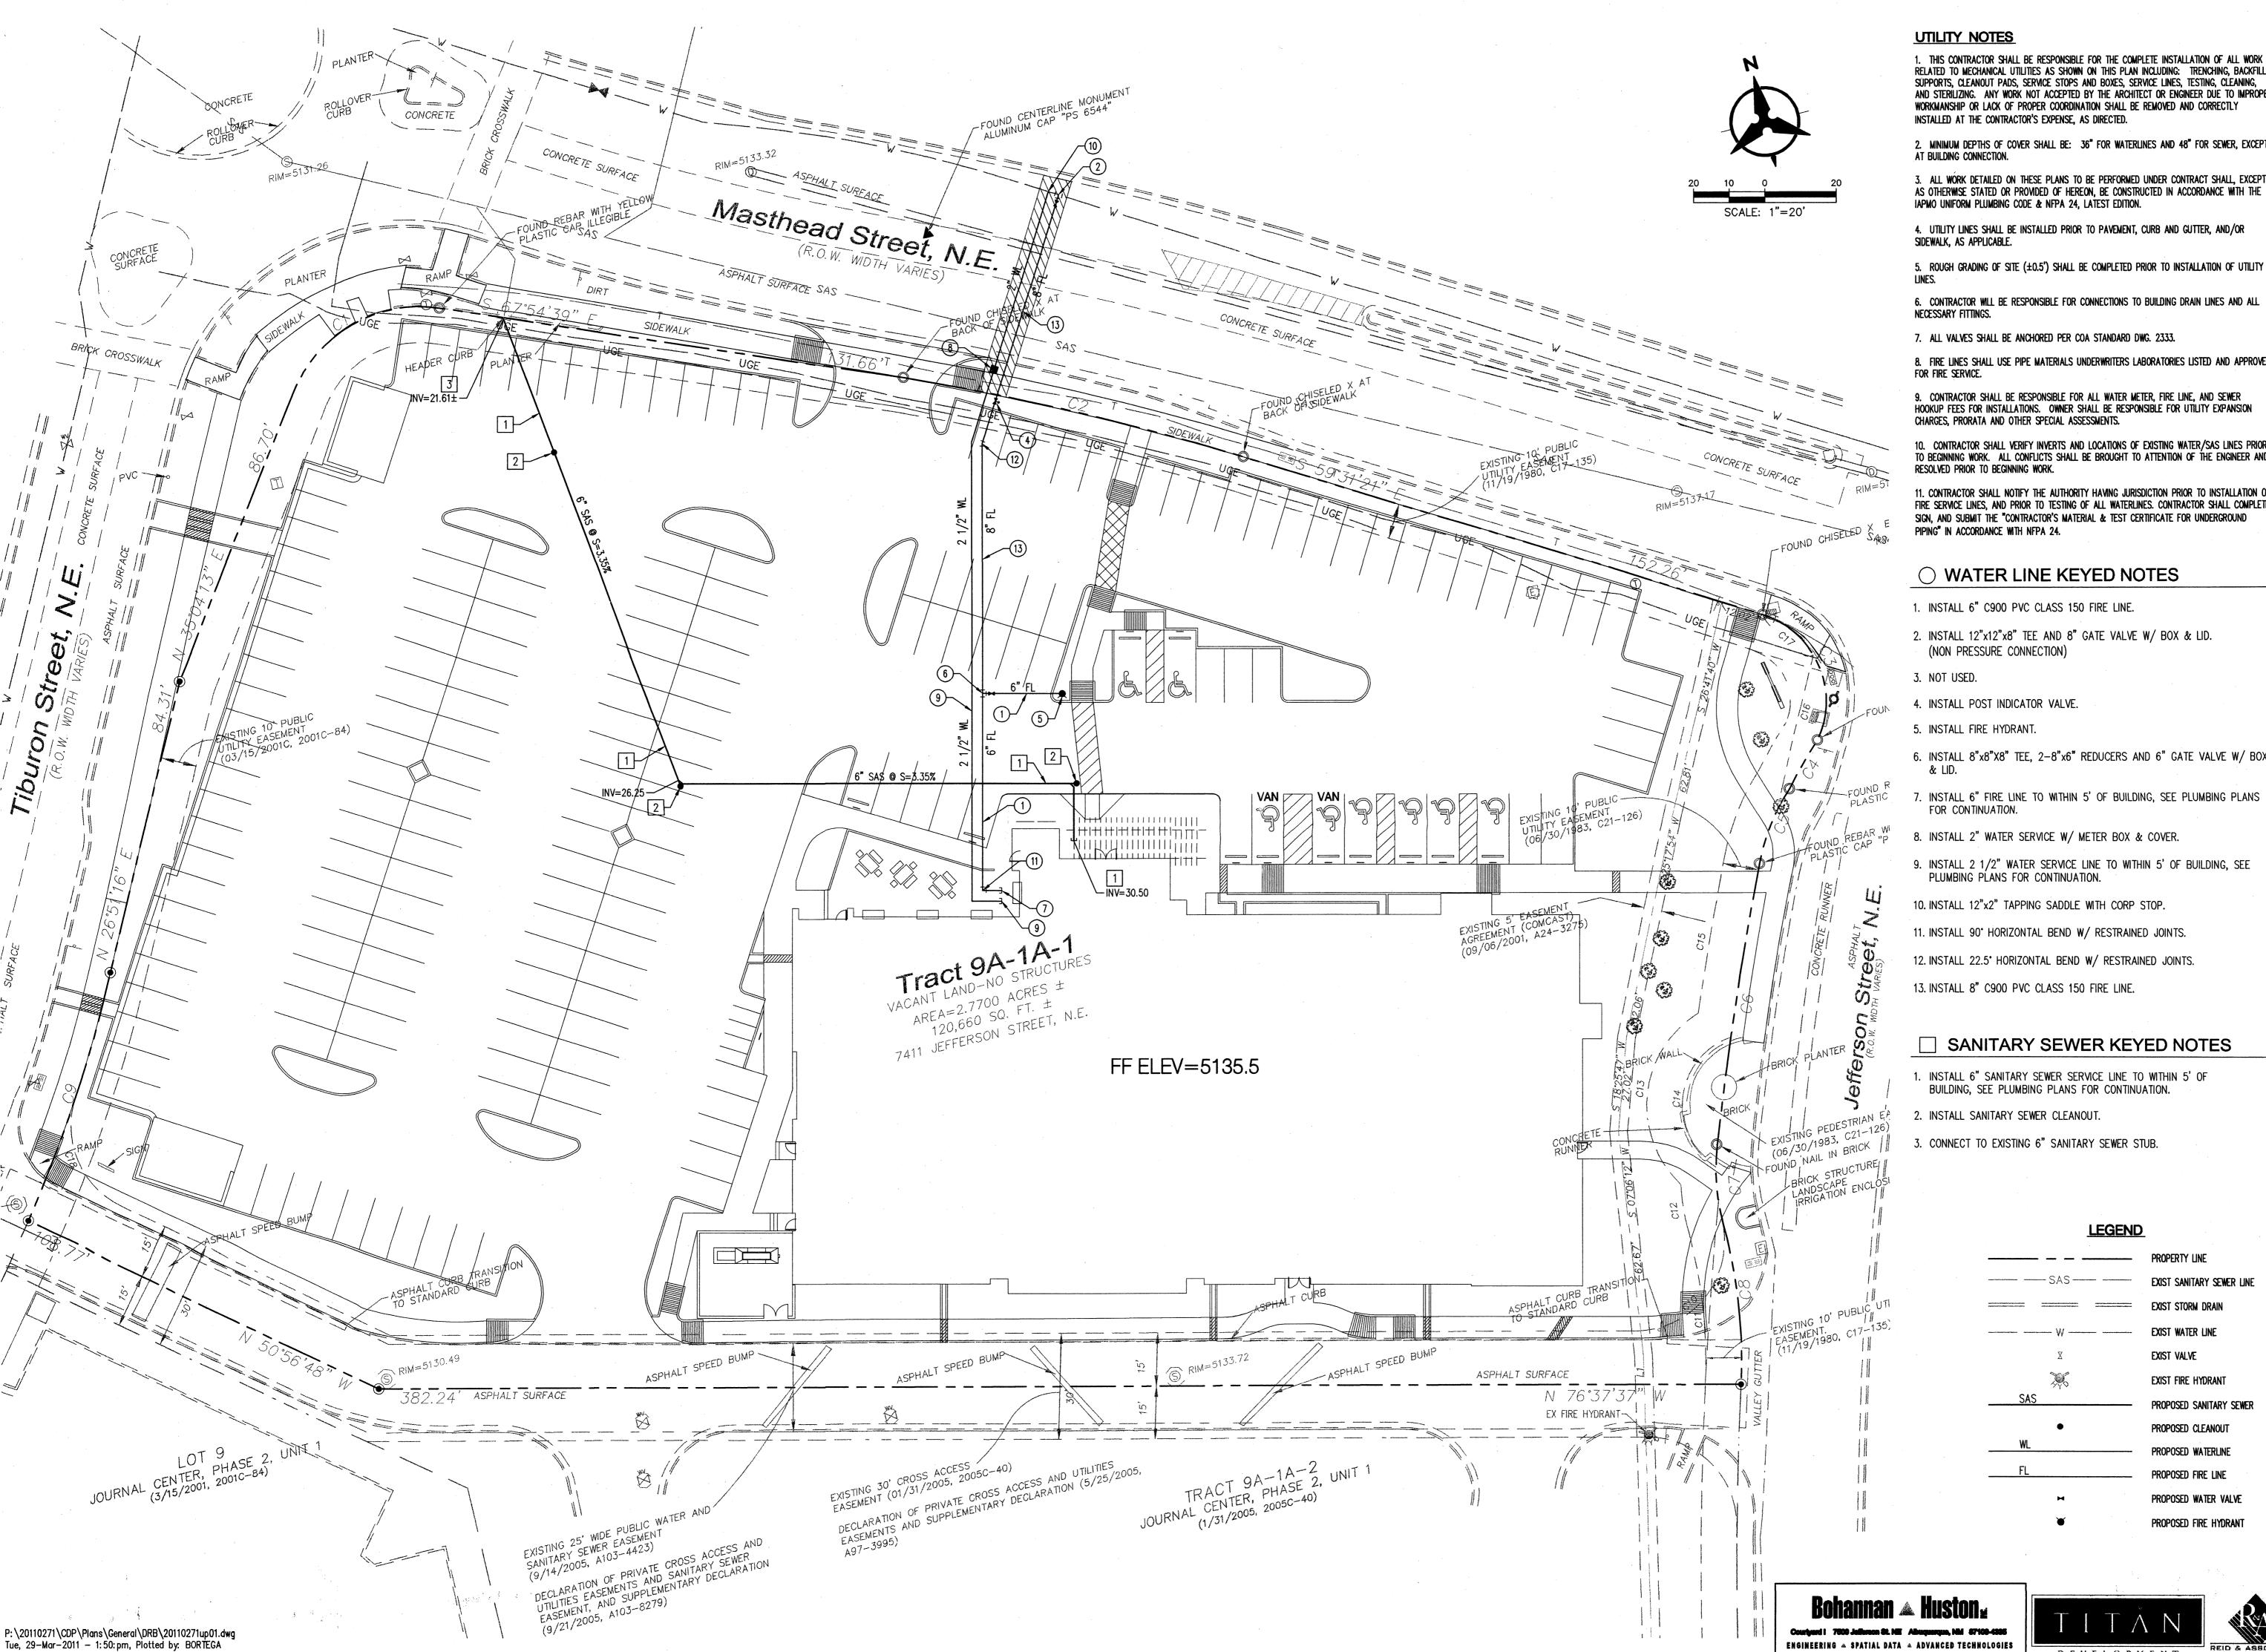

UTILITY NOTES

1. THIS CONTRACTOR SHALL BE RESPONSIBLE FOR THE COMPLETE INSTALLATION OF ALL WORK RELATED TO MECHANICAL UTILITIES AS SHOWN ON THIS PLAN INCLUDING: TRENCHING, BACKFILL, SUPPORTS, CLEANOUT PADS, SERVICE STOPS AND BOXES, SERVICE LINES, TESTING, CLEANING, AND STERILIZING. ANY WORK NOT ACCEPTED BY THE ARCHITECT OR ENGINEER DUE TO IMPROPER WORKMANSHIP OR LACK OF PROPER COORDINATION SHALL BE REMOVED AND CORRECTLY INSTALLED AT THE CONTRACTOR'S EXPENSE, AS DIRECTED.

MINIMUM DEPTHS OF COVER SHALL BE: 36" FOR WATERLINES AND 48" FOR SEWER, EXCEPT AT BUILDING CONNECTION.

3. ALL WORK DETAILED ON THESE PLANS TO BE PERFORMED UNDER CONTRACT SHALL, EXCEPT AS OTHERWISE STATED OR PROVIDED OF HEREON, BE CONSTRUCTED IN ACCORDANCE WITH THE IAPMO UNIFORM PLUMBING CODE & NFPA 24, LATEST EDITION.

4. UTILITY LINES SHALL BE INSTALLED PRIOR TO PAVEMENT, CURB AND GUTTER, AND/OR SIDEWALK, AS APPLICABLE.

6. CONTRACTOR WILL BE RESPONSIBLE FOR CONNECTIONS TO BUILDING DRAIN LINES AND ALL

NECESSARY FITTINGS.

7. ALL VALVES SHALL BE ANCHORED PER COA STANDARD DWG. 2333.

8. FIRE LINES SHALL USE PIPE MATERIALS UNDERWRITERS LABORATORIES LISTED AND APPROVED FOR FIRE SERVICE.

9. CONTRACTOR SHALL BE RESPONSIBLE FOR ALL WATER METER, FIRE LINE, AND SEWER HOOKUP FEES FOR INSTALLATIONS. OWNER SHALL BE RESPONSIBLE FOR UTILITY EXPANSION CHARGES, PRORATA AND OTHER SPECIAL ASSESSMENTS.

10. CONTRACTOR SHALL VERIFY INVERTS AND LOCATIONS OF EXISTING WATER/SAS LINES PRIOR TO BEGINNING WORK. ALL CONFLICTS SHALL BE BROUGHT TO ATTENTION OF THE ENGINEER AND RESOLVED PRIOR TO BEGINNING WORK.

1. CONTRACTOR SHALL NOTIFY THE AUTHORITY HAVING JURISDICTION PRIOR TO INSTALLATION OF FIRE SERVICE LINES, AND PRIOR TO TESTING OF ALL WATERLINES. CONTRACTOR SHALL COMPLETE, SIGN, AND SUBMIT THE "CONTRACTOR'S MATERIAL & TEST CERTIFICATE FOR UNDERGROUND PIPING" IN ACCORDANCE WITH NFPA 24.

○ WATER LINE KEYED NOTES

1. INSTALL 6" C900 PVC CLASS 150 FIRE LINE.

2. INSTALL 12"x12"x8" TEE AND 8" GATE VALVE W/ BOX & LID. (NON PRESSURE CONNECTION)

NOT USED.

4. INSTALL POST INDICATOR VALVE.

5. INSTALL FIRE HYDRANT.

6. INSTALL 8"x8"X8" TEE, 2-8"x6" REDUCERS AND 6" GATE VALVE W/ BOX

. INSTALL 6" FIRE LINE TO WITHIN 5' OF BUILDING, SEE PLUMBING PLANS FOR CONTINUATION.

8. INSTALL 2" WATER SERVICE W/ METER BOX & COVER.

9. INSTALL 2 1/2" WATER SERVICE LINE TO WITHIN 5' OF BUILDING, SEE PLUMBING PLANS FOR CONTINUATION.

10. INSTALL 12"x2" TAPPING SADDLE WITH CORP STOP.

11. INSTALL 90° HORIZONTAL BEND W/ RESTRAINED JOINTS.

12. INSTALL 22.5° HORIZONTAL BEND W/ RESTRAINED JOINTS.

13. INSTALL 8" C900 PVC CLASS 150 FIRE LINE.

☐ SANITARY SEWER KEYED NOTES

INSTALL 6" SANITARY SEWER SERVICE LINE TO WITHIN 5' OF BUILDING, SEE PLUMBING PLANS FOR CONTINUATION.

2. INSTALL SANITARY SEWER CLEANOUT.

5. CONNECT TO EXISTING 6" SANITARY SEWER STUB.

LEGEND

	PROPERTY LINE
SAS	EXIST SANITARY SEWER LIN
Aphanological control of the control	EXIST STORM DRAIN
W	exist water line
Χ	EXIST VALVE
	EXIST FIRE HYDRANT
SAS	PROPOSED SANITARY SEWE
•	PROPOSED CLEANOUT
WL	PROPOSED WATERLINE
FL	PROPOSED FIRE LINE
H	PROPOSED WATER VALVE

e Buildin Jefferson N New Mex

architecture

interiors

landscape

planning

engineering

7601 Jefferson NE Suite 100

Albuquerque, NM 87109

505 761-9700

fax 761-4222

ARCHITECT

dps ⊚ dpsdesign.org

DRAWN BY

REVIEWED BY GSB DATE 3/29/2011 PROJECT NO.

DRAWING NAME

CONCEPTUAL UTILITY PLAN

Bohannan & Huston



PROPOSED FIRE HYDRANT

SHEET NO.



