EXHIBIT A: VEHICULAR, PEDESTRIAN AND COMMON SPACE

√2 <sup>6</sup>

2 16

ARCHITECTURAL SITE PLAN

BLOCK "B

6 TRACT A

9 10



# 26 25 24 23 22 21 20 19

SUBDIVISION DATA SITEPLAN AREA.. 58.5209 AC **ZONE ATLAS NUMBER.** NUMBER OF LOTS CREATED. . 411 RESIDENTIAL LOTS  $\frac{Z1\Delta}{2}$ 1 NEIGHBORHOOD COMMERCIAL 18 TRACTS OF COMMON SPACE 🖄 NUMBER OF TRACTS CREATED., ...431 TRACTS RIGHT-OF-WAY AREA DEDICATED TO CITY... . approx. 15.49 AC **EXISTING ZONING.** SU-1 FOR MH PARK PROPOSED ZONING. ... SU-1 FOR PDA

### SITE DEVELOPMENT PLAN FOR SUBDIVISION

(NOT TO SCALE)

The redevelopment of Monterra Del Rey will stress an innovative design providing a range of housing types that includes a mix of affordability and lifestyles. The overall goal is to crate a vibrant, sustainable community, encompassing the existing residents of the Del Rey Mobile Home Park and new families into a cohesive community environment. The emphasis will be placed on incorporating a diversity of housing product into a walkable and inclusive neighborhood consistent

⚠ The site consists of 58.52 acres as shown on Zone Atlas Number C-18-Z. This project proposes a total of 431 Tracts; 412 Tracts of residential lots of various sizes. 18 Tracts of landscaped common areas of various sizes and 1 Tract of neighborhood commercial of approximately 2.4 acres, conducive to a neighborhood environment. Approximately 15.49 acres of land will be dedicated to the City of Albuquerque as right of way area for roads and sidewalks to serve the community and surrounding neighborhoods. The existing zoning for the site is SU-1 for MH Park we are proposing changing the zoning to SU-1 for PDA.

C1 A003

Pedestrian Ingress & Egress: Public sidewalks and trails will provide pedestrian connectivity within the site as well as to surrounding neighborhoods and businesses. Access to the neighborhood commercial portion of this project, from within the proposed site, will be limited to pedestrian access only. All sidewalks will have a minimum width of 5', and will indude a landscaped parkway between the street and the sidewalk. Landscaped bump-outs are also provided at intersections throughout the site as a means of tratic calming and allowing for safe locations for pedestrians wanting to cross the street. See Exhibit 1 on Sheet A001. Landscaped breezeways abutting the site wall shall provide pedestrian and visual access, gates are acceptable,

provided that they can be opened from either side.

Vehicular ingress & Egress: Vehicular access to the site is limited to six points into the site; 3 along Derickson on the north side of the site and 3 along Santa Monica on the south side of the site. There is no vehicular access to and from the residential portion of the site along San Pedro or Louisiana. Vehicular access to the neighborhood commercial portion of the site will be from Louisiana only; there will be no vehicular access to the neighborhood commercial site from within the residential portion of the project. See Exhibit: on Sheet A001.

Internal Circulation Requirements The internal circulation with primary access off of Santa Monica and Derickson meet the required street widths, radius and configurations and comply with the COA standards. An Entry Boulevard with landscaped median is provided at the

western end of the site and is intended to be the primary access point into the newly developed neighborhood with additional secondary entrances further east from this point. Right-of-ways are designed with tree-lined sidewalks and landscaped bump-outs at intersections to encourage walkability within the site.

This project will be broken down into three phases (See Exhibit 1a on sheet A001):

Unit 1 (Phase 1) - Relocation and re-development of 8.39 acres designated Are; 1 (Mobile Homes). This phase will begin with the relocation of any residents currently living at the western end of the site and then preparing the land and installing the infrastructure for the 47 residential lots to be constructed in Area 1. Once the land and infrastructure are in all remaining residents of the former Del Rey Mobile Home Park will be relocated to the newly developed lots within Areal.

BLOCK "K"

11 BLOCK "L" 4

5 0 3 5

BLOCK "J"

TRACT P

Unit 2 (Phase 2) - Redevelopment of residential lots and common spaces as indicated by the boundry shown in Exhibit 1A on this page.. This phase will remove any existing infrastructure and or site utilities to be abandoned and then redevelop the site to the proposed configuration, installing new infrastructure and grading newly developed residential lots and public common areas and parks A associated with the residential portion of the site. (Area 2, 3 and a portion of area

Unit 3 (Phase 3) - Redevolopment of the remaining residential lots and common spaces as well as the Development of the 2.4 acres of the Neighborood Commercial portion of the site. This phase will finish the proposed plan of the Monterra Del Rey Neighborhood by finding a user for the south-east portion with a use that is conducive to a neighborhood environment (Area 5, 6 and the remaining portion of area 4).

Storm Water Management:

3

BLOOK "N"

10 12 18

The site is broken down into two drainage basins the eastern half of the site will drain along Ray Street to the existing arroyo running just north of the site. The western half of the site will drain to the northwestern corner of the site and into the existing storm water drainage system. Both the existing storm water drainage system and the arroyo have the capacity necessary for the drainage of the site. See Exhibit 1b on Sheet A001.

(1) (2) (18)

TRACT S

TRACT U

(A) (9) (2)

<u>(3)</u>

(5) (11)

ACRES ALBUQUERQUE **ACRES ZONE ATLAS: D-18-Z (NOT TO SCALE)** 

**LEGAL DESCRIPTION** 

TRACT A, UNIT A, BLOCK 18 AND BLOCK 19, NORTH ALBUQUERQUE ACRES CITY OF ALBUQUERQUE, BERNALILLO COUNTY, NEW MEXICO AND CONTAINING 58.5209 ACRES (MORE OR LESS).

KEYED NOTES

1. CONCRETE SIDEWALK (WIDTH

2. CMU SITE WALL

CONCRETE SIDEWALK (5' WIDE)

**UTILITY AND DRAINAGE EASMENT** 5. ACCESSIBLE SIDEWALK RAMP, PER

**COA STANDARD DETAIL #2418** 

PERPINDICULAR PARKING (9'X20') **CONCRETE SIDEWALK (6' WIDE)** 

8. LANDSCAPED MEDIAN, SEE

LANDSCAPE DRAWINGS FOR

TYPICAL MEDIAN LANDSCAPE 9. LANDSCAPED COMMON AREAS AND

PARKS SEE LANDSCAPE PLANS 10. PARALLEL PARKING, 8'-6" WIDE

11. 8' WIDE CROSS-WALK

12. ACCESS DRIVE ALLEY

13. LANDSCAPED BUMP-OUT

14. MONUMENT SIGN, SEE SHEET C002 15. WALL MOUNTED ENTRANCE SIGN,

SIMILAR TO MONUMENT SIGN. 16. PEDESTRIAN ACCESS 17. CROSSWALK FOR ALLEY OR DRIVE

**COURT, 6' WIDTH DIFFERENTIATE** 18. STREET TREE GRATE 4'x4' MIN.

## INDEX TO DRAWINGS

A001 SITE DEVELOPMENT PLAN FOR SUBDIVISION A002 AREA BREAKDOWNS, ZONING REQUIREMENTS AND ARCHITECTURAL DESIGN STANDARDS A003 ENLARGED AREA PLANS

**L001 LANDSCAPE PLANS** 

L002 LANDSCAPE PLANS

L003 LANDSCAPE PLANS

C001 OVERALL CONCEPTUAL UTILITY PLAN

C002 TRAFFIC DISTRIBUTION MAP

Q003 GRADING & DRAINAGE PLAN (SHEETS 1-10)

**PROJECT NUMBER:** 

Application Number :

This plan is consistent with the specific Site Development Plan approved by the Environmental Planning Commission (EPC), dated Findings and Conditions in the Official Notification of Decision are satisfied.

Is an Infrastructure List required? () Yes () No If yes, then a set of approved DRC plans with a work order is required for any construction within Public Right-of-Wayor for construction of public improvements.

DRB SITE DEVELOPMENT PLAN SIGNOFE APPROVAL

Traffic Engineering, Transportation Division	Date
Albuquerque Bernalillo County Water Utility Authority	Date
Parks and Recreation Department	Date
City Engineeer	Date
*Environmental Heath Department (conditional)	- Date
Solid Waste Management	 Date
DRB Chairperson, Panning Department	Date

\*Environmental Health, if necessary

interiors

engineering

7601 Jefferson NE Suite 100

Albuquerque, NM 87109

505 761-9700 fax 761-4222

ARCHITECT

dps@dpsdesign.org

REVISIONS	<del>"</del>
10/19/2007 EPO	C Conditions
2 03/31/2008 DR	B Comments
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DRAWN BY	raw
REVIEWED BY	
DATE	10/2/07
PROJECT NO.	07034
DRAWING NAME	

Site Development

Plan for Subdivision

SHEET NO.

### EXHIBIT B: MONTERRA DEL REY HOUSING PRODUCT TYPE BREAK DOWN (NOT TO SCALE)

### Sustainable Design Statement:

The development and design team for Monterra del Rey is designing the site plan to create a community using the guiding principles of Build Green New Mexico (BGNM). This will be accomplished through the redevelopment of infill space using the BGNM guidelines of site planning and construction implementation. The goal is to create a certified sustainable development as set forth by the BGNM. The process involves coordination and consideration from the earliest stages of the site plan design though construction and into the home ownership stage.

### Area (PDA) - Residential Areas Only

### Neighborhood Commercial shall be architecturally compatible with the adjoining residential areas and shall integrate into the residential open space and pedestrian network.

The purpose of these design standards is to establish a framework for a quality development of the subject development area shown on the development plan for subdivision. The primary goal for these design standards is to create an attractive, comfortable, safe and sustainable residential community that fosters pedestrian accessibility and creates a strong coherent and inclusive community for all residents These standards address the issues of architecture, parking, site lighting, screen walls and fences, pedestrian amenities, and signage to create the quality image desired for this development. The design standards are intended to be complimentary to the planning and design of adjacent properties.

### **Off-Street Parking:**

Off street parking spaces shall be provided in compliance with regulation 14-16-3-1 of the Albuquerque comprehensive City Zoning Code.

## On-Street Parking:

Additional parking has been provided throughout the site for visitor and resident use as the site plan.

### Massing, Exterior Wall Materials and Colors:

Exterior wall materials are to be predominately vernacular based. The varying styles of vernacular Northern New Mexico Architecture shall be the basis of a more simple and contemporary expression or interpretation for architectural design.

Articulation of massing so as not to produce a long and flat building façade is required. Special attention should be given to street facing garage facades within the town home areas of the site to vary the articulation of garage façade. An articulated top-line of buildings and the play of figure/ground will help the massing to achieve this goal. Building

The height and design of walls, fences and retaining walls shall comply with Section massing shall also promote pedestrian site access.

The use of a stucco wall finish system (or synthetic version thereof) shall be the predominate material for buildings to reinforce the Northern New Mexico vernacular architectural expression.

Exterior wall color shall reflect a consistent overall palette of earth-based tones for the field colors, however; more saturated earth-based tones with a much wider color palette range is providing landscaped access ways to and from the site as well as within the sight. permitted for accent colors. This is intended to add vitality to the rich mix of housing types in the area.

Exterior detail trim such as shade canopies, trellises, open railings, pitched roof elements, parapet cornicing, lintels, etc. should be consistently detailed throughout the site to complement the overall architecture and to help to break up any long facades.

### **Roof Materials and Colors:**

Roof materials may vary with the New Mexico vernacular expression from flat roof (low 1 slope) with parapet, to metal roof and clay or concrete tile roof. Low reflectivity is required. Asphalt shingles are not permited.

### Site Lighting:

In order to enhance the safety, security and visual aesthetics, careful consideration must be given to both the daytime and nighttime appearance of the lighting design and fixtures. The  $\frac{2}{3}$ primary design objective of the site lighting system shall maximize public safety while not affecting adjacent properties, buildings or roadways with unnecessary glare or reflection. In  $\frac{21}{12}$ order to accomplish the lighting goals, the following guidelines shall be required for the design of the lighting system:

- Placement of fixtures and standards shall conform to state and local safety and
- pollution of the existing "Dark Sky."
- Area light fixtures shall be full cut-off design with no visible light source above a horizontal line projected from the bottom of the fixture housing. Building mounted fixtures shall also comply with this requirement.
- The height of street lights and parking area lights shall be kept to a minimum necessary to meet safety requirements. • The maximum height of light poles other than street lights shall be 16' in, and within
- 100', of a residential zone. Individual site lighting shall blend with the architectural character of the buildings and other site fixtures.
- Parks and landscaped walkways shall have pedestrian-scale lighting.

All lighting on site will be pursuent to the New Mexico Night Sky Ordinance.

### Placement of Mechanical Units:

Only pad mounted mechanical units will be permitted for new construction. Mechanical units must be screened from view, walls and/or landscape materials may be used for screening of mechanical units.

All residents to have COA rolling refuse containers. Storage for containers must be provided outside the home and must be screened from view to street.

### Walls/Fences:

Perimeter walls and fencing are allowed on the property. However efforts shall be made to lessen the visual impact of the walls or fencing through the use of landscaping and the Adesign and location of openings.

- A Barbed wire, concertina wire and plastic/vinyl fencing are prohibited. Standard gray CMU walls shall be prohibited
- Internal fences separating building lots are allowed, acceptable materials would include masonry block, block with stucco, split face block, stone, painted tube steel, chain link or a combination of fence and/or wall. The maximum height for internal fences
- separating building lots shall be 6 feet. • Interior fences will not be allowed within 20' of the front property line.
- Clear sight distances shall be maintained at all driveway/entrance locations. • The design, material and color of interior walls and fences shall be compatible with the architecture of the housing in their respective area of the site (Areas 1-5) to ensure a harmonious design.

Site walls will incorporate variations in type of block and color of block in order to break up the appearance of a straight wall. Open iron fencing will be incorporated into the wall at needed. Both perpendicular parking and parallel parking have been provided as shown on common space locations to help in breaking up the mass of the wall. (See Conceptual Site Wall Drawings on this sheet)

- Perimeter fences for the entire site shall be colored concrete block with openings as required for pedestrian access to and from the site. The maximum height for the Perimeter fence shall be 6 feet in compliance with Section 14-16-3-19 of the Zonina
- Clear sight distances shall be maintained at all driveway/entrance locations.

Site and patio walls should reflect the same use of stucco finish to complement that of the buildings, or may contrast the building finish by use of exposed split-face CMU.

14-16-3-19 of the Zoning Code Pedestrian Amenities:

The creation of a pedestrian-friendly environment will depend on creative site design and will be a primary design objective for this project. Objectives to achieve this goal include. but are not limited to, maintaining a high quality and consistency in style for site amenities, including benches, parks, walkways, landscaping and lighting. Other objectives include

Parks and open spaces will be equiped with shade shelters, play structures and benches as shown on Landscape Drawings.

Traffic calming techniques such as "bump-outs" at intersection corners, on street parking and alternative paving materials at pedestrian crossings shall be incorporated into the design of the site. In addition, "bump-outs" will provide a space for cluster mailboxes as deemed necessary by the USPS.

### Landscaping:

All landscaping shall be in accordance with the Build Green New Mexico Guidlines and shall be of native materials and water conserving as required. All landscaping and pedestrian ammentities within public areas and shared private drives shall be maintained by a Home Owners Association. All landscaping should also meet COA requirements.

common spaces to be impated using the Cith of Albuquerque's non-potable water line.

Lanscaped breezeways abbutting the site wall shall provide pedestrian access as well as a visual opening. Gates are acceptable, provided they can be opened from either side.

### Signage:

All signage shall conform to the City of Albuquerque sign code (14-6-3-5). This project • All lights shall be shielded source to prevent spillage onto adjoining properties or light shall have two monument signs, one at each vehicular entrance to the community located in the median of the boulevard at the western end of the property. There shall be four additional wall mounted signs, one at each of the remaining vehicular entrances into the property. See Conceptual Monumant Sign and Site Wall on Sheet A002.

### **Design Review and Enforcement:**

All enforcement and approval of these Design Guidlines shall be under the authority of the Home Owners Association. This does not preclude compliance with COA Zoning Code and Development Review Procedures.

### **⚠** GENERAL NOTES:

- The site development plan for building permit for the commercial lot and any ammendments to the site development plan for subdivision for Area 1 (affordable housing) shall require EPC approval. Future site development plans for the residential lots may proceed directly to building permit.
- Minor amendments to this Site Development Plan for Subdivision shall be approved by the Planning Director in accordance with the Albuquerque Comprehensive City Zoning Code. Major amendments to this Site Development Plan for Subdivision shall be approved by the Environmental Planning Commission.

### Area 1 Area 2 Area 3 Area 4 Area 5 Area 6 ingle Family Detached Single Family Detached Green Court Single Neighborhood Description Affordable Housing aired Town Homes Aultiple Town Homes **Approximate Acres** 8.39 acres (5.6 du) 7.16 acres (8.7 du) 9.62 acres (10.6 du) 6.73 acres (8.9 du) 2.4 acres Number of Lots 141 SU-1 for PDA (C1 and **Zoning Districts** <u>U-1 for PDA (R1)</u> U-1 for PDA (R-T) SU-1 for PDA (R-T) SU-1 for PDA (GC) SU-1 for PDA (R1) Single family detached A-Permisive Uses nomes and Mobile Single family detached Single family paired town | Single family multiple Single family detached lomes (1 per lot)\* homes - GreenCourt\* nomes (1 per lot)\* attached town-homes\* Minimum Lot Width C-Height (\*26' Maximum except as permitted in Zone Code Section 14-16-3-3 26' Maximum\* 2,700 sqft D-Lot Size E-Setbacks )' from Green Court, see 2' from Drive Court, see 15' from edge of alley Back *E3/A003* ' from side adjacent to other homes, 10' from 11 streets or property lines adjacent to next quad. and at boundry of housing type, see 5' minimum on interior of 10' on corner lots, lots and 8' on street side adjacent to street. 10' 8' on street side of corner (5' interior), 10' on street E3/A003 Per COA Zoning Code Per COA Zoning Code Per COA Zoning Code Per COA Zoning Code F-Off-Street Parking Section 14-16-3-1 ? spaces per DU Based on use G-Usable Open Space 550 sqft on site per lot 360 sqft on site per lot Based on use Zero lot line setback for permited non-occupied structures (ex. Detached garage), along the left This is a newhousing side of the property when product, see Exhibit D this sheet. Max FAR .6 Text in ITALIC indicates a proposed change to the COA Comprehensive Zoning Code.

## **EXHIBIT C: MONTERRA DEL REY ZONING CODE BREAKDOWN** (NOT TO SCALE)

PACE BECOMES THE ATE SPACE FOR THE FOR THE BACK HOME IARED EASMENT THIS COMES THE PRIVATE OR THE FRONT HOME \*Uses not permitted for R-1 and R-T Residential Zoning Use:

Based on Section 14-16-2-6 R-1 Residential Zoning, the following uses are not permitted under the Special Use Permit for Planned Development Area for Monterra Del Rey Project.

### Accessory Uses not allowed: 1. Agricultural animal keeping, for noncommercial purposes, as follows: rabbits and similar animals, poultry, pigeons.

6. Wireless Telecommunications Facility

- Recreational vehicle, boat, or boat-and-boat trailer parking restricted by covenants 4. Trailer parking allowed if screened from public view, as described in covenants. 5. Public school, including caretaker's mobile home.
- Conditional Uses not allowed:

3. Public library

- 1. Accessory living quarters 2. Health care, including physicians, massage, therapy, etc. (but not nursing homes
- 4. Public utility structure 5. Recreational facility (non-profit), such as community center, swimming pool, tennis club. 6. Second kitchen within a house.

\*\*Uses not permitted for C-1 and O-1:
Based on Section 14-16-2-16 C-1 Neighborhood Commercial Zoning. The following uses are not permitted under the Special Use Permit for Planned Development Area for

- Permissive Uses not allowed Antenna, up to 65 feet in heigh Park and ride temporary facilit
- Public utility structure Retail sales of the following goods, plus incidental retailing of related goods and incidental service or
- b. Christmas trees, including outside sales, provided the use is limited to 45 days in one calendar
- c. Gasoline, oil, liquifed petroleum gas, including outside sales. d. Hardware, building materials, provided it is in a completely enclosed building.
- a. Automobile, bicycle and motorized bicycle (moped) repairing, but no body work,
- c. Parking lot, as regulated in the O-1 zone

### 7. Wireless Telecommunications Facility

Conditional Uses not allowed 2. Community Residential Program except not either Community Residential corrections program or Community residential program for substance abusers.

- 3. Auto, trailer, and truck rental, service, storage. 4. Drive-up service window, except where listed as permissive in this zone, provided that the vehicle
- movement plan is approved by the Traffic Engineer, and further provided that the service window in existence upon the effective date of this Zoning Code shall be considered as approved conditional uses. 5. Fireworks sales
- 7. Outdoor storage or activity
- 8. Park-and-ride joint use facilities 9. Public utility structure
- 10. Use or activities in a tent.
- Wireless Telecommunications Facility, Roof-Mounted, up to 20 feet above the parpet of the


### EXHIBIT D: MONTERRA DEL REY GREEN COURT HOUSING LAYOUT (NOT TO SCALE)

AREAS AND OVERALL LENGHT OF WALL

VEHICULAR ACCESS IS GAINED THROUGH THE REAR

DRIVEWAY LAYOUT (TO BE MAINTAINED BY HOA)

OF THE HOMES WHICH FEATURE A SHARED

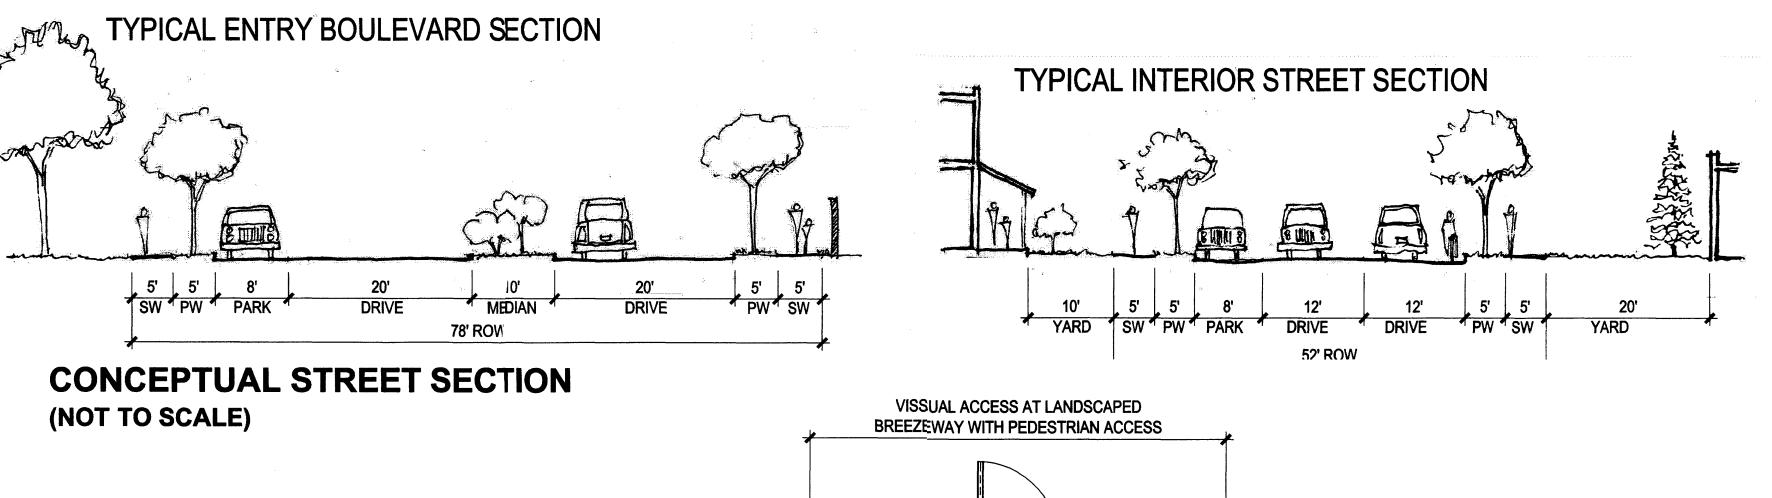

**PRIVATE SIDE OF WALL** \_\_\_\_\_\_ **A PUBLIC SIDE OF WALL** PROVIDE PEDESTRIAN GATE WITH ACCESS FROM BOTH SIDES STONE CAP AND ACCENT **TUBULAR STEEL "LOOKOUT PAINT** PILASTERS, STYLE AND COLOR TBD **COLOR TBD TO MATCH STUCCO** 

PRIMARY FIELD COLOR **TUBULAR STEEL FENCE WITH** - STUCCO ACCENT MASONRY PAINT TBD PEDESTRIAN ACCESS GATE DISTANCE TBD BY LOT LINES, COMMON COLOR TBD

PEDESTRIAN ACCESS AT STUB

**A CONCEPTUAL SITE WALL** (NOT TO SCALE)

**HOMES SIT ALONG A SHARED** 

**GREEN SPACE (OR TO STREET** 

LANDSCAPED GREEN SPACE, THE FRONT

DOORS ARE ACCESSED FROM THIS

STREET WITHIN BLOCK M SHALL BE **SIMILAR TO OPENING AT BREEZWAYS** WITH GATES PROVIDED AT EACH SIDE WALK LOCATION.

7601 Jefferson NE Suite 100 Albuquerque, NM 8710 505 761-9700 fax 761-4222 dps @ dpsdesign.org **ARCHITECT** 

planning

engineering


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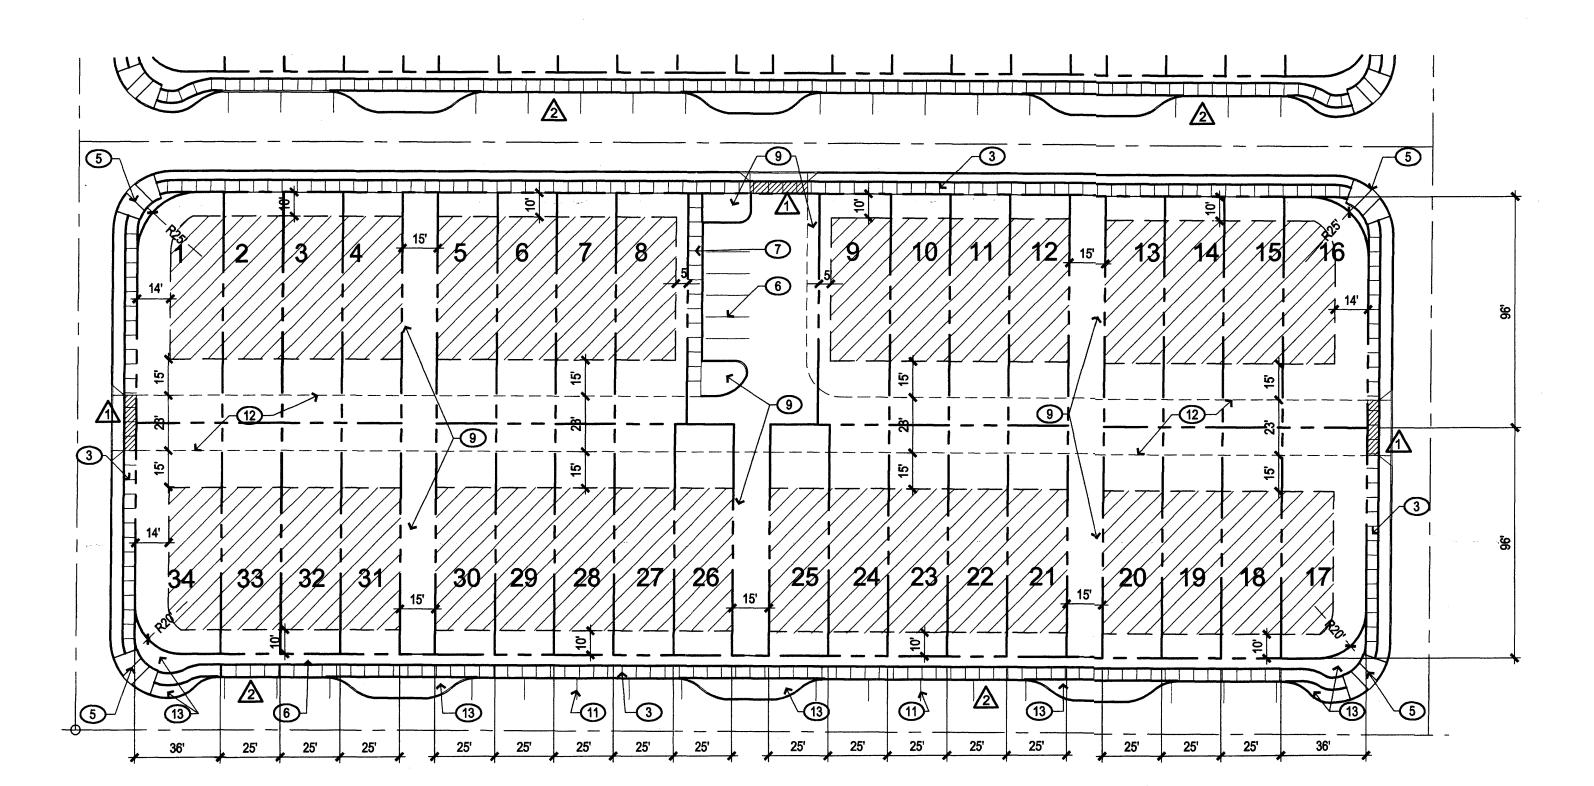
1 10/19/2007 EPC Conditions 2 04/13/2008 DRB Comments

**DRAWN BY REVIEWED BY** DATE PROJECT NO. DRAWING NAME


Architectural Design Guidlines, Area Break **Downs and Zoning** 





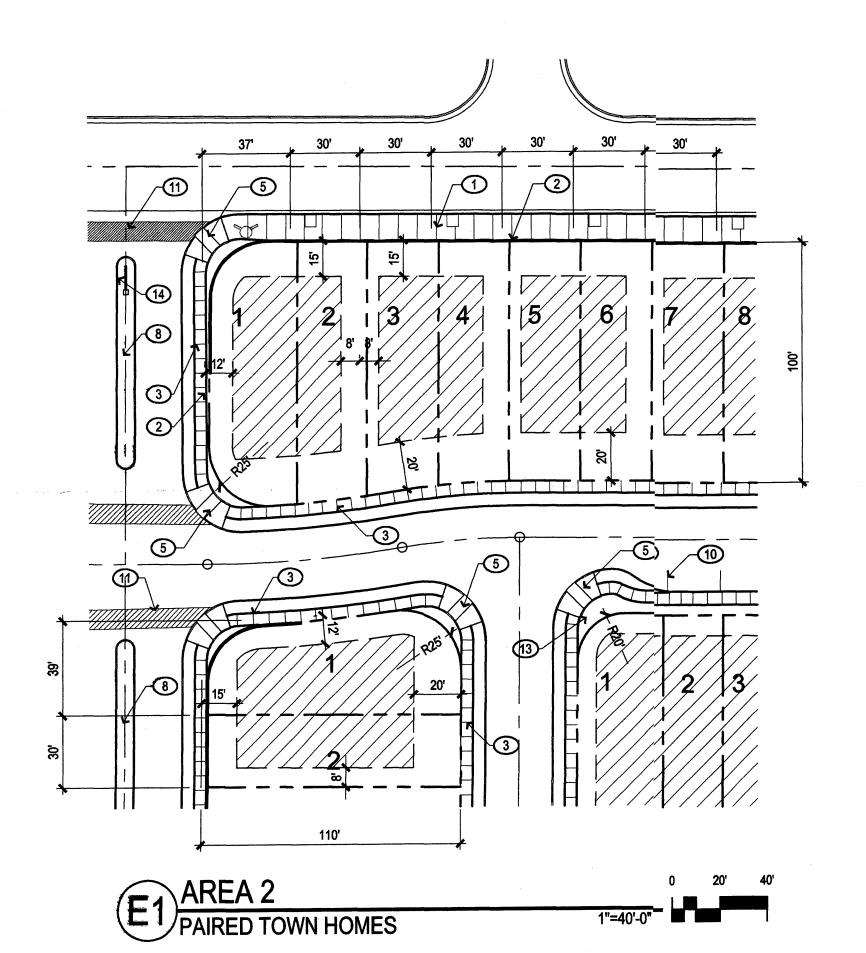

B2 AREA 3
MULTIPLE TOWN HOMES

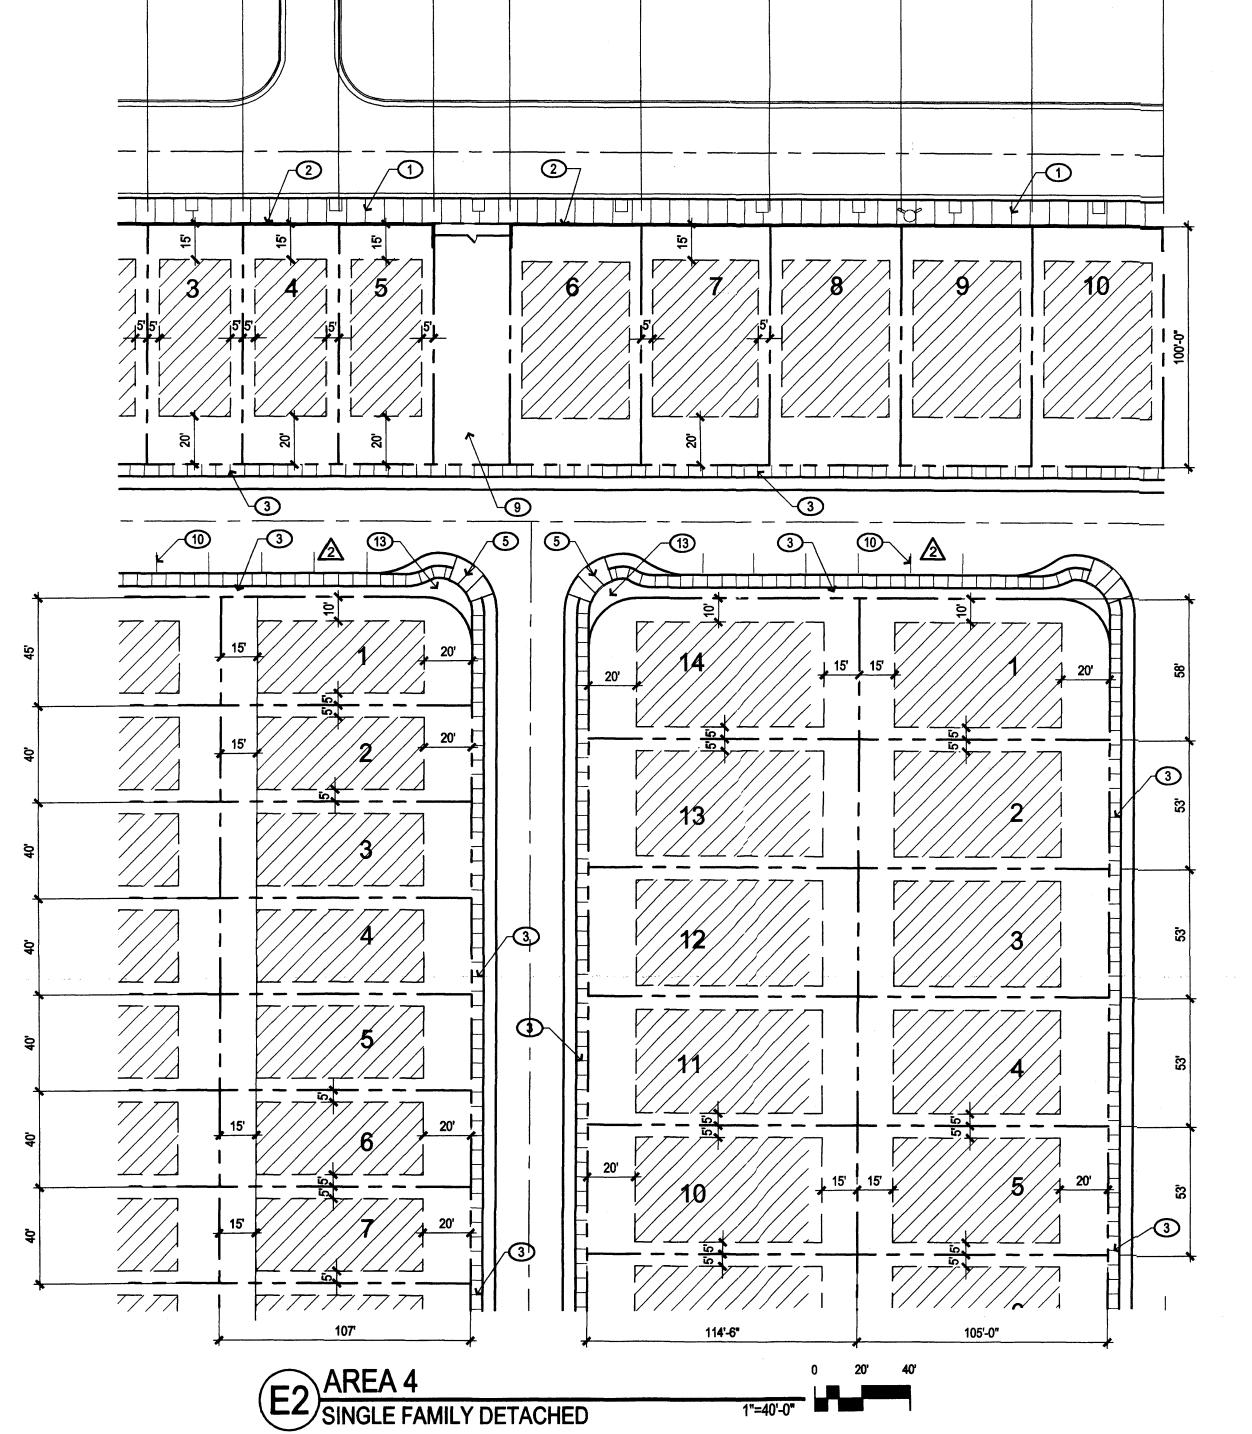

# KEYED NOTES

- 1. CONCRETE SIDEWALK (WIDTH
- **VARIES)**
- 2. CMU SITE WALL, SEE XX/XXX
- 3. CONCRETE SIDEWALK (5' WIDE) 4. UTILITY AND DRAINAGE EASMENT
- 5. ACCESSIBLE SIDEWALK RAMP, PER
- COA STANDARD DETAIL #2418
- 6. PERPINDICULAR PARKING (9'X20')
- 7. CONCRETE SIDEWALK (6' WIDE) 8. LANDSCAPED MEDIAN, SEE XX/XXX
- 9. LANDSCAPED COMMON AREAS AND
- PARKS SEE LANDSCAPE PLANS (TO BE MAINTAINED BY H.O.A.)
- 10. PARALLEL PARKING 11. 8' WIDE CROSS-WALK
- 12. ACCESS DRIVE ALLEY (PRIVATE, TO
- **BE MAINTAINED BY H.O.A.)** 13. LANDSCAPED BUMP-OUT
- 14. MONUMENT SIGN, SEE SHEET A002
- 15. WALL MOUNTED ENTRANCE SIGN, SIMILAR TO MONUMENT SIGN

### **GENERAL NOTES**

- A. SEE LANDSCAPE SHEETS LOO1 AND L002 FOR TYPICAL LANDSCAPES AND FOR COMMON SPACE LANDSCAPE LAYOUT. (ALL LANDSCAPE

AREAS TO BE MAINTAINED BY H.O.A.) B. SEE EXHIBIT C ON SHEET A002 FOR FULL ZONING

REQUIREMENTS FOR EACH AREA.

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engineering

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dps@dpsdesign.org


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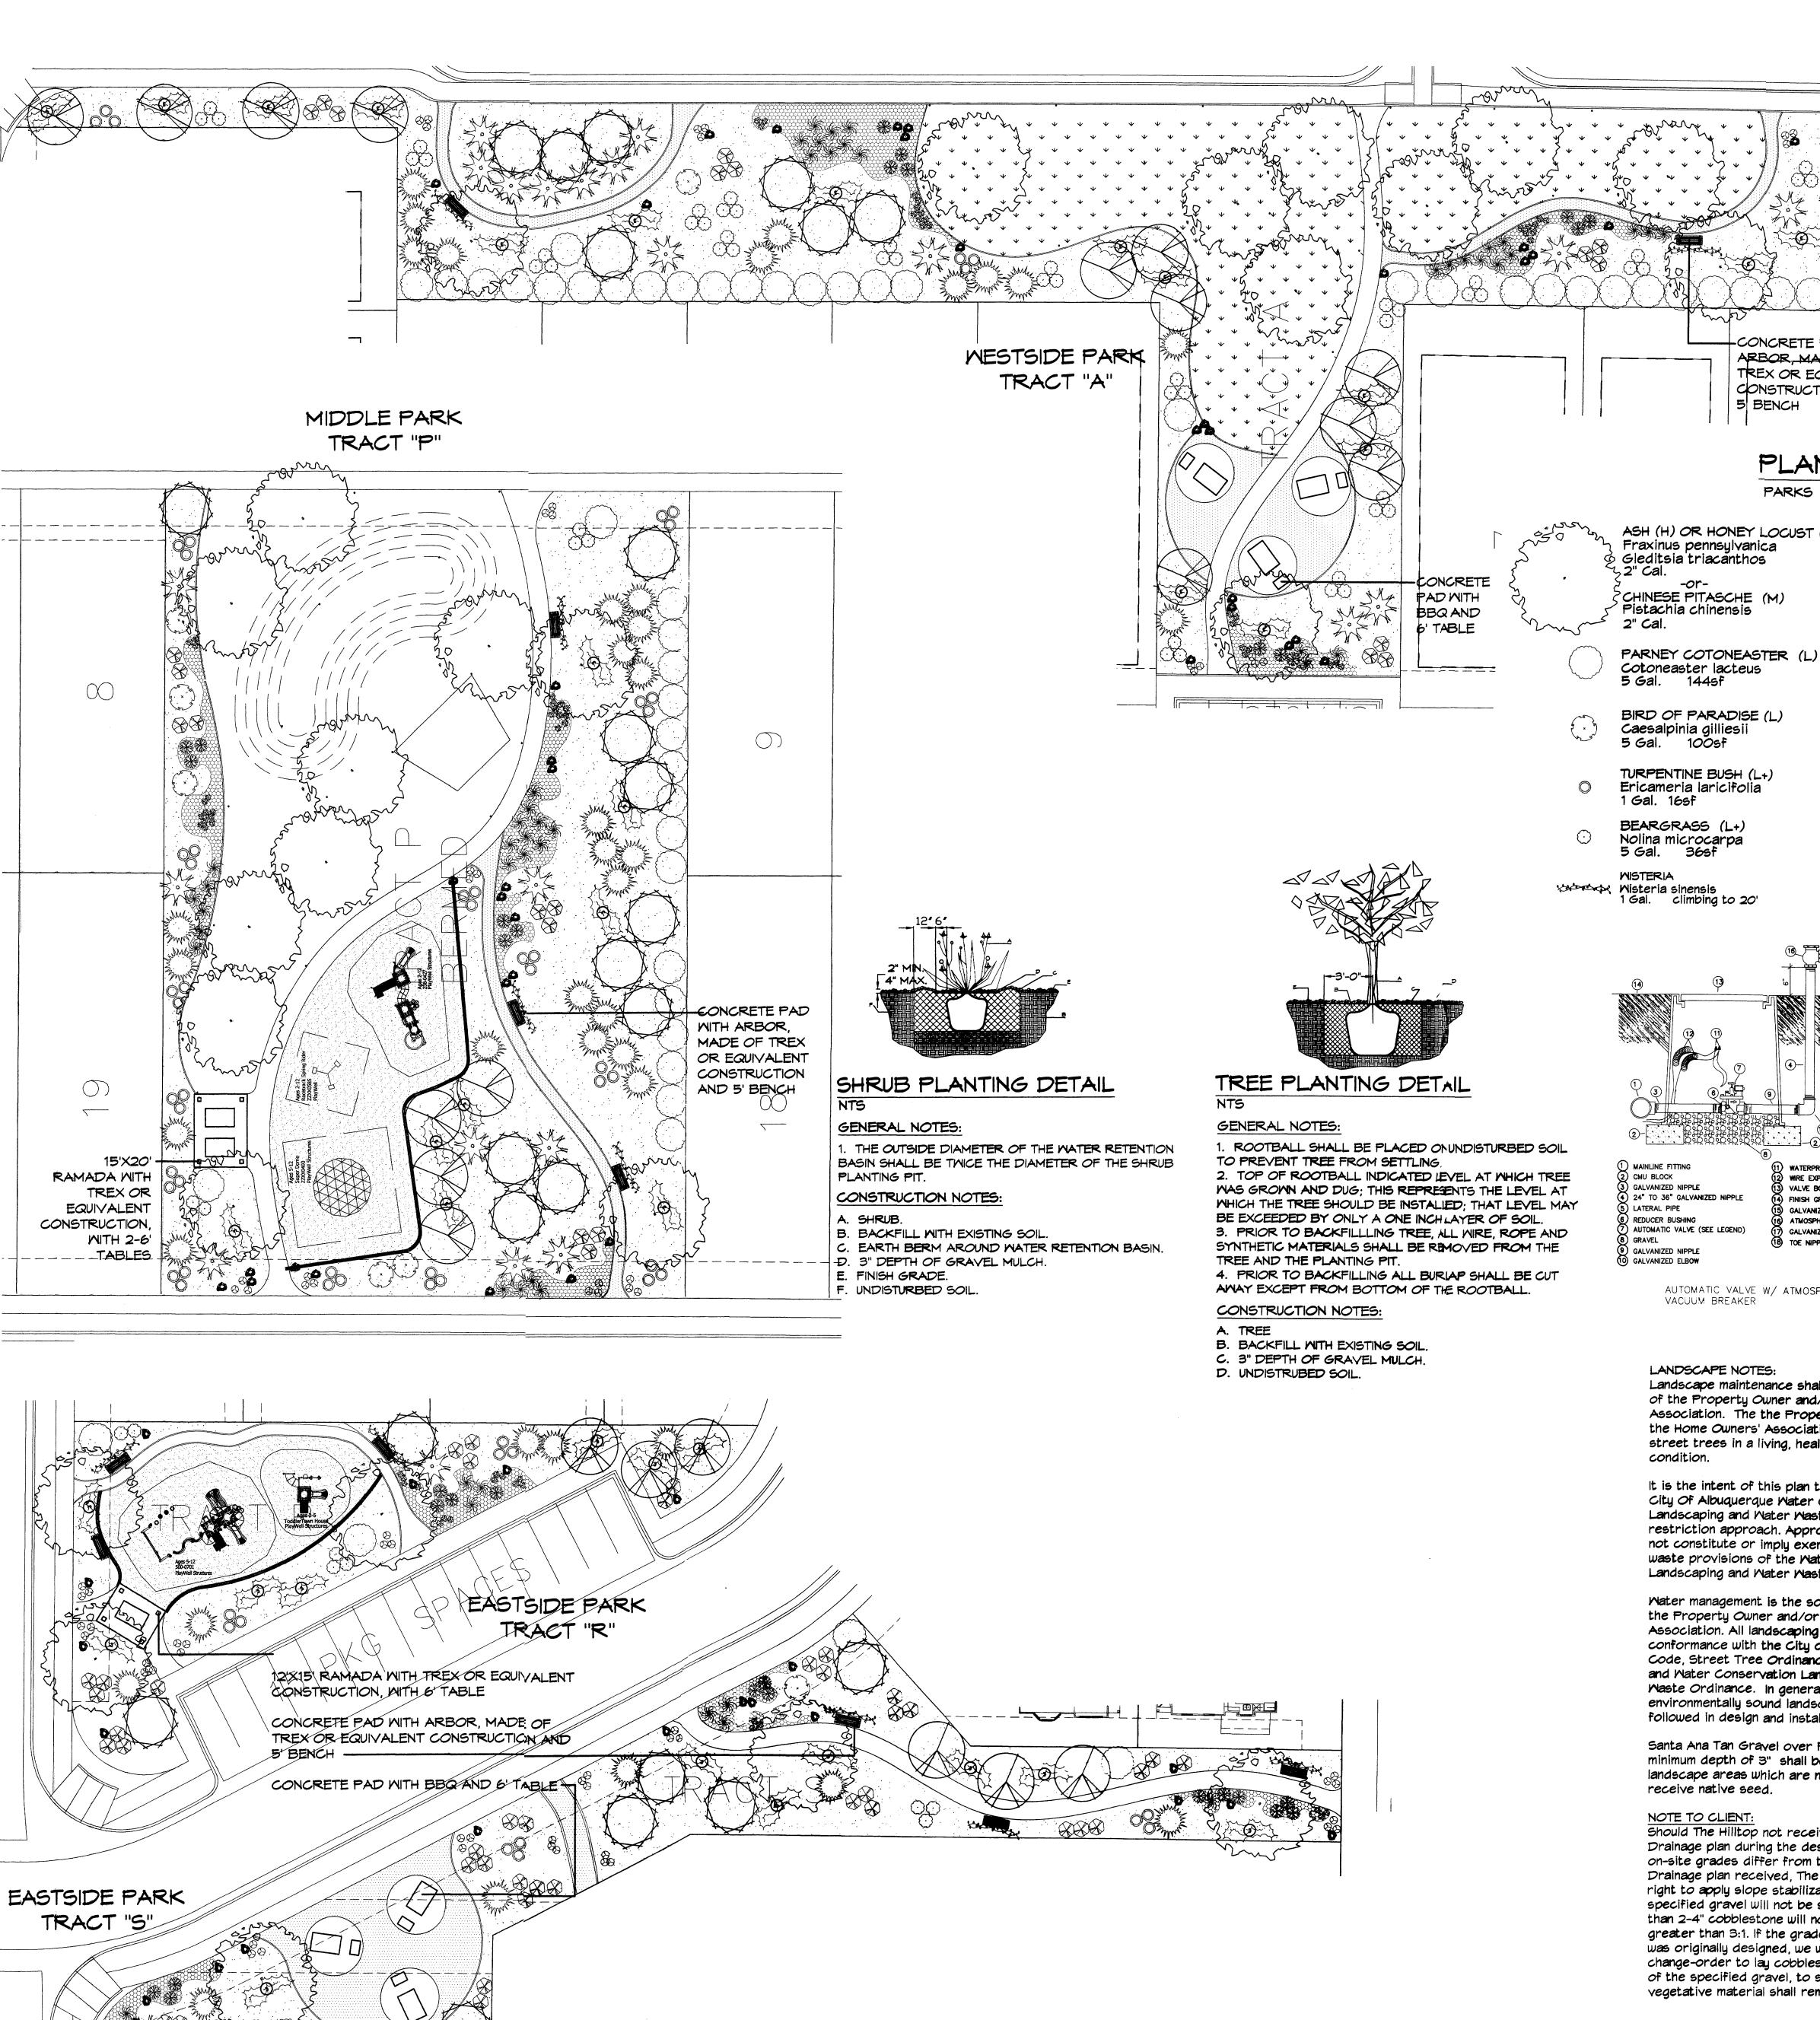
DRAWN BY REVIEWED BY 07034 PROJECT NO.

Site Development Plan for Subdivision Enlarged Area Plans

DRAWING NAME

SHEET NO. A003



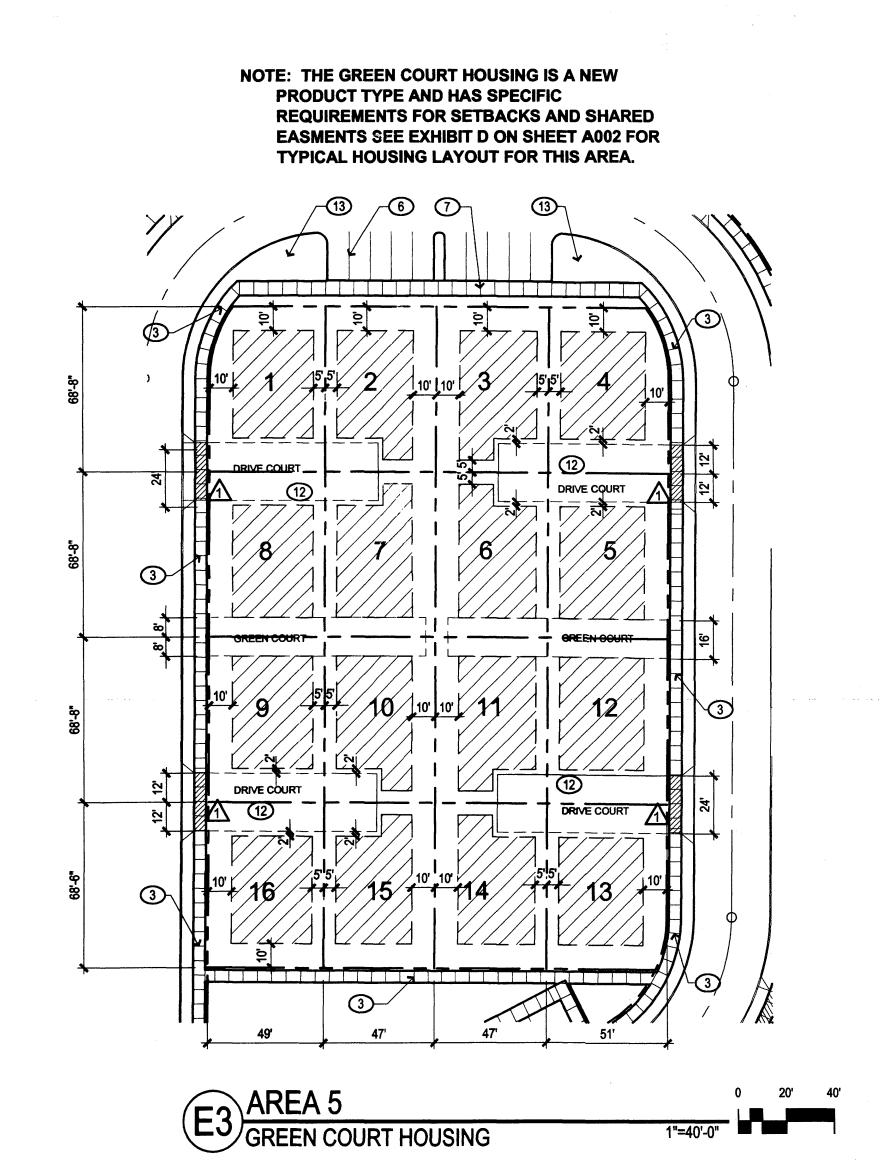



TOTAL BED PROVIDED square feet GROUNDCOVER REQ. 75% square feet TOTAL GROUNDCOVER REQUIREMENT 34032 square feet TOTAL GROUNDCOVER PROVIDED 34243 (75%) square feet

### PLANT LEGEND PARKS

CONCRETE PAD WITH

TREX OR EQUIVALENT

CONSTRUCTION AND

ARBOR, MADE OF

5 BENCH

ASH (H) OR HONEY LOCUST (M) Fraxinus pennsylvanica Gleditsia triacanthos

CHINESE PITASCHE (M) Pistachia chinensis 2" Cal.

BIRD OF PARADISE (L) Caesalpinia gilliesii

TURPENTINE BUSH (L+) Ericameria laricifolia

BEARGRASS (L+) Nolina microcarpa 5 Gal. 36sf

EASTERN REDBUD (M) Cercis canadensis 2" Cal., 30' H x 30' M

> SPANISH BROOM (M) Genista hispanica 5 Gal. 165f

Chamaebatiaria millefolium

Symbol indicates 3 plants

HEAVY DUTY
POLYSULFONE
POPETS are designed to
provide reliable
amd long life\_\_

BONNET is vandal resistant. It cannot be removed by rotating the canopy\_\_\_

TEST COCKS are vandal—

resistant reducing damage caused by normal tampering experienced in the field

DOUBLE GUIDED
CHECK ASSEMBLY
reduces check valve
fouling and chattering
thereby providing long
life and reliable
operation\_\_\_\_

FULL PORT SHUTOFF
VALVES minimize head
loss through the device\_\_\_\_

ALL BRONZE BODY provides durability and long life.

PAMPAS GRASS (M) Cortaderia selloana 5 Gal. 100sf FERNBUSH (L+)

5 Gal. 25sf CREEPING ROSEMARY (L) Rosmarinus officinalis 'Prostrata'

VITEX (M) Vitex agnus-castus 15 Gal. 225 sf, 20' H x 20' W NEW MEXICO OLIVE (L) Forestiera neomexicana 15 Gal. 225sf, 15' H x 15' W

Miscanthus sinensis 5 Gal. 16sf

SAND DROPSEED (L) Sporobolus cryptandrus

> Stipa tennuisima 1 Gal. 45f

MAIDENGRASS (M)

THREADGRASS (L+)

MILDFLOWER

NATURAL EDGE

COMMERCIAL GRADE STEEL EDGE 6" CONCRETE MONCURB

engineering

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Albuquerque, NM 87109

505 761-9700 fax 761-4222

ARCHITECT

PROJECT

el

onterra

dps @ dpsdesign.org

LOW MATER MEADON GRASSES WITH WILDFLOWERS AND STRETCH IRRIGATION

SANTA ANA TAN GRAVEL WITH FILTER FABRIC


COMPACTED SANTA FE BROWN CRUSHERFINE PATH

> COBBLESTONE ACCENT WITH FILTER FABRIC

COMPACTED GREY

CRUSHERFINE PATH

BIO-ENGINEERED WOODFIBER/COMPACTED 12" DEPTH/ ADA ACCESSIBLE

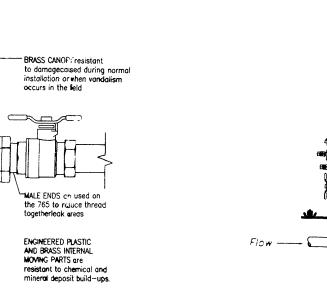

2" above the highest downstream outlet and the highest point in the downstream piping FEBCO MODEL 765 Pressure Vacuum Breaker Outside Installation

LANDSCAPE NOTES:

VACUUM BREAKER

Landscape maintenance shall be the responsibility of the Property Owner and/or the Home Owners' Association. The the Property Owner and/or the Home Owners' Association shall maintain street trees in a living, healthy, and attractive condition.

AUTOMATIC VALVE W/ ATMOSPHERIC

WIRE EXPANSION LOOPS

GALVANIZED STREET ELL

GALVANIZED NIPPLE - 18" TO 24" LENGTH

ATMOSPHERIC VACUUM BREAKER

TOE NIPPLE OR MALE ADAPTER

FINISH GRADE

It is the intent of this plan to comply with the City Of Albuquerque Water Conservation Landscaping and Water Waste Ordinance planting restriction approach. Approval of this plan does not constitute or imply exemption from water waste provisions of the Water Conservation Landscaping and Water Waste Ordinance.

Water management is the sole responsibility of the Property Owner and/or the Home Owners' Association. All landscaping will be in conformance with the City of Albuquerque Zoning Code, Street Tree Ordinance, Pollen Ordinance, and Water Conservation Landscaping and Water Maste Ordinance. In general, water conservative, environmentally sound landscape principles will be followed in design and installation.

Santa Ana Tan Gravel over Filter Fabric to a minimum depth of 3" shall be placed in all landscape areas which are not designated to receive native seed.

NOTE TO CLIENT:

Should The Hilltop not receive a Grading and responsibility of the Developer/Builder. Drainage plan during the design process or the on-site grades differ from the Grading and Drainage plan received. The Hilltop reserves the right to apply slope stabilization materials where the water will be used to irrigate common areas. specified gravel will not be suitable. Gravel smaller than 2-4" cobblestone will not stay on a slope greater than 3:1. If the grades are greater than what was originally designed, we will request an infield change-order to lay cobblestone or rip-rap, in lieu of the specified gravel, to stabilize the slope. All vegetative material shall remain per plan.

IRRIGATION NOTES:

Irrigation shall be a complete underground system with Trees to receive 1 Netafim spiral (50' length) with 3 loops at a final radius of 4.5' from tree trunk, pinned in place. Netafim shall have emitters 12" o.c. with a flow of .6 gph. Shrubs to receive (2) 1.0 GPH Drip Emitters. Drip and Bubbler systems to be tied to 1/2" polypipe with flush caps at each end. Trees and shrubs shall be on separate

FEBCO MODEL 765

Pressure Vacuum Breaker Features

Run time per each shrub drip valve will be approximately 15 minutes per day. Tree drip valve shall run 1.5 hours, 3 times per week. Run time will be adjusted according to the


Point of connection for irrigation system is unknown at current time and will be coordinated in the field. Irrigation will be operated by automatic controller.

and power source for controller to be provided by others. Irrigation maintenance shall be the

Location of controller to be field determined

responsibility of the Property Owner and/or the Home Owners' Association. Water and Power source shall be the

Site will be connected to the City of Albuquerque's non-potable water line and this

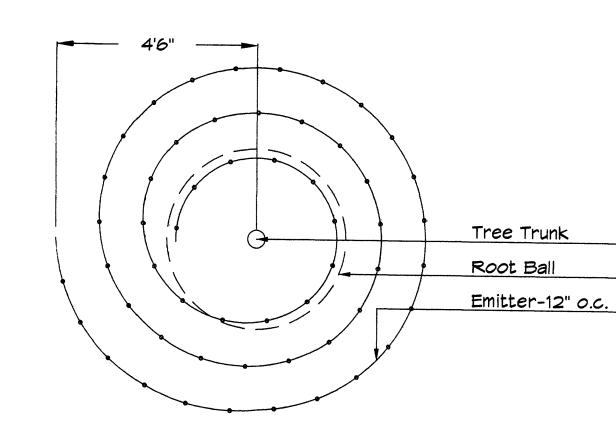


Netafim Spiral Detail

GRAPHIC SCALE

20 10 0 10 20

SCALE: 1"=20'

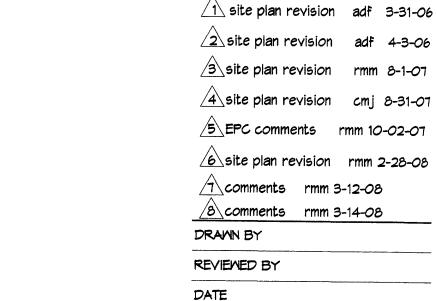

PROJECT NO.

DRAWING NAME


LANDSCAPE ARCHITECTS & CONTRACTORS Cont. Lic. #26458 7909 Edith N.E.

Albuquerque, NM 87184 Ph. (505) 898-9690 Fax (505) 898-7737 cjohnson@hilltoplandscaping.com All creative ideas contained Herein remains the property of The Hilltop Landscape Architects and Contractors and are protected by copyright laws. This is an original design and must not be released or copied unless applicable fees have been paid or job order

07034

10 comments/site plan rmc 4-11-08

9 comments rmm 3-21-08

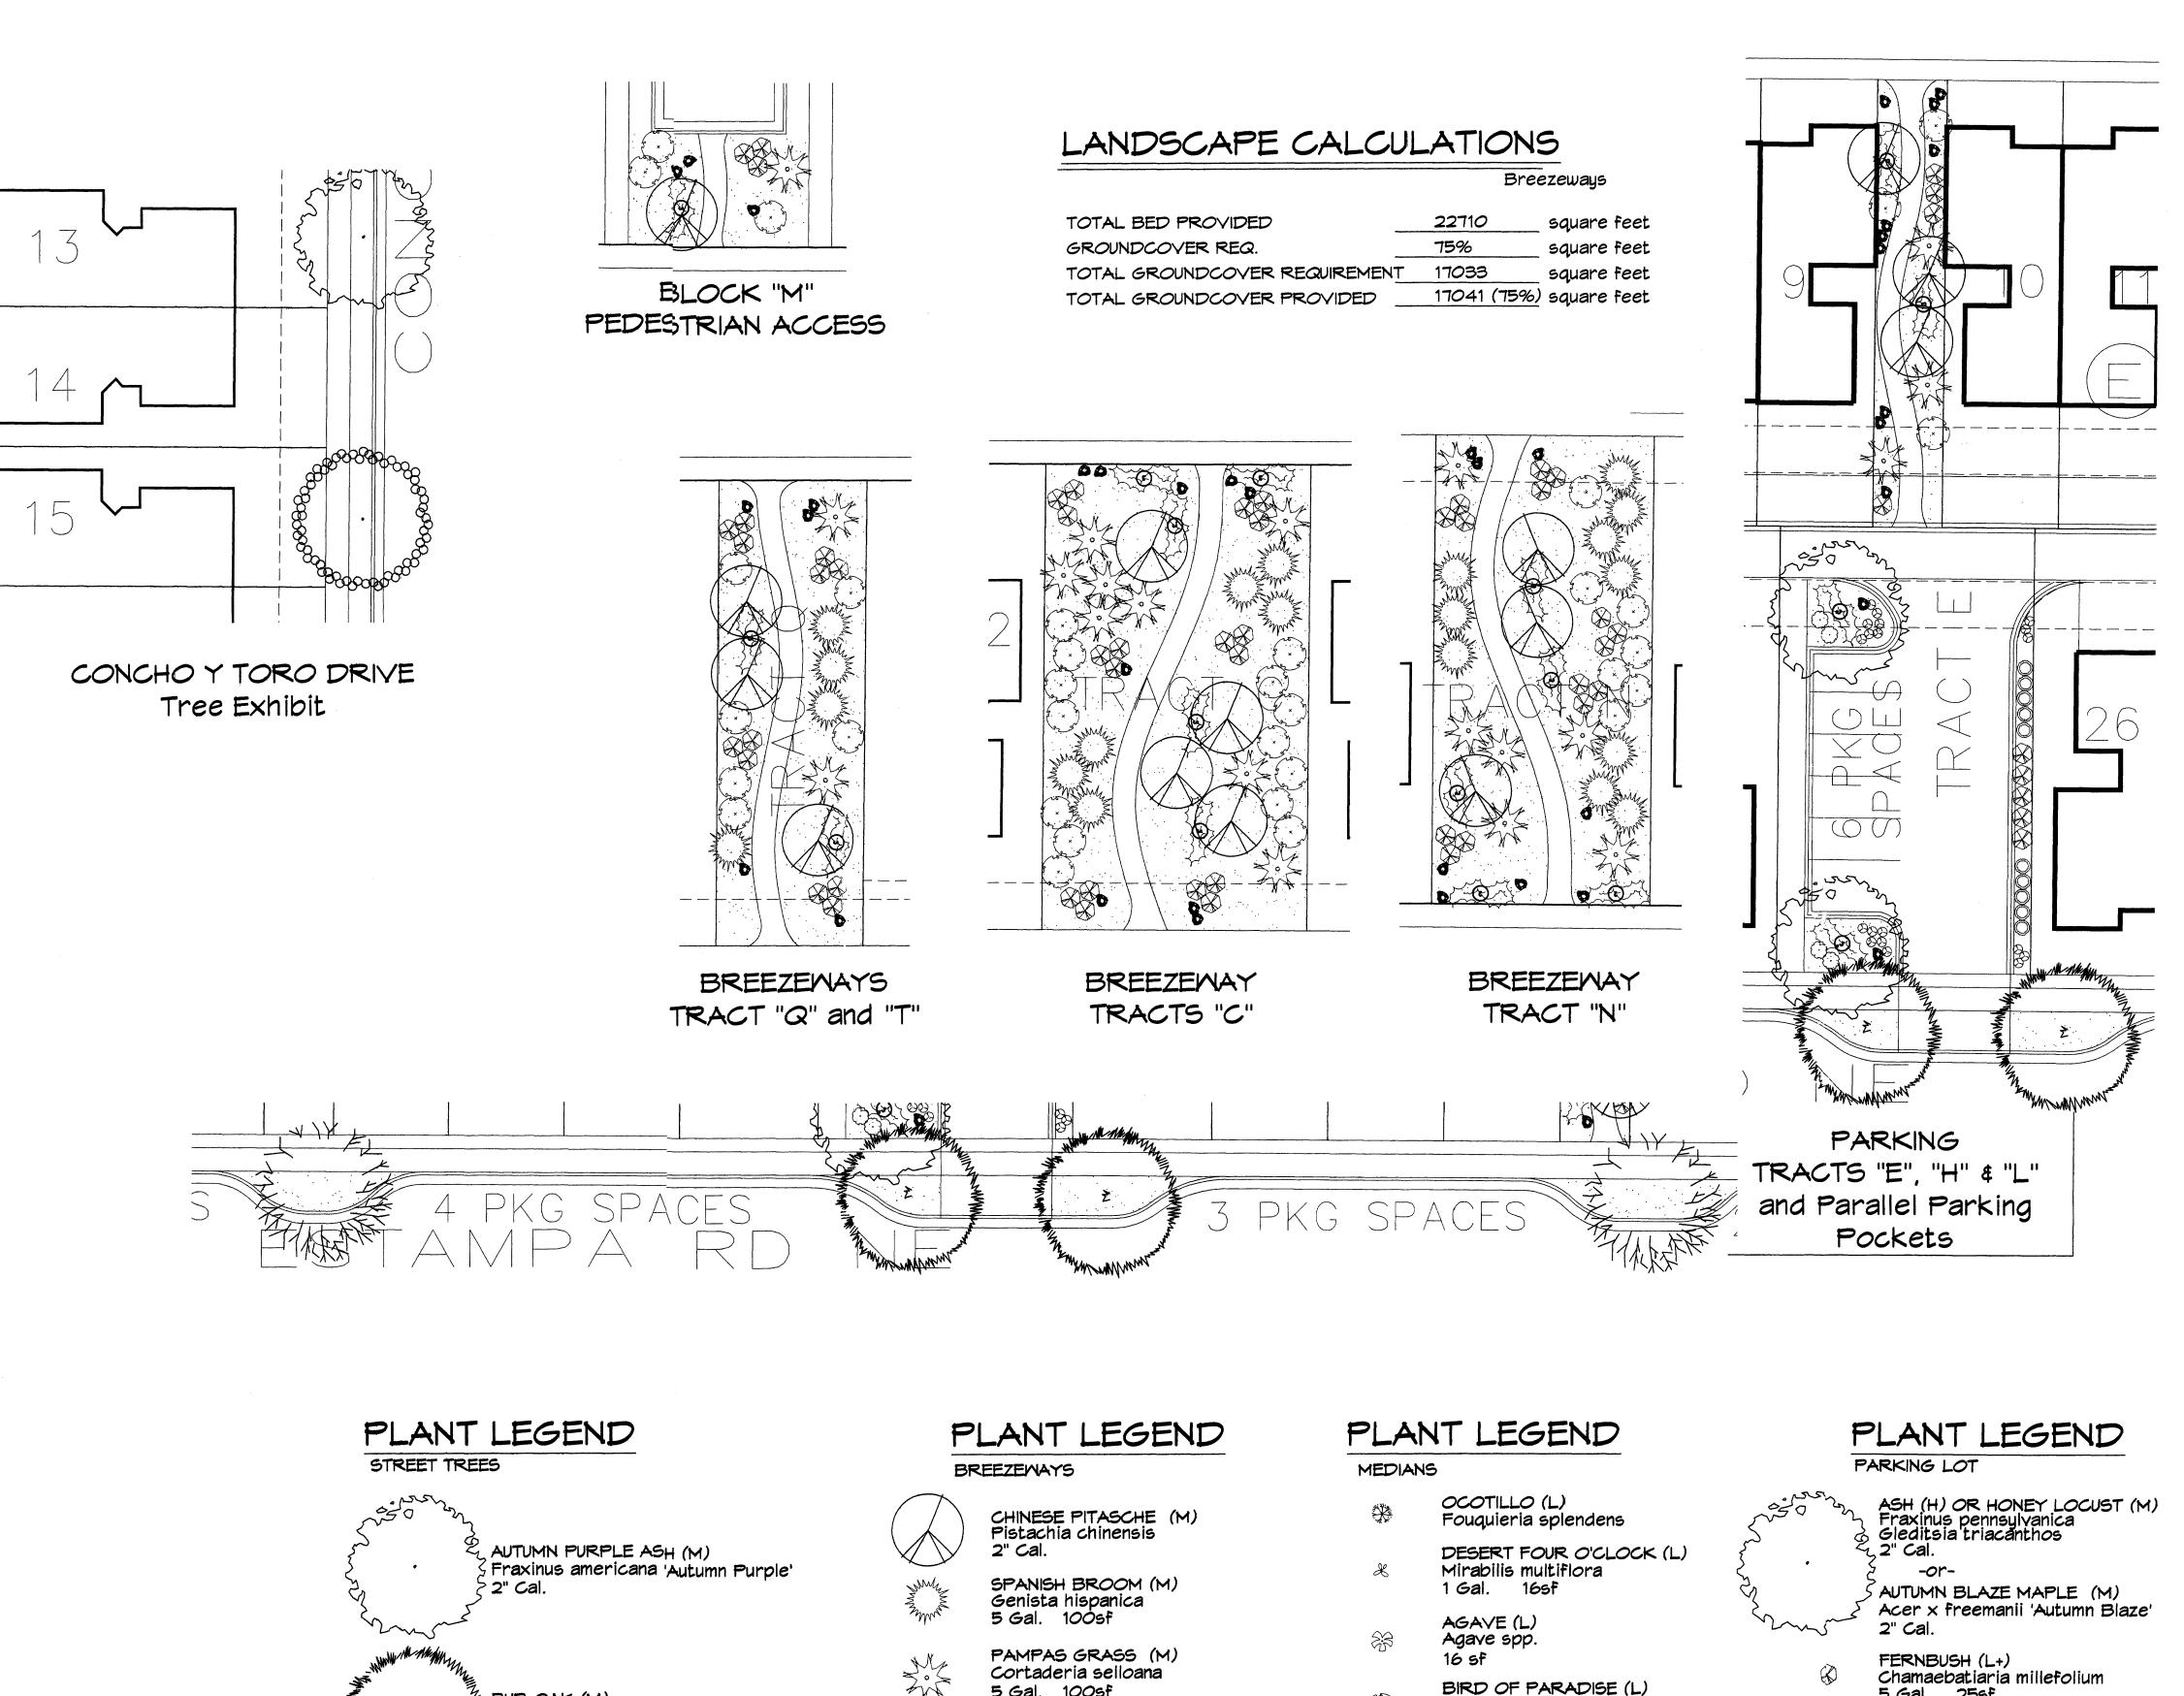

5 Gal. 100sf

BIRD OF PARADISE (L)

Chamaebatiaria millefolium

CREEPING ROSEMARY (L) Rosmarinus officinalis 'Prostrata' Symbol indicates 3 plants 1 Gal. 36sf

Caesalpinia gilliesii 5 Gal. 100sf

FERNBUSH (L+)

5 Gal. 25sf


Caesalpinia gilliesii


APACHE PLUME (L) Fallugia paradoxa 5 Gal. 25sf

Chrysothamnus nauseosus

5 Gal. 100sf

CHAMISA (L)

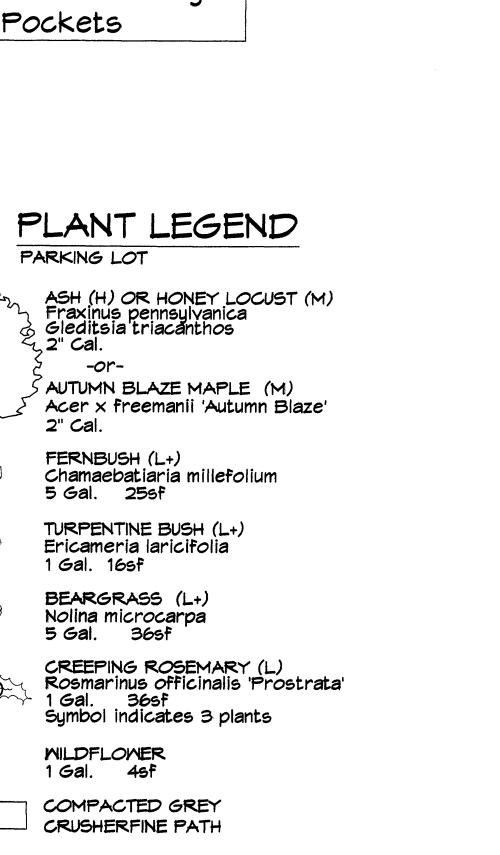


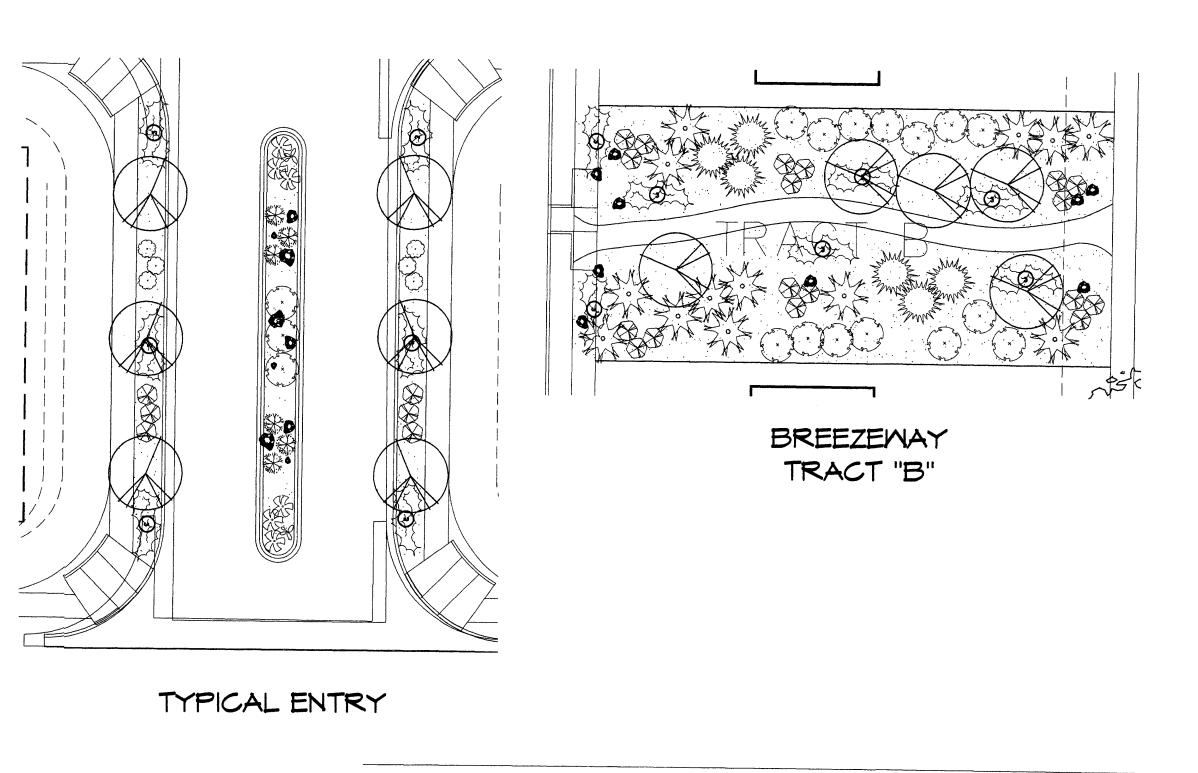



engineering 7601 Jefferson NE Suite 100 Albuquerque, NM 87109

architecture

505 761-9700 fax 761-4222 dps @ dpsdesign.org

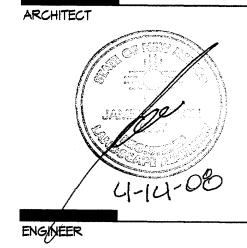

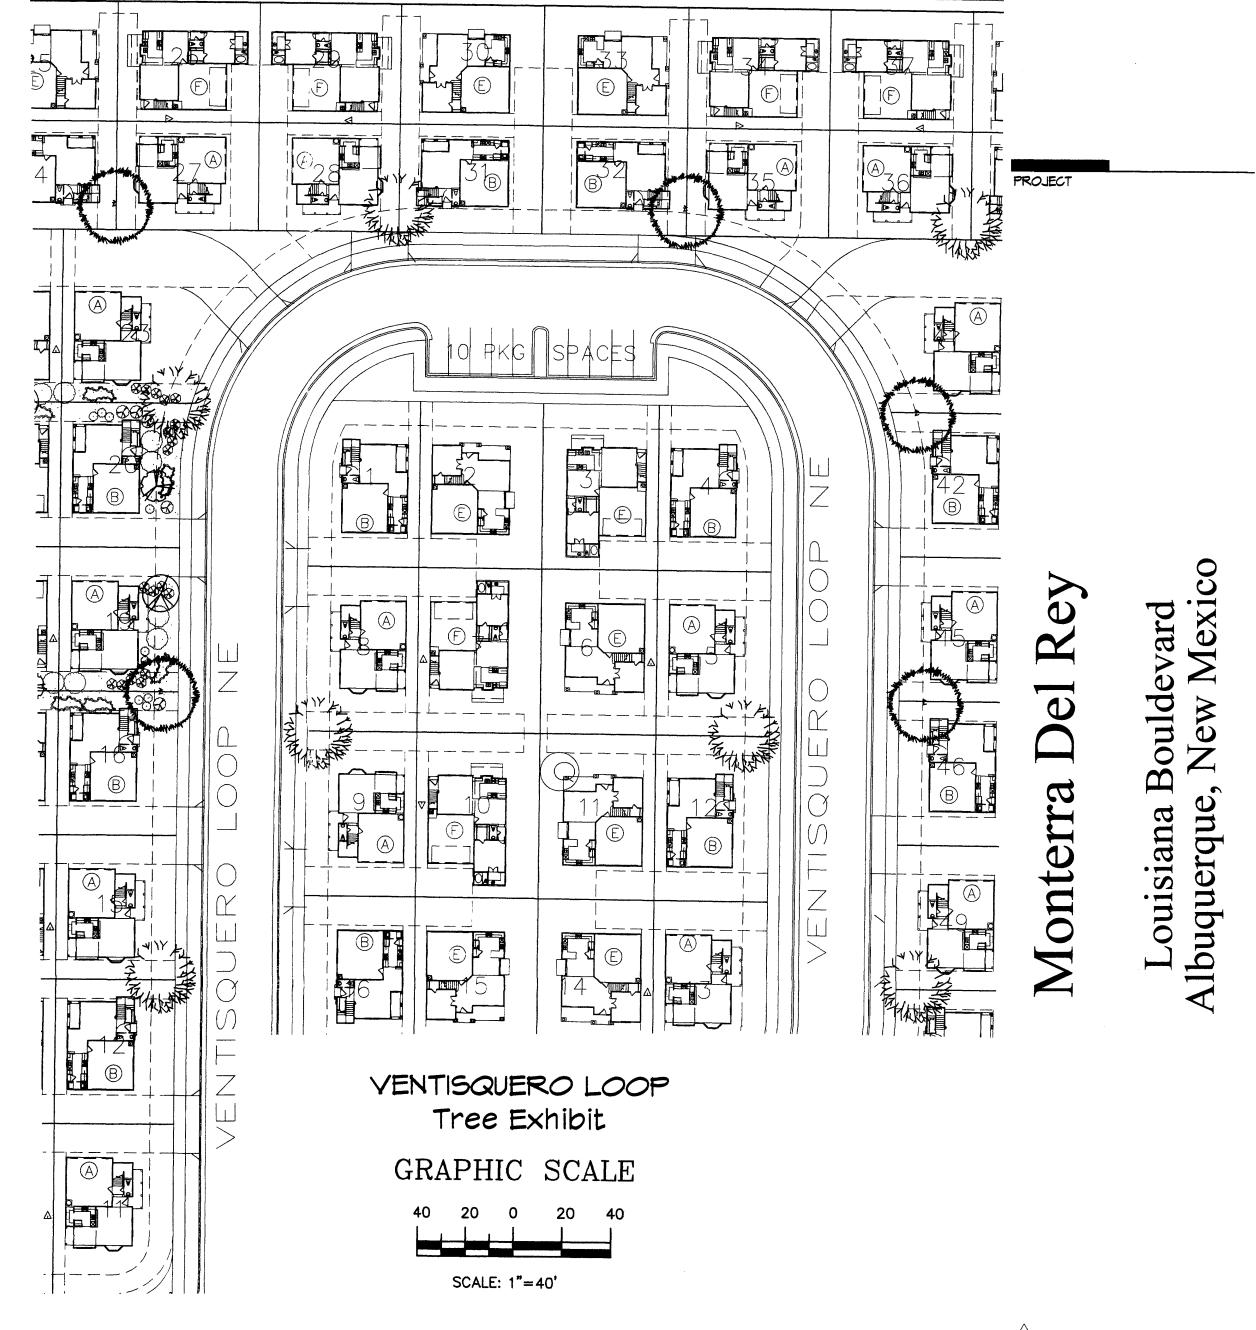

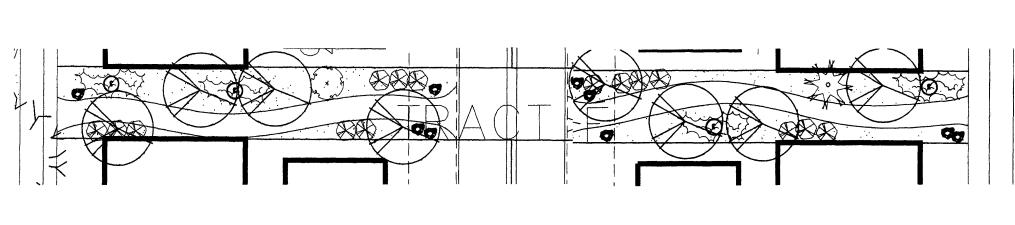

BUR OAK (M)

₹ 2" Cal.

COMMON HACKBERRY (M)
Celtis occidentalis
2" Cal.


SYCAMORE (M) Platanus spp.

2" Cal.

€ Quercus macrocarpa

BREEZEWAY TRACTS "D", "F", "G", "J", "K" & "M"

CONTRACTOR OF THE SECONDARY OF THE SECON

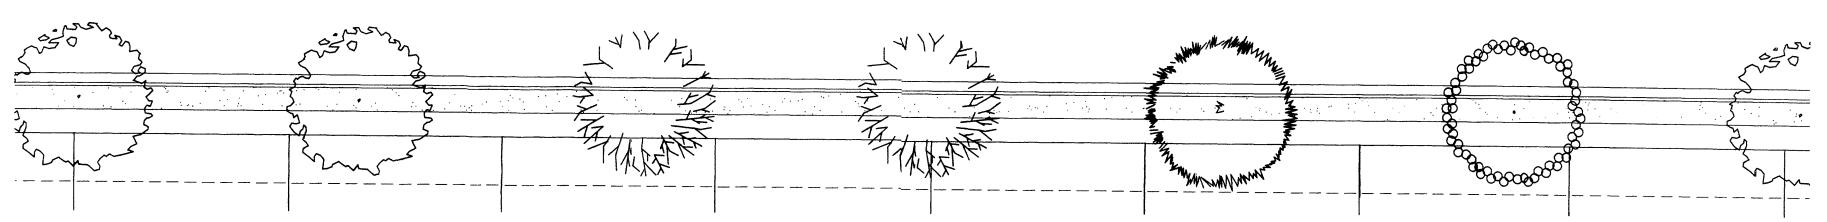

TYPICAL STREET TREES Applies to internal streets and to the perimeter of the site. May adjust for drive pads. Trees 60 feet On Center.

GRAPHIC SCALE

SCALE: 1"=20'

Cont. Lic. #26458 7909 Edith" N.E. Albuquerque, NM 87184 Ph. (505) 898-9690 Fax (505) 898-7737 cjohnson@hilltoplandscaping.com
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DRAWN BY

DATE

REVIEWED BY

PROJECT NO.

DRAWING NAME

10 comments/site rev rmc 4-14-08

1 site plan revision adf 3-31-06

2 site plan revision adf 4-3-06

3 site plan revision rmm 8-1-07

4 site plan revision CMJ 8-31-07


5 EPC Comments rmm 10-02-07

6 site plan revision rmm 2-28-08

07034

7 comments rmm 3-12-08 8 comments rmm 3-14-08

9 comments rmm 3-21-08

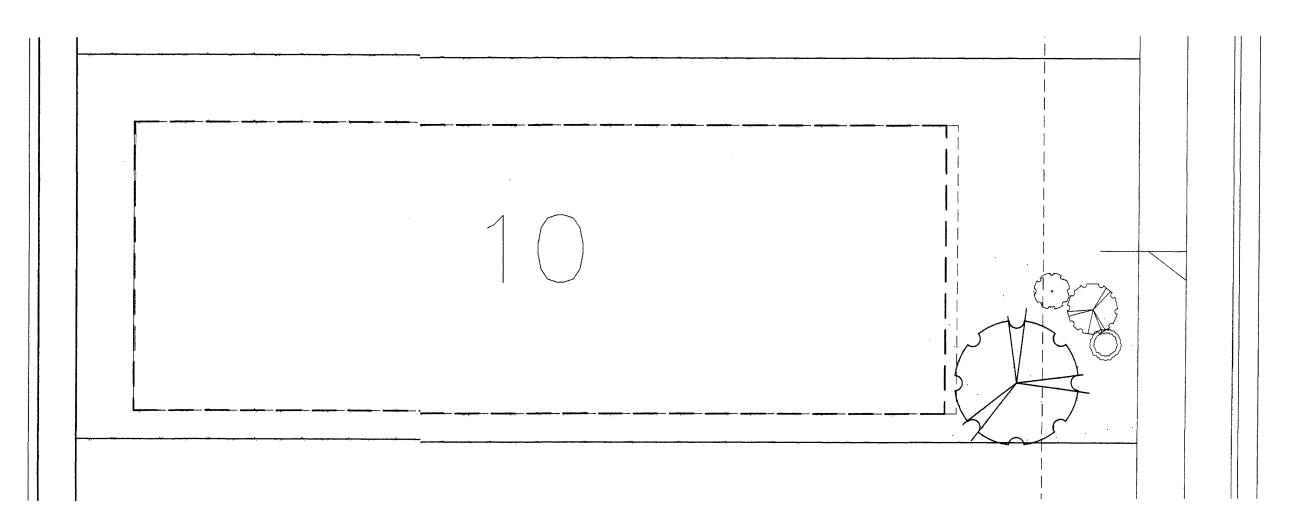

TYPICAL LOTS AREA 1


# LANDSCAPE CALCULATIONS

Residential Lots Averages

TOTAL BED PROVIDED	5767	square feet
GROUNDCOVER REQ.	75%	square feet
TOTAL GROUNDCOVER REQUIREMENT	4325	square feet
TOTAL GROUNDCOVER PROVIDED	4327 (75%)	square feet


# PLANT LEGEND


TYPICAL LOT PLANTINGS

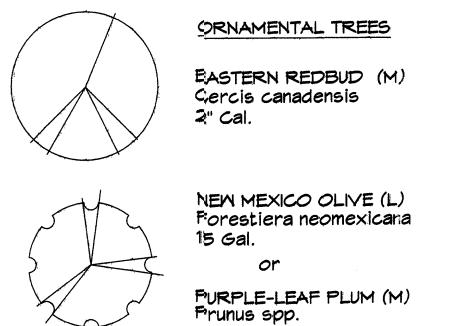


MINTER JASMINE (L+) Hasminum nudiflorum 1 Gal. 144sf



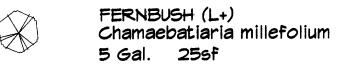


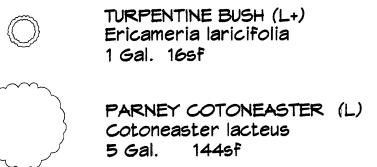


PONIS CASTLE SAGE (L+) Artemisia X Powis Castle 1 Gal. 25sf

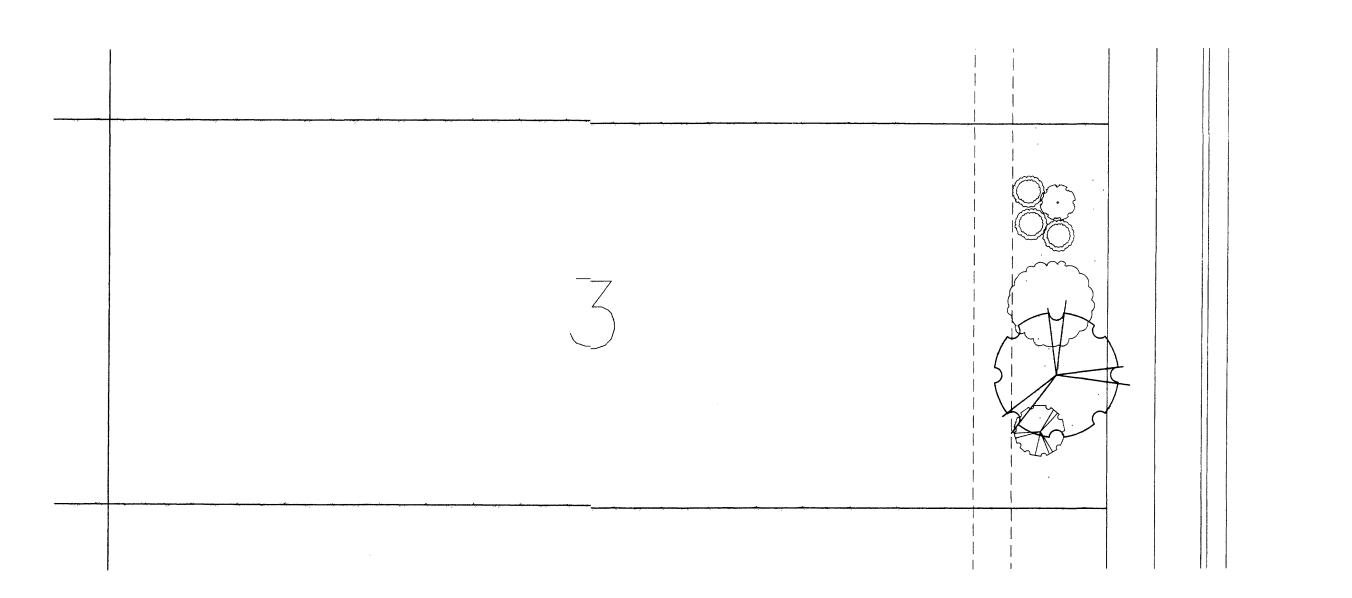


TYPICAL LOTS AREA 3

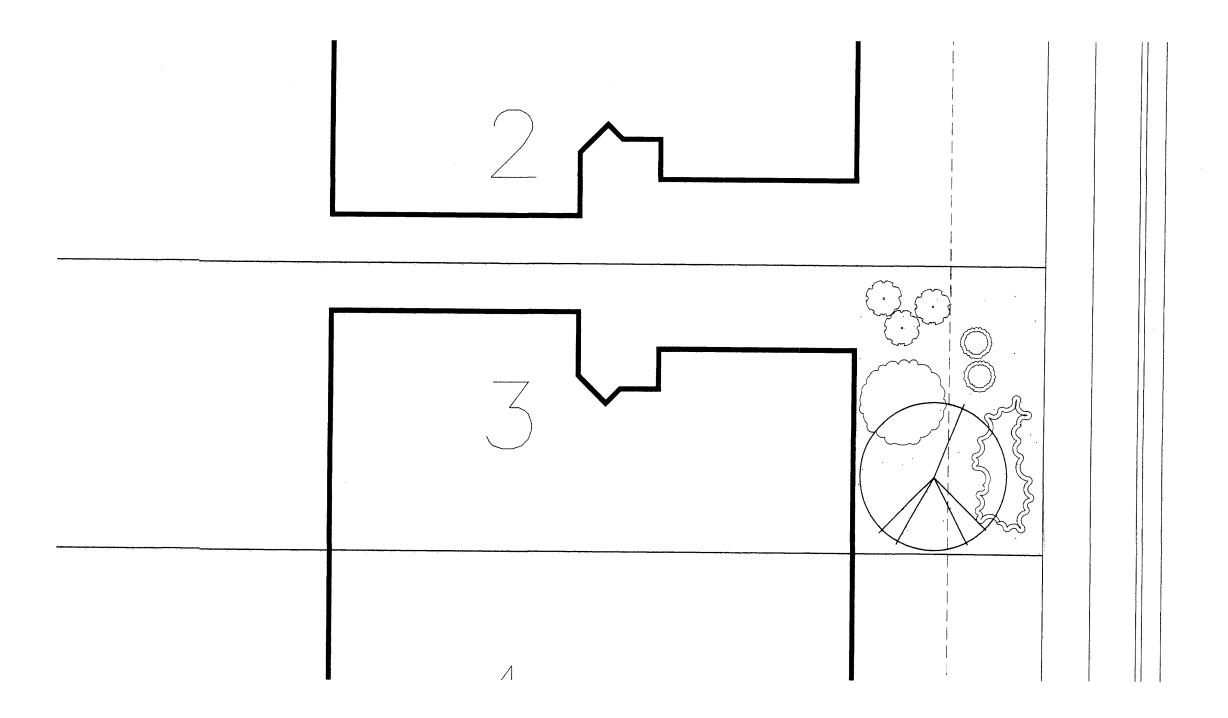

TYPICAL LOTS AREA 2

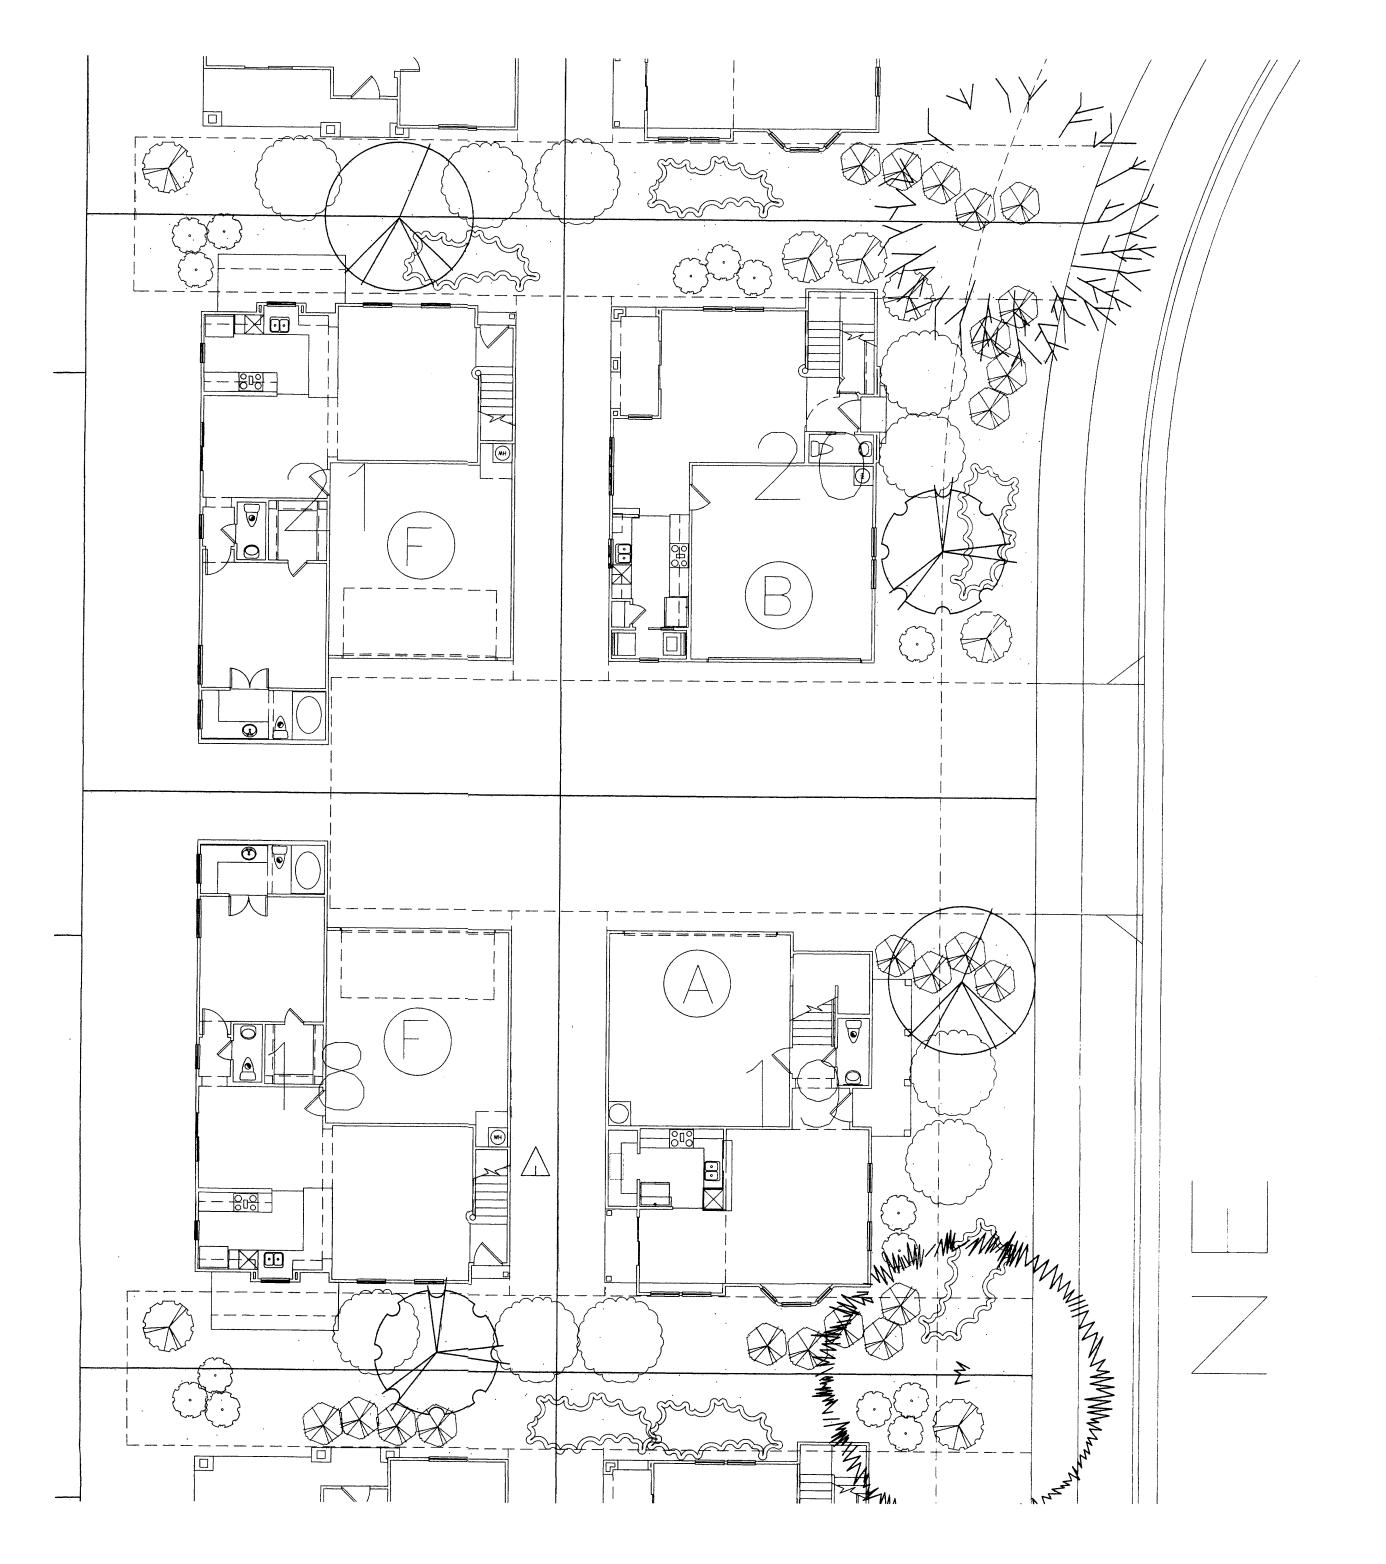

TYPICAL LOTS AREA 4

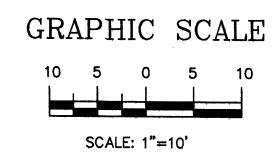



SHEET NO.

7601 Jefferson NE Suite 100 Albuquerque, NM 87109 505 761-9700 fax 761-4222 dps @ dpsdesign.org

10 comments/site rev rmc 4-14-08


1 site plan revision adf 3-31-06 2 site plan revision adf 4-3-06 3 site plan revision rmm 8-1-07 4 site plan revision CMJ 8-31-07

5 EPC Comments rmm 10-02-07 6 site plan revision rmm 2-28-08

7 comments rmm 3-12-08 8 comments rmm 3-14-08

DRAWN BY

REVIEWED BY DATE PROJECT NO. DRAWING NAME

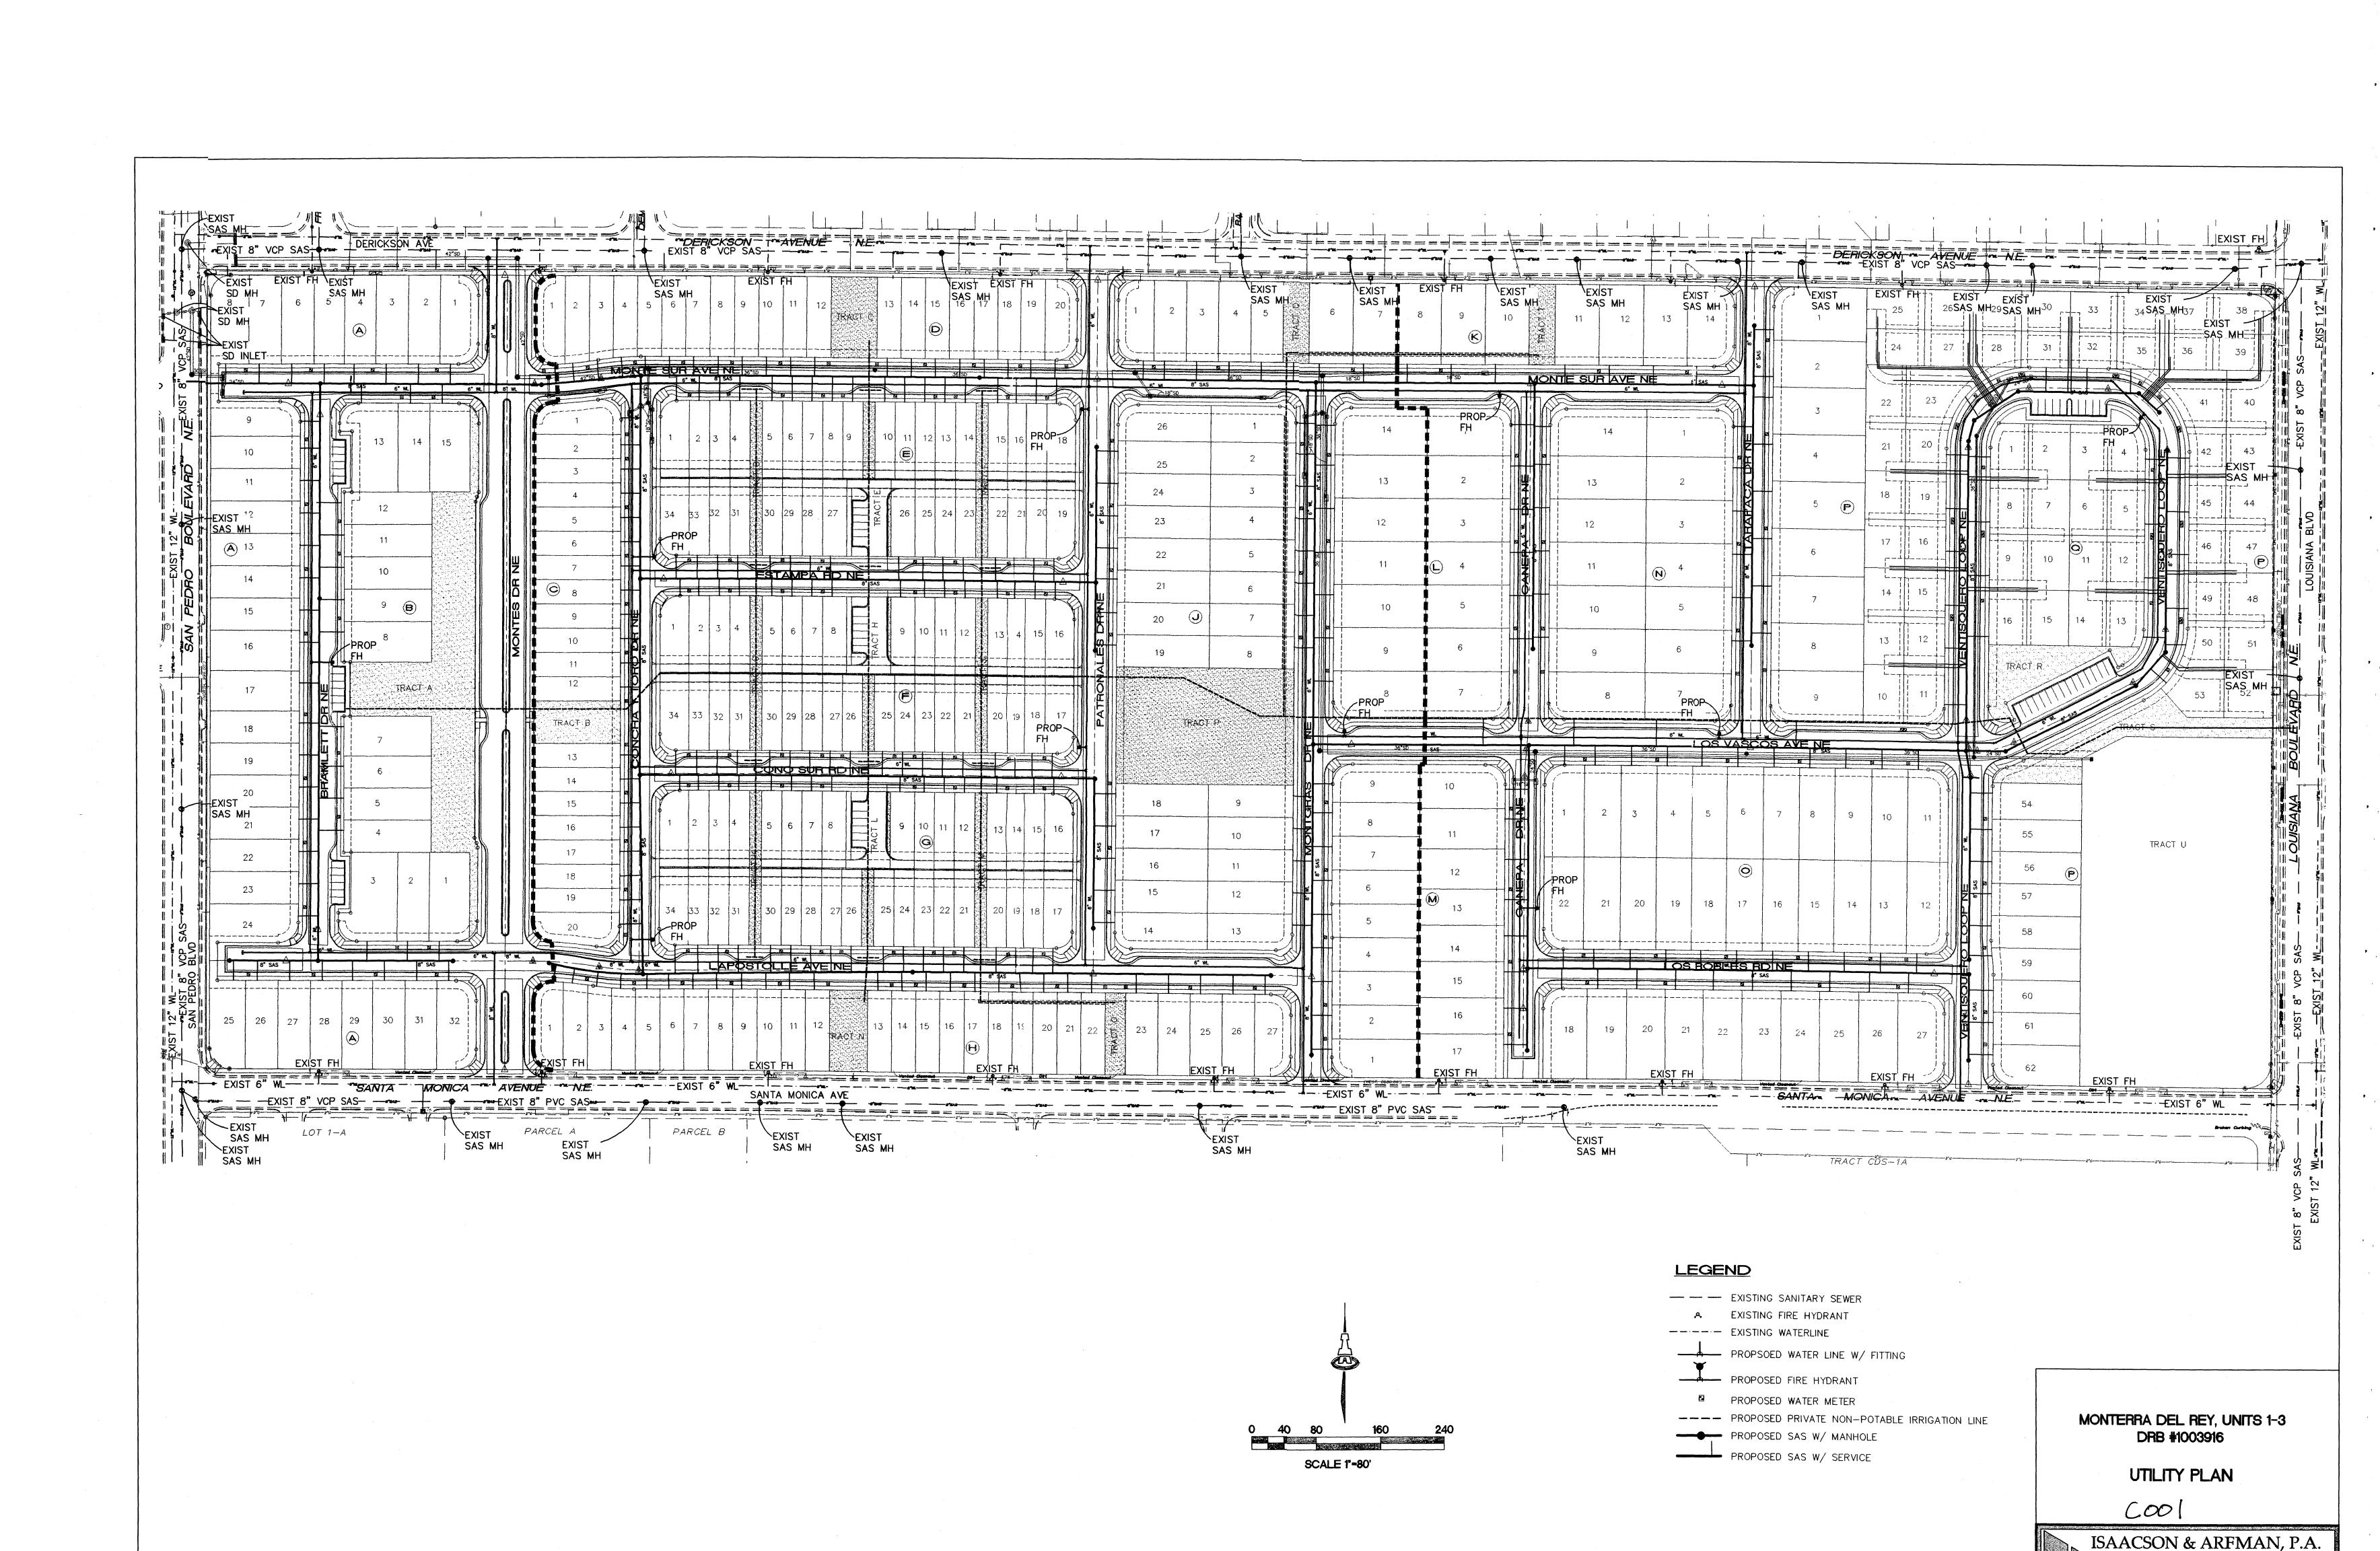


Consulting Engineering Associates

Apr 04,2008

128 Monroe Street N.E.

Albuquerque, New Mexico 87108

Ph. 505-268-8828 Fax. 505-268-2632

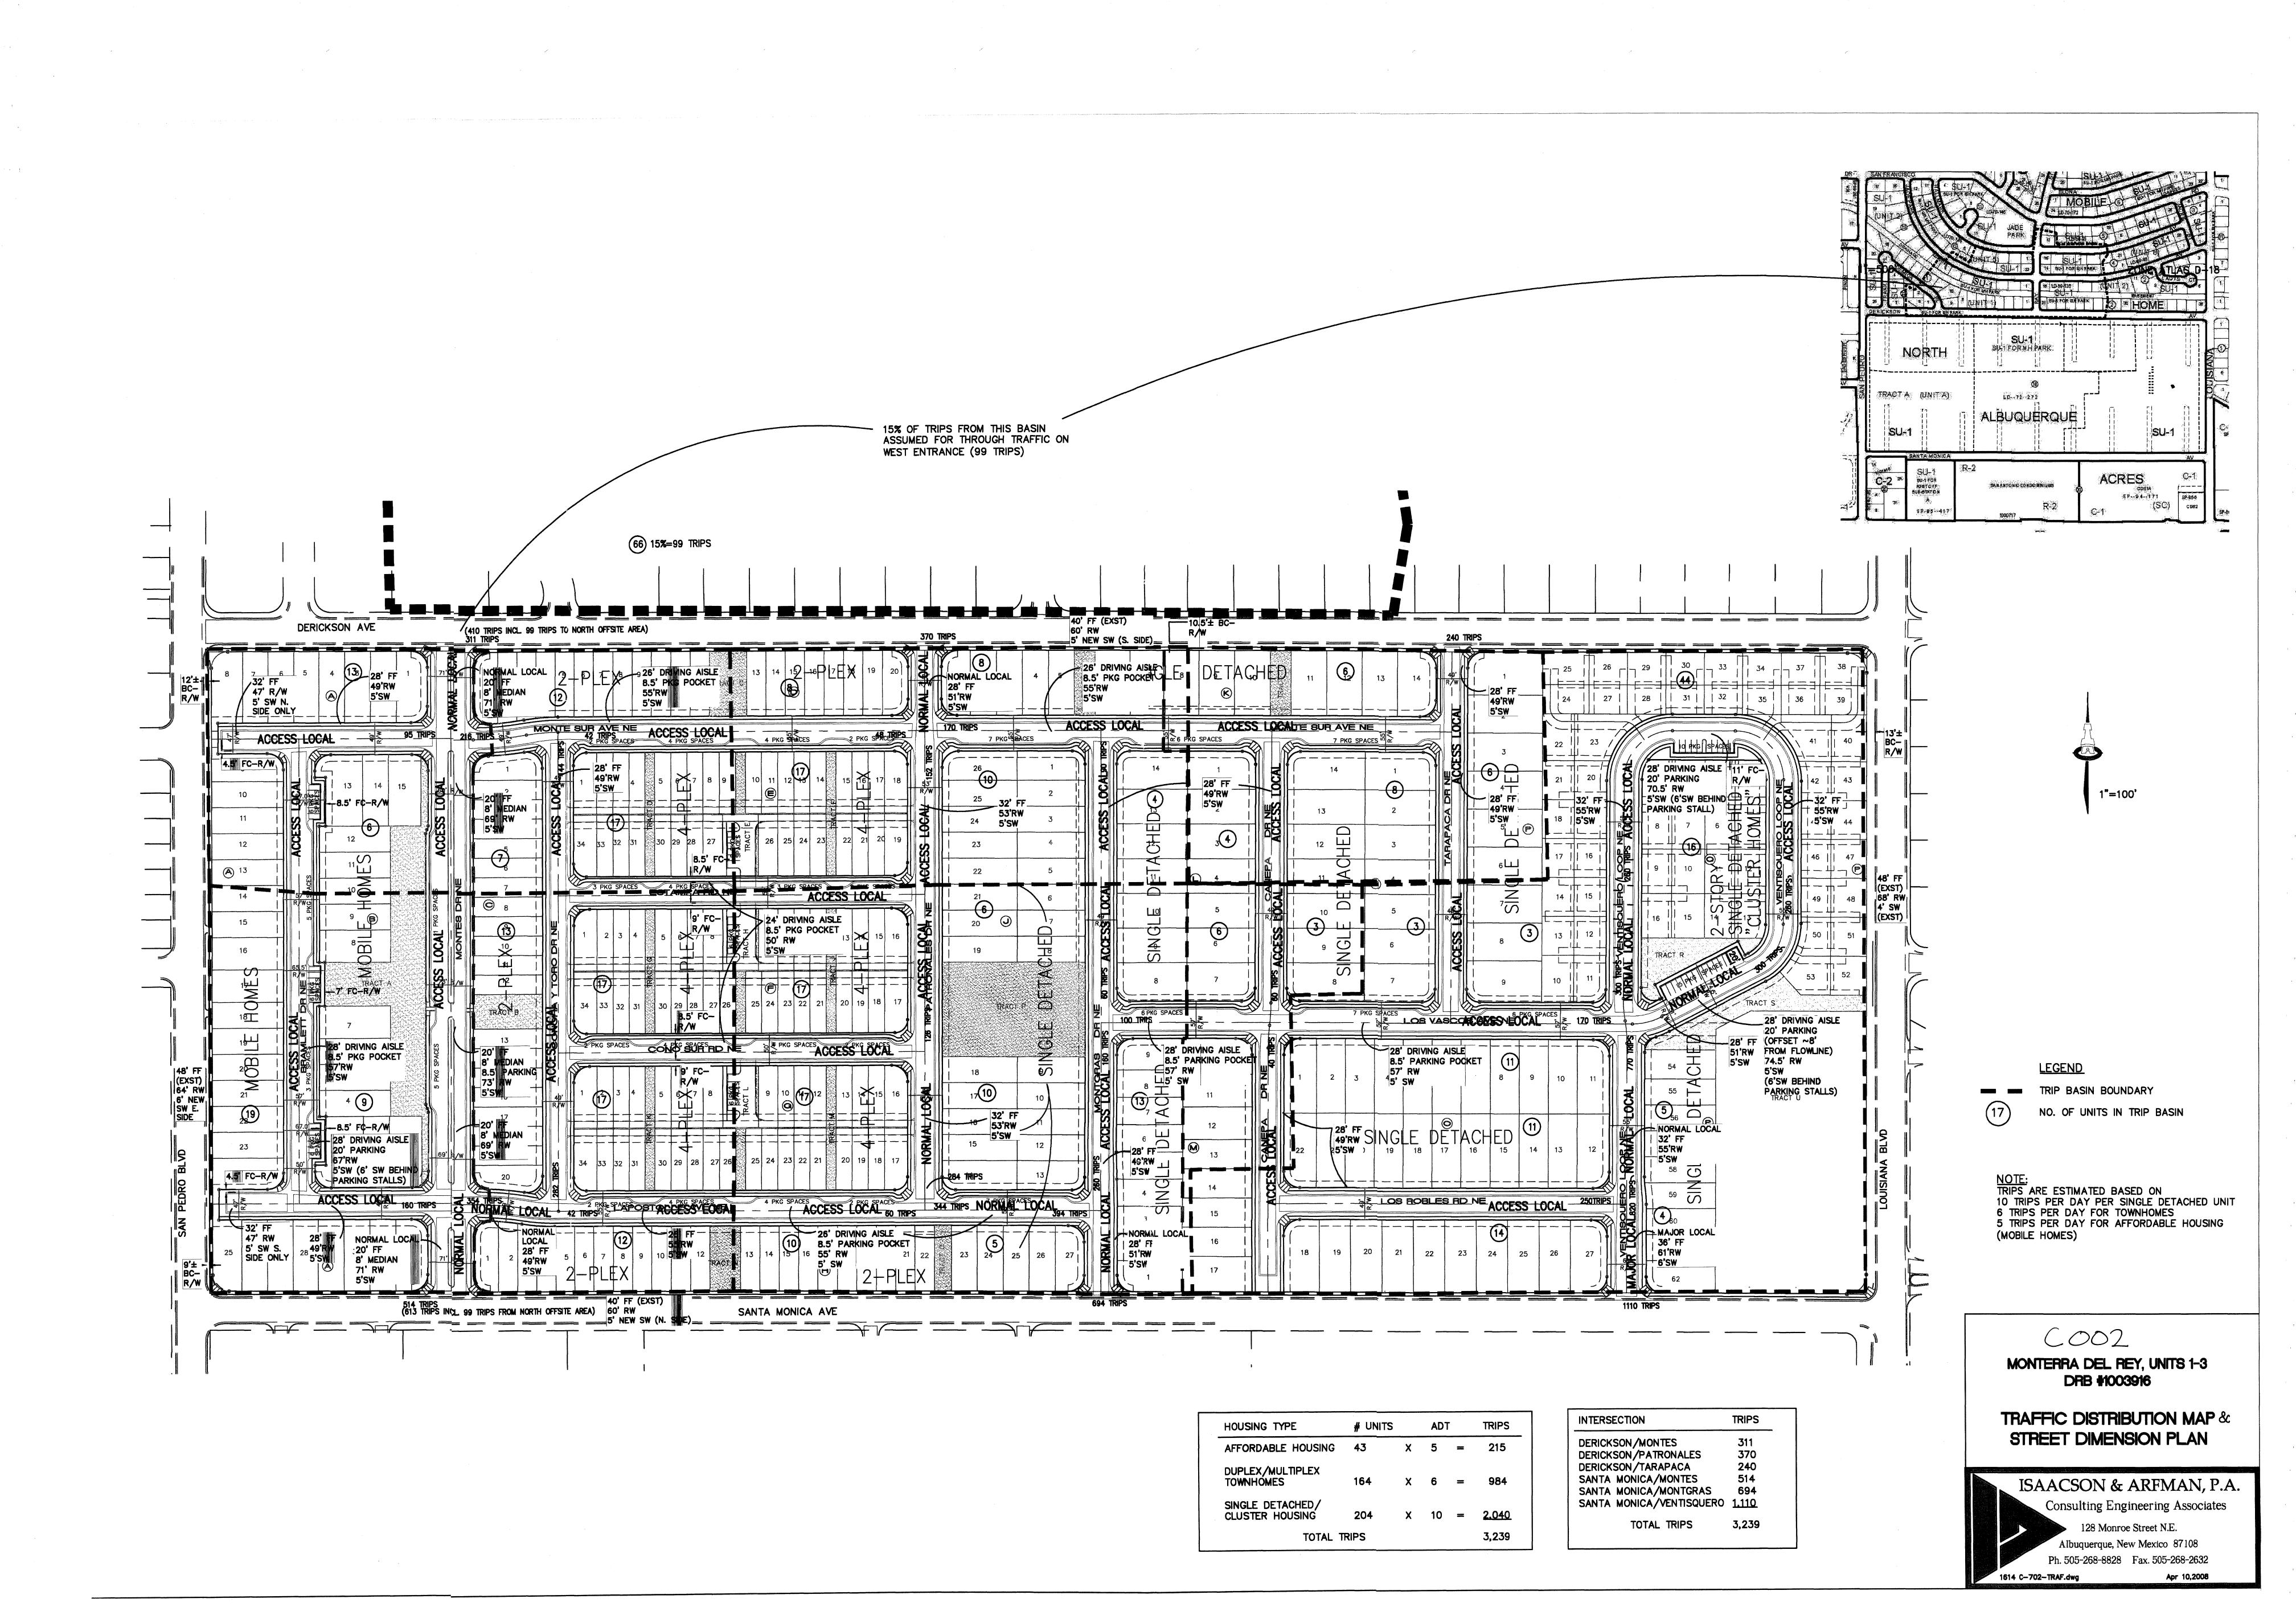



ALL STREETS HAVE MOUNTABLE CURB EXCEPT WHERE NOTED AS FOLLOWS:

MEDIAN CURB--PARKING SPACES PERPENDICULAR TO STREET

MOUNTABLE OR STANDARD CURB (STANDARD CURB WHERE

UNIT 2

ALL STREET GRADES REFER TO FLOWLINE ELEVATIONS

DESIGNATED AS - - - )

UNIT 1

# INDEX

SHEET 1 OVERALL GRADING & DRAINAGE PLAN 1"=100"

SHEETS 2-6 GRADING & DRAINAGE PLAN
AFORDABLE HOUSING UNITS, TOWNHOME UNITS, SINGLE DETACHED UNITS

UNIT 2

SJEET 7 GRADING & DRAINAGE PLAN (REENCOURT UNITS

SHEET 8 RADING DETAILS & NOTES

SHEETS 9-10 ETAINING WALL PLANS

# SITE DATA

LEGAL DESC.: BLOCKS 18 & 19 OF TRACT A, NORTH
ALBUQUERQUE ACRES UNIT A, AND A PORTION
OF DEL REY AVE., NE, VACATED BY V-71-33.

ZONE ATLAS: D-18

ZONING: SU-1


AREA: 58.30 ACRES
SURVEYOR: SURV-TEK.

BENCHMARK: ACS BENCHMARK "10-D18" ELEVATION = 5319.15 (NGVD 29)


AUGUST, 2007


FLOODPLAIN: THE SITE IS IN FLOOD ZONE X (OUTSIDE 1

FLOODPLAIN: THE SITE IS IN FLOOD ZONE X (OUTSIDE THE AREA OF THE 0.2% ANNUAL CHANCE FLOOD PLAIN) AS SHOWN ON FEMA MAP 35001C0137F, 11-19-03

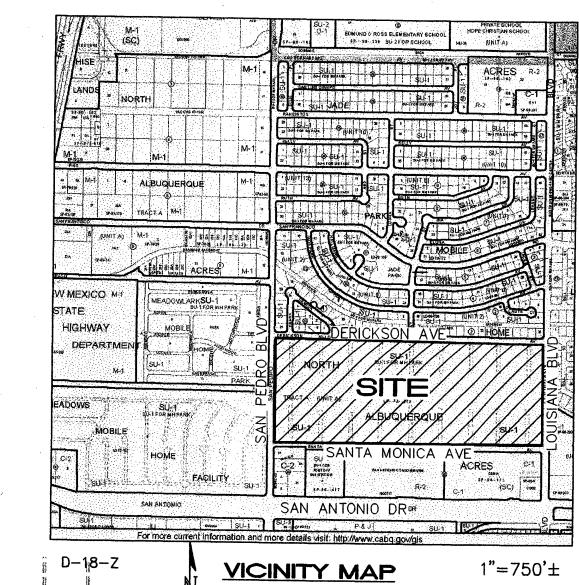

SCALE 1'-100'

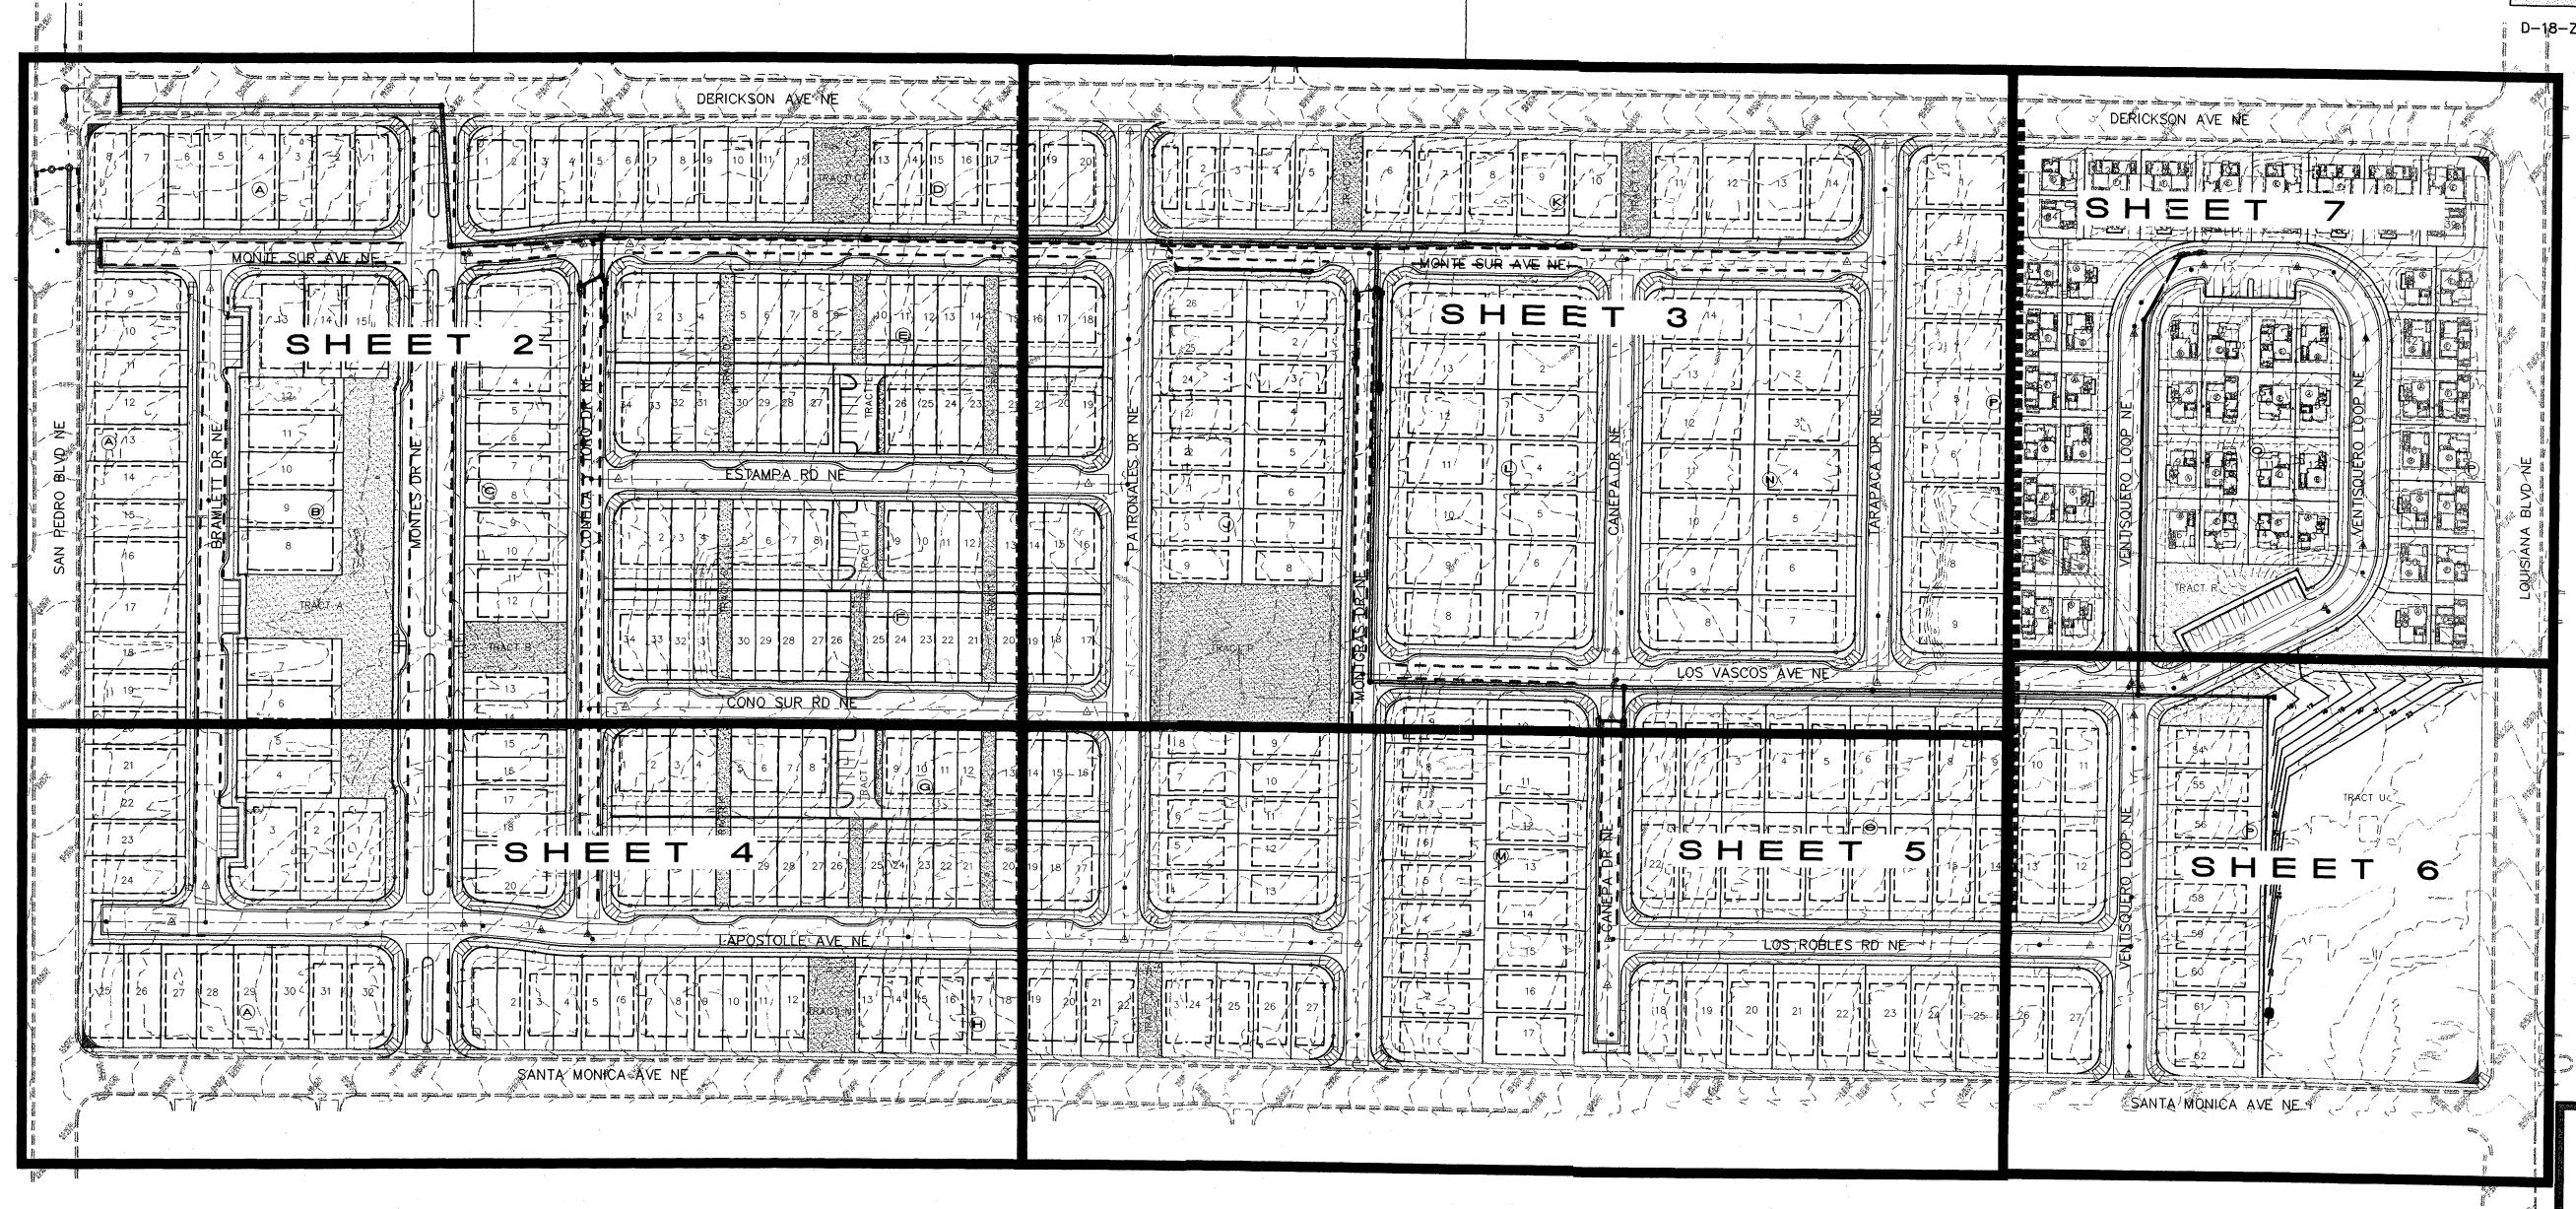

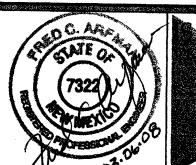

AACSON & ARFMAN, P.A.
Consulting Engineering Associates

128 Monroe Street N.E.
Albuquerque, New Mexico 87108

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MONTERRA DEL REY, UNITS 1-3

GRADING & DRAINAGE PLAN

Date: 1/12/08 No. Revision: Date: Job No. 1614

Drawn By: ÅNW
Ckd By: SH. 1 OF 10

C003