PROJECT NUMBER:

Application Number: 05 DRB-01590

DRB SITE DEVELOPMENT PLAN APPROVAL:

Traffic Engineering, Transportation Division

10/17/65

10/19/05

Parks and Recreation Department

10/19/05

City Engineer

DRB Chairperson, Planning Department Date

Mesa del Sol Employment Center - Phase 1 Albuquerque, NM

EPC Submittal for Master Development Plan REVISED

10/10/05 TO DRB

PROJECT TEAM

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OWNER

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CIVIL ENGINEER

BOHANNAN HUSTON 7500 JEFFERSON NE ALBUQUERQUE, NM 87109 (505) 823-1000 FAX: (505) 798-7980

PLANNER


DRAWING INDEX

CALTHORPE ASSOCIATES 2095 ROSE ST. BERKEKEY CA 94709 (510) 548-6800 FAX: (548) 548-6848



N.T.S.

VICINITY MAP

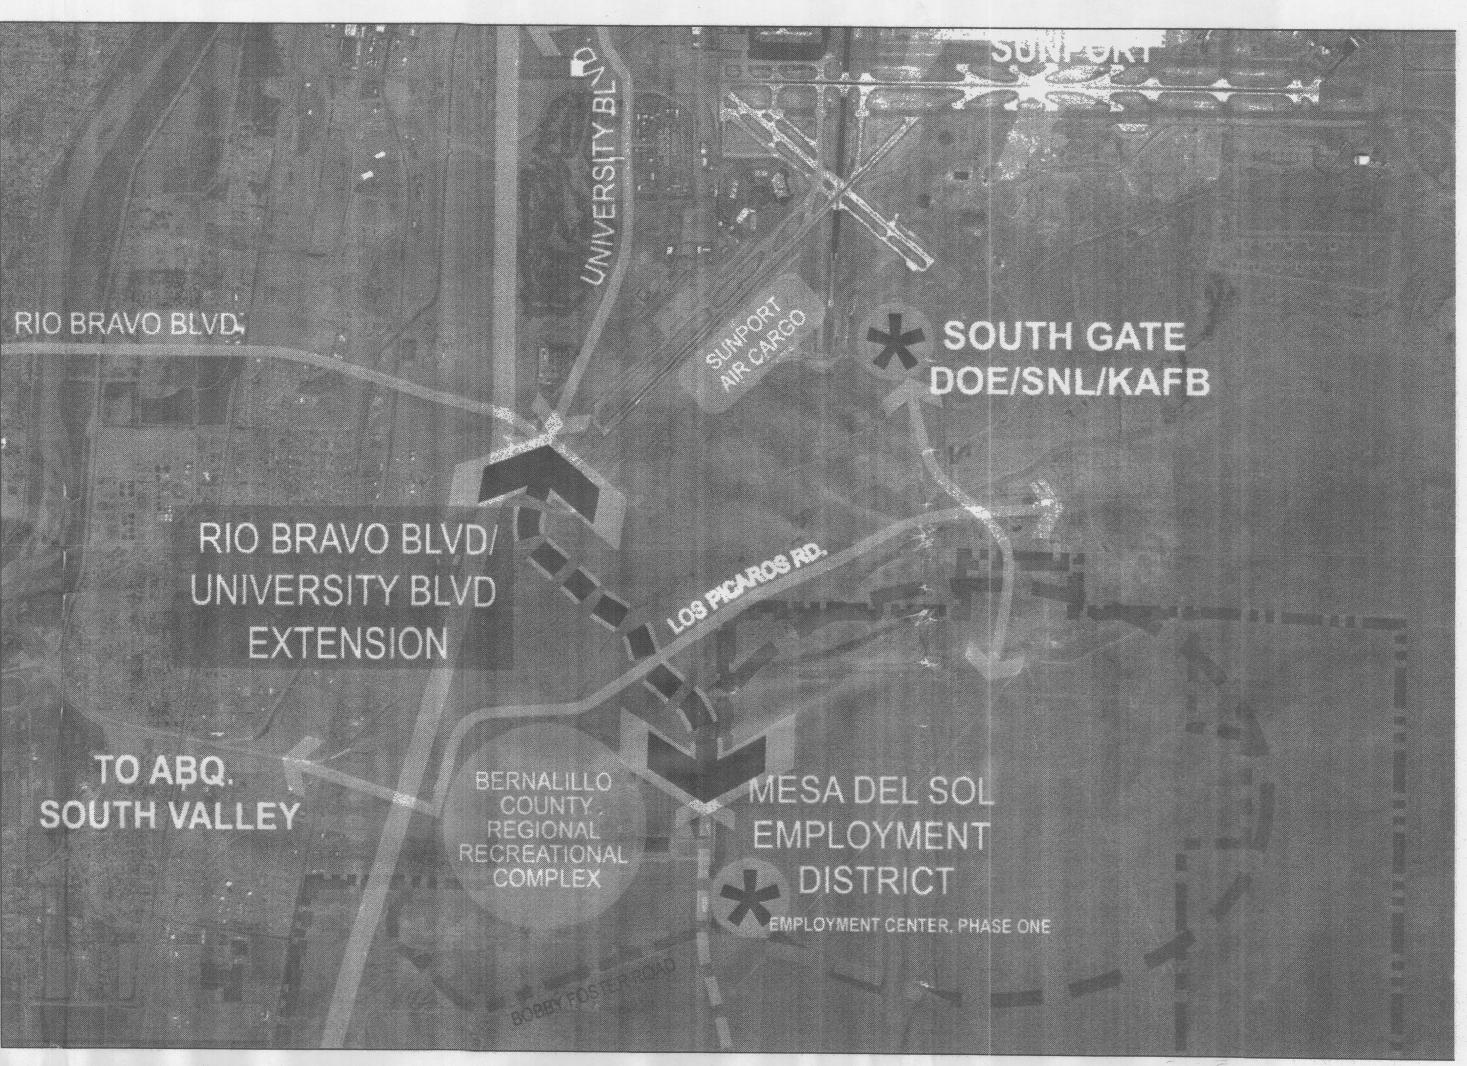

AREA MAP

N.T.S.

architecture interiors planning engineering

Dekker Perich Sabatini

> 6801 Jefferson NE Suite 100 Albuquerque, NM 87109 505 761-9700 fax 761-4222 dps@dpsabq.com

ARCHITECT

EPC SUBMITTAL

ENGINEER

PROJECT

MESA DEL SOL
Employment Center - Phase One
Albuquerque, New Mexico
City Project #1004097

REVISIONS

4-26-05 EPC SUBMITTAL REVISIONS EPC # 05EPC00576/00579

2 5-9-05 EPC SUBMITTAL REVISIONS

3 10-10-05 DRB SUBMITTAL


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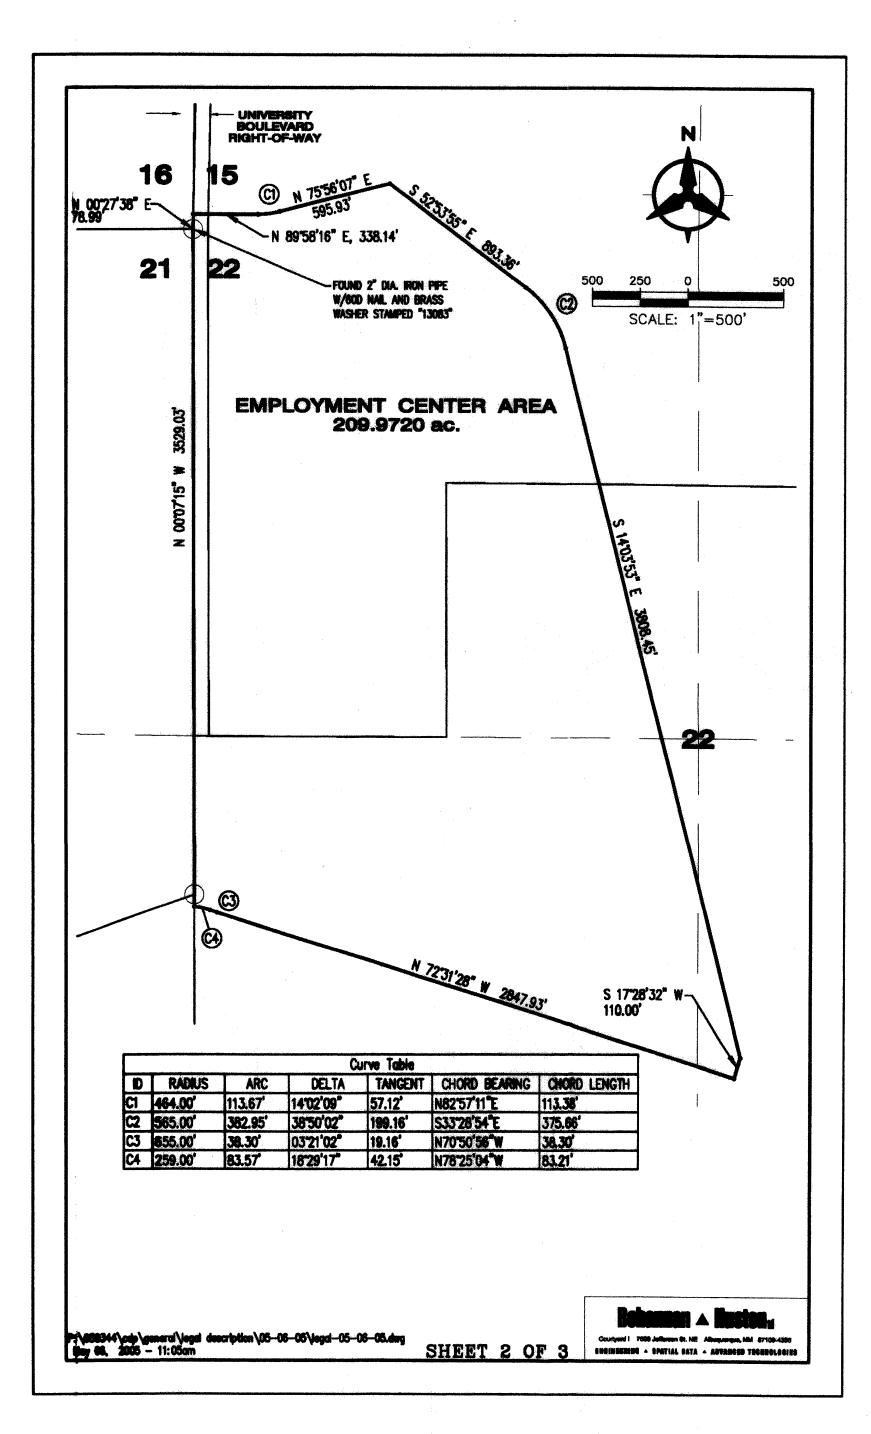
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REVIEWED BY DPS


DATE OCTOBER 10, 2005
PROJECT NO. 03069
DRAWING NAME

VICINITY AND AREA MAPS

SHEET NO.



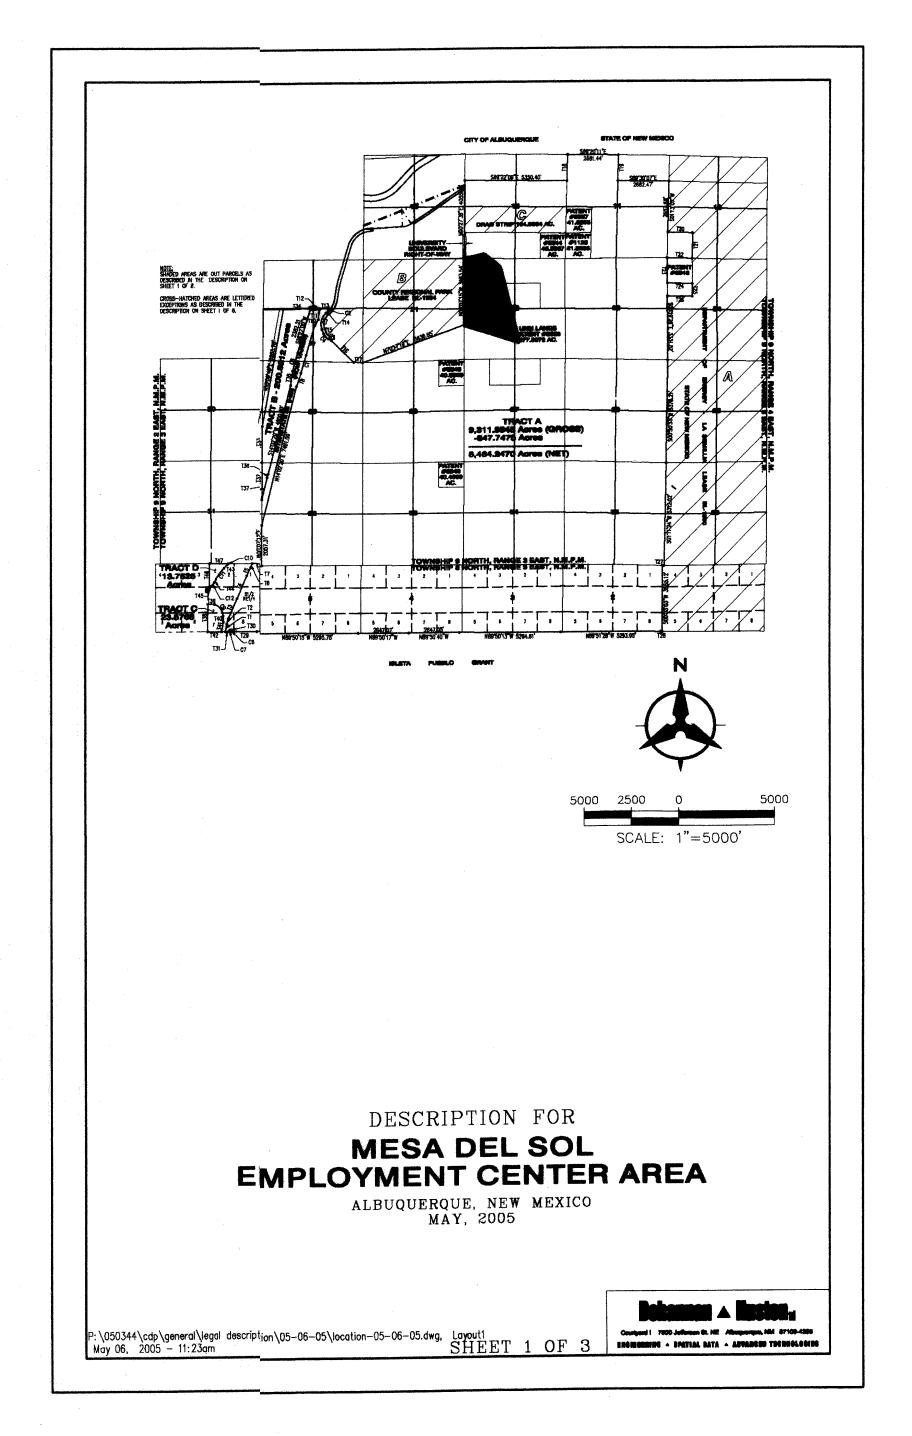

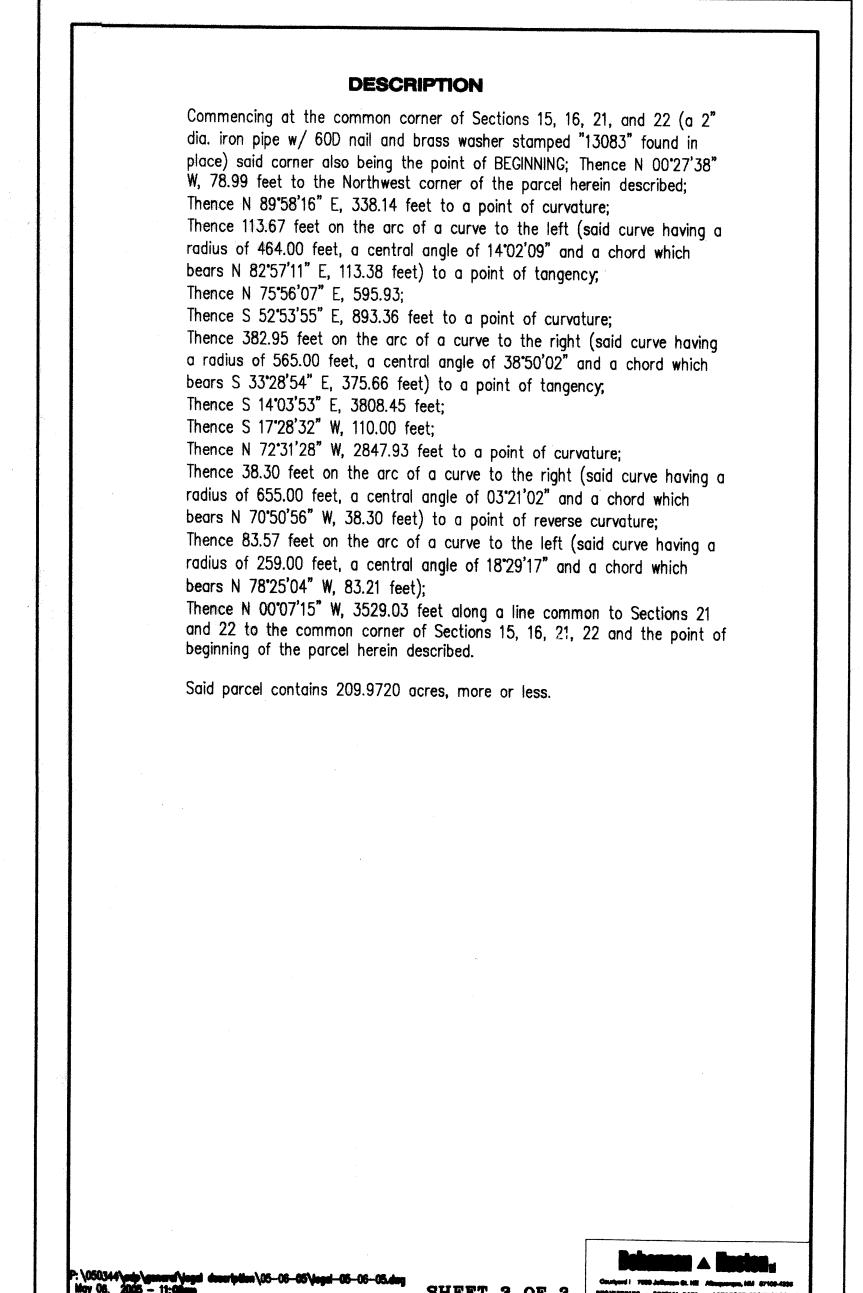

interiors planning engineering

Dekker Perich Sabatin

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PROJE

MESA DEL SOL

iployment Center - Phase On
Albuquerque, New Mexico

REVISIONS

4-26-05 EPC SUBMITTAL REVISIONS EPC #05EPC00576/00579

5-9-05 EPC SUBMITTAL REVISIONS

10-10-05 DRB SUBMITTAL

DRAWN BY RMB

REVIEWED BY JLM

DATE OCTOBER 10, 2005

PROJECT NO. 09069

DRAWING NAME


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DESCRIPTION


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Courtyard | 7500 Jefferson St. NE Albuquerque, NM 87109-4335
ENGINEERING A SPATIAL DATA A ABVANCED TECHNOLOGIES

SHEET NO



SITE PLAN FOR SUBDIVISION - MASTER DEVELOPMENT PLAN

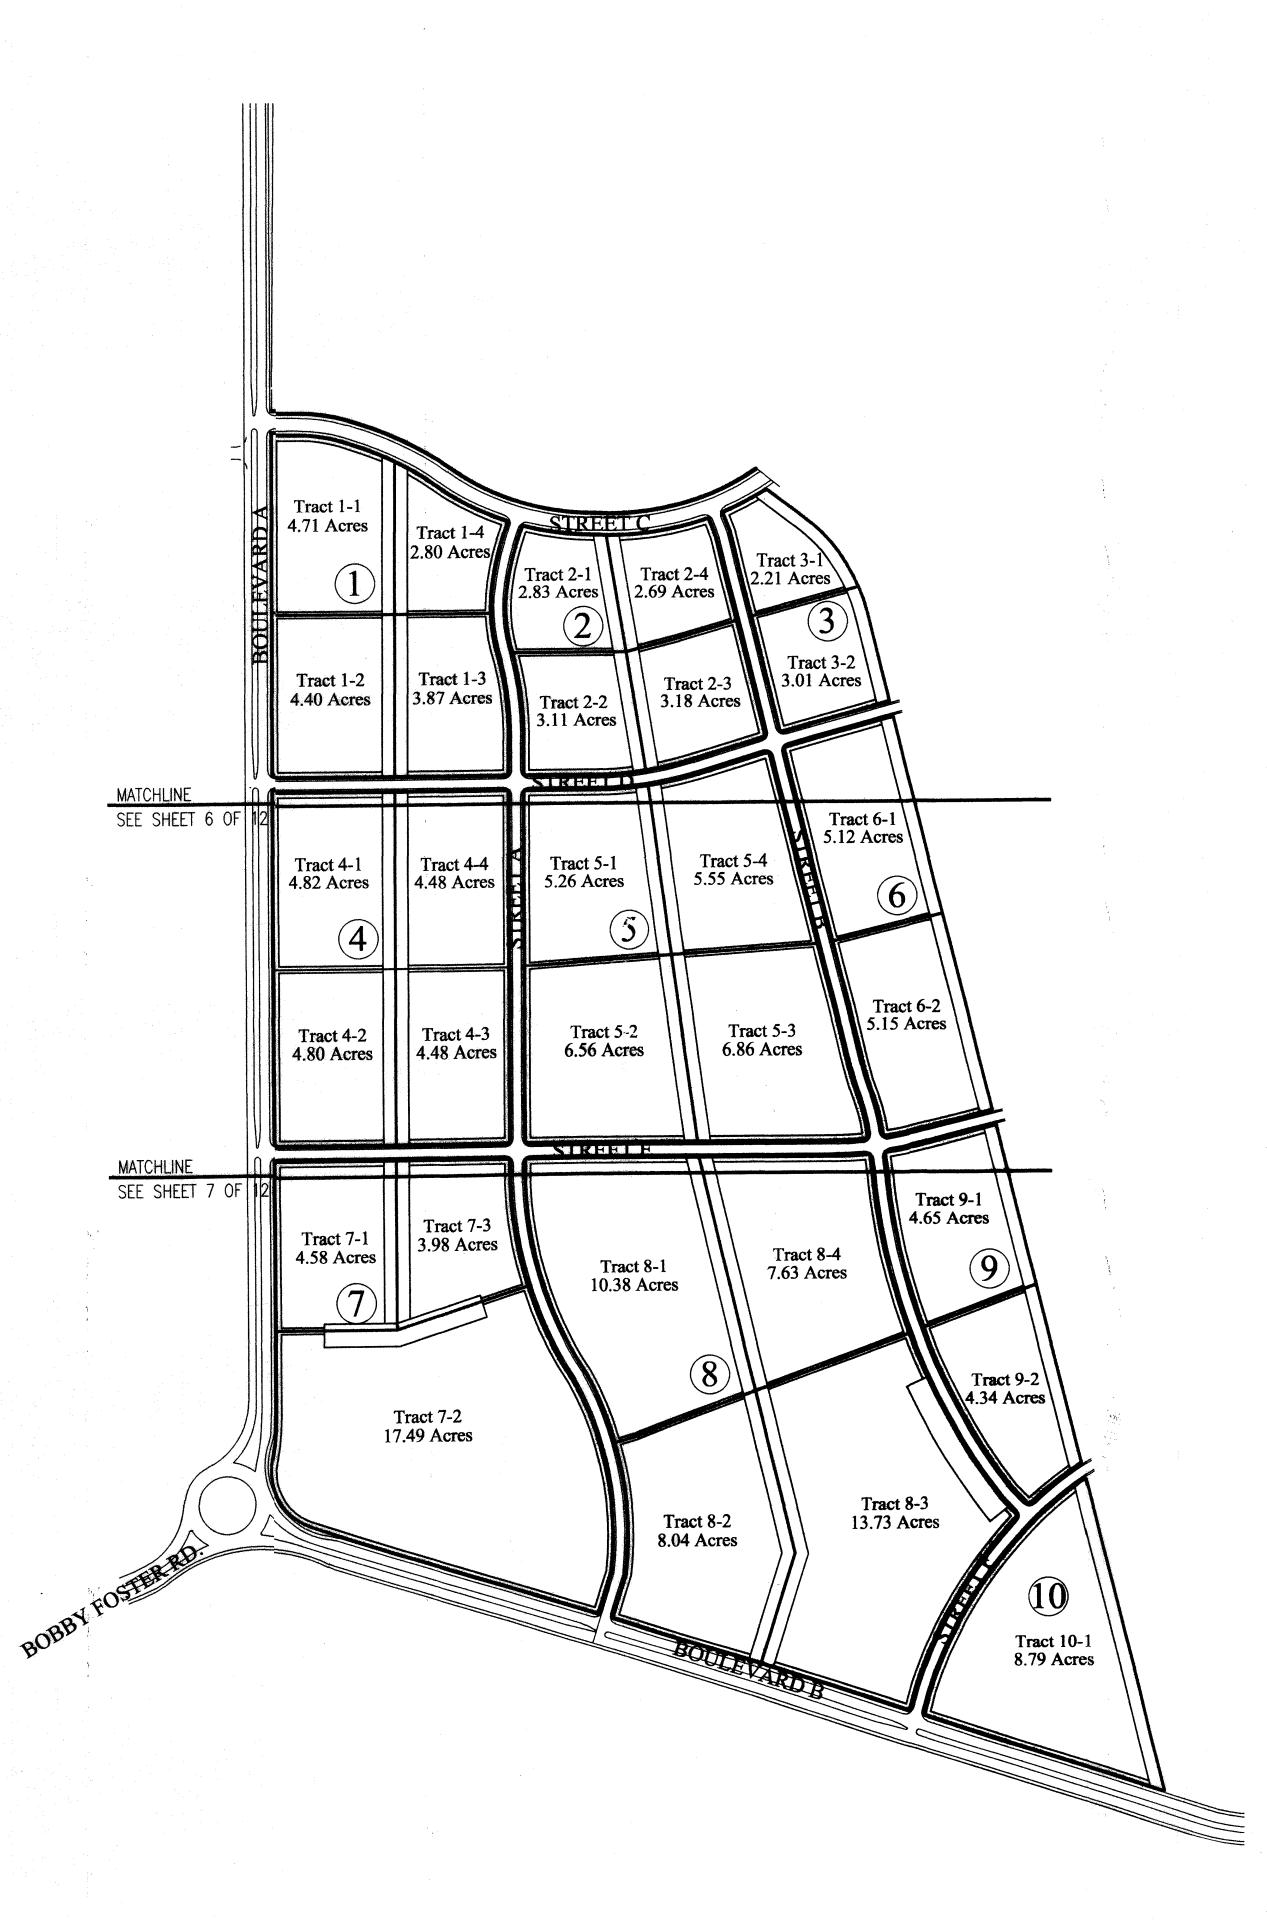

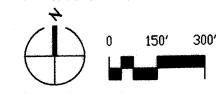SITE PLAN FOR SUBDIVISION MASTER DEVELOPMENT PLAN

LEGAL DESCRIPTION: SEE LEGAL DESCRIPTION SHEETS

ZONING:

SU-1 FOR IP USES

SECTOR PLAN:

THERE IS NO SECTOR PLAN FOR THIS AREA. HOWEVER, THE OWNER WILL INCLUDE THIS PROPERTY IN UPCOMING PLANNING SUBMISSIONS, PER THE PLANNED COMMUNITIES CRITERIA, FOR MESA DEL SOL.

SUBDIVISION CONCEPT:

THE PLAN FOR THE 169.50 NET ACRE SITE SUBDIVIDES THE SITE INTO 30 TRACTS. THE PLAN ALSO INCLUDES A HIERARCHY OF PUBLIC RIGHT-OF-WAYS, SIDEWALKS AND PUBLIC ACCESS EASEMENTS THAT WILL INCREASE CONNECTIVITY THROUGHOUT THE EMPLOYMENT CENTER.

LAND UTILIZATION CONCEPT:

THIS PROPERTY IS INTENDED TO BE DEVELOPED AS THE FIRST PHASE OF A LARGE EMPLOYMENT CENTER THAT WILL PROVIDE UNIQUE BUSINESS AND JOB-CREATING OPPORTUNITIES IN THE REGION BY VIRTURE OF ItS SIZE, INFRASTRUCTURE AND PROXIMITY TO THE ALBUQUERQUE SUNPORT, SANDIA NATIONAL LABORATORY AND KIRTLAND AIR FORCE BASE. THE EMPLOYMENT CENTER WILL BE COMPRISED PRIMARILY OF OFFICE, INDUSTRIAL AND MANUFACTURING USES.

PROPOSED USES:

PERMISSIVE USES SHALL BE PURSUANT TO CITY OF ALBUQUERQUE ZONING CODE SECTION 14-16-2-19 INDUSTRIAL PARK ZONE.

APPROVAL PROCESS:

IN ACCORDANCE WITH CONSIDERATION OF THE MESA DEL SOL EMPLOYMENT CENTER AS A "CERTIFIED SITE" AND WITH THE PROVISION OF THE DESIGN STANDARDS INCLUDED IN THIS SITE PLAN FOR SUBDIVISION, APPROVALS FOR DEVELOPMENT WITHIN THE EMPLOYMENT CENTER SHALL BE AS FOLLOWS:



1. THE FIRST SITE DEVELOPMENT PLAN FOR BUILDING PERMIT ON THE SUBJECT SITE SHALL BE REVIEWED AND APPROVED BY THE EPC, AND AT THAT TIME, THE EPC WILL MAKE THE DETERMINATION AS TO WHETHER OR NOT TO DELEGATE FURTHER SITE PLANS TO DRB. THE SUBMITTAL PACKAGE FOR ALL SITE DEVELOPMENT PLANS FOR BUILDING PERMIT SHALL REQUIRE A LETTER OF APPROVAL FROM THE PRIVATE ARCHITECTURAL REVIEW COMMITTEE (ARC) FOLLOWING NOTIFICATION OF ADJOINING PROPERTY OWNERS.



[5E] 2. A PRIVATE ARCHITECTURE REVIEW COMMITTEE (ARC) WILL ENSURE ADHERENCE TO THE DESIGN INTENT AS STATED IN THE PROJECT DESIGN STANDARDS. SITE DEVELOPMENT PLANS FOR BUILDING PERMIT WITHIN THIS SITE PLAN FOR SUBDIVISION AREA MUST BE APPROVED BY THE ARC PRIOR TO BEING SUBMITTED FOR EPC OR DRB REVIEW.

VARIATION FROM IP ZONE:

DEVELOPMENT AT THE MESA DEL SOL EMPLOYMENT CENTER, PHASE ONE SHALL COMPLY WITH AND MEET THE INTENT AND REQUIREMENTS OF THE IP - INDUSTRIAL PARK ZONE, WITH THE EXCEPTION OF BUILDING HEIGHT AND SETBACKS (SEE BELOW). IN A CHANGE FROM THE STANDARD IP ZONE, BUILDING HEIGHT LIMITS ARE NOT DIRECTLY RELATED TO THE SETBACK DISTANCE.

- 1. MAXIMUM BUILDING HEIGHT:
- a. A STRUCTURE SHALL NOT EXCEED A HEIGHT OF 120'.
- 2. MINIMUM SETBACKS:
- a. FRONT-YARD SETBACK: 15 FEET
- b. SIDE-YARD SETBACK: 10 FEET.
- C. REAR-YARD SETBACK: 10 FEET.

INGRESS AND EGRESS:

1. VEHICULAR ACCESS (SEE STREET SECTIONS, SHEET 5 OF 12): a. ACCESS TO THE SITE WILL BE GAINED FROM BOBBY FOSTER ROAD TO BOULEVARD A AND BOULEVARD B. IN THE NEAR FUTURE VEHICULAR ACCESS TO THE SITE WILL ALSO BE AVAILABLE FROM NORTH OF THE PROPERTY (THE UNIVERSITY/ RIO BRAYO BOULEVARD EXTENSION). BOULEVARD A WILL BEGIN AT THE SOUTHERN END OF THE UNIVERSITY/ RIO BRAYO BOULEVARD EXTENSION).

b. IT IS ANTICIPATED THAT NEW ROAD CLASSIFICATIONS WILL BE UTILIZED AT MESA DEL SOL. THESE CLASSIFICATIONS REFLECT AN INNOVATIVE TRANSPORTATION MODEL THAT INCREASES THE FREQUENCY OF MEDIUM TRAFFIC-VOLUME STREETS IN A GRID-LIKE CONFIGURATION IN ORDER TO DISPERSE VEHICULAR TRAFFIC, AND CREATE OPPORTUNITIES TO GENERATE TRULY MULTI-MODAL CIRCULATION CORRIDORS. THE ROAD SECTIONS FOR THE MESA DEL SOL EMPLOYMENT CENTER, PHASE ONE INCLUDE BOULEVARDS, CONNECTOR STREETS AND LOCAL-INDUSTRIAL STREETS (SEE DESIGN GUIDELINES FOR STREET SECTIONS AND DESCRIPTIONS).

2. PEDESTRIAN ACCESS:

a. DIRECT PEDESTRIAN ACCESS TO THE PHASE ONE EMPLOYMENT CENTER WILL BE PROVIDED ALONG BOULEVARDS A AND B ALONG BOTH SIDES OF THE STREETS THAT RUN INTO THE PROPERTY AND ALONG INTERNAL LOCAL STREETS b. INTERNAL PEDESTRIAN CIRCULATION BETWEEN BLOCKS MAY ALSO BE PROVIDED IN ACCESS EASEMENTS THAT ARE CREATED WITHIN DRAINAGE EASEMENTS AT THE BACK OF EACH TRACT.

3. BICYCLE ACCESS:

a. BICYCLE LANES ARE NOT PROVIDED ON THE STREET SECTIONS TO BE BUILT AS PART OF THIS SITE PLAN FOR SUBDIVISION b. IT IS OUR INTENT TO PROVIDE BICYCLE LANES IN FUTURE PHASES- WITHIN THE MAJOR NORTH/SOUTH STREET SECTIONS. INCLUDING THE NEXT MAJOR NORTH/SOUTH STREET EAST OF THE PHASE ONE EMPLOYMENT CENTER. USE OF BICYCLES ON TRAILS. CONNECTOR AND LOCAL STREETS AND WITHIN THE INTERIOR BLOCK ACCESS EASEMENTS WILL BE ALLOWED AND ENCOURAGED

4. TRANSIT:

a. TRANSIT WILL BE ACCOMMODATED WITHIN THE PROJECT STREET SECTIONS THROUGH THE USE OF SIGNAGE AND STRIPING. b. IT IS OUR INTENT TO ALSO ACCOMMODATE TRANSIT WITHIN THE CENTER MEDIAN OF THE NEXT MAJOR NORTH/SOUTH STREET SECTION, TO BE LOCATED EAST OF THE PHASE ONE EMPLOYMENT CENTER.



C. TO ACCOMMODATE LOCATIONS OF POTENTIAL TRANSIT SHELTERS, 200 SQUARE FEET (10' X 20') SHALL BE RESERVED FOR TRANSIT SHELTERS ABUTTING THE RIGHT-OF-WAY ALONG DESIGNATED MAJOR TRANSIT CORRIDORS. THE RESERVED AREA SHALL BE ON THE FAR SIDE OF MAJOR INTERSECTIONS 75 FEET FROM THE CURB RADIUS AT THE INTERSECTION, AND 12 FEET FROM THE BACK OF THE CURB TO THE BACK OF THE TRANSIT SHELTER.



d. FUTURE EMPLOYERS IN THE PLAN AREA WILL PARTICIPATE IN THE CITY'S TRANSIT DEMAND MANAGEMENT PROGRAM.

LOT SIZE:

1. MINIMUM LOT SIZE SHALL BE PURSUANT TO CITY OF ALBUQUERQUE ZONING CODE SECTION 14-16-2-19 INDUSTRIAL PARK ZONE. THIS !NCLUDES:

a. A MINIMUM LOT AREA OF ONE-HALF ACRE; b. A MINIMUM LOT WIDTH OF 100 FEET; AND A

C. REQUIREMENT THAT NO MORE THAN 50 % OF THE SURFACE OF ANY LOT OR SITE SHALL BE COVERED WITH BUILDINGS.

MAXIMUM FAR:

1. THE MAXIMUM FLOOR AREA RATIO FOR THE ENTIRE EMPLOYMENT CENTER IS .50. 2. THE MAXIMUM FLOOR AREA RATIO FOR INDIVIDUALTRACTS IS

GENERAL NOTES

- 1. PHASING OF INFRASTRUCTURE AND PLATTING IS ANTICIPATED.
- 2. LOTS SHOWN ON THE PLAN ARE ILLUSTRATIVE.
- 3. THE ADDITION OF ROAD ROW AND UTILITY EASEMENTS SHALL BE CONSIDERED A MINOR MODIFICATION TO THE SITE PLAN, PROVIDED THAT THE REVISIONS ARE CONSISTENT WITH THIS SITE PLAN FOR SUBDIVISION AND DESIGN STANDARDS.
- 4. DRIVEWAY ACCESS CUTS FROM PUBLIC ROW'S ARE TO BE DETERMINED DURING INDIVIDUAL SITE DEVELOPMENT DESIGN.
- 5. FUTURE SIDEWALKS ARE TO BE DESIGNED AND CONSTRUCTED DURING INDIVIDUAL LOT SITE DEVELOPMENT.

architecture

interiors

planning

engineering

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ARCHITECT

SUBMITTAL

PROJECT

Phase CA (D) ---

REVISIONS

1 4-26-05 EPC SUBMITTAL REVISIONS 2 5-9-05 EPC SUBMITTAL REVISIONS 3 10-10-05 DRB SUBMITTAL

DRAWN BY SZ, MB, CMM REVIEWED BY

OCTOBER 10, 2005 PROJECT NO. 03069 DRAWING NAME

SITE PLAN FOR SUBDIVISION AND MASTER DEVELOPMENT PLAN

SHEET NO.

STREET DESIGN

INTENT

1. TO ORGANIZE AN ADAPTABLE AND INTERCONNECTED TRANSPORTATION SYSTEM WHICH PROVIDES SUPERIOR ACCESS TO ALL BUILDINGS, SIDEWALKS, TRAILS AND TRANSIT MODES AND WHICH SEEKS TO MINIMIZE NEGATIVE IMPACTS ON AIR POLLUTION AND RELIANCE ON THE AUTOMOBILE.

2. TO PROVIDE A BALANCED SYSTEM OF THROUGH STREETS, TRANSIT CORRIDORS, SIDEMALKS AND TRAILS IN A PATTERN THAT FACILITATES DISPERSED TRAFFIC AND MULTIPLE ACCESS ROUTES TO ALL SITES.

STANDARDS

1. UTILIZE NEW ROAD CLASSIFICATIONS SPECIFIC TO MESA DEL SOL. THIS HIERARCHY OF STREETS:

a. REFLECTS AN INNOVATIVE TRANSPORTATION MODEL THAT INCREASES THE FREQUENCY OF MEDIUM TRAFFIC-VOLUME STREETS IN A GRID-LIKE CONFIGURATION;

- b. DISPERSES VEHICULAR TRAFFIC; AND
- C. CREATES OPPORTUNITIES FOR THE DEVELOPMENT OF MULTI-MODAL CIRCULATION CORRIDORS.



2. THE ROAD SECTIONS FOR THE MESA DEL SOL EMPLOYMENT CENTER, PHASE ONE INCLUDE BOULEVARDS, INDUSTRIAL CONNECTOR AND INDUSTRIAL LOCAL STREETS (SEE STREET SECTION ILLUSTRATIONS).

a. BOULEVARDS:

I. BOULEVARD A RUNS ALONG THE WEST SIDE OF THE EMPLOYMENT CENTER, AND HAS A 100-FOOT RIGHT-OF-WAY COMPRISED OF A 84-FOOT, FOUR-LANE. MEDIAN-DIVIDED, PUBLIC STREET, WITH ON-STREET PARKING LOCATED ON ONE SIDE OF THE STREET - THE SIDE ADJACENT TO THE EMPLOYMENT CENTER. II. BOULEVARD B RUNS ALONG THE SOUTH SIDE OF THE EMPLOYMENT CENTER, AND HAS A 124-FOOT RIGHT-OF-WAY COMPRISED OF A 92-FOOT, FOUR LANE MEDIAN-DIVIDED, PUBLIC STREET, WITH ON-STREET PARKING LOCATED ON BOTH SIDES OF THE STREET.


b. CONNECTOR INDUSTRIAL:


I. CONNECTOR STREETS LINK SMALL AND LARGE STREETS AND DISPERSE TRAFFIC THROUGHOUT THE PROPERTY. STREET C IS THE ONLY INDUSTRIAL CONNECTOR IN PHASE ONE OF THE EMPLOYMENT CENTER, AND HAS A 72-FOOT ROW WITH TWO TRAVEL LANES AND PARKING ON BOTH SIDES OF THE STREET.


C. LOCAL INDUSTRIAL:


I. ALL OTHER STREETS WITHIN THE PHASE ONE EMPLOYMENT CENTER ARE LOCAL INDUSTRIAL STREETS THAT CONVEY VEHICLES AND PEOPLE TO AND FROM BUSINESSES AND LARGER STREETS. THE LOCAL STREETS HAVE A 50' RIGHT-OF-WAY THAT INCLUDES A 28' PUBLIC STREET WITH TWO WIDE TRAVEL LANES AND NO ON-STREET PARKING

3. CURB RADII ON ALL PUBLIC STREETS SHALL BE LIMITED TO 25 FEET. WHILE SMALL CURB RADII ARE CONSIDERED MORE APPROPRIATE FOR PEDESTRIAN CIRCULATION, THE 25-FOOT CURB RADIUS IS THE SMALLEST RECOMMENDED FOR THE ANTICIPATED TYPE OF VEHICULAR TRAFFIC.

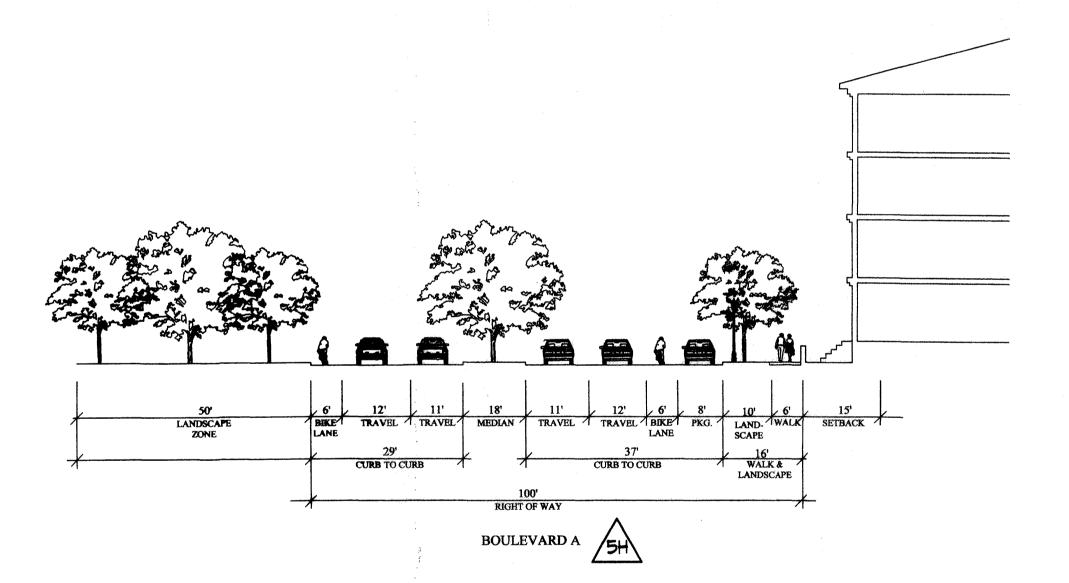

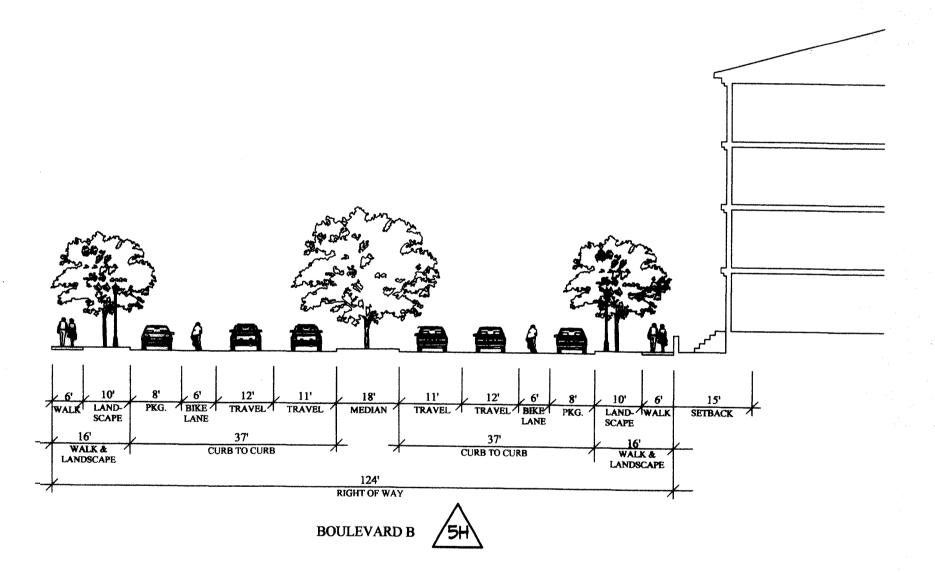

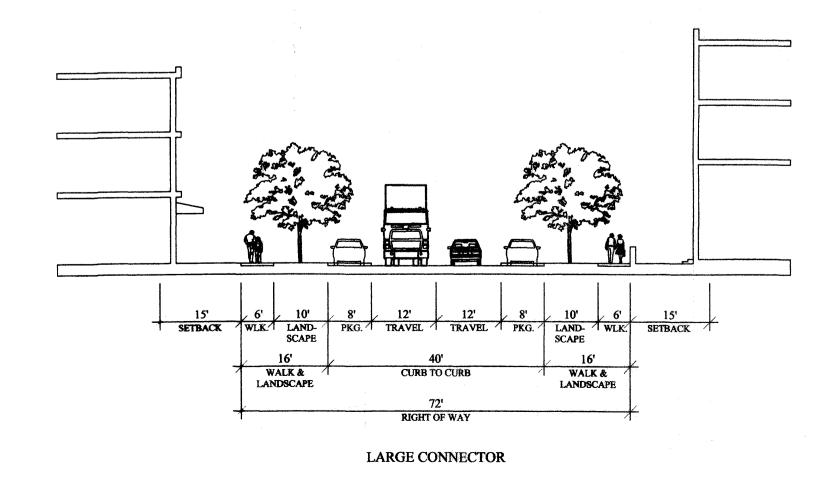

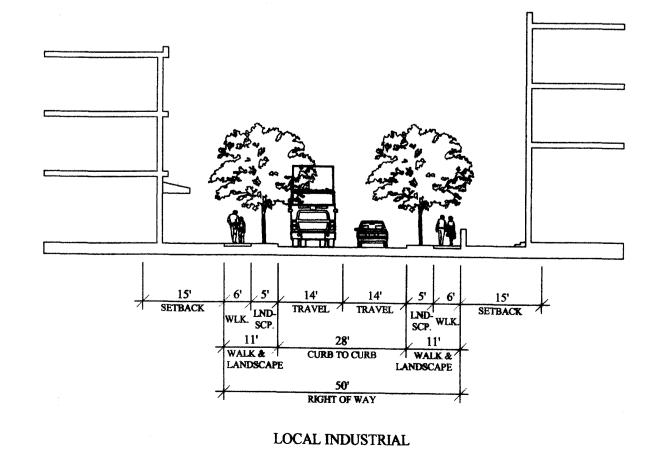

SECTIONS NOT TO SCALE




architecture

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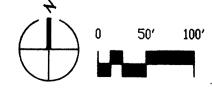
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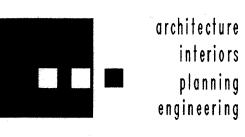
PROJECT NO.

DRAWING NAME SECTIONS -



ENLARGED SITE PLAN

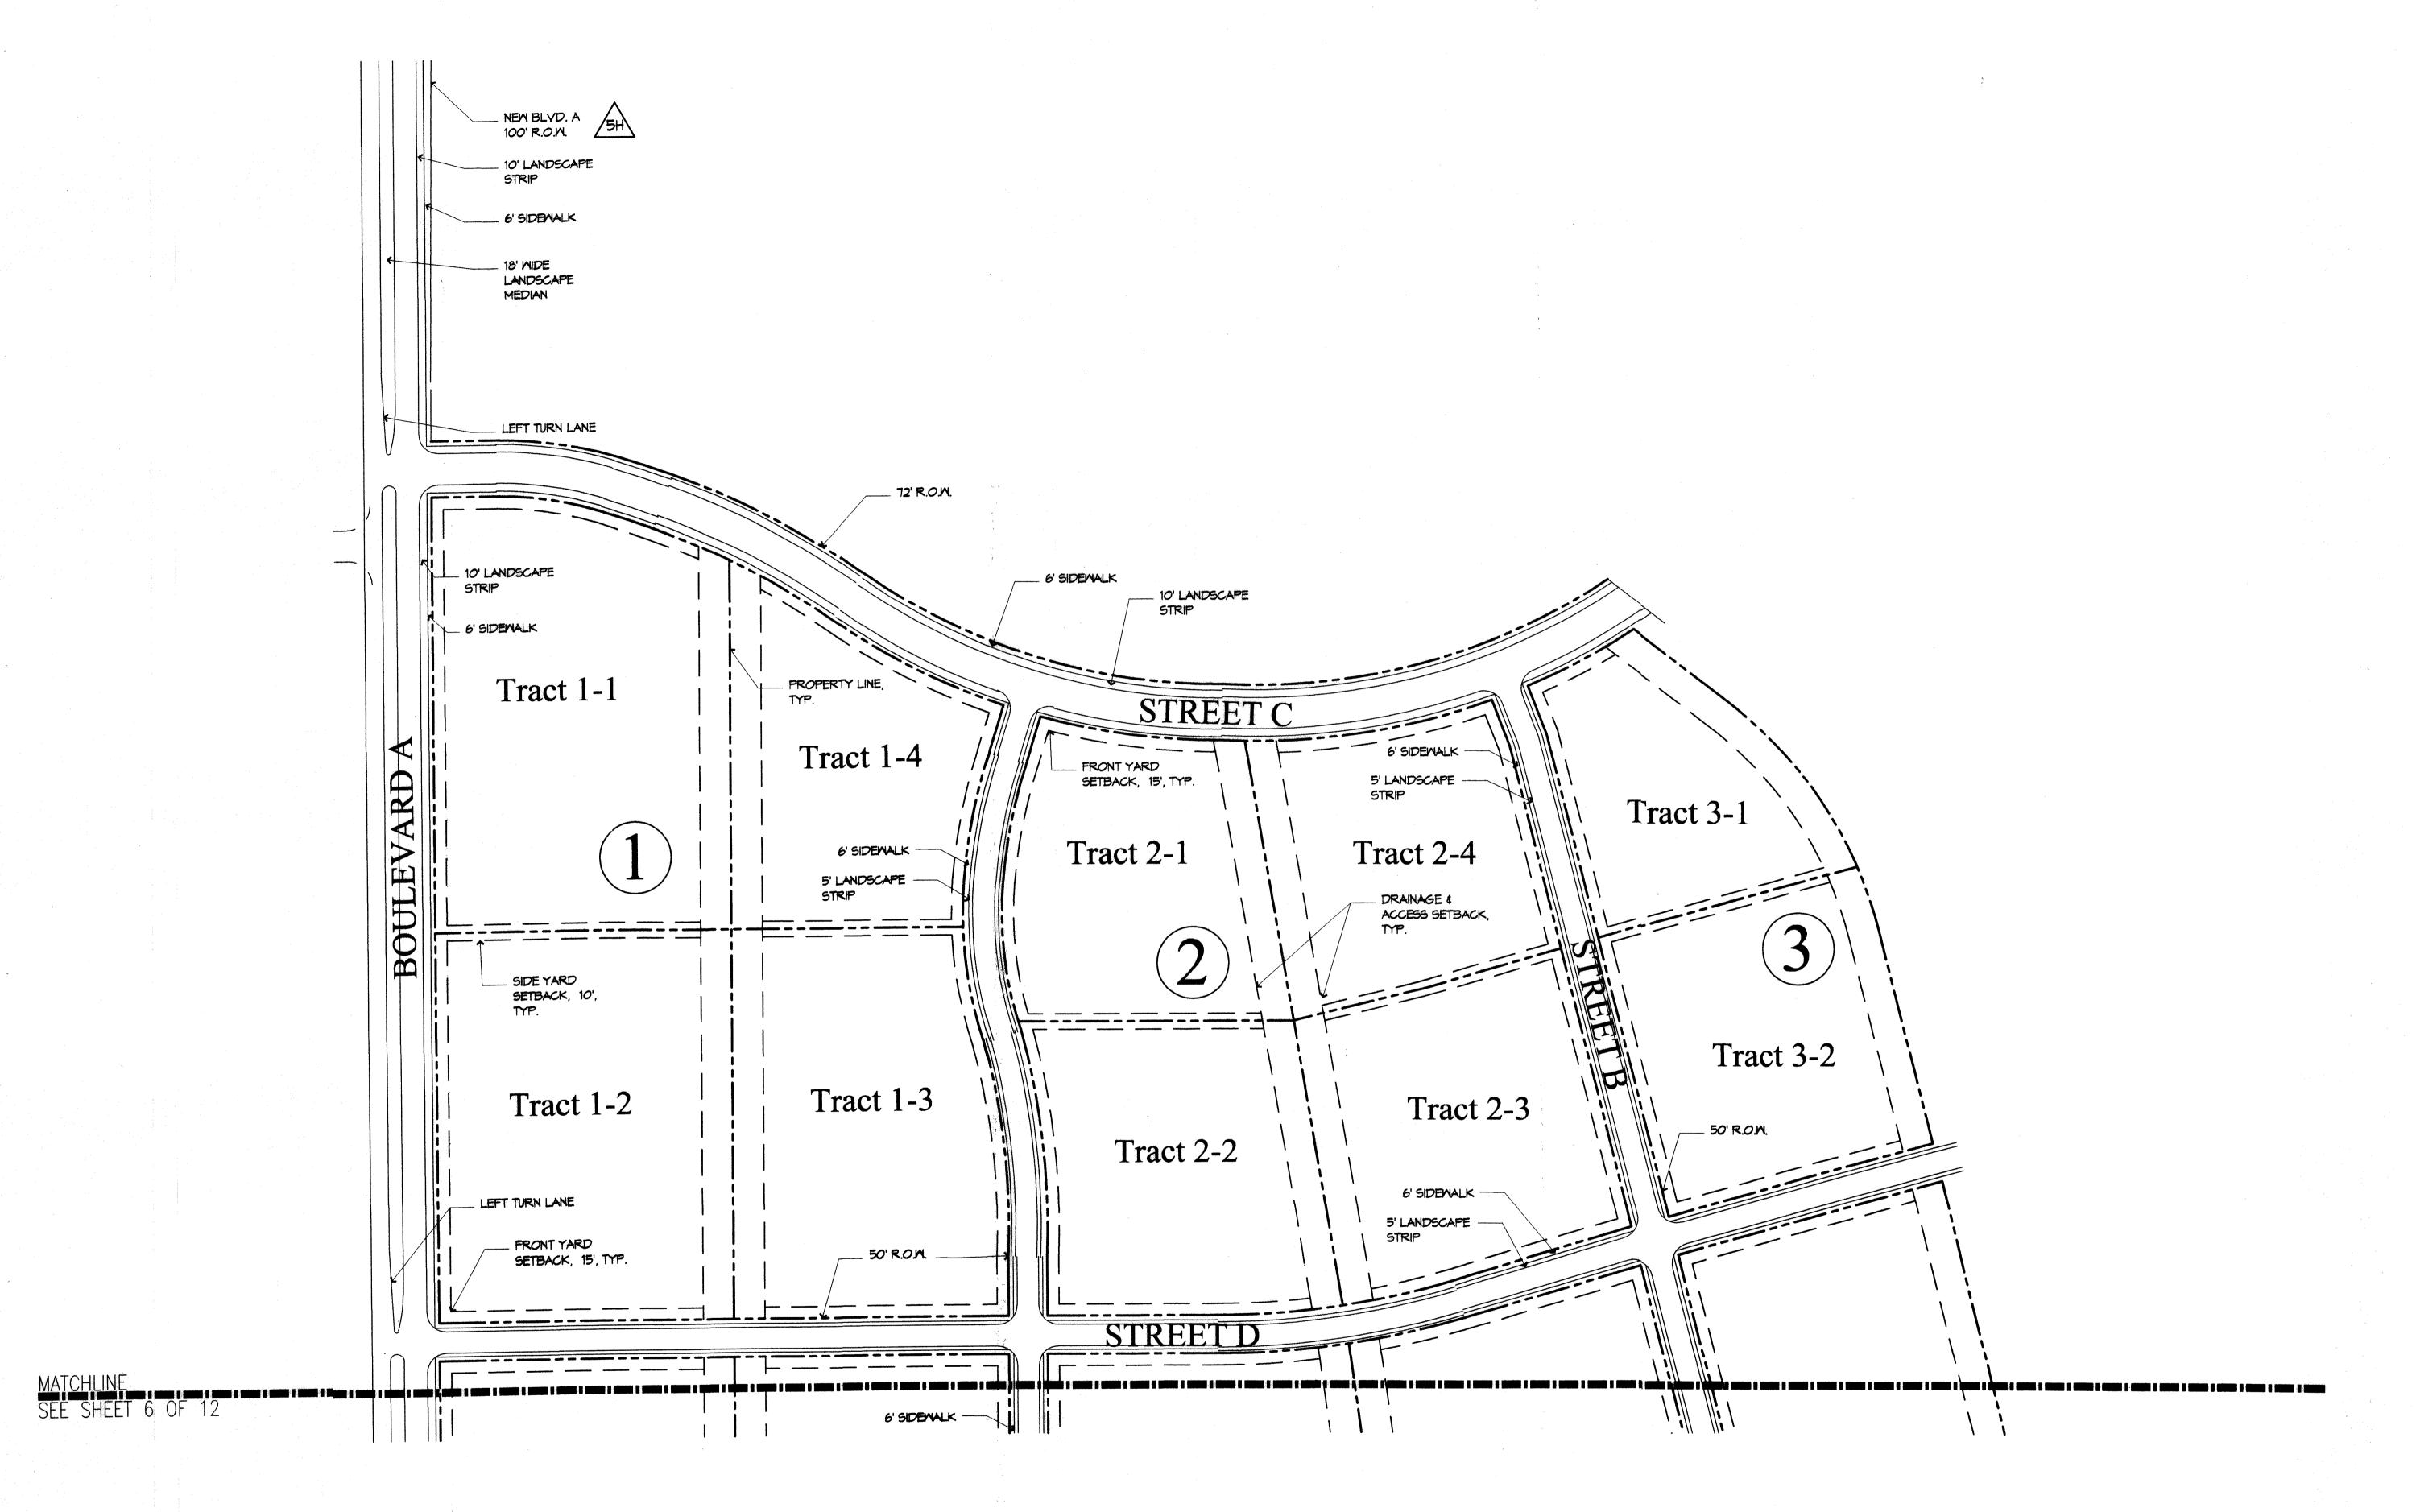



Dekker Perich Sabatin

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PROJECT

MESA DEL SOL

Employment Center - Phase C
Albuquerque, New Mexico
City Project #1004097

3 10-10-05 DRB SUBMITT


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REVIEWED BY DPS
DATE OCTOBER 10, 2005
PROJECT NO. 03069

DRAWING NAME

1" = 100'

ENLARGED SITE
PLAN FOR
SUBDIVISION FOR
MASTER DEV. PLAN

SHEET NO.

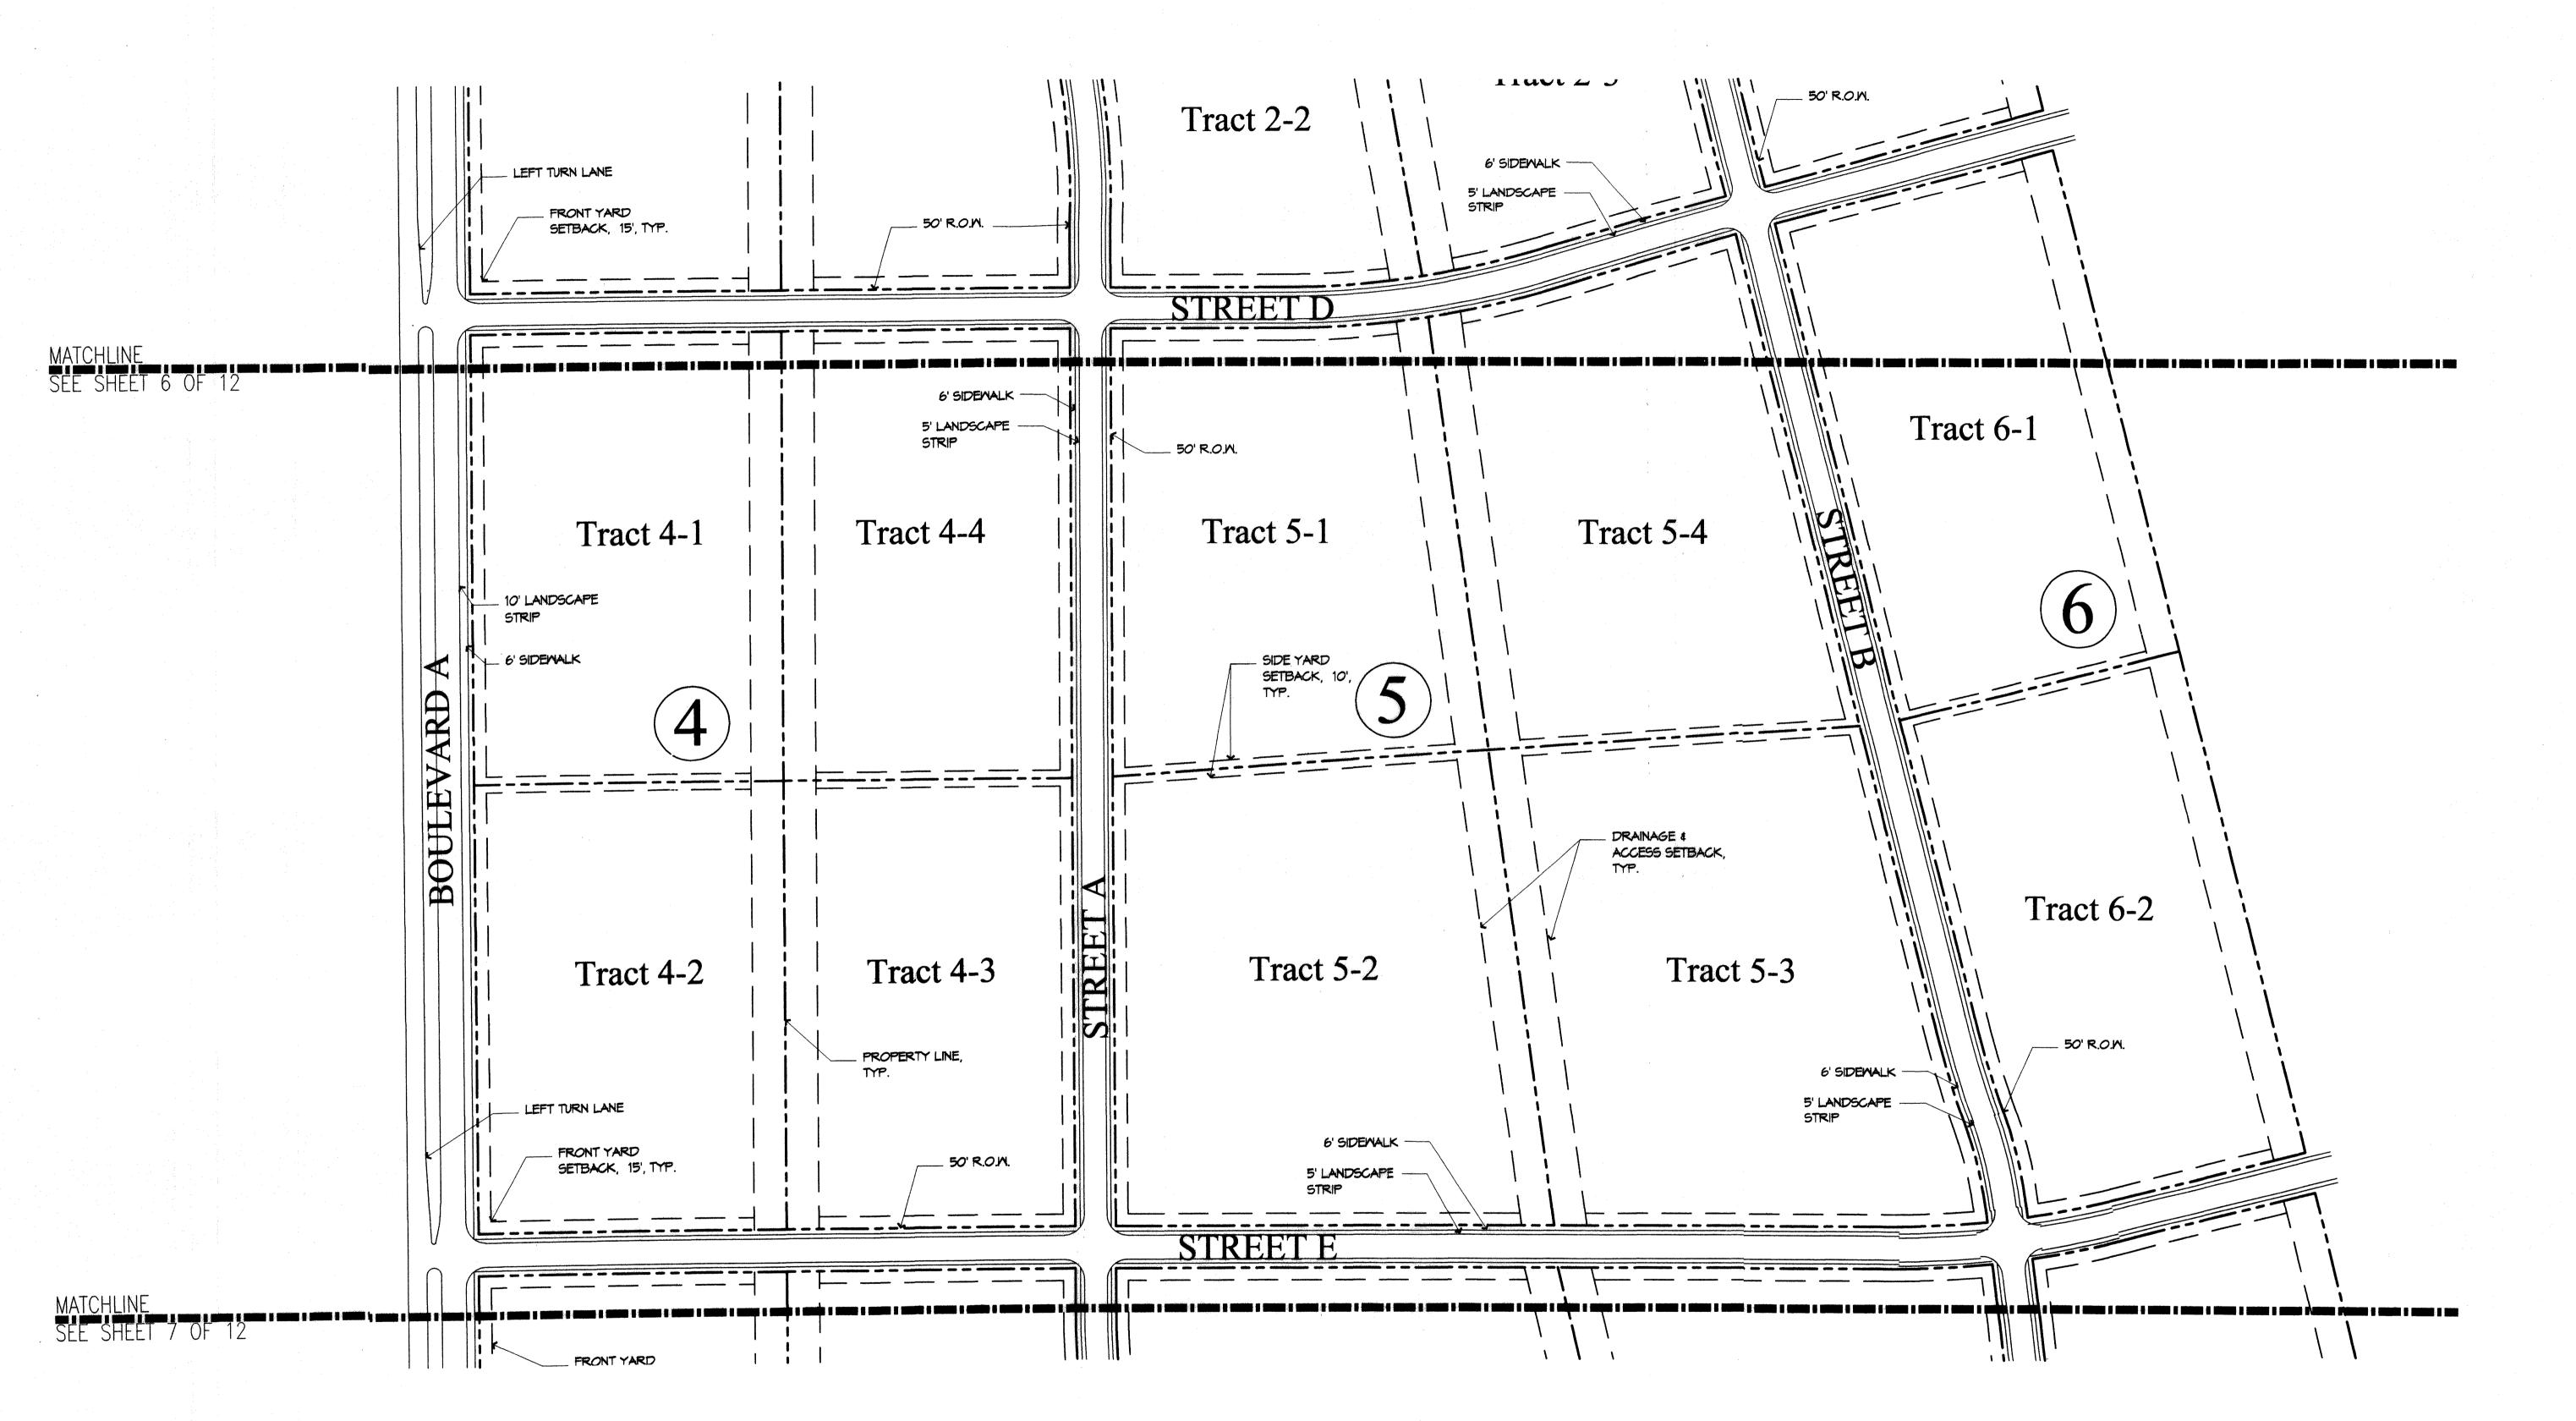

ENLARGED SITE PLAN

1" = 100'

0 50' 100'

Dekker Perich Sabatin

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ARCHITECT

EPC SUBMITTAL

ENGINEER

PROJEC

| MESA DEL SOL | Employment Center - Phase On Albuquerque, New Mexico City Project #1004097

REVISIONS

4-26-05 EPC SUBMITTAL REVISIONS EPC # 05EPC00576/00579


2 5-9-05 EPC SUBMITTAL REVISIONS

3 10-10-05 DRB SUBMITTAL

DRAWN BY SZ, CMM
REVIEWED BY DPS
DATE OCTOBER 10, 2005
PROJECT NO. 03069
DRAWING NAME

ENLARGED SITE PLAN FOR SUBDIVISION FOR MASTER DEV. PLAN

SHEET NO.

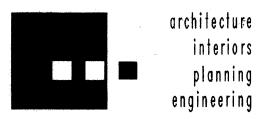

planning engineering

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EPC SUBMITTAL

enter | Employment Cent Albuquerque, N City Project #

REVISIONS


4-26-05 EPC SUBMITTAL REVISIONS EPC # 05EPC00576/00579 2 5-9-05 EPC SUBMITTAL REVISIONS 3 10-10-05 DRB SUBMITTAL

SZ, MB, CMM REVIEWED BY

PROJECT NO. DRAWING NAME

ENLARGED SITE PLAN FOR SUBDIVISION FOR MASTER DEV. PLAN

03069

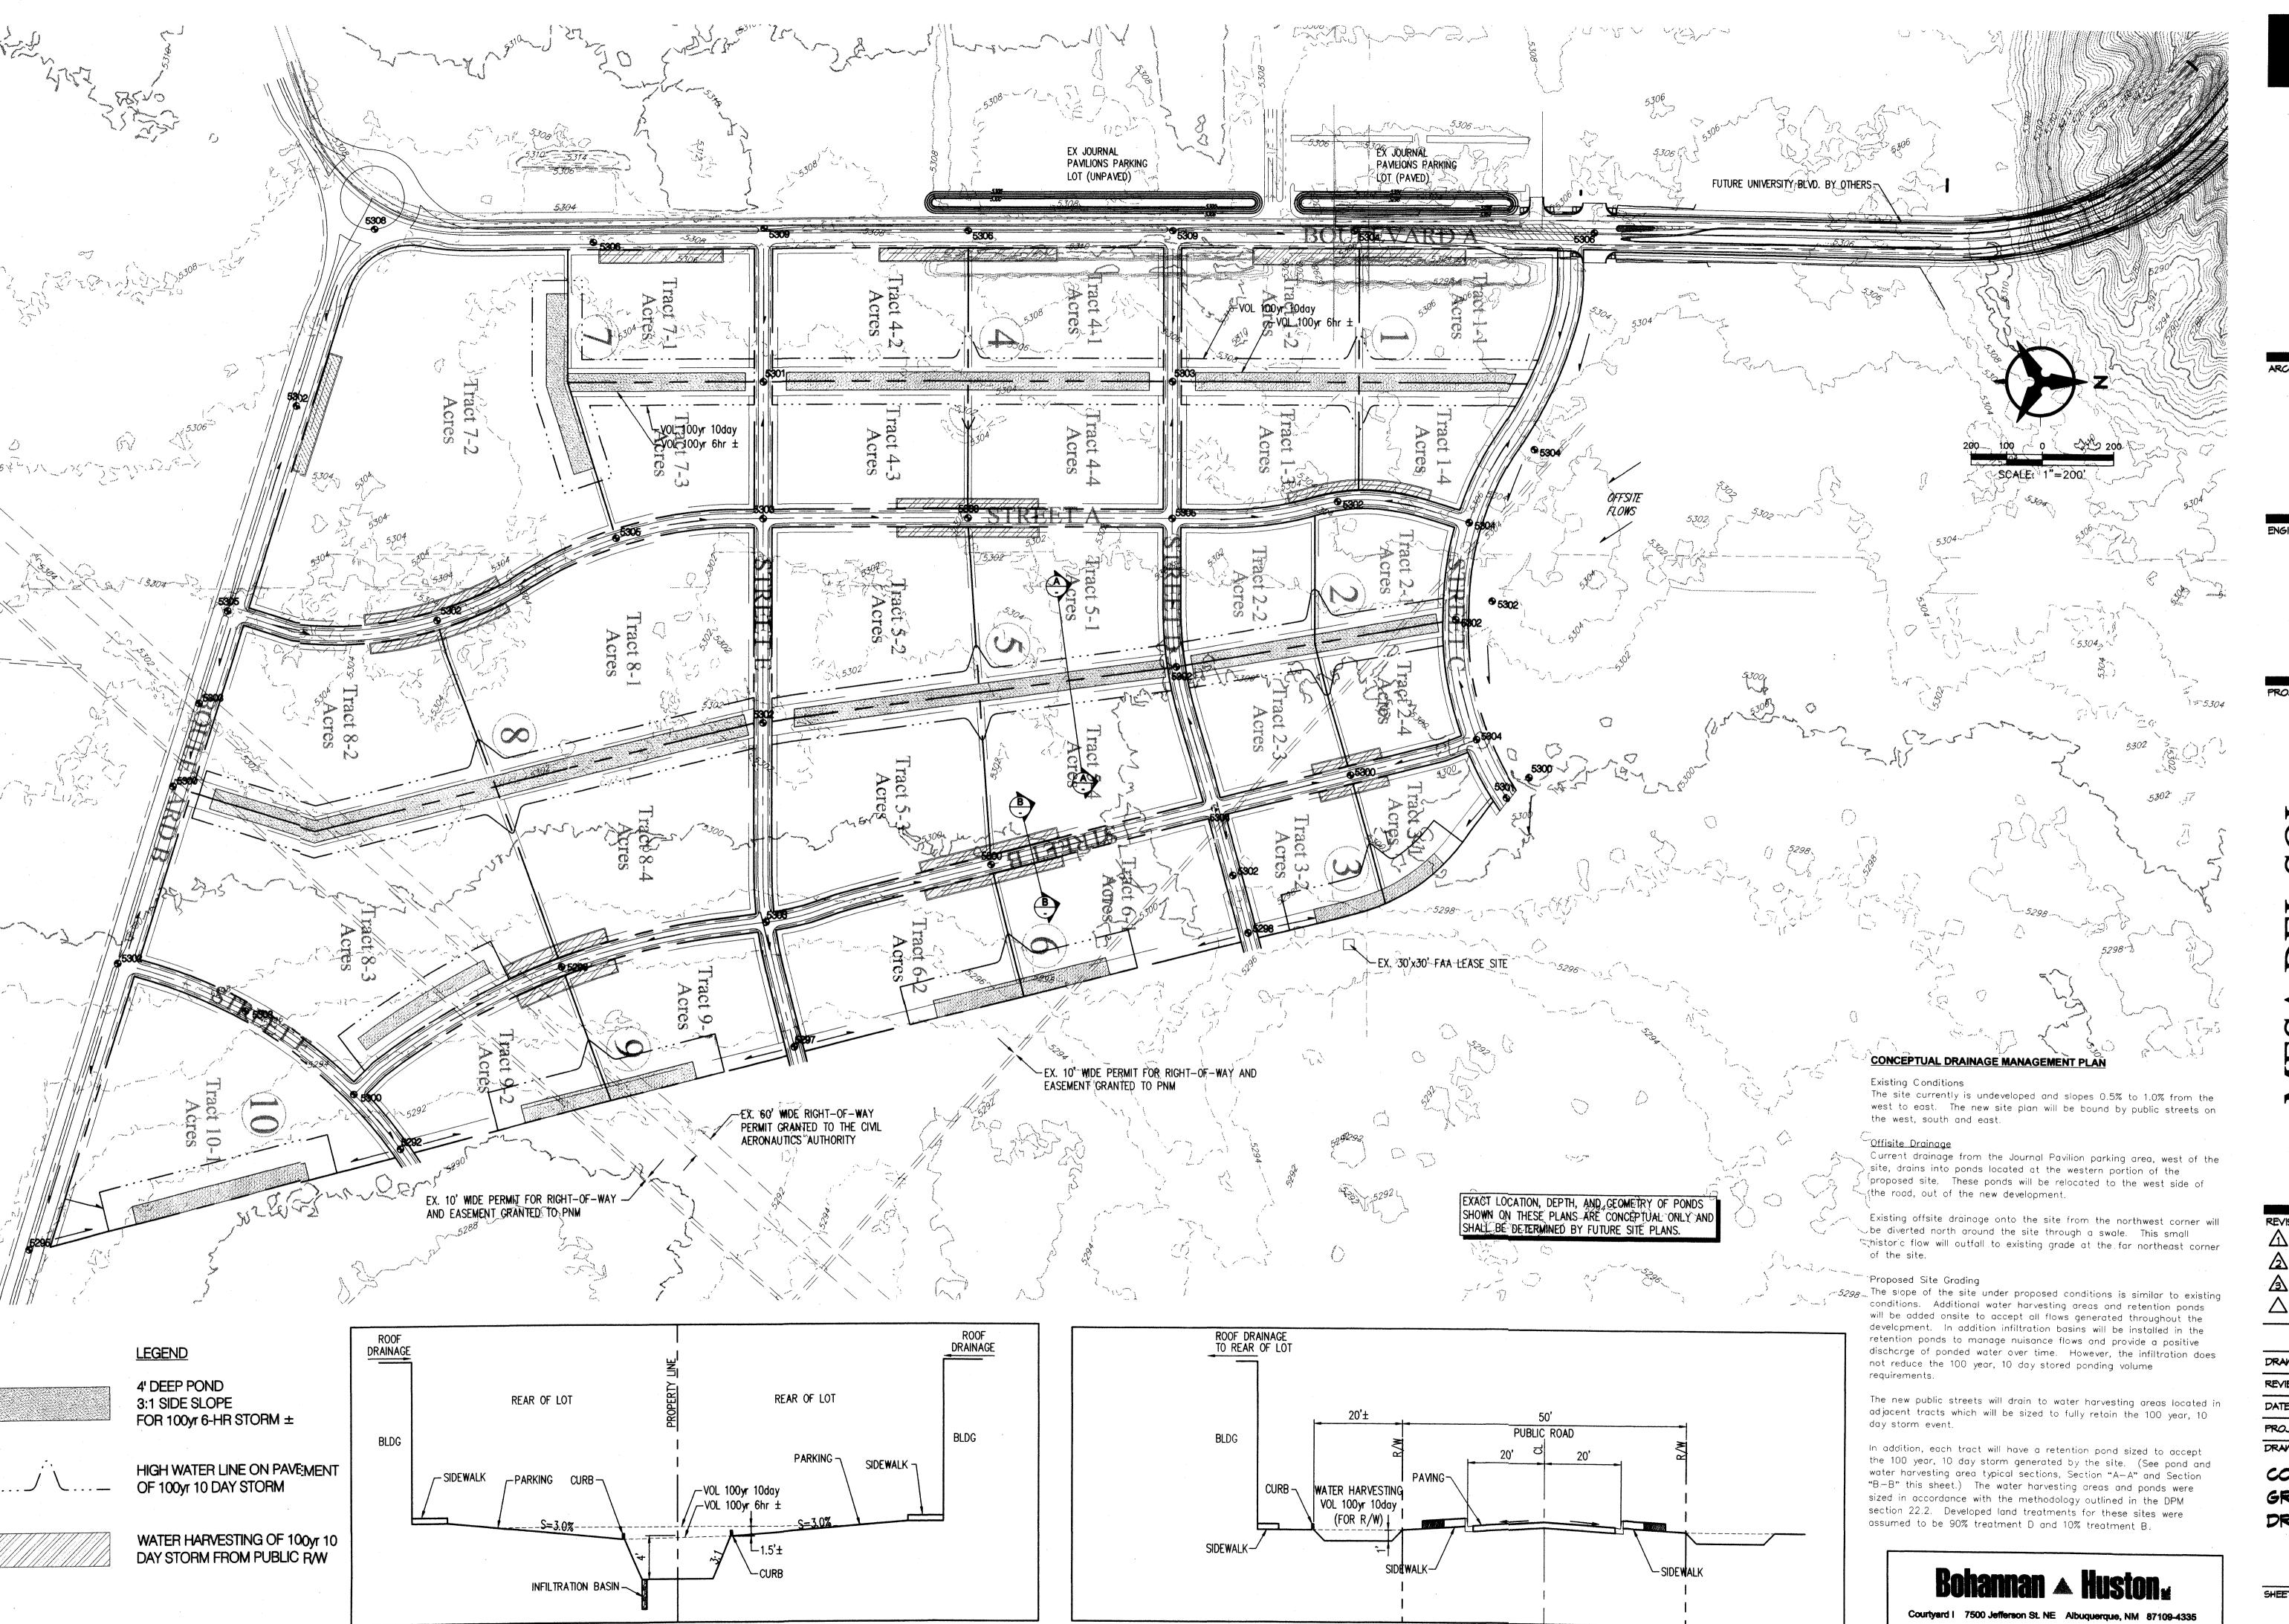

SECTION "B-B"

SECTION "A-A"

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6801 Jefferson NE Suite 100 Albuquerque, NM 87109 505 761-9700 fax 761-4222 dps⊕dpsabq.com

enter Albuquerque, N City Project Employment

4-26-05 EPC SUBMITTAL REVISIONS EPC #05EPC00576/00579 5-4-05 EPC SUBMITTAL REVISIONS 10-10-05 DRB SUBMITTAL

DRAWN BY REVIEWED BY

DATE OCTOBER 10, 2005


PROJECT NO. DRAWING NAME

CONCEPTUAL grading &

DRAINAGE PLAN

SHEET NO.

ENGINEERING & SPATIAL DATA & ADVANCED TECHNOLOGIES

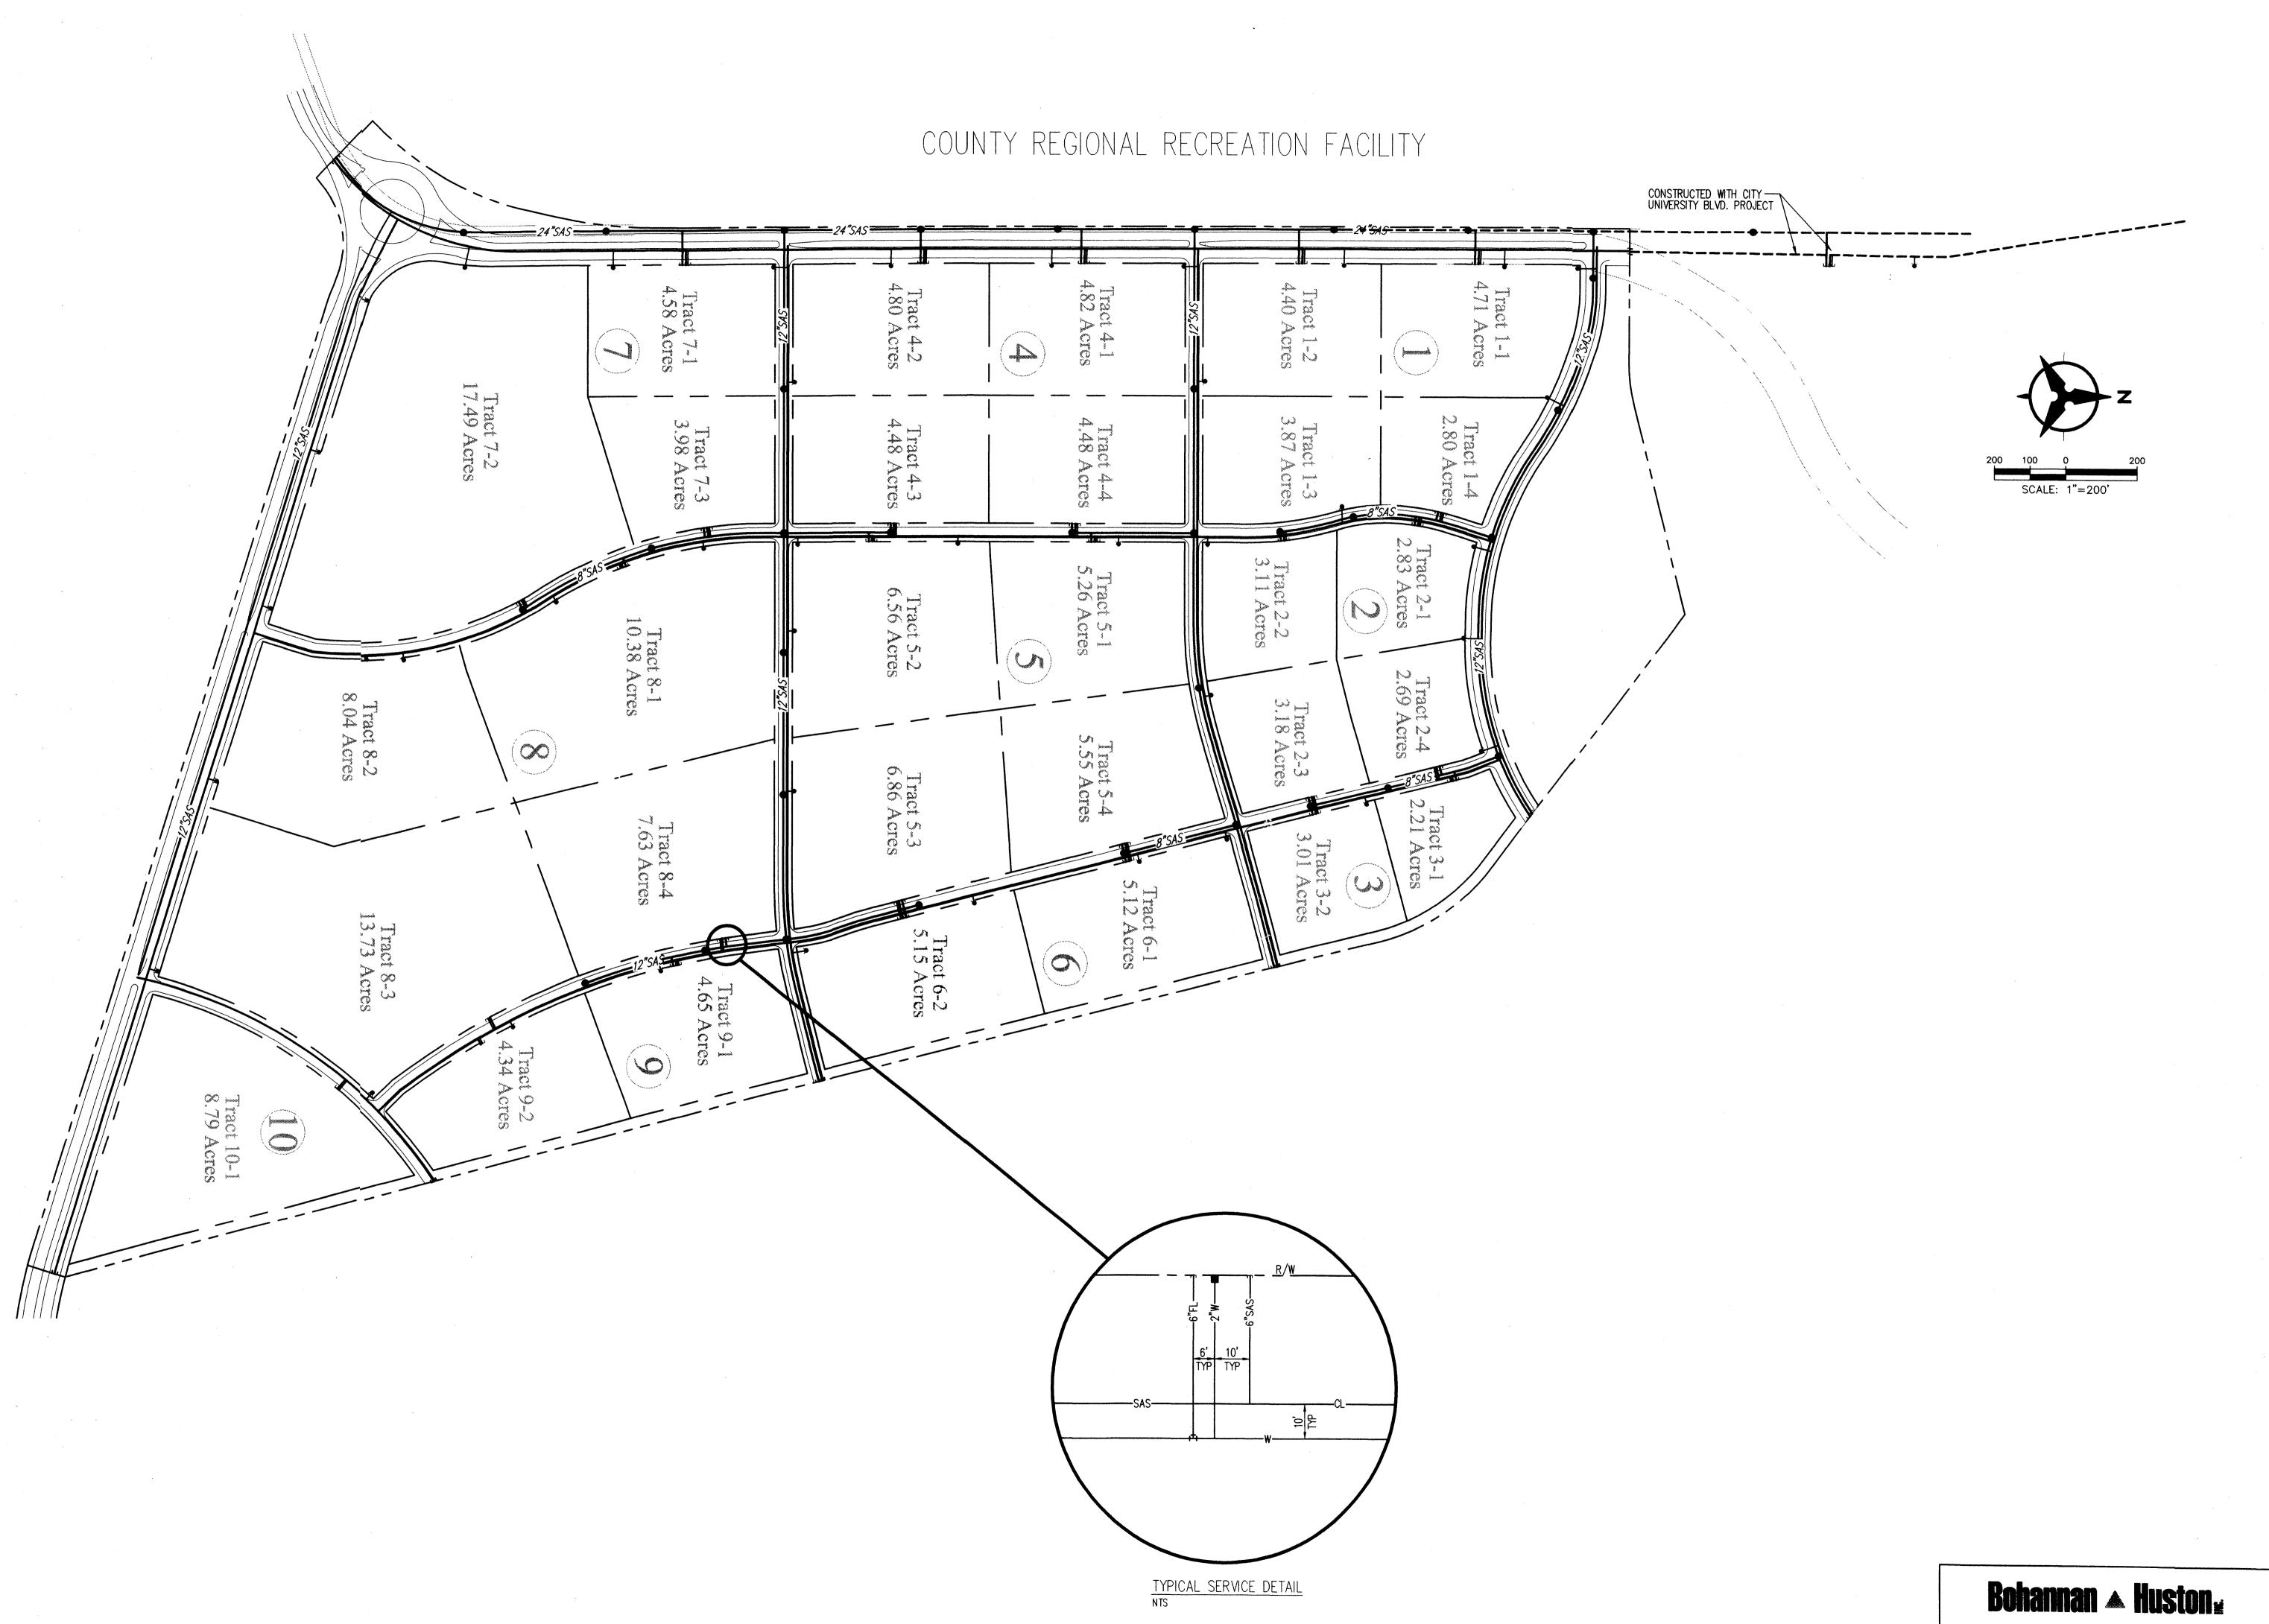

architecture

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5-9-05 EPC SUBMITTAL REVISIONS

REVIEWED BY DATE OCTOBER 10, 2005 PROJECT NO. 03069

DRAWING NAME CONCEPTUAL

UTILITY PLAN

ENGINEERING & SPATIAL DATA & ADVANCED TECHNOLOGIES

SHEET NO.

MASTER DEVELOPMENT PLAN DESIGN STANDARDS

INTRODUCTION

THE OVERALL GOAL OF THE MESA DEL SOL EMPLOYMENT CENTER PHASE ONE IS TO ESTABLISH A PREMIER, SUSTAINABLE, EMPLOYMENT CAMPUS THAT WILL DRAW AND ACCOMMODATE A WIDE VARIETY OF JOB-CREATING BUSINESSES TO THE AREA.

THESE DESIGN GUIDELINES ARE WRITTEN AS INTENT STATEMENTS WITH DESIGN STANDARDS, AND ARE TO BE OBSERVED ACCORDINGLY.

PERMISSIVE USES

THIS ZONE PROVIDES SUITABLE SITES FOR A WIDE RANGE OF INDUSTRIAL. OFFICE AND COMMERCIAL USES. PERMISSIVE USES IN THE SU-1 FOR IP ZONE INCLUDE ALL OF THE PERMISSIVE AND CONDITIONAL USES LISTED IN THE CITY OF ALBUQUERQUE ZONING CODE SECTION 14-16-2-19. INDUSTRIAL PARK ZONE.

DESIGN STANDARDS - GENERAL INTENT THE GENERAL INTENT OF THE MESA DEL SOL EMPLOYMENT CENTER PHASE ONE DESIGN GUIDELINES IS TO:

- 1. ESTABLISH A PRACTICAL, INTERCONNECTED SYSTEM OF STREETS AND OPEN SPACES THAT ALLOW EASY ORIENTATION AND CONVENIENT ACCESS FOR ALL MODES OF TRANSPORTATION.
- 2. ACCOMMODATE A BROAD MIX OF DEVELOPMENT TYPES.
- 3. PROVIDE COMMON USABLE OPEN SPACE THAT IS OF MUTUAL BENEFIT TO SURROUNDING PROPERTY OWNERS, BUSINESSES EMPLOYEES AND VISITORS.
- 4. CONSTRUCT THE EARLY PHASES OF DEVELOPMENT IN A MANNER THAT ESTABLISHES A PATTERN, CHARACTER AND IDENTITY FOR THE LONG-TERM EVOLUTION OF THE EMPLOYMENT CENTER AND THE ENTIRE MESA DEL SOL COMMUNITY.
- 5. CREATE A BUILT ENVIRONMENT THAT IS IN SCALE AND CHARACTER WITH PEDESTRIAN-ORIENTED ACTIVITIES.
- 6. PROVIDE A FRAMEWORK FOR DEVELOPMENT THAT ENCOURAGES THE USE OF SUSTAINABLE PLANNING AND DESIGN PRACTICES.

PROJECT IDENTITY

- 1. ESTABLISH AN IMAGE FOR A STATE-OF-THE-ART EMPLOYMENT CENTER THAT LOOKS APPROPRIATE AND TIMELESS IN THE HIGH DESERT SETTING.
- 2. CREATE INDUSTRIAL AND COMMERCIAL ARCHITECTURE THAT EMPHASIZES THE UNIQUE CHARACTERISTICS OF ARCHITECTURAL STYLES PRESENT IN NEW MEXICO.

STANDARDS

- 1. SITE PLANNING, ARCHITECTURE, LANDSCAPE, LIGHTING AND SIGNAGE DESIGN ARE TO BE COORDINATED IN ORDER TO REINFORCE THE PROJECT IDENTITY.
- 2. FOCAL AREAS FOR PROJECT IDENTITY DESIGN SHALL BE THE PRIMARY ROAD CORRIDORS, ENTRIES TO THE PROPERTY, PUBLIC BUILDING ENTRANCES, INTERNAL CIRCULATION AREAS, AND PRIVATE RECREATION AND GATHERING SPACES.
- 3. FOR ADDITIONAL INFORMATION, SEE DESIGN STANDARDS FOR SITE PLANNING, ARCHITECTURE, LANDSCAPE, LIGHTING AND SIGNAGE.

SITE PLANNING

- 1. PROVIDE FOR COMPATIBILITY OF USE, ACC, ESS, AND CIRCULATION BETWEEN ADJOINING PROPERTIES
- 2. ENSURE THAT STREETS ARE TREATED AS IDEVELOPMENT FRONTAGE.
- 3. SET STANDARDS OF QUALITY THAT WILL ENSURE LONG-TERM VALUE AND MAINTAINABILITY OF PROPERTIES.
- 4. ENSURE THAT BUILDING PLACEMENT AND ORIENTATION IS CONSISTENT WITH PEDESTRIAN-ORIENTED DEVELOPMENT
- 5. MINIMIZE NEGATIVE VISUAL IMPACTS OF SERVICE AREAS AND DISCOURAGE ANY DEVELOPMENT FROM ORIENTING POOR QUALITY BUILDING FACADES OR SERVICE AREAS TOWARD A PUBLIC STREET.
- 6. PROVIDE FOR THE COORDINATION OF DESIGN AND LOCATION OF WALLS AND FENCES TO MAXIMIZE THE POSITIVE INTERRELATIONSHIP OF BUILDINGS, PUBLIC STREETS AND OPEN SPACE.
- 7. PROVIDE AREA(S) WITHIN EACH TRACT WHERE STORM WATER RUNOFF CAN BE DIRECTED AND USED TO SUPPLEMENT AUTOMATED IRRIGATION.

- 8. PROVIDE OPPORTUNITIES FOR MID-BLOCK PEDESTRIAN CIRCULATION.
- 9. RE-ESTABLISH DESERT GRASSLAND, NEW WILDLIFE AND PLANT HABITAT CORRIDORS WITHIN THE EMPLOYMENT CENTER.

STANDARDS

- 1. LOTS SHALL BE DESIGNED TO MINIMIZE CONFLICTS BETWEEN AUTOMOBILES, TRUCKS, BIKES, AND PEDESTRIANS, AS WELL AS TO CREATE AN ORGANIZED SYSTEM OF ENTRANCES, DRIVEWAYS, PARKING LOTS AND DELIVERY AREAS.
- 2. NO DEVELOPMENT SHALL BE PERMITTED TO PLACE OR ORIENT BUILDINGS, PARKING, CIRCULATION, OR SERVICE FACILITIES ON A LOT IN SUCH A WAY AS TO TREAT PRIMARY STREET FRONTAGE(S) AS A REAR LOT LINE.
- 3. ALL BUILDING FRONTAGES VISIBLE FROM A STREET SHALL HAVE THE EQUIVALENT TREATMENT OF THE PRIMARY BUILDING FACADE AND COMPLETELY SCREEN ALL SERVICE AND LOADING FACILITIES.
- 4. LARGE BUILDINGS OVER 30,000 SQUARE FEET SHALL BE LOCATED TO MINIMIZE THE IMPACT OF WINDOWLESS WALLS AND SERVICE AREAS ON PUBLIC STREETS.

5. WALLS AND FENCES:

- a. IF PROVIDED, WALLS AND FENCES SHALL COMPLY WITH THE INTENT OF THE CITY'S DESIGN MANUAL FOR SUBDIVISION ACCESS AND PERIMETER WALLS. CHAIN LINK FENCING IS NOT ALLOWED. b. WALLS AND FENCES EXCEEDING FOUR FEET IN HEIGHT THAT ARE LOCATED WITHIN THE SETBACK AREA ADJOINING A PUBLIC STREET. SHALL PROVIDE VARIETY AND ARTICULATION AT INTERVALS NOT
- EXCEEDING 100 FEET THROUGH NOT LESS THAN TWO OF THE FOLLOWING METHODS: I. CHANGES IN PLANE OF NOT LESS THAN TWO FEET:
- III. VARIATION OF MATERIAL: AND/OR IV. VARIATION OF FORM, SUCH AS FROM SOLID TO OPEN PICKETS. V. THE DESIGN AND MATERIALS FOR WALLS AND FENCES SHALL BE COORDINATED WITH THE DESIGN AND MATERIALS OF THE PRINCIPAL BUILDINGS IN TERMS OF COLOR, QUALITY, SCALE AND DETAIL.

II. EXPRESSION OF STRUCTURE, SUCH AS POST, COLUMN, OR PILASTER

6. STORAGE AREAS MUST BE SCREENED.

NOT LESS THAT ONE FOOT IN WIDTH;

7. ACCESSIBLE ROUTES SHALL BE PROVIDED BETWEEN BUILDINGS, AND BETWEEN BUILDINGS AND ACCESSIBLE PARKING.

/8B\ B. IN ORDER TO FACILITATE PEDESTRAIN ACCESS FROM NON-WAREHOUSE/NON-INDUSTRIAL USE AREAS TO FUTURE TRANSIT SERVICE ALONG ENHANCED TRANSIT CORRIDORS, THE CREATION OF A NETWORK OF PEDESTRIAN PATHS BETWEEN PROPOSED LOTS WILL BE ENCOURAGED AND ALLOWED. ADDITIONALLY THE CONCEPTUAL SITE PLAN ON SHEET 11 OF 12 ILLUSTRATES THE APPLICANT'S INTENTION TO CREATE PEDESTRIAN ACCESS WITHIN THE LARGER BLOCKS THAT ARE DESIGNATED FOR NON-INDUSTRIAL, PRIMARILY OFFICE BUILDINGS.

- 9. ACCESS AND DRAINAGE EASEMENTS SHALL BE PROVIDED ALONG THE REAR TRACT LINES. IN THE MIDDLE OF THE BLOCKS.
- 10. SERVICE AND EMERGENCY SERVICE LANES SHALL BE DESIGNED AS PART OF THE SITE CIRCULATION AND SHALL NOT BE USE DEDICATED LANES THAT ADD IMPERVIOUS SURFACE.
- 11. SERVICE AREAS AND STORAGE AREAS SHALL NOT FRONT ONTO STREETS AND OPEN SPACES.
- 12. REFUSE STORAGE AND PICK-UP AREAS SHALL BE COMBINED WITH OTHER SERVICE AND LOADING AREAS TO THE EXTENT PRACTICABLE. UNLESS NOTED OTHERWISE, ALL DEVELOPMENT SHALL COMPLY WITH THE SWMD ORDINANCES AND REQUIREMENTS.
 - 13. WHERE POSSIBLE, UTILITY EQUIPMENT SHALL BE LOCATED TO FACILITATE ACCESS AND CONNECTION TO MULTIPLE PROPERTIES.
 - 14. UTILITY APPURTENANCES WITHIN THE RIGHT-OF-WAY SHALL BE LOCATED BEHIND THE SIDEWALK AND OUT OF THE LANDSCAPE ZONE BETWEEN THE CURB AND SIDEWALK. IF THEY MUST BE LOCATED NEAR THE CURB, EQUIPMENT SHALL BE CENTERED IN THE LANDSCAPE SPACE
- $\sqrt{2}$ 15. Sustainable site planning, building design and construction AS OUTLINED BELOW IS REQUIRED:
 - a. SITE PLANS MUST INCLUDE INTEGRATED GRADING AND DRAINAGE, ARCHITECTURE AND LANDSCAPE DESIGN, AND SHALL BE CREATED TO ACHIEVE OPTIMUM SUSTAINABILITY.
 - b. SUSTAINABLE DESIGN PRINCIPLES, ENVIRONMENTALLY-RESPONSIBLE BUILDING CONCEPTS, AND EARTH-FRIENDLY PRODUCTS SHALL GUIDE DESIGN AND DEVELOPMENT OF FUTURE SITE DEVELOPMENT PLANS.

16. SITE PLANS FOR BUILDING PERMIT THAT ARE ADJACENT TO UNIVERSITY BLVD. (BLVD. "A" IN THE SUBMITTAL) SHALL SHOW PEDESTRIAN CONNECTIONS TO THE STREET AND PROVIDE ENTRANCES THAT ARE ORIENTED TOWARDS UNIVERSITY BOULEVARD (BOULEVARD

PARKING

INTENT

1. ENCOURAGE COMPREHENSIVE, MULTI-USE PARKING STRATEGIES THAT MINIMIZE REDUNDANT ACCESS AND THAT MAXIMIZE OPEN SPACE AND LANDSCAPING AS WELL AS CONVENIENT AND SAFE AUTO AND PEDESTRIAN CIRCULATION WITHIN AND BETWEEN SITES

- 2. CREATE A CLEARLY ORGANIZED SYSTEM OF ENTRANCES DRIVEWAYS, PARKING AREAS, AND PEDESTRIAN CIRCULATION.
- 3. MITIGATE HEAT/GLARE THROUGH THE PROVISION OF LANDSCAPING.
- 4. MINIMIZE THE VISUAL IMPACT OF PARKING AREAS ON STREETS AND ADJOINING DEVELOPMENT. GENERALLY LOCATE PARKING LOTS TO THE SIDE OR REAR OF BUILDINGS. MAXIMIZE THE POSITIVE CHARACTER OF STREETS AND BUILDINGS THROUGH CONTINUITY OF BUILDINGS AND LANDSCAPE FRONTAGE.
- 5. UTILIZE STORM WATER SURFACE RUNOFF TO SUPPLEMENT AUTOMATED LANDSCAPE IRRIGATION.

STANDARDS

- 1. PARKING SPACE QUANTITY AND DIMENSION REQUIREMENTS SHALL BE PER THE CITY OF ALBUQUERQUE'S COMPREHENSIVE ZONING CODE AND DEVELOPMENT PROCESS MANUAL.
- 2. CITY AREA REQUIREMENTS FOR PARKING LOT LANDSCAPING SHALL
- 3. PARKING AREAS SHALL BE SUBDIVIDED INTO SUB AREAS WITH LANDSCAPING AND PEDESTRIAN CIRCULATION CORRIDORS SO THAT NO SUB AREA CONSISTS OF MORE THAN 150 PARKING SPACES.
- 4. CLEAR PEDESTRIAN CONNECTIONS SHALL BE PROVIDED THROUGH PARKING AREAS.
- 5. ADA-COMPLIANT PARKING SHALL BE LOCATED ADJACENT TO MAIN BUILDING ENTRIES.
- 6. PARKING AND VEHICULAR CIRCULATION BETWEEN STREETS AND BUILDINGS SHALL BE LIMITED. SHARED PARKING AND CIRCULATION IS ENCOURAGED WHEREVER PRACTICAL
- 7. NO TRUCK PARKING OR DOCKS ARE PERMITTED FACING ANY BOULEVARD OR CONNECTOR STREET
- 8. WATER HARVESTING, WATER COLLECTION, POROUS PAVING AND OTHER SUSTAINABLE SITE DEVELOPMENT METHODS MAY BE APPLIED IN THE PARKING LOTS TO REDUCE DEPENDENCE ON IRRIGATION AND REDUCE SURFACE STORM-WATER RUN-OFF.
- 9. PARKING SHALL BE SCREENED FROM CONTIGUOUS PUBLIC STREETS. SCREENING MAY INCLUDE EARTH BERMS, LANDSCAPING, PERIMETER OR RETAINING FENCES OR WALLS, IF FENCES OR WALLS ARE USED. THEY SHALL BE DESIGNED TO INTEGRATE WITH THE MATERIALS AND DESIGN OF ADJACENT BUILDINGS AND THE EMPLOYMENT CENTER AS A MHOLE.
- 10. CAR/VANPOOL PREFERRED PARKING SHALL BE PROVIDED NEAR BUILDING ENTRANCES AND SHALL BE CLEARLY DEMARCATED

BICYCLE FACILITIES

INTENT

- 1. DESIGN A SAFE, CONVENIENT AND INTER-CONNECTED SYSTEM OF BICYCLE FRIENDLY STREETS, PATHS AND ROUTES.
- 2. ACCOMMODATE BICYCLE ACCESS BY PROVIDING DEFINED ROUTES TO PRIMARY BUILDING ENTRIES.
- 3. SUPPORT ALTERNATIVE MODES OF TRANSPORTATION IN AND AROUND THE MESA DEL SOL PHASE ONE EMPLOYMENT CENTER.

STANDARDS

- 1. BICYCLE PARKING FOR EMPLOYEES SHALL BE PROVIDED TO PROMOTE ALTERNATIVE VEHICLE USE. ONE BICYCLE RACK SPACE PER 50 PARKING SPACES IS REQUIRED, AND SHALL BE CONVENIENTLY LOCATED NEAR BUILDINGS.
- 2. COVERED AND SECURED BICYCLE STORAGE FOR 10 PERCENT OF THE REQUIRED BICYCLE PARKING SHALL BE PROVIDED.
- 3. A CONVENIENT SHOWER FACILITY SHALL BE AVAILABLE TO BICYCLISTS AND OTHER EMPLOYEES.
- 4. BICYCLE ACCESS SHALL BE PROVIDED BETWEEN BICYCLE LANES OR TRAILS AND ON-SITE BICYCLE PARKING AREAS.

SETBACKS

- 11 1. ENCOURAGE THE PLACEMENT OF BUILDINGS TO DEFINE ORDERLY STREET SPACES AND URBAN CHARACTER IN A CONSISTENT MANNER. THE DEVELOPER SHALL CREATE ONE OR MORE STREET CORRIDORS IN WHICH THE BUILDINGS FRAME BOTH SIDES OF THE STREET. IT IS RECOMMENDED THAT THESE BE LOCATED ON THE BOULEVARD WHICH ESTABLISH THE CHARACTER FOR THE EMPLOYMENT CENTER AND/OR SELECTED AREAS INTERNAL TO THE EMPLOYMENT CENTER.
- 2. CREATE BUILDINGS THAT PROVIDE HUMAN SCALE, INTEREST AND VARIATION IN THEIR OVERALL FORM.

STANDARDS


- 1. BUILDINGS SHALL BE LOCATED ACCORDING TO THE FOLLOWING SETBACK DIMENSIONS:
- a. FRONT-YARD SETBACK: 15 FEET
- b. SIDE-YARD SETBACK: 10 FEET:
- C. REAR-YARD SET BACK: 10 FEET.

2. PARKING SETBACKS:

- a. A MINIMUM LANDSCAPED STRIP OF TEN FEET SHALL BE MAINTAINED BETWEEN PARKING AREAS AND THE STREET RIGHT-OF-WAY LINE, REGARDLESS OF SITE
- b. A MINIMUM LANDSCAPED STRIP OF 6 FEET SHALL BE MAINTAINED BETWEEN PARKING AREAS AND ADJACENT LOTS, REGARDLESS OF SITE SIZE,

ARCHITECTURE

- 1. ENCOURAGE BUILDING FORMS THAT WILL DEFINE HIGH QUALITY, ORDERLY AND REGULAR STREET SPACES, COMPATIBLE RELATIONSHIPS TO ADJOINING SITES, AND URBAN CHARACTER.
- 2. CREATE BUILDINGS THAT PROVIDE HUMAN SCALE, INTEREST AND VARIATION IN THEIR OVERALL FORM.
- 3. USE ARCHITECTURAL STYLES AND MATERIALS THAT REFLECT THOSE FOUND IN REGIONAL ARCHITECTURE
- 4. PROVIDE HUMAN SCALE AND VISIBLE ACTIVITY WITHIN THOSE PORTIONS OF BUILDINGS THAT FACE STREETS.
- 5. PROVIDE MATERIALS OF QUALITY, DURABILITY, AND SCALE APPROPRIATE TO PEDESTRIAN ACTIVITY AND CONTACT IN AREAS WHERE THIS MAY OCCUR.
- 6. ENCOURAGE BUILDING FORMS AND ARCHITECTURE THAT WILL SERVE AS MODELS OF SUSTAINABILITY IN THE REGION.

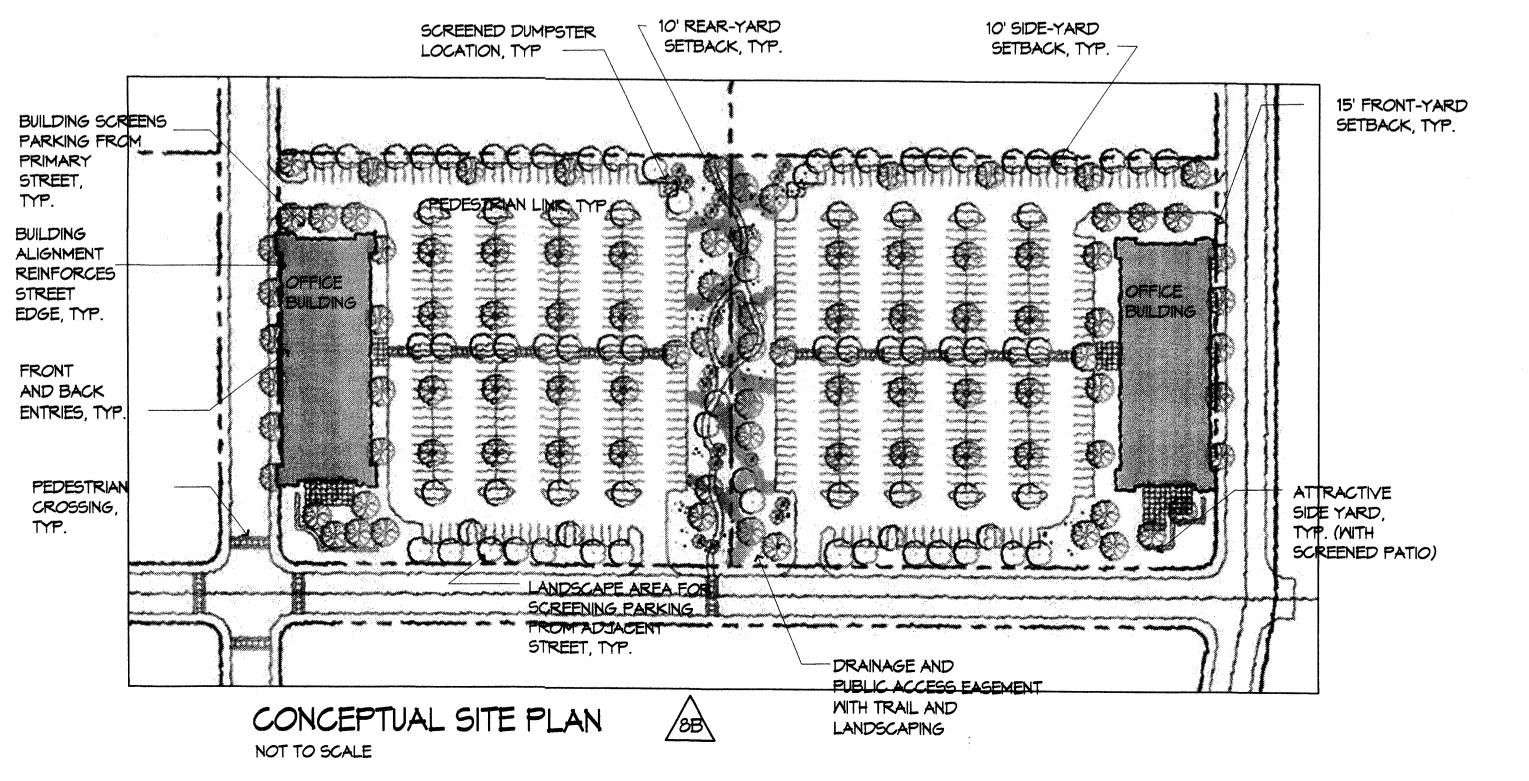



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REVISIONS

1 4-26-05 EPC SUBMITTAL REVISIONS EPC # 05EPC00576/00576 2 5-9-05 EPC SUBMITTAL REVISIONS 3 10-10-05 DRB SUBMITTAL

DRAWN BY SZ, MB REVIEWED BY OCTOBER 10, 2005 PROJECT NO.

DESIGN STANDARDS MASTER DEVELOPMENT PLAN

SHEET NO.

DRAWING NAME

DESIGN STANDARDS (CONT'D.)

ARCHITECTURE STANDARDS

1. ALL BUILDINGS SHALL MEET OR EXCEED THE CURRENT IP-ZONE REQUIREMENTS OF THE CITY OF ALBUQUERQUE ZONING CODE EXCEPT AS NOTED IN THIS DOCUMENT, AND CITY OF ALBUQUERQUE ZONING CODE SECTION 14-16-3-18 GENERAL BUILDING AND SITE DESIGN REGULATIONS FOR NON-RESIDENTIAL USES.

2. ALL BUILDINGS WILL BE REQUIRED TO MEET OR EXCEED ADDITIONAL DESIGN STANDARDS AS IDENTIFIED BY THE MESA DEL SOL EMPLOYMENT CENTER DESIGN REVIEW COMMITTEE.

3. BUILDINGS SHALL BE DESIGNED TO RELATE DIRECTLY TO AND REINFORCE THE PEDESTRIAN SCALE AND QUALITY OF STREET, CIVIC AND OPEN SPACES. THE FOLLOWING TECHNIQUES MAY BE USED TO MEET THIS OBJECTIVE: a. SHIFTS IN BUILDING MASSING, VARIATIONS IN HEIGHT, PROFILE AND ROOF FORM:

b. MINIMIZING LONG EXPANSES OF WALL AT A SINGLE HEIGHT OR PLANE.

4. BUILDINGS SHALL BE DESIGNED TO PROVIDE HUMAN SCALE, INTEREST AND VARIETY. THE FOLLOWING TECHNIQUES MAY BE USED TO MEET THIS OBJECTIVE: a. VARIATION IN BUILDING FORM, SUCH AS RECESSED OR PROJECTED BAYS; b. EXPRESSION OF ARCHITECTURAL OR STRUCTURAL MODULES OR DETAIL; C. DIVERSITY OF WINDOW SIZE, SHAPE OR PATTERNS THAT RELATE TO INTERIOR FUNCTIONS:

d. EMPHASIS ON BUILDING ENTRIES THROUGH PROJECTED OR RECESSED FORMS DETAIL, COLOR, OR MATERIALS;

e. VARIATION OF MATERIAL. MATERIAL MODULES, EXPRESSED JOINTS AND DETAILS, SURFACE RELIEF, COLOR AND TEXTURE TO BREAK UP LARGE BUILDING FORMS AND WALL SURFACES.

F. USE OF OPEN COURTYARD DESIGNS TO FORM TRANSITIONS BETWEEN PARKING AREAS AND BUILDINGS.

5. BUILDING FACADES FACING THE PRIMARY STREET SHALL EITHER INCLUDE THE PRIMARY ENTRY FACADE OR SHALL CONSIST OF COMPARABLE QUALITY IN TERMS OF ARCHITECTURE, MATERIALS AND DETAILING.

6. ROOFTOP MECHANICAL EQUIPMENT AND GROUND MOUNTED UTILITIES SHALL BE SCREENED FROM THE VIEW OF PUBLIC STREETS AND OPEN SPACE.

7. SCREENING ENCLOSURES SHALL BE INCORPORATED INTO BUILDING ARCHITECTURE AND UTILIZE THE SAME MATERIALS AS THE PRIMARY BUILDING TO THE GREATEST DEGREE PRACTICABLE.

8. BUILDING MATERIALS:

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a ALL PRIMARY BUILDINGS SHALL USE MATERIALS THAT ARE DURABLE ECONOMICALLY MAINTAINED, AND OF A QUALITY THAT WILL RETAIN THEIR APPEARANCE OVER TIME.

b. DURABLE, LONG-LASTING MATERIALS THAT ALSO PROVIDE SCALE AND DETAIL SHOULD ALWAYS BE INCORPORATED CLOSE TO PEDESTRIAN AREAS AND NEAR STREETS AND ENTRIES. MATERIAL QUALITY IS MOST IMPORTANT ON BUILDING FACADES FACING PUBLIC STREETS AND SPACES AND AT PRIMARY BUILDING ENTRIES.

C. BUILDING DESIGN, MATERIALS AND COLORS SHALL BE USED TOGETHER TO REFLECT THE UNIQUE CHARACTERISTICS OF ARCHITECTURAL STYLES PRESENT IN NEW MEXICO, MATERIALS MAY INCLUDE, BUT ARE NOT LIMITED TO, STUCCO, STONE, MASONRY, GLASS CURTAIN WALL, BRICK, METAL AND EIFS. d. SUSTAINABLE BUILDING DESIGN PRINCIPLES INCLUDING, BUT NOT LIMITED TO, ORIENTATION, MATERIALS, MECHANICAL SYSTEMS, ROOF SYSTEMS, GLAZING TYPE AND PERCENTAGES, AND SHADING TECHNIQUES, SHALL RESPOND TO ENVIRONMENTAL AND ECONOMIC FACTORS THAT IMPACT PROJECT SUSTAINABILITY.

e. LARGE WALLS OF GLASS SHOULD INCORPORATE A VARIETY OF MULLION PATTERNS, BAY DIMENSIONS, GLASS TYPES OR DETAILING TO PROVIDE HUMAN SCALE.

LANDSCAPE

1. ESTABLISH AN AESTHETIC THAT IS CONSIDERATE OF THE SITE'S EXISTING HIGH DESERT GRASSLAND CONTEXT AND COMPLEMENTARY TO THE ANTICIPATED EMPLOYMENT CENTER IMAGE.

2. PROMOTE QUALITY IN LANDSCAPE DESIGN, COMPATIBILITY BETWEEN LOTS. MITIGATION OF THE IMPACTS OF LARGE BUILDINGS AND PAVED AREAS. WATER CONSERVATION AND A WELL-MAINTAINED APPEARANCE.

3. CREATE OPEN SPACE SUITABLE FOR PASSIVE RECREATION.

4. PROVIDE TRANSITIONS BETWEEN DEVELOPED AND NATURAL AREAS, AND BUFFERS BETWEEN DIFFERENT USES.

STANDARDS

1. LANDSCAPE DESIGN:

a. LANDSCAPE DESIGN FOR INDIVIDUAL LOTS SHALL BE DEVELOPED ACCORDING TO A LANDSCAPE PLAN.

4 b. ALL LANDSCAPE PLANS SHALL COMPLY WITH THE CITY'S WATER CONSERVATION LANDSCAPING AND WATER WASTE ORDINANCE, POLLEN ORDINANCE AND CITY OF ALBUQUERQUE ZONING CODE SECTION 14-16-3-10 LANDSCAPING REGULATIONS APPLICABLE TO APARTMENT AND NONRESIDENTIAL DEVELOPMENT.

C. XERISCAPE PRINCIPLES SHALL BE APPLIED TO ALL LANDSCAPE DESIGNS INCLUDING THE USE OF DROUGHT TOLERANT PLANT MATERIALS, NATIVE PLANT SEED MIXES, SOIL AMENDMENTS, MULCHES AND WATER HARVESTING AREAS WHERE PRACTICAL.

d. ALONG ALL STREETS, CONTINUITY OF LANDSCAPE TREATMENT SHALL BE MAINTAINED TO THE GREATEST DEGREE POSSIBLE WITH ALLOWANCE MADE FOR REQUIRED ACCESS DRIVES.

e. LANDSCAPE AREAS SHALL BE CONTINUOUS FROM ONE LOT TO ANOTHER AND SHALL INCORPORATE LANDSCAPE MATERIALS THAT ARE COMPATIBLE WITH LANDSCAPING ON ADJACENT LOTS, PUBLIC STREETS, DRAINAGE CORRIDORS, AND LANDSCAPE EASEMENTS.

F. EARTH BERMS WITHIN ANY REQUIRED SETBACK AREA SHALL HAVE A MAXIMUM SLOPE OF 3:1 AND SHALL BE PLANTED WITH GROUND COVER TO PREVENT EROSION, OR SHALL USE EQUALLY EFFECTIVE MITIGATION MEASURES.

a. ALL PLANTING AREAS SHALL BE STABILIZED WITH EITHER MULCH, PLANTING SEEDING OR TURF.

h. LANDSCAPE BUFFERS SHALL BE PROVIDED BETWEEN THE SITE AND ADJACENT PROPERTIES AND STREETS. A MINIMUM BUFFER OF 6' SHALL BE USED ALONG SIDE AND REAR PROPERTY BOUNDARIES. A MINIMUM BUFFER OF 10' SHALL BE MAINTAINED BETWEEN PARKING AREAS AND THE STREET RIGHT-OF-WAY.

GRAVEL MULCH, COBBLE, AND SIMILAR MATERIALS ARE ACCEPTABLE AS A TOP DRESSING FOR LANDSCAPE AREAS. HOWEVER, THEY ARE NOT TO BE CONSIDERED A FOCAL LANDSCAPE ELEMENT.

I. WATER HARVESTING AND COLLECTION TECHNIQUES ARE ENCOURAGED. K. FUTURE DEVELOPMENT AREAS WITHIN THE SITE SHALL BE MAINTAINED IN THEIR NATURAL CONDITION. IF THESE AREAS ARE DISTURBED, THEY SHALL BE RE-VEGETATED WITH NATIVE SEED MIX APPROPRIATE FOR THIS REGION. I TREE PLANTING AND/OR THE USE OF HIGH ALBEDO PAVING SHALL BE UTILIZED TO REDUCE HEAT ABSORPTION IN DEVELOPED AREAS OF THE SITE.

2. STREET TREES:

a. STREET TREE PLANTINGS SHALL BE REQUIRED ALONG BOULEVARDS, CONNECTOR AND LOCAL STREETS.

b. STREET TREES IN THE RIGHT-OF-WAY SHALL BE CENTERED IN LANDSCAPE ZONES.

C. WHERE HIGH LEVELS OF PEDESTRIAN ACTIVITY ARE ANTICIPATED, PAVING AND TREES IN TREE GRATES MAY BE SUBSTITUTED FOR LARGER LANDSCAPE AREAS.

d. TREE GRATE AND TREE PLANTER AREAS MUST BE AT LEAST 36 SF. e. STREET TREES MAY INCLUDE NATIVE, NON-TRADITIONAL SPECIES.

F. STREET TREE SPECIES SHALL BE SELECTED TO MAXIMIZE THE COHESIVENESS OF EACH BLOCK OR SERIES OF BLOCKS, WITHOUT CREATING MONOCULTURES THAT MAY BE SUSCEPTIBLE TO DISEASE.

3. PLANT MATERIALS:

a. ALL PLANT MATERIALS SHALL MEET MINIMUM STANDARDS ESTABLISHED BY THE AMERICAN ASSOCIATION OF NURSERYMEN, OR IN THE CASE OF NATIVE PLANT MATERIALS, SHALL MEET REGIONAL STANDARDS FOR NURSERY STOCK AS ESTABLISHED BY A CONSENSUS OF LOCAL GROWERS. LA SEMILLA AND MESA DEL SOL REPRESENTATIVES. b. THE EXISTING SITE IS A HIGH DESERT GRASSLAND IN VARYING CONDITIONS OF DENSITY AND ESTABLISHMENT. THE SITE HAS STRONG VISUAL CONNECTIONS TO NEAR AND DISTANT MOUNTAINS AS WELL AS THE VALLEY. THE LANDSCAPE DESIGN WILL FEATURE NATIVE AND DROUGHT TOLERANT GRASSES TO REINFORCE THE SENSE OF PLACE AND REDUCE DEMANDS FOR SOIL AMENDMENT AND IRRIGATION.

C. ALL PLANT MATERIALS SHALL BE MAINTAINED BY THE OWNER IN A LIVING. ATTRACTIVE CONDITION.

e. SIGNIFICANT PLANT MATERIAL EXISTING ON THE SITE MAY BE SALVAGED FOR USE ELSEWHERE ON THE SITE.

4. IRRIGATION:

a. AN AUTOMATIC UNDERGROUND IRRIGATION SYSTEM IS REQUIRED TO SUPPORT SITE LANDSCAPING. THE SYSTEM SHALL BE DESIGNED TO AVOID OVER-SPRAYING ONTO WALKS, BUILDINGS, FENCES, ETC. b. THE IRRIGATION SYSTEM SHALL BE DESIGNED TO ACCOMMODATE NON-POTABLE WATER.

5. INSTALLATION SIZES/MINIMUM PLANTING SIZES: PLANTING SIZES WILL VARY BY GENUS AND SPECIES AND AVAILABILITY. IN GENERAL, THE PLANT SIZES WILL BE LARGER IN HIGH VISIBILITY AREAS, WHERE THE SPECIFIED PLANTS ARE AVAILABLE AND WILL DO BETTER WHEN PLANTED IN LARGER SIZES. SMALLER PLANTING SIZES WILL BE USE FOR QUICK GROWING, ADAPTABLE PLANT MATERIAL

6. PLANT PALETTE:

a. PROVIDES OPPORTUNITIES FOR CREATIVITY, WITH A NON-TRADITIONAL NATIVE HIGH DESERT PLANT PALETTE. b. PLANT MATERIAL MARKED BY AN ASTERISK IS NATIVE TO THE SITE. BUT MAY NOT CURRENTLY BE ALLOWED TO BE PLANTED, WHEN/IF NATIVE JUNIPERS ARE ALLOWED TO BE PLANTED. WE WOULD ENCOURAGE THEIR USE AT MESA DEL SOL. C. LIST OF APPROVED PLANTS:

ASH (MODESTO), FRAXINUS VELUTINA "MODESTO HASTE TREE. VITEX AGNUS-CASTUS HITALPA CHITALPA TASHKENTENSI TTONWOOD SPECIES, POPULUS SI LDER SPECIES, SAMBUCUS SP. OLDENRAIN TREE, KOELREJTERIA PANICULATA JUNIPER SPECIES, JUNIPERUS, SF OCUST SPECIES, ROBINIA SP. NEM MEXICO OLIVE, FORESTIERA NEOMEXICAN MESQUITE SPECIES, PROSOPIS, SP. PINON PINUS EDULIS REDBUD SPECIES, CERCIS SP. SWEETGUM, LIQUIDAMBER STYRACIFLUA

OTONEASTER VAR., COTONEASTER VAR BLUE MIST SHRUB, CARYOPTERIS CLANDONENS ROOM SPECIES, CYTISUS SP., GENISTA SP., BACCHARIS BUTTERFLY BUSH VAR. BUDDLEIA VAR UNIPER SPECIES JUNIPERUS SP. MUGO PINE PINUS MUGO MUGO SALTBUSH VAR., ATRIPLEX VAR. SAGE VAR ARTEMESIA VAR ROSE PARY (SEMI-PROSTRATE), ROSEMARINUS HOMPSON BROOM BACCHARIS "STARN" "THOMPSON TURPENTINE BUSH, ERICAMERIA LARCIFOLIA

ACCENTS AND ORNAMENTAL GRASSES: AGAVE SPECIES, AGAVE SP. BLUESTEM SPECIES, ANDROPOGON SI DEER FRAGS, MUHLENBERGIA RIGENS ESERT SPOON, SOTOL ESCUE SPECIES, FESTUCA SP. SALLETA GRASS, GALLETA SP NDIANGRASS ORYZOPSIS SP DIAN RICEGRASS, SORGHASTRUM SE ECHUGUILLA, AGAVE LECHUGUILLA RED YUCCA, HESPERALOE PARVIFLORA MUHLENBERGIA SPECIES, MUHLENBERGIA S SACATON SPECIES, SPOROBOLUS SP. THERGRASS, NASELLA TENUISSIMA, STIPA SP.

BERMUDA GRASS BLEND, CYNODON DACTYLON BLUE GRAMA GRASS, BOUTELOUA GRACILIS "HACHITA BUFFALO GRASS, BUCHELOE DACTYLOIDES "LEGACY GALLETA GRASS (VIVA), HILARIA JAMESII "VIVA"

PLANTS OF THE SOUTHWEST: DRYLAND BLEND, SAND SOIL STABILIZER, HIGH DESERT WILDFLOWER MIX CURTIS AND CURTIS: PIONEER'S PRIDE OR OMESTEADER'S CHOICE NATIVE GRASS SEED BLENDS ANO ESTACADO OR SHOWY PLAINS AND JUNIPER ILLS WILDFLOWER MIXES.

LIGHTING

INTENT

1. CREATE A WELL BALANCED, INTEGRATED LIGHTING PLAN FOR PUBLIC AND PRIVATE PROPERTIES THAT ENHANCES VEHICULAR AND PEDESTRIAN VISIBILITY WHILE MINIMIZING LIGHTING GLARE AND CONTRAST.

2. CREATE A CONSISTENT LIGHTING THEME THAT EMPHASIZES PUBLIC AND PRIVATE FEATURES AND DESTINATIONS BY USING A MINIMUM AMOUNT OF LIGHT TO MEET THESE OBJECTIVES.

STANDARDS

1. ALL FIXTURES AND DESIGN SHALL COMPLY WITH THE NEW MEXICO NIGHT SKY PROTECTION ACT AND CITY OF ALBUQUERQUE ZONING CODE. SECTION 14-16-3-9 AREA LIGHTING REGULATIONS.

2. ALL LIGHT FIXTURES INCLUDING STREETLIGHTS, PARKING AREA WALKWAY AND ENTRY FIXTURES SHALL NOT EXCEED A MAXIMUM HEIGHT OF 30 FEET, AND ALL STREET, PATH, PARKING AREA AND PEDESTRIAN LIGHT FIXTURES SHALL BE OF UNIFORM DESIGN.

3. LIGHTING WITHIN THE PUBLIC RIGHT-OF-WAY SHALL BE SUBJECT TO THE STANDARDS AND REVIEW OF PNM. UNLESS MAINTENANCE FOR RIGHT-OF-WAY LIGHTING IS THE FULL RESPONSIBILITY OF OTHER

4. LIGHTING DESIGN FOR PEDESTRIAN AREAS SHALL MINIMIZE HOT SPOTS, DARK SPOTS AND GLARE, AND INCLUDE VISIBLE LIGHT SOURCES THAT CLEARLY INDICATE THE PATH OF TRAVEL AHEAD.

5. LIGHTING DESIGN FOR PARKING AREAS SHALL BE LIGHTED TO PROVIDE FUNCTIONAL, ATTRACTIVE, AND UNIFIED LIGHTING THROUGHOUT THE LOT, AND BE EXTINGUISHED ONE HOUR AFTER THE CLOSE OF BUSINESS, EXCEPT AS NEEDED TO PROVIDE FOR MINIMUM SECURITY LEVELS.

6. ACCENT LIGHTING SHALL BE IN CHARACTER WITH THE ARCHITECTURAL AND LANDSCAPE DESIGN CHARACTER OF THE DEVELOPMENT.

7. SECURITY AND SERVICE AREA LIGHTING SHALL BE CONFINED WITHIN THE SERVICE AREA BOUNDARY AND ENCLOSURE WALLS. NO SPILLOVER SHALL OCCUR OUTSIDE THE SERVICE OR STORAGE AREA, AND THE LIGHTING SOURCE SHALL NOT BE VISIBLE FROM THE STREET OR COMMON AREA OPEN SPACE. LIGHTS AT SERVICE OR EXIST DOORS SHALL BE LIMITED TO LOW WATTAGE DOWNCAST OR LOW CUT-OFF FIXTURES THAT MAY REMAIN ON THROUGHOUT THE NIGHT.

SIGNAGE

INTENT

1. CREATE A CONSISTENT SIGNAGE THEME THAT REINFORCES THE PROJECT IDENTITY, AND IS AN EFFECTIVE WAYFINDING TOOL.

2. CREATE A SEAMLESS FRAMEWORK FOR BOTH DIRECTIONAL AND PROMOTIONAL SIGNAGE THAT ESTABLISHES A CONSISTENT LEVEL OF QUALITY, VISUAL INTEREST AND CONTINUITY FOR THE PROJECT.

STANDARDS

1. SIGNAGE DESIGN AND PLACEMENT SHALL CONFORM TO THE REQUIREMENTS OF THE CITY OF ALBUQUERQUE'S IP INDUSTRIAL PARK

2. SIGNAGE IS TO BE OF SIMPLE, CLEAN DESIGN AND CONSTRUCTED OF DURABLE MATERIALS WHICH ARE CONSISTENT AND COMPATIBLE WITH THE BUILDING ARCHITECTURE

3. PROPOSED PLANS FOR SIGNAGE, TEMPORARY AND PERMANENT, INCLUDING DETAILS OF DESIGN MATERIALS, LETTERING, LOCATION. MOUNTING SIZE, COLOR AND LIGHTING, ARE TO BE SUBMITTED TO THE DRC FOR APPROVAL.

4. MONUMENT SIGNS SHALL NOT EXCEED 20 FEET IN HEIGHT AND MAY BE A MAXIMUM OF 300 SQUARE FEET IN SIGN FACE.

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ARCHITECT

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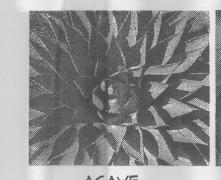
REVISIONS

1 4-26-05 EPC SUBMITTAL REVISIONS 2 5-9-05 EPC SUBMITTAL REVISIONS 3 10-10-05 DRB SUBMITTAL

DRAWN BY MB REVIEWED BY OCTOBER 10, 2005 PROJECT NO. 03069 DRAWING NAME


DESIGN STANDARDS -MASTER DEVELOPMENT PLAN

SHEET NO.





STIPA

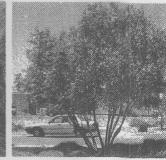

CHILOPSIS












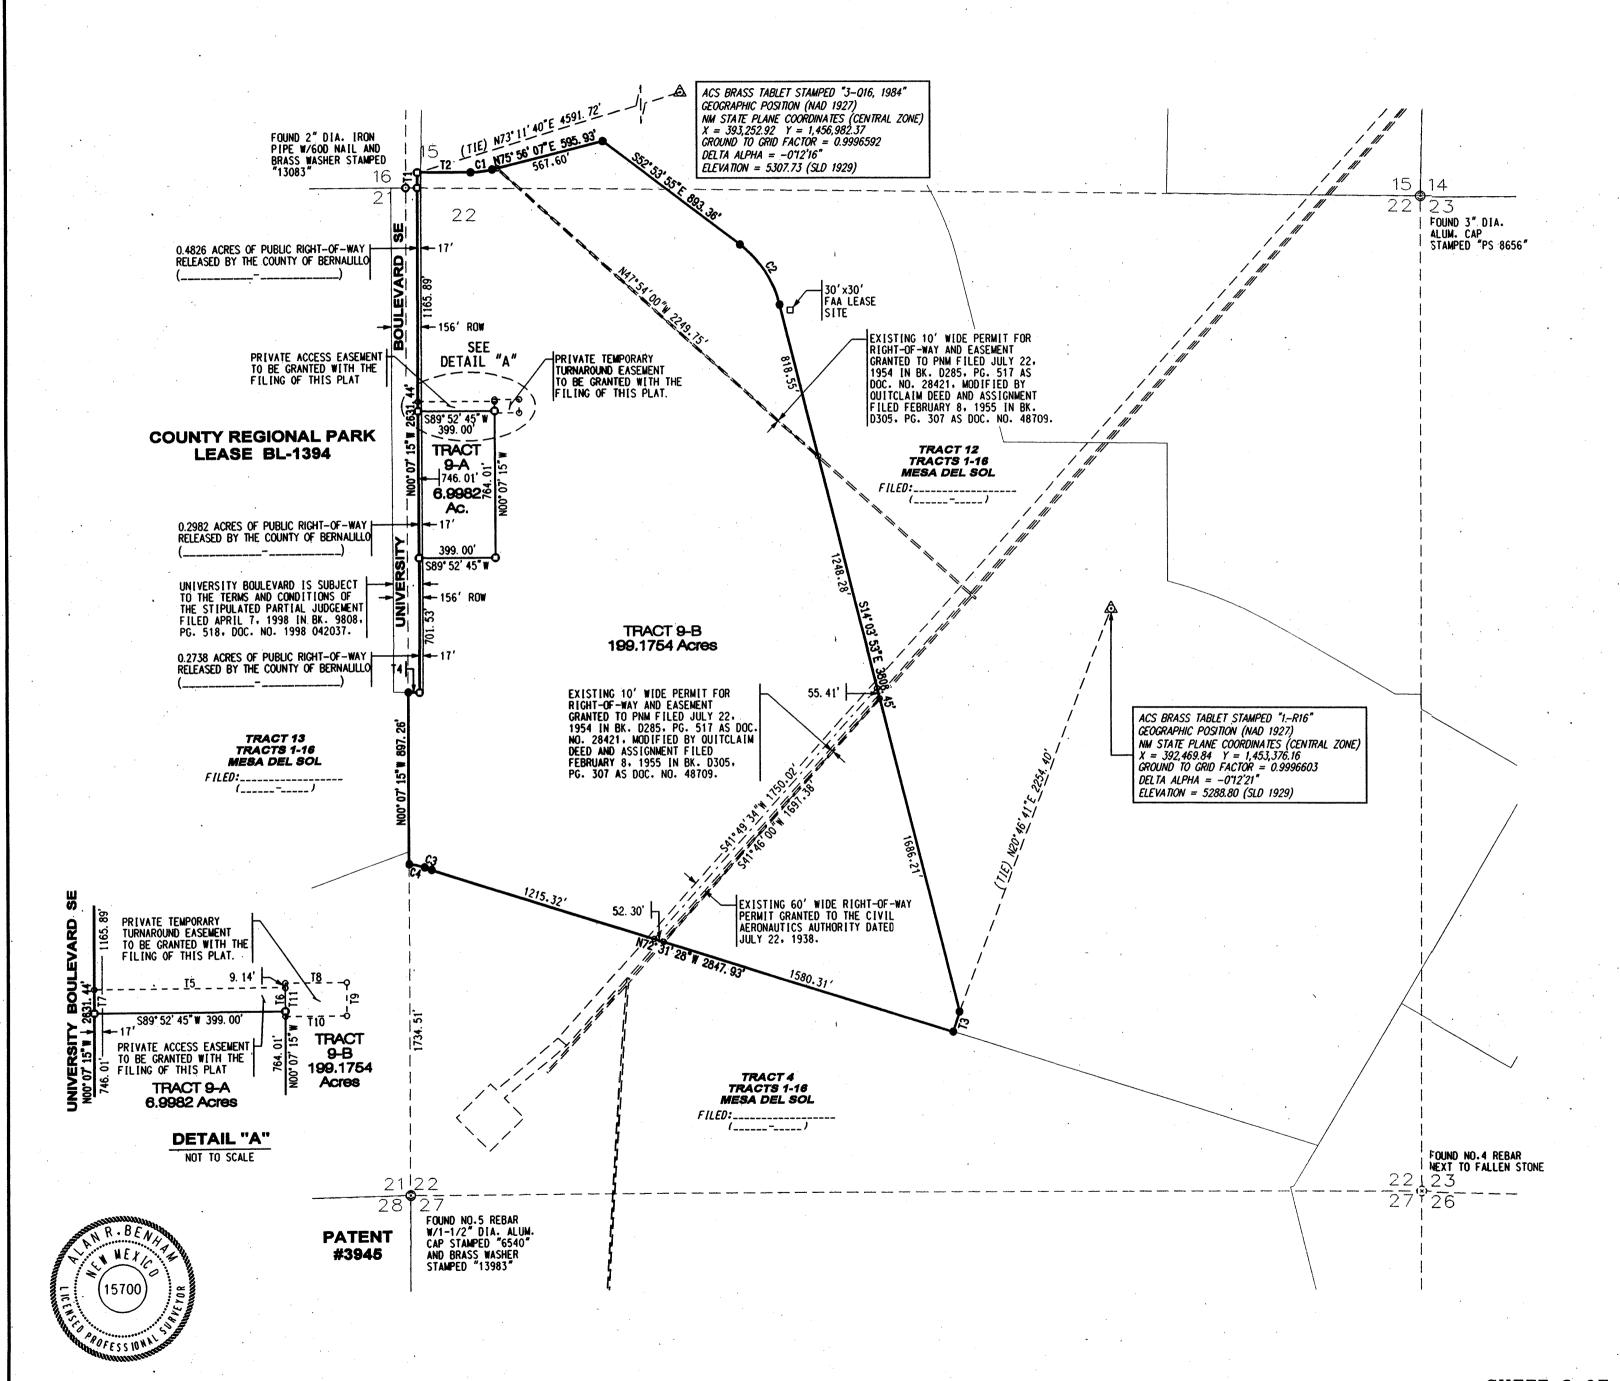


PLAT OF

TRACTS 9-A & 9-B MESA DEL SOL

(A REPLAT OF TRACT 9, MESA DEL SOL)

SECTIONS 15 & 22 TOWNSHIP 9 NORTH, RANGE 3 EAST, N.M.P.M. ALBUQUERQUE, BERNALILLO COUNTY, NEW MEXICO OCTOBER, 2005

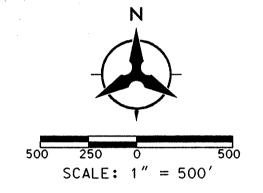

-1				Curve Do	oto		
	ID	DELTA	TANGENT	ARC	RADIUS	CHORD.	CHORD BRG
	C1	14*02'09"	57. 12'	113. 67'	464. 00'	113. 38'	N82*57' 11"E
	C2	38* 50' 02"	199. 16'	382. 95'	565. 00'	375. 66'	S33* 28' 54"E
	C3	03" 21' 02"	19. 16'	38. 30'	655. 00'	38. 30'	N70° 50' 56" W
- [C4	18* 29' 17"	42. 15'	83. 57'	259. 00'	83. 21'	N78° 25' 04" W

		Tangen	t Data		
ID	BEARING	DISTANCE	ID	BEARING	DISTANCE
T1	N00° 59' 25" E	79. 59'	T7	N00° 07' 15" W	50. 00'
T2	N89° 58′ 16" E	276. 65'	T8	N90°00' 00"E	128. 75'
T3	S17* 28' 32" W	110. 00'	Т9	S00° 00' 00" E	70. 00'
T4	S89° 47' 27" E	61. 00'	T10	N90°00'00"W	128. 61'
T5	N89* 52' 44" E	399. 00'	T11	N00° 07' 15" W	70. 00'
T6	S00° 07′ 15″ E	50. 00'			

L	EGEND
	BOUNDARY LINE
	TRACT LINE
	EXISTING EASEMENT LINE
	ADJOINING PROPERTY LINE
The second product amount to the second second	SECTION LINE
0	FOUND IRON PIPE AS NOTED
(∑)	FOUND REBAR AS NOTED
	FOUND CAPPED REBAR AS NOTED
•	SET 5/8" REBAR W/ORANGE PLASTIC CAP STAMPED "BENHAM LS 15700"
•	FOUND 5/8" REBAR W/ORANGE PLASTIC CAP STAMPED "BENHAM LS 15700"

Bohannan 🔺 Huston 🗷

Courtyard I 7500 Jefferson St. NE Albuquerque, NM 87109-4335 ENGINEERING - SPATIAL DATA - ADVANCED TECHNOLOGIES

SHEET 2 OF 2

SP-2005430559 KIRTLAND AIR MESA COUNTY REGIONAL FORCE DEL BASE

LOCATION MAP

ISLETA PUEBLO GRANT

ZONE ATLAS INDEX MAPS Q-16, R-15, R-16 & S-16 NOT TO SCALE

NOTES

- 1. Bearings shown hereon are New Mexico State Plane Grid Bearings (Central Zone,
- Distances are ground distances.
- Project Ground to Grid Factor = 0.999656215 The Gross Area of this Tract is 206.1736 Acres.
- 5. The location of pipeline, powerline, and communication line easements and/or right-of-ways shown hereon were plotted from the granting documents in conjunction with field ties of existing infrastructure.
- 6. All easements as may be shown hereon were provided by Fidelity National Title. Commitment No. 03-1033983-B-RAD Schedule B II or were provided by the State Land Office as unrecorded documents. Dated: July 17, 2003.

DISCLOSURE STATEMENT

The purpose of this plat is to subdivide Tract 9 of the PLAT OF TRACTS 1-16. MESA DEL SOL, Albuquerque, New Mexico, as the same is shown and designated on the plat thereof, recorded in the office of the County Clerk of Bernalillo County. New Mexico on .___ in Book _____, Page ____ as Document No. ____

PUBLIC UTILITY EASEMENTS

PUBLIC UTILITY EASEMENTS shown on this plat are for the common joint use of:

- A. PNM Electric Services for the installation, maintenance and service fixtures, structures, and related facilities reasonably necessary to
- B. PNM Gas services for installation, maintenance, and service of natural gas lines, valves and other equipment and facilities reasonably necessary to provide natural gas.
- C. OWEST for the installation, maintenance, and service of all buried communication lines and other related equipment and facilities reasonably necessary to provide communication services, including but not limited to above ground pedestals and closures.
- D. Comcast Cable for the installation, maintenance, and service of such lines, cable, and other related equipment and facilities reasonably necessary to provide Cable TV service.

Included is the right to build, rebuild, construct, reconstruct, locate, relocate, change, remove, modify, renew, operate, and maintain facilities for the purposes described above, together with free access to, from, and over said easements, including sufficient working area space for electric transformers, with the right and privilege to trim and remove trees, shrubs or bushes which interfere with the purposes set forth herein. No building, sign, pool, (above ground or subsurface), hot tub, concrete or wood pool decking, or other structure shall be erected or constructed on said easements, nor shall any well be drilled or operated thereon. Property owners shall be solely responsible for correcting any violations of National Electric Safety Code caused by construction of pools, decking, or any structures adjacent to or near easements shown on this plat.

Easements for electric transformers/switchgears, as installed shall extend ten feet (10') in front of transformer/switchgear doors and five feet (5') on each

DESCRIPTION

A certain tract of land being a portion of Sections 15 and 22, Township 9 North, Range 3 East, New Mexico Principal Meridian, Bernalillo County, New Mexico, being and comprising all of TRACT 9 of BULK LAND PLAT OF MESA DEL SOL, TRACTS 1-16. Albuquerque, New Mexico as the same is shown and designated on the plat thereof. recorded in the office of the County Clerk of Bernalillo County, New Mexico on

in Book _____ as Document No. ___ and being more particularly described by New Mexico State Plane Grid Bearings (Central Zone, NAD 83) and ground distances as follows:

BEGINNING at the northwest corner of the tract herein described, whence the City of Albuquerque survey monument "3-Q16, 1984", having New Mexico State Plane Grid coordinates for the Central Zone; X=393,252.92, Y=1,456,982.37, bears N73°11'40"E a distance of 4591.72 feet; thence along the north boundary line of the tract herein M89*58'16"E a distance of 276.65 feet to a point of curvature; thence,

113.67 feet along the arc of a tangent curve to the left having a radius of 464.00 feet with an interior angle of 14°02'09" and a chord bearing N82°57'11"E a distance of 113.38 feet to a point of tangency; thence. N75°56'07"E a distance of 595.93 feet to the northeast corner of the tract herein

described; thence along the east boundary line of the tract herein described, S52°53′55″E a distance of 893.36 feet to a point of curvature; thence,

382.95 feet along the arc of a tangent curve to the right having a radius of 565.00 feet with an interior angle of 38°50′02″ and a chord bearing S33°28′54″E a distance of 375.66 feet to a point of tangency; thence, S14°03′53″E a distance of 3808.45 feet; thence, \$17.28'32"W a distance of 110.00 feet to the southeast corner of the tract herein

described; thence along the south boundary line of the tract herein described, N72°31'28"W a distance of 2847.93 feet to a point of curvature; thence. 38.30 feet along the arc of a tangent curve to the left having a radius of 655.00 feet with an interior angle of 03°21'02" and a chord bearing N70°50'56"W a distance

of 38.30 feet to a point of compound curvature; thence.
83.57 feet along the arc of a tangent curve to the left having a radius of 259.00 feet with an interior angle of 18°29'17" and a chord bearing N78°25'04"W a distance of 83.21 feet to a point of non-tangency on the west boundary line of said Section 22. said point also being the southwest corner of the tract herein described; thence along the west boundary line of Section 22 and also the west boundary line of the tract herein described.

NOO°07'15"W a distance of 897.26 feet to a point on the southerly right-of-way line University Boulevard SE; thence along the southerly right-of-way line of said University Boulevard SE.

E a distance of 61.00 feet; thence. NOO°07'15"W a distance of 2631.45 feet to a point on the northerly boundary line of said Section 22: thence. NOO°59'25"E a distance of 79.59 feet to the point and place of beginning.

Said tract contains 206.1736 acres, more or less.

FREE CONSENT AND DEDICATION

The foregoing plat of land hereon described is with the free consent and in accordance with the desires of the undersigned owner(s) and/or proprietor(s) thereof. Said owner(s) and/or proprietor(s) do hereby consent to all of the foregoing and do hereby certify that this Plat is their free act and deed and said owner(s) and/or proprietor(s) do hereby dedicate all streets and and said owner(s) and/or proprietor(s) do hereby dedicate all streets and public rights-of-way as may be shown hereon to the City of Albuquerque in Fee Simple with warranty covenants and do hereby grant: Any access. Utility, and Drainage Easements as may be shown hereon, inspection, and maintenance of facilities therein; and any Public Utility easements as may be shown hereon for the common and joint use of Gas. Electrical Power and Communication Services for buried and/or overhead distribution lines, conduits, pines for underground and/or overhead Utilities as may be shown or conduits, pipes for underground and/or overhead Utilities as may be shown or indicated, and including the right of ingress and egress for construction and maintenance, and the right to trim interfering trees and shrubs. The city has the right to enter upon the Grantees Property at any time and perform whatever inspection, installation, maintenance, and iffication maintenance. perform whatever inspection. installation. maintenance. repair. modification or removal ("Work") it deems appropriate without liability to the City. If work effects any Improvements or Encroachments made by the Grantee, the City will not be financially or otherwise responsible for rebuilding or repairing of Improvements or Encroachments. If in the opinion of the City, the work to be performed by the City could endanger the structural integrity or otherwise damage the Improvements or Encroachments, the Grantee shall, at its own expense, take whatever protective measures are required to safeguard the Improvements or Encroachments. Said owner(s) and/or proprietor(s) do hereby consent to all of the foregoing and do hereby certify that this subdivision is with their free act and deed.

REGENTS OF THE UNIVERSITY OF NEW MEXICO.
A CONSTITUTION OF THE STATE OF NEW MEXICO

By:
Dovid M. Harris
Executive Vice President for Administrative of New Mexico

University of New Mexico

OFFICIAL SEAL Karen W. Vickers STATE OF NEW MEXICO

My Commission Expires: 2-25-08

State of New Mexico)

County of Bernalillo)

This instrument was acknowledged before me on 215T day of New Extensions by David W. Harris, Executive Vice President for Administration, University

My Commission Expires: 2-25-08

COMMISSIONER OF PUBLIC LANDS. OF THE STATE OF NEW MEXICO. Trustee for the Enabling Act Trust. Act of June 29. 1910.

SHEET 1 OF 2

SURVEYOR'S CERTIFICATION



I. Alan R. Benham, a registered Professional New Mexico Surveyor, certify that I am responsible for this survey and that this plat was prepared by me or under supervision, and conforms to the Minimum Requirements of the Board of Registration for Professional Engineers and Professional Surveyors in October. 2000 and meets the minimum requirements for monumentation and surveys contained in the Albuquerque subdivision ordinance, and is true and accurate to the best of my knowledge and belief.

Bohannan-Huston, Inc. Courtyard I 7500 Jefferson Street, N.E. Albuquerque. New Mexico 87109 (505)823-1000

New Mexico Professional Surveyor 15700 Date: 11-30-05

PLAT OF

TRACTS 9-A & 9-B MESA DEL SOL

(A REPLAT OF TRACT 9, MESA DEL SOL)

SECTIONS 15 & 22 TOWNSHIP 9 NORTH, RANGE 3 EAST, N.M.P.M. ALBUQUERQUE, BERNALILLO COUNTY, NEW MEXICO OCTOBER, 2005

PROJECT NUMBER	
APPLICATION NUMBER	
PLAT APPROV	/AL
UTILITY APPROVALS:	
OWEST	DATE
COMCAST CABLE	DATE
PNM ELECTRIC SERVICES	DATE
PNM GAS SERVICES	DATE
CITY APPROVALS: 01 12-14-1	100 1 200
CITY SURVEYOR	12-1-05 DATE
TRAFFIC ENGINEERING, TRANSPORTATION DIVISION	DATE
UTILITIES DEVELOPMENT	DATE
PARKS & RECREATION DEPARTMENT	DATE
A.M.A.F.C.A.	DATE
CITY ENGINEER	DATE
DRB CHAIRPERSON, PLANNING DEPARTMENT	DATE
REAL PROPERTY DIVISION	DATE
COUNTY OF BERNALLLIO	DATE


In approving this plat, PNM Electric Services and Gas Services (PNM) did not conduct a Title Search of the properties shown hereon. Consequently, PNM does not waive nor release any easement or easement rights to which it may be entitled.


TAX CERTIFICATION

THIS IS TO CERTIFY THAT TAXES ARE CURRENT A	AND PAID ON UPC #
PROPERTY OWNER OF RECORD	
BERNALILLO COUNTY TREASURER'S OFFICE	DATE

Bohannan 🔺 Huston 🗷

Courtyard I 7500 Jefferson St. NE Albuquerque, NM 87109-4335 ENGINEERING A SPATIAL DATA A ADVANCED TECHNOLOGIES

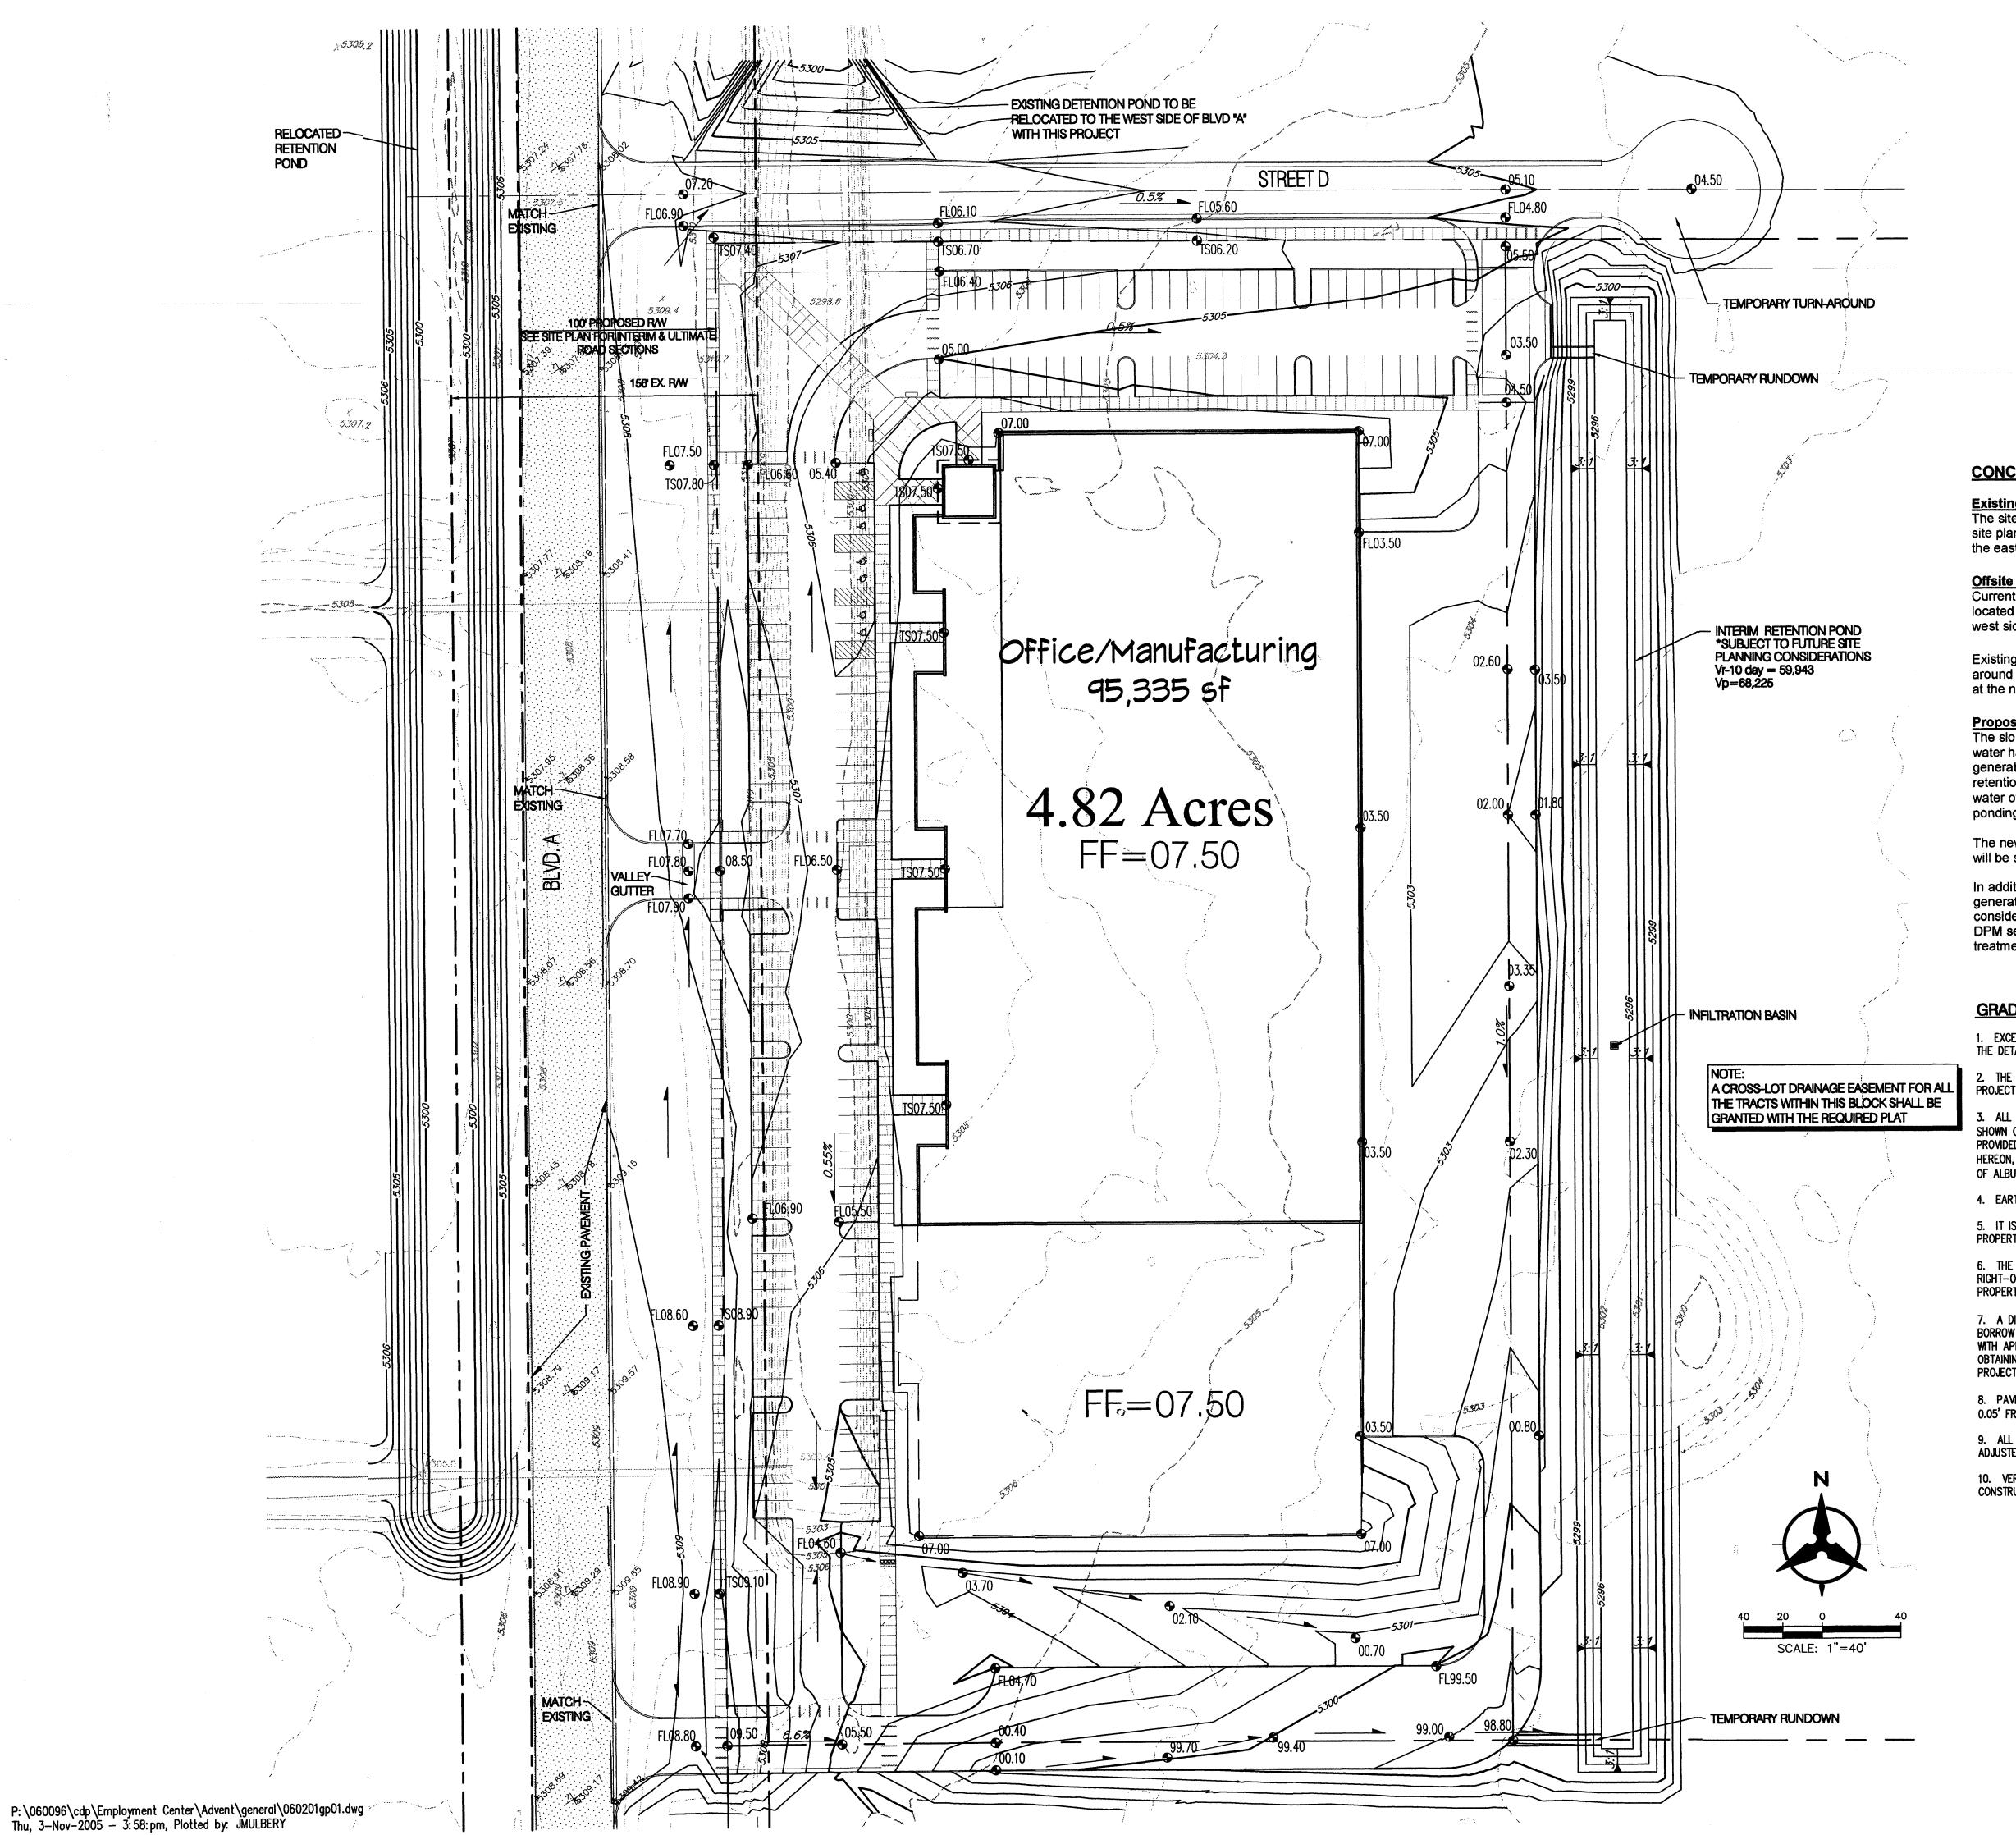

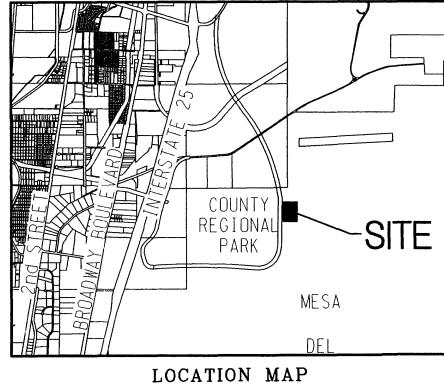

ZONE ATLAS INDEX MAP R-16 NOT TO SCALE

PROPOSED LEGAL DESCRIPTION

TRACT 9-A AS SHOWN ON THE PLAT OF TRACTS 9-A AND 9-B OF MESA DEL SOL

CONCEPTUAL DRAINAGE MANAGEMENT PLAN

The site currently is undeveloped and slopes 0.5% to 1.0% from the west to east. The new site plan will be bound by public streets on the north and west, and undeveloped land on the east and south.

Offsite Drainage

Current drainage from the Journal Pavilion parking area, west of the site, drains into ponds located at the western portion of the proposed site. These ponds will be relocated to the west side of the road, out of the new development.

Existing offsite drainage onto the site from the northwest comer will be diverted north around the site via the proposed road. This small historic flow will outfall to existing grade at the northeast corner of the site.

Proposed Site Grading

The slope of the site under proposed conditions is similar to existing conditions. Additional water harvesting areas and retention ponds will be added onsite to accept all flows generated throughout the development. In addition infiltration basins will be installed in the retention ponds to manage nuisance flows and provide a positive discharge of ponded water over time. However, the infiltration does not reduce the 100 year, 10 day stored ponding volume requirements.

The new public streets will drain to water harvesting areas located in adjacent tracts which will be sized to fully retain the 100 year, 10 day storm event.

In addition, the tract will have a retention pond sized to accept the 100 year, 10 day storm generated by the site. This is an interim pond and shall be subject to future site planning considerations. The pond was sized in accordance with the methodology outlined in the DPM section 22.2. Developed land treatments for these sites were assumed to be 90% treatment D and 10% treatment B.

GRADING NOTES

1. EXCEPT AS PROVIDED HEREIN, GRADING SHALL BE PERFORMED AT THE ELEVATIONS AND IN ACCORDANCE WITH THE DETAILS SHOWN ON THIS PLAN.

2. THE COST FOR REQUIRED CONSTRUCTION DUST AND EROSION CONTROL MEASURES SHALL BE INCIDENTAL TO THE

3. ALL WORK RELATIVE TO FOUNDATION CONSTRUCTION, SITE PREPARATION, AND PAVEMENT INSTALLATION, AS SHOWN ON THIS PLAN, SHALL BE CONSTRUCTED IN ACCORDANCE WITH THE "GEOTECHNICAL INVESTIGATION," AS PROVIDED BY THE ARCHITECT OR OWNER. ALL OTHER WORK SHALL, UNLESS OTHERWISE STATED OR PROVIDED FOR HEREON, BE CONSTRUCTED IN ACCORDANCE WITH THE PROJECT, (FIRST PRIORITY) SPECIFICATIONS, AND/OR THE CITY OF ALBUQUERQUE (COA) STANDARD SPECIFICATIONS FOR PUBLIC WORKS (SECOND PRIORITY).

4. EARTH SLOPES SHALL NOT EXCEED 3 HORIZONTAL TO 1 VERTICAL UNLESS SHOWN OTHERWISE.

5. IT IS THE INTENT OF THESE PLANS THAT THIS CONTRACTOR SHALL NOT PERFORM ANY WORK OUTSIDE OF THE PROPERTY BOUNDARIES EXCEPT AS REQUIRED BY THIS PLAN.


6. THE CONTRACTOR IS TO ENSURE THAT NO SOIL ERODES FROM THE SITE ONTO ADJACENT PROPERTY OR PUBLIC RIGHT-OF-WAY. THIS SHOULD BE ACHIEVED BY CONSTRUCTING TEMPORARY BERMS OR SILT FENCE AT THE PROPERTY LINES AND WETTING THE SOIL TO PROTECT IT FROM WIND EROSION.

7. A DISPOSAL SITE FOR ANY & ALL EXCESS EXCAVATION MATERIAL, AND UNSUITABLE MATERIAL AND/OR A BORROW SITE CONTAINING ACCEPTABLE FILL MATERIAL SHALL BE OBTAINED BY THE CONTRACTOR IN COMPLIANCE WITH APPLICABLE ENVIRONMENTAL REGULATIONS AND APPROVED BY THE OBSERVER. ALL COSTS INCURRED IN OBTAINING A DISPOSAL OR BORROW SITE AND HAUL TO OR FROM SHALL BE CONSIDERED INCIDENTAL TO THE PROJECT AND NO SEPARATE MEASUREMENT OR PAYMENT SHALL BE MADE.


8. PAVING AND ROADWAY GRADES SHALL BE +/- 0.1' FROM PLAN ELEVATIONS. PAD ELEVATION SHALL BE +/-0.05' FROM BUILDING PLAN ELEVATION.

9. ALL PROPOSED CONTOURS REFLECT TOP OF PAVEMENT ELEVATIONS IN THE PARKING AREA AND MUST BE ADJUSTED FOR MEDIANS AND ISLANDS.

10. VERIFY ALL ELEVATIONS SHOWN ON PLAN FROM BASIS OF ELEVATION CONTROL STATION PRIOR TO BEGINNING

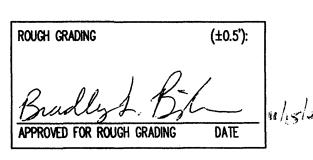

FOR ROUGH GRADING AND FOUNDATION PERMIT ONLY

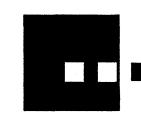

architecture interiors planning engineering

6801 Jefferson NE Suite 100 Albuquerque, NM 87109 505 761-9700 fax 761-4222 dps Odpsabq.com

DRB SUBMITTAL



PROJECT

Phase exico ibuquerque, BUILDI /ment 0 Emple

REVISIONS

DRAWN BY REVIEWED BY


DATE NOVEMBER 3, 2005 PROJECT NO.

DRAWING NAME CONCEPTUAL/

ROUGH GRADING PLAN

03069

SHEET NO. C100

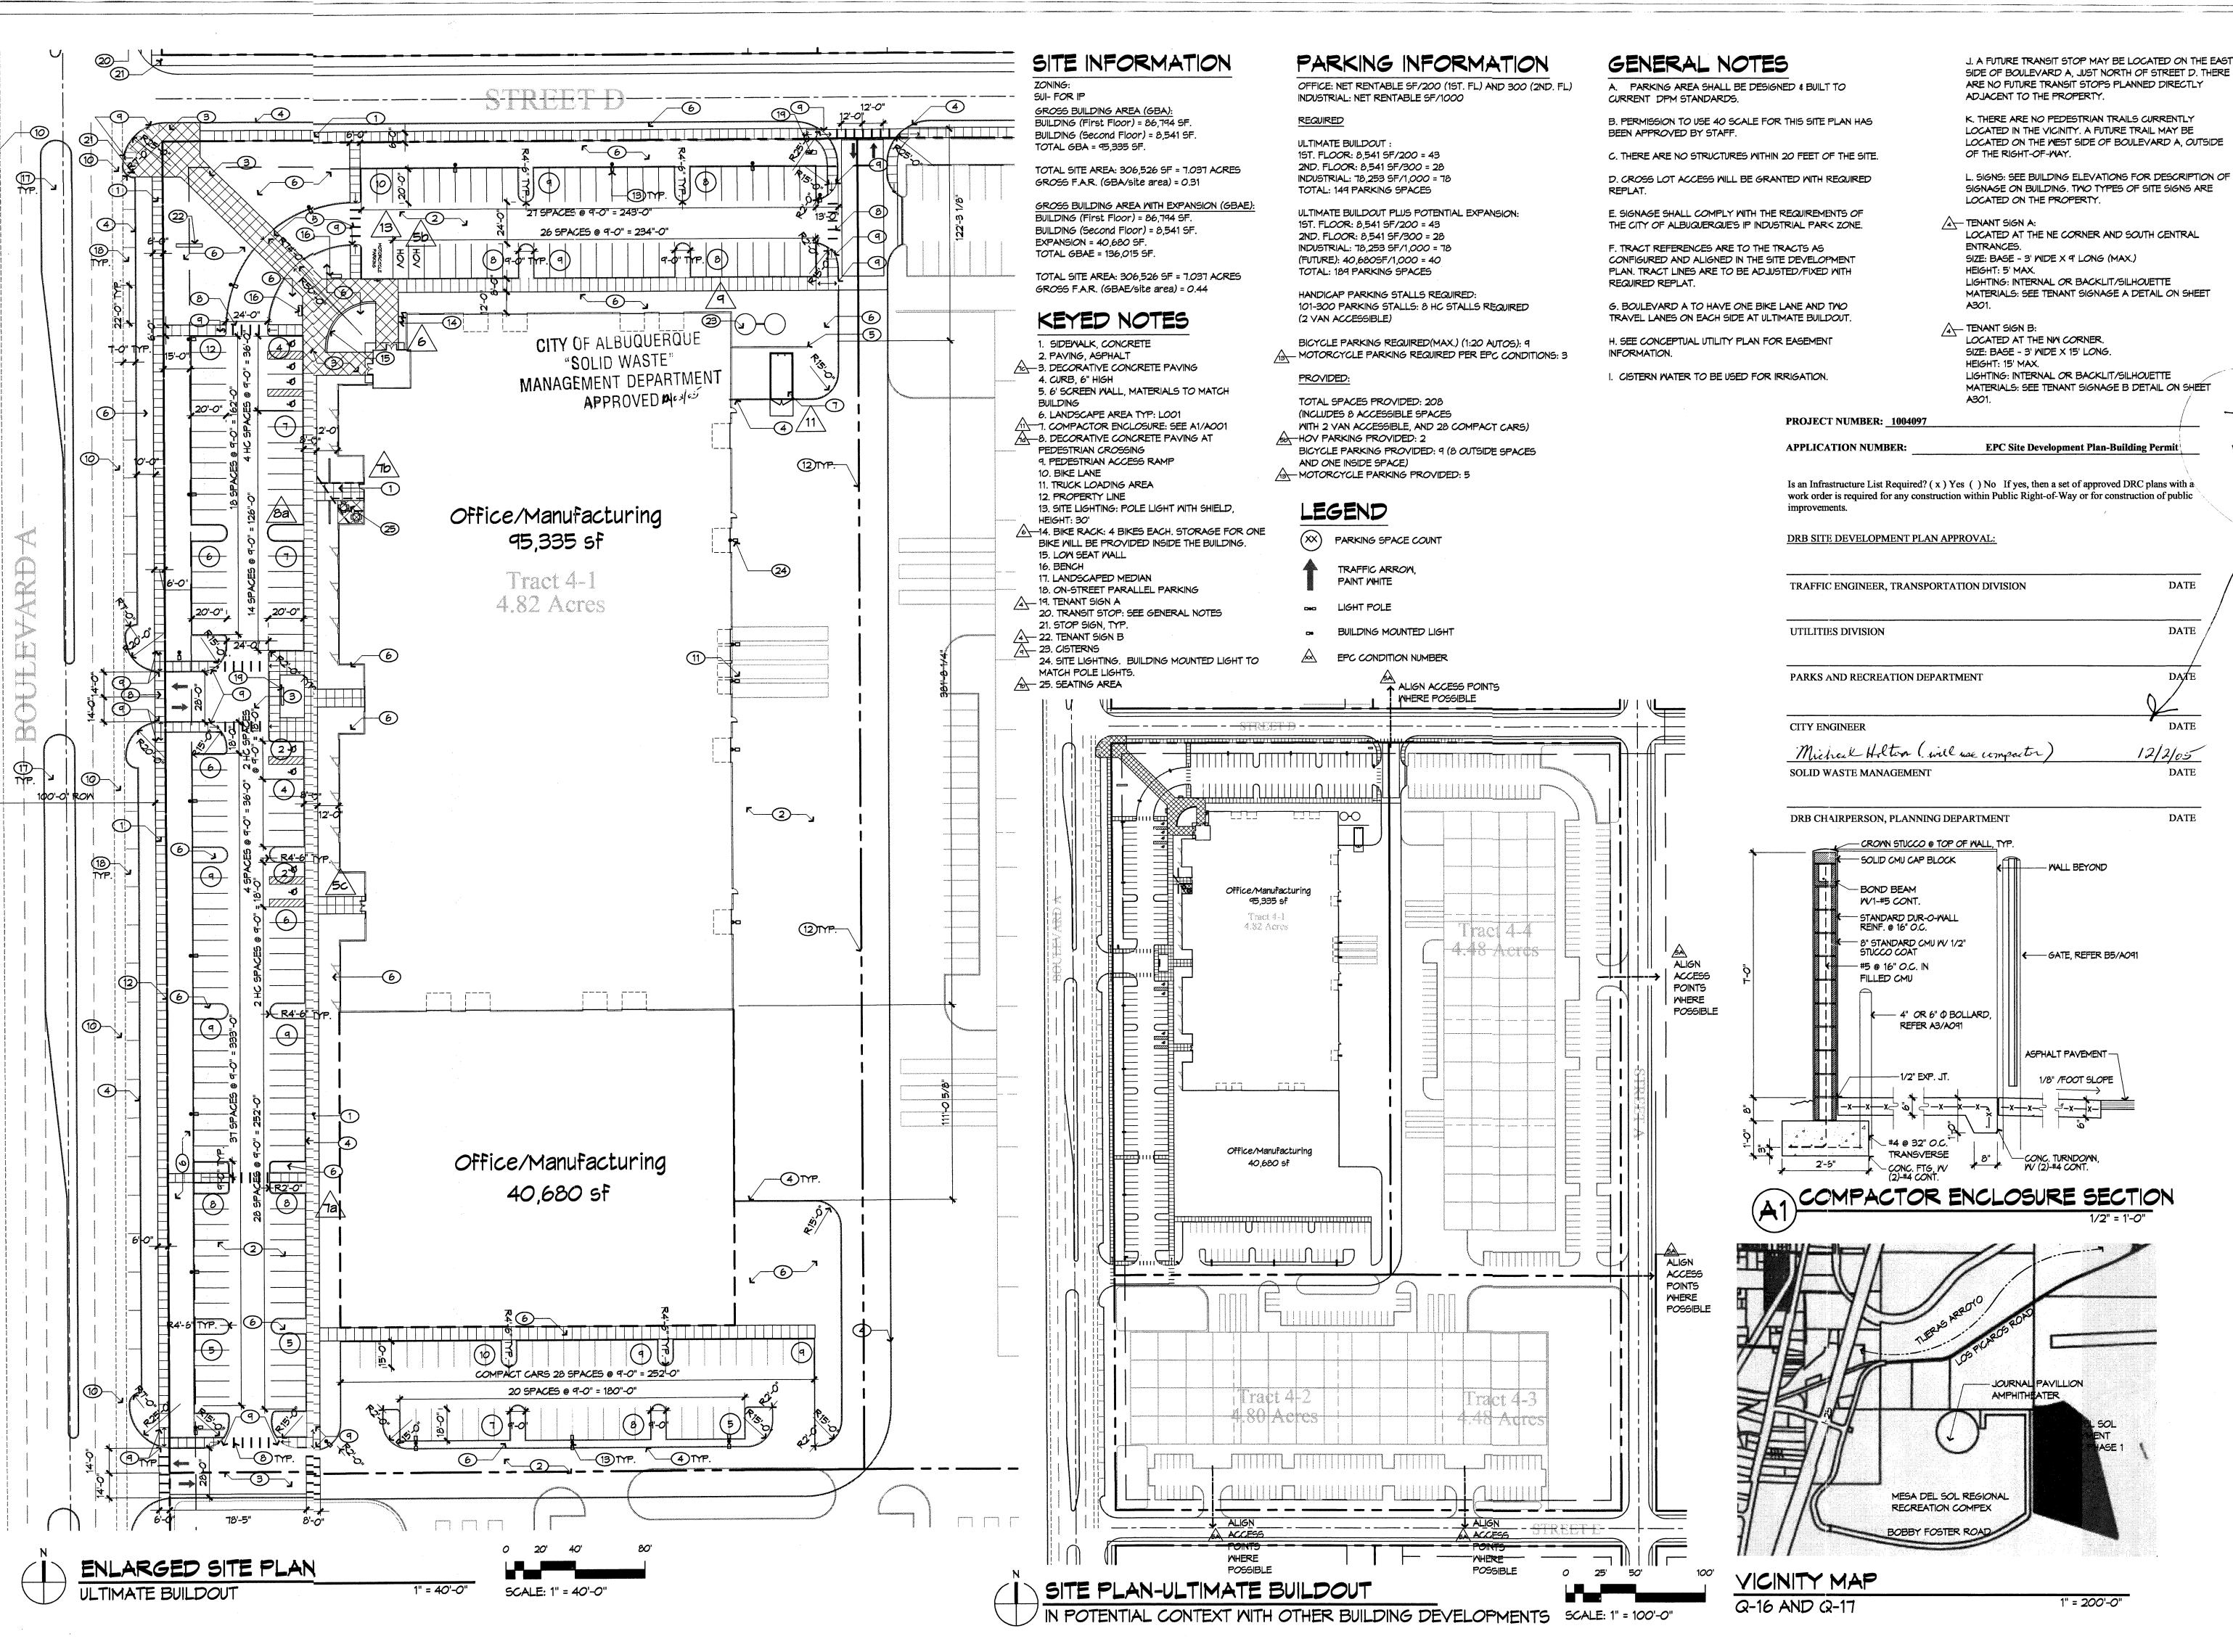

planning engineering

6801 Jefferson NE Suite 100 Albuquerque, NM 87109 505 761-9700 fax 761-4222

dps@dpsabq.com ARCHITECT

NOT FOR CONSTRUCTION

65% SUBMITTAL

PROJECT

REVISIONS 12/02/05 - DRB SUBMITTAL

DRAWN BY SY, SZ, MB REVIEWED BY

PROJECT NO. DRAWING NAME

SITE PLAN FOR BUILDING PERMIT