

1. 14' HIGH MASONRY SCREEN WALL TO MATCH BUILDING. REF. ARCH. DETAILS. WALL TO SCREEN MECH. EQUIPMENT.

2. MASONRY REFUSE ENCLOSURE TO MATCH BUILDING. MIN 6' HIGH. SEE DETAILS 1-5 ON SHEET AS1.2. INSTALL CONCRETE PAD PER CROSS SECTION DETAIL ON SHEET C1.2.

- 3. SAWCUT & REMOVE EXISTING SIDEWALK AND CURB & GUTTER. INSTALL HANDICAP RAMP/ MIN. 5'x5' LANDING
- 4. BICYCLE PARKING (21 SPACES). REF. DETAIL ON SHEET C1.2.
- 5. 6' WIDE, PIGMENTED CONCRETE SIDEWALK CROSSING TO MEET JOURNAL CENTER STANDARDS (2% MAX. CROSS SLOPE). PIGMENT COLOR PER ARCHITECT. REF. DETAIL ON SHEET C1.2.
- 6. EXISTING MONUMENT SIGN, INSTALLED WITH PHASE 1.
- 7. EXISTING 6' WIDE SIDEWALK, INSTALLED WITH PHASE 1.
- 8. 4' HIGH± MASONRY RETAINING WALL. RETAINING WALL SHALL BE SPLIT FACE CMU TO COMPLEMENT BUILDING. REF. DETAIL ON SHEET C1.2.
- 9. 6'x6' TREE PLANTER (TYP). REF LANDSCAPE PLANS FOR TREATMENT.
- 10. LIGHT POLE. REF. LIGHTING PLANS FOR DETAILS.
- 11. MEDIAN CURB & GUTTER PER COA STD DWG 2415B (6" HIGH CURB).
- 12. CONC VALLEY GUTTER PER COA STD DWG 2421 (SECTION A-A).
- 13. 4" THICK CONCRETE SIDEWALK PER COA STD DWG 2430.
- 14. INSTALL PRECAST CONCRETE WHEELSTOP PER MANUFACTURER'S RECOMMENDATIONS.

15. INSTALL HANDICAPPED PARKING SPACES, STRIPING, AND SIGNAGE PER DETAIL ON SHEET C1.2.

- 16. INSTALL CURB ACCESS RAMP PER COA STD DWGS 2440 AND 2441.
- 17. INSTALL 4" WIDE WHITE PARKING STRIPE (2 COATS PAINT).
- 18. INSTALL NEW ASPHALT PAVEMENT PER DETAILS SHEET C1.2.
- 19. INSTALL 4" BOLLARDS PER DETAILS 2 & 4, SHEET AS1.2.


20. INSTALL FIRE LANE STRIPING ON CURB. FACE OF CURB SHALL BE PAINTED SOLID RED WITH 4" TALL WHITE LETTERS STATING "FIRE LANE - NO PARKING" AT MINIMUM 20' INTERVALS.

21. BOLLARD LIGHTING PER DETAIL ON SHEET C1.1

Application Number: 05DRB-01781 Is an Infrastructure List required? () Yes (X) No If yes, then a set of approved DRC plans with a work order is required for any construction within Public Right-of-Way or for construction of public improvements. DRB SITE DEVELOPMENT PLAN APPROVAL: 3-70-06 Date 12/21/05 Date 12/21/05 Environmental Health Department (conditional) Michael Holton 12/21/05 Date

*Environmental Health, if necessary

sf sf
S sf
-
_
0 automobile spaces

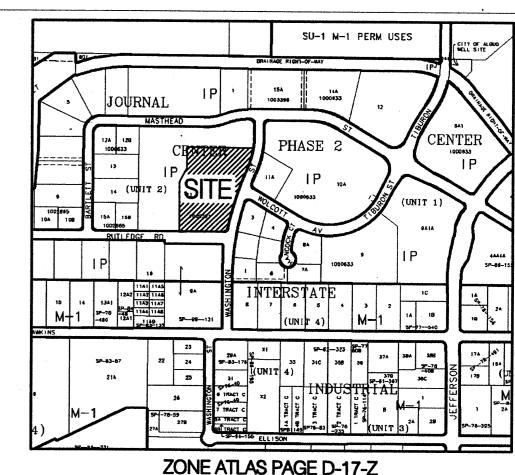

ZONE ATLAS PAGE D-17-Z SCALE: 1"=600'±

LEGAL DESCRIPTION
TRACT 11-B OF JOURNAL CENTER UNIT 2, PHASE 2 ALBUQUERQUE, NM, NOVEMBER, 2005

GENERAL NOTES

1. SCREEN WALLS AND REFUSE ENCLOSURE SHALL BE INTEGRAL TO BUILDING ARCHITECTURE.

2. UTILITY BOXES SHALL BE SCREENED WITH MATURE LANDSCAPING.

3. SITE LIGHTING SHALL BE HORIZONTAL CUT — OFF TYPE AND MAXIMUM 24' HIGH ABOVE GRADE. POLES AND FIXTURES SHALL BE PER JOURNAL CENTER

4. ALL ROOF MOUNTED MECHANICAL EQUIPMENT SHALL BE SCREENED FROM VIEW.

5. AT THE TIME COMMON AREA IRRIGATION IS CONNECTED TO JOURNAL CENTER 2 COMMON AREA IRRIGATION SYSTEM, THE DEVELOPER "TIBURON INVESTMENT, LLC" MUST BE CONTACTED.

DRAWING INDEX

C1.0 - SITE PLAN
C1.1 - SITE DETAILS
L1.0 - LANDSCAPE PLAN

C2.0 - PRELIMINARY GRADING PLAN

A2.1 — BUILDING & STRUCTURE ELEVATIONS A2.2 — BUILDING & STRUCTURE ELEVATIONS AS1.1 - REFUSE ENCLUSURE AND MONUMENTAL SIGN DETAILS C3.0 - CONCEPTUAL UTILITY PLAN

Bohannan A Hustong

ENGINEERING A SPATIAL DATA A ADVANCED TECHNOLOGIES

1306 RIO GRANDE BLVD NW ALBUQUERQUE, NM 87104 505-255-6400 505-268-6954 FAX WWW.NCA-ARCHITECTS.COM

ARCHITECT

CONSULTANT

PROJECT TITLE


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JOB NUMBER: A0559


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SHEET NO

C1.0




REFUSE ENCLOSURE CONCRETE PAVEMENT

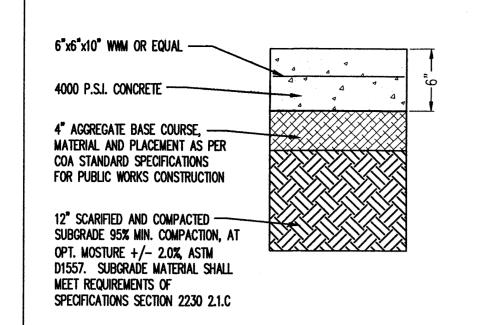

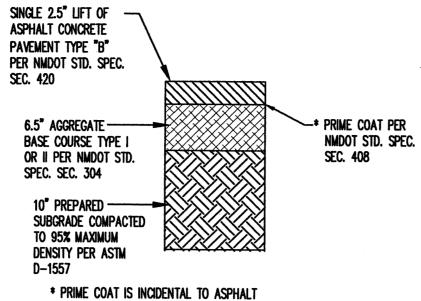
CONCRETE PAVEMENT * REFERENCE GEOTECHNICAL REPORT FOR ADDITIONAL INFORMATION.

LIGHT DUTY ASPHALT PAVEMENT SECTION N.T.S.

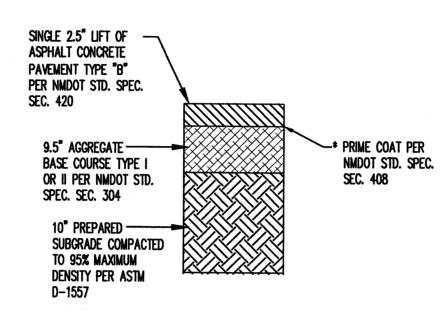

* PRIME COAT IS INCIDENTAL TO ASPHALT CONCRETE PAVEMENT * REFERENCE GEOTECHNICAL REPORT FOR ADDITIONAL INFORMATION.

HEAVY DUTY ASPHALT PAVEMENT SECTION

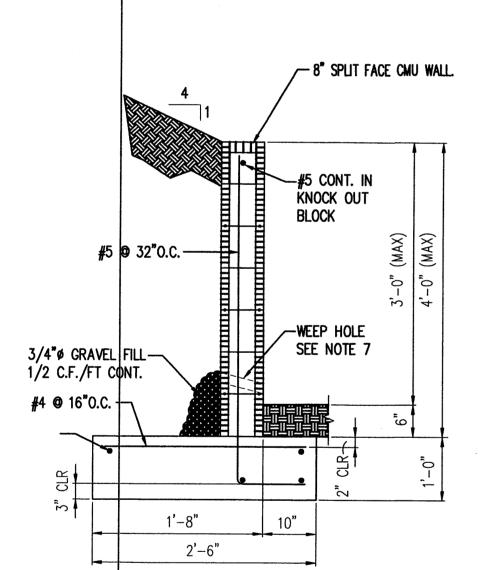



- 1. RETAINING WALL SHALL NOT BE BACK-FILLED UNTIL AT LEAST 7 DAYS AFTER CASTING THE WALL.
- 2. VERTICAL CONTROL JOINTS IN THE WALL SHALL BE PLACED AT 8'-0" O.C. MAX.
- CONSTRUCTION OF RETAINING WALLS SHALL CONFORM TO REQUIREMENTS OF THE 1997 UNIFORM BUILDING CODE.
- DESIGN DATA EFP (ACTIVE) = 36 PCF SOIL BEARING PRESSURE = 1500 PCF (1/3 INCREASE FOR WIND/SEISMIC) COEFFICIENT OF FRICTION = 0.35EFP (PASSIVE) = 300 PCFCONCRETE F'C (28 DAYS) = 3000 PSI REINFORCEMENT = 60 ASTM A-615

CONTRACTOR SHALL NOTIFY OWNER PRIOR TO CONCRETE FOOTING POUR FOR INSPECTION OF COMPACTION UNDER FOOTING, FOOTING DEPTH AND WIDTH AND WALL STEEL AND SPACING. FINAL INSPECTION OF FOOTING AND WALL WILL BE REQUIRED.


- THE CONTRACTOR SHALL BE RESPONSIBLE TO SEE THAT ALL REBAR IS PROPERLY ALIGNED AND TIED IN PLACE BEFORE PLACING CONCRETE. ALL STEEL SHALL BE ACCURATELY LOCATED AND SECURED IN PLACE SO THAT IT REMAINS IN POSITION DURING (THE PLACEMENT OF THE CONCRETE. ANY REBAR IMPROPERLY INSTALLED SHALL BE REMOVED AT NO ADDITIONAL COST TO THE OWNER.
- 7. WEEP HOLES: PLACE A 2" DIA. WEEP HOLE @ 5'-0" O.C. W/ 1/2 CUBIC FOOT/FOOT OF 3/4" GRAVEL IN FILTER FABRIC
- 8. THE FIRST COURSE OF CMU BLOCK MAY BE PLACED IN FRESH FOOTING CONCRETE. SUBSEQUENT COURSES OF CMU BLOCK SHALL NOT BE PLACED UNTIL 7 DAYS AFTER THE FOOTING IS CAST.
- 9. ALL CMU BLOCK JOINTS SHALL BE TOOLED.
- 10. BACK FILL AND COMPACTION OF RETAINING WALL IS INCIDENTAL TO INSTALLATION OF RETAINING WALL.

SPLIT FACE CMU RETAINING WALL NOT TO SCALE

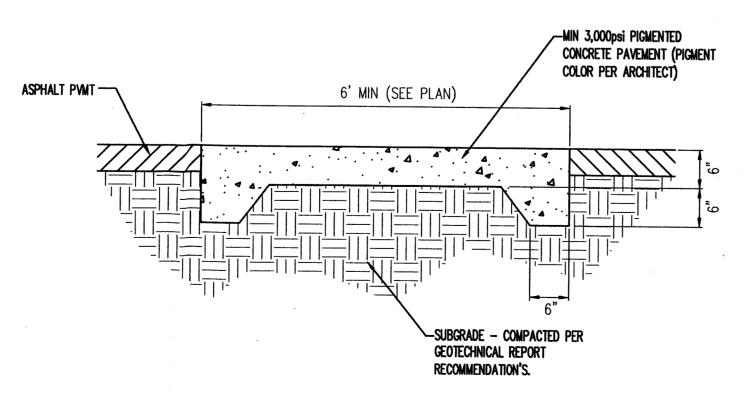

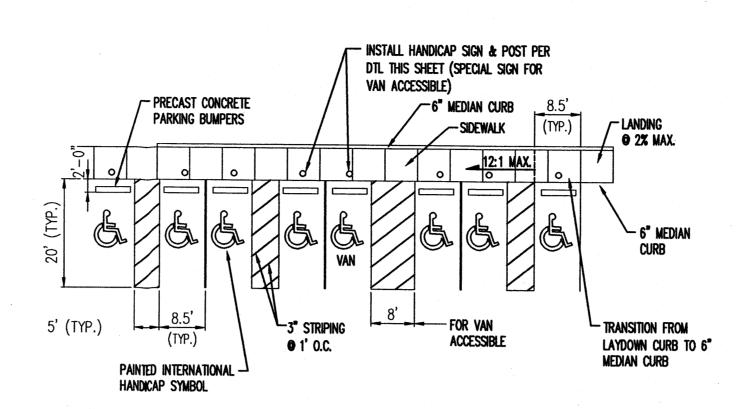


HANDICAP PARKING DETAIL

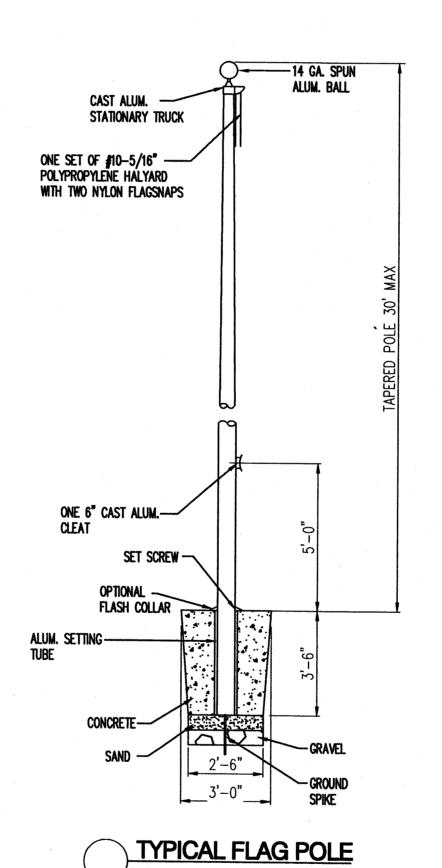


INSTALL REDWOOD -----MIN 3,000psi PIGMENTED EXPANSION JOINT CONCRETE PAVEMENT (PIGMENT COLOR PER ARCHITECT) (SEE PLAN) BUILDING SLAB ---FINISHED GRADE -SUBGRADE - COMPACTED PER GEOTECHNICAL REPORT RECOMMENDATION'S.

CONCRETE PATIO DETAIL

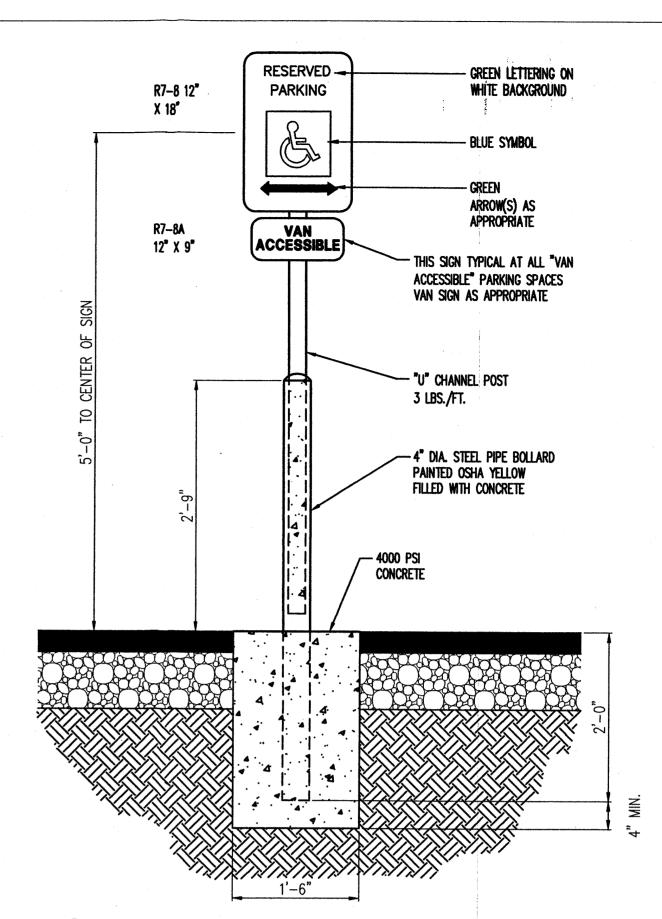

HANDICAP PARKING SIGN MOUNTING DETAIL ONE SIGN SHALL BE INSTALLED AT EACH HANDICAP SPACE.

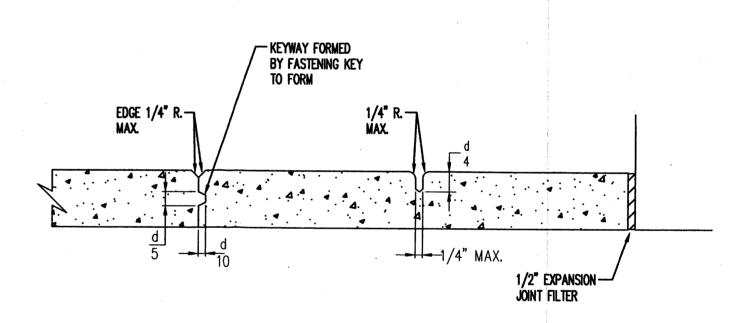


DETAIL A CONSTRUCTION JOINT 12'-0" SPACING (TYP.)

DETAIL B CONSTRUCTION FORMED JOINT 12'-0" SPACING (TYP.)

DETAIL C USE ONLY AT BUILDINGS OR OBJECTS ABUTTING THE PAVED AREA

CONCRETE PAVEMENT JOINT DETAILS

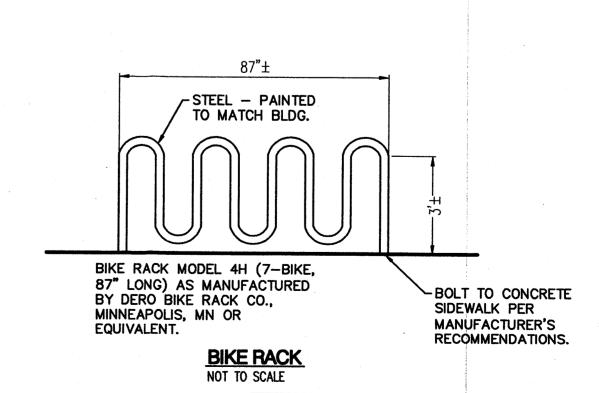

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ARCHITECT

CONSULTANT

PROJECT TITLE

ASTHEAD OFFICE COMPL AT JOURNAL CENTER 2

0

REVISIONS

MK DATE DESCRIPTION DRAWN BY: CHECKED BY: RWB JTW JOB NUMBER: A0559


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SHEET NO

C1.1

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SIDEWALK CROSSING DETAIL



PLANT LEGEND

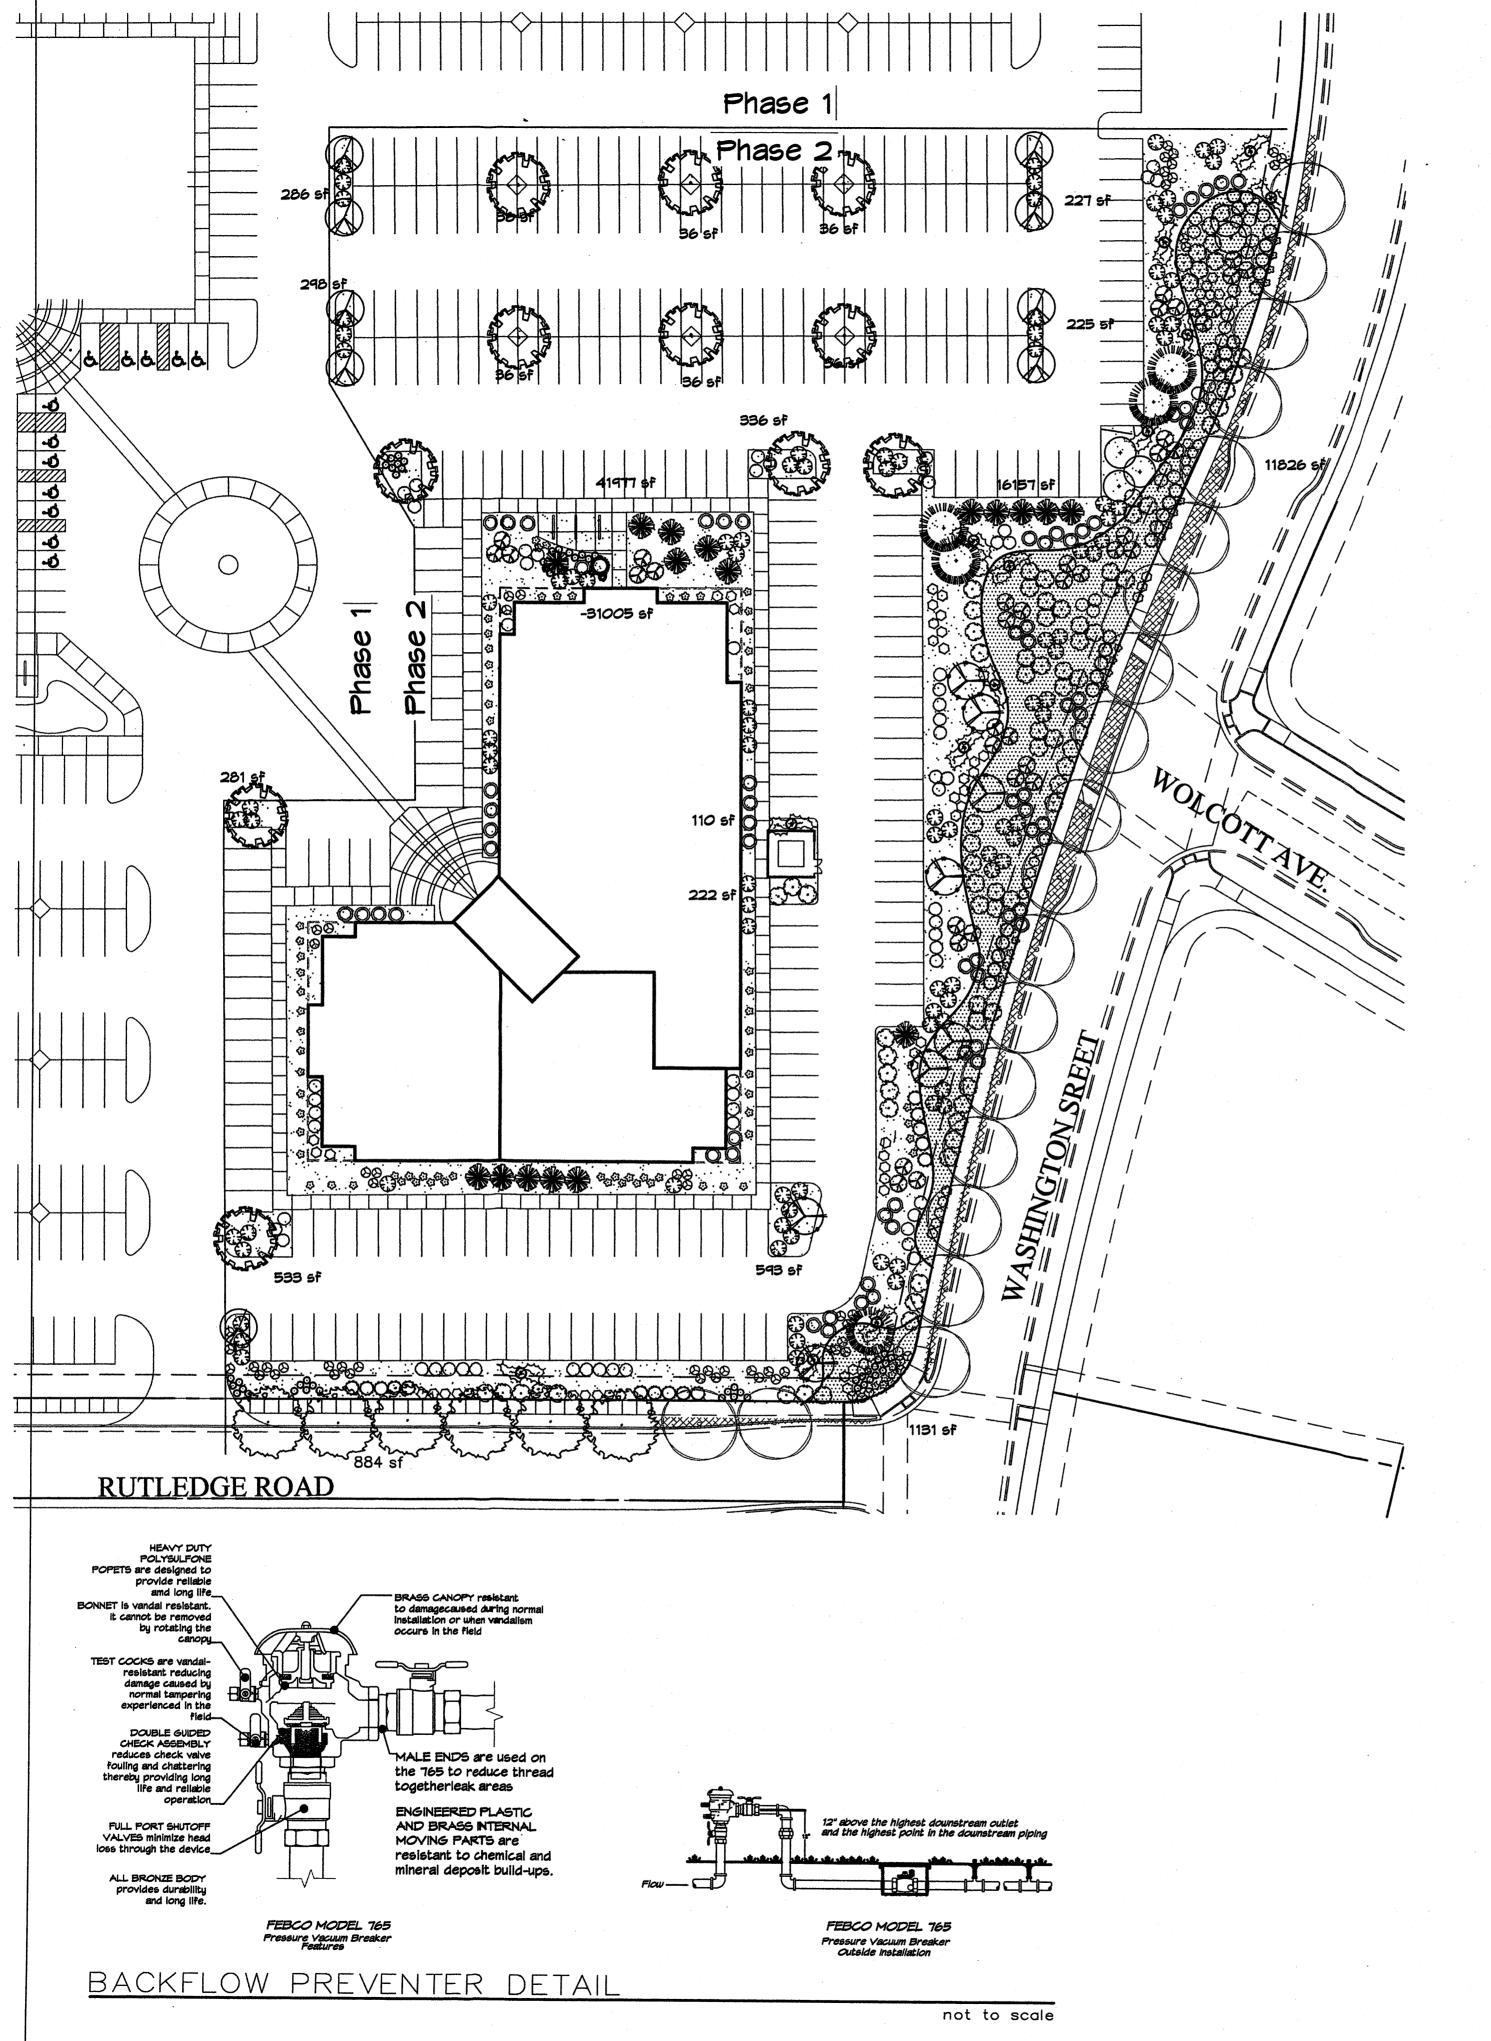EXISTING BERINDA ASH BERINDA ASH (H) 6 Fraxinus SPP. 2" Cal. CURLLEAF MTN MAHOGANY (L) 83 Carcorpus ledfolius 5 Gal. 100SF (PER THE JOURNAL CENTER REQUIREMENTS FOR STREET TREE PARKSTRIP)

CHINESE PISTACHE (M) 11 Pistachia chinensis 2" Cal.

REDBUD (M) 9 Cercis reniformis 2" Cal.

THORNLESS HAWTHORN (M+) 5 Crataegus crus-galli inermis 15 Gal. 225sf

SOTOL 17 Dasylirion wheeleri 5 Gal. 36sf

LANDSCAPE NOTES: Landscape maintenance shall be the responsibility of the Property Owner.

It is the intent of this plan to comply with the City Of Albuquerque Water Conservation Landscaping and Water Waste Ordinance planting restriction approach. Approval of this plan does not constitute or imply exemption from water waste provisions of the Water Conservation Landscaping and Water Waste

Water management is the sole responsibility of the Property Owner. All landscaping will be in conformance with the City of Albuquerque Zoning Code, Street Tree Ordinance, Pollen Ordinance, and Water Conservation Landscaping and Water Waste Ordinance. In general, water conservative, environmentally sound landscape principles will be followed in design and installation.

Plant beds shall achieve 75% live ground cover at maturity.

Santa Ana Tan Gravel over Filter Fabric shall be placed in all landscape areas which are not designated to receive native seed.

MUGO PINE (M) 1 Pinus mugo 5 Gal. 36sf

THREE-LEAF SUMAC (L) 43 Rhus trilobata 5 Gal. 36sf

APACHE PLUME (L) 83 Fallugia paradoxa 5 Gal. 42sf THREADGRASS (M) 91 Stipa tennuisima

1 Gal. 45f AUTUMN SAGE (M) 71 O Salvia greggii 5 Gal.

LAVENDER (M) 49 Lavandula angustifolia 1 Gal. 95f

ARP ROSEMARY (M) 66 Rosmarinus officianalis 5 Gal. 36sf

> IRRIGATION NOTES: Irrigation shall be a complete underground system with Trees to receive (5) 1.0 GPH Drip Emitters and Shrubs to receive (2) 1.0 GPH Drip Emitters. Drip and Bubbler systems to be tied to 1/2" polypipe with flush caps at each end.

Run time per each drip valve will be approximately 15 minutes per day, to be adjusted according to the season.

Point of connection for irrigation system is unknown at current time and will be coordinated in the field. Irrigation will be operated by automatic controller.

Location of controller to be field determined and power source for controller to be provided by others. Irrigation maintenance shall be the

responsibility of the Property Owner. Water and Power source shall be the responsibility of the Developer/Builder

POWIS CASTLE SAGE (L) 39 Artimesia x powis castle 5 Gal. 25sf

WINTER JASMINE (L+) 99 Jasminum nudiflorum 5 Gal. 1445f

WILDFLOWER 59 1 *G*al. 45f

GREYLEAF COTONEASTER 39 Cotoneaster buxifolius 5 Gal. 81sf

NATURAL EDGE

SANTA ANA TAN GRAVEL WITH FILTER FABRIC GREY CRUSHERFINES WITH FILTER FABRIC OVERSIZED GRAVEL

WITH FILTER FABRIC

EXISTING LANDSCAPING

BOULDERS (6)

STHEAD OFFICE COMPLAT JOURNAL CENTER 2

1306 RIO GRANDE BLVD NW ALBUQUERQUE, NM 87104

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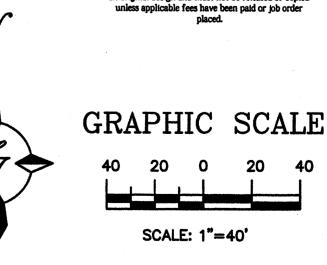
DRR 11/22/05 REVISED SITE PLAN MK DATE DESCRIPTION DRR

LANDSCAPE CALCULATIONS

TOTAL LOT AREA	181507	— square feet
TOTAL BUILDINGS AREA	43401	square feet
OFFSITE AREA	884	square feet
NET LOT AREA	137222	square feet
LANDSCAPE REQUIREMENT	15%	
TOTAL LANDSCAPE REQUIREMENT	20583	square feet
TOTAL BED PROVIDED	44297	square feet
GROUNDCOVER REQ.	75%	square feet
TOTAL GROUNDCOVER REQUIREMENT	33223	square feet
TOTAL GROUNDCOVER PROVIDED _	34394 (77%)	square feet
TOTAL SOD AREA (max. 20% of landscape required)	0	square feet
TOTAL NATIVE SEED AREA	0	square feet
TOTAL LANDSCAPE PROVIDED _	44297 (32%)	square feet




Cont. Lic. #26458 7909 Edith N.E. Albuquerque, NM 87184 Ph. (505) 898-9690 Fax (505) 898-7737 ciohnson@hilltoplandscaping.com All creative ideas contained Herein remains the property of The Hilltop Landscape Architects and Contractors and are protected by copyright laws. This is an original design and must not be released or copied unless applicable fees have been paid or job order



A0559

NOVEMBER 2005

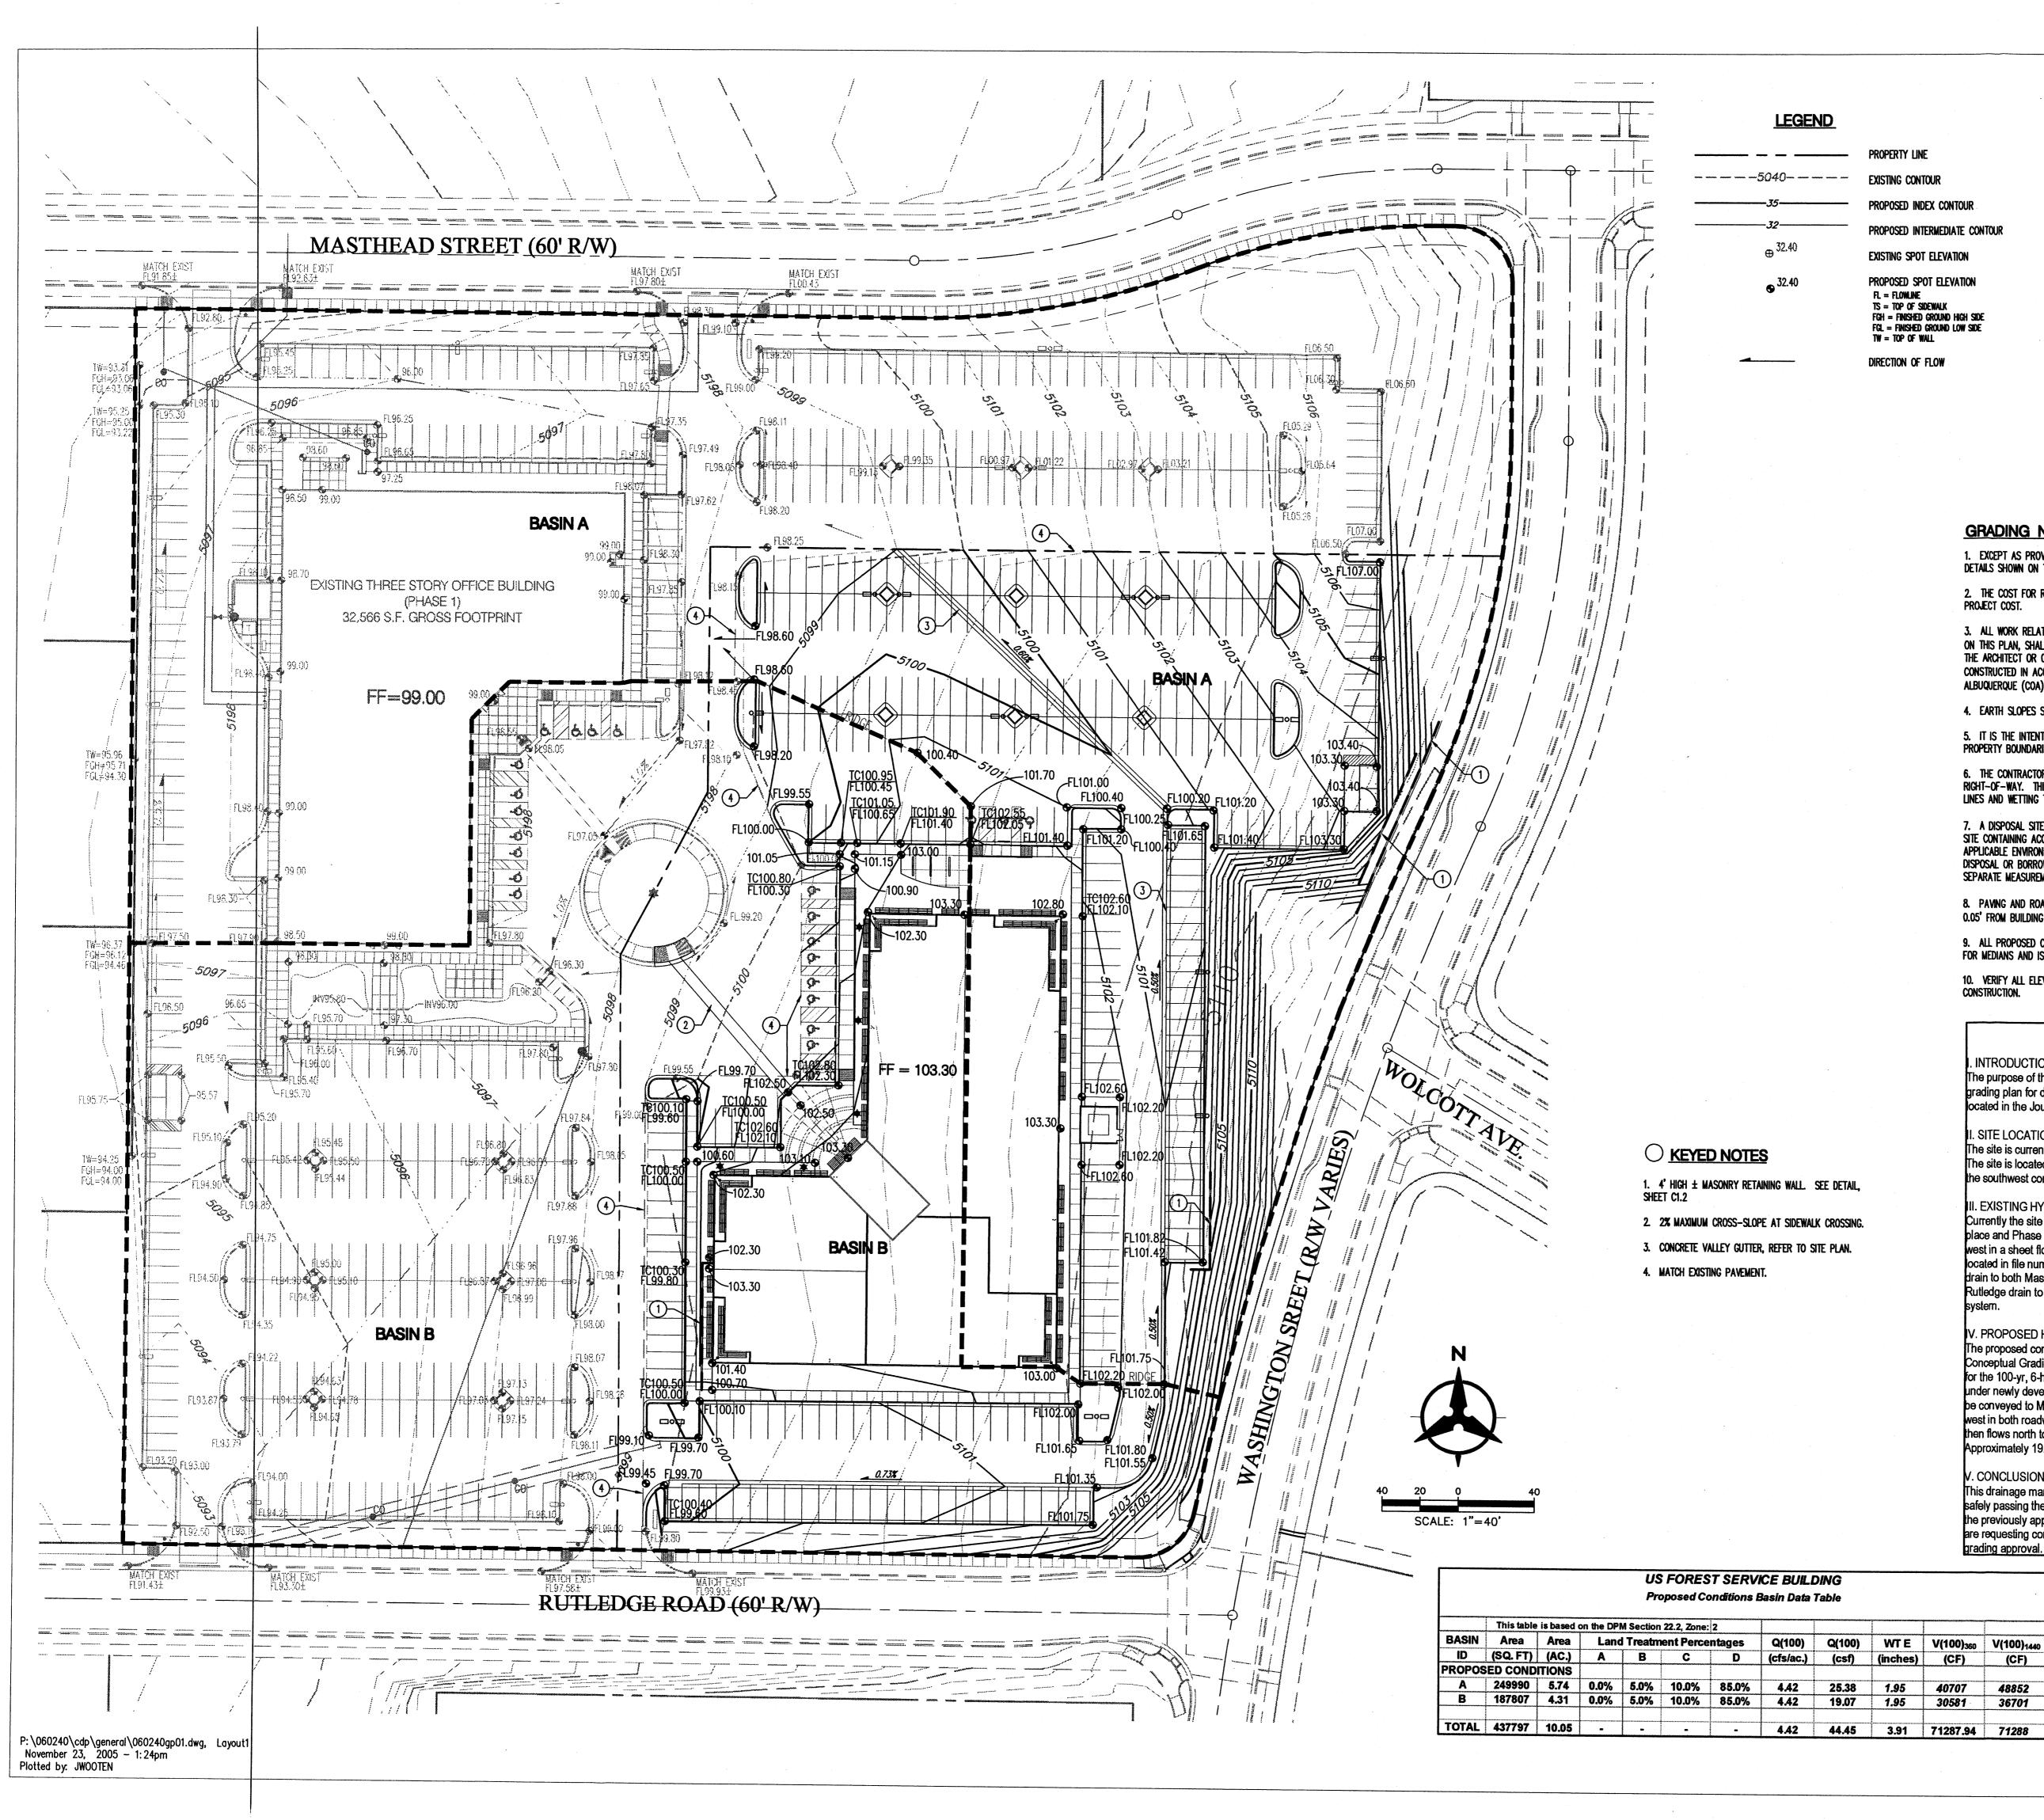

LEGEND PROPOSED INTERMEDIATE CONTOUR EXISTING SPOT ELEVATION **→** 32.40 PROPOSED SPOT ELEVATION TS = TOP OF SIDEWALK FGH = FINISHED GROUND HIGH SIDE FGL = FINISHED GROUND LOW SIDE TW = TOP OF WALL

ZONE ATLAS PAGE D-17-Z SCALE: 1"=600'±

LEGAL DESCRIPTION TRACT 11-B OF JOURNAL CENTER UNIT 2, PHASE 2 ALBUQUERQUE, NM, NOVEMBER, 2005

GRADING NOTES

DIRECTION OF FLOW

- 1. EXCEPT AS PROVIDED HEREIN, GRADING SHALL BE PERFORMED AT THE ELEVATIONS AND IN ACCORDANCE WITH THE DETAILS SHOWN ON THIS PLAN.
- 2. THE COST FOR REQUIRED CONSTRUCTION DUST AND EROSION CONTROL MEASURES SHALL BE INCIDENTAL TO THE PROJECT COST.
- 3. ALL WORK RELATIVE TO FOUNDATION CONSTRUCTION, SITE PREPARATION, AND PAVEMENT INSTALLATION, AS SHOWN ON THIS PLAN, SHALL BE CONSTRUCTED IN ACCORDANCE WITH THE "GEOTECHNICAL INVESTIGATION." AS PROVIDED BY THE ARCHITECT OR OWNER. ALL OTHER WORK SHALL, UNLESS OTHERWISE STATED OR PROVIDED FOR HEREON, BE CONSTRUCTED IN ACCORDANCE WITH THE PROJECT, (FIRST PRIORITY) SPECIFICATIONS, AND/OR THE CITY OF ALBUQUERQUE (COA) STANDARD SPECIFICATIONS FOR PUBLIC WORKS (SECOND PRIORITY).
- 4. EARTH SLOPES SHALL NOT EXCEED 3 HORIZONTAL TO 1 VERTICAL UNLESS SHOWN OTHERWISE.
- 5. IT IS THE INTENT OF THESE PLANS THAT THIS CONTRACTOR SHALL NOT PERFORM ANY WORK OUTSIDE OF THE PROPERTY BOUNDARIES EXCEPT AS REQUIRED BY THIS PLAN.
- 6. THE CONTRACTOR IS TO ENSURE THAT NO SOIL ERODES FROM THE SITE ONTO ADJACENT PROPERTY OR PUBLIC RIGHT-OF-WAY. THIS SHOULD BE ACHIEVED BY CONSTRUCTING TEMPORARY BERMS OR SILT FENCE AT THE PROPERTY LINES AND WETTING THE SOIL TO PROTECT IT FROM WIND EROSION.
- 7. A DISPOSAL SITE FOR ANY & ALL EXCESS EXCAVATION MATERIAL, AND UNSUITABLE MATERIAL AND/OR A BORROW SITE CONTAINING ACCEPTABLE FILL MATERIAL SHALL BE OBTAINED BY THE CONTRACTOR IN COMPLIANCE WITH APPLICABLE ENVIRONMENTAL REGULATIONS AND APPROVED BY THE OBSERVER. ALL COSTS INCURRED IN OBTAINING A DISPOSAL OR BORROW SITE AND HAUL TO OR FROM SHALL BE CONSIDERED INCIDENTAL TO THE PROJECT AND NO SEPARATE MEASUREMENT OR PAYMENT SHALL BE MADE.
- 8. PAVING AND ROADWAY GRADES SHALL BE \pm 0.1' From Plan Elevations. Pad Elevation shall be \pm /-0.05' FROM BUILDING PLAN ELEVATION.
- 9. ALL PROPOSED CONTOURS REFLECT TOP OF PAVEMENT ELEVATIONS IN THE PARKING AREA AND MUST BE ADJUSTED FOR MEDIANS AND ISLANDS.
- 10. VERIFY ALL ELEVATIONS SHOWN ON PLAN FROM BASIS OF ELEVATION CONTROL STATION PRIOR TO BEGINNING

DRAINAGE MANAGEMENT PLAN

INTRODUCTION

The purpose of this submittal is to provide a conceptual Drainage Management Plan and rough grading plan for development of the Masthead Office Complex at Journal Center 2 - Phase 2, ocated in the Journal Center, Phase 2, Unit 2, Lot 11-B in NE Albuquerque.

I. SITE LOCATION

The site is currently legally described as, Journal Center, Phase 2, Unit 2, Lot 11-B (+/- 4.4 acres). The site is located within zone atlas map #M-21, and is in hydrologic zone 2. The site is located at the southwest corner of Masthead and Washington, just west of Jefferson.

III. EXISTING HYDROLOGIC CONDITIONS

Currently the site (4.4 ac.) is undeveloped land. The surrounding streets and infrastructure are in place and Phase 1 of the development is currently under construction. The site drains from east to west in a sheet flow condition. Per the approved Drainage Plan of Journal Center - Phase 2 ocated in file number D17/D3AA, this site has been approved as a fully developed site and can drain to both Masthead and Rutledge via. surface flow out of the driveways. Both Masthead and Rutledge drain to the west of the site where the drainage is collected in an underground drainage

V. PROPOSED HYDROLOGIC CONDITIONS

The proposed conditions for the Masthead Office Complex at Journal Center 2 are shown on this Conceptual Grading Plan. The hydrologic analysis for this area is based on drainage requirements for the 100-yr, 6-hr storm event. The total site (+/- 10.0 acres) will generate a total of 44.45 cfs under newly developed conditions and consists of approximately 85% D land treatment. Flows will be conveyed to Masthead and Rutledge by surface and curb and gutters. This split flow will travel west in both roadways to a common existing underground drainage system. This drainage system then flows north to the North Pino Arroyo, and then to the AMAFCA North Diversion Channel. Approximately 19.07 cfs drains to Rutledge; the other 25.38 cfs drains to Masthead.

/. CONCLUSION

This drainage management plan provides for grading and drainage elements which are capable of safely passing the 100 year storm and which meet city requirements and are in conformance with the previously approved master drainage plan for Journal Center, Phase 2. With this submittal we are requesting conceptual grading and drainage plan approval for building permit and rough grading approval.

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REVISIONS


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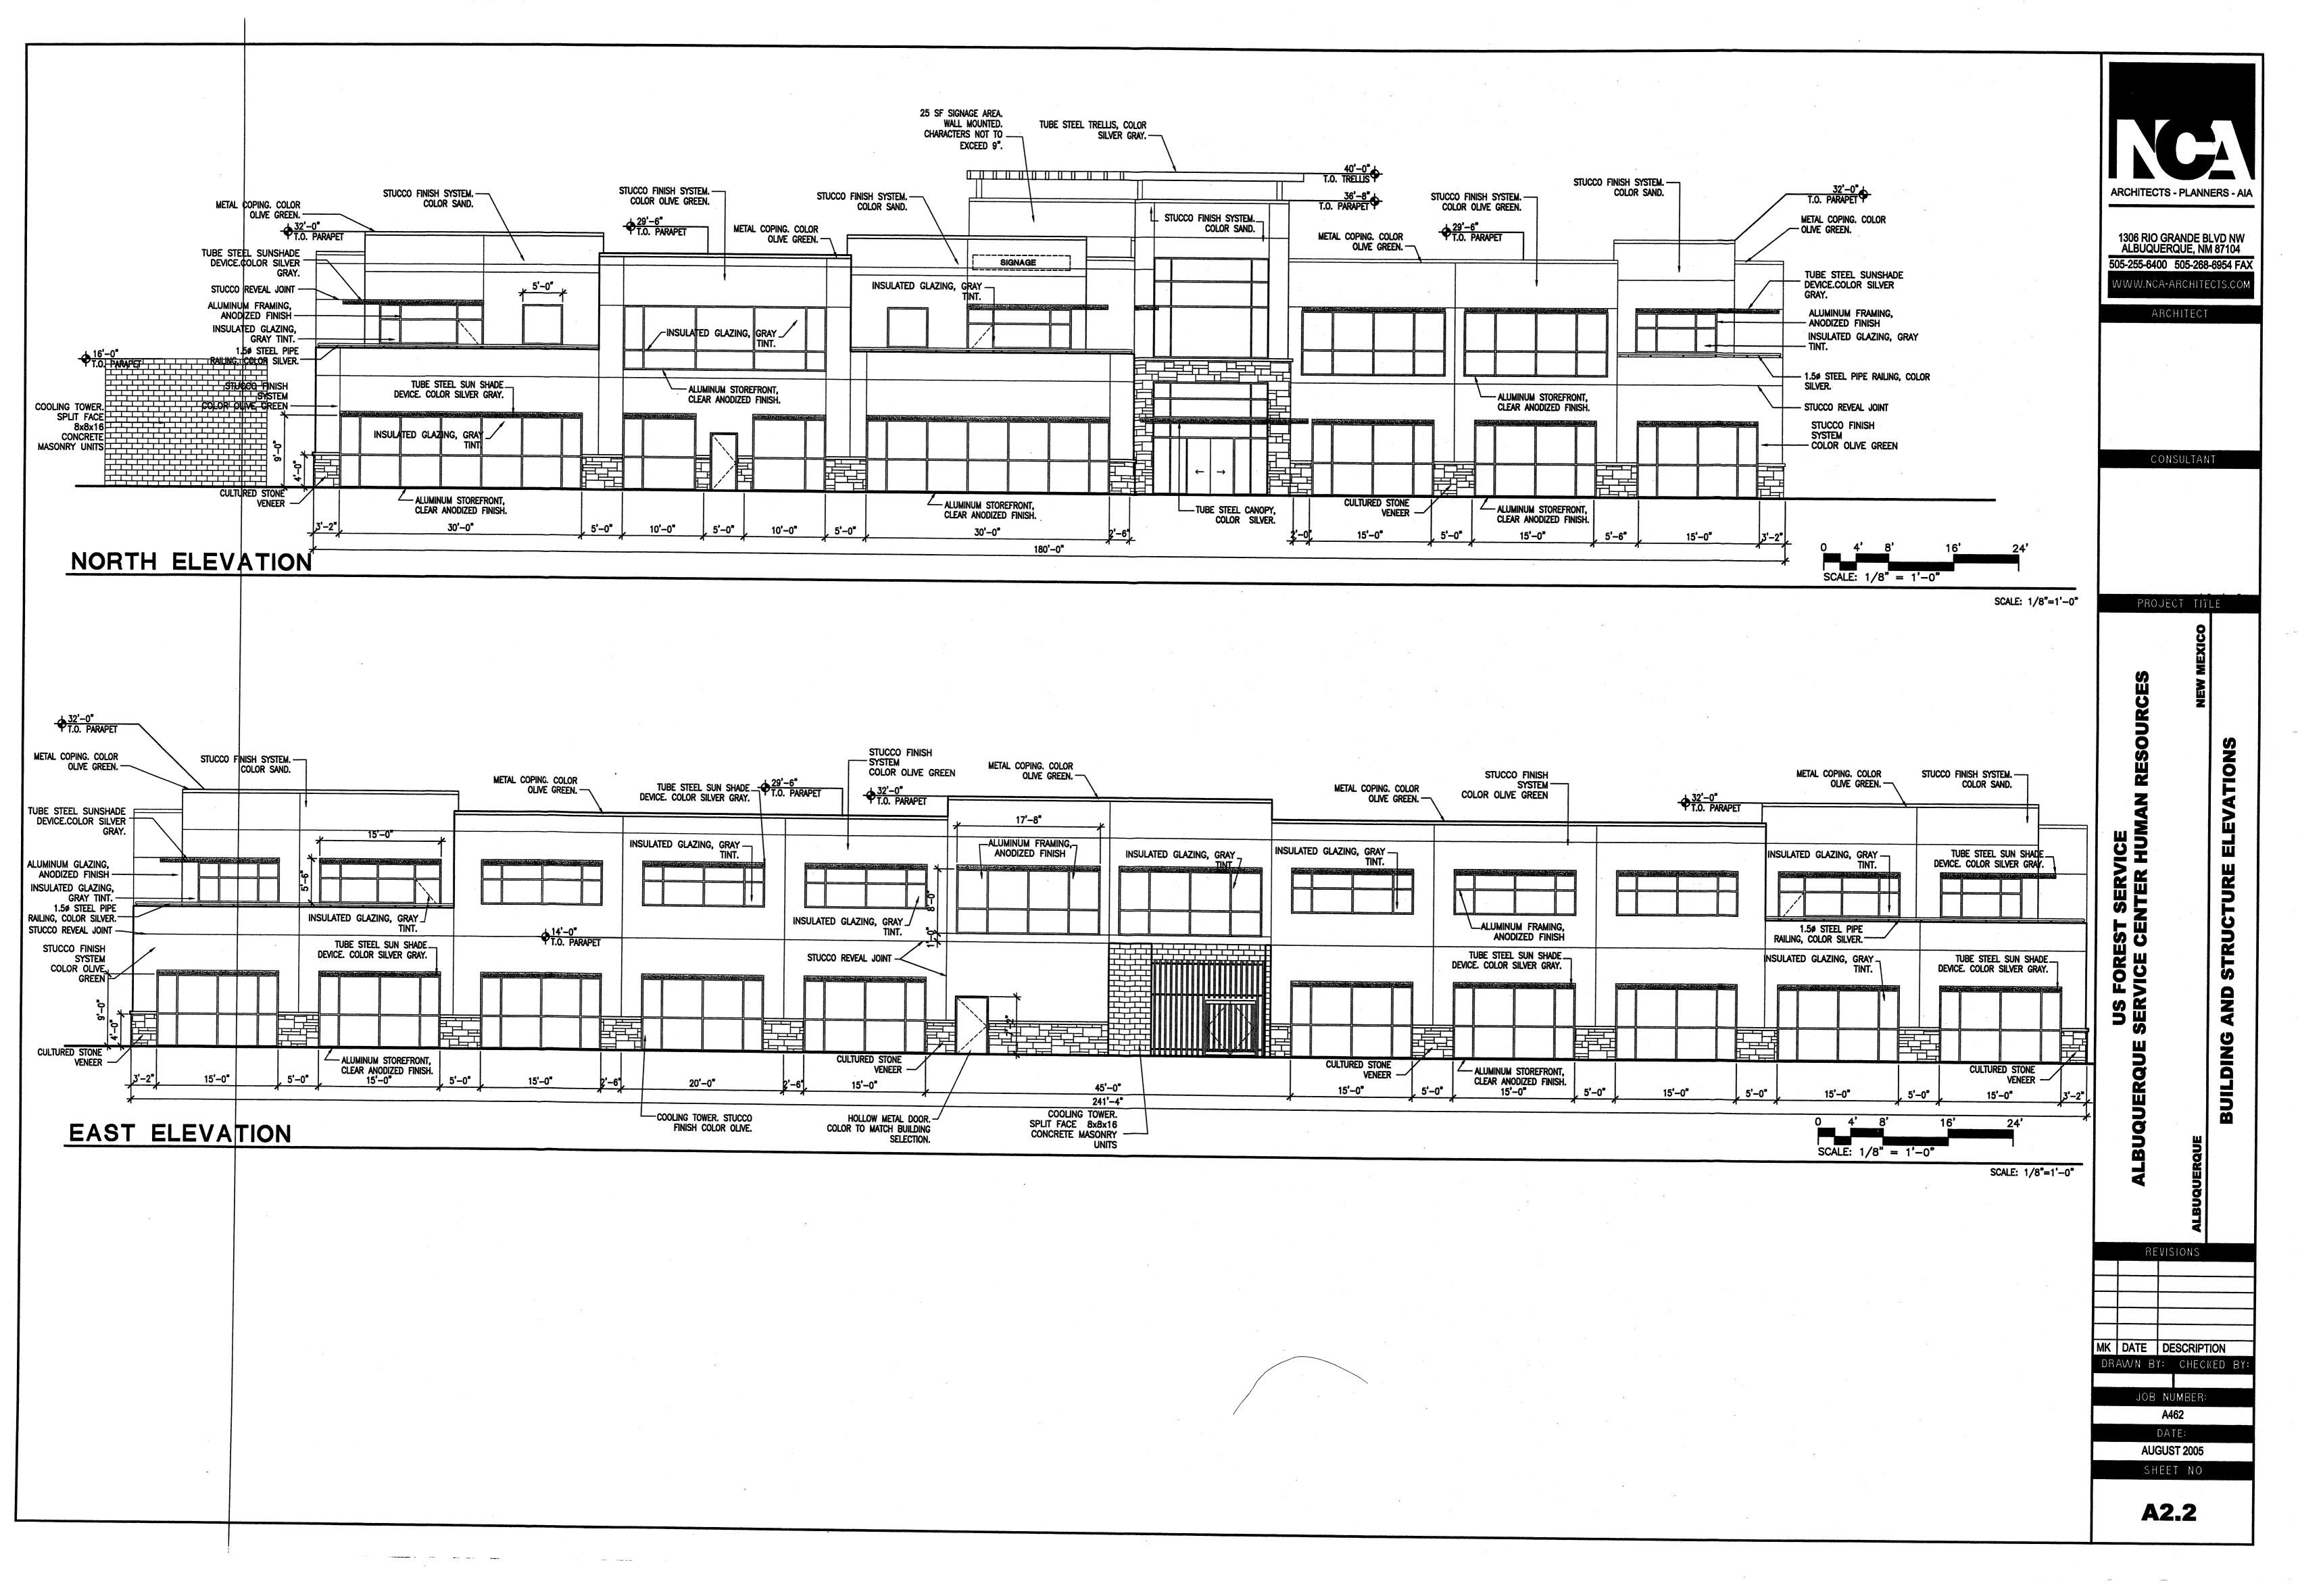
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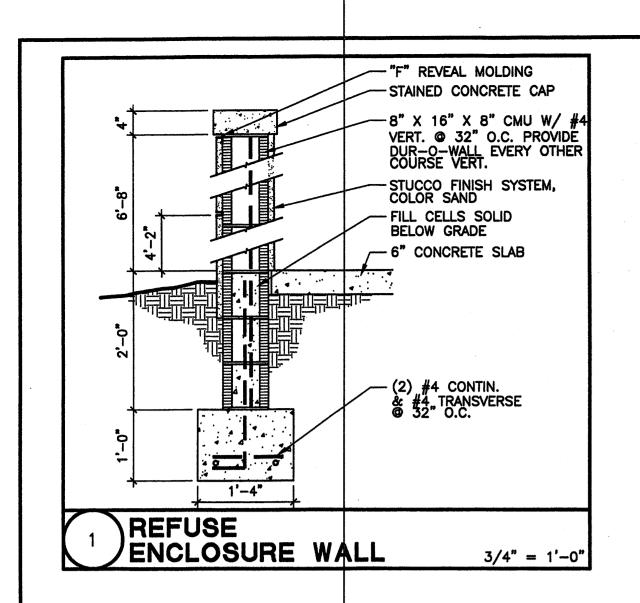
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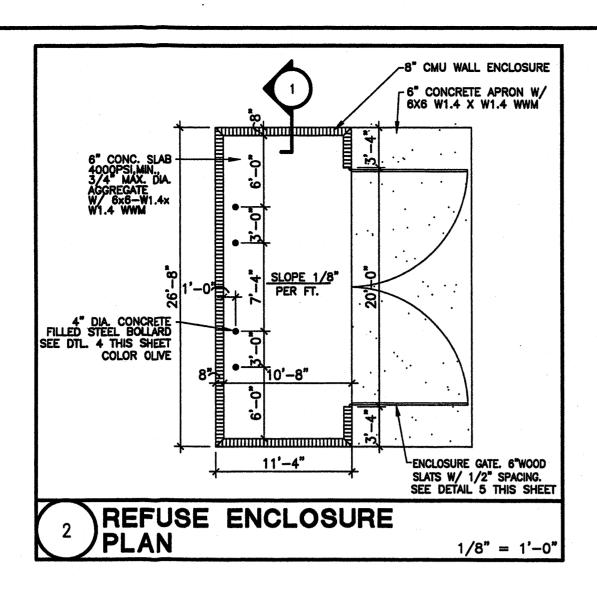
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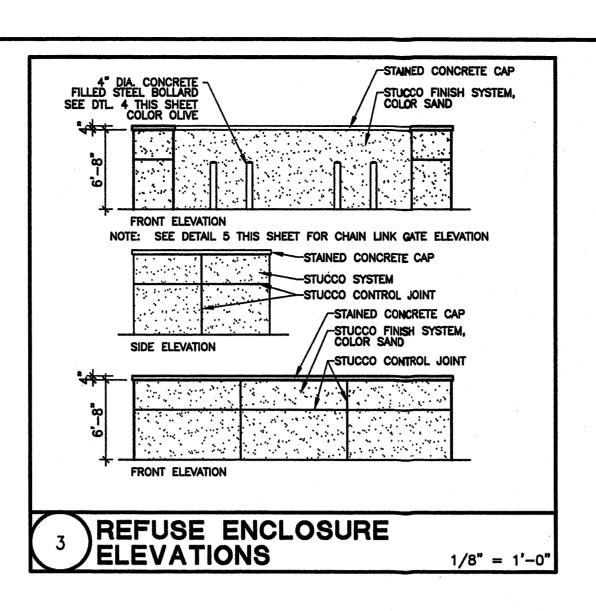
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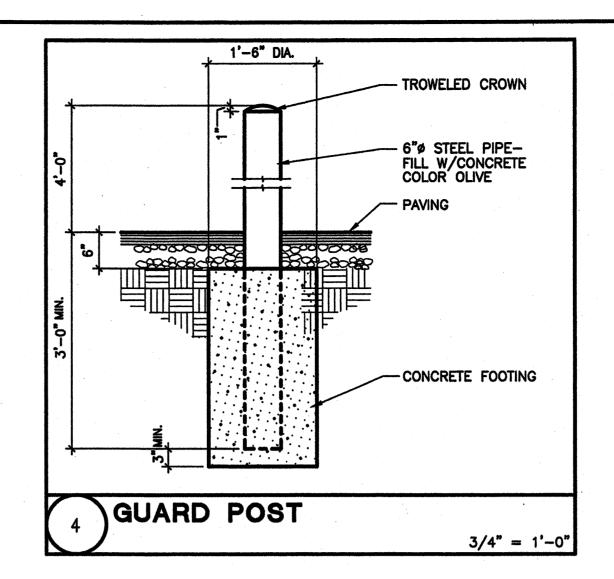











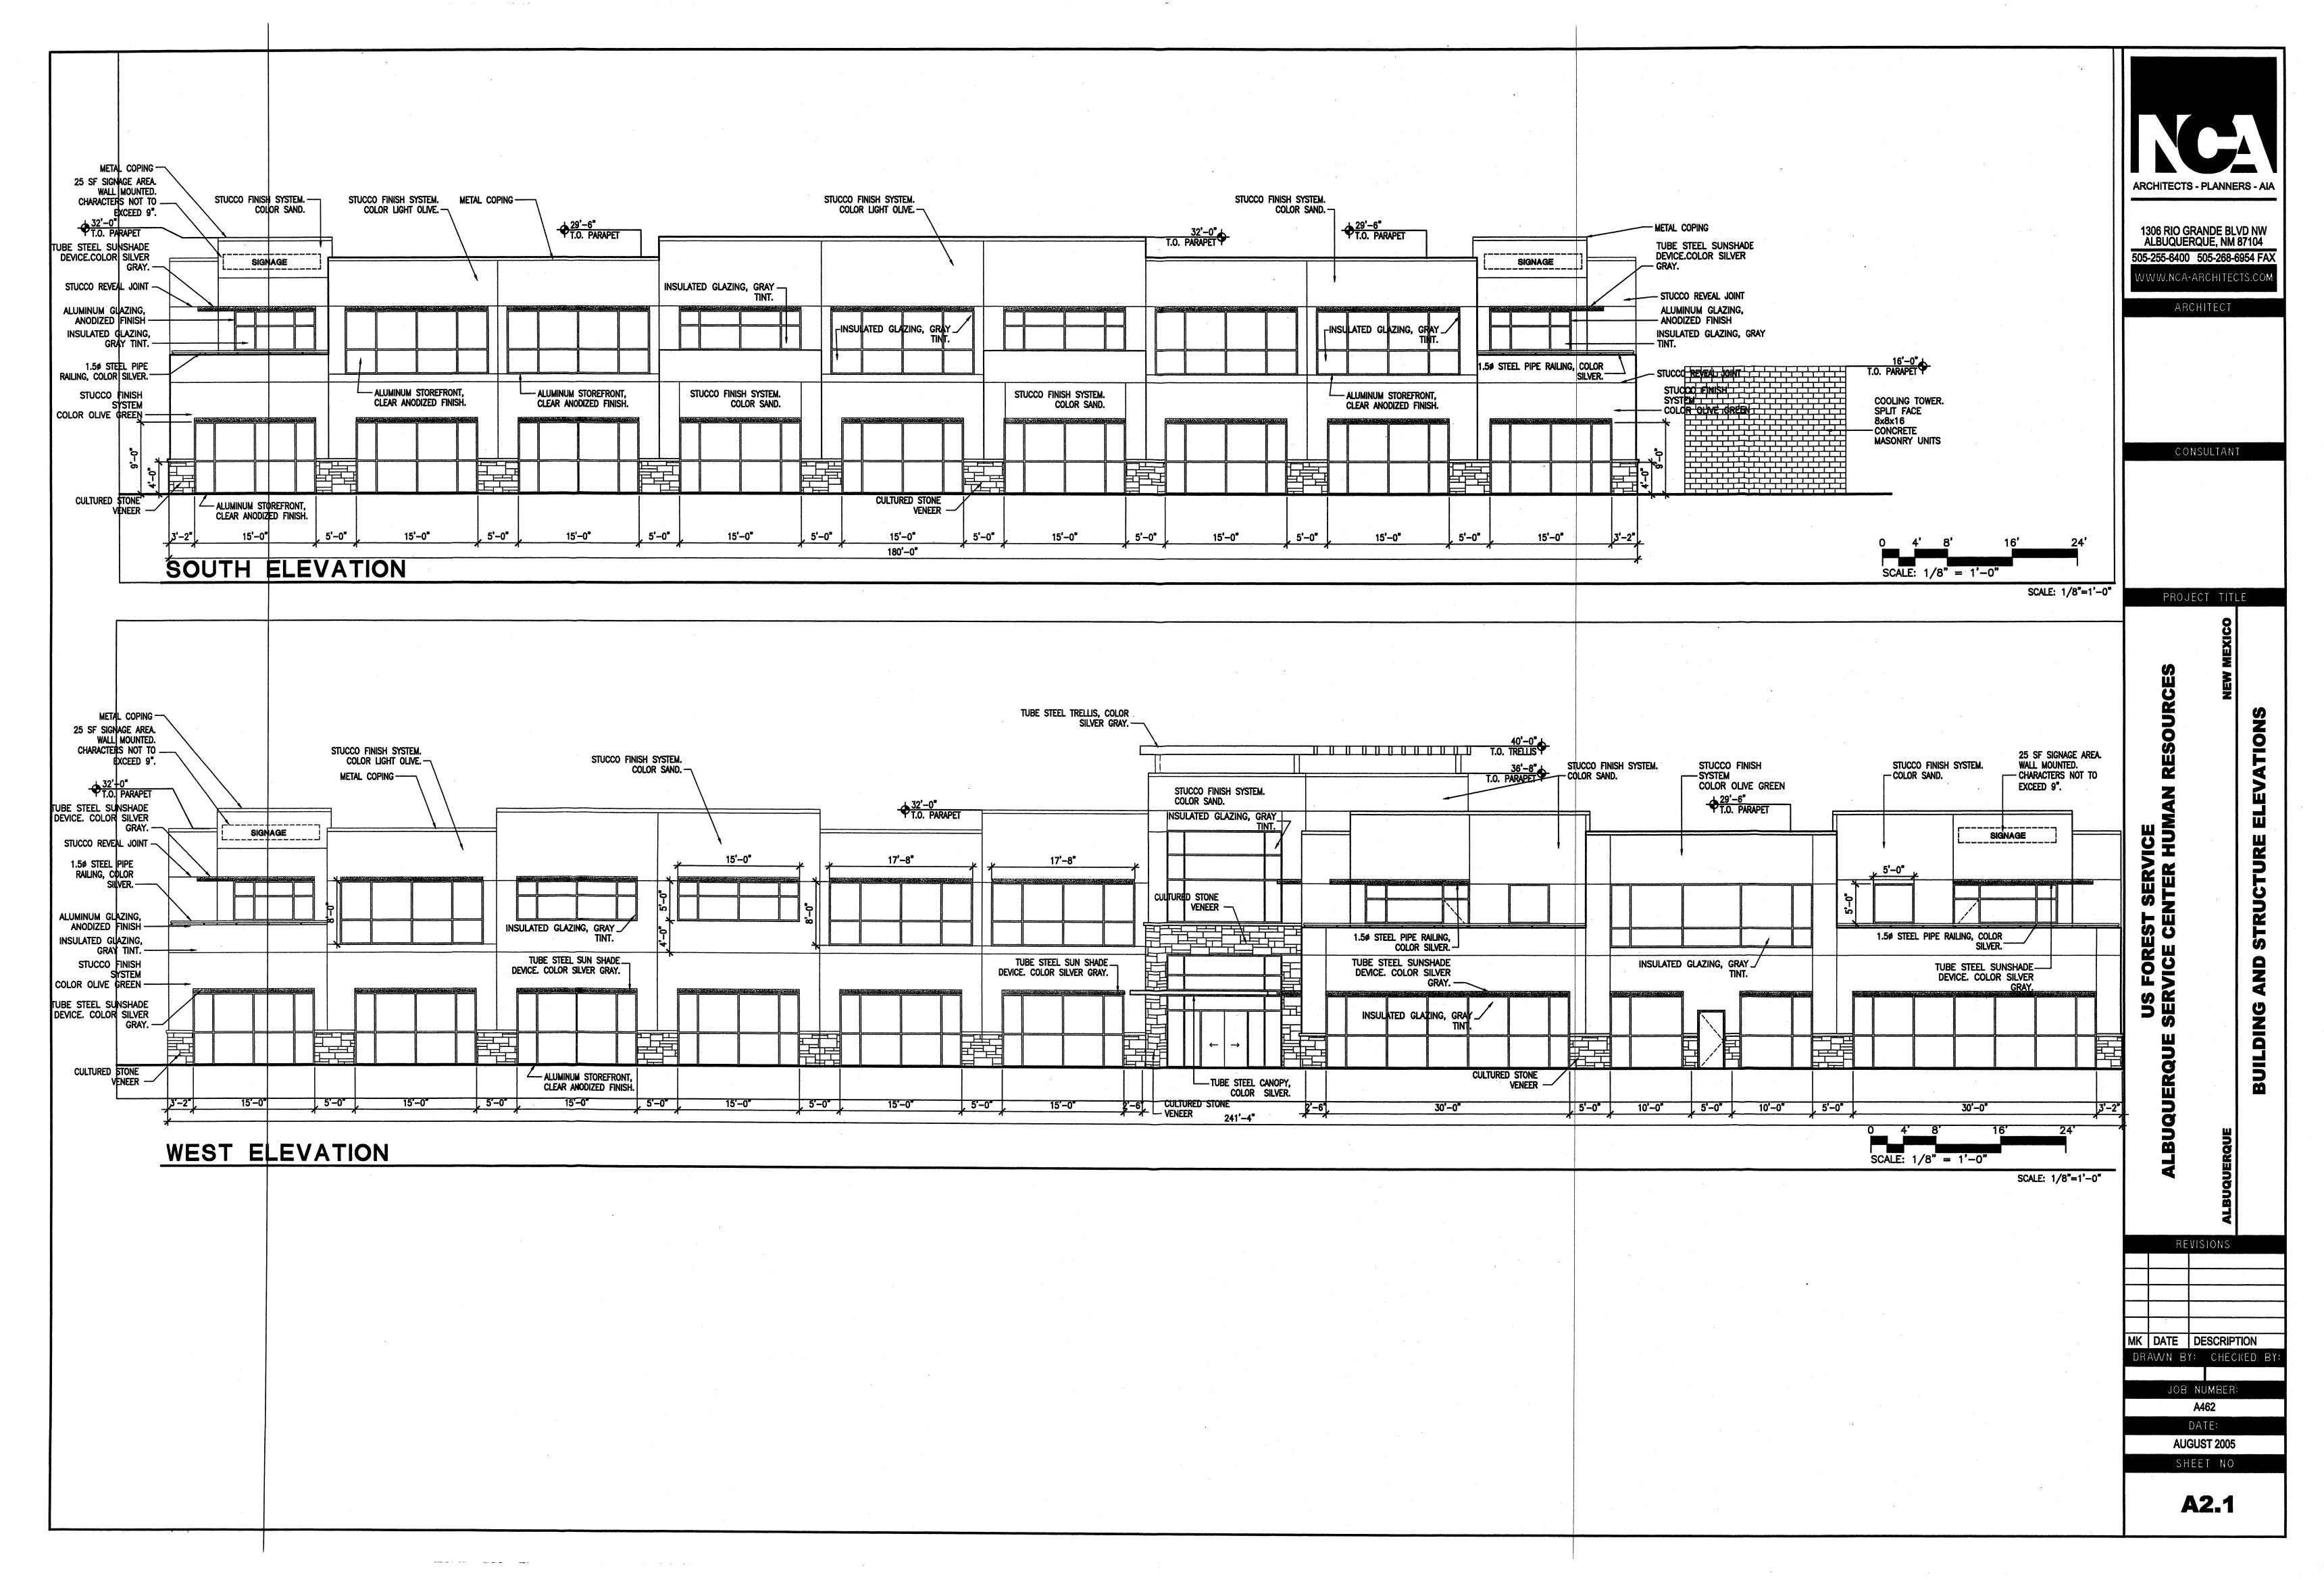

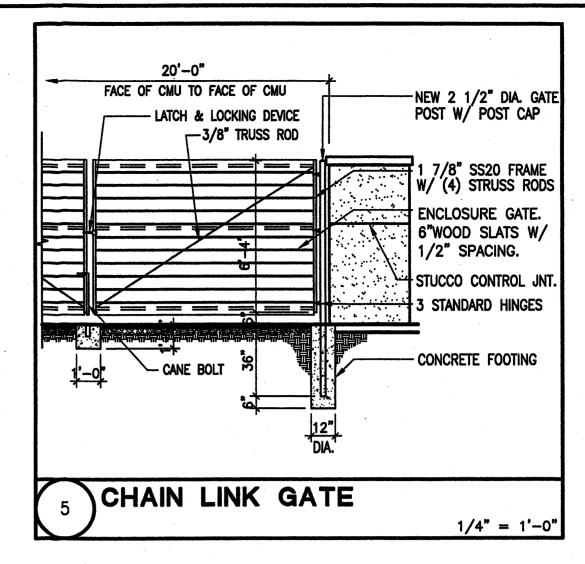



CONSULTANT

PROJECT TITLE

ALL SPLIT FACE MASONRY UNITS AND STUCCO COLORS TO MATCH AND HARMONIZE WITH THE BUILDING'S OVERALL COLOR SCHEME.

MASTHEAD OFFICE COMPLEX
AT JOURNAL CENTER 2
BUQUERQUE

MK DATE DESCRIPTION

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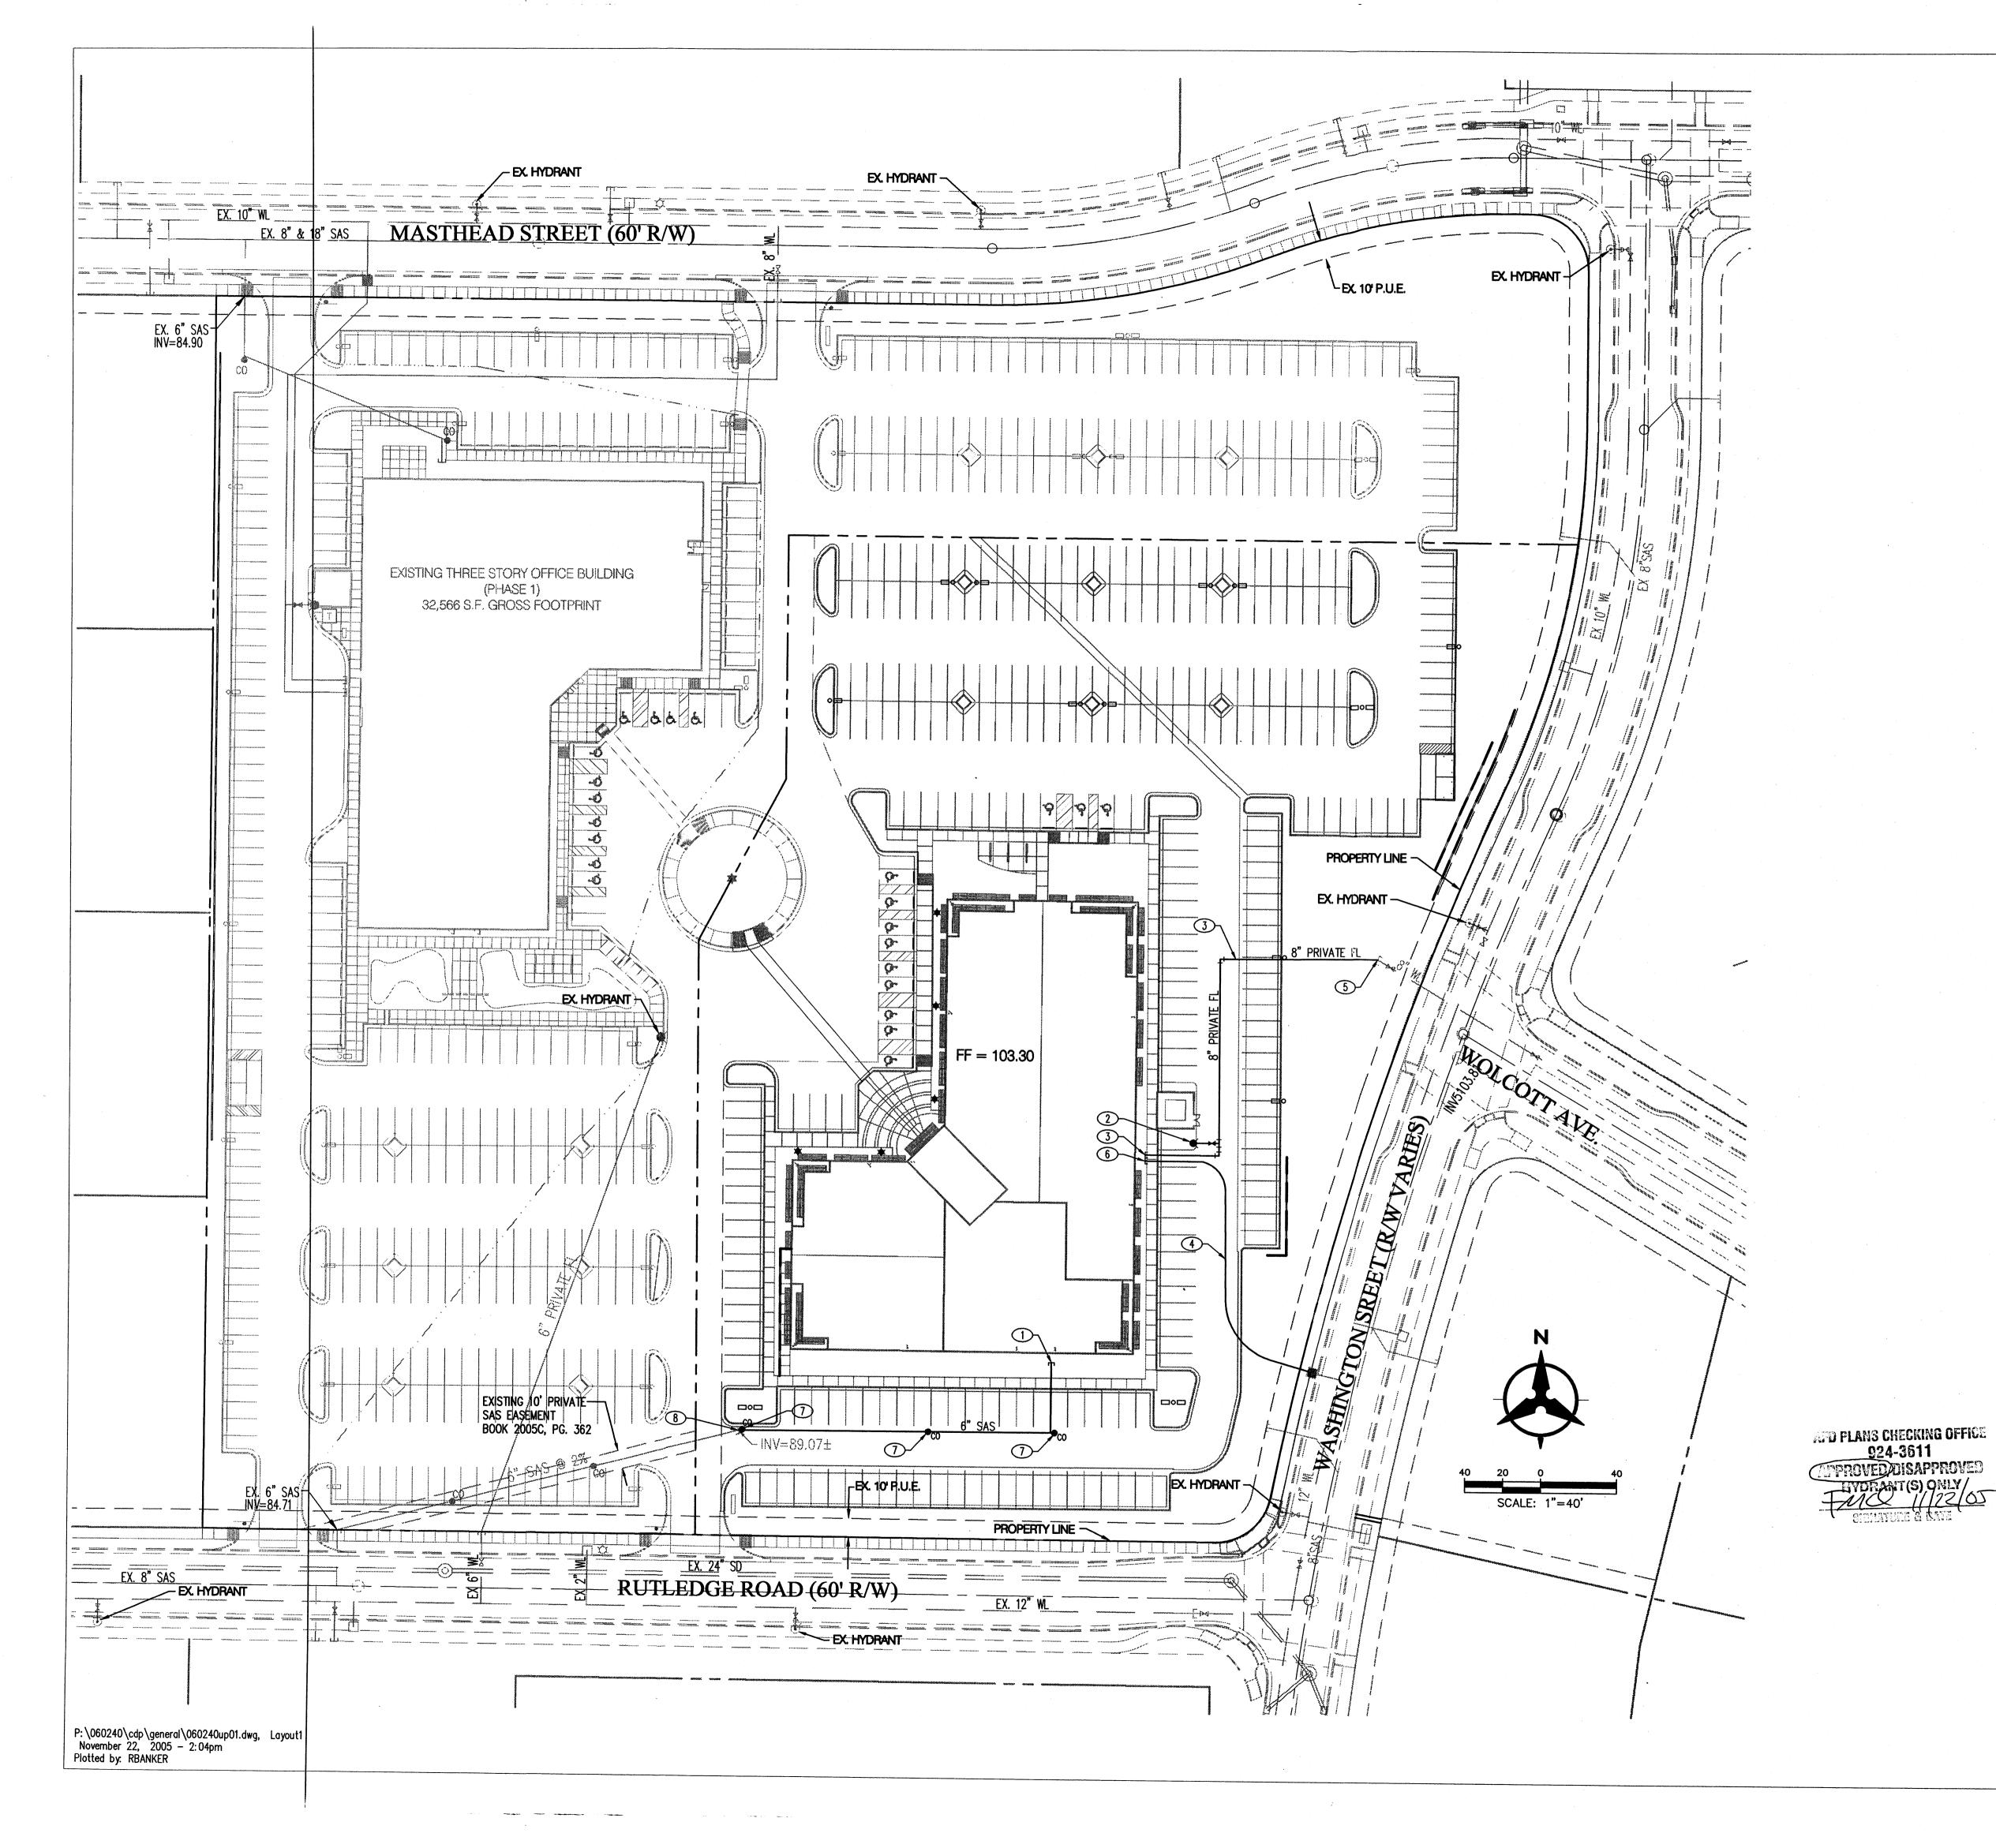
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DATE:

NOVEMBER 2005

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<u>UTILITY NOTES</u>

- 1. THIS CONTRACTOR SHALL BE RESPONSIBLE FOR THE COMPLETE INSTALLATION OF ALL WORK RELATED TO MECHANICAL UTILITIES AS SHOWN ON THIS PLAN INCLUDING: TRENCHING, BACKFILL, SUPPORTS, CLEANOUT PADS, SERVICE STOPS AND BOXES, SERVICE LINES, TESTING, CLEANING, AND STERILIZING. ANY WORK NOT ACCEPTED BY THE ARCHITECT OR ENGINEER DUE TO IMPROPER WORKMANSHIP OR LACK OF PROPER COORDINATION SHALL BE REMOVED AND CORRECTLY INSTALLED AT THE CONTRACTOR'S EXPENSE, AS DIRECTED.
- 2. MINIMUM DEPTHS OF COVER SHALL BE: 36" FOR WATERLINES AND 48" FOR SEWER, EXCEPT AT BUILDING CONNECTION.
- 3. ALL WORK DETAILED ON THESE PLANS TO BE PERFORMED UNDER CONTRACT SHALL, EXCEPT AS OTHERWISE STATED OR PROVIDED OF HEREON, BE CONSTRUCTED IN ACCORDANCE WITH THE IAPMO UNIFORM PLUMBING CODE, LATEST EDITION.
- 4. UTILITY LINES SHALL BE INSTALLED PRIOR TO PAVEMENT, CURB AND GUTTER, AND/OR SIDEWALK, AS APPLICABLE
- 5. ROUGH GRADING OF SITE (±0.5') SHALL BE COMPLETED PRIOR TO INSTALLATION OF UTILITY LINES.
- 6. CONTRACTOR WILL BE RESPONSIBLE FOR CONNECTIONS TO BUILDING DRAIN LINES AND ALL NECESSARY FITTINGS.
- 7. ALL VALVES SHALL BE ANCHORED PER COA STANDARD DWG. 2333.
- 8. FIRE LINES SHALL USE PIPE MATERIALS UNDERWRITERS LABORATORIES LISTED AND APPROVED FOR FIRE SERVICE.
- 9. CONTRACTOR SHALL BE RESPONSIBLE FOR ALL WATER METER, FIRE LINE, AND SEWER HOOKUP FEES FOR INSTALLATIONS. OWNER SHALL BE RESPONSIBLE FOR UTILITY EXPANSION CHARGES, PRORATA AND OTHER SPECIAL ASSESSMENTS.
- 10. CONTRACTOR SHALL VERIFY INVERTS AND LOCATIONS OF EXISTING WATER/SAS LINES PRIOR TO BEGINNING WORK. ALL CONFLICTS SHALL BE BROUGHT TO ATTENTION OF THE ENGINEER AND RESOLVED PRIOR TO BEGINNING WORK.

UTILITY KEYED NOTES

- 1. 6" SANITARY SEWER STUB
- 2. NEW PRIVATE FIRE HYDRANT
- 3. 8" PRIVATE FIRE LINE SERVICE FOR BUILDING SPRINKLERS.
 BACKFLOW PREVENTER TO BE INSTALLED INSIDE MECHANICAL ROOM.
 FDC TO BE LOCATED ON BUILDING WALL.
- 4. NEW 1 1/2" METERED WATER SERVICE. CONNECT TO EXISTING 2" WATER LINE STUB OUT.
- 5. CONNECTION TO EXISTING 8" FIRE LINE STUB
- 6. NEW 1 1/2" DOMESTIC WATER SERVICE TO BUILDING, BACKFLOW PREVENTER SHALL BE INSIDE MECHANICAL ROOM.
- 7. SANITARY SEWER CLEANOUT
- 8. CONNECT TO EX. 6" SAS STUB PROVIDED TO SITE WITH PHASE 1.

<u>LEGEND</u>

	PROPERTY LINE
EX. 8" SAS	EX SANITARY SEWER & MANH
EX. 24" SD ()	EX STORM DRAIN & MANHOLE
	EX INLET
EX. 12" W	EX WATER LINE
*	EX VALVE
	EX METER
E	EX FIRE HYDRANT
X [*] X	EX STREET LIGHT
SAS	PROPOSED SANITARY SEWER
● co	PROPOSED CLEANOUT

Bohannan 📤 Huston 🗈

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ENGINEERING & SPATIAL DATA & ADVANCED TECHNOLOGIES

---- PROPOSED WATERLINE

1306 RIO GRANDE BLVD NW ALBUQUERQUE, NM 87104 505-255-6400 505-268-6954 FAX WWW.NCA-ARCHITECTS.COM

ARCHITECT

CONSULTANT

PROJECT TITLE

XICO

SXIN MIN

ASTHEAD OFFICE COMPLEX
AT JOURNAL CENTER 2

BUILDING PER

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ALBUQUER

REVISIONS

MK DATE DESCRIPTION

DRAWN BY: CHECKED BY

RWB JTW

JOB NUMBER:

A0559

DATE:
NOVEMBER 2005
SHEET NO

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