

11.

11.00

UTILITY NOTES

1. THIS CONTRACTOR SHALL BE RESPONSIBLE FOR THE COMPLETE INSTALLATION OF ALL WORK RELATED TO MECHANICAL UTILITIES AS SHOWN ON THIS PLAN INCLUDING: TRENCHING, BACKFILL, SUPPORTS, CLEANOUT PADS, SERVICE STOPS AND BOXES, SERVICE LINES, TESTING, CLEANING, AND STERILIZING. ANY WORK NOT ACCEPTED BY THE ARCHITECT OR ENGINEER DUE TO IMPROPER WORKMANSHIP OR LACK OF PROPER COORDINATION SHALL BE REMOVED AND CORRECTLY INSTALLED AT THE CONTRACTOR'S EXPENSE, AS

2. MINIMUM DEPTHS OF COVER SHALL BE: 36" FOR WATERLINES AND 48" FOR SEWER, EXCEPT AT BUILDING CONNECTION.

3. ALL WORK DETAILED ON THESE PLANS TO BE PERFORMED UNDER CONTRACT SHALL, EXCEPT AS OTHERWISE STATED OR PROVIDED OF HEREON, BE CONSTRUCTED IN ACCORDANCE WITH THE IAPMO UNIFORM PLUMBING CODE, LATEST EDITION.

4. UTILITY LINES SHALL BE INSTALLED PRIOR TO PAVEMENT, CURB AND GUTTER, AND/OR SIDEWALK, AS APPLICABLE.

5. ROUGH GRADING OF SITE (±0.5") SHALL BE COMPLETED PRIOR TO INSTALLATION OF UTILITY LINES.

6. CONTRACTOR WILL BE RESPONSIBLE FOR CONNECTIONS TO BUILDING DRAIN LINES AND ALL NECESSARY FITTINGS.

7. ALL VALVES SHALL BE ANCHORED PER COA STANDARD DWG. 2333.

8. FIRE LINES SHALL USE PIPE MATERIALS UNDERWRITERS LABORATORIES LISTED AND APPROVED FOR FIRE SERVICE.

9. CONTRACTOR SHALL BE RESPONSIBLE FOR ALL WATER METER, FIRE LINE, AND SEWER HOOKUP FEES FOR INSTALLATIONS. OWNER SHALL BE RESPONSIBLE FOR UTILITY EXPANSION CHARGES, PRORATA AND OTHER SPECIAL ASSESSMENTS.

10. CONTRACTOR SHALL VERIFY INVERTS AND LOCATIONS OF EXISTING WATER/SAS LINES PRIOR TO BEGINNING WORK. ALL CONFLICTS SHALL BE BROUGHT TO ATTENTION OF THE ENGINEER AND RESOLVED PRIOR TO BEGINNING WORK.

UTILITY KEYED NOTES

- 1. 6" SANITARY SEWER STUB, SEE PLUMBING PLANS FOR CONTINUATION.
- 2. NEW PRIVATE FIRE HYDRANT PER COA STD DWG 2340.

3. 8" PRIVATE FIRE LINE SERVICE FOR BUILDING SPRINKLERS.
BACKFLOW PREVENTER TO BE INSTALLED INSIDE MECHANICAL ROOM.
FDC TO BE LOCATED ON BUILDING WALL. FIRE LINE PIPE JOINTS AND MECHANICAL JOINTS SHALL BE RESTRAINED FOR ENTIRE LENGTH.
PROVIDE 3' MINIMUM COVER, VERTICAL BENDS AS REQUIRED (NOT > 22.5°).

4. NEW 2 1/2" METERED WATER SERVICE. CONNECT TO EXISTING 2" WATER LINE STUB OUT.

5. CONNECTION TO EXISTING 8" FIRE LINE STUB.

6. NEW 2 1/2" DOMESTIC WATER SERVICE TO BUILDING, BACKFLOW PREVENTER SHALL BE INSIDE MECHANICAL ROOM.

7. SANITARY SEWER CLEANOUT.

8. CONNECT TO EX. 6" SAS STUB PROVIDED TO SITE WITH PHASE 1

9. POST INDICATOR VALVE.

10. EXISTING 1 1/2" WATER SERVICE LINE AND METER BOX. CONTRACTOR SHALL COORDINATE AND PAY FOR CITY INSTALLATION OF METER.

11. 8"X6" TEE AND 8"X6" REDUCER.

12. NEW 1" WATER LINE FOR MAKE-UP WATER TO COOLING TOWER SEE PLUMBING PLANS.

13. NEW 4"SAS SEE PLUMBING PLANS FOR INVERTS AND CONTINUATION.

14. 12"x6" TAPPING SLEEVE & 6" GATE VALVE.

15. REMOTE FDC.

LEGEND

	PROPERTY LINE
EX. 8" SAS	EX SANITARY SEWER & MANHOLE
EX. 24"_SD	EX STORM DRAIN & MANHOLE
	ex inlet
EX. 12" WL	EX WATER LINE
7.	EX VALVE
C)	EX METER
€	EX FIRE HYDRANT
Q	ex street light
SAS	PROPOSED SANITARY SEWER
● _{co}	PROPOSED CLEANOUT
WL	PROPOSED WATERLINE

Bohannan A Huston

Courtyard I 7500 Jefferson St. NE Albuquerque, NM 87109-4335

ENGINEERING A SPATIAL DATA ADVANCED TECHNOLOGIES

ARCHITECTS - PLANNERS - AIA

1306 RIO GRANDE BLVD NW ALBUQUERQUE, NM 87104 505-255-6400 505-268-6954 FAX WWW.NCA-ARCHITECTS.COM

ARCHITECT

CONSULTANT

USFS
PHASE II
ALBUQUERQUE
SERVICE CENTER

HUMAN

RESOURCES

NEW MEXICO

PROJECT TITLE

ALBUQUERQUE

ηL	MISTOMS

MK DATE DESCRIPTION

DRAWN BY: CHECKED B

PROJECT NUMBER:

A10.08
DATE:


JUNE 17, 2010 SHEET TITLE:


CONCEPTUAL

UTILITY PLAN

SHEET NO:

C3.0

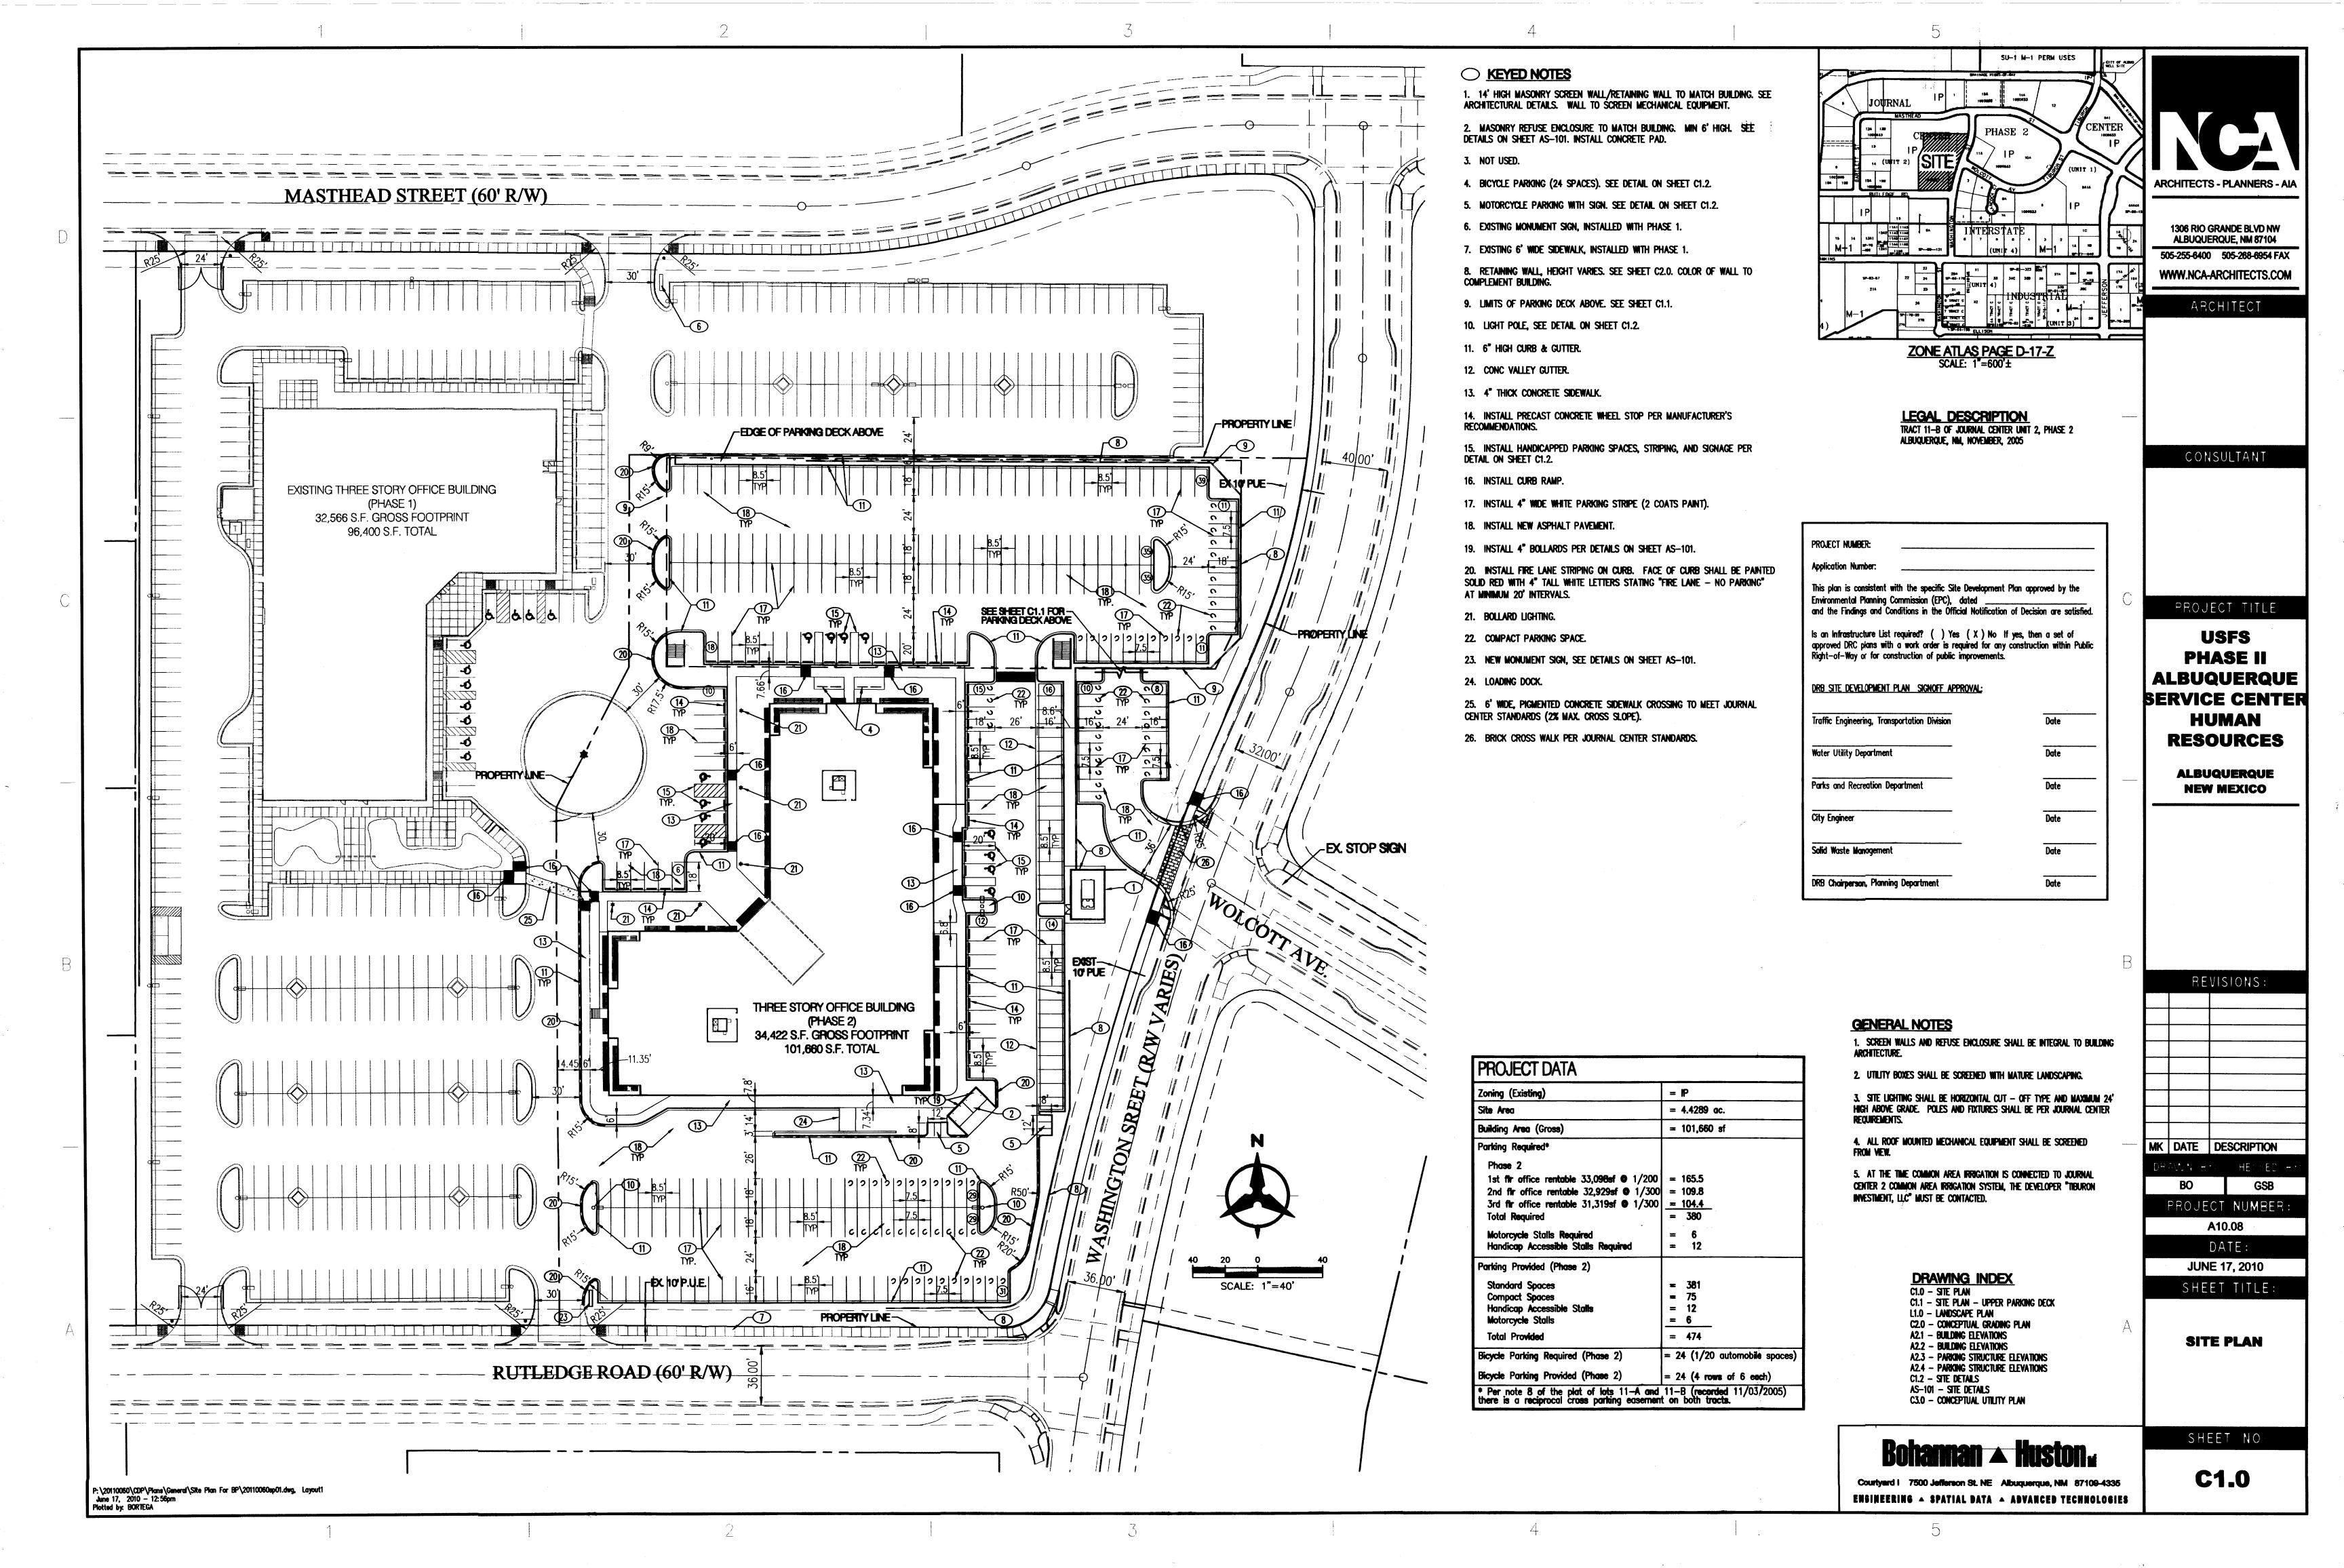

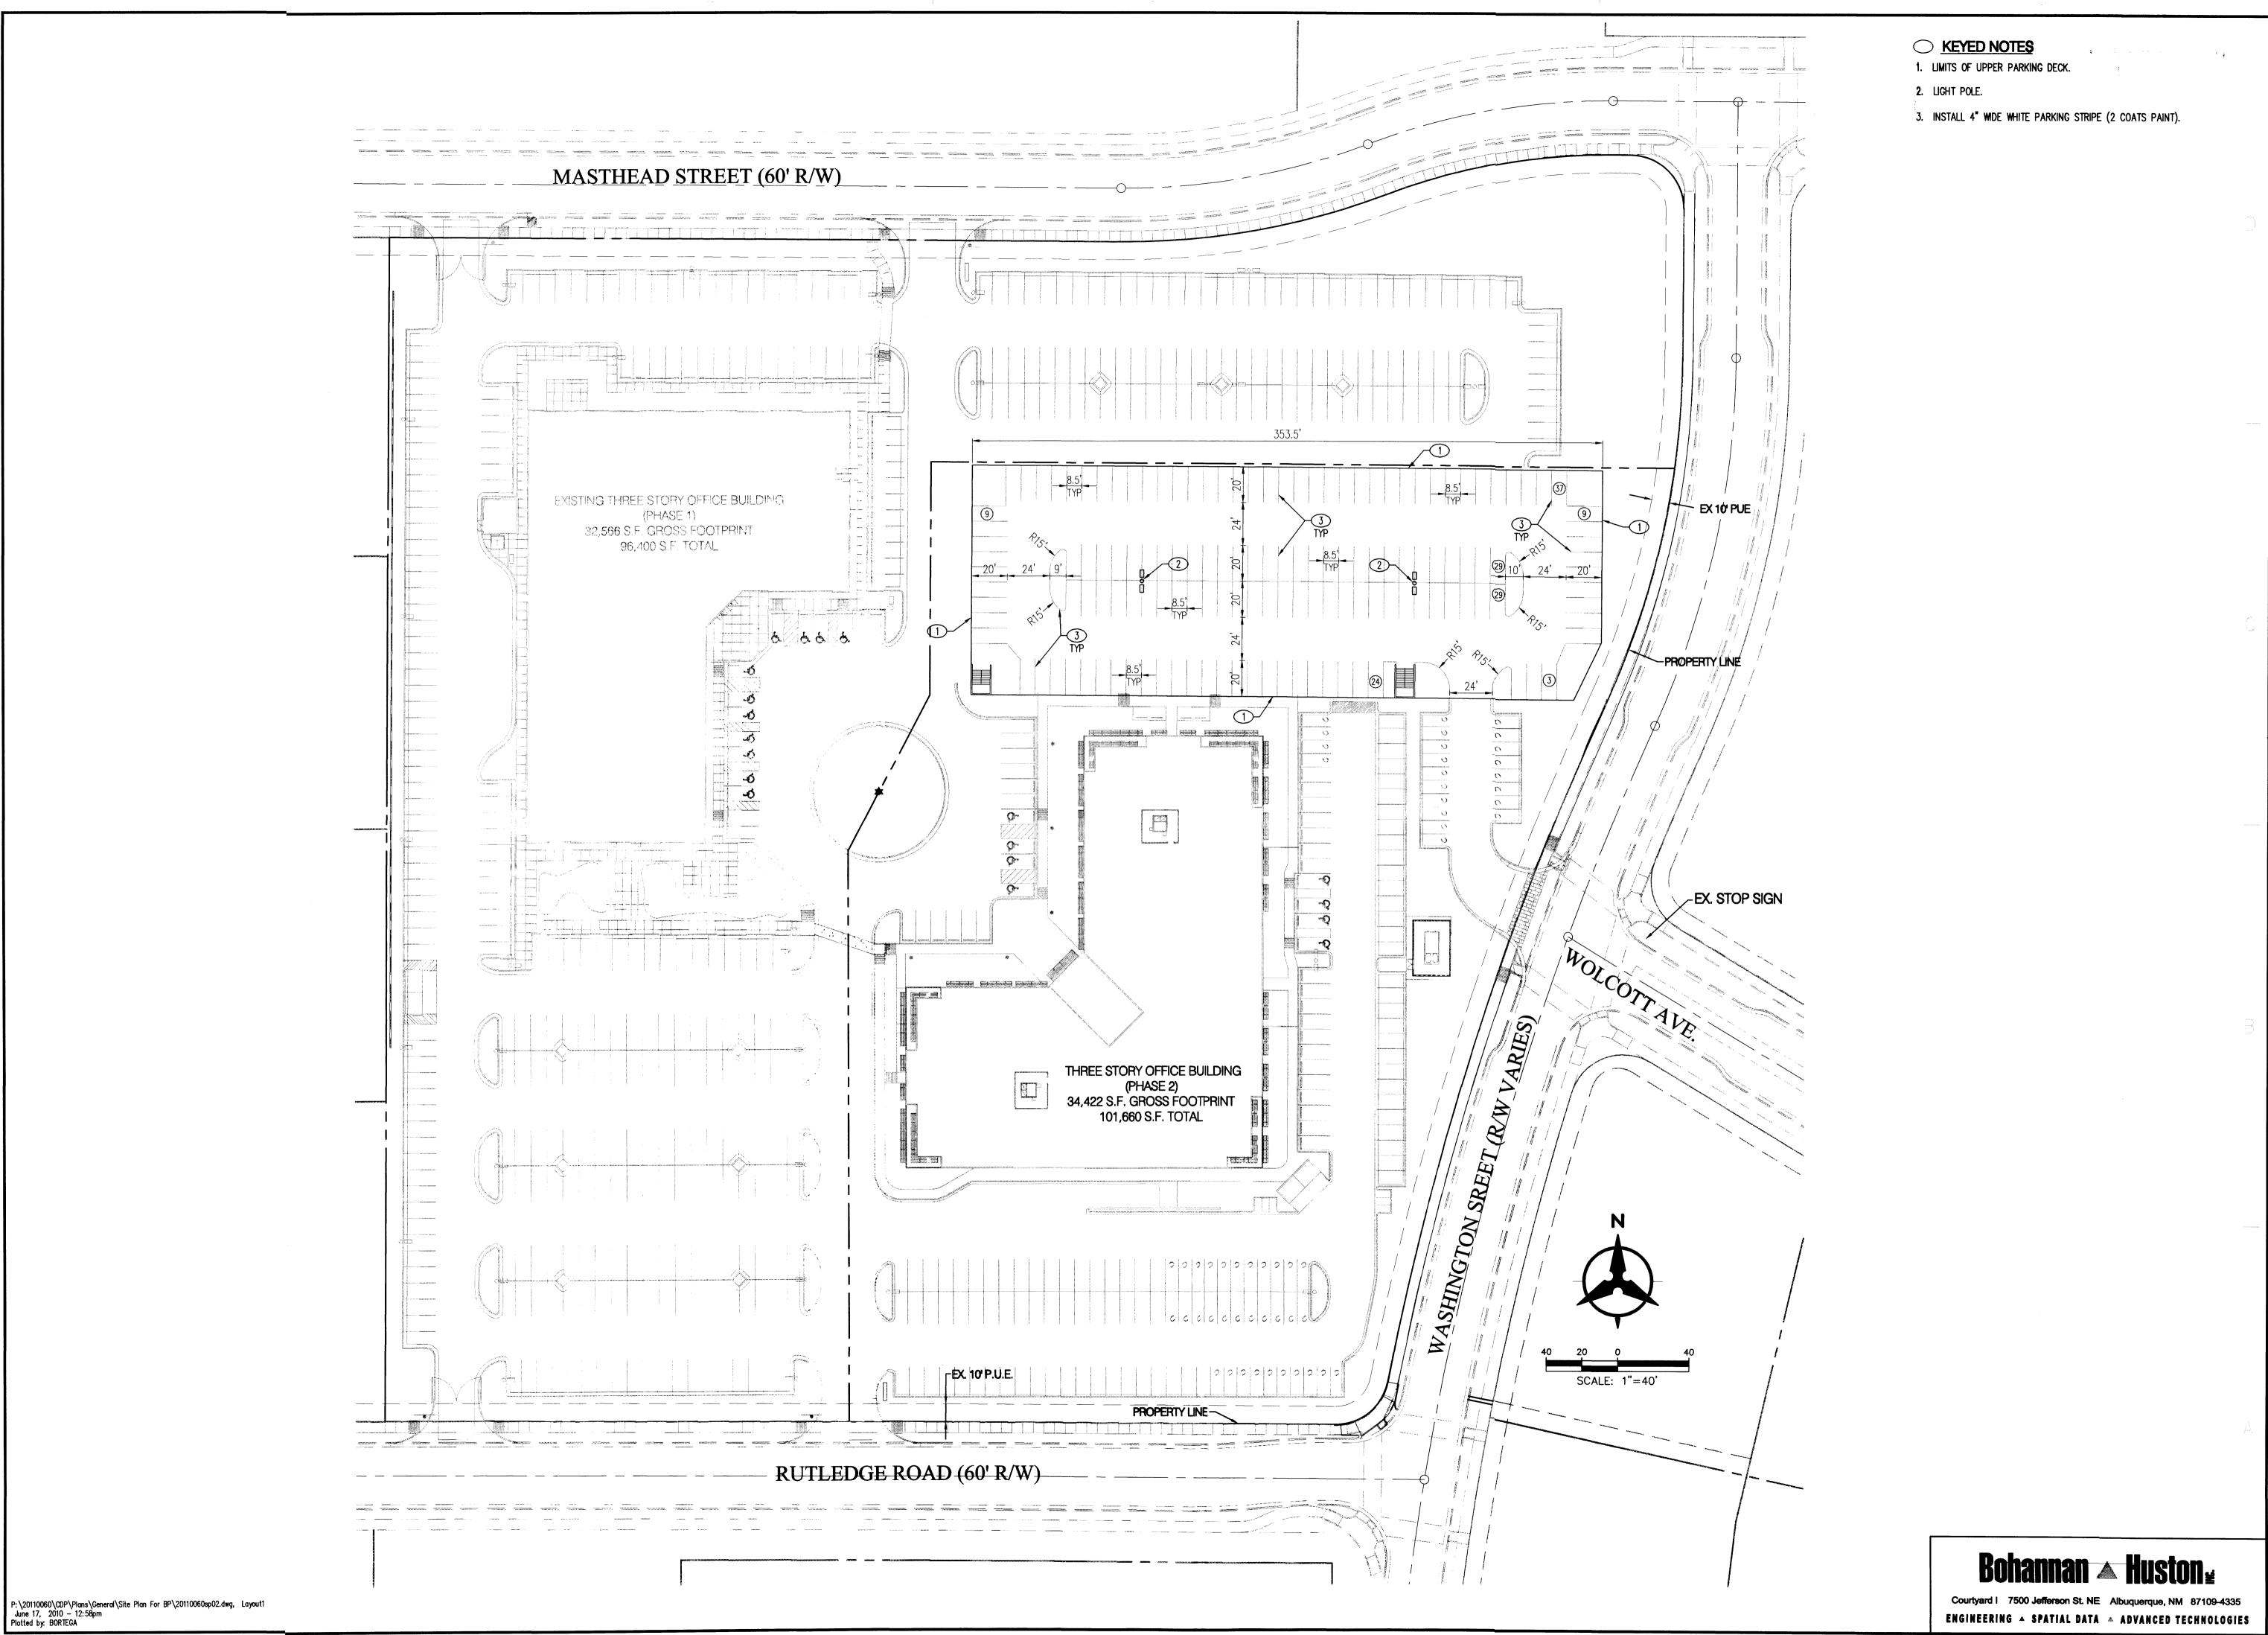

11

ARCHITECTS - PLANNERS - AIA

1306 RIO GRANDE BLVD NW ALBUQUERQUE, NM 87104 505-255-6400 505-268-6954 FAX WWW.NCA-ARCHITECTS.COM

ARCHITECT

CONSULTANT

PROJECT TITLE

USFS
PHASE II
ALBUQUERQUE
SERVICE CENTER
HUMAN
RESOURCES

ALBUQUERQUE NEW MEXICO

REVISIONS:

MK DATE DESCRIPTION

BO GSB

PROJECT NUMBER:


DATE: JUNE 17, 2010

SHEET TITLE:

SITE PLAN UPPER PARKING DECK

SHEET NO:

C1.1

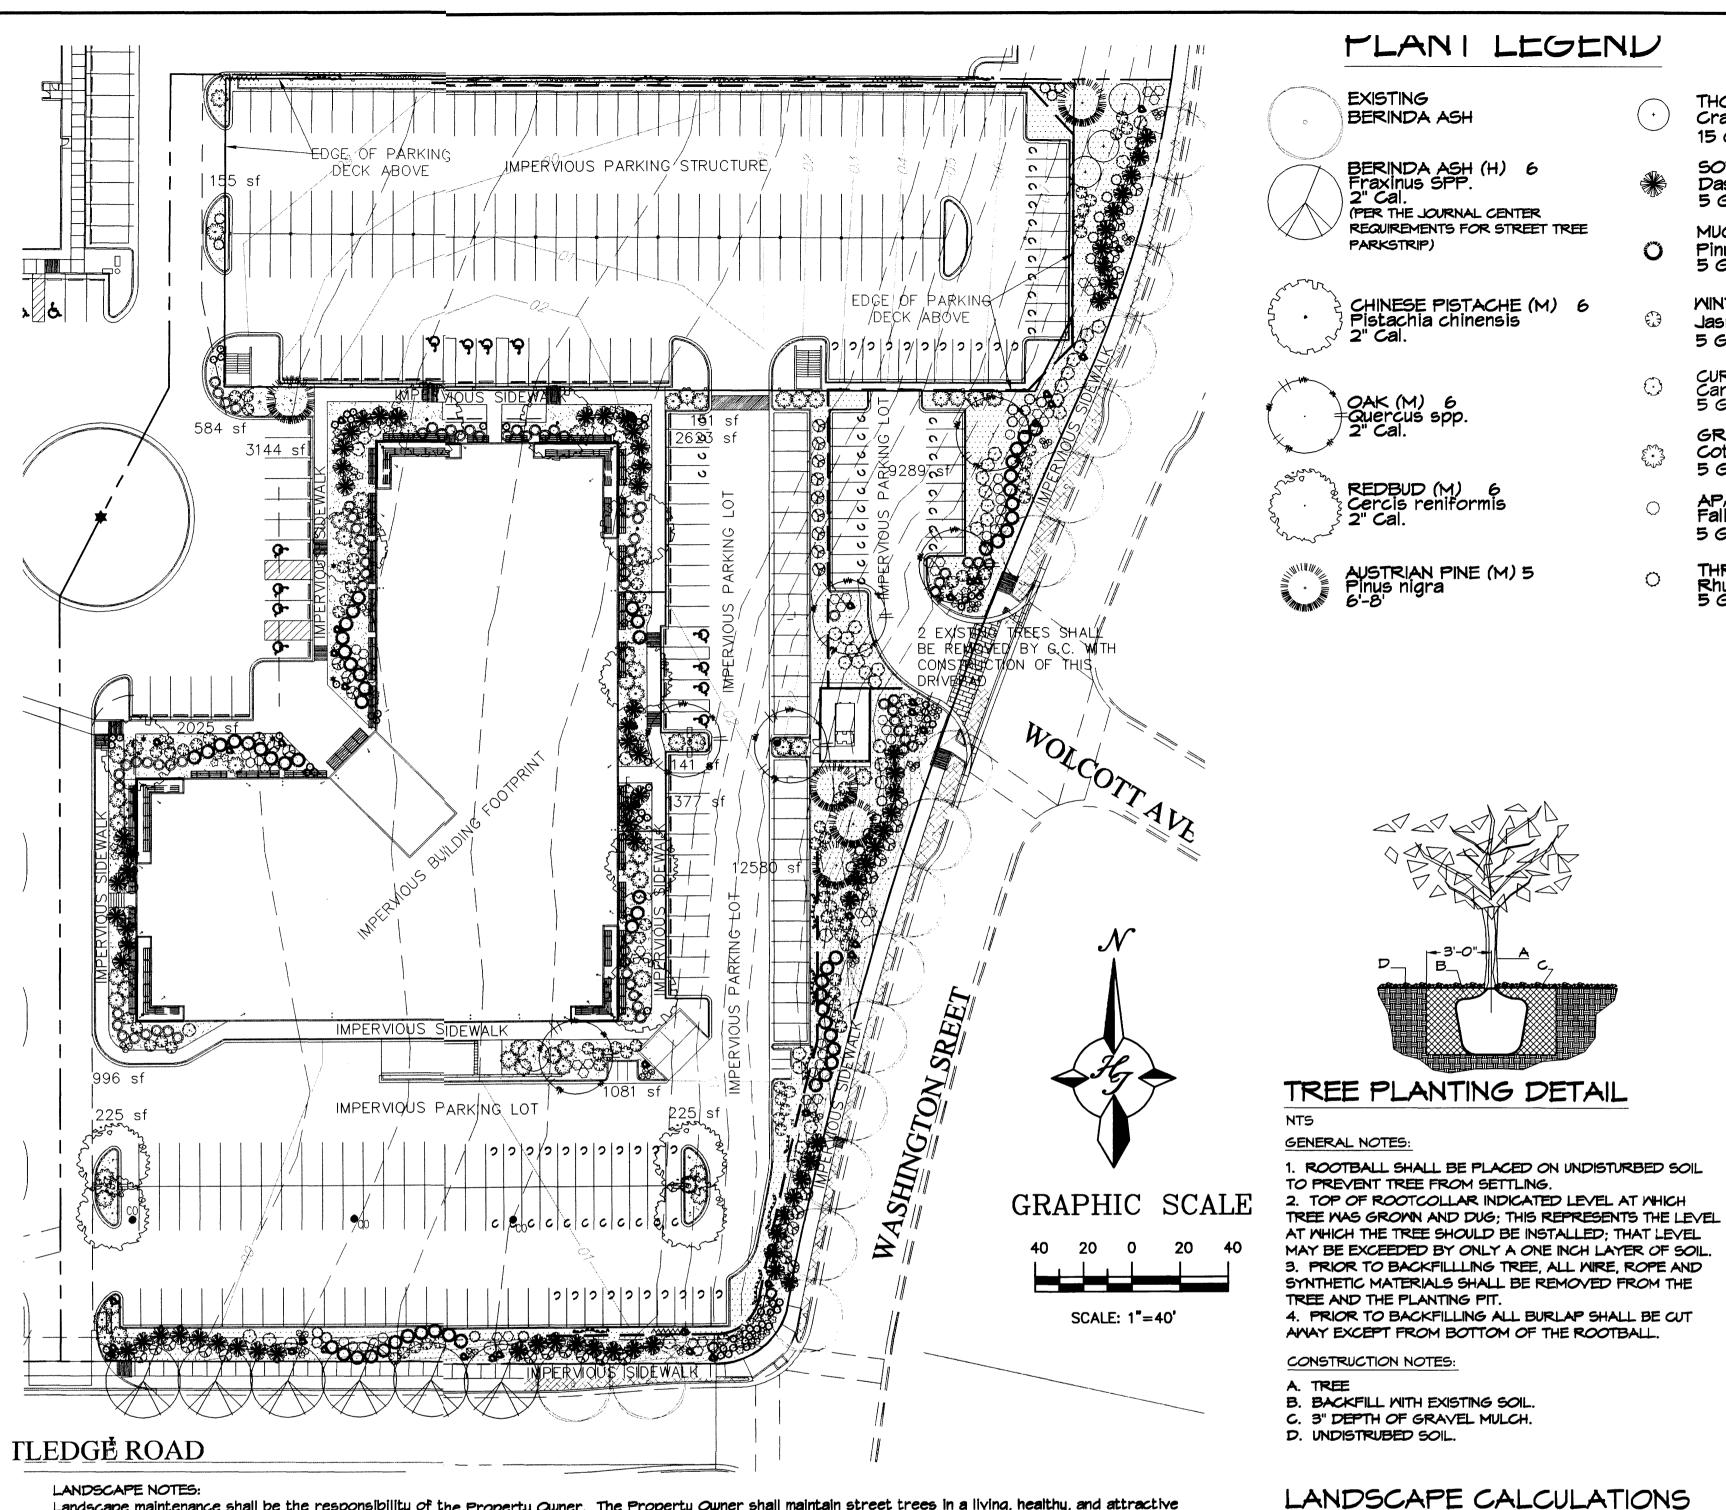

LANDSCAPE NOTES: Landscape maintenance shall be the responsibility of the Property Owner. The Property Owner shall maintain street trees in a living, healthy, and attractive

It is the intent of this plan to comply with the City Of Albuquerque Water Conservation Landscaping and Water Waste Ordinance planting restriction approach. Approval of this plan does not constitute or imply exemption from water waste provisions of the Water Conservation Landscaping and Water Waste Ordinance.

Water management is the sole responsibility of the Property Owner. All landscaping will be in conformance with the City of Albuquerque Zoning Code, Street Tree Ordinance, Pollen Ordinance, and Mater Conservation Landscaping and Mater Maste Ordinance. In general, water conservative, environmentally sound landscape principles will be followed in design and installation.

Plant beds (pervious area) shall achieve 75% live ground cover at maturity.

Santa Ana Tan Gravel over Filter Fabric to a minimum depth of 3" shall be placed in all Pervious landscape areas which are not designated to receive native

IRRIGATION NOTES FOR PHASE 2: Irrigation shall be a complete underground system with Trees to receive 1 Netafim spiral (50' length) with 3 loops at a final radius of 4.5' from tree trunk, pinned in

place. Netafim shall have emitters 12" o.c. with a flow of .6 gph. Shrubs to receive (2) 1.0 GPH Drip Emitters. Drip and Bubbler systems to be tied to 1/2" polypipe with flush caps at each end. Trees and shrubs shall be on separate valves.

Common area irrigation shall be tied to the Master C.Journal Center 2 common area irrigation system. Contact the developer, Tiburon Investment LLC at 797-2566

Run time per each shrub drip valve will be approximately 15 minutes per day. Tree drip valve shall run 1.5 hours, 3 times per week. Run time will be adjusted according to the season.

Point of connection for irrigation system is unknown at current time and will be coordinated in the field. Irrigation will be operated by automatic controller.

Location of controller to be field determined and power source for controller to be provided by others.

Irrigation maintenance shall be the responsibility of the Property Owner.

Water and Power source shall be the responsibility of the Developer/Builder.

PHASE ONE IRRIGATION NOTES:

Irrigation is a complete underground system with Trees supplied with (5) 1.0 GPH Drip Emitters and Shrubs supplied with (2) 1.0 GPH Drip Emitters. Drip and Bubbler systems tied to 1/2" polypipe with flush caps at each end.

TLANI LEGENU

BERINDA ASH

PARKSTRIP)

BERINDA ASH (H) 6 Fraxinus SPP. 2" Cal. (PER THE JOURNAL CENTER REQUIREMENTS FOR STREET TREE

CHINESE PISTACHE (M) 6 Pistachia chinensis

JSTRIAN PINE (M) 5

THORNLESS HAWTHORN (M+) 5 Crataegus crus-galli inermis

SOTOL 75 Dasylirion wheeleri 5 Găl. 36sf

MUGO PINE (M) 57

WINTER JASMINE (L+) 90 Jasminum nudiflorum 5 Gal. 1445f

CURLLEAF MTN MAHOGANY (L) 53 Carcorpus ledfolius 5 Gal. 1005F

GREYLEAF COTONEASTER 60 Cotoneaster buxifolius 5 Gal. 81sf

APACHE PLUME (L) 31 Fallugia paradoxa

THREE-LEAF SUMAC (L) 25 Rhus trilobata 5 Gal. 36sf

ARP ROSEMARY (M) 75 Rosmarinus officianalis 5 Gal. 36sf

POMIS CASTLE SAGE (L) 45 Artimesia x powis castle 5 Gal. 25sf

AUTUMN SAGE (M) 33 Salvia greggii 5 Gal.

LAVENDER (M) 57 _avandula angustifolia 1 Gal. 95f

THREADGRASS (M) 64 Stipa tennuisima 1 Gal. 4sf

WILDFLOWER 52 1 Gal.

ENGLISH IVY (M) 6 Hedera helix 1 *Gal*.

CORAL HONEYSUCKLE (M) 6 Lonicera sempervirens

LADY BANKS ROSE (M) 6 Rosa banksiae

BOULDERS WITH OVERSIZED GRAVEL ACCENT (41)

SANTA FE BROWN GRAVEL MITH FILTER FABRIC

OVERSIZED GRAVEL WITH FILTER FABRIC

EXISTING LANDSCAPING

ARCHITECT

ARCHITECTS - PLANNERS - AIA

1306 RIO GRANDE BLVD NW

ALBUQUERQUE, NM 87104

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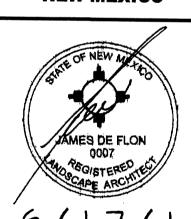
CONSULTANT LANDSCAPE ARCHITECTS & CONTRACTOR Cont. Lic. #26458 7909 Edith N.E.

Albuquerque, NM 87184 Ph. (505) 898-9690 Fax (505) 898-7737 cmj@hilltoplandscaping.com All creative ideas contained Herein remains the property of The Hilliop Landscape Architects and contractors and are protected by copyright lews. This is original design and coust not be released or copied unless applicable fees have been paid or job order placed.

PROJECT TITLE

USFS PHASE II **ALBUQUERQUE** SERVICE CENTER HUMAN RESOURCES

> **ALBUQUERQUE NEW MEXICO**



6/17/10

REVISIONS: 3 6-17-10 site revision -cmi 2 6-4-10 site revision -cmi

MK DATE DESCRIPTION DRAWN BY: CHECKED B

5-17-06 site revision -adf

PROJECT NUMBER: A10.08

> DATE: **JUNE 17 2010**


SHEET TITLE:

LANDSCAPING PLAN

TOTAL PHASE 2 AREA sauare feet

IDIAL PHASE 2 AREA	1903 10	square feet
TOTAL PHASE 2 BUILDING AREA	34422	square feet
NET LOT AREA	155948	square feet
LANDSCAPE REQUIREMENT	15%	•
TOTAL LANDSCAPE REQUIREMENT	23392	square feet
TOTAL BED PROVIDED	34596 (22%)	square feet
GROUNDCOVER REQ.	75%	square feet
TOTAL GROUNDCOVER REQUIREMENT	25947	square feet
TOTAL GROUNDCOVER PROVIDED	25972 (75%)	square feet
TOTAL PONDING AREA		square feet
TOTAL SOD AREA	0	square feet
(max. 20% of landscape required)		•
TOTAL NATIVE SEED AREA	0	square feet
		, , , , , , , , , , , , , , , , , , , ,
TOTAL LANDSCAPE PROVIDED IN PHASE 2	34596 (22%)	square feet

Should The Hilltop not receive a Grading and Drainage plan during the design process or the on site grades differ from the Grading and Drainage plan received, The Hilltop reserves the right to apply slope stabilization materials where the specified gravel will not be suitable. This will be addressed as an infield-change order.

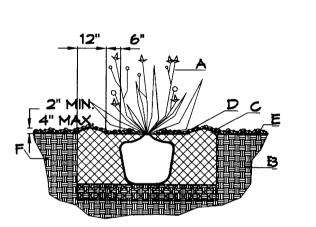

SHRUB PLANTING DETAIL

GENERAL NOTES:

1. THE OUTSIDE DIAMETER OF THE WATER RETENTION BASIN SHALL BE TWICE THE DIAMETER OF THE SHRUB PLANTING PIT.

CONSTRUCTION NOTES:

B. BACKFILL WITH EXISTING SOIL. C. EARTH BERM AROUND WATER RETENTION BASIN.

STREET TREE REQUIREMENTS - Minimum 2" Caliper

Required 8 Provided 8 (6 NEW/2 EXISTING)

PARKING LOT TREE REQUIREMENTS - Minimum 2" Caliper

Shade trees required under the City Of Albuquerque

Street Tree Ordinance are as follows:

Required 16 Provided 16 EXISTING

Parking Lot Tree Ordinance are as follows:

Provided #

Name of Street : RUTLEDGE

Name of Street: WASHINGTON

1 Shade tree per 10 spaces


Required #

Street trees required under the City Of Albuquerque


D. 3" DEPTH OF GRAVEL MULCH.


E. FINISH GRADE.

F. UNDISTURBED SOIL.

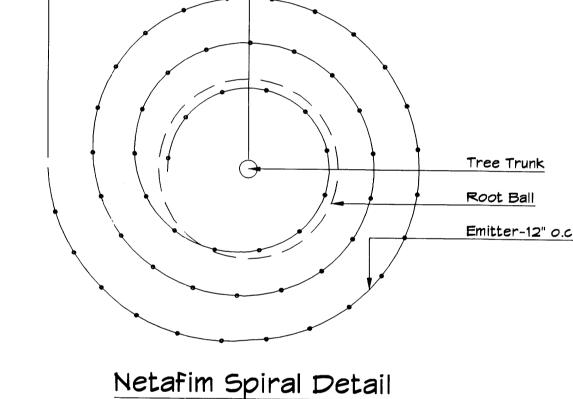

GRAVEL ACCENT DETAIL

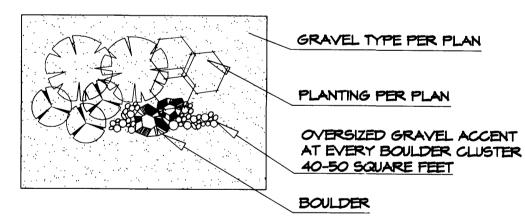

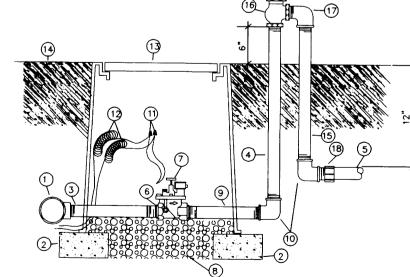

MAINLINE FITTING CMU BLOCK) GALVANIZED NIPPLE) LATERAL PIPE REDUCER BUSHING

24" TO 36" GALVANIZED NIPPLE AUTOMATIC VALVE (SEE LEGEND)) GRAVEL GALVANIZED NIPPLE 10) GALVANIZED ELBOW


VALVE BOX GALVANIZED NIPPLE - 18" TO 24" LENGTH ATMOSPHERIC VACUUM BREAKER GALVANIZED STREET ELL (18) TOE NIPPLE OR MALE ADAPTER

WIRE EXPANSION LOOPS

WATERPROOF WIRE CONNECTOR

AUTOMATIC VALVE W/ ATMOSPHERIC VACUUM BREAKER

SHEET NO:

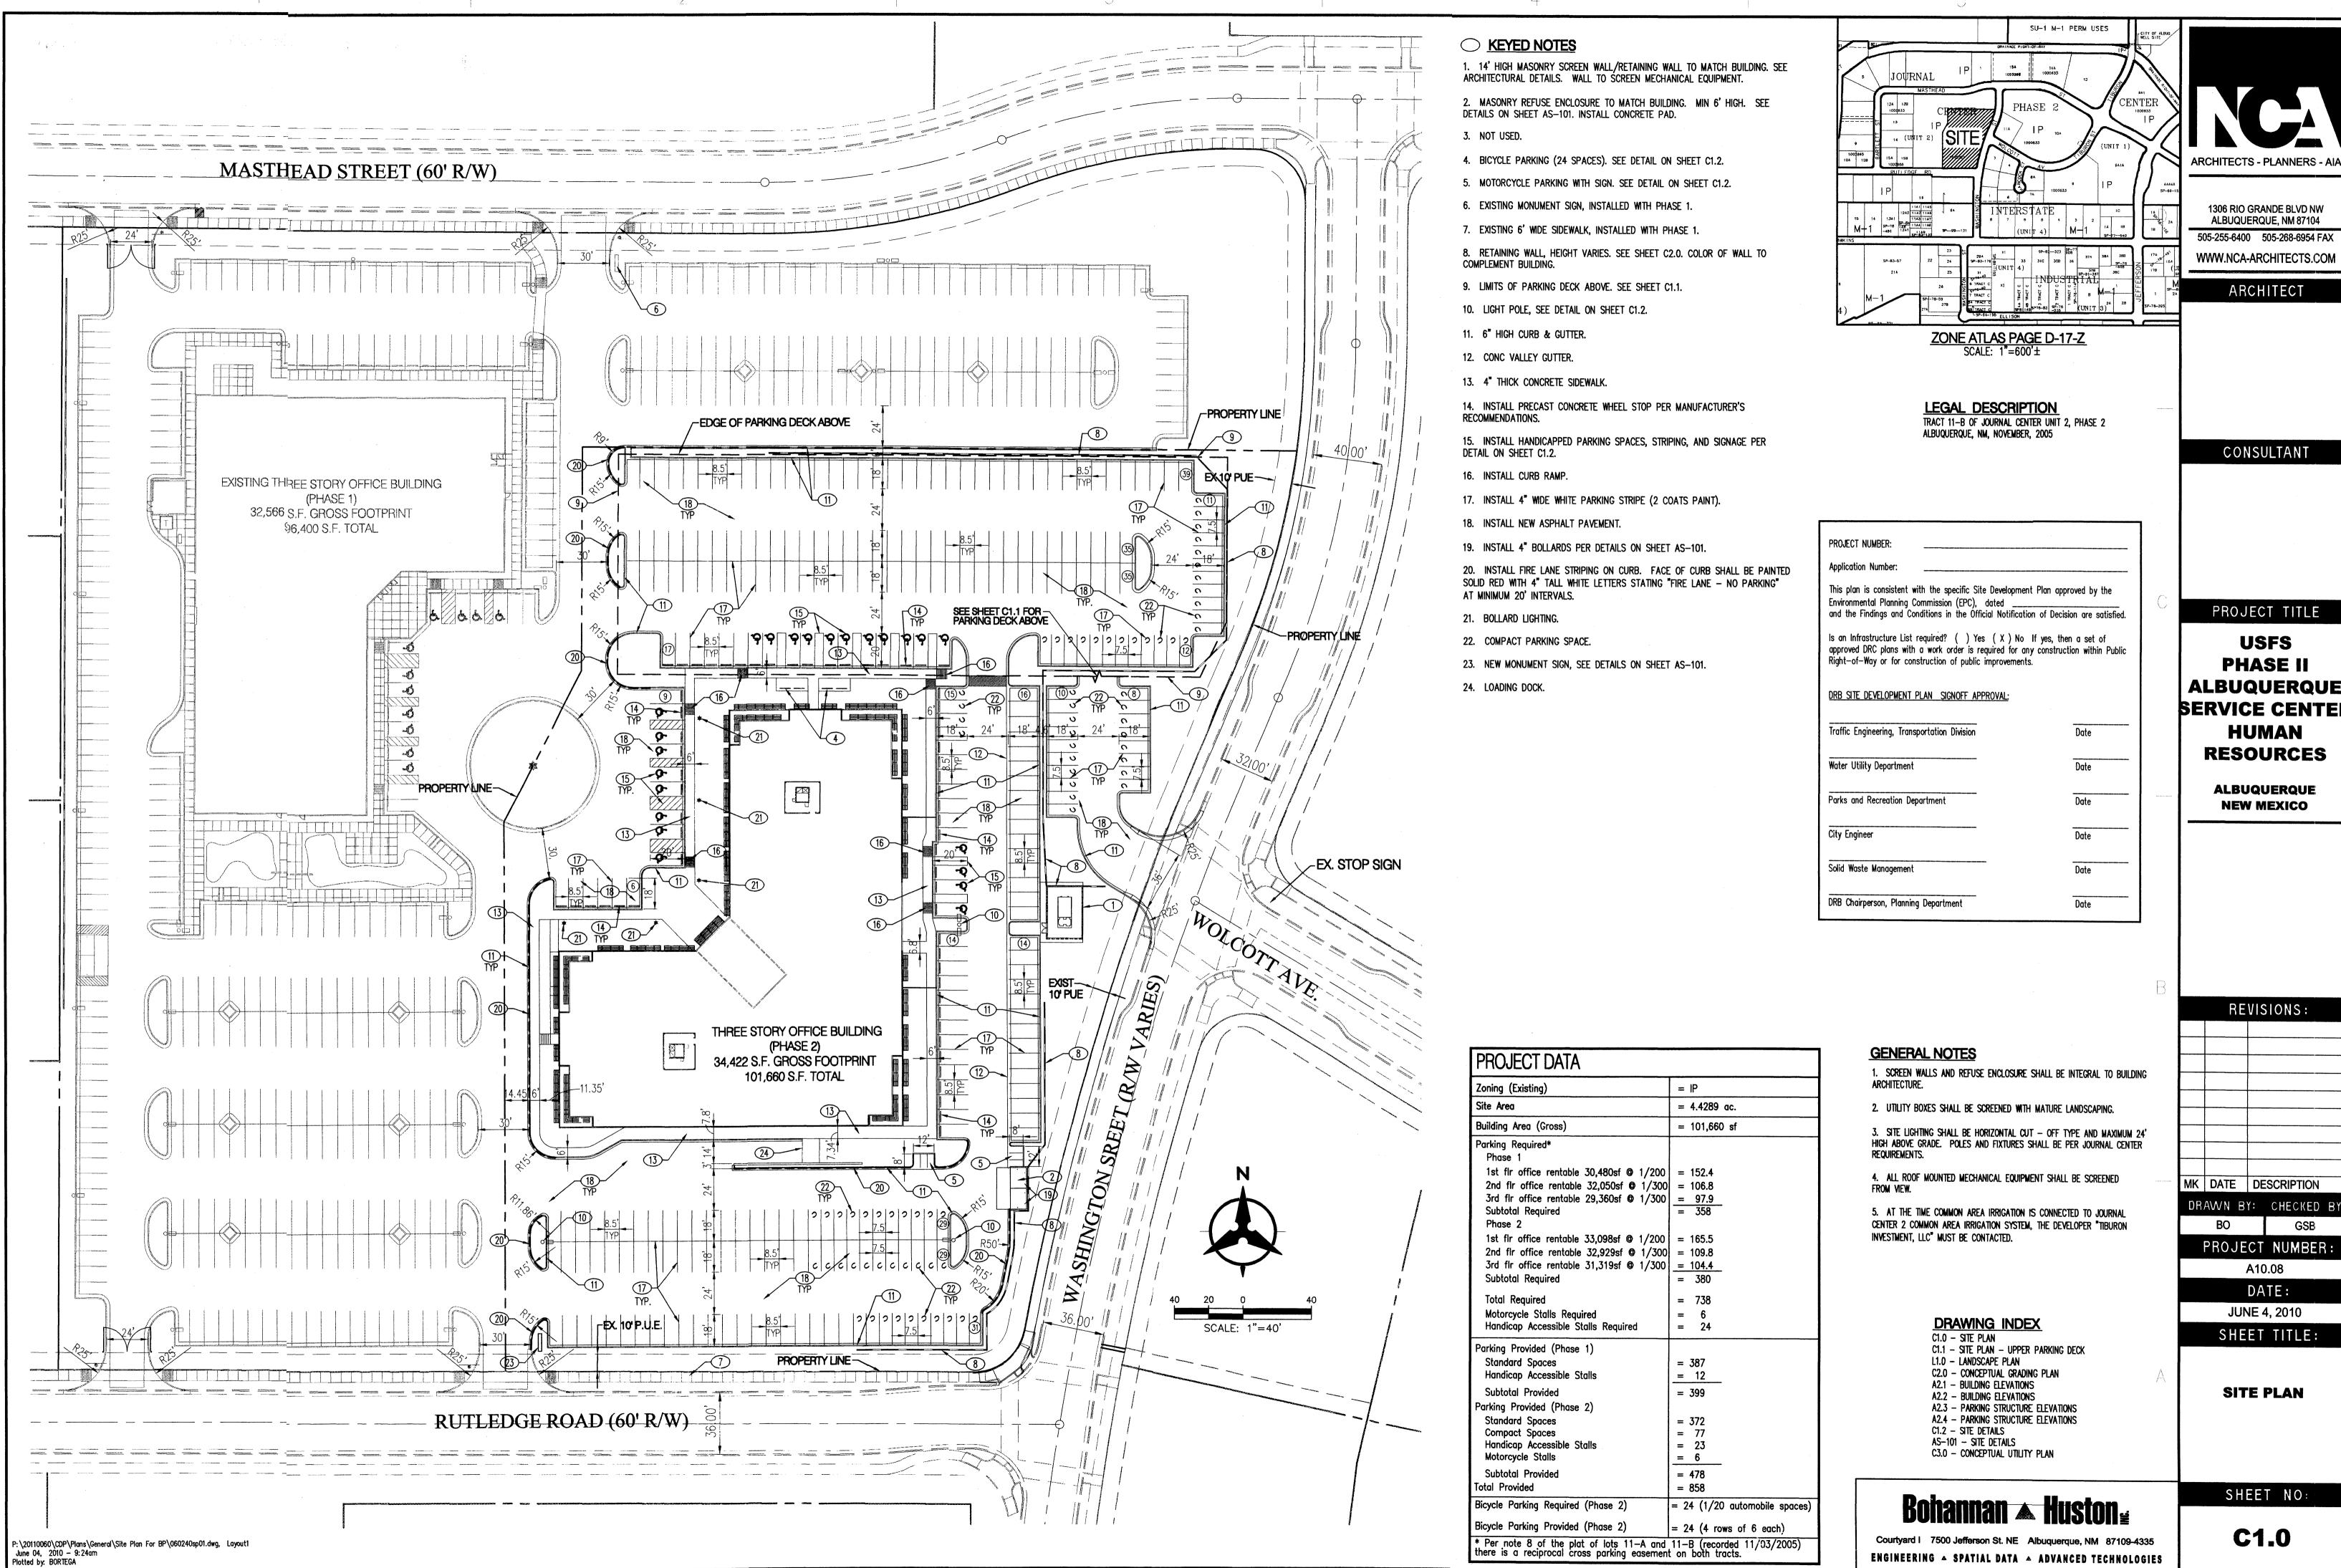

ARCHITECTS - PLANNERS - AIA 1306 RIO GRANDE BLVD NW ALBUQUERQUE, NM 87104 505-255-6400 505-268-6954 FAX WWW.NCA-ARCHITECTS.COM ARCHITECT

> PROJECT TITLE **USFS** PHASE II **ALBUQUERQUE** SERVICE CENTER

> > **RESOURCES ALBUQUERQUE**

CONSULTANT

HUMAN

NEW MEXICO

REVISIONS:

GSB

SHEET NO:

A10.08


DATE:

JUNE 4, 2010

SHEET TITLE:

SITE PLAN

C1.0

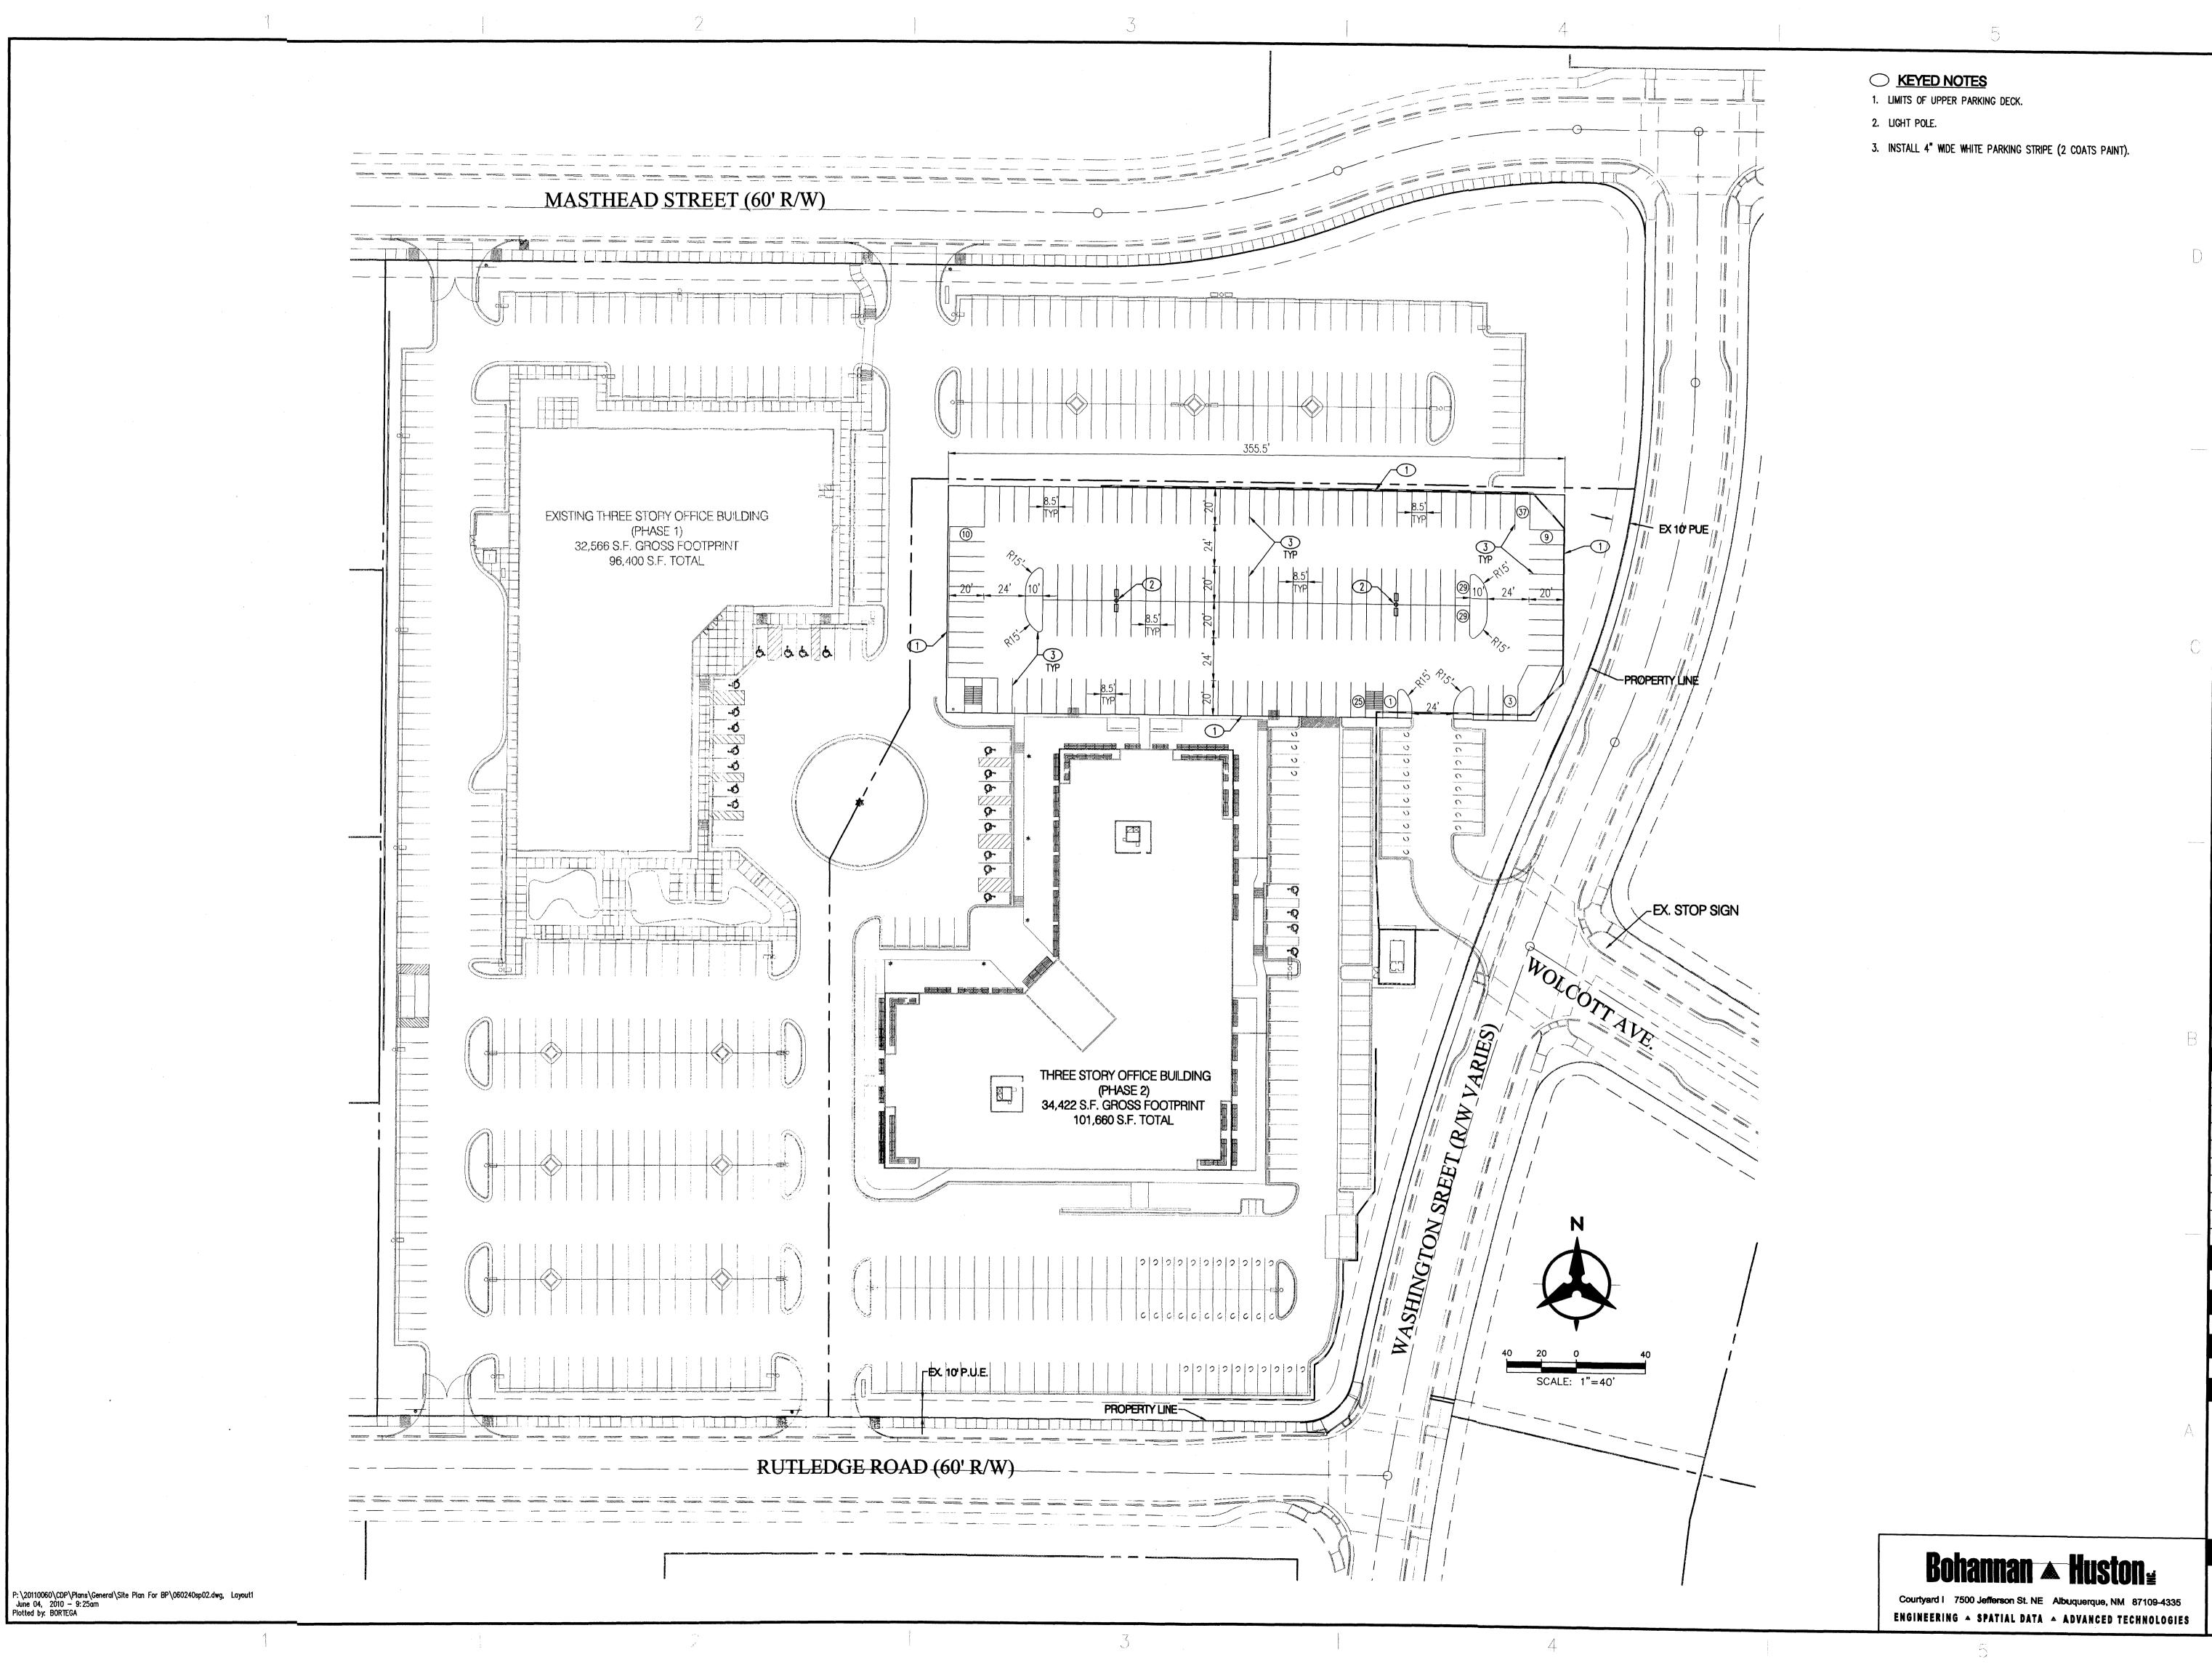



1306 RIO GRANDE BLVD NW ALBUQUERQUE, NM 87104 505-255-6400 505-268-6954 FAX WWW.NCA-ARCHITECTS.COM

ARCHITECT

CONSULTANT

PROJECT TITLE

USFS
PHASE II
ALBUQUERQUE
SERVICE CENTER
HUMAN
RESOURCES

ALBUQUERQUE NEW MEXICO

REVISIONS:

MK DATE DESCRIPTION

DRAWN BY: CHECKED BY
BO GSB

PROJECT NUMBER A10.08

DATE:


JUNE 4, 2010 SHEET TITLE:

SITE PLAN UPPER PARKING DECK

UCCT NO

SHEET NO:

C1.1

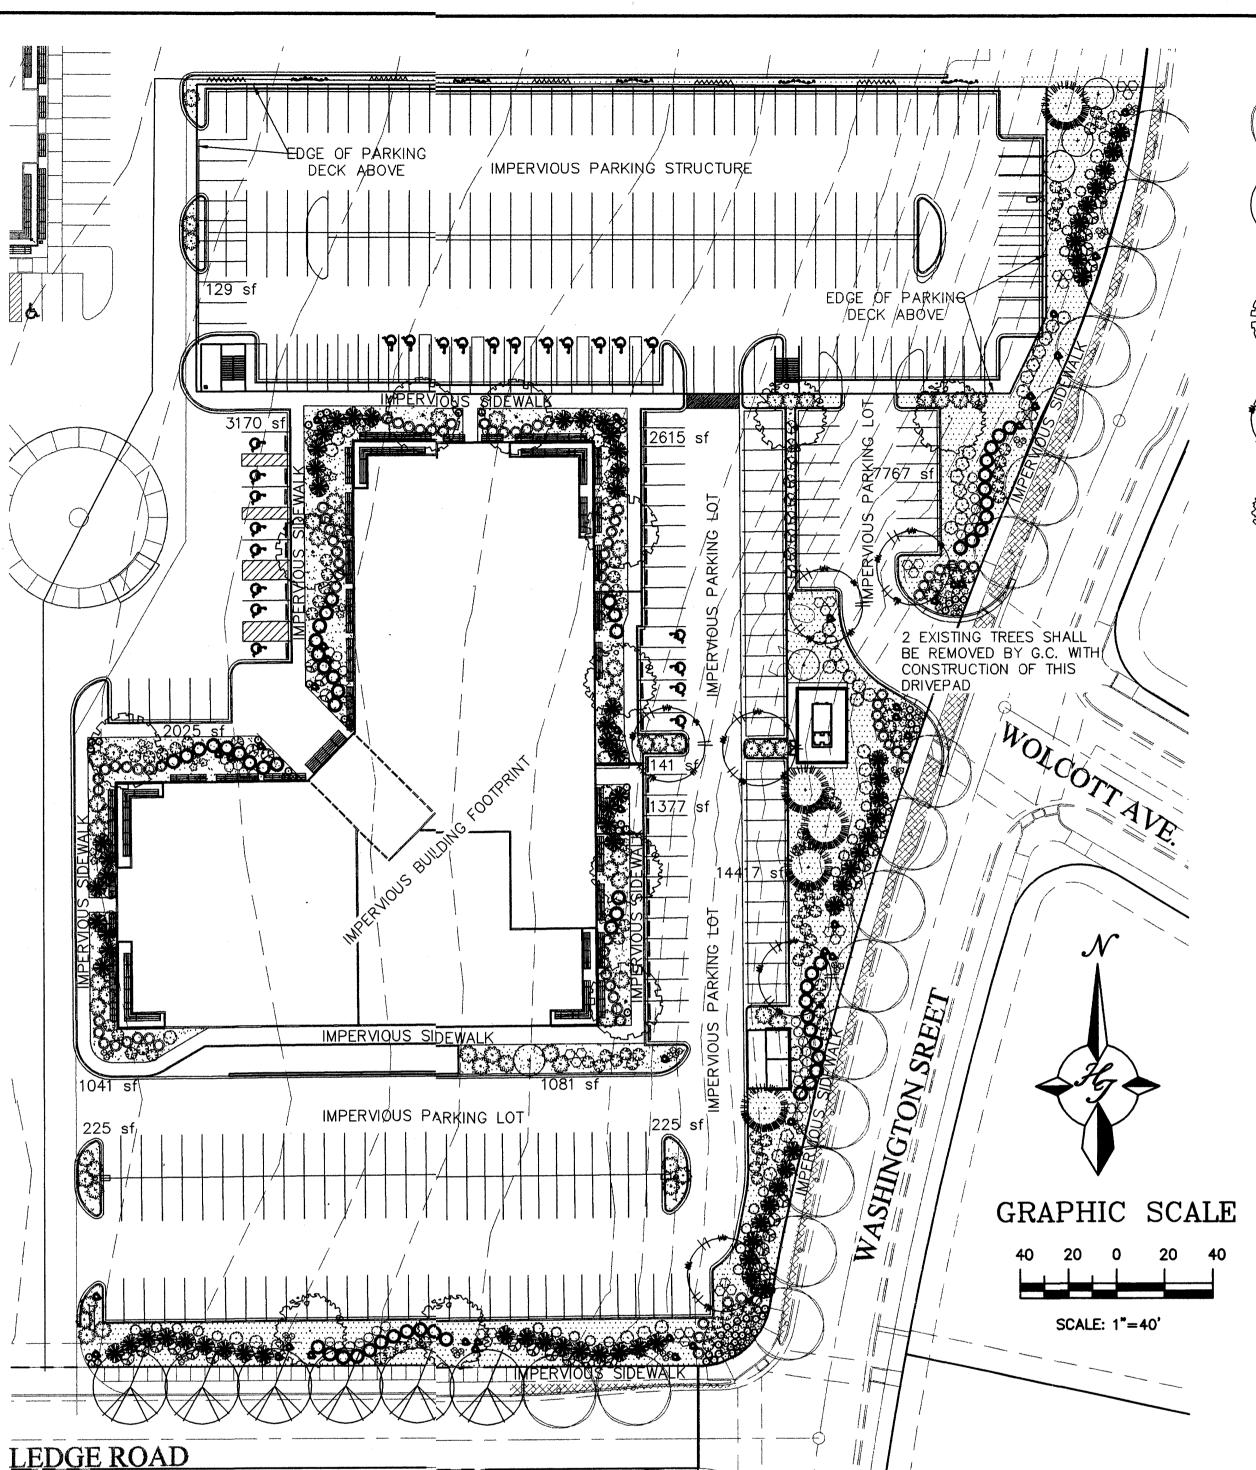

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principles will be followed in design and installation.

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TLANI LEGENU

EXISTING BERINDA ASH

BERINDA ASH (H) 6 Fraxinus SPP. (PER THE JOURNAL CENTER REQUIREMENTS FOR STREET TREE

CHINESE PISTACHE (M) 6 Pistachia chinensis 2" Cal.

GENERAL NOTES:

TO PREVENT TREE FROM SETTLING.

TREE AND THE PLANTING PIT.

B. BACKFILL WITH EXISTING SOIL.

C. 3" DEPTH OF GRAVEL MULCH.

TOTAL PHASE 2 BUILDING AREA

TOTAL LANDSCAPE REQUIREMENT

TOTAL GROUNDCOYER REQUIREMENT

TOTAL GROUNDCOVER PROVIDED

(max. 20% of landscape required)

TOTAL LANDSCAPE PROVIDED IN PHASE 2

CONSTRUCTION NOTES:

D. UNDISTRUBED SOIL.

TOTAL PHASE 2 AREA

LANDSCAPE REQUIREMENT

TOTAL BED PROVIDED

TOTAL PONDING AREA

TOTAL NATIVE SEED AREA

TOTAL SOD AREA

GROUNDCOVER REQ.

NET LOT AREA

A. TREE

1. ROOTBALL SHALL BE PLACED ON UNDISTURBED SOIL

TREE WAS GROWN AND DUG; THIS REPRESENTS THE LEVEL

AT WHICH THE TREE SHOULD BE INSTALLED; THAT LEVEL

MAY BE EXCEEDED BY ONLY A ONE INCH LAYER OF SOIL.

3. PRIOR TO BACKFILLLING TREE, ALL WIRE, ROPE AND

SYNTHETIC MATERIALS SHALL BE REMOVED FROM THE

4. PRIOR TO BACKFILLING ALL BURLAP SHALL BE CUT

LANDSCAPE CALCULATIONS

AWAY EXCEPT FROM BOTTOM OF THE ROOTBALL.

2. TOP OF ROOTCOLLAR INDICATED LEVEL AT WHICH

REDBUD (M) 6 Cercis reniformis

AUSTRIAN PINE (M) 5 Pinus nigra 6'-8'

THORNLESS HAWTHORN (M+) 5 Crataegus crus-galli inermis

Dasylirion wheeleri 5 Gal. 36sf

MUGO PINE (M) 57

MINTER JASMINE (L+) 90 Jasminum nudiflorum 5 Gal. 144sf

CURLLEAF MTN MAHOGANY (L) 53

GREYLEAF COTONEASTER 60 Cotoneaster buxifolius

APACHE PLUME (L) 31 Fallugia paradoxa 42sf

THREE-LEAF SUMAC (L) 25 Rhus trilobata

ARP ROSEMARY (M) 75 Rosmarinus officianalis 5 Gal. 36sf

POWIS CASTLE SAGE (L) 45 Artimesia x powis castle 5 Gal. 25sf

AUTUMN SAGE (M) 33 Salvia greggii 5 Gal.

LAVENDER (M) 57 Lavandula angustifolia

> THREADGRASS (M) 64 Stipa tennuisima 1 Gal. 4sf

MILDFLOMER 52

ENGLISH IVY (M) 5 Hedera helix 1 *Gal*.

CORAL HONEYSUCKLE (M) 5 Lonicera sempervirens

BOULDERS WITH OVERSIZED GRAVEL ACCENT (41)

SANTA FE BROWN GRAVEL WITH FILTER FABRIC

OVERSIZED GRAVEL WITH FILTER FABRIC

EXISTING LANDSCAPING

ALBUQUERQUE, NM 87104 505-255-6400 505-268-6954 FAX WWW.NCA-ARCHITECTS.COM

ARCHITECTS - PLANNERS - AIA

1306 RIO GRANDE BLVD NW

ARCHITECT

CONSULTANT TheHilltop

LANDSCAPE ARCHITECTS & CONTRACT Cont. Lic. #26458 7909 Edith N.E. Albuquerque, NM 87184 Fax (505) 898-7737

PROJECT TITLE


USFS PHASE II **ALBUQUERQUE** SERVICE CENTER HUMAN **RESOURCES**

> **ALBUQUERQUE NEW MEXICO**

Tree Trunk

Emitter-12" o.c

Root Ball

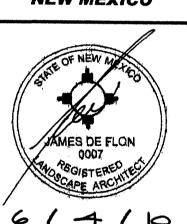

REVISIONS:

2 6-4-10 site revision -cmi 1 5-17-06 site revision -adf MK DATE DESCRIPTION

DRAWN BY: CHECKED BY


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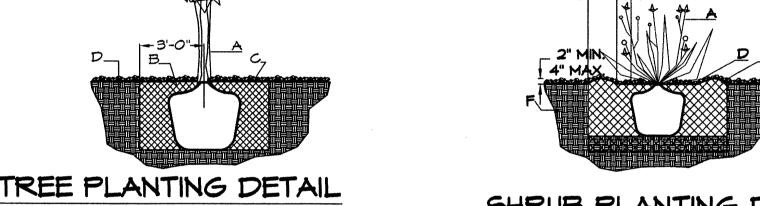
> DATE: **JUNE 2010**

SHEET TITLE:

LANDSCAPING PLAN

SHEET NO:



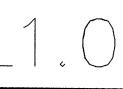

SHRUB PLANTING DETAIL

GENERAL NOTES:

1. THE OUTSIDE DIAMETER OF THE WATER RETENTION BASIN SHALL BE TWICE THE DIAMETER OF THE SHRUB PLANTING PIT.

CONSTRUCTION NOTES:

A. SHRUB.

190370

34638

155732

15%

23359

75%

Should The Hilltop not receive a Grading and Drainage plan

during the design process or the on site grades differ

reserves the right to apply slope stabilization materials

addressed as an infield-change order.

from the Grading and Drainage plan received. The Hilltop

where the specified gravel will not be suitable. This will be

25972 (76%)

B. BACKFILL WITH EXISTING SOIL. C. EARTH BERM AROUND WATER RETENTION BASIN.

D. 3" DEPTH OF GRAVEL MULCH. E. FINISH GRADE.


F. UNDISTURBED SOIL.

square feet

34213 (22%) square feet

34213 (22%) square feet

GRAVEL ACCENT DETAIL

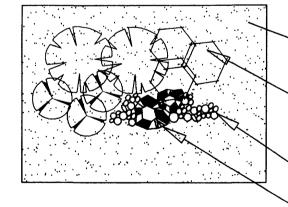


GRAVEL TYPE PER PLAN PLANTING PER PLAN OVERSIZED GRAVEL ACCENT AT EVERY BOULDER CLUSTER 40-50 SQUARE FEET BOULDER

Street trees required under the City Of Albuquerque Street Tree Ordinance are as follows:

Name of Street : RUTLEDGE Required 8 Provided 8 (6 NEW/2 EXISTING)

Name of Street: Washington

Shade trees required under the City Of Albuquerque Parking Lot Tree Ordinance are as follows:

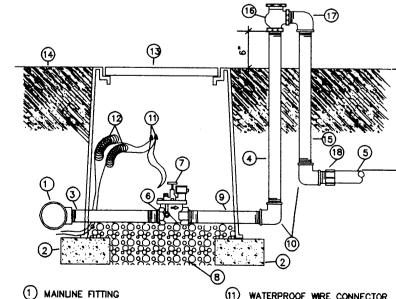

Netafim Spiral Detail

MAINLINE FITTING CMU BLOCK GALVANIZED NIPPLE 24" TO 36" GALVANIZED NIPPLE LATERAL PIPE REDUCER BUSHING AUTOMATIC VALVE (SEE LEGEND) GRAVEL GALVANIZED NIPPLE

ATMOSPHERIC VACUUM BREAKER GALVANIZED STREET ELL (18) TOE NIPPLE OR MALE ADAPTER

VALVE BOX

FINISH GRADE

WIRE EXPANSION LOOPS

GALVANIZED NIPPLE - 18" TO 24" LENGTH


AUTOMATIC VALVE W/ ATMOSPHERIC VACUUM BREAKER


STREET TREE REQUIREMENTS - Minimum 2" Caliper


Required 16 Provided 16 EXISTING


PARKING LOT TREE REQUIREMENTS - Minimum 2" Caliper


1 Shade tree per 10 spaces Required # Provided #

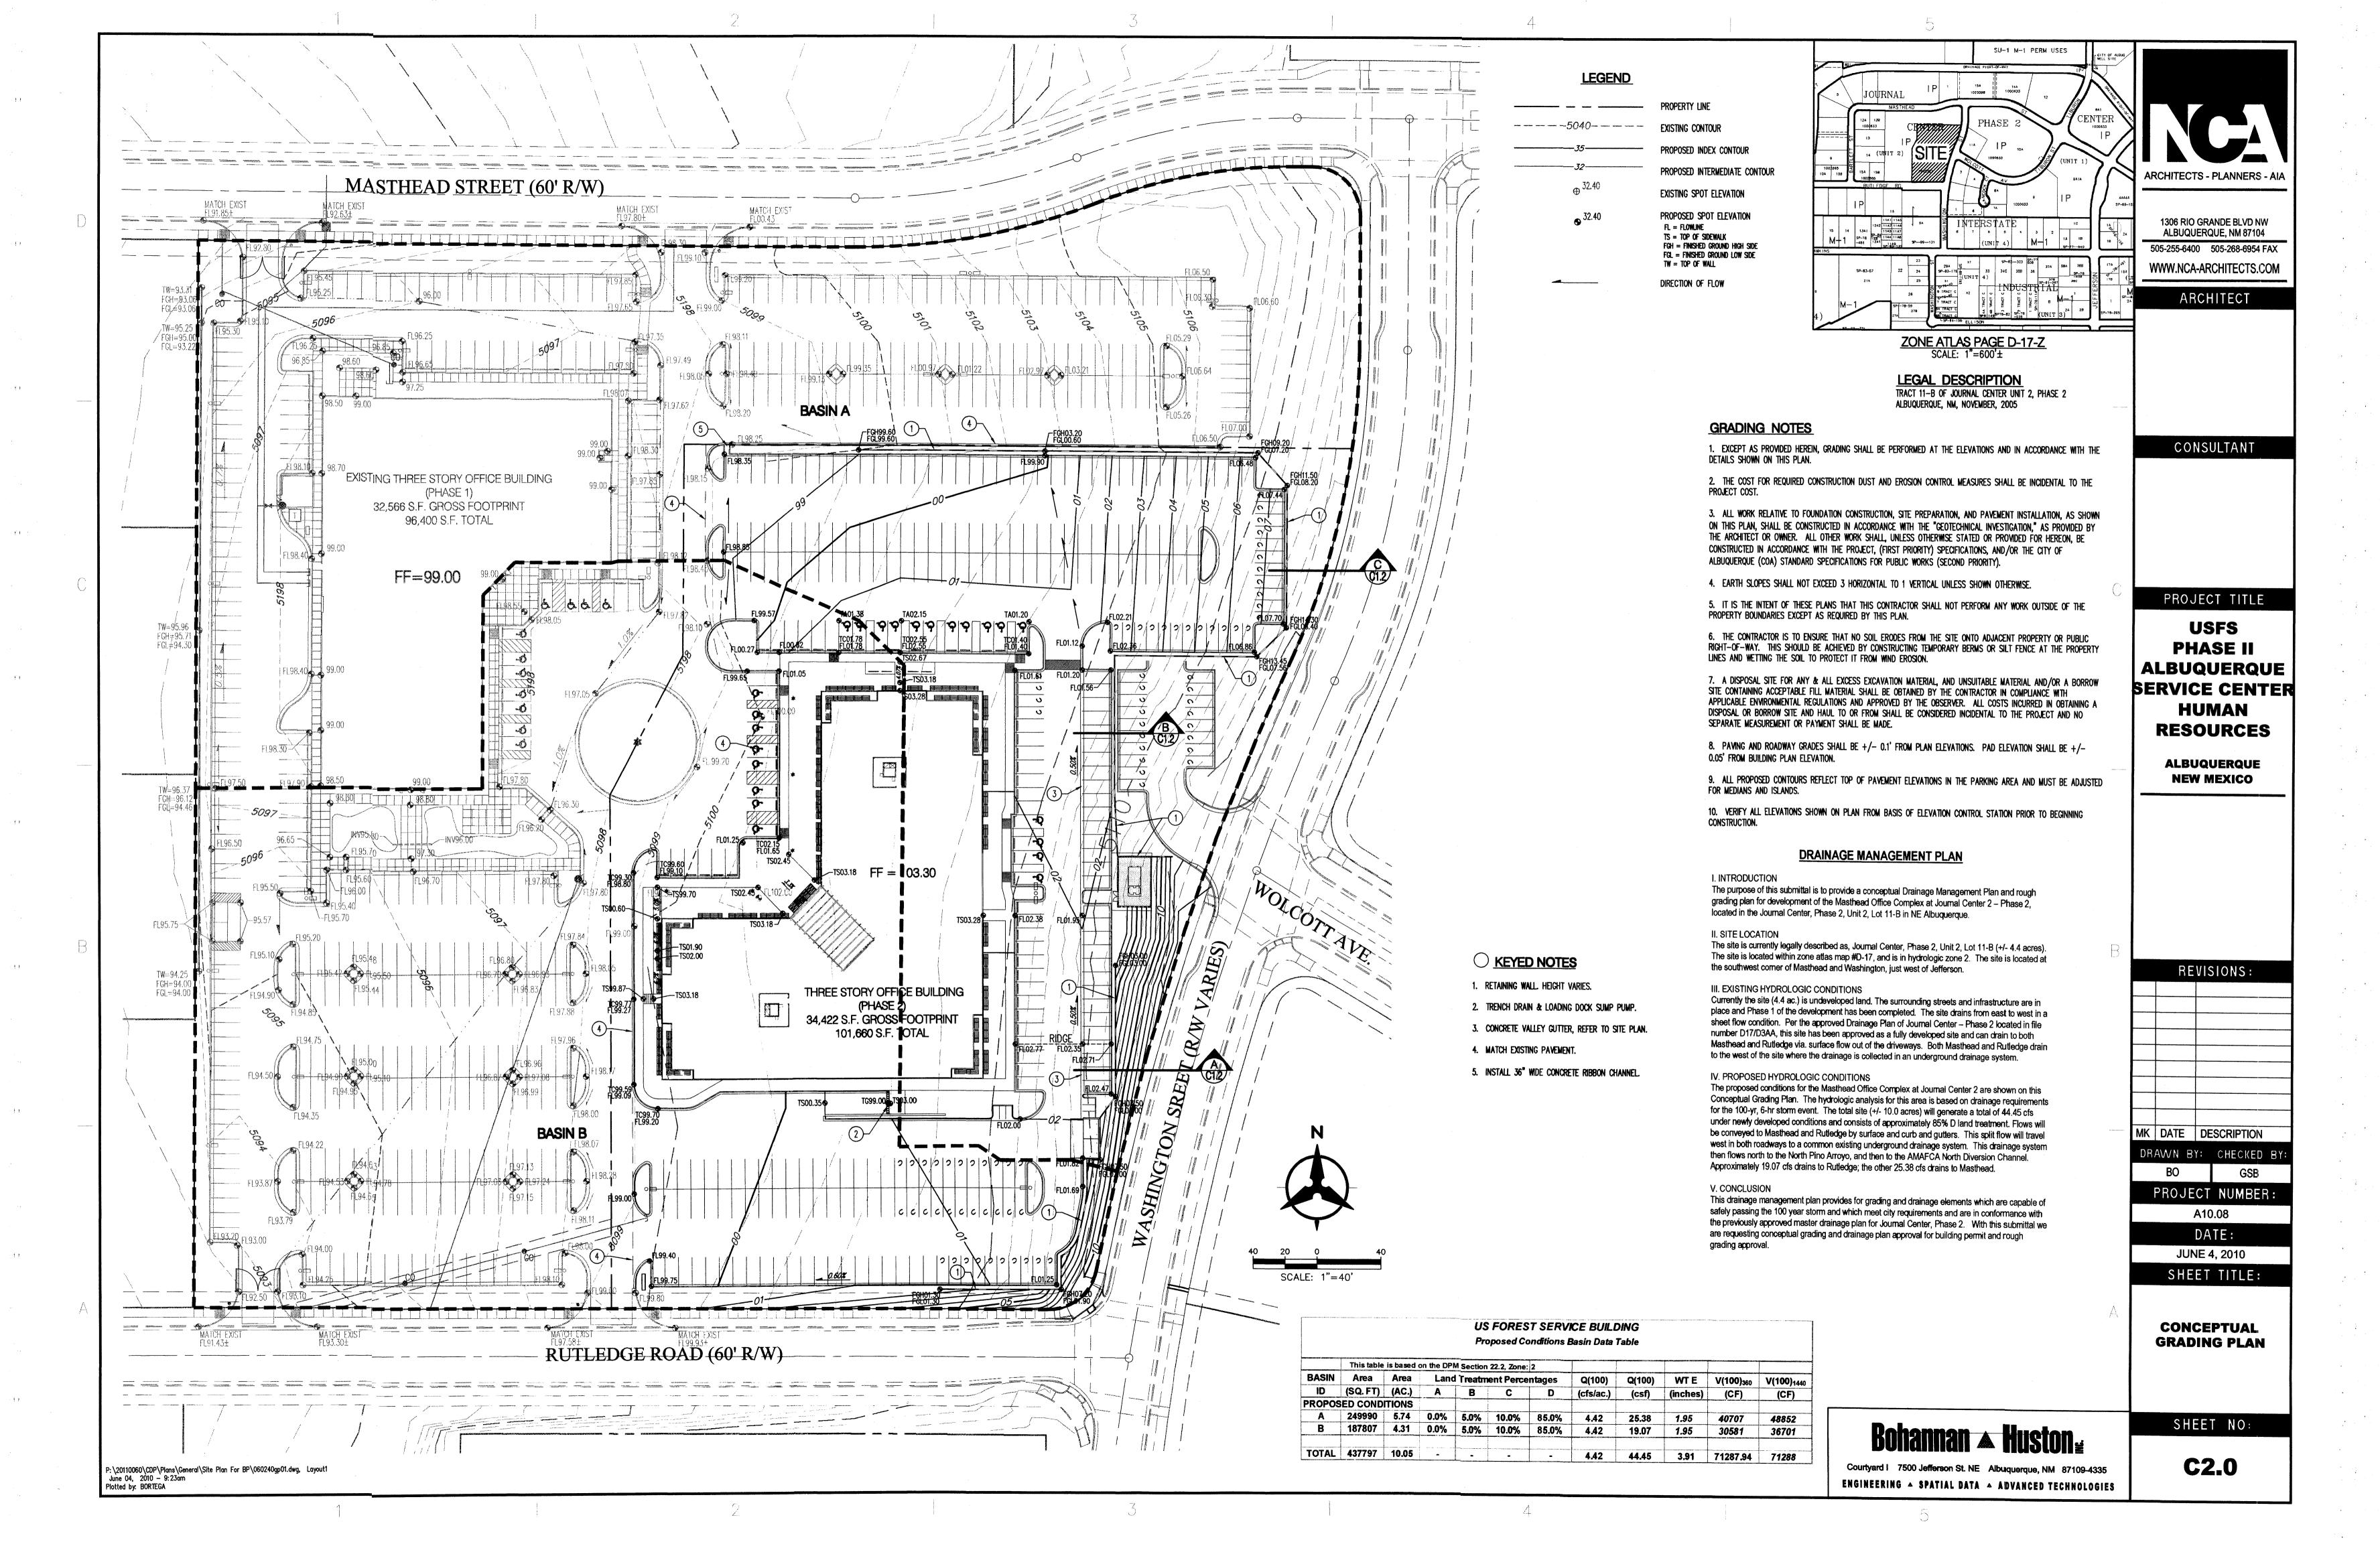


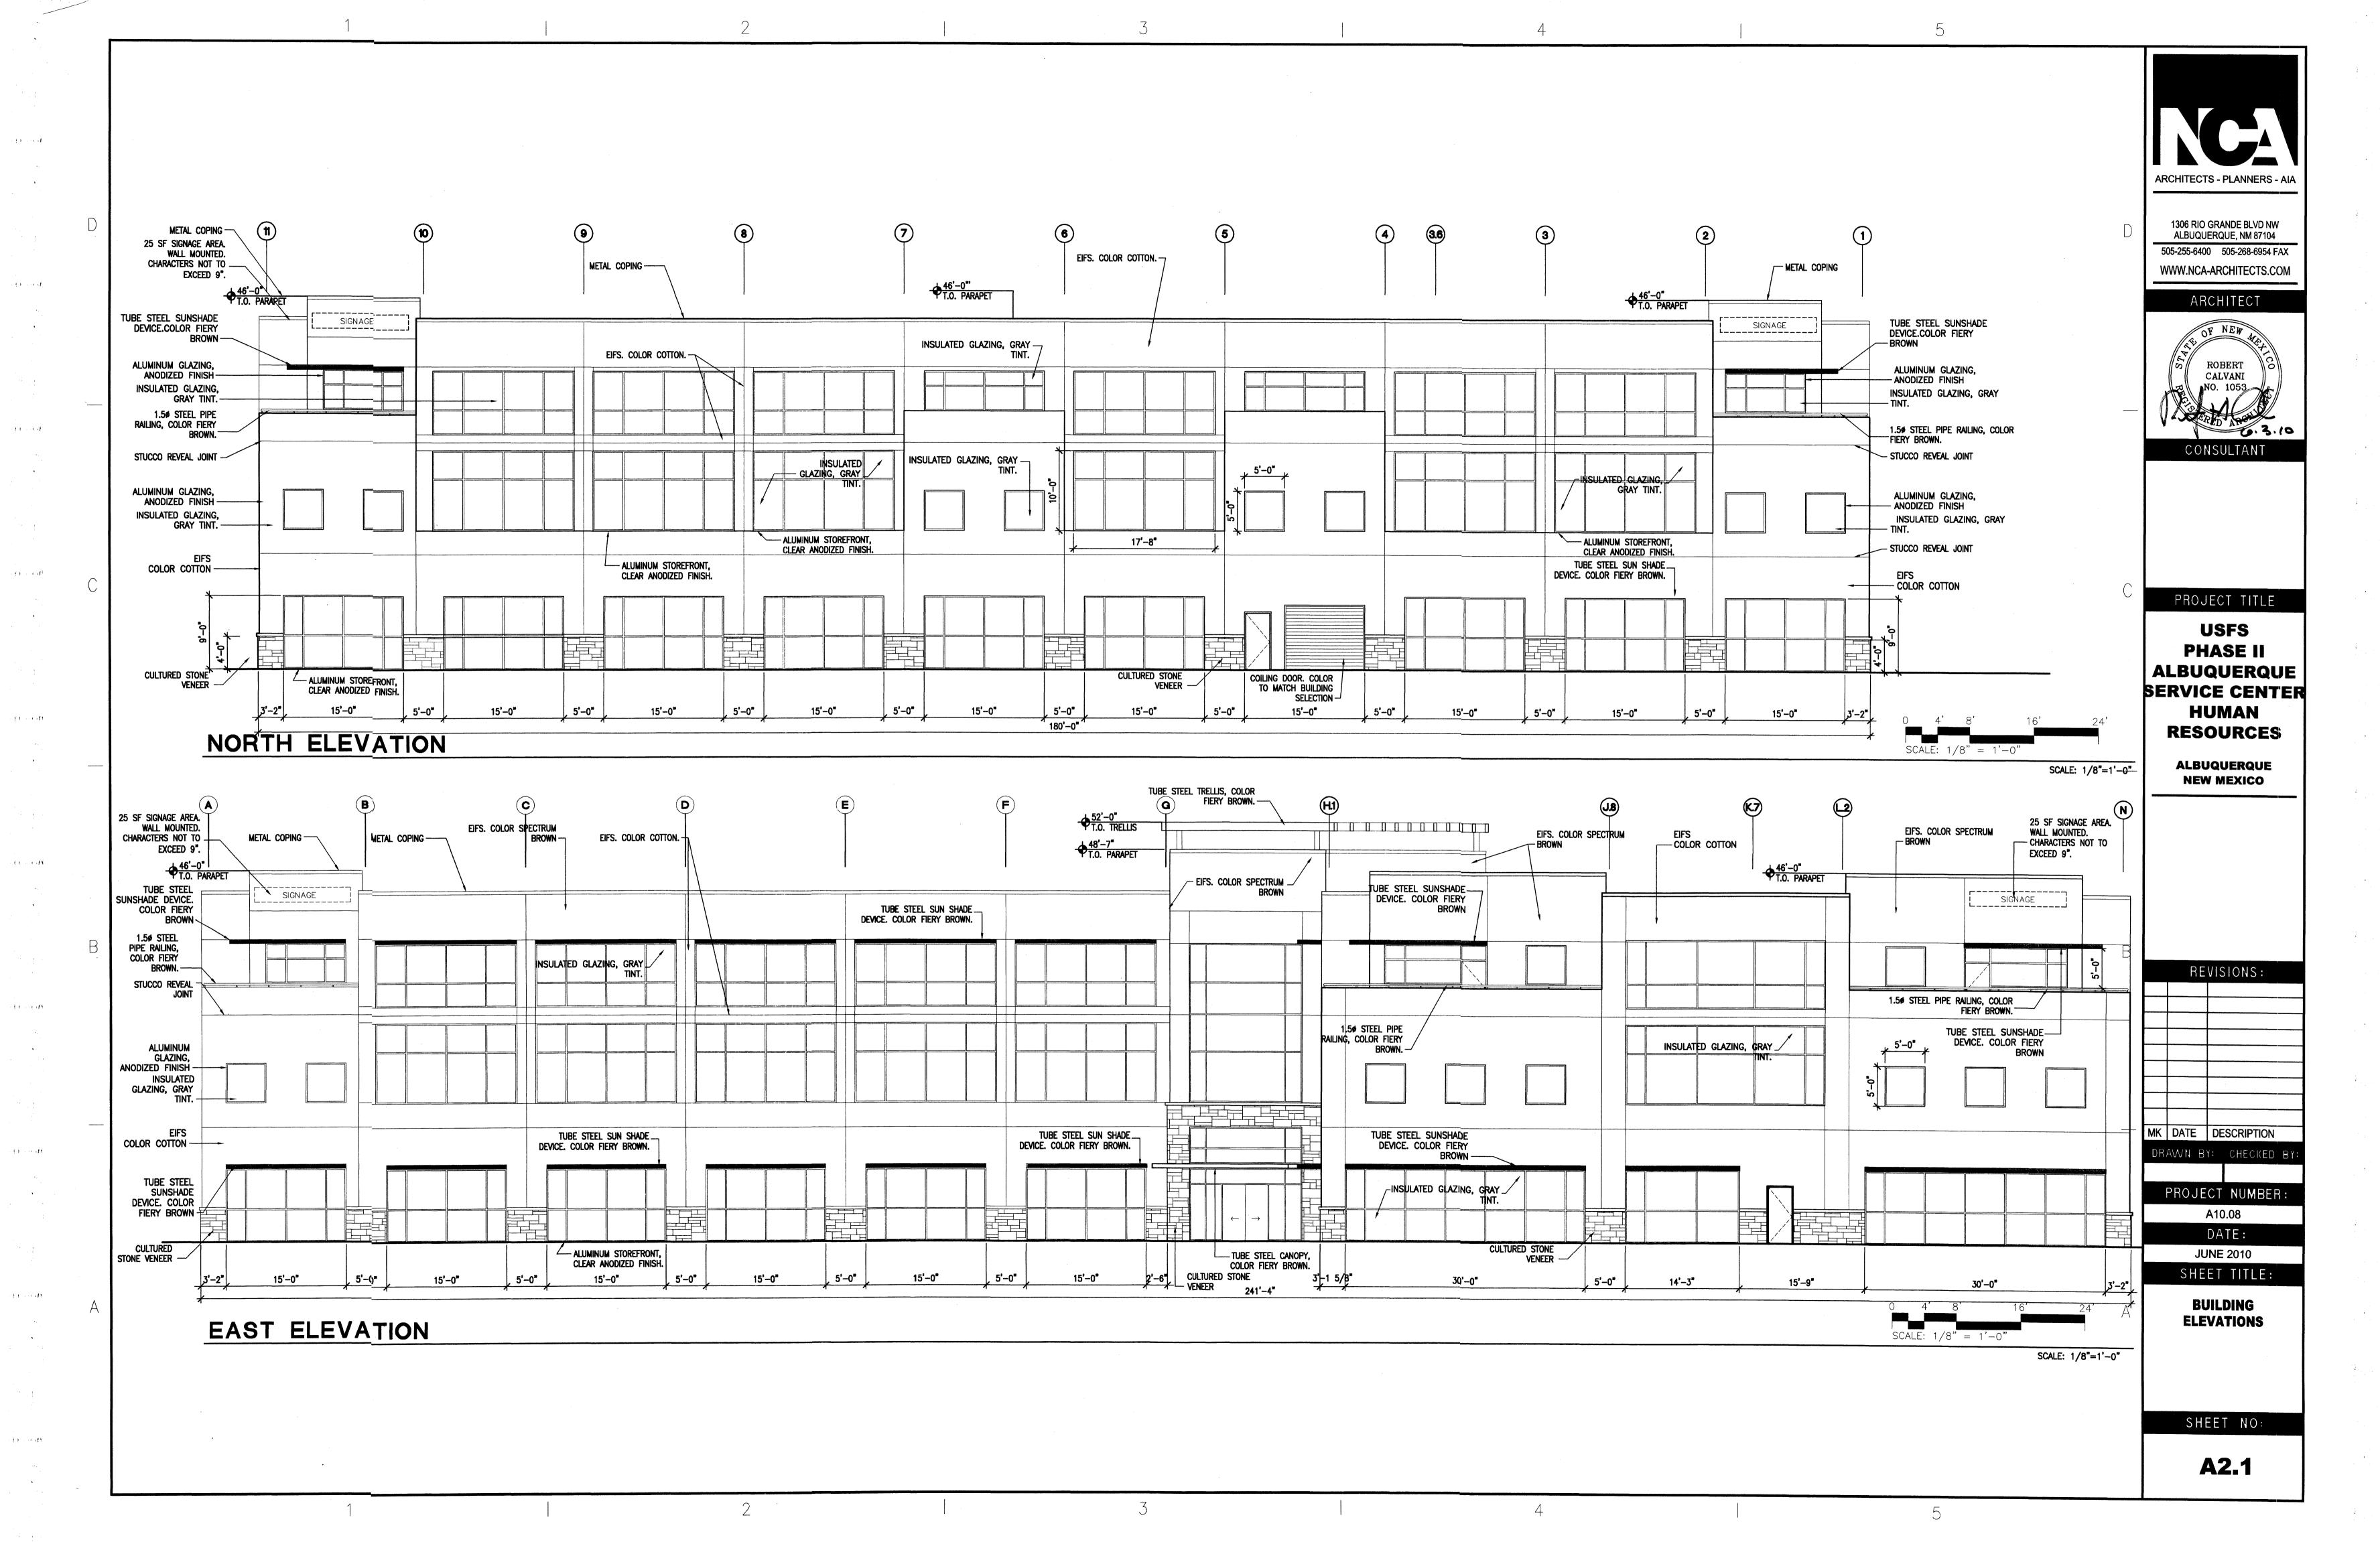


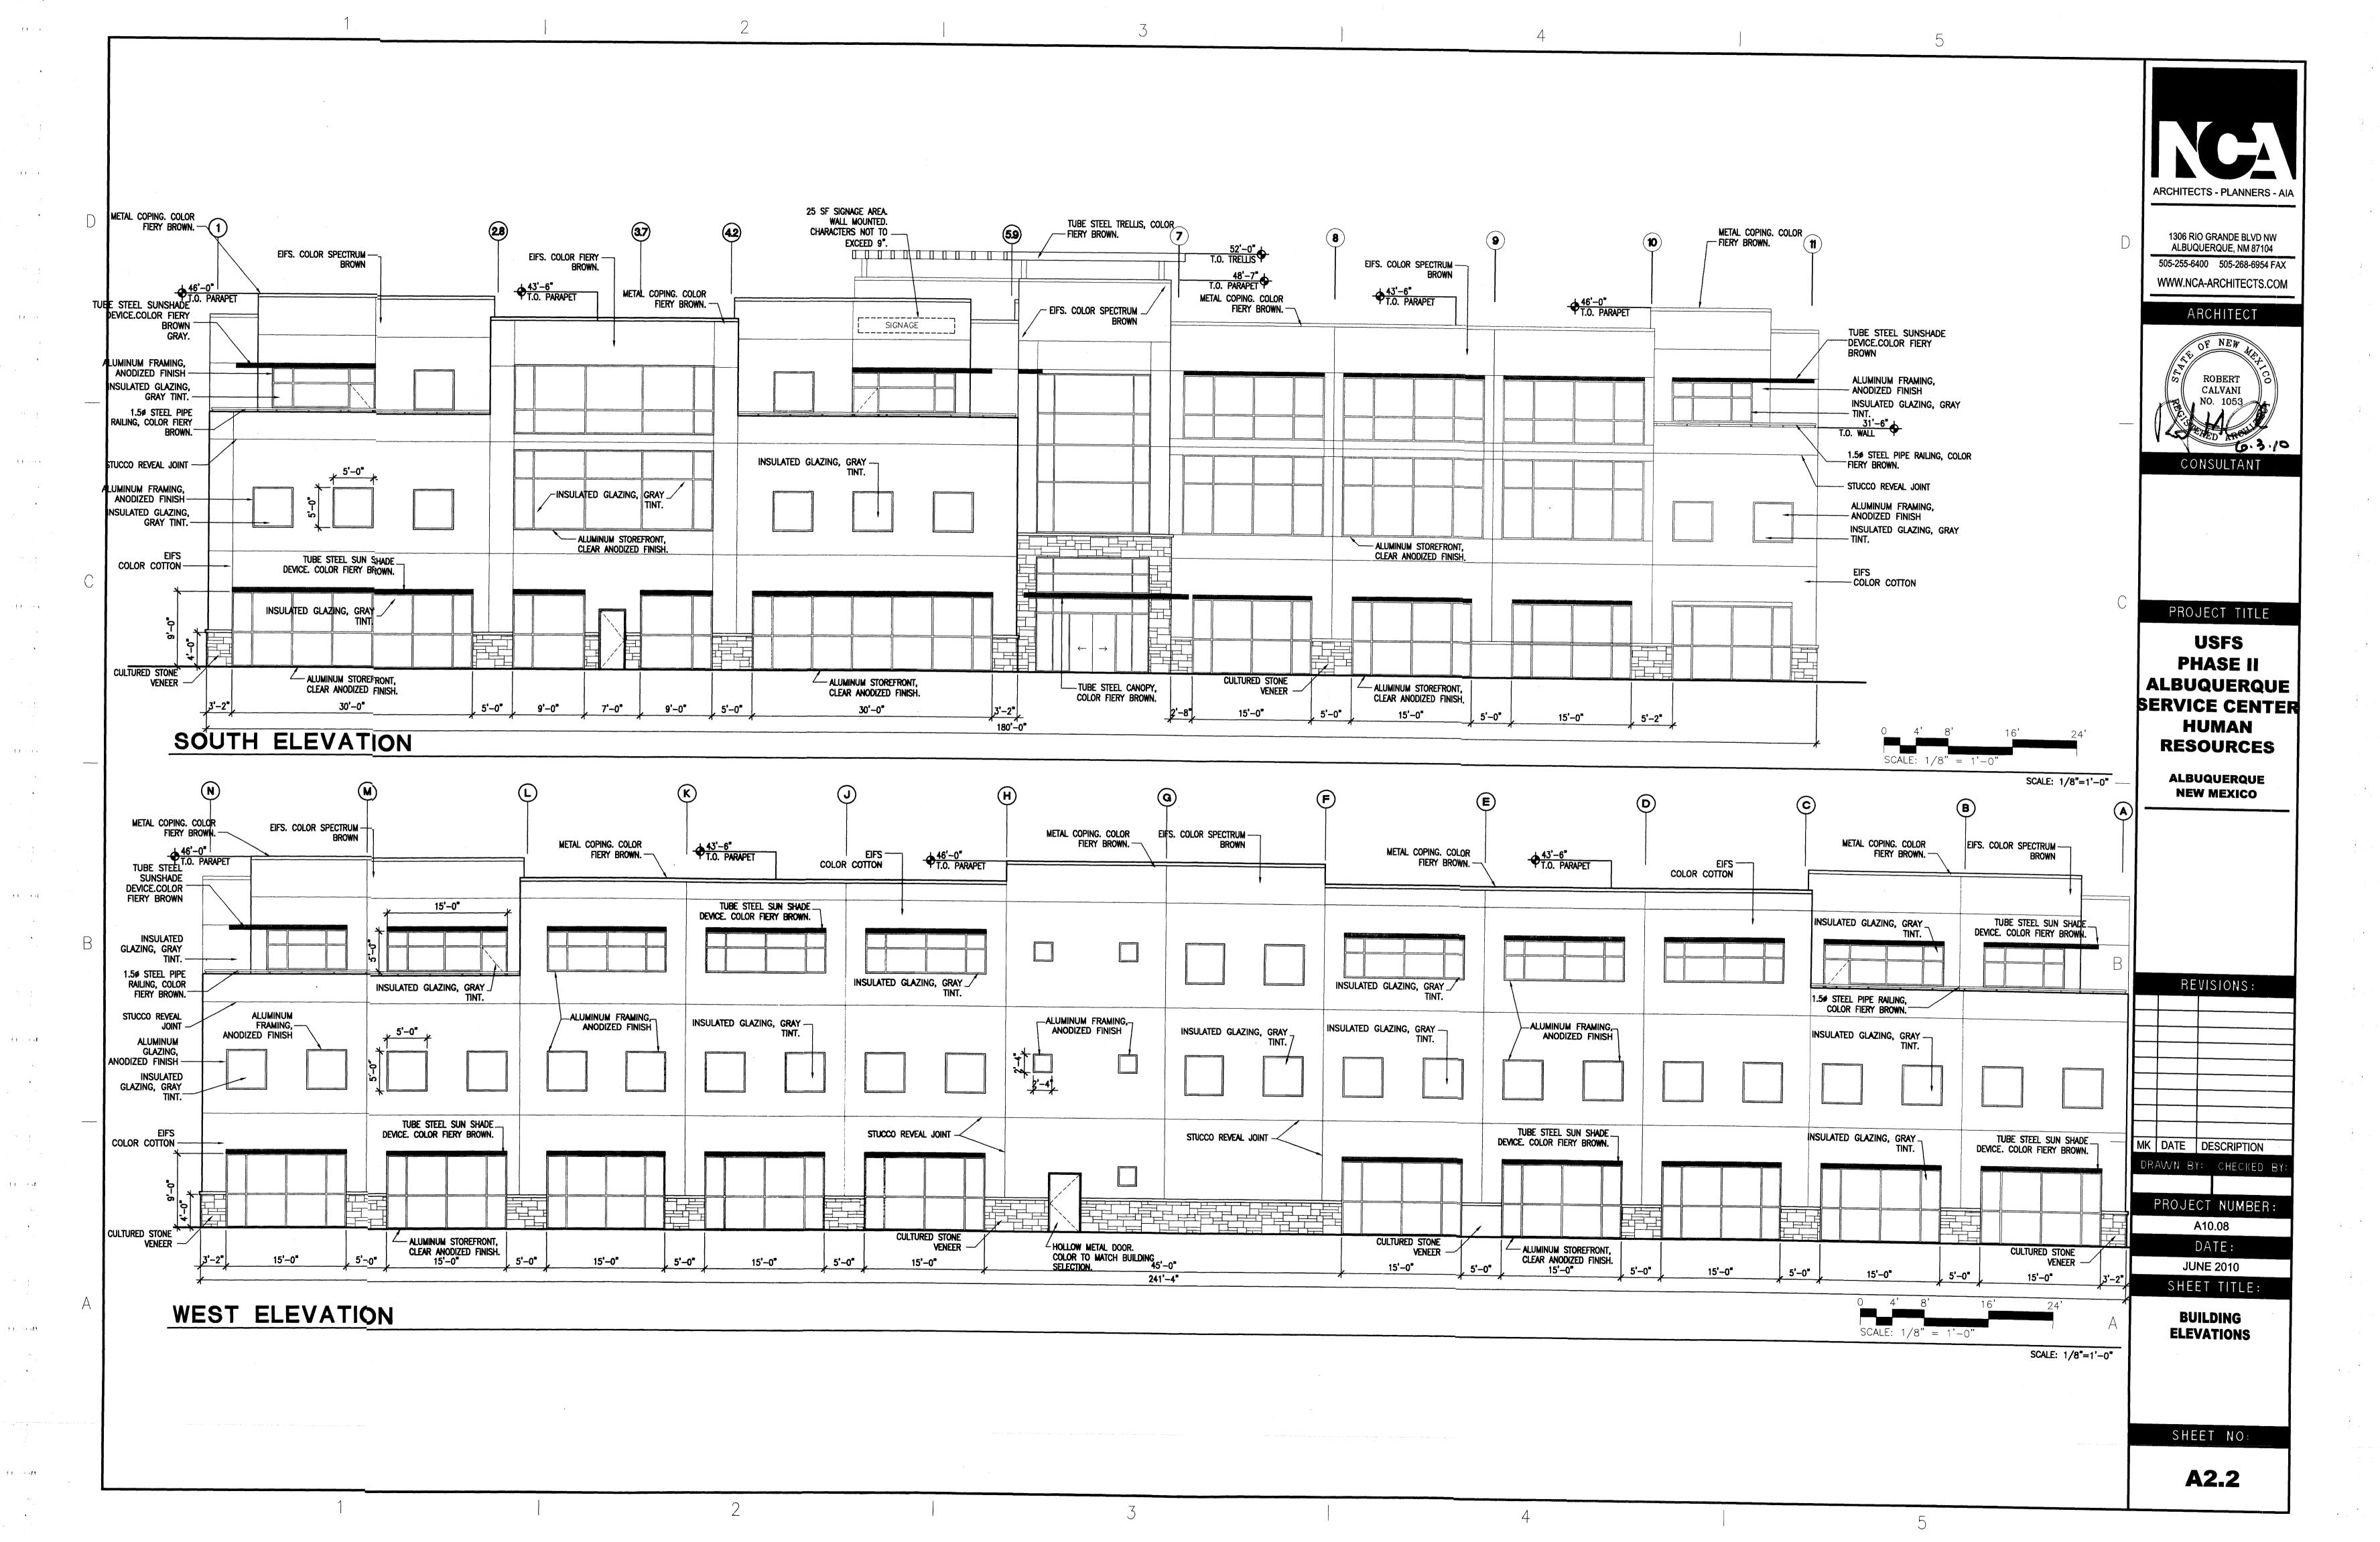


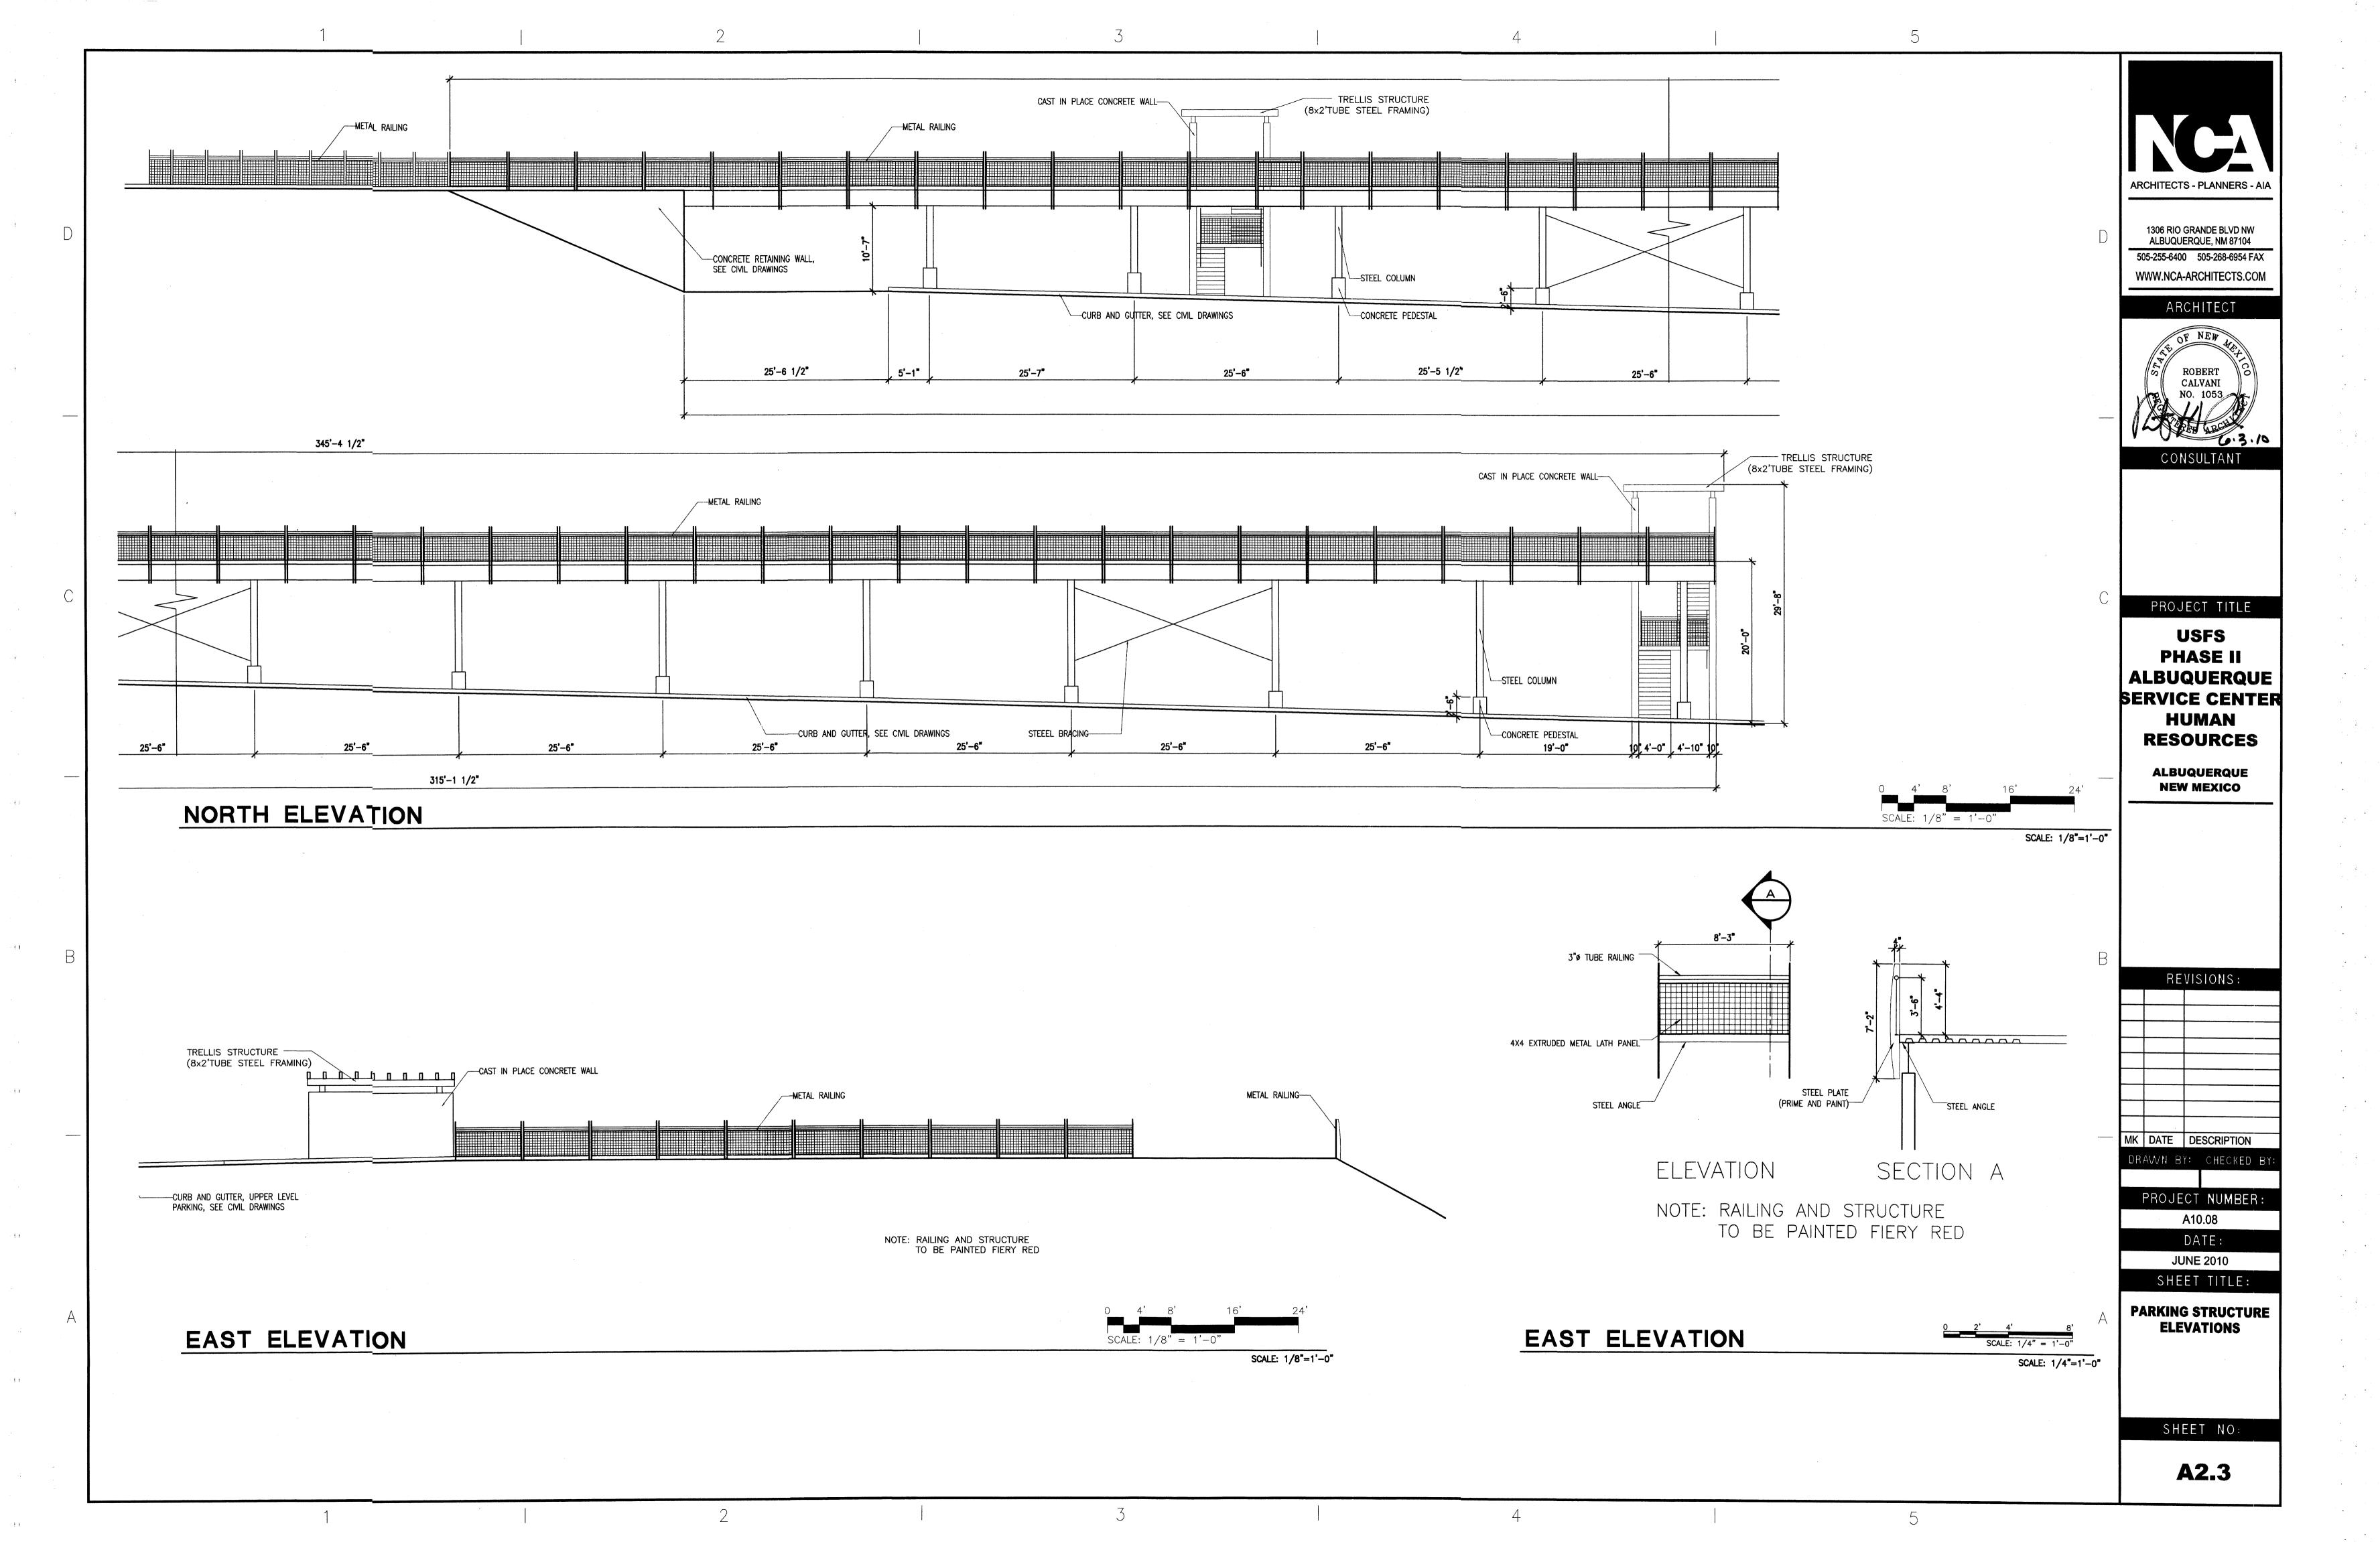

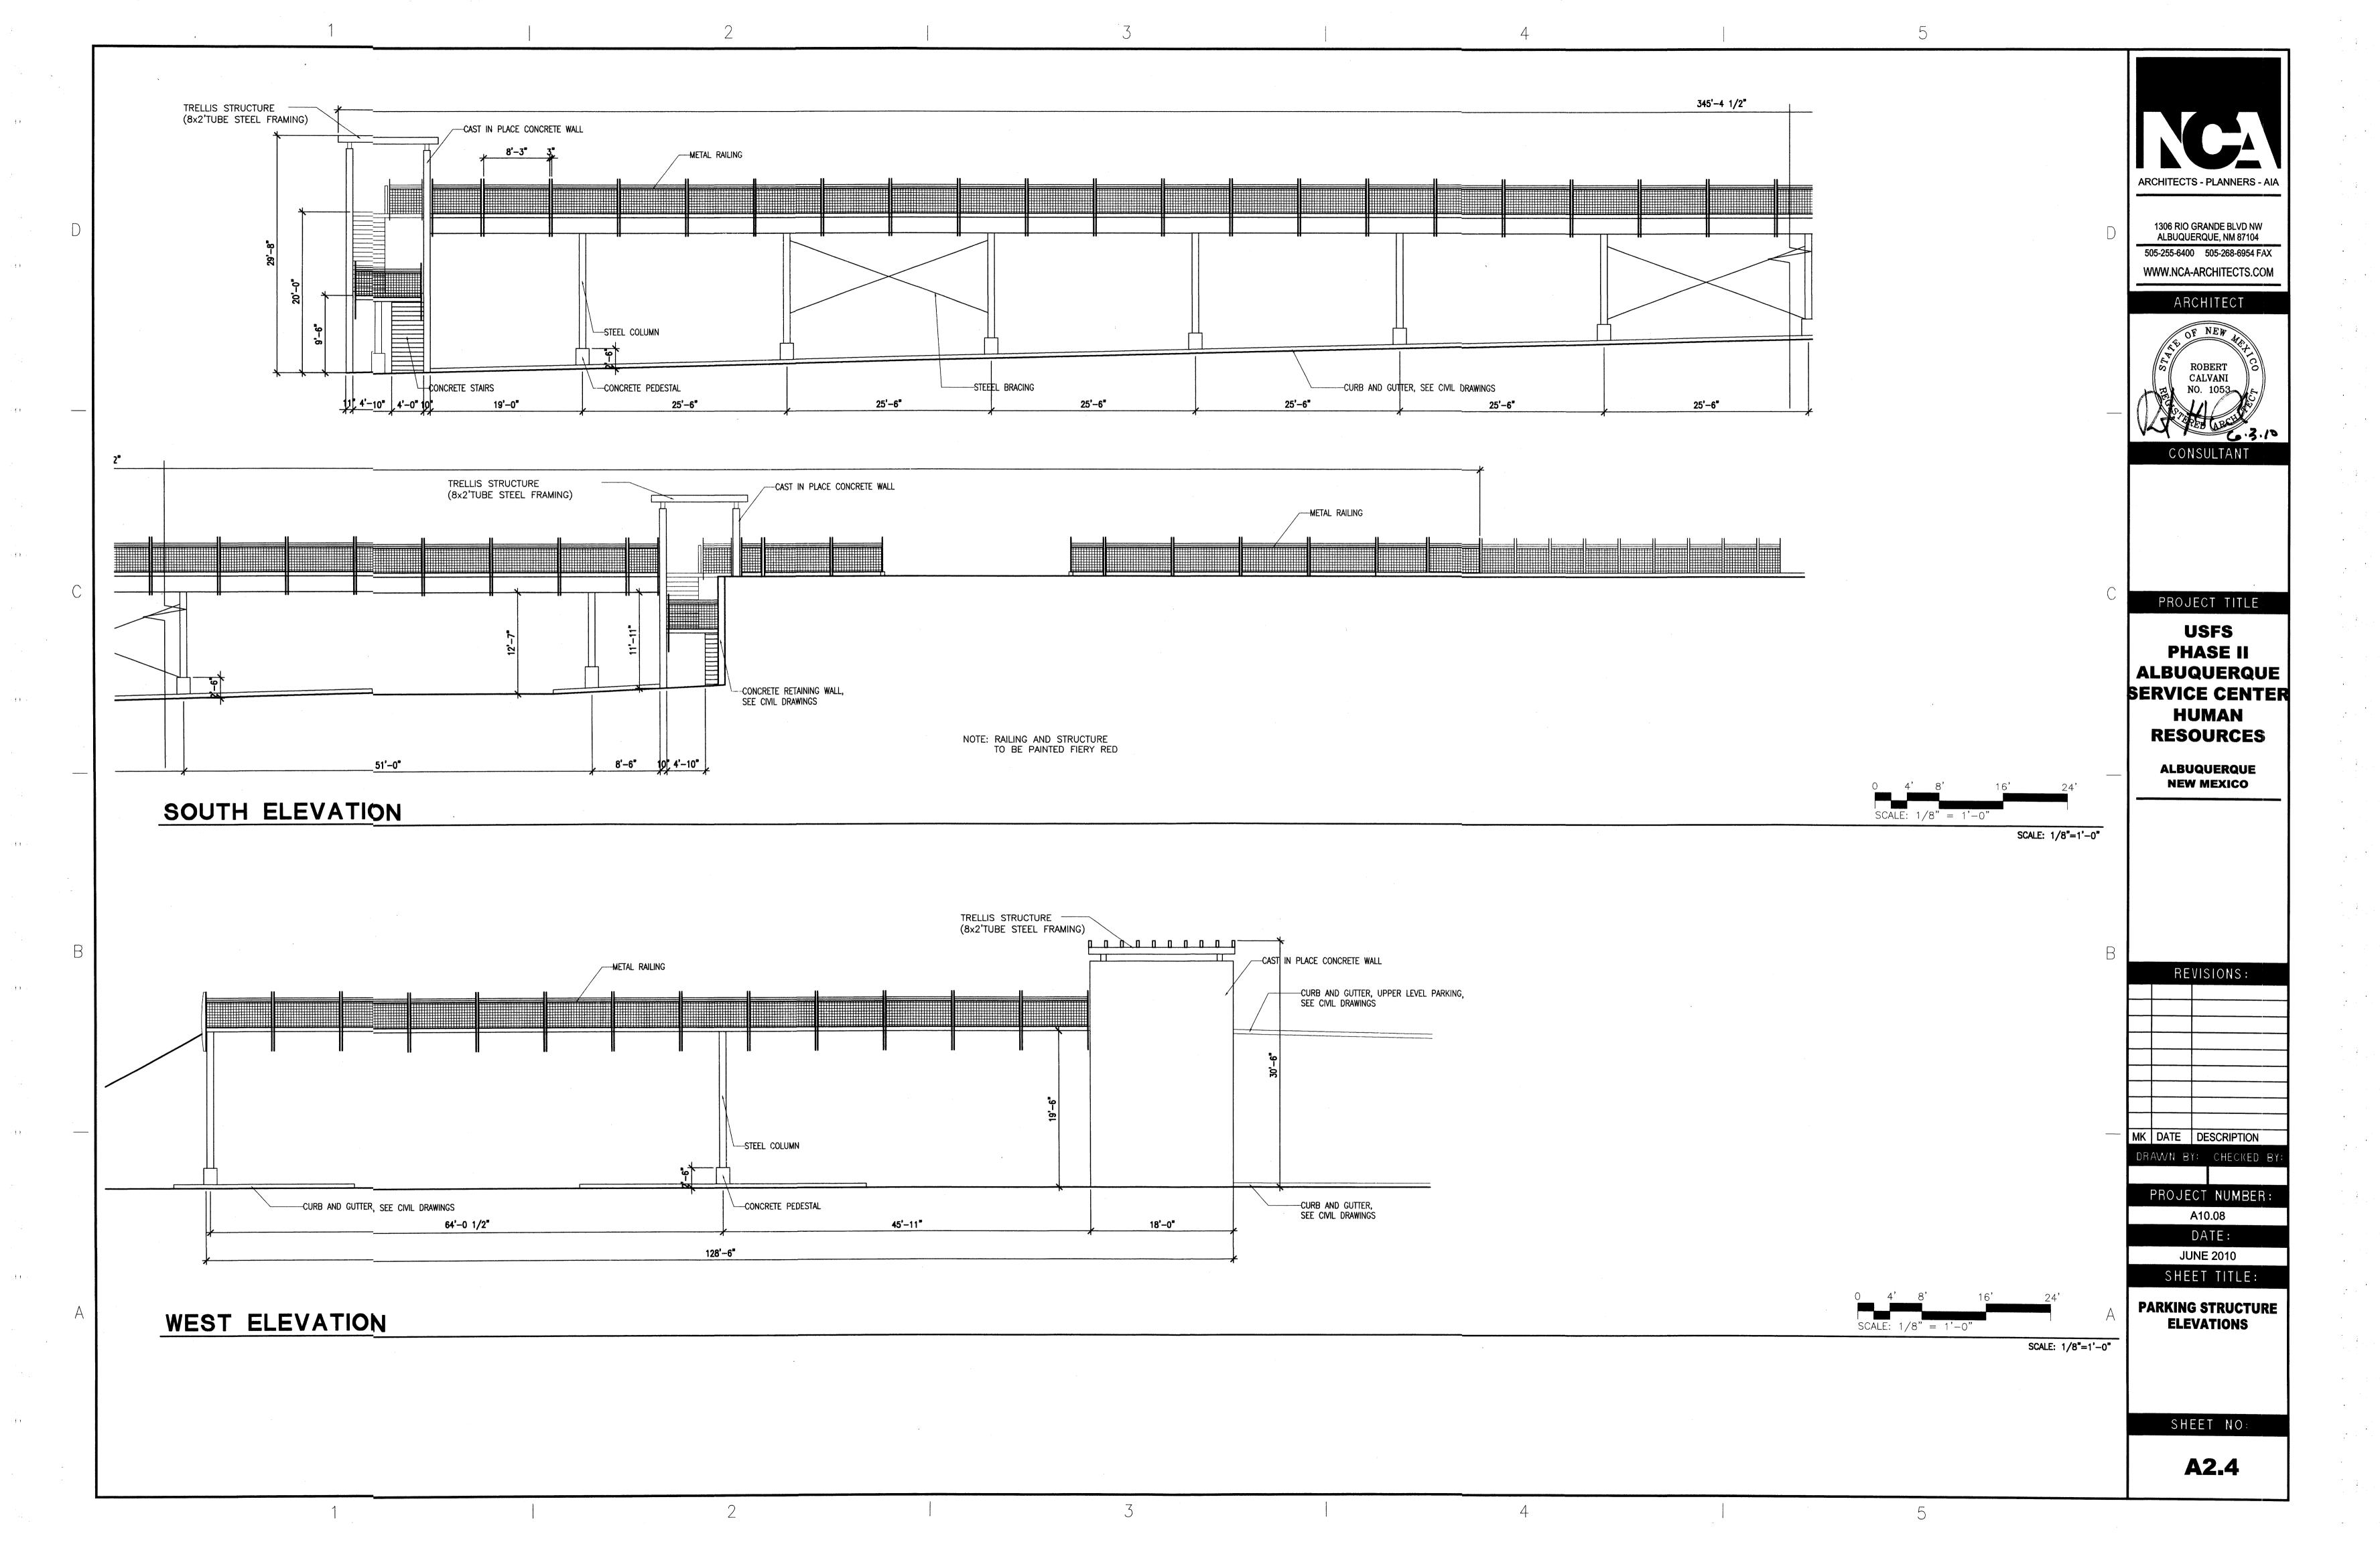

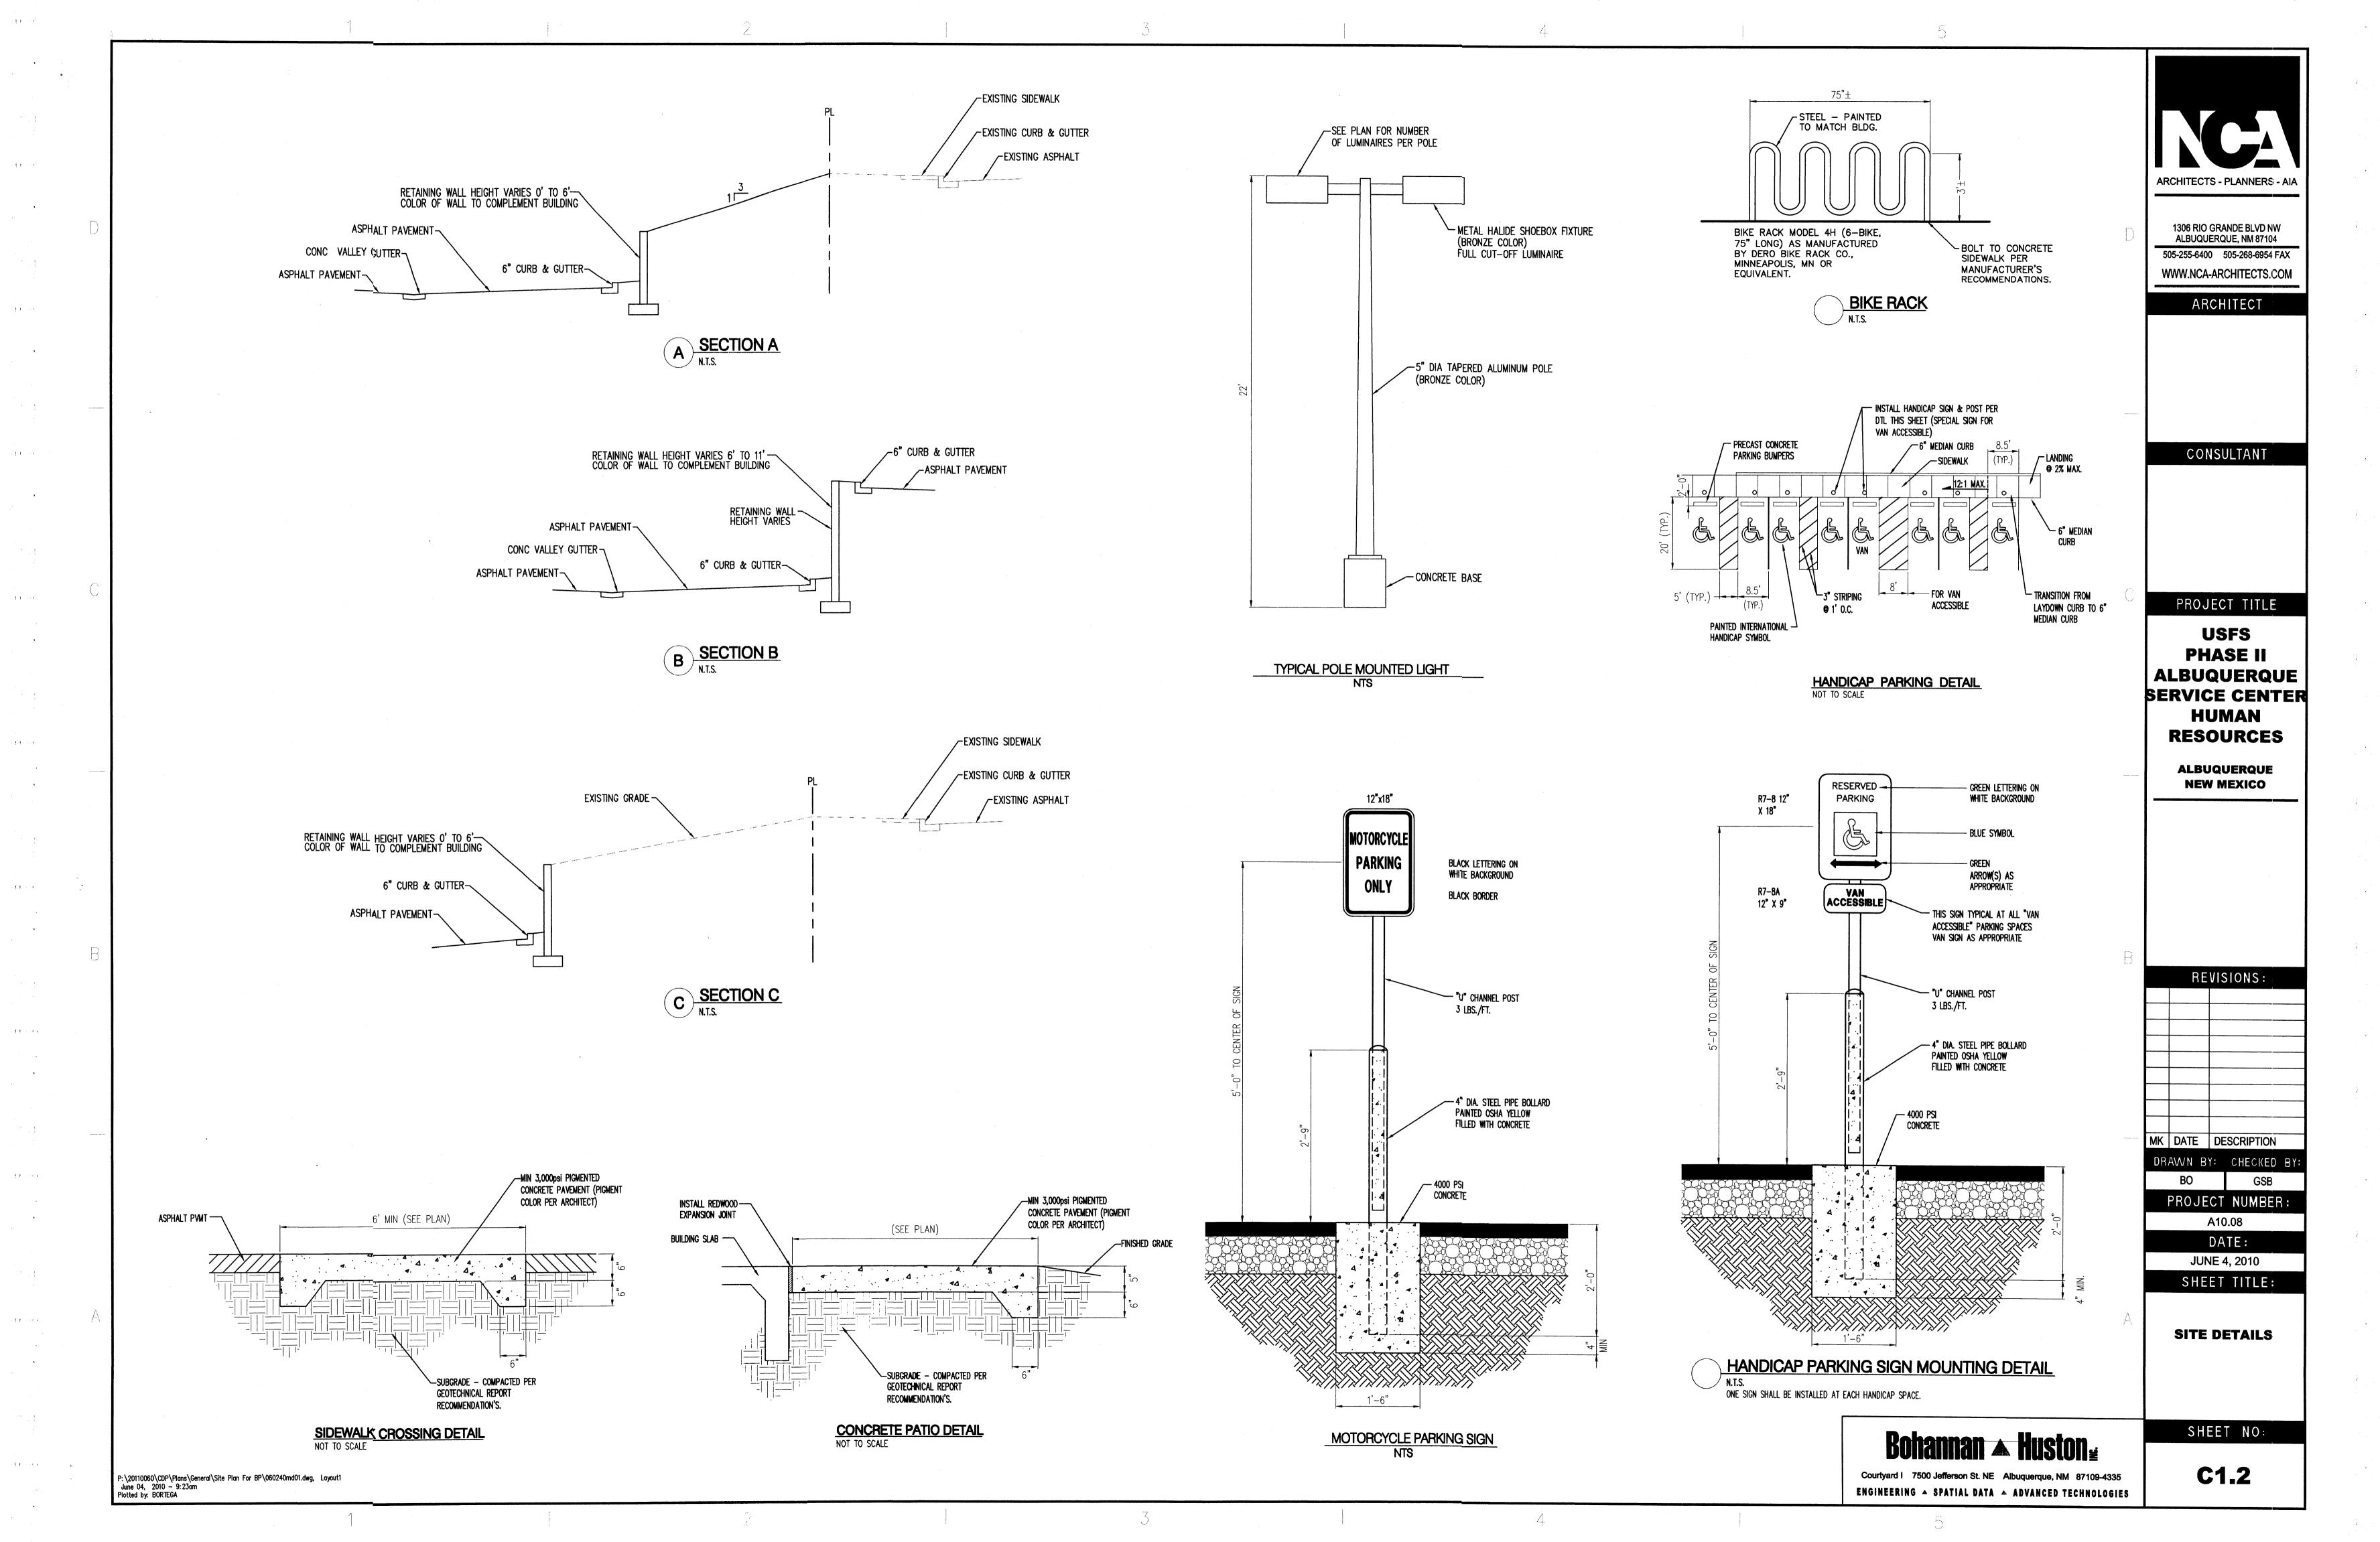

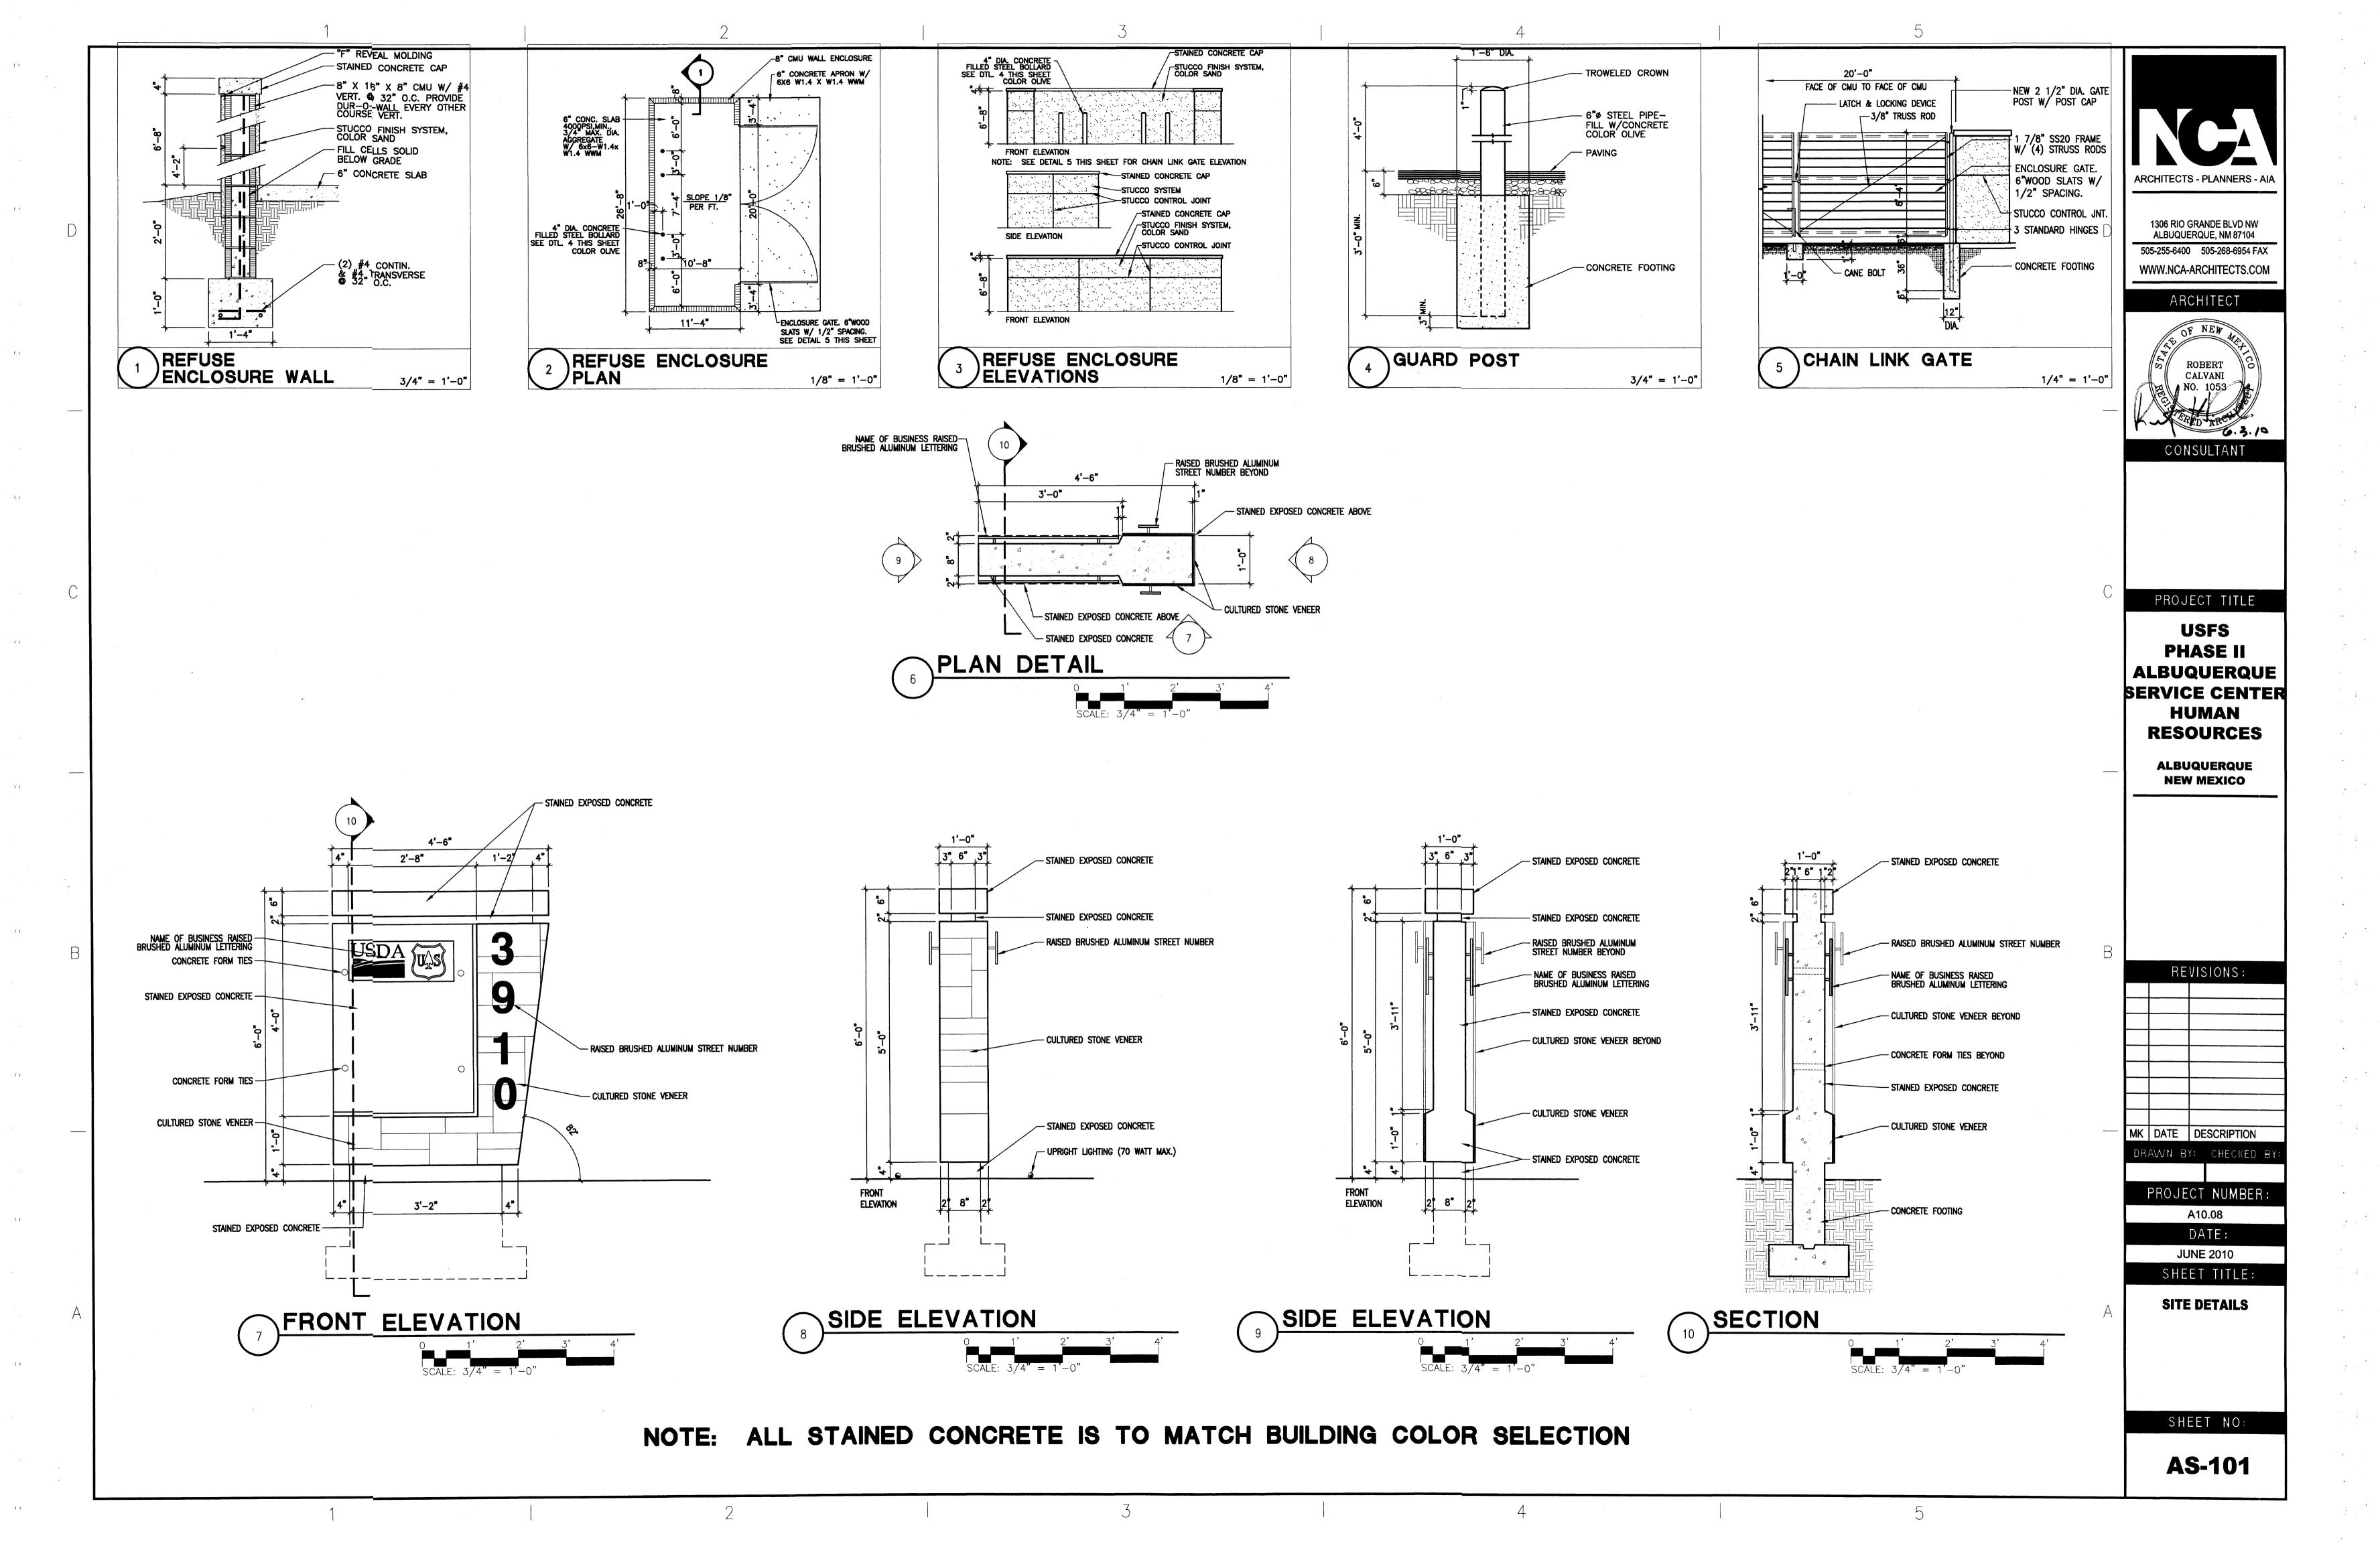

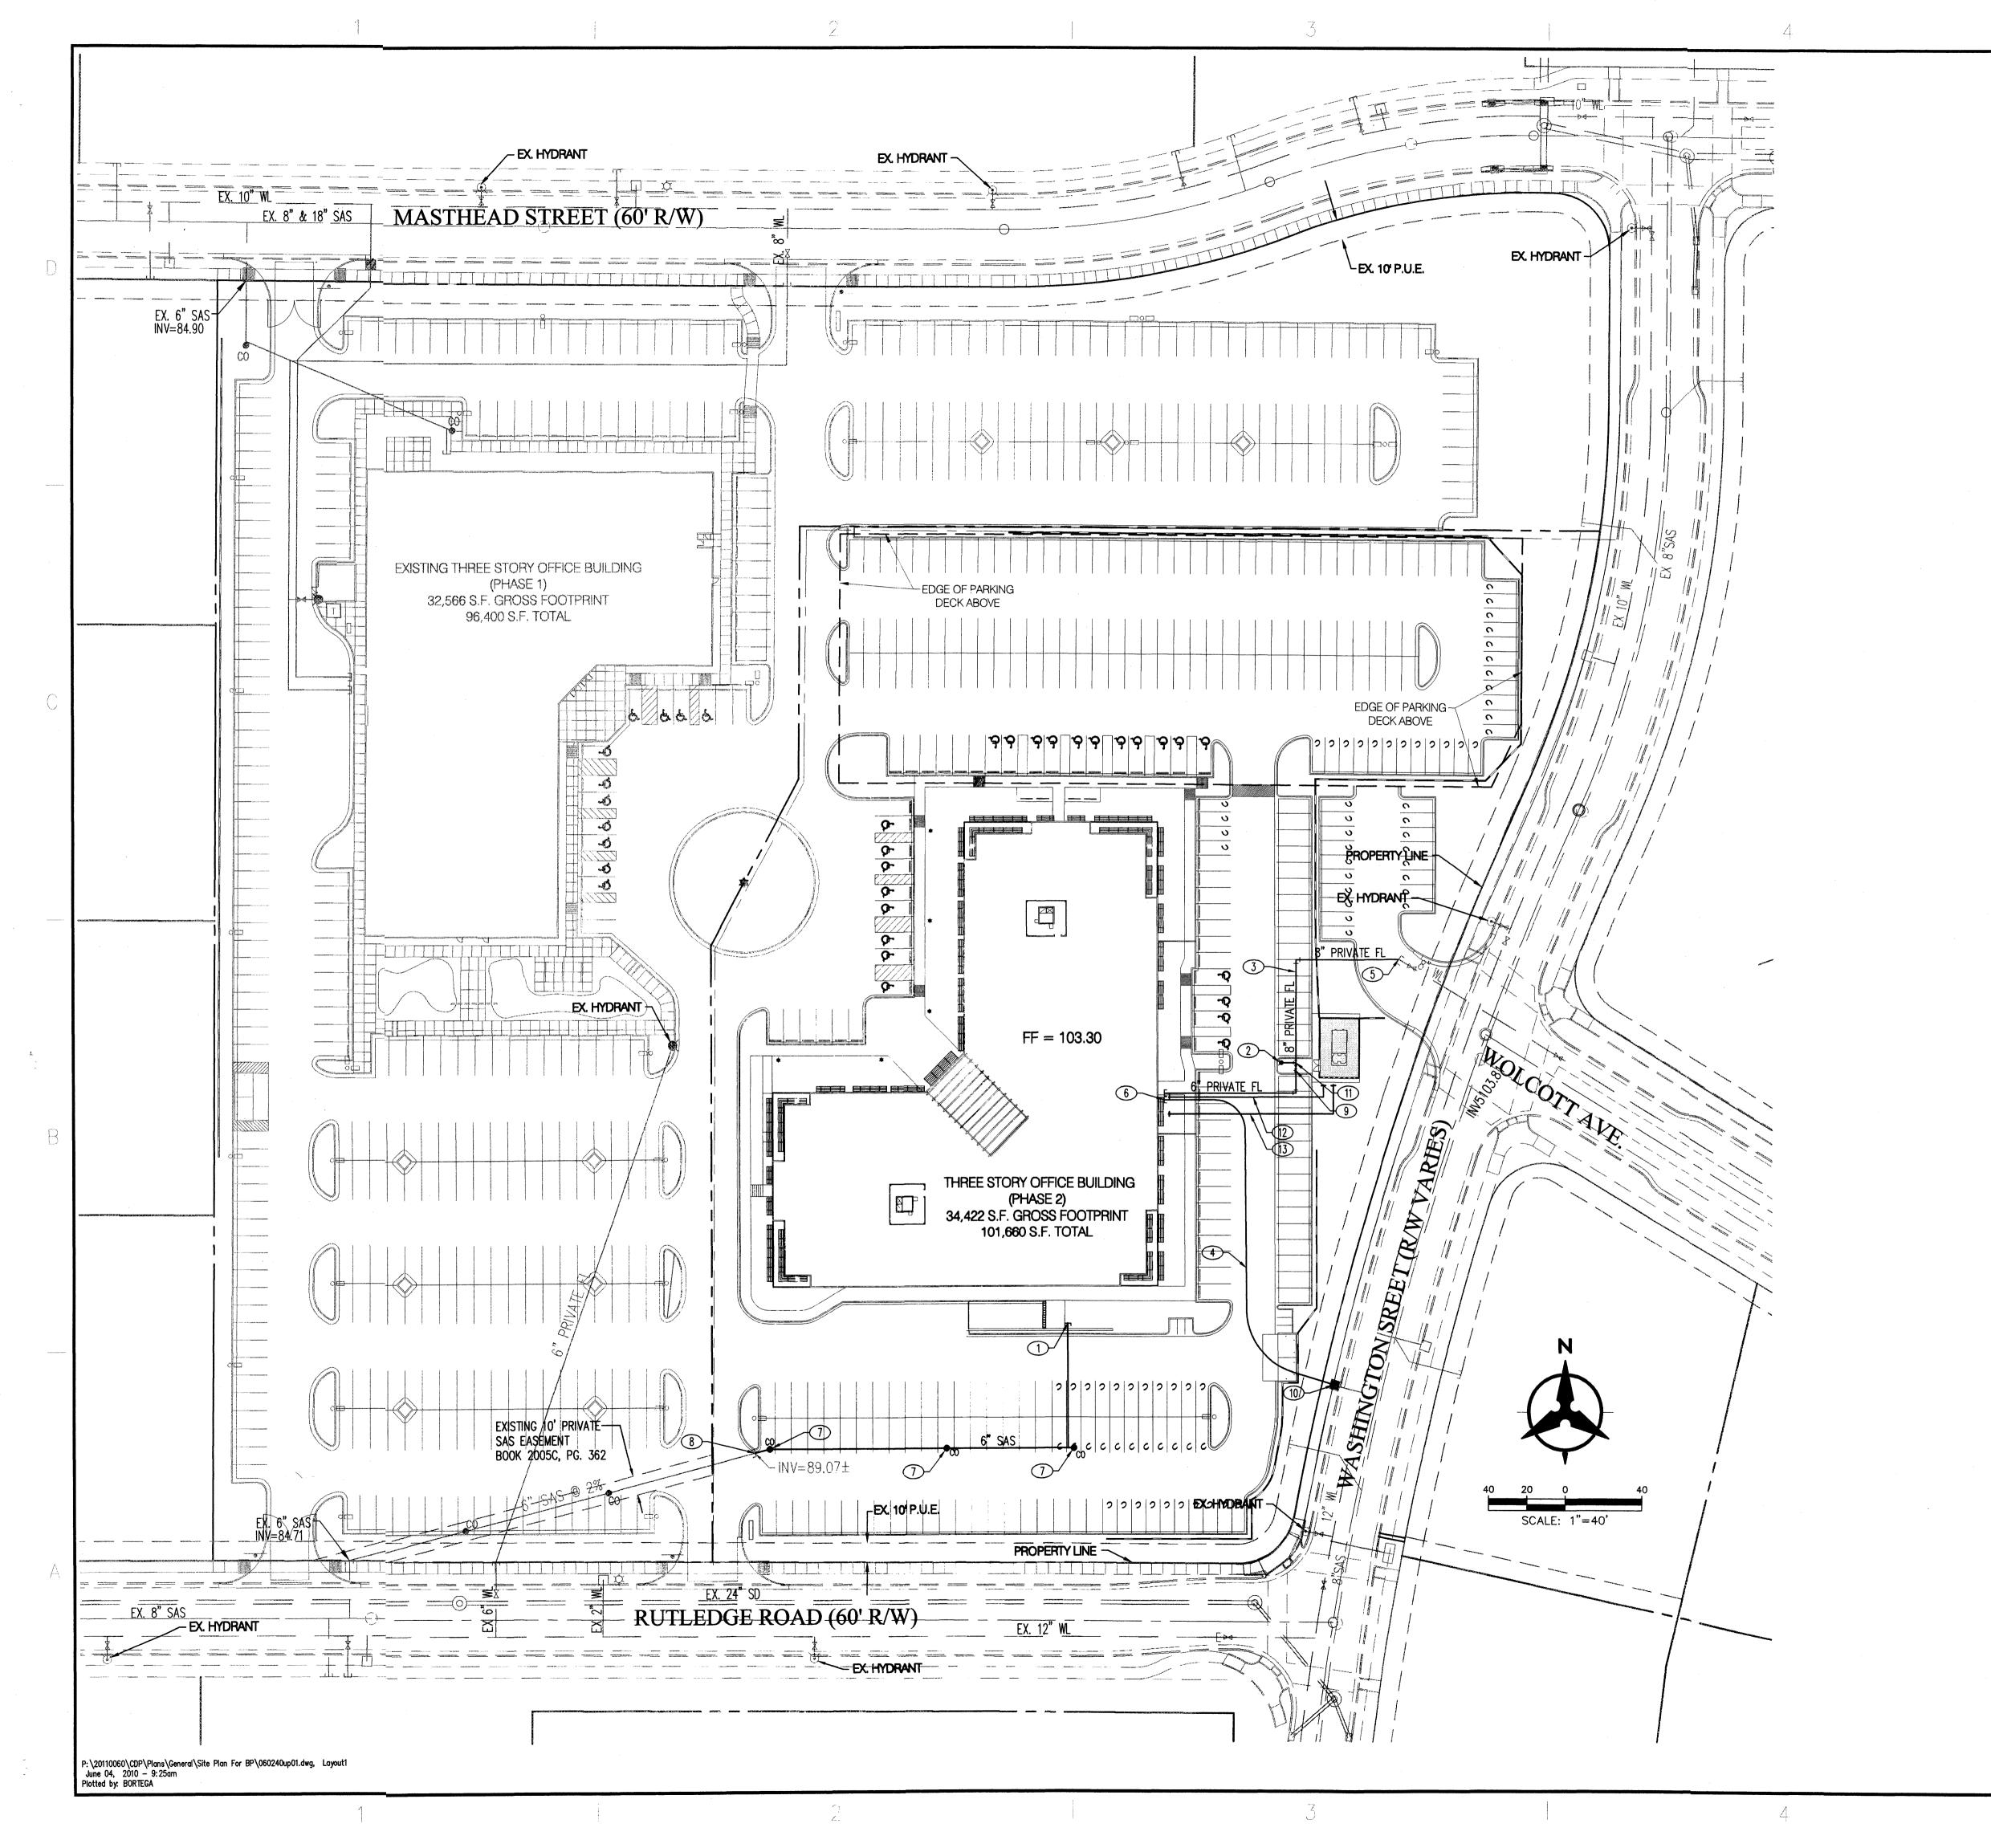

UTILITY NOTES

- 1. THIS CONTRACTOR SHALL BE RESPONSIBLE FOR THE COMPLETE INSTALLATION OF ALL WORK RELATED TO MECHANICAL UTILITIES AS SHOWN ON THIS PLAN INCLUDING: TRENCHING, BACKFILL, SUPPORTS, CLEANOUT PADS, SERVICE STOPS AND BOXES, SERVICE LINES, TESTING, CLEANING, AND STERILIZING. ANY WORK NOT ACCEPTED BY THE ARCHITECT OR ENGINEER DUE TO IMPROPER WORKMANSHIP OR LACK OF PROPER COORDINATION SHALL BE REMOVED AND CORRECTLY INSTALLED AT THE CONTRACTOR'S EXPENSE, AS DIRECTED.
- 2. MINIMUM DEPTHS OF COVER SHALL BE: 36" FOR WATERLINES AND 48" FOR SEWER, EXCEPT AT BUILDING CONNECTION.
- 3. ALL WORK DETAILED ON THESE PLANS TO BE PERFORMED UNDER CONTRACT SHALL, EXCEPT AS OTHERWISE STATED OR PROVIDED OF HEREON, BE CONSTRUCTED IN ACCORDANCE WITH THE IAPMO UNIFORM PLUMBING CODE LATEST EDITION.
- 4. UTILITY LINES SHALL BE INSTALLED PRIOR TO PAVEMENT, CURB AND GUTTER, AND/OR SIDEWALK, AS
- 5. ROUGH GRADING OF SITE (±0.5") SHALL BE COMPLETED PRIOR TO INSTALLATION OF UTILITY LINES.
- 6. CONTRACTOR WILL BE RESPONSIBLE FOR CONNECTIONS TO BUILDING DRAIN LINES AND ALL NECESSARY FITTINGS.
- 7. ALL VALVES SHALL BE ANCHORED PER COA STANDARD DWG. 2333.
- 8. FIRE LINES SHALL USE PIPE MATERIALS UNDERWRITERS LABORATORIES LISTED AND APPROVED FOR FIRE SERVICE.
- 9. CONTRACTOR SHALL BE RESPONSIBLE FOR ALL WATER METER, FIRE LINE, AND SEWER HOOKUP FEES FOR INSTALLATIONS. OWNER SHALL BE RESPONSIBLE FOR UTILITY EXPANSION CHARGES, PRORATA AND OTHER SPECIAL ASSESSMENTS.
- 10. CONTRACTOR SHALL VERIFY INVERTS AND LOCATIONS OF EXISTING WATER/SAS LINES PRIOR TO BEGINNING WORK. ALL CONFLICTS SHALL BE BROUGHT TO ATTENTION OF THE ENGINEER AND RESOLVED PRIOR TO BEGINNING WORK.

UTILITY KEYED NOTES

- 1. 6" SANITARY SEWER STUB, SEE PLUMBING PLANS FOR CONTINUATION.
- 2. NEW PRIVATE FIRE HYDRANT PER COA STD DWG 2340.
- 3. 8" PRIVATE FIRE LINE SERVICE FOR BUILDING SPRINKLERS.
 BACKFLOW PREVENTER TO BE INSTALLED INSIDE MECHANICAL ROOM.
 FDC TO BE LOCATED ON BUILDING WALL. FIRE LINE PIPE JOINTS AND
 MECHANICAL JOINTS SHALL BE RESTRAINED FOR ENTIRE LENGTH.
 PROVIDE 3' MINIMUM COVER, VERTICAL BENDS AS REQUIRED (NOT > 22.5').
- 4. NEW 2 1/2" METERED WATER SERVICE. CONNECT TO EXISTING 2" WATER LINE STUB OUT.
- 5. CONNECTION TO EXISTING 8" FIRE LINE STUB.
- 6. NEW 2 1/2" DOMESTIC WATER SERVICE TO BUILDING, BACKFLOW PREVENTER SHALL BE INSIDE MECHANICAL ROOM.
- 7. SANITARY SEWER CLEANOUT.
- 8. CONNECT TO EX. 6" SAS STUB PROVIDED TO SITE WITH PHASE 1
- 9. POST INDICATOR VALVE.
- 10. EXISTING 1 1/2" WATER SERVICE LINE AND METER BOX. CONTRACTOR SHALL COORDINATE AND PAY FOR CITY INSTALLATION OF METER.
- 11. 8"X6" TEE AND 8"X6" REDUCER.
- 12. NEW 1" WATER LINE FOR MAKE-UP WATER TO COOLING TOWER SEE PLUMBING PLANS.
- 13. NEW 4"SAS SEE PLUMBING PLANS FOR INVERTS AND CONTINUATION.

LEGEND

PROPERTY LINE
EX SANITARY SEWER & MANI
EX STORM DRAIN & MANHOLI
ex inlet
EX WATER LINE
ex valve
EX METER
ex fire hydrant
ex street light
PROPOSED SANITARY SEWER
PROPOSED CLEANOUT
PROPOSED WATERLINE

Bohannan 🔺 Huston

Courtyard | 7500 Jefferson St. NE Albuquerque, NM 87109-4335

ENGINEERING A SPATIAL DATA A ADVANCED TECHNOLOGIES

NGA\

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ARCHITECTS - PLANNERS - AIA

ARCHITECT

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CONSULTANT

PROJECT TITLE

USFS
PHASE II
ALBUQUERQUE
SERVICE CENTER
HUMAN
RESOURCES

ALBUQUERQUE NEW MEXICO

REVISIONS:

MK DATE DESCRIPTION

DRAWN BY: CHECKED BY

BO GSB PROJECT NUMBER:


PROJECT NUMBER A10.08 DATE:

JUNE 4, 2010 SHEET TITLE:

CONCEPTUAL UTILITY PLAN

SHEET NO:

C3.0

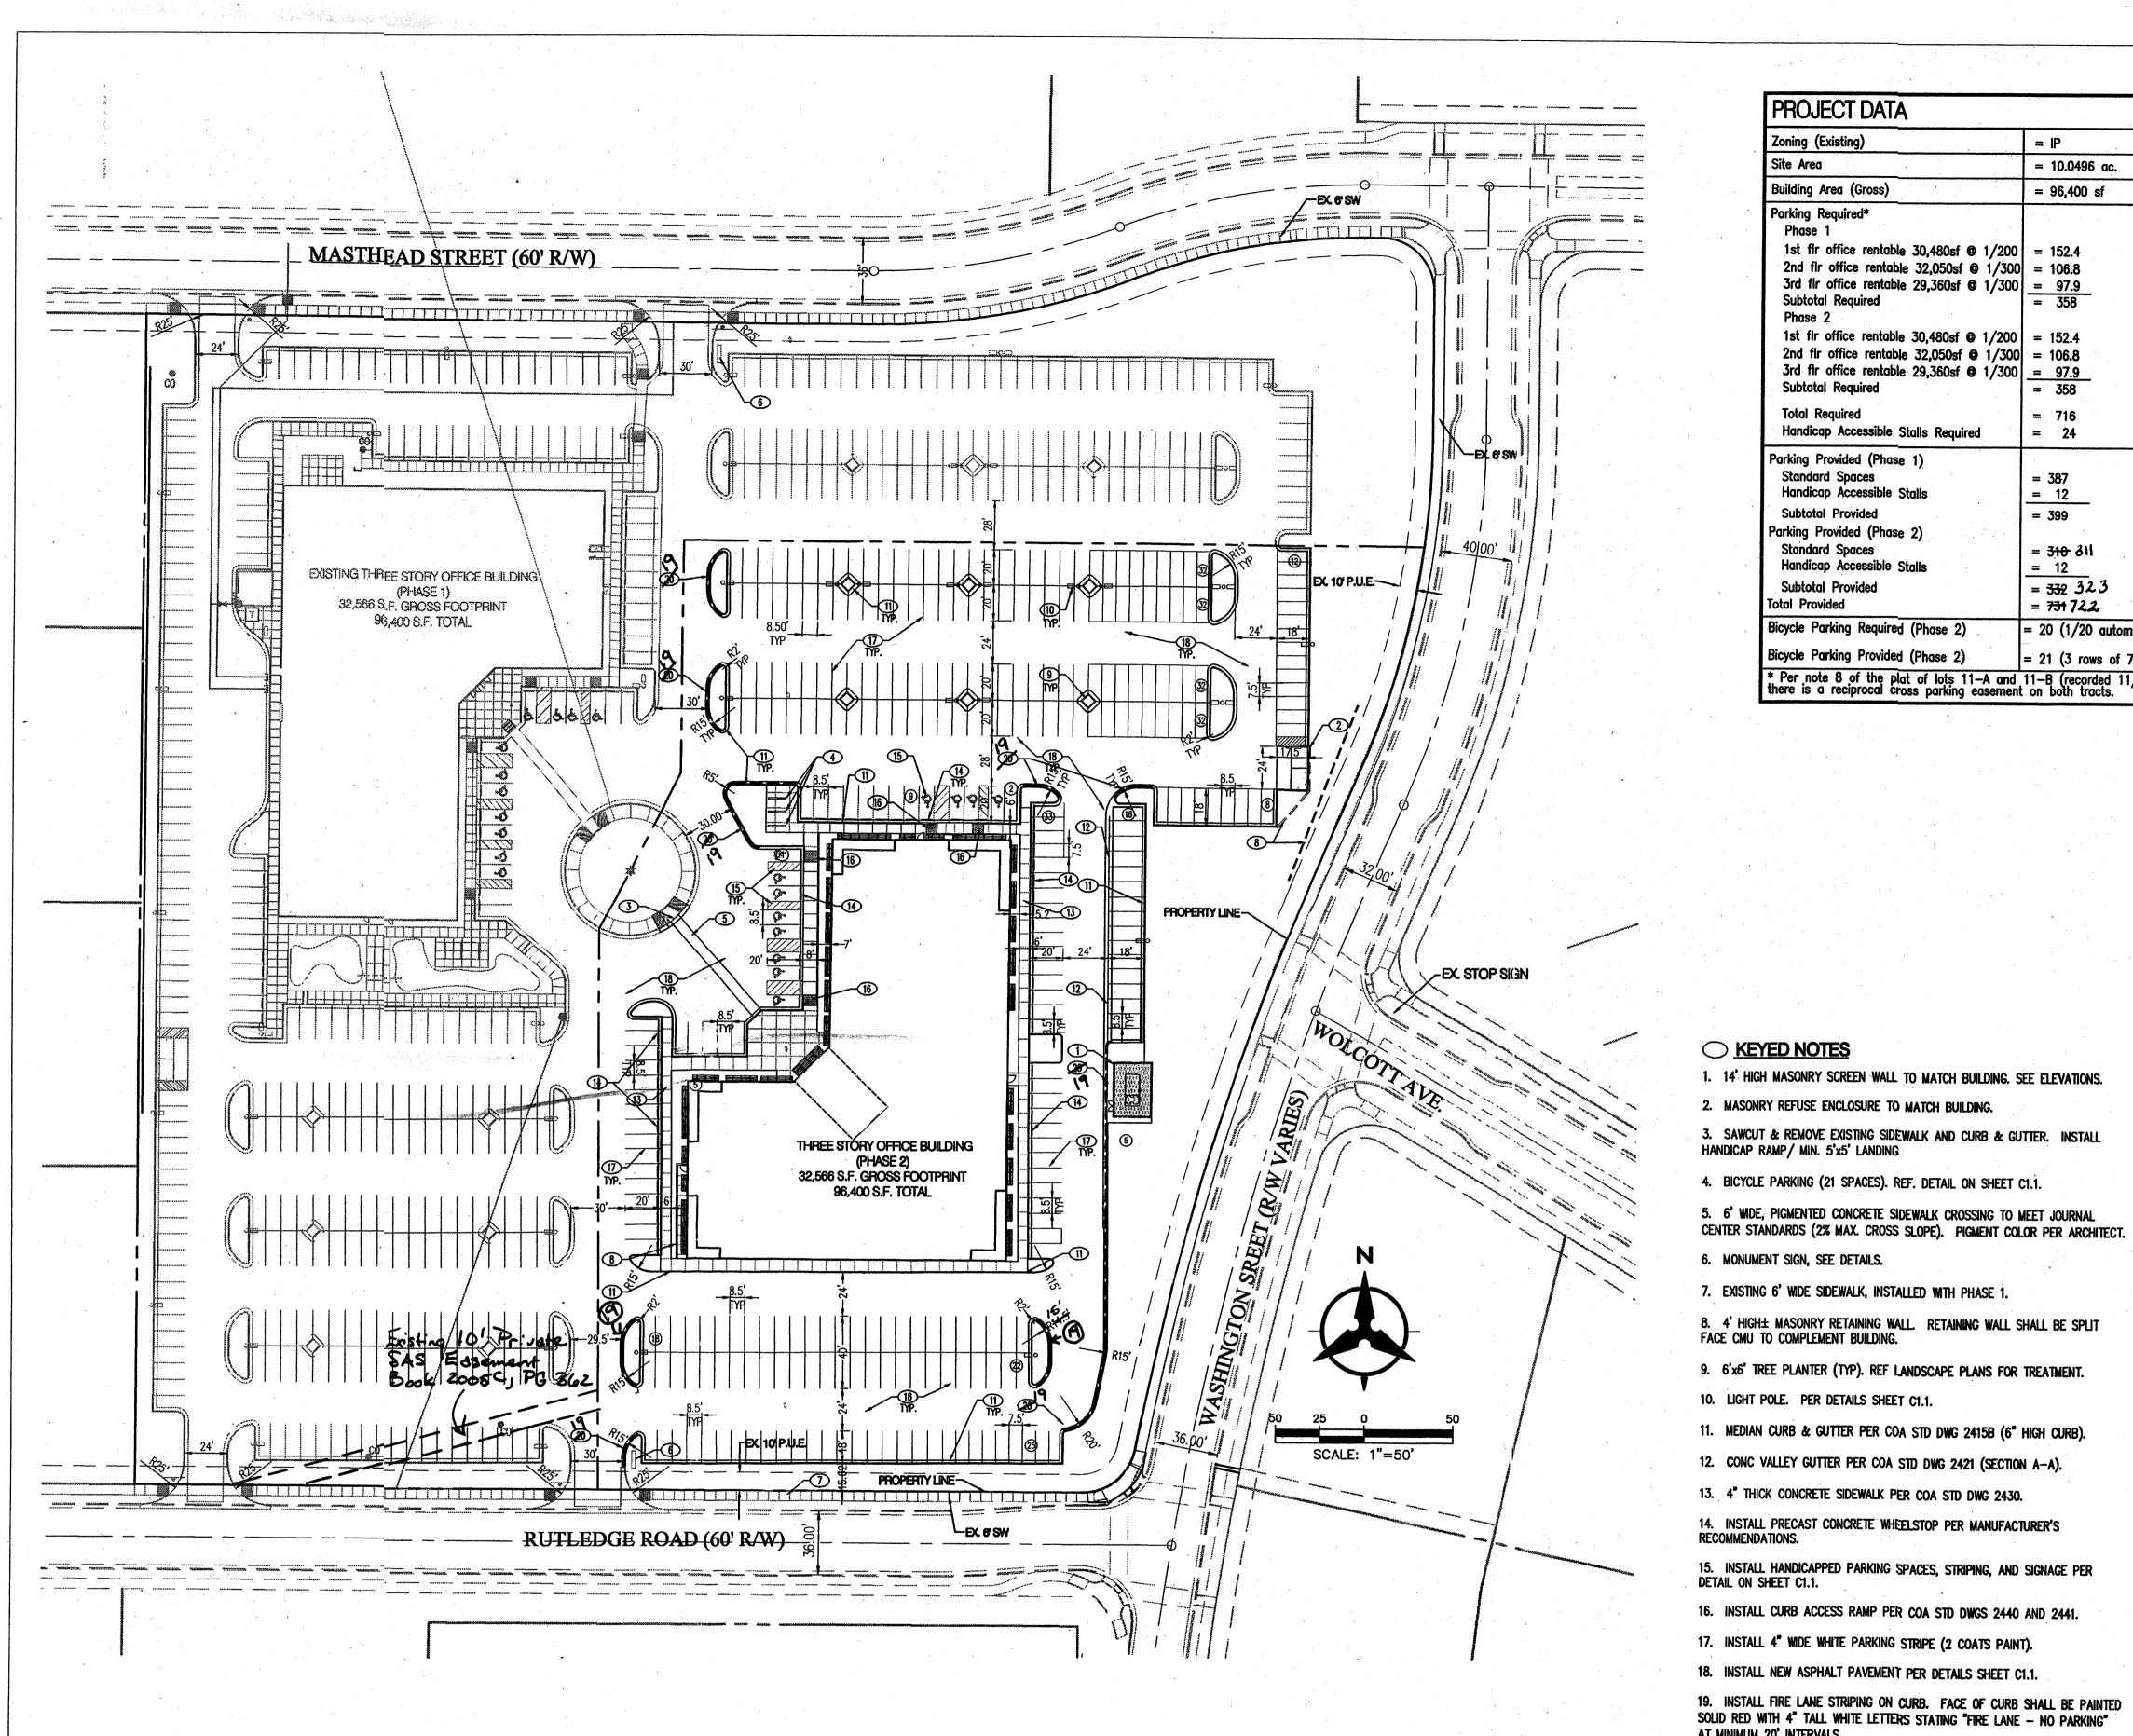

PROJECT DATA Zoning (Existing) = IP Site Area = 10.0496 ac. **Building Area (Gross)** = 96,400 sfParking Required* 1st fir office rentable 30,480sf @ 1/200 | = 152.4 2nd flr office rentable 32,050sf @ 1/300 = 106.8 3rd flr office rentable 29,360sf @ 1/300 = 97.9 Subtotal Required Phase 2 1st flr office rentable 30,480sf @ 1/200 = 152.4 2nd fir office rentable 32,050sf @ 1/300 = 106.8 3rd flr office rentable 29,360sf € 1/300 = 97.9 Subtotal Required **Total Required** = 716 Handicap Accessible Stalls Required Parking Provided (Phase 1) Standard Spaces = 387 Handicap Accessible Stalls = 12 Subtotal Provided = 399 Parking Provided (Phase 2) Standard Spaces = 310 311 Handicap Accessible Stalls = 12 Subtotal Provided = 332323Total Provided = 731722Bicycle Parking Required (Phase 2) = 20 (1/20 automobile spaces) Bicycle Parking Provided (Phase 2) = 21 (3 rows of 7 each) * Per note 8 of the plat of lots 11—A and 11—B (recorded 11/03/2005) there is a reciprocal cross parking easement on both tracts.

SU-1 M-1 PERM USES ZONE ATLAS PAGE D-17-Z SCALE: 1"=600'±

LEGAL DESCRIPTION

ALBUQUERQUE, NM, NOVEMBER, 2005

TRACT 11-B OF JOURNAL CENTER UNIT 2, PHASE 2

1306 RIO GRANDE BLVD NW ALBUQUERQUE, NM 87104 505-255-6400 505-268-6954 FAX WW.NCA-ARCHITECTS.COM

ARCHITECT

CONSULTANT

PROJECT TITLE

JDS

BJS

JOB NUMBER:

A0559

DATE:

MAY 17, 2006

SHEET NO

C1.0

1004556

<u>6-14-06</u> Date

Application Number:

PROJECT NUMBER:

06 DRB-00707

is an Infrastructure List required? () Yes (X) No If yes, then a set of approved DRC plans with a work order is required for any construction within Public Right-of-Way or for construction of public improvements.

DRB SITE DEVELOPMENT PLAN APPROVAL:

Traffic Engineering, Transportation Division

Michael Holton Solid Waste Management

*Environmental Health, if necessary

Bohannan A Huston

Courtyard I 7500 Jefferson St. NE Albuquerque, NM 87109-4335 ENGINEERING & SPATIAL DATA A ADVANCED TECHNOLOGIES

6/14/06 6/14/06 7/31/06 * Environmental Health Department (conditional) 8/1/06 Date MK DATE DESCRIPTION 8/1/06 DRAWN BY: CHECKED BY DRB Chairperson, Planning Department

P:\060240\cdp\general\SDP for BP\Site Development Plan.dwg, Layout1 May 18, 2006 — 3:14pm
Plotted by: JSMITH

DRAWING INDEX

C2.0 - PRELIMINARY GRADING PLAN

C3.0 - CONCEPTUAL UTILITY PLAN

C1.0 - SITE PLAN

C1.1 - SITE DETAILS

L1.0 - LANDSCAPE PLAN

A2.1 - BUILDING ELEVATIONS

A2.2 - BUILDING ELEVATIONS

AS1.1 - ARCH SITE DETAILS

CENTER 2 COMMON AREA IRRIGATION SYSTEM, THE DEVELOPER "TIBURON INVESTMENT, LLC" MUST BE CONTACTED.

1. SCREEN WALLS AND REFUSE ENCLOSURE SHALL BE ARCHITECTURALLY

3. SITE LIGHTING SHALL BE HORIZONTAL CUT - OFF TYPE AND MAXIMUM 24'

HIGH ABOVE GRADE. POLES AND FIXTURES SHALL BE PER JOURNAL CENTER

2. UTILITY BOXES SHALL BE SCREENED WITH MATURE LANDSCAPING.

4. ALL ROOF MOUNTED MECHANICAL EQUIPMENT SHALL BE SCREENED

5. AT THE TIME COMMON AREA IRRIGATION IS CONNECTED TO JOURNAL

SITE PLAN NOTES

COMPATABLE TO BUILDING.

7. EXISTING 6' WIDE SIDEWALK, INSTALLED WITH PHASE 1. 8. 4' HIGH± MASONRY RETAINING WALL. RETAINING WALL SHALL BE SPLIT FACE CMU TO COMPLEMENT BUILDING. 9. 6'x6' TREE PLANTER (TYP). REF LANDSCAPE PLANS FOR TREATMENT. 10. LIGHT POLE. PER DETAILS SHEET C1.1. 11. MEDIAN CURB & GUTTER PER COA STD DWG 2415B (6" HIGH CURB). 12. CONC VALLEY GUTTER PER COA STD DWG 2421 (SECTION A-A). 13. 4" THICK CONCRETE SIDEWALK PER COA STD DWG 2430. 14. INSTALL PRECAST CONCRETE WHEELSTOP PER MANUFACTURER'S RECOMMENDATIONS.

15. INSTALL HANDICAPPED PARKING SPACES, STRIPING, AND SIGNAGE PER DETAIL ON SHEET C1.1.


16. INSTALL CURB ACCESS RAMP PER COA STD DWGS 2440 AND 2441.

17. INSTALL 4" WIDE WHITE PARKING STRIPE (2 COATS PAINT).


18. INSTALL NEW ASPHALT PAVEMENT PER DETAILS SHEET C1.1.

19. INSTALL FIRE LANE STRIPING ON CURB. FACE OF CURB SHALL BE PAINTED SOLID RED WITH 4" TALL WHITE LETTERS STATING "FIRE LANE - NO PARKING" AT MINIMUM 20' INTERVALS.


REFUSE ENCLOSURE CONCRETE PAVEMENT

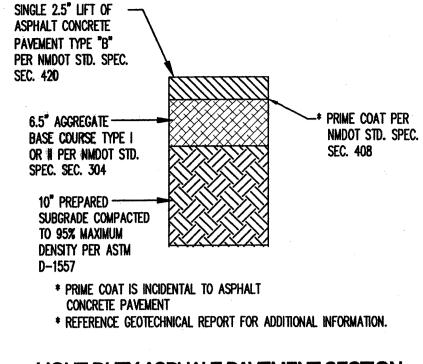


LIGHT DUTY ASPHALT PAVEMENT SECTION

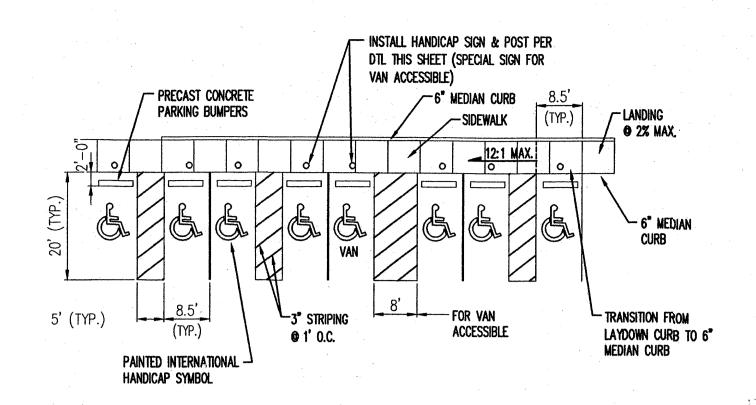

HANDICAP PARKING DETAIL

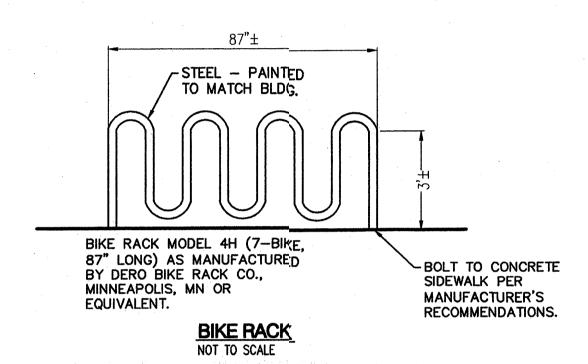

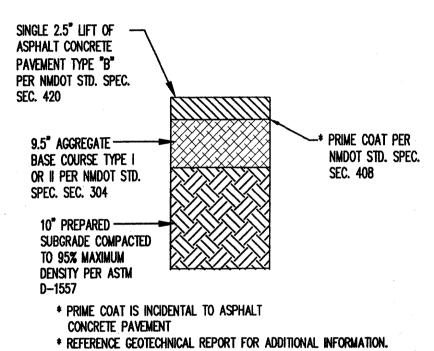

HEAVY DUTY ASPHALT PAVEMENT SECTION

- METAL HALIDE SHOEBOX FIXTURE (BRONZE COLOR). - STEEL POLE (BRONZE COLOR) - CONCRETE BASE

HANDICAP PARKING SIGN MOUNTING DETAIL

ONE SIGN SHALL BE INSTALLED AT EACH HANDICAP SPACE.

RESERVED -

PARKING

VAN ACCESSIBLE

R7-8 12"

12" X 9"

X 18"

- Green Lettering on

WHITE BACKGROUND

- BLUE SYMBOL

ARROW(S) AS

APPROPRIATE

- THIS SIGN TYPICAL AT ALL "VAN

ACCESSIBLE" PARKING SPACES

VAN SIGN AS APPROPRIATE

-4" DIA. STEEL PIPE BOLLARD

PAINTED OSHA YELLOW FILLED WITH CONCRETE

— "U" CHANNEL POST

3 LBS./FT.

CONCRETE

- Green

NOT TO SCALE

SIDEWALK CROSSING DETAIL NOT TO SCALE

SUBGRADE — COMPACTED PER GEOTECHNICAL REPORT RECOMMENDATION'S.

MIN 3,000psi PIGMENTED
CONCRETE PAVEMENT (PIGMENT
COLOR PER ARCHITECT)

BUILDING SLAB

6' MIN (SEE PLAN)

Bohannan A Huston

ASTHEAD OFFICE COMP AT JOURNAL CENTER REVISIONS MK DATE DESCRIPTION DRAWN BY: CHECKED BY JOB NUMBER: A0559 DATE: MAY 17, 2006 SHEET NO Courtyard I 7500 Jefferson St. NE Albuquerque, NM 87109-4335 C1.1 ENGINEERING & SPATIAL DATA & ADVANCED TECHNOLOGIES

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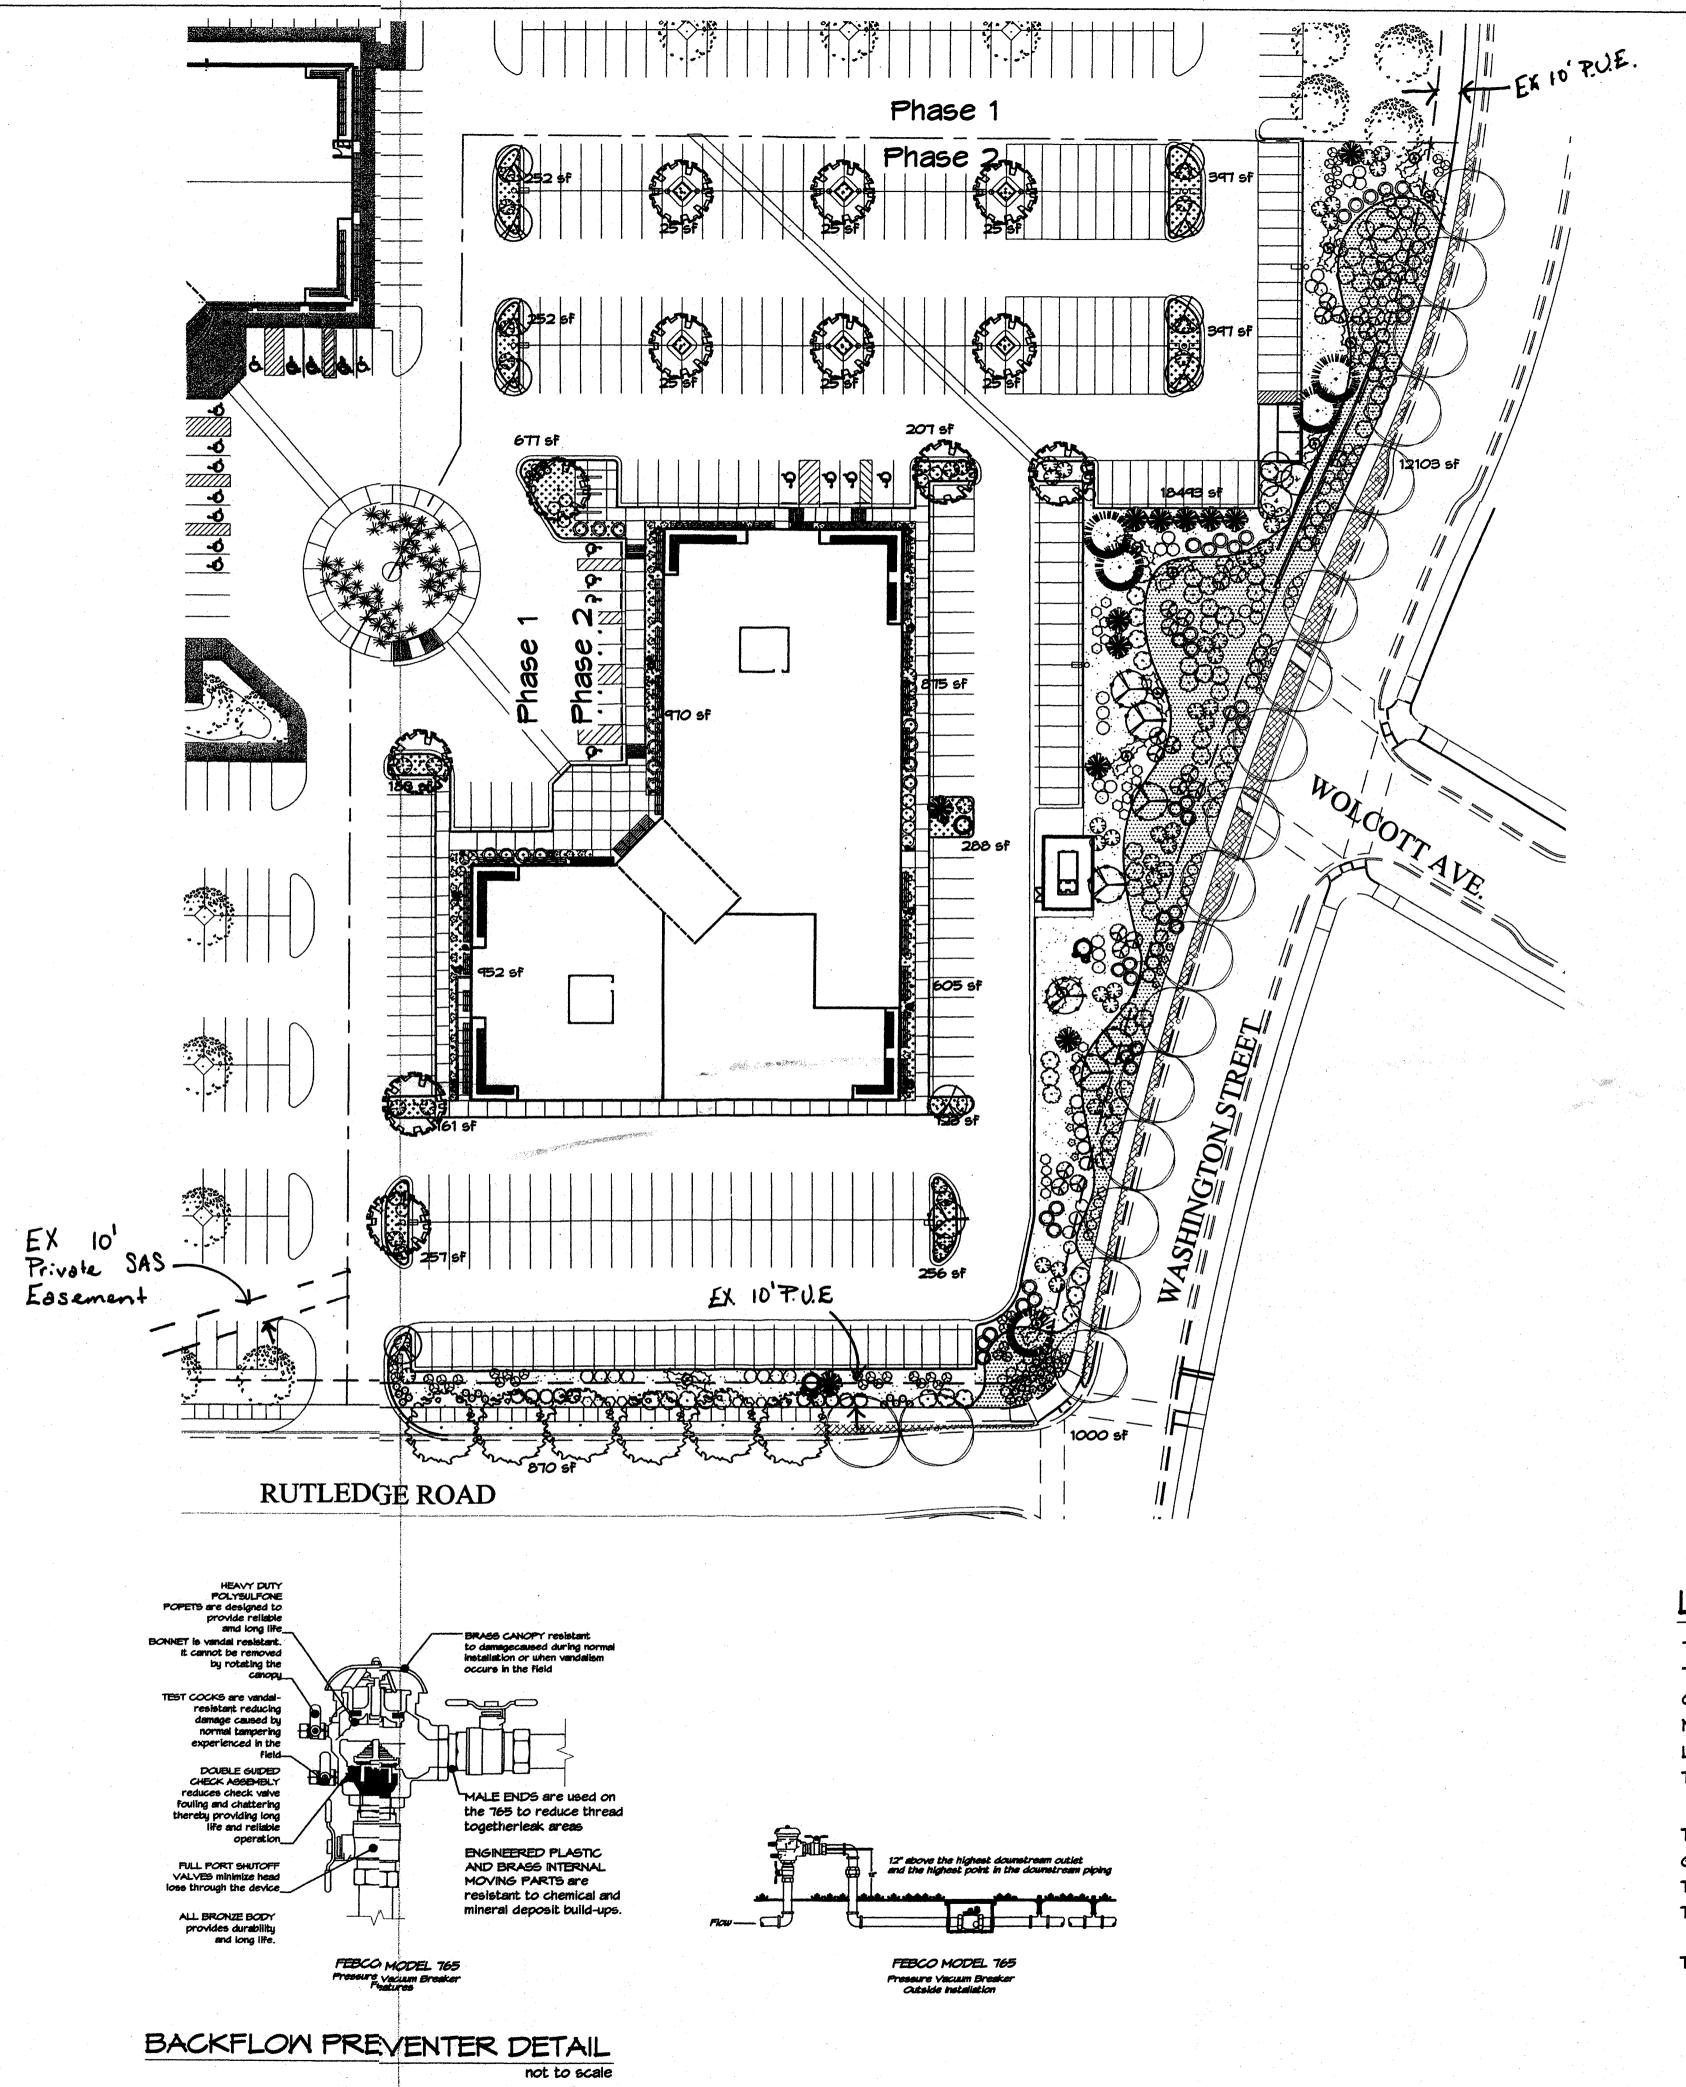
ARCHITECT

CONSULTANT

PROJECT TITLE

P:\060240\cdp\general\SDP for BP\Site Details.dwg, Layout1 May 18, 2006 — 3:17pm Plotted by: JSMITH

ASPHALT PVMT -



PLANT LEGEND

EXISTING BERINDA ASH MUGO PINE (M) 3 POWIS CASTLE SAGE (L) 28 Artimesia x powis castle 5 Gal. 25sf Pinus mugo 5 Gal. 36sf BERINDA ASH (H) 6 Fraxinus SPP. 2" Cal. WINTER JASMINE (L+) 68 CURLLEAF MTN MAHOGANY (L) 70 Carcorpus ledfolius 5 Gal. 1005F Jasminum nudiflorum 5 Gal. 144sf (PER THE JOURNAL CENTER REQUIREMENTS FOR STREET TREE WILDFLOWER 50 THREE-LEAF SUMAC (L) 38 Rhus trilobata 5 Gal. 36sf PARKSTRIP) CHINESE PISTACHE (M) 12 Pistachia chinensis 2" Cal. GREYLEAF COTONEASTER 36 Cotoneaster buxifolius APACHE PLUME (L) 67 Fallugia paradoxa 5 Gal. 42sf each symbol indicates 3 plants OAK (M) 8 Quercus spp. 2" Cal. BOULDERS (41) THREADGRASS (M) 89 Stipa tennuisima NATURAL EDGE AUTUMN SAGE (M) 60 SANTA ANA TAN GRAVEL WITH FILTER FABRIC Salvia greggii 5 Gal. SANTA FE BROWN GRAVEL WITH FILTER FABRIC LAVENDER (M) 34 GREY CRUSHERFINES Lavandula angustifolia WITH FILTER FABRIC 1 Gal. 95f THORNLESS HAMTHORN (M+) 5 Crataegus crus-galli inermis 15 Gal. 225sf OVERSIZED GRAVEL ARP ROSEMARY (M) 54 WITH FILTER FABRIC

Rosmarinus officianalis

5 Gal. 36sf

LANDSCAPE NOTES: Landscape maintenance shall be the responsibility of the Property Owner.

SOTOL 12 Dasylirion wheeleri 5 Gal. 36sf

It is the intent of this plan to comply with the City Of Albuquerque Water Conservation Landscaping and Water Waste Ordinance planting restriction approach. Approval of this plan does not constitute or imply exemption from water waste provisions of the Water Conservation Landscaping and Water Waste Ordinance.

Mater management is the sole responsibility of the Property Owner. All landscaping will be in conformance with the City of Albuquerque Zoning Code, Street Tree Ordinance, Pollen Ordinance, and Water Conservation Landscaping and Water Maste Ordinance. In general, water conservative, environmentally sound landscape principles will be followed in design and installation.

Plant beds shall achieve 75% live ground cover at maturity.

IRRIGATION NOTES:

Irrigation shall be a complete underground system with Trees to receive (5) 1.0 GPH Drip Emitters and Shrubs to receive (2) 1.0 GPH Drip Emitters. Drip and Bubbler systems to be tied to 1/2" polypipe with flush caps at each end.

Run time per each drip valve will be approximately 15 minutes per day, to be adjusted according to the season.

Point of connection for irrigation system is unknown at current time and will be coordinated in the field. Irrigation will be operated by automatic controller.

Location of controller to be field determined and power source for controller to be provided by others.


Irrigation maintenance shall be the responsibility of the Property Owner.

Mater and Power source shall be the responsibility of the Developer/Builder.


Should The Hilltop not receive a Grading and Drainage plan during the design process or the on site grades differ from the Grading and Drainage plan received. The Hilltop reserves the right to apply slope stabilization materials where the specified gravel will not be suitable. This will be addressed as an infield-change order.


LANDSCAPE CALCULATIONS

TOTAL LOT AREA	182360	square feet	
TOTAL BUILDINGS AREA	34975	square feet	
OFFSITE AREA	870	square feet	
NET LOT AREA	146515	square feet	
LANDSCAPE REQUIREMENT	15%	•	
TOTAL LANDSCAPE REQUIREMENT	21977	square feet	
TOTAL BED PROVIDED	39468	square feet	
GROUNDCOVER REQ.	75%	square feet	
TOTAL GROUNDCOVER REQUIREMENT	29601	square feet	
TOTAL GROUNDCOVER PROVIDED	29601	square feet	
TOTAL LANDSCAPE PROVIDED	39468	square feet	

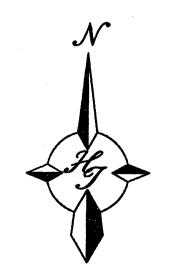

GRAPHIC SCALE

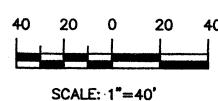

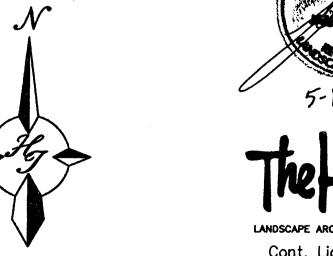

EXISTING LANDSCAPING

Cont. Lic. #26458 7909 Edith N.E. Albuquerque, NM 87184 Ph. (505) 898-9690 Fax (505) 898-7737 cjohnson@hilltoplandscaping.com All creative ideas contained Herein remains the property of The Hilltop Landscape Architects and ntractors and are protected by copyright laws. This is an original design and must not be released or copied unless applicable fees have been paid or job order




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AASTHEAD OFFICE (AT JOURNAL CEN

MK DATE DESCRIPTION A0559 **NOVEMBER 2005**

1 5-17-06 site revision adf

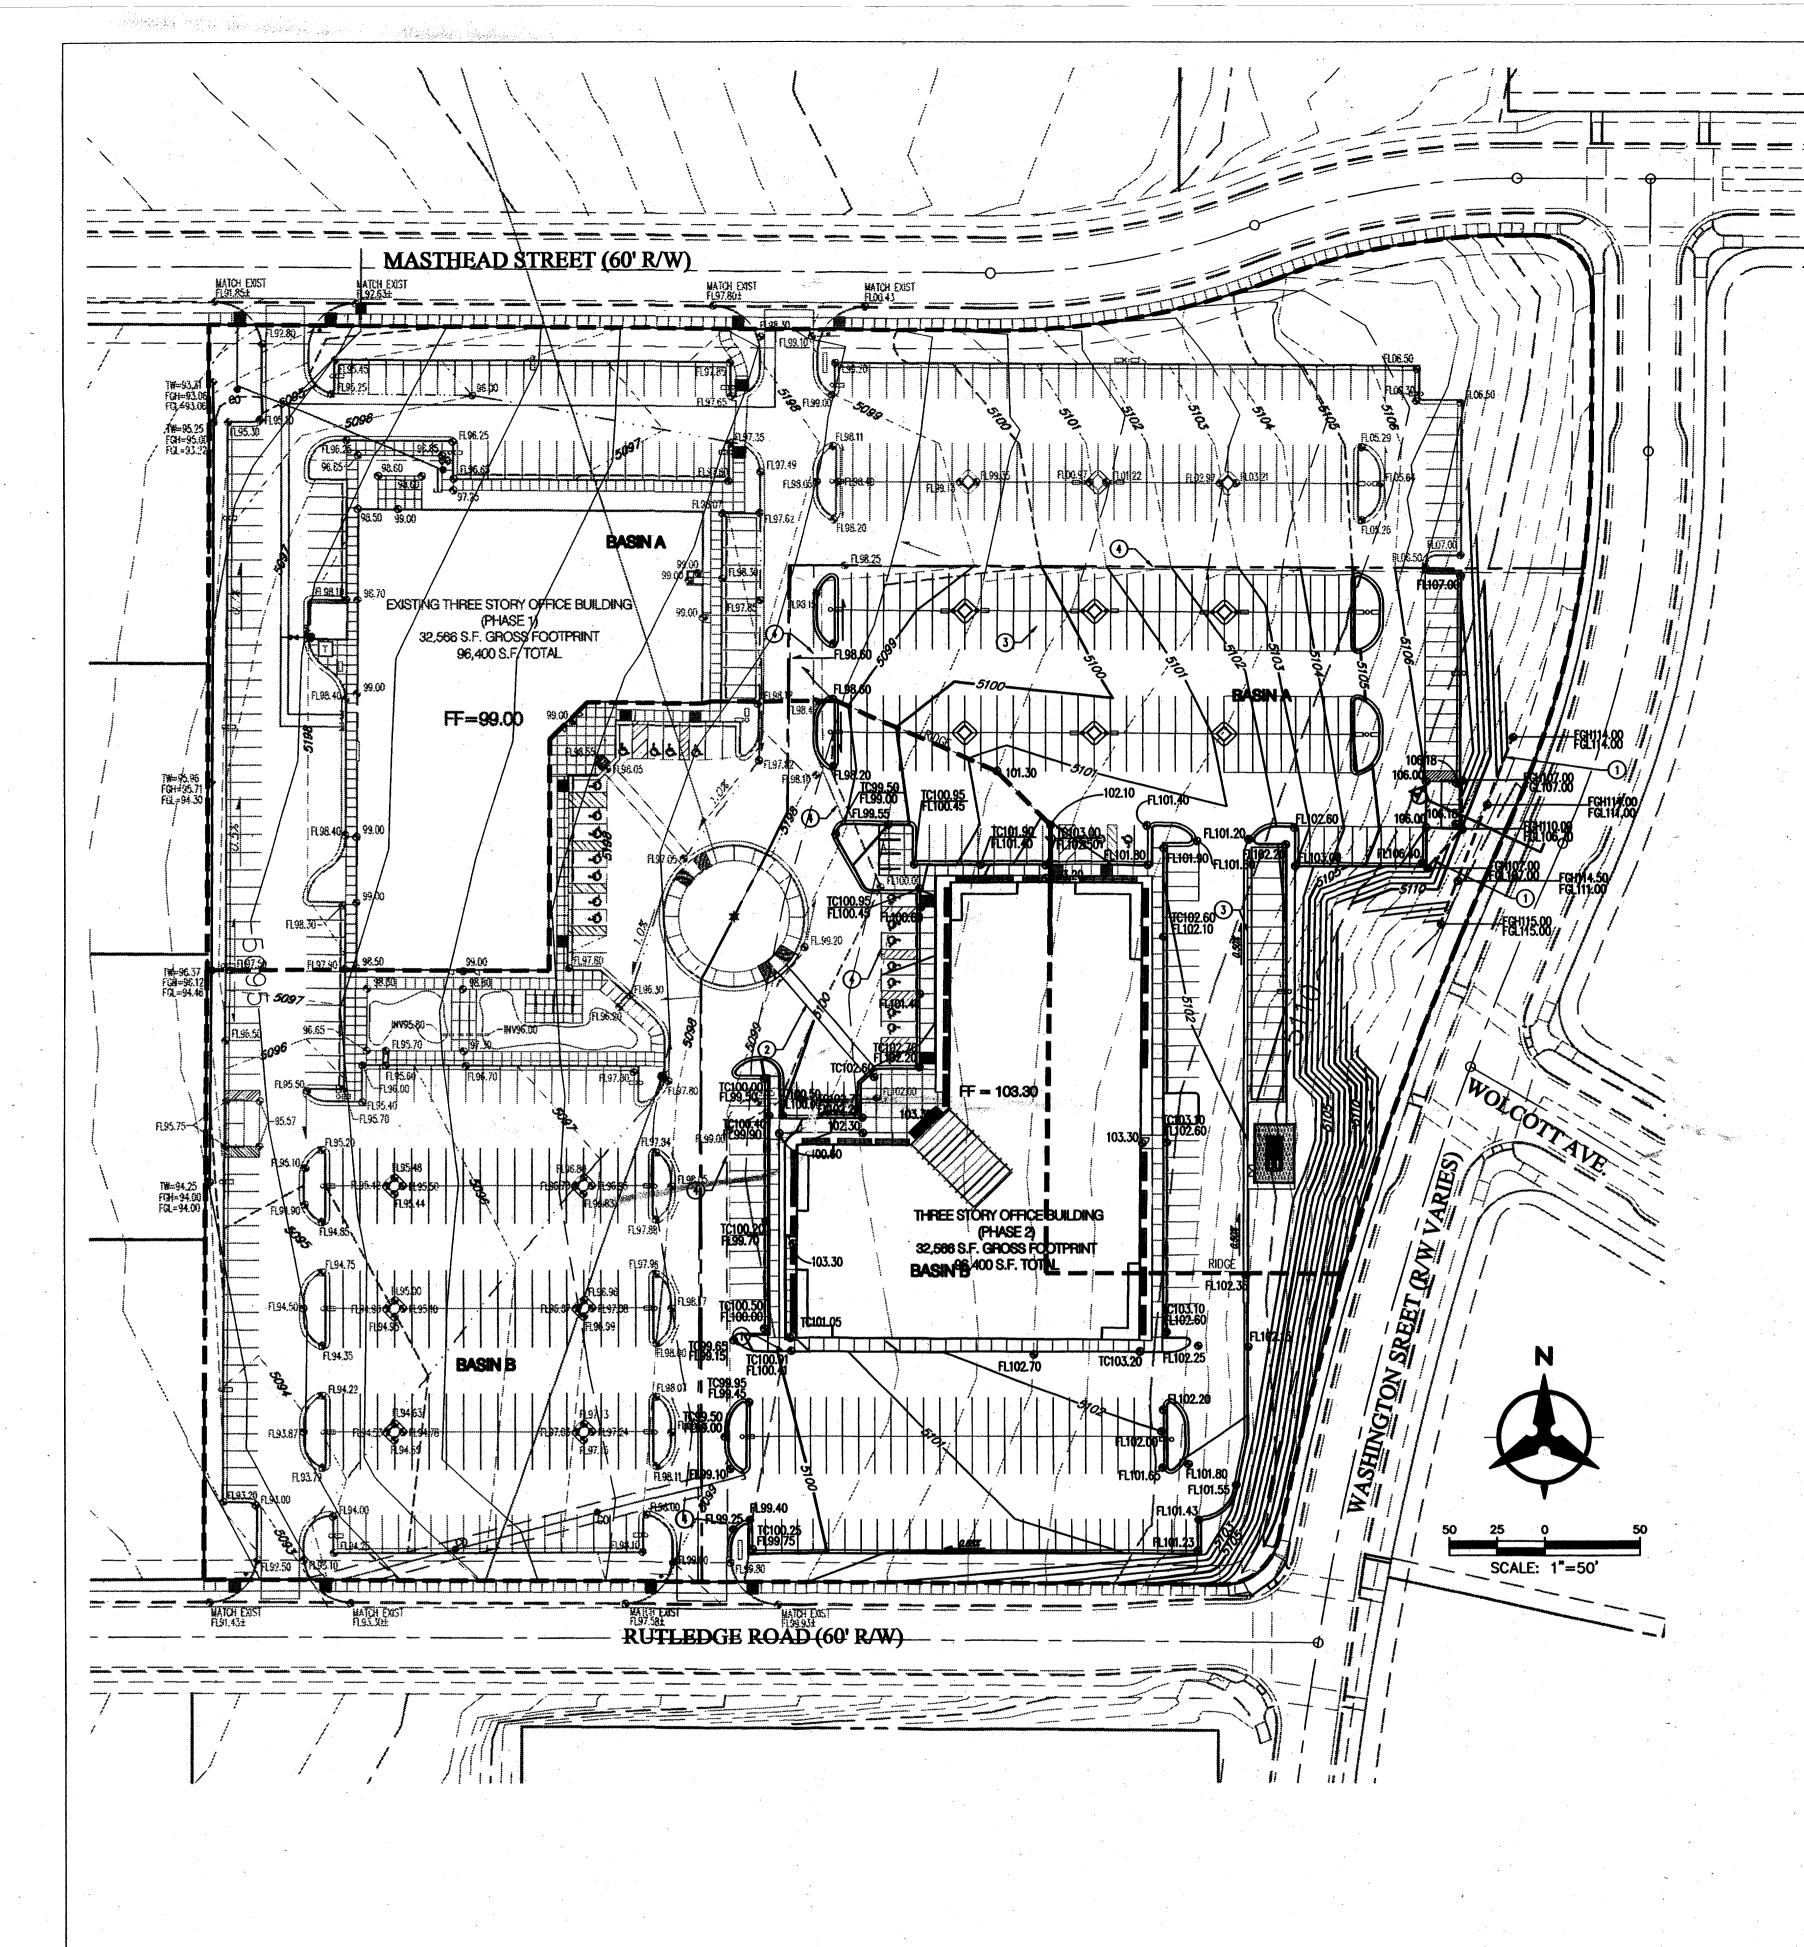

DRAINAGE MANAGEMENT PLAN

I. INTRODUCTION

The purpose of this submittal is to provide a final Drainage Management Plan for development of the Masthead Office Complex at Journal Center 2 – Phase 2, located in the Journal Center, Phase 2, Unit 2, Lot 11-B in NE Albuquerque.

II. SITE LOCATION

The site is currently legally described as, Journal Center, Phase 2, Unit 2, Lot 11-B (+/- 4.4 acres). The site is located within zone atlas map #D-17, and is in hydrologic zone 2. The site is located at the southwest comer of Masthead and Washington, just west of Jefferson.

III. SITE TOPOGRAPHY

The site slopes evenly from east to west at a value of less than 5%. Washington Street has a high point at the intersection of Wolcott Avenue from which it slopes north to Masthead and south to Rutledge. The area surrounding the site maintains similar topography.

IV. EXISTING HYDROLOGIC CONDITIONS

Currently the site (4.4 ac.) is undeveloped land. The surrounding streets and infrastructure are in place and Phase 1 of the development is currently under construction. The site drains from east to west in a sheet flow condition. Per the approved Drainage Plan of Journal Center — Phase 2 located in file number D17/D3AA, this site has been approved as a fully developed site and can drain to both Masthead and Rutledge via surface flow out of the driveways. Both Masthead and Rutledge drain to the west of the site where the drainage is collected in an underground drainage system. This site is within Basins B1 and C1 of the mentioned drainage plan. Basin B1 drains into Rutledge and the development contained in B1 is allotted 20.11 cfs of outflow. Basin C1 drains into Masthead. The portion of the new development contained in C1 is allotted 24.53 cfs of outflow per the approved Drainage Plan of Journal Center-Phase 2.


V. PROPOSED HYDROLOGIC CONDITIONS

The proposed conditions for the Masthead Office Complex at Journal Center 2 are shown on this Conceptual Grading Plan. The hydrologic analysis for this area is based on drainage requirements for the 100-yr, 6-hr storm event. The total site (+/- 10.0 acres) will generate a total of 44.45 cfs under newly developed conditions and consists of approximately 85% D land treatment. Flows will be conveyed to Masthead and Rutledge by surface and curb and gutters. This split flow will travel west in both roadways to a common existing underground drainage system. This drainage system then flows north to the North Pino Arroyo, and then to the AMAFCA North Diversion Channel. Approximately 20.09cfs drains to Rutledge; the other 24.36 cfs drains to Masthead. These flow values comply with the restrictions placed on the site by the approved drainage plan referenced in Section IV of this document.

VI. CONCLUSION

This drainage management plan provides for grading and drainage elements which are capable of safely passing the 100 year storm and which meet city requirements and are in conformance with the previously approved master drainage plan for Journal Center, Phase 2. With this submittal we are requesting building permit approval.

		,		US	FORES	T SERV	ICE BUILL	DING			· .
				Pro	posed Co	onditions l	Basin Data 1	Table			•
	This table	is based	on the DP	M Section	22.2, Zone:	2					
BASIN	Area	Area	Land	i Treatm	ent Perce	ntages	Q(100)	Q(100)	WTE	V(100) ₃₆₀	V(100)1440
ID	(SQ. FT)	(AC.)	·A	В	С	D	(cfs/ac.)	(cfs)	(inches)	(CF)	(CF)
PROPOS	ED COND	ITIONS						***************************************			
A	239933	5.51	0.0%	5.0%	10.0%	85.0%	4.42	24.36	1.95	39069	45887
В	197855	4.54	0.0%	5.0%	10.0%	85.0%	4.42	20.09	1.95	32217	38664
			·							and the second	
TOTAL	437788	10.05	•	-	. •	• .	4.42	44.45	3.91	71286.48	71286

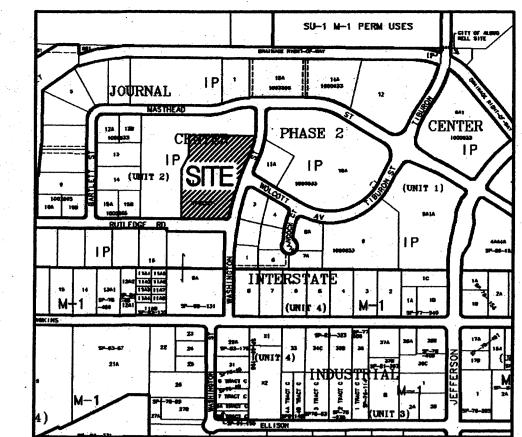

ZONE ATLAS PAGE D-17

LEGAL DESCRIPTION
TRACT 11-B OF JOURNAL CENTER UNIT 2, PHASE 2
ALBUQUERQUE, NM, NOVEMBER, 2005

LEGEND

PROPOSED INDEX CONTOUR 32 PROPOSED INTERMEDIATE CONTOUR 32.40 EXISTING SPOT ELEVATION FL = FLOWLINE TS = TOP OF SIDEWALK FCH = FINISHED GROUND HIGH SIDE FGL = FINISHED GROUND LOW SIDE TW = TOP OF WALL	-	PROPERTY LINE		
PROPOSED INTERMEDIATE CONTOUR 32.40 EXISTING SPOT ELEVATION PROPOSED SPOT ELEVATION FL = FLONLINE TS = TOP OF SDEWALK FGH = FINISHED GROUND HIGH SIDE FGL = FINISHED GROUND LOW SIDE		EXISTING CONTOUR		
EXISTING SPOT ELEVATION 32.40 PROPOSED SPOT ELEVATION FL = FLOWLINE TS = TOP OF SIDEWALK FGH = FINISHED GROUND HIGH SIDE FGL = FINISHED GROUND LOW SIDE	35	PROPOSED INDEX CONTOUR		
32.40 PROPOSED SPOT ELEVATION FL = FLOWLINE TS = TOP OF SIDEWALK FGH = FINISHED GROUND HIGH SIDE FGL = FINISHED GROUND LOW SIDE	32	PROPOSED INTERMEDIATE CONTOUR		
TS = TOP OF SIDEWALK FGH = FINISHED GROUND HIGH SIDE FGL = FINISHED GROUND LOW SIDE	⊕ 32.40	EXISTING SPOT ELEVATION		
	→ ^{32.40}	FL = FLONLINE TS = TOP OF SIDEWALK		

DIRECTION OF FLOW

KEYED NOTES

- 1. 4' HIGH ± MASONRY RETAINING WALL.
- 2. 2% MAXIMUM CROSS-SLOPE AT SIDEWALK CROSSING.
- 3. CONCRETE VALLEY GUTTER, REFER TO SITE PLAN.
- 4. MATCH EXISTING PAVEMENT.

RETAINING WALL/REFUSE
ENCLOSURE WALL

RETAINING WALL SECTION A-A

Bohannan 🔺 Huston

Courtyard 1 7500 Jefferson St. NE Albuquerque, NM 87109-4335.

ENGINEERING A SPATIAL BATA A ABVANCED TECHNOLOGIES

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ARCHITEC

CONSERTANT

NEW MEXICO

DUERQUE

REVISIONS

MK DATE DESCRIPTION

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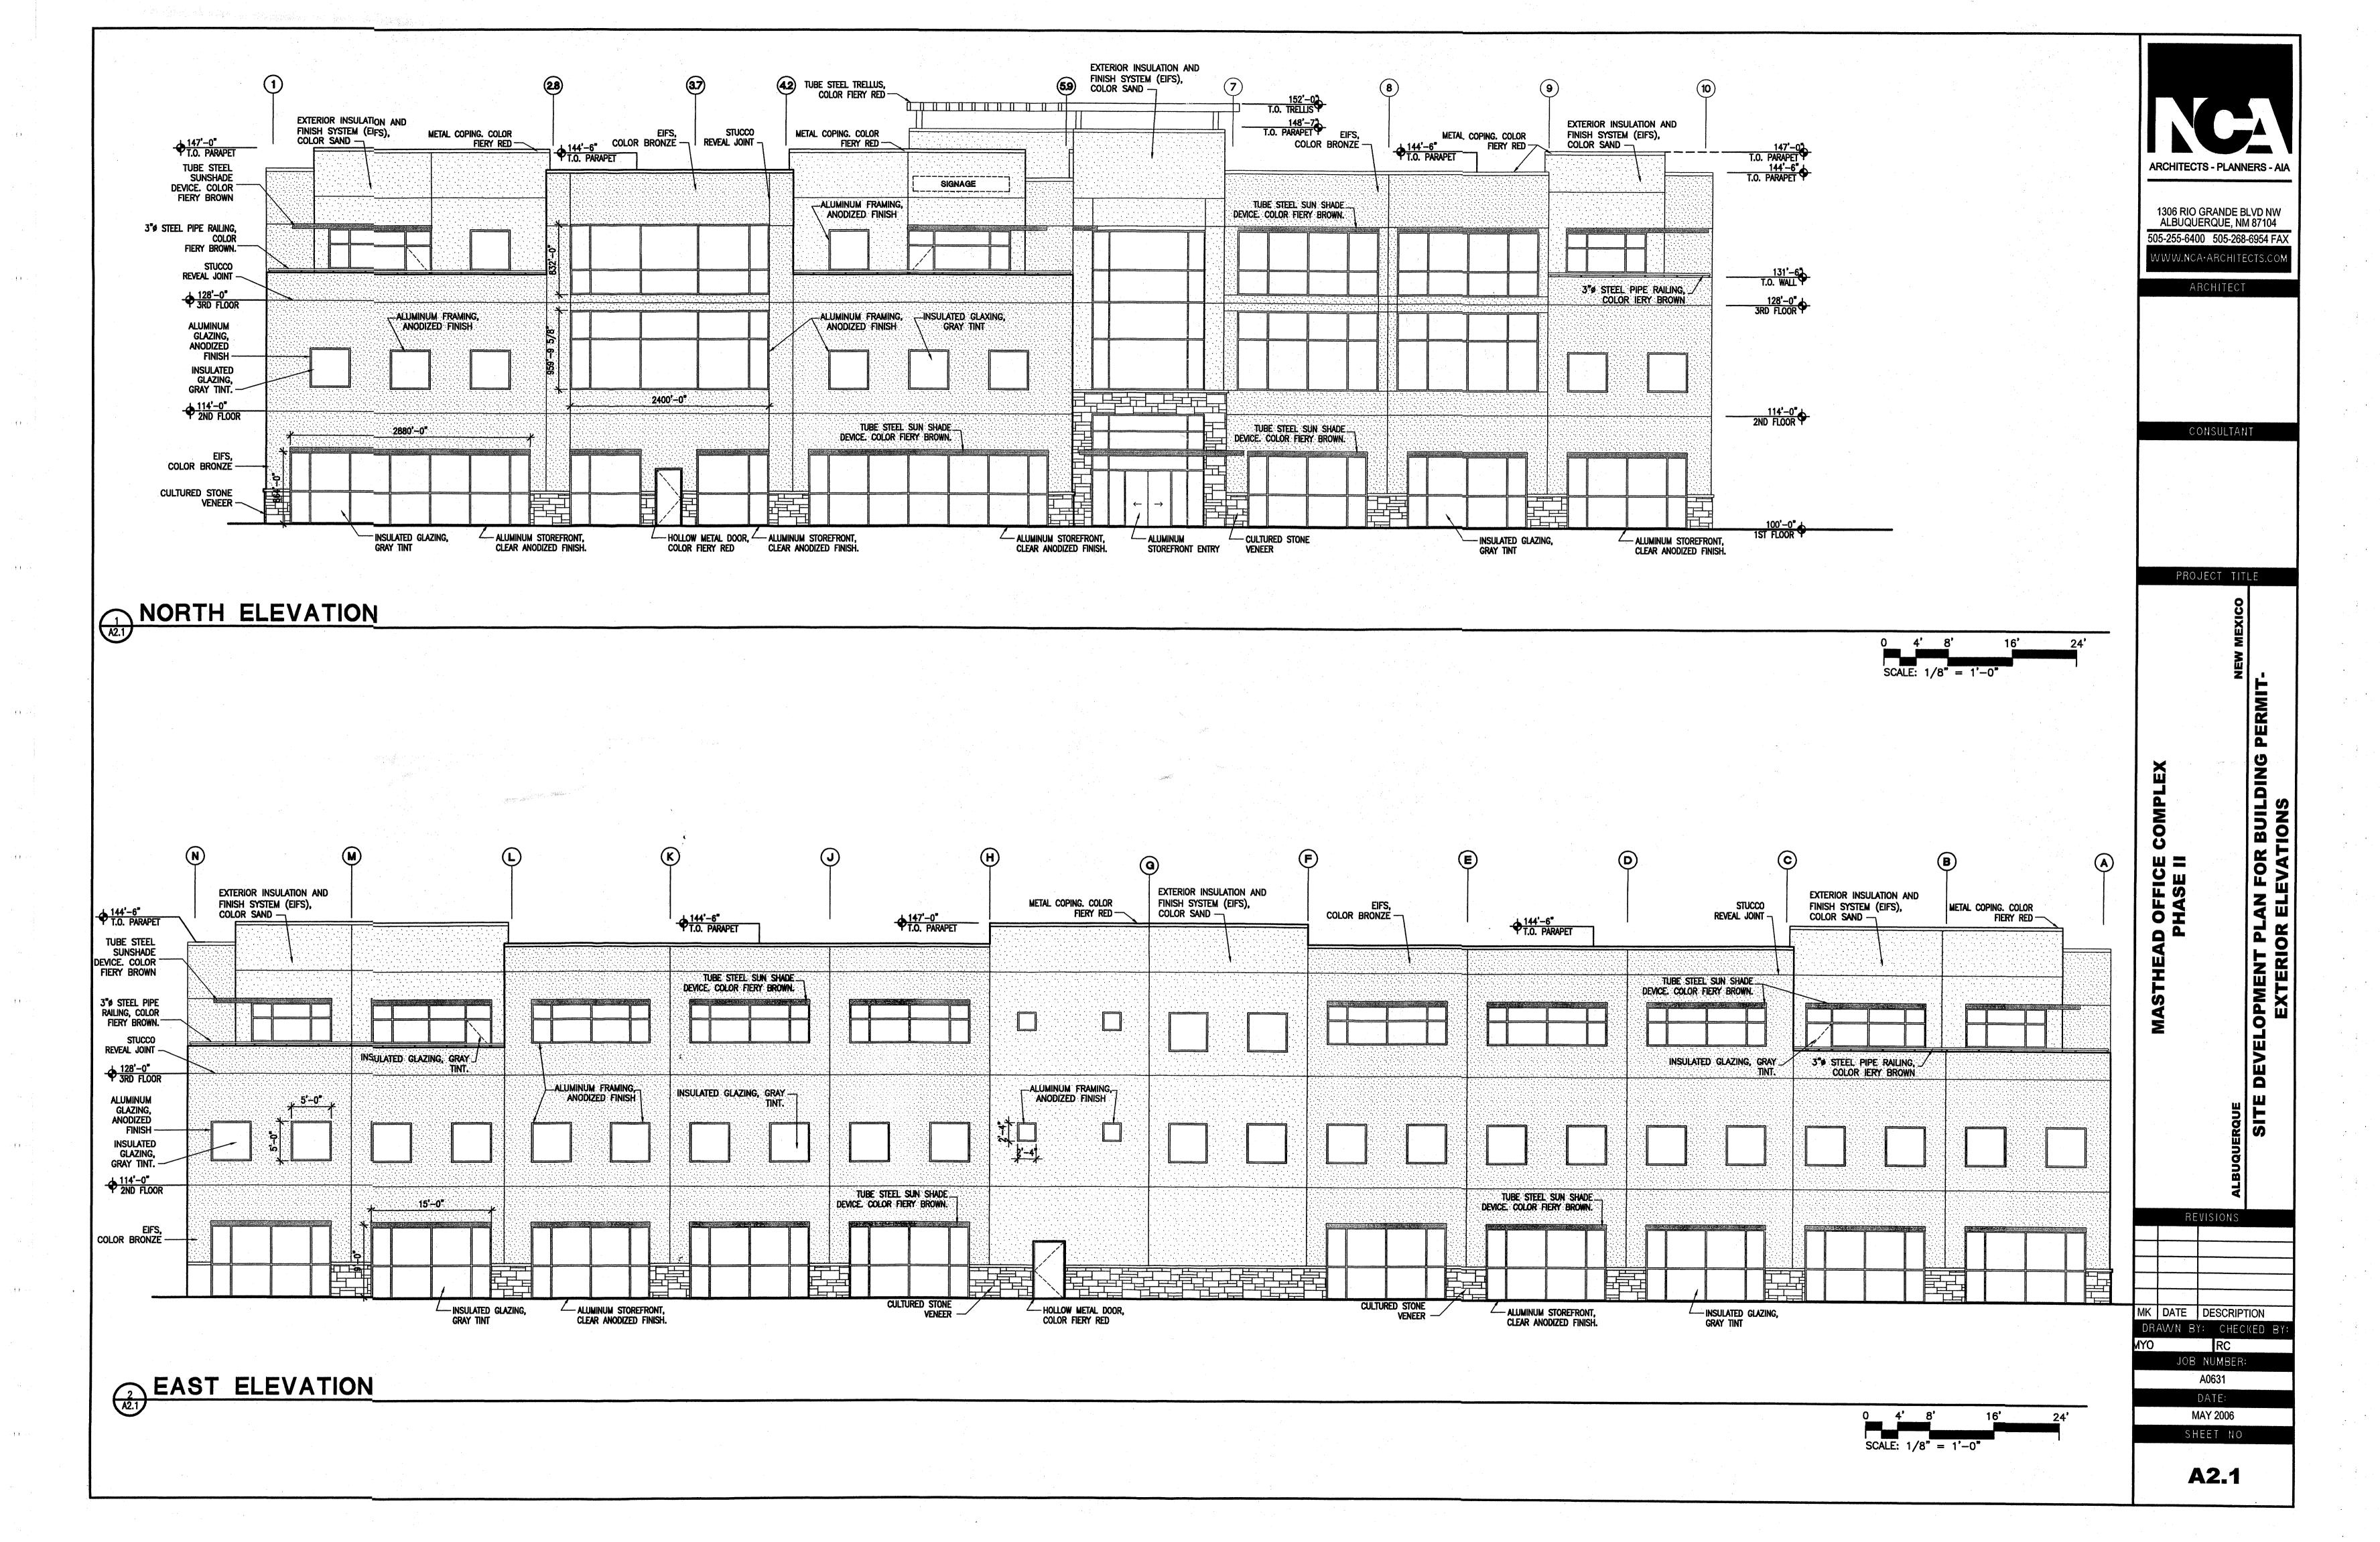
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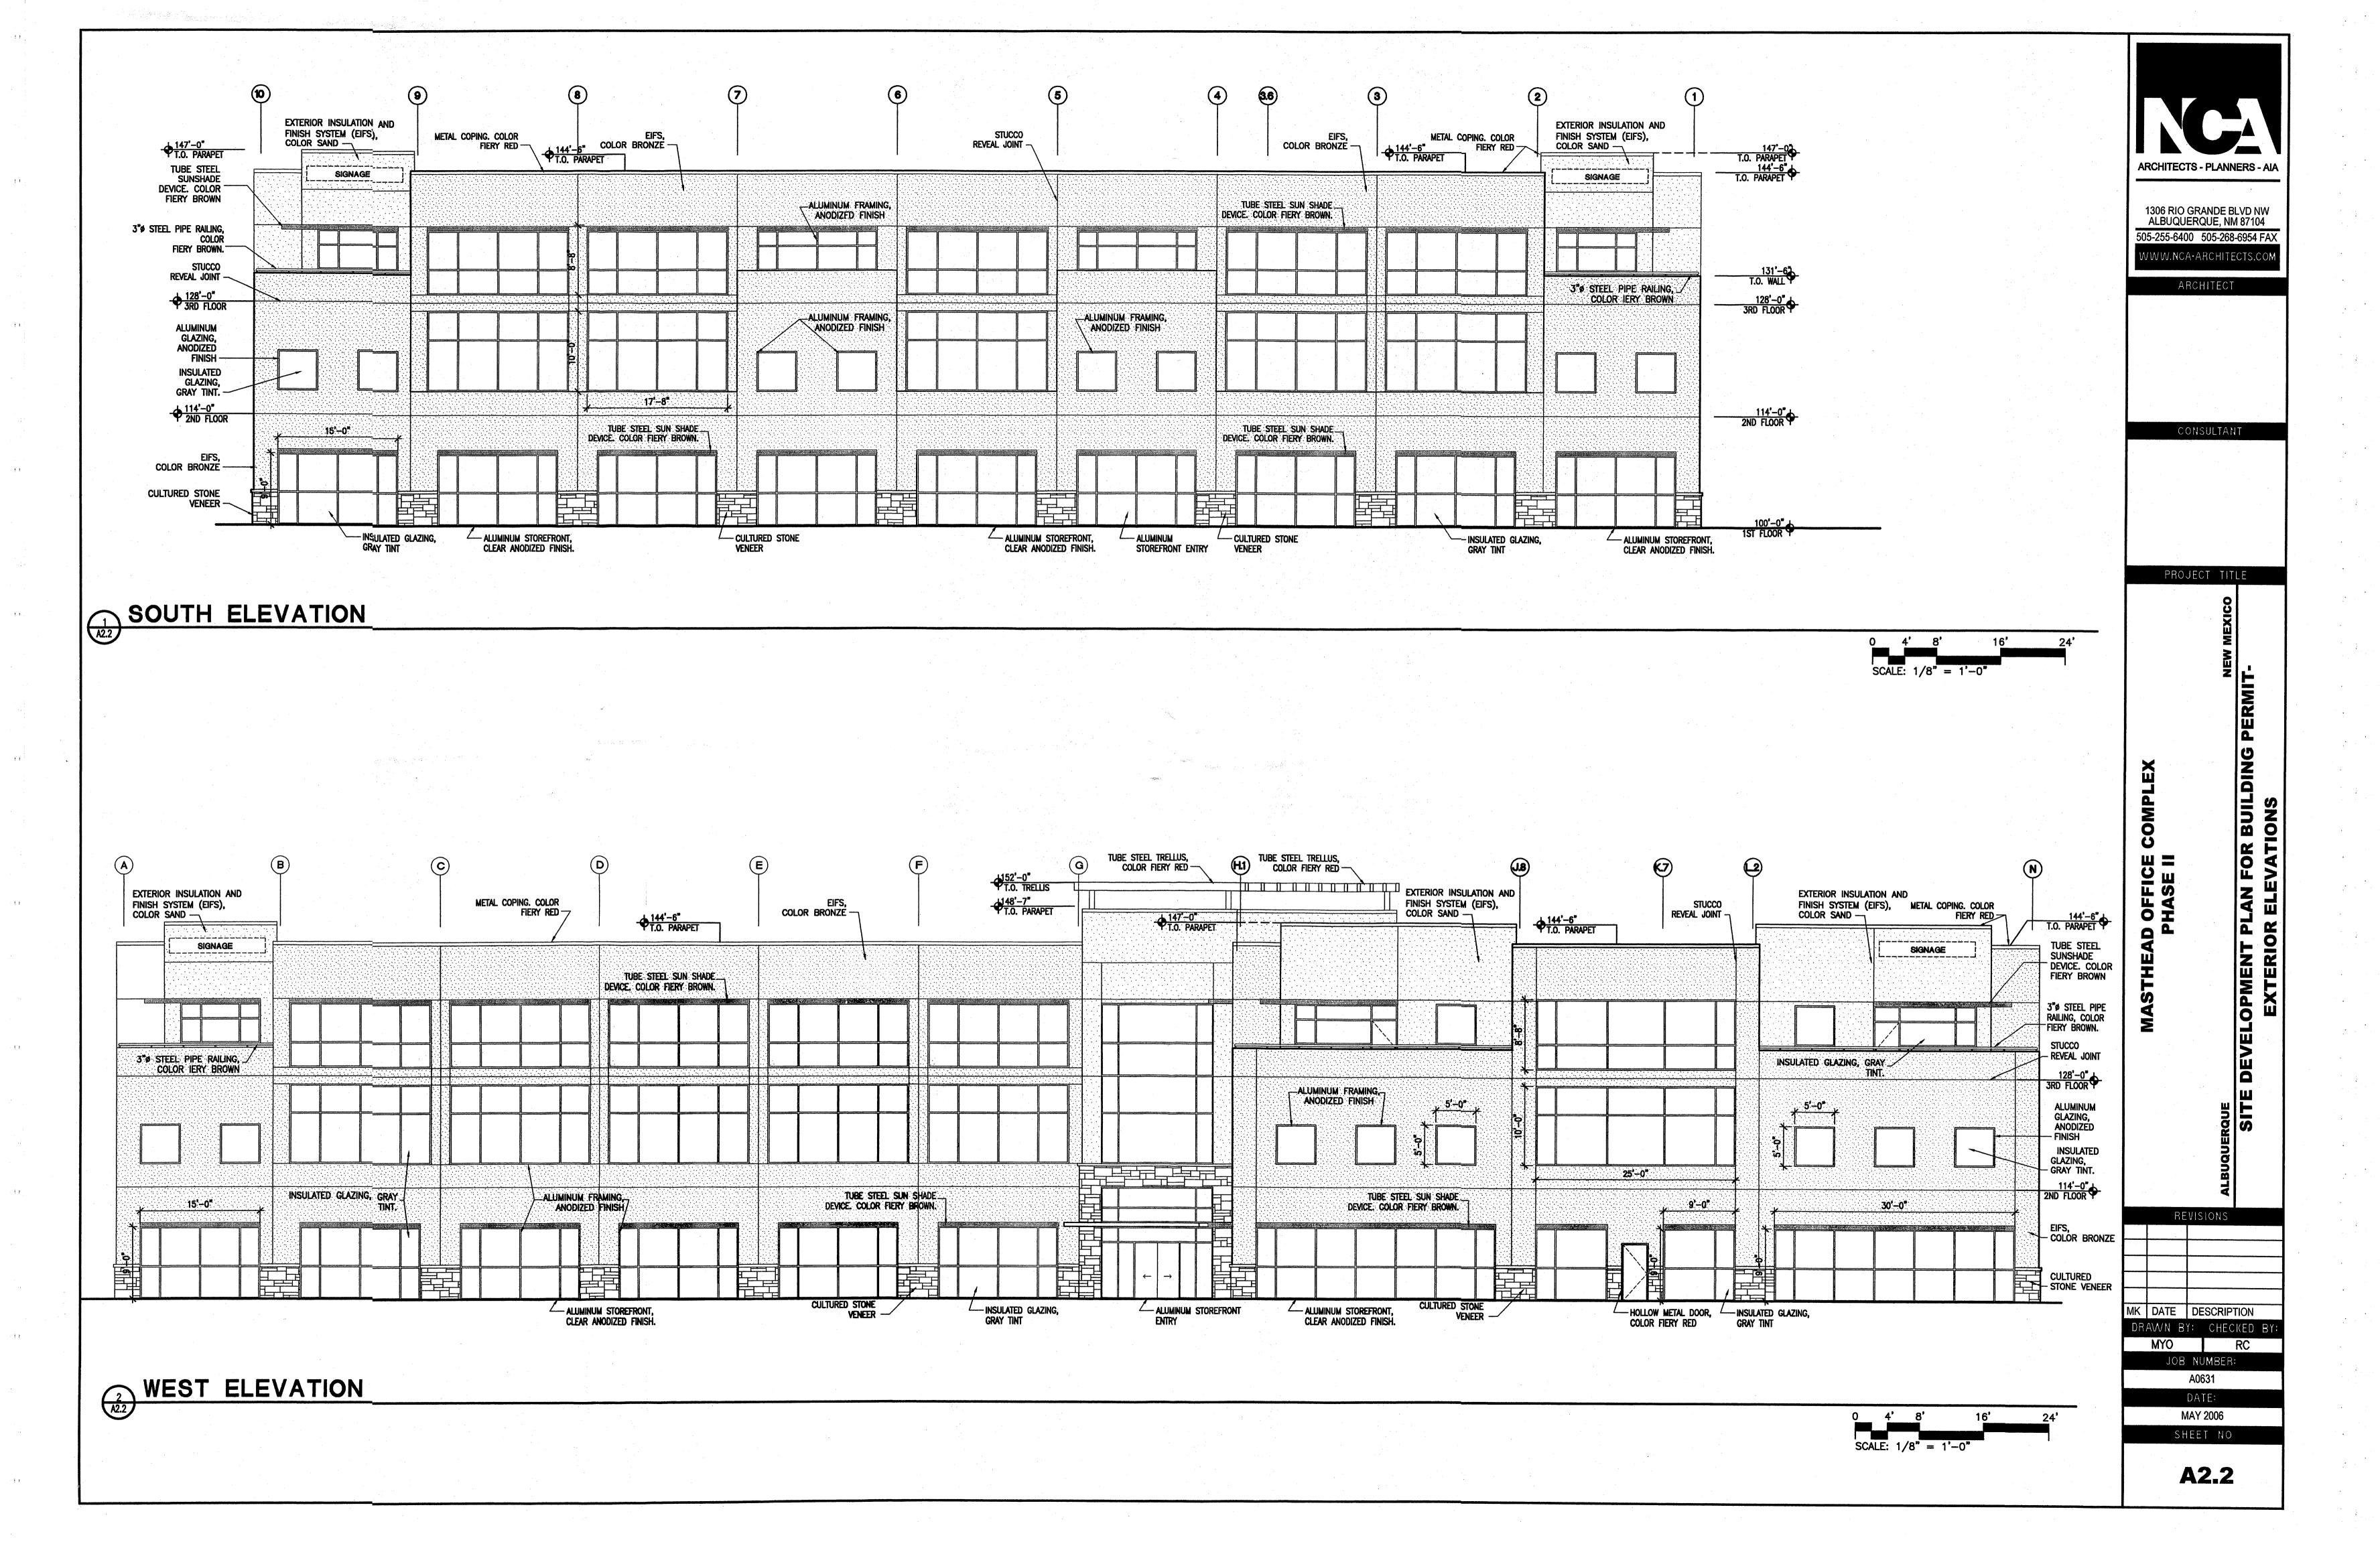
DATE: MAY 17, 2006


SHEET NO


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2:\060240\cdp\general\SDP for BP\Site Grading Plan.dwg, Layout1 May 18, 2006 — 3:59pm







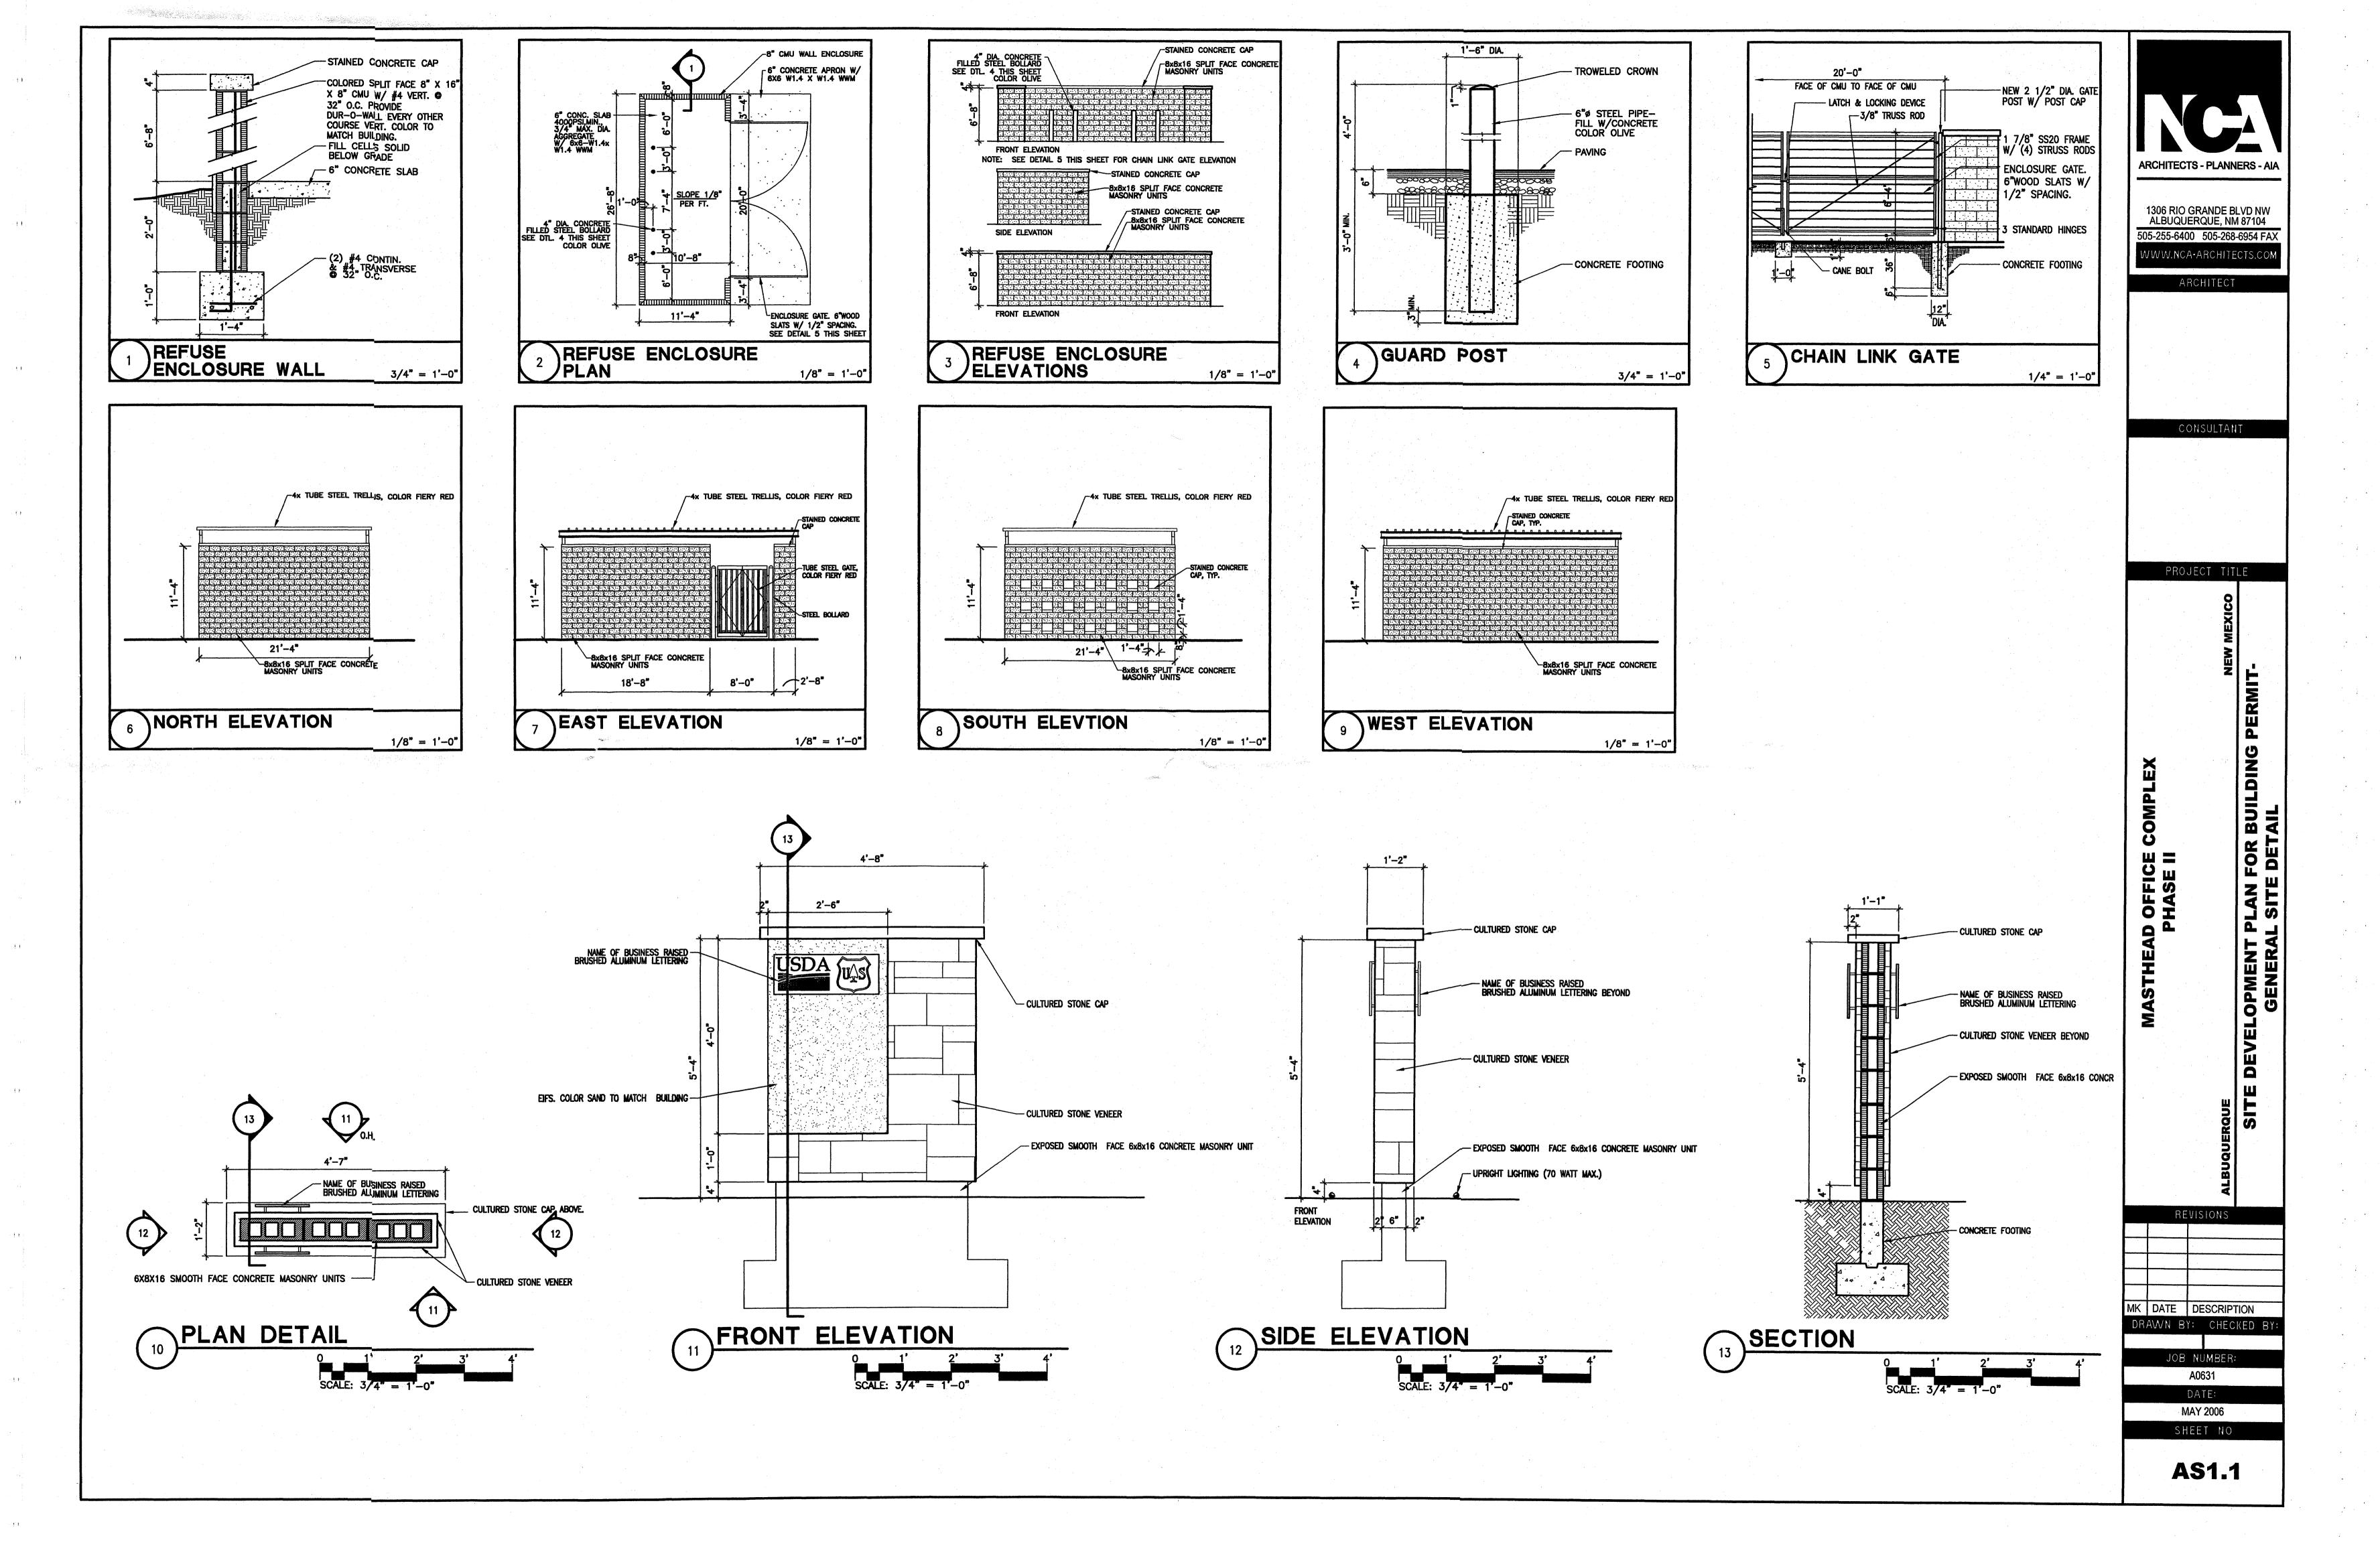

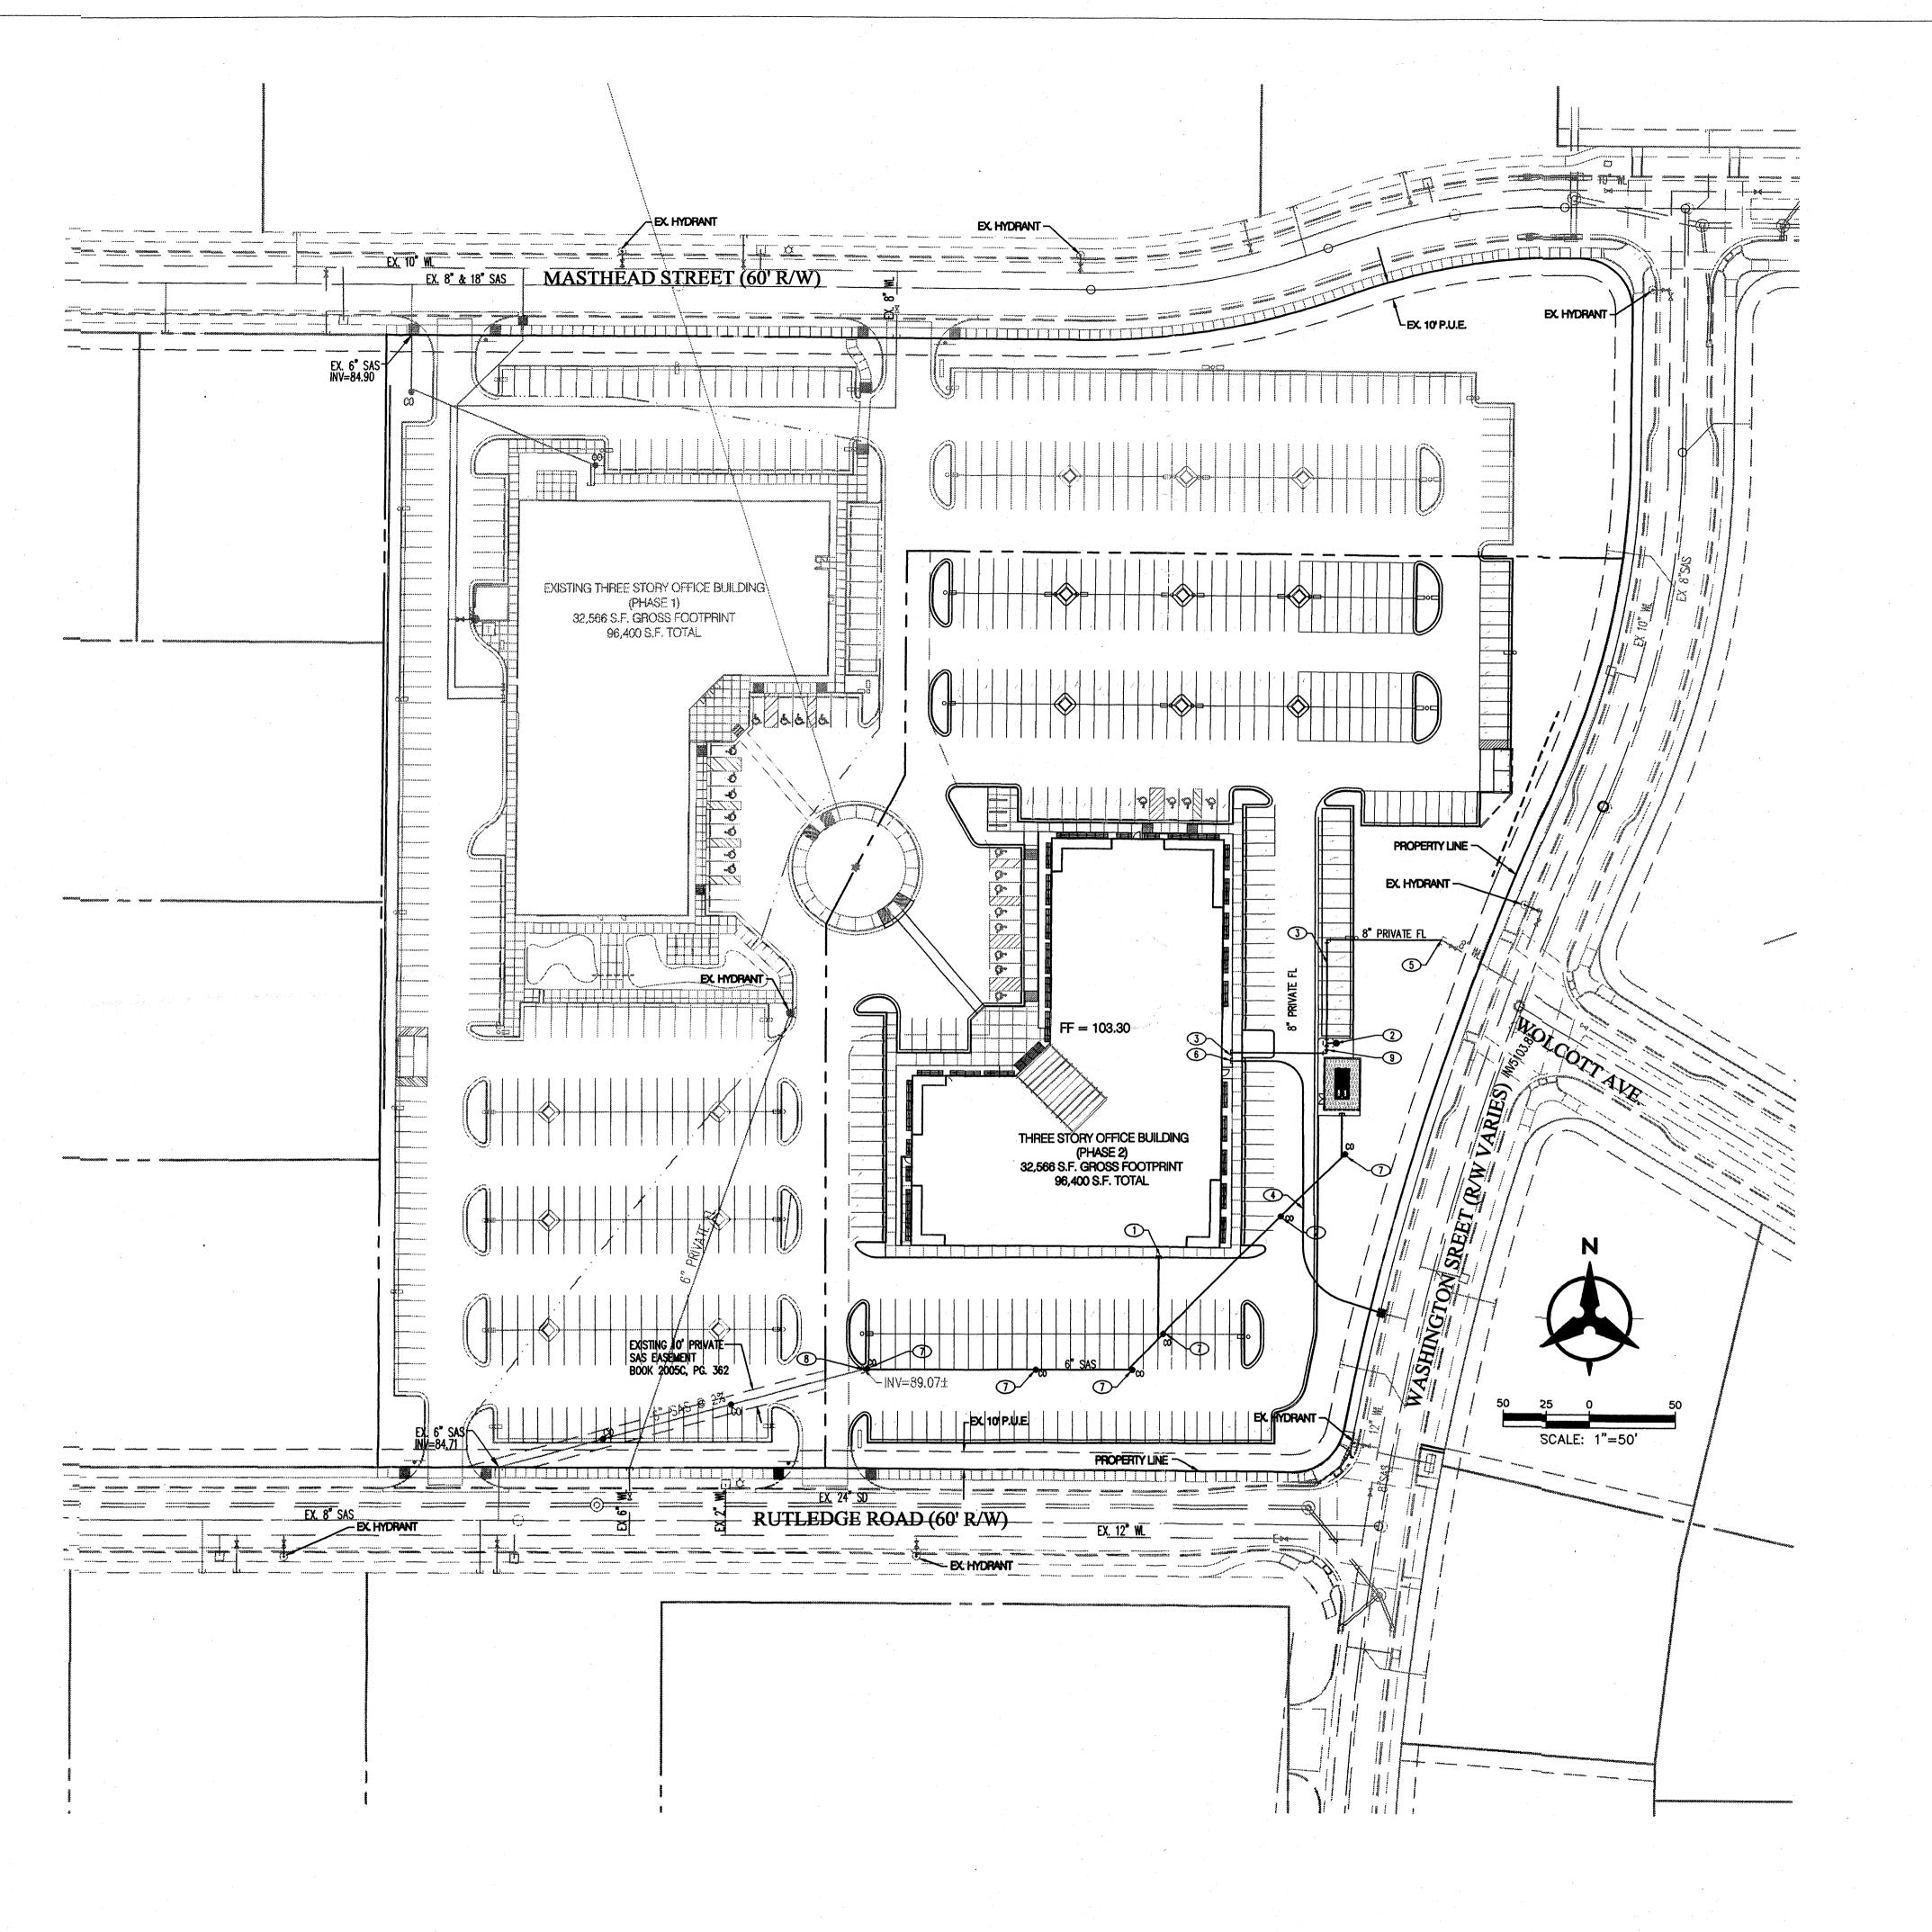

- 1. 6" SANITARY SEWER STUB
- 2. NEW PRIVATE FIRE HYDRANT
- 3. 8" PRIVATE FIRE LINE SERVICE FOR BUILDING SPRINKLERS.
 BACKFLOW PREVENTER TO BE INSTALLED INSIDE MECHANICAL ROOM.
 FDC TO BE LOCATED ON BUILDING WALL.
- 4. NEW 1 1/2" METERED WATER SERVICE. CONNECT TO EXISTING 2" WATER LINE STUB OUT.
- 5. CONNECTION TO EXISTING 8" FIRE LINE STUB
- 6. NEW 1 1/2" DOMESTIC WATER SERVICE TO BUILDING, BACKFLOW PREVENTER SHALL BE INSIDE MECHANICAL ROOM.
- 7. SANITARY SEWER CLEANOUT
- 8. CONNECT TO EX. 6" SAS STUB PROVIDED TO SITE WITH PHASE 1
- 9. POST INDICATOR VALVE.

LEGEND

		· · · · · · · · · · · · · · · · · · ·	PROPERTY LINE
	EX. 8° SAS	,,,,,,,,,,,,,,,,,,,,,,,,,,,,,,,,,,,,,,,	EX SANITARY SEWER & MANHOL
	EX. 24"_SD	***************************************	EX STORM DRAIN & MANHOLE
	-		EX INLET
	EX. 12* WL	······	EX WATER LINE
	X		EX VALVE
	i i		EX METER
	Ø		EX FIRE HYDRANT
	\$ \$		EX STREET LIGHT
100	SAS		PROPOSED SANITARY SEWER
	● _{co}		PROPOSED CLEANOUT
	W_		PROPOSED WATERLINE



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ARCHITECT

CONSULTANT

PROJECT TITLE

MEXICO

ASTHEAD OFFICE COMPLEX
AT JOURNAL CENTER 2

BUQUERQUE

REVISIONS

MK DATE DESCRIPTION

DRAWN BY: CHECKED BY

JDS BJS

JOB NUMBER:

A0559

DATE:
MAY 17, 2006
SHEET NO

C3.0

Bohannan A Huston

Courtyard I 7500 Jefferson St. NE Albuquerque, NM 87109-4335

ENGINEERING & SPATIAL DATA & ADVANCED TECHNOLOGIES


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May 18, 2006 — 3:21pm
Plotted by: JSMITH







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PROJECT TITLE

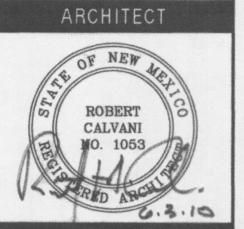USFS
PHASE II
ALBUQUERQUE
SERVICE CENTER
HUMAN
RESOURCES

ALBUQUERQUE NEW MEXICO

REVISIONS:

MK DATE DESCRIPTION

DRAWN BY: CHECKED

PROJECT NUMBER:


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JUNE 2010


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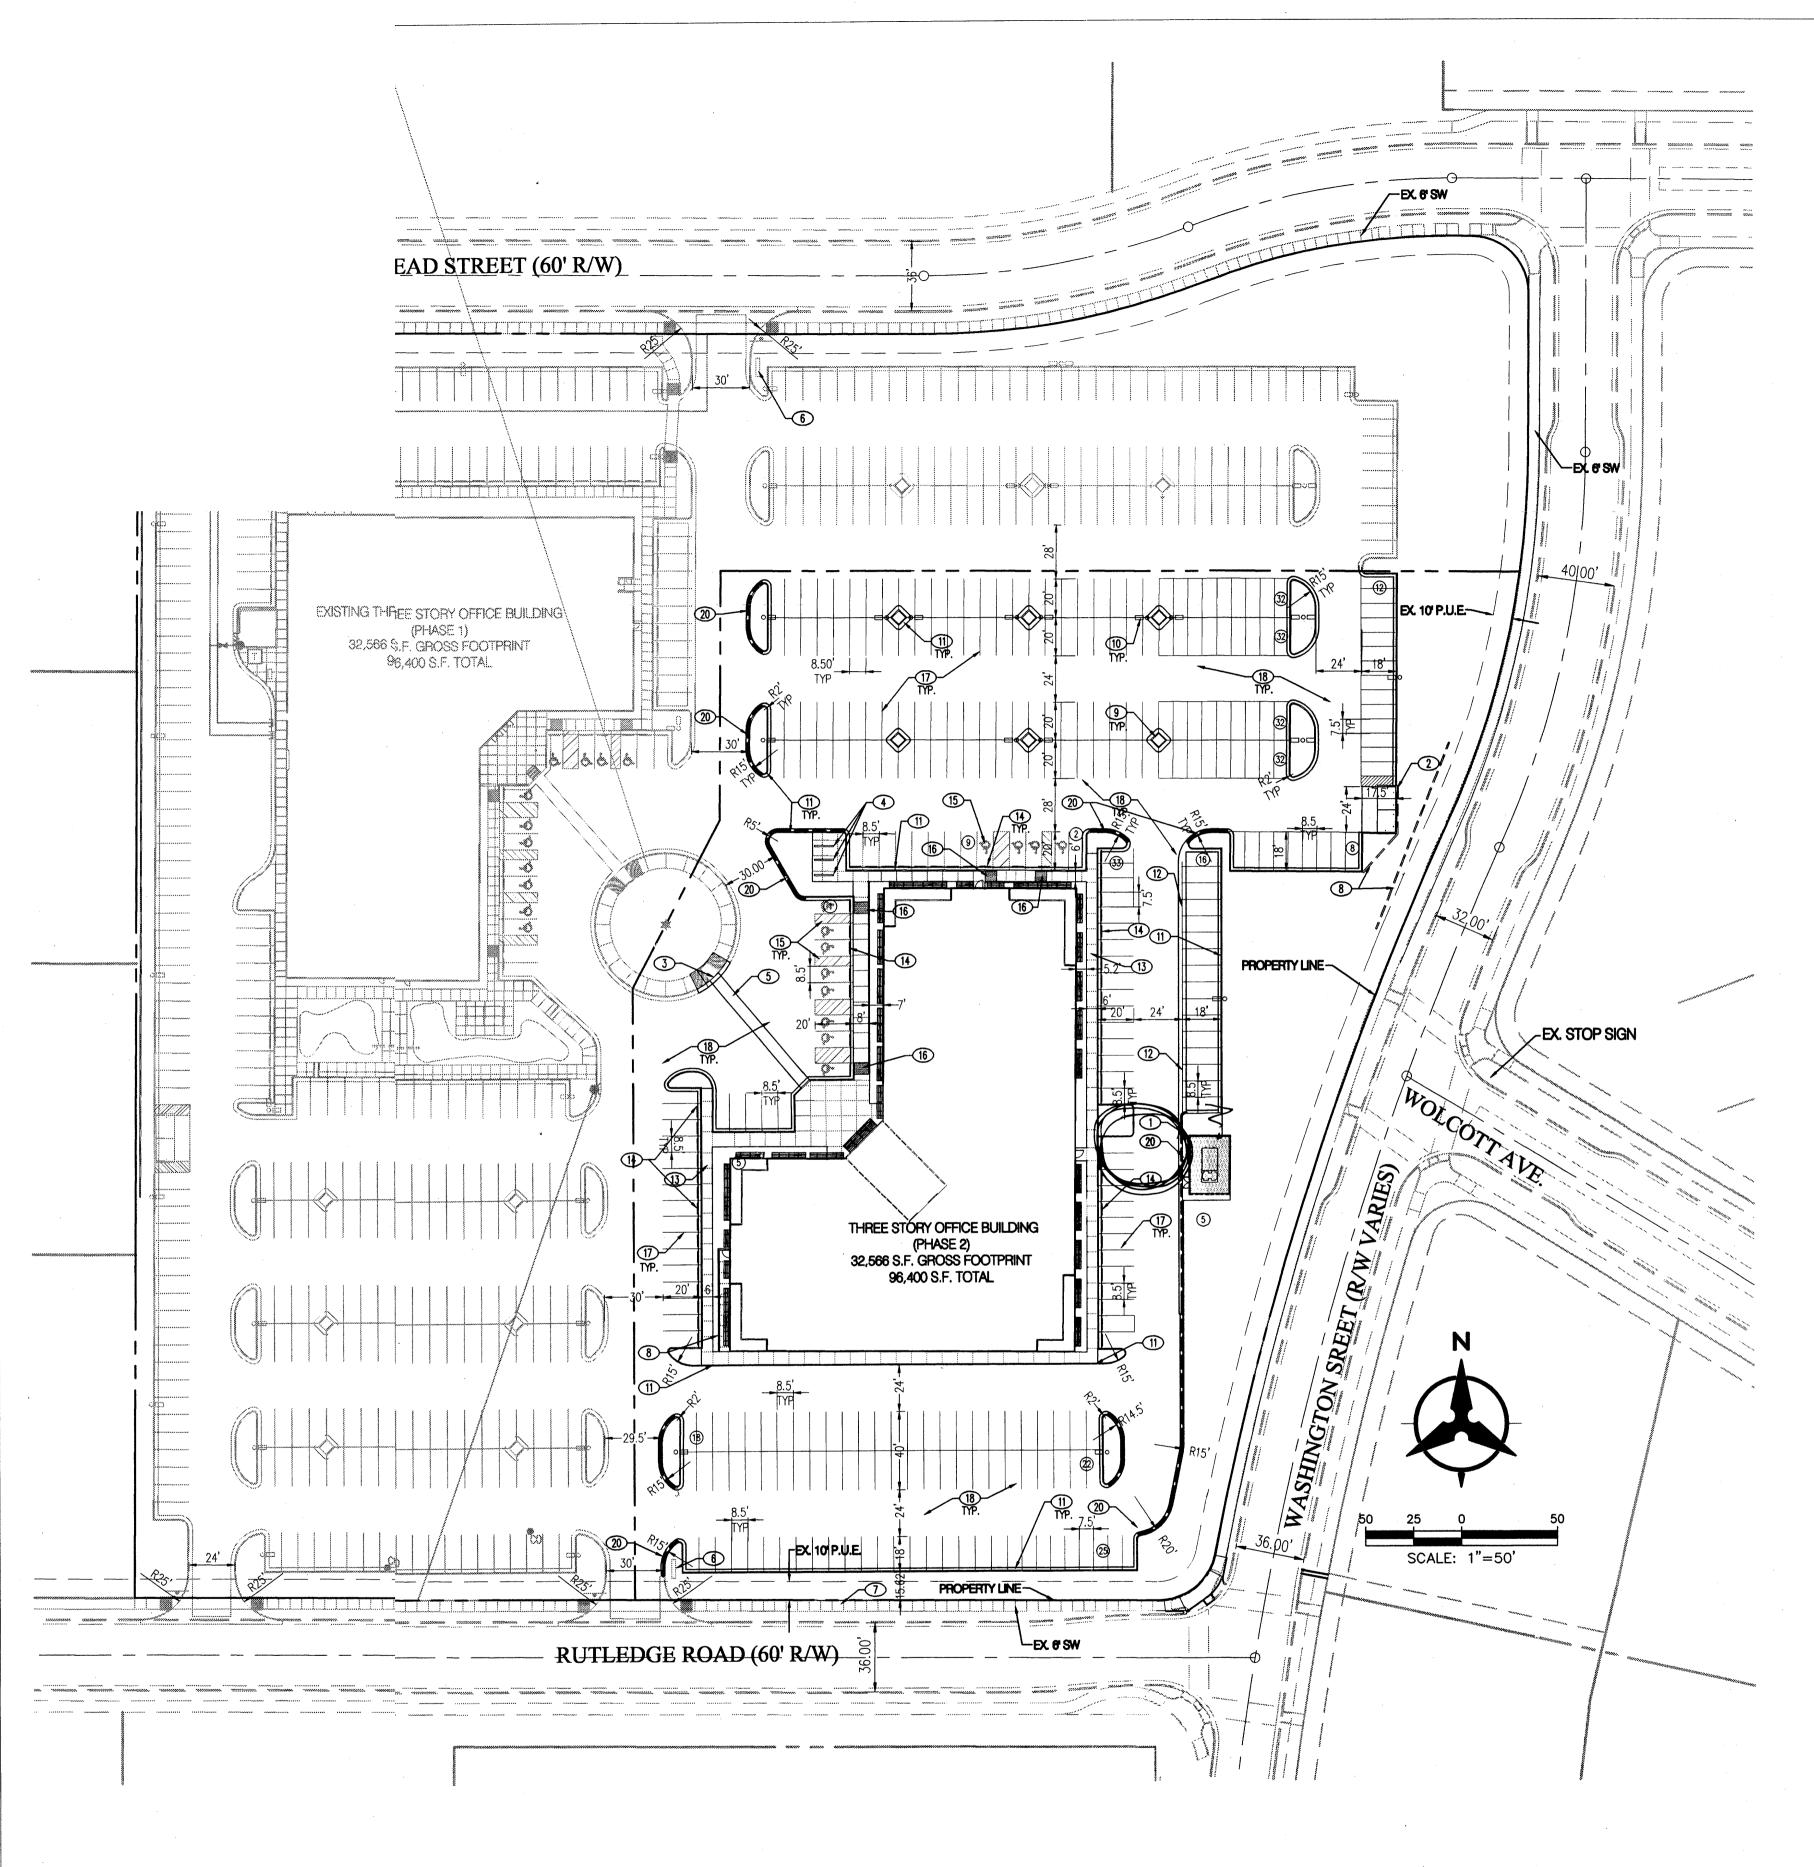
COLOR RENDERINGS

SHEET NO:

A0.1



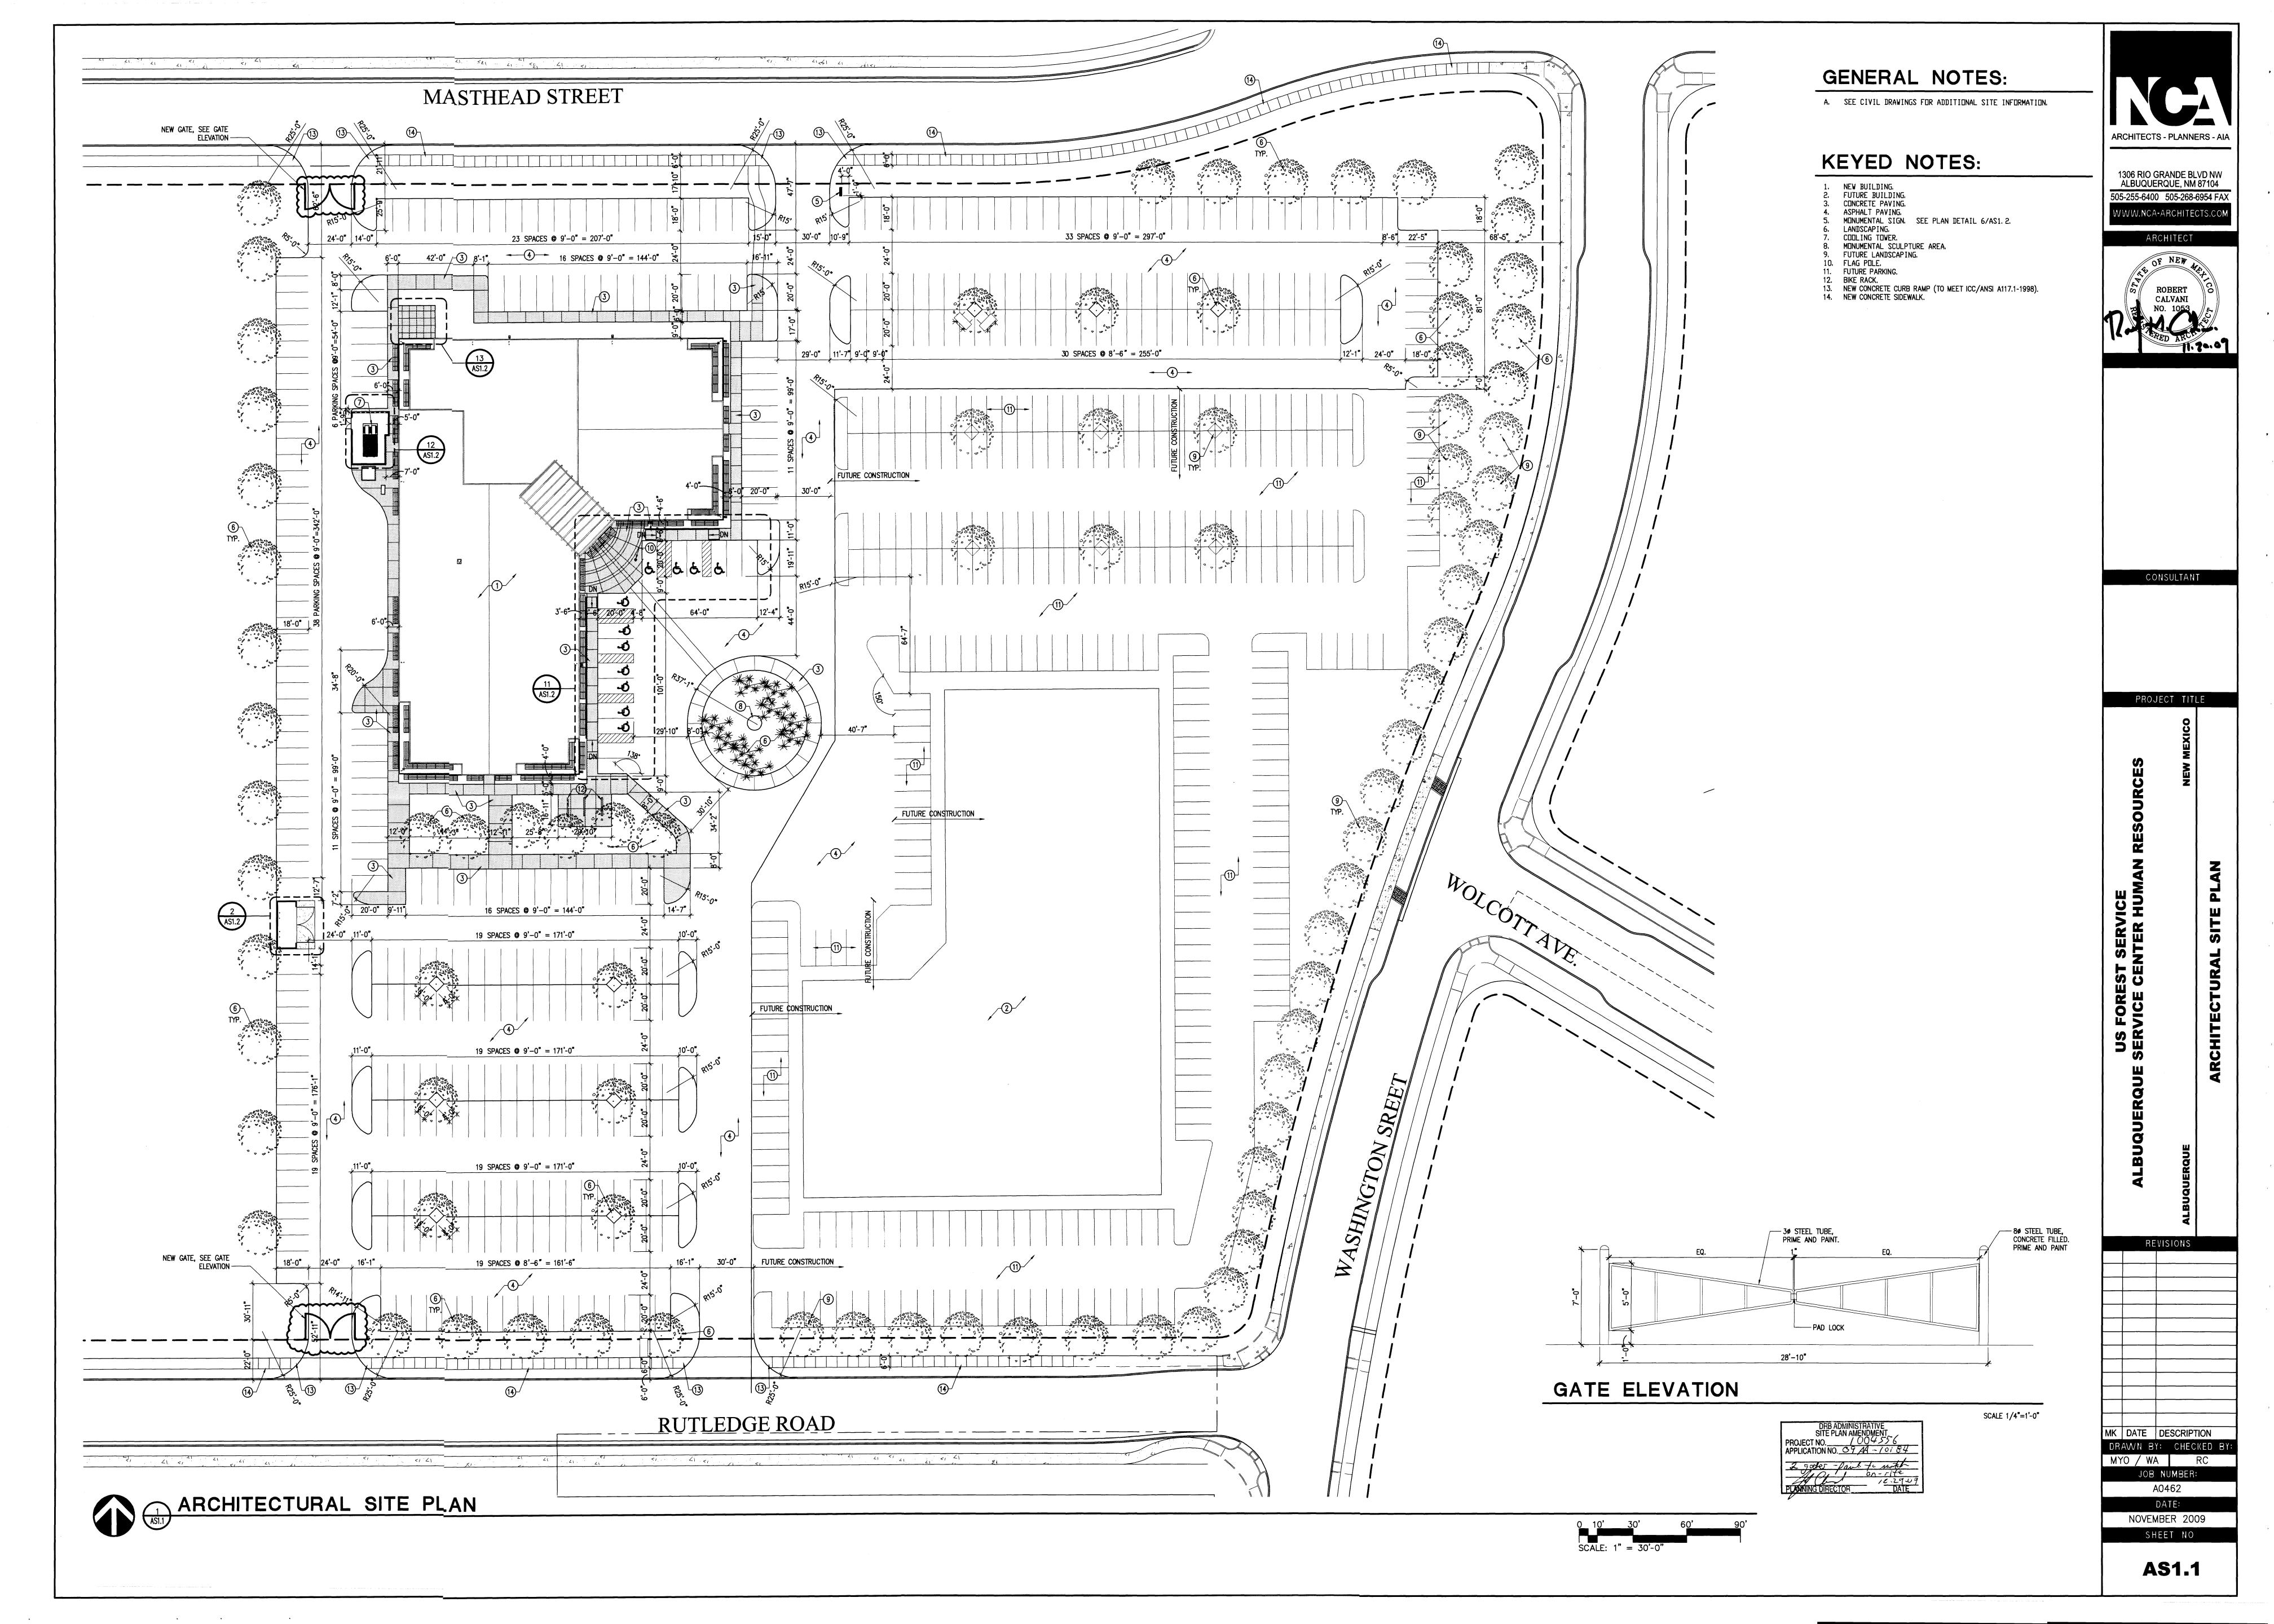

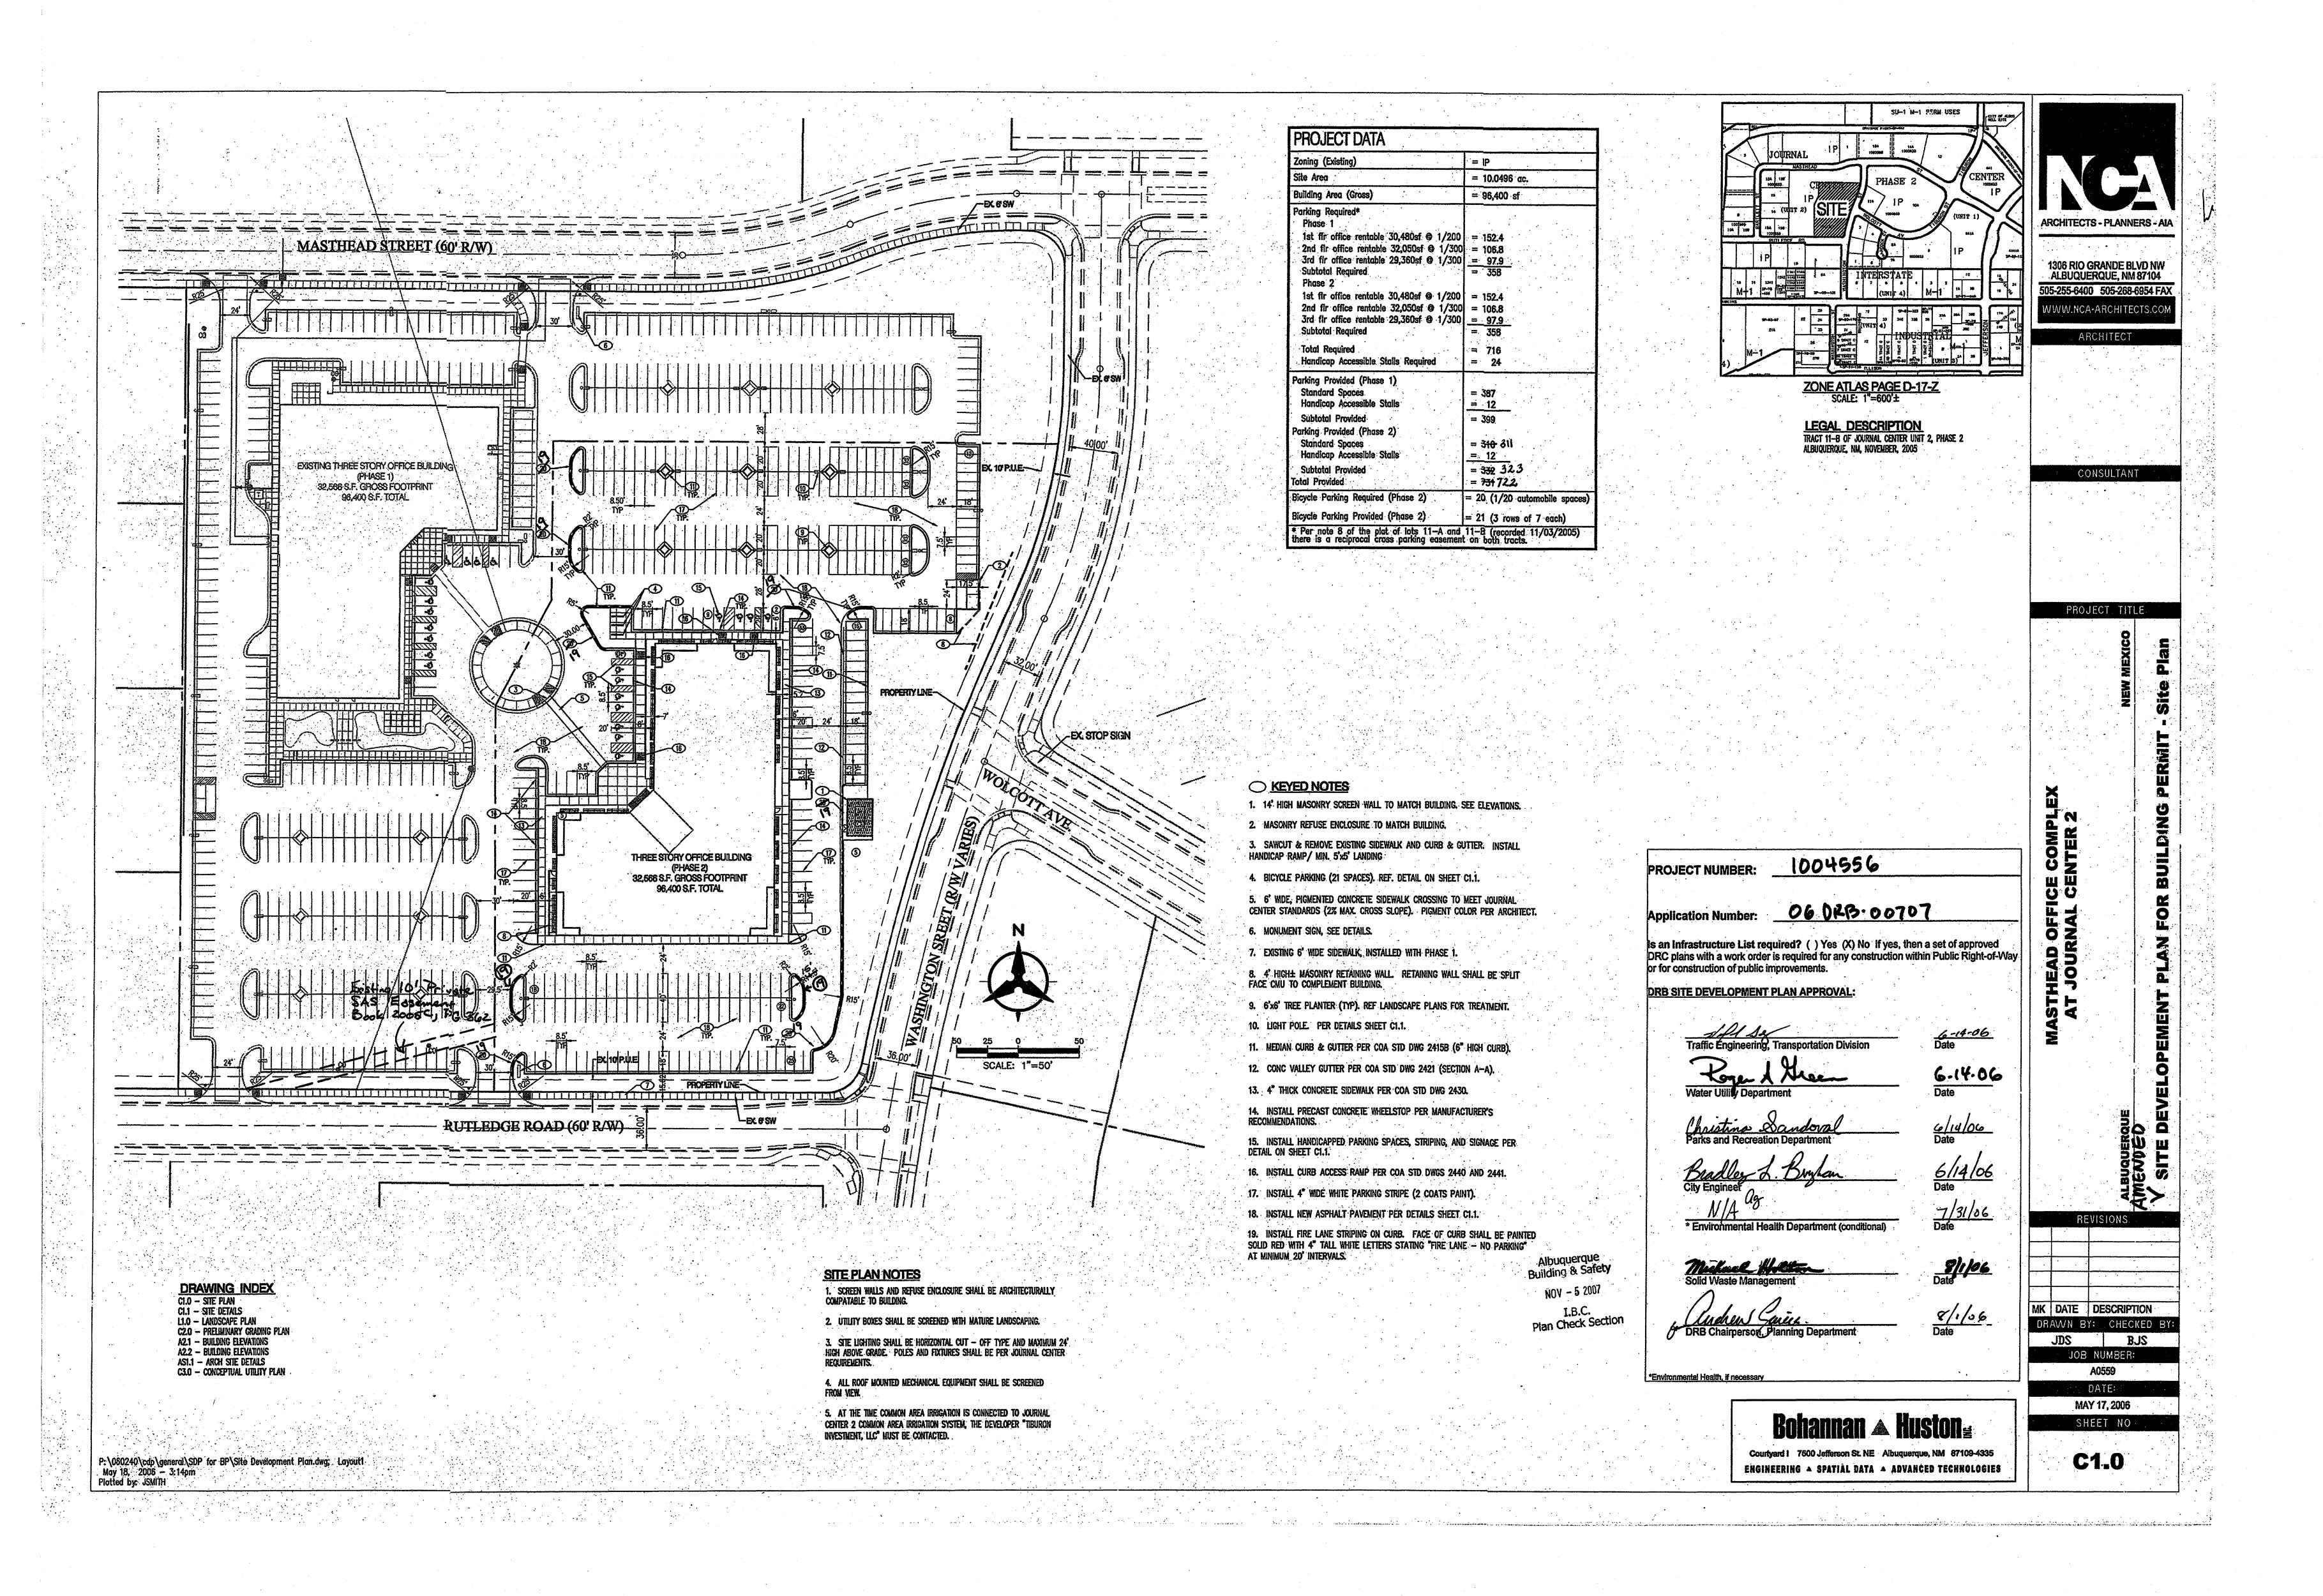

SITE PLAN NOTES

1. SCREEN WALLS AND REFUSE ENCLOSURE SHALL BE ARCHITECTURALLY COMPATABLE TO BUILDING.

2. UTILITY BOXES SHALL BE SCREENED WITH MATURE LANDSCAPING.

3. SITE LIGHTING SHALL BE HORIZONTAL CUT — OFF TYPE AND MAXIMUM 24' HIGH ABOVE GRADE. POLES AND FIXTURES SHALL BE PER JOURNAL CENTER requirements.

4. ALL ROOF MOUNTED MECHANICAL EQUIPMENT SHALL BE SCREENED FROM VIEW.


5. AT THE TIME COMMON AREA IRRIGATION IS CONNECTED TO JOURNAL CENTER 2 COMMON AREA IRRIGATION SYSTEM, THE DEVELOPER "TIBURON INVESTMENT, LLC" MUST BE CONTACTED.

Zoning (Existing)	= IP							
Site Area	= 10.0496 ac.							
Building Area (Gross)	= 96,400 sf							
Parking Required* Phase 1								
1st flr office rentable 30,480sf @ 1/200	= 152.4							
2nd fir office rentable 32,050sf @ 1/300	= 106.8							
3rd flr office rentable 29,360sf © 1/300 Subtotal Required	= 97.9 = 358							
Phase 2	_ 330							
1st fir office rentable 30,480sf @ 1/200	= 152.4							
2nd flr office rentable 32,050sf @ 1/300	= 106.8							
3rd flr office rentable 29,360sf @ 1/300	= 97.9							
Subtotal Required	= 358							
Total Required	= 716							
Handicap Accessible Stalls Required	= 24							
Parking Provided (Phase 1)								
Standard Spaces	= 387							
Handicap Accessible Stalls	= 12							
Subtotal Provided	= 399							
Parking Provided (Phase 2)								
Standard Spaces Handicap Accessible Stalls	= 310 = 12							
•								
Subtotal Provided Total Provided	= 332 = 731							
Bicycle Parking Required (Phase 2)	= 20 (1/20 automobile spaces)							
Bicycle Parking Provided (Phase 2) = 21 (3 rows of 7 each)								

- 1. 14' HIGH MASONRY SCREEN WALL TO MATCH BUILDING. SEE ELEVATIONS.
- 2. MASONRY REFUSE ENCLOSURE TO MATCH BUILDING.
- 3. SAWCUT & REMOVE EXISTING SIDEWALK AND CURB & GUTTER. INSTALL HANDICAP RAMP/ MIN. 5'x5' LANDING
- 4. BICYCLE PARKING (21 SPACES). REF. DETAIL ON SHEET C1.1.
- 5. 6' WIDE, PIGMENTED CONCRETE SIDEWALK CROSSING TO MEET JOURNAL CENTER STANDARDS (2% MAX. CROSS SLOPE). PIGMENT COLOR PER ARCHITECT.
- 6. MONUMENT SIGN, SEE DETAILS.
- 7. EXISTING 6' WIDE SIDEWALK, INSTALLED WITH PHASE 1.
- 8. 4' HIGH± MASONRY RETAINING WALL. RETAINING WALL SHALL BE SPLIT FACE CMU TO COMPLEMENT BUILDING.
- 9. 6'x6' TREE PLANTER (TYP). REF LANDSCAPE PLANS FOR TREATMENT.
- 10. LIGHT POLE. PER DETAILS SHEET C1.1.
- 11. MEDIAN CURB & GUTTER PER COA STD DWG 2415B (6" HIGH CURB).
- 12. CONC VALLEY GUTTER PER COA STD DWG 2421 (SECTION A-A).
- 13. 4" THICK CONCRETE SIDEWALK PER COA STD DWG 2430.
- 14. INSTALL PRECAST CONCRETE WHEELSTOP PER MANUFACTURER'S RECOMMENDATIONS.
- DETAIL ON SHEET C1.1.

15. INSTALL HANDICAPPED PARKING SPACES, STRIPING, AND SIGNAGE PER

- 16. INSTALL CURB ACCESS RAMP PER COA STD DWGS 2440 AND 2441.
- 17. INSTALL 4" WIDE WHITE PARKING STRIPE (2 COATS PAINT).
- 18. INSTALL NEW ASPHALT PAVEMENT PER DETAILS SHEET C1.1.
- 19. INSTALL FIRE LANE STRIPING ON CURB. FACE OF CURB SHALL BE PAINTED SOLID RED WITH 4" TALL WHITE LETTERS STATING "FIRE LANE - NO PARKING" AT MINIMUM 20' INTERVALS.

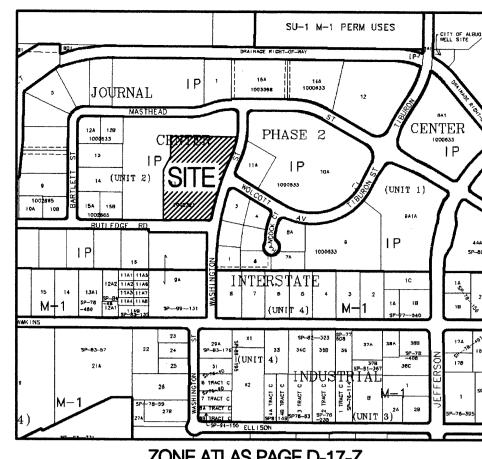

LEGAL DESCRIPTION
TRACT 11-B OF JOURNAL CENTER UNIT 2, PHASE 2
ALBUQUERQUE, NM, NOVEMBER, 2005

PROJECT NUMBER:

Application Number:

or for construction of public improvements.

Water Utility Department

Solid Waste Management

City Engineer

*Environmental Health, if necessary

Parks and Recreation Department

DRESITE DEVELOPMENT PLAN APPROVAL:

Traffic Engineering, Transportation Division

* Environmental Health Department (conditional)

DRB Chairperson, Planning Department

AMENDED SPBP PRELIMINARY PLAT APPROVED BY DRB

ZONE ATLAS PAGE D-17-Z SCALE: 1"=600'±

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Is an Infrastructure List required? () Yes (X) No If yes, then a set of approved DRC plans with a work order is required for any construction within Public Right-of-Way MK DATE DESCRIPTION

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DATE: MAY 17, 2006 SHEET NO

C1.0

REVISIONS

DRAWN BY: CHECKED BY:

JDS BJS

JOB NUMBER:

A0559

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DRAWING INDEX

C2.0 - PRELIMINARY GRADING PLAN

C3.0 - CONCEPTUAL UTILITY PLAN

C1.0 - SITE PLAN

Att Section


W. Carlott

C1.1 - SITE DETAILS


L1.0 - LANDSCAPE PLAN

A2.1 — BUILDING ELEVATIONS A2.2 - BUILDING ELEVATIONS


AS1.1 - ARCH SITE DETAILS

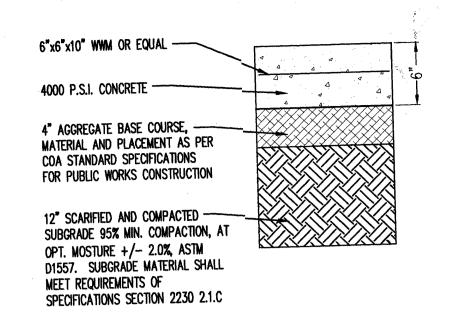

REFUSE ENCLOSURE CONCRETE PAVEMENT

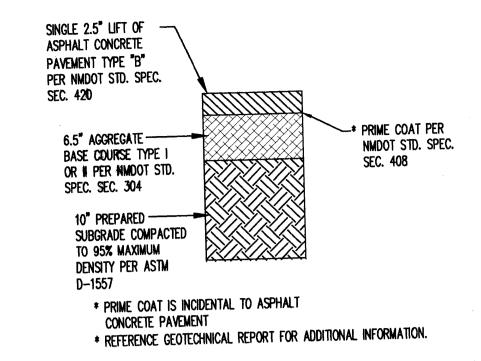


LIGHT DUTY ASPHALT PAVEMENT SECTION

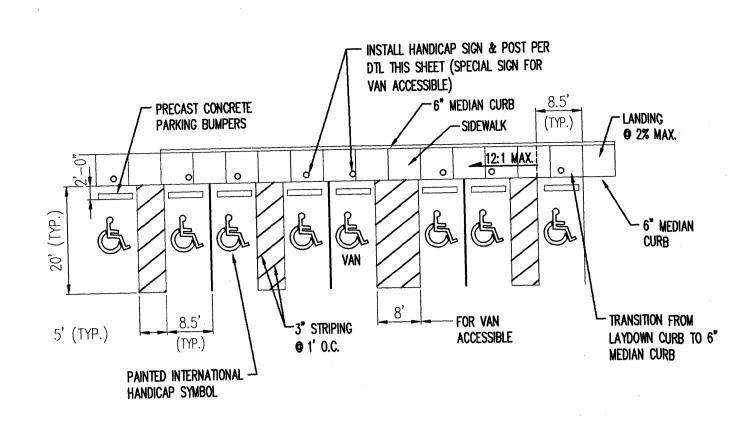


HANDICAP PARKING DETAIL


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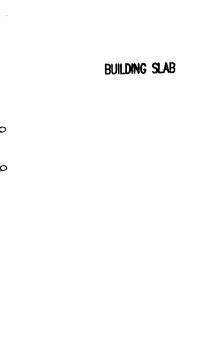
SINGLE 2.5" LIFT OF ASPHALT CONCRETE PAVEMENT TYPE "B" PER NMDOT STD. SPEC. SEC. 420 * PRIME COAT PER 9.5" AGGREGATE ----NMDOT STD. SPEC. BASE COURSE TYPE I SEC. 408 OR II PER NMDOT STD. SPEC. SEC. 304 10" PREPARED ----SUBGRADE COMPACTED TO 95% MAXIMUM DENSITY PER ASTM D-1557 * PRIME COAT IS INCIDENTAL TO ASPHALT CONCRETE PAVEMENT * REFERENCE GEOTECHNICAL REPORT FOR ADDITIONAL INFORMATION.

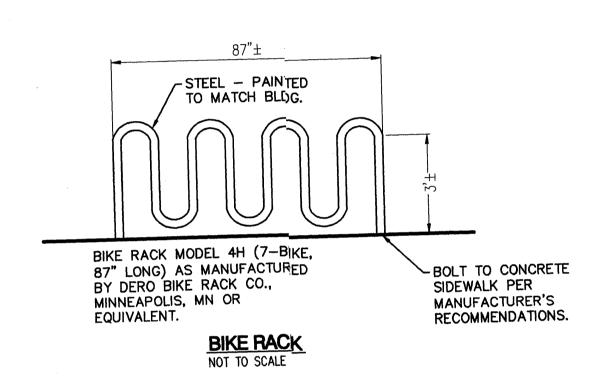
HEAVY DUTY ASPHALT PAVEMENT SECTION
N.T.S.



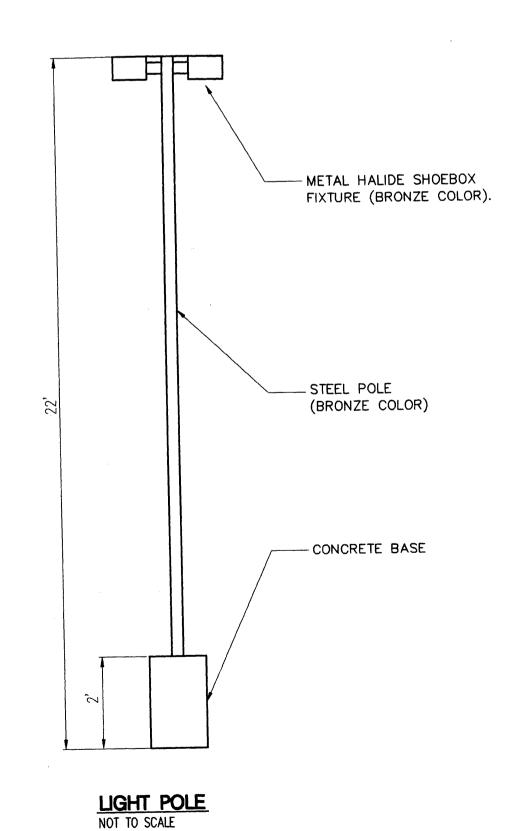

SIDEWALK CROSSING DETAIL
NOT TO SCALE

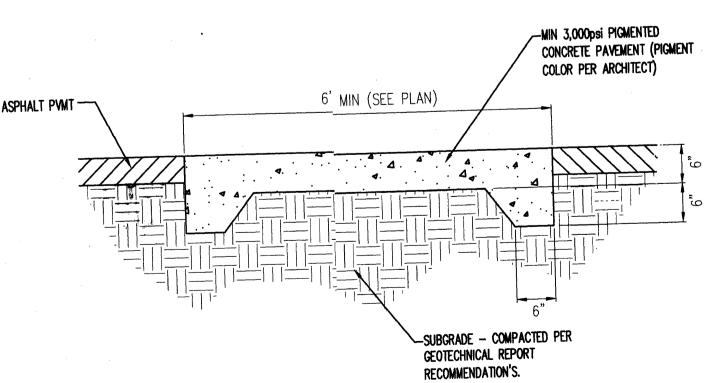

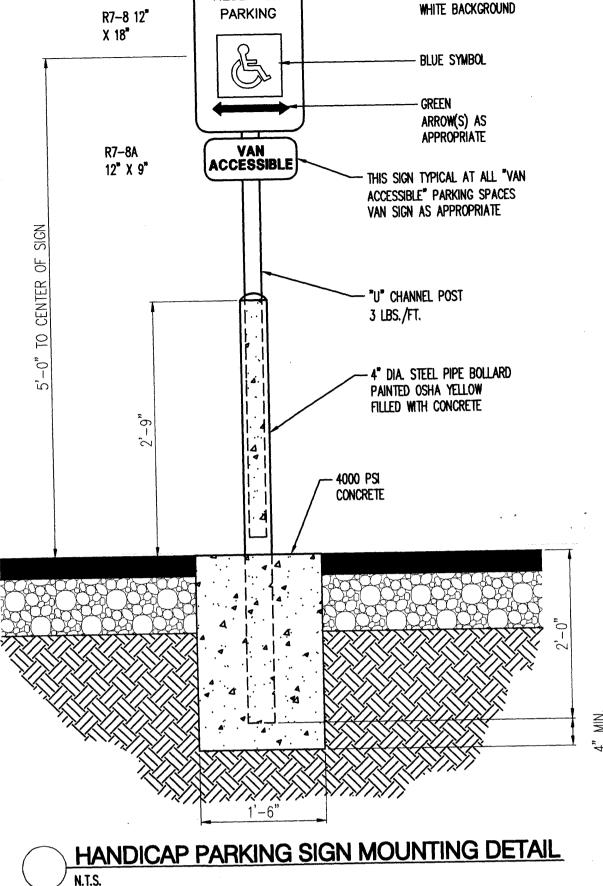

RESERVED -

— Green Lettering on

N.T.S.
ONE SIGN SHALL BE INSTALLED AT EACH HANDICAP SPACE.

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REVISIONS

MK DATE DESCRIPTION

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JDS BJS

JOB NUMBER:

A0559

DATE:

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CONSULTANT

PROJECT TITLE

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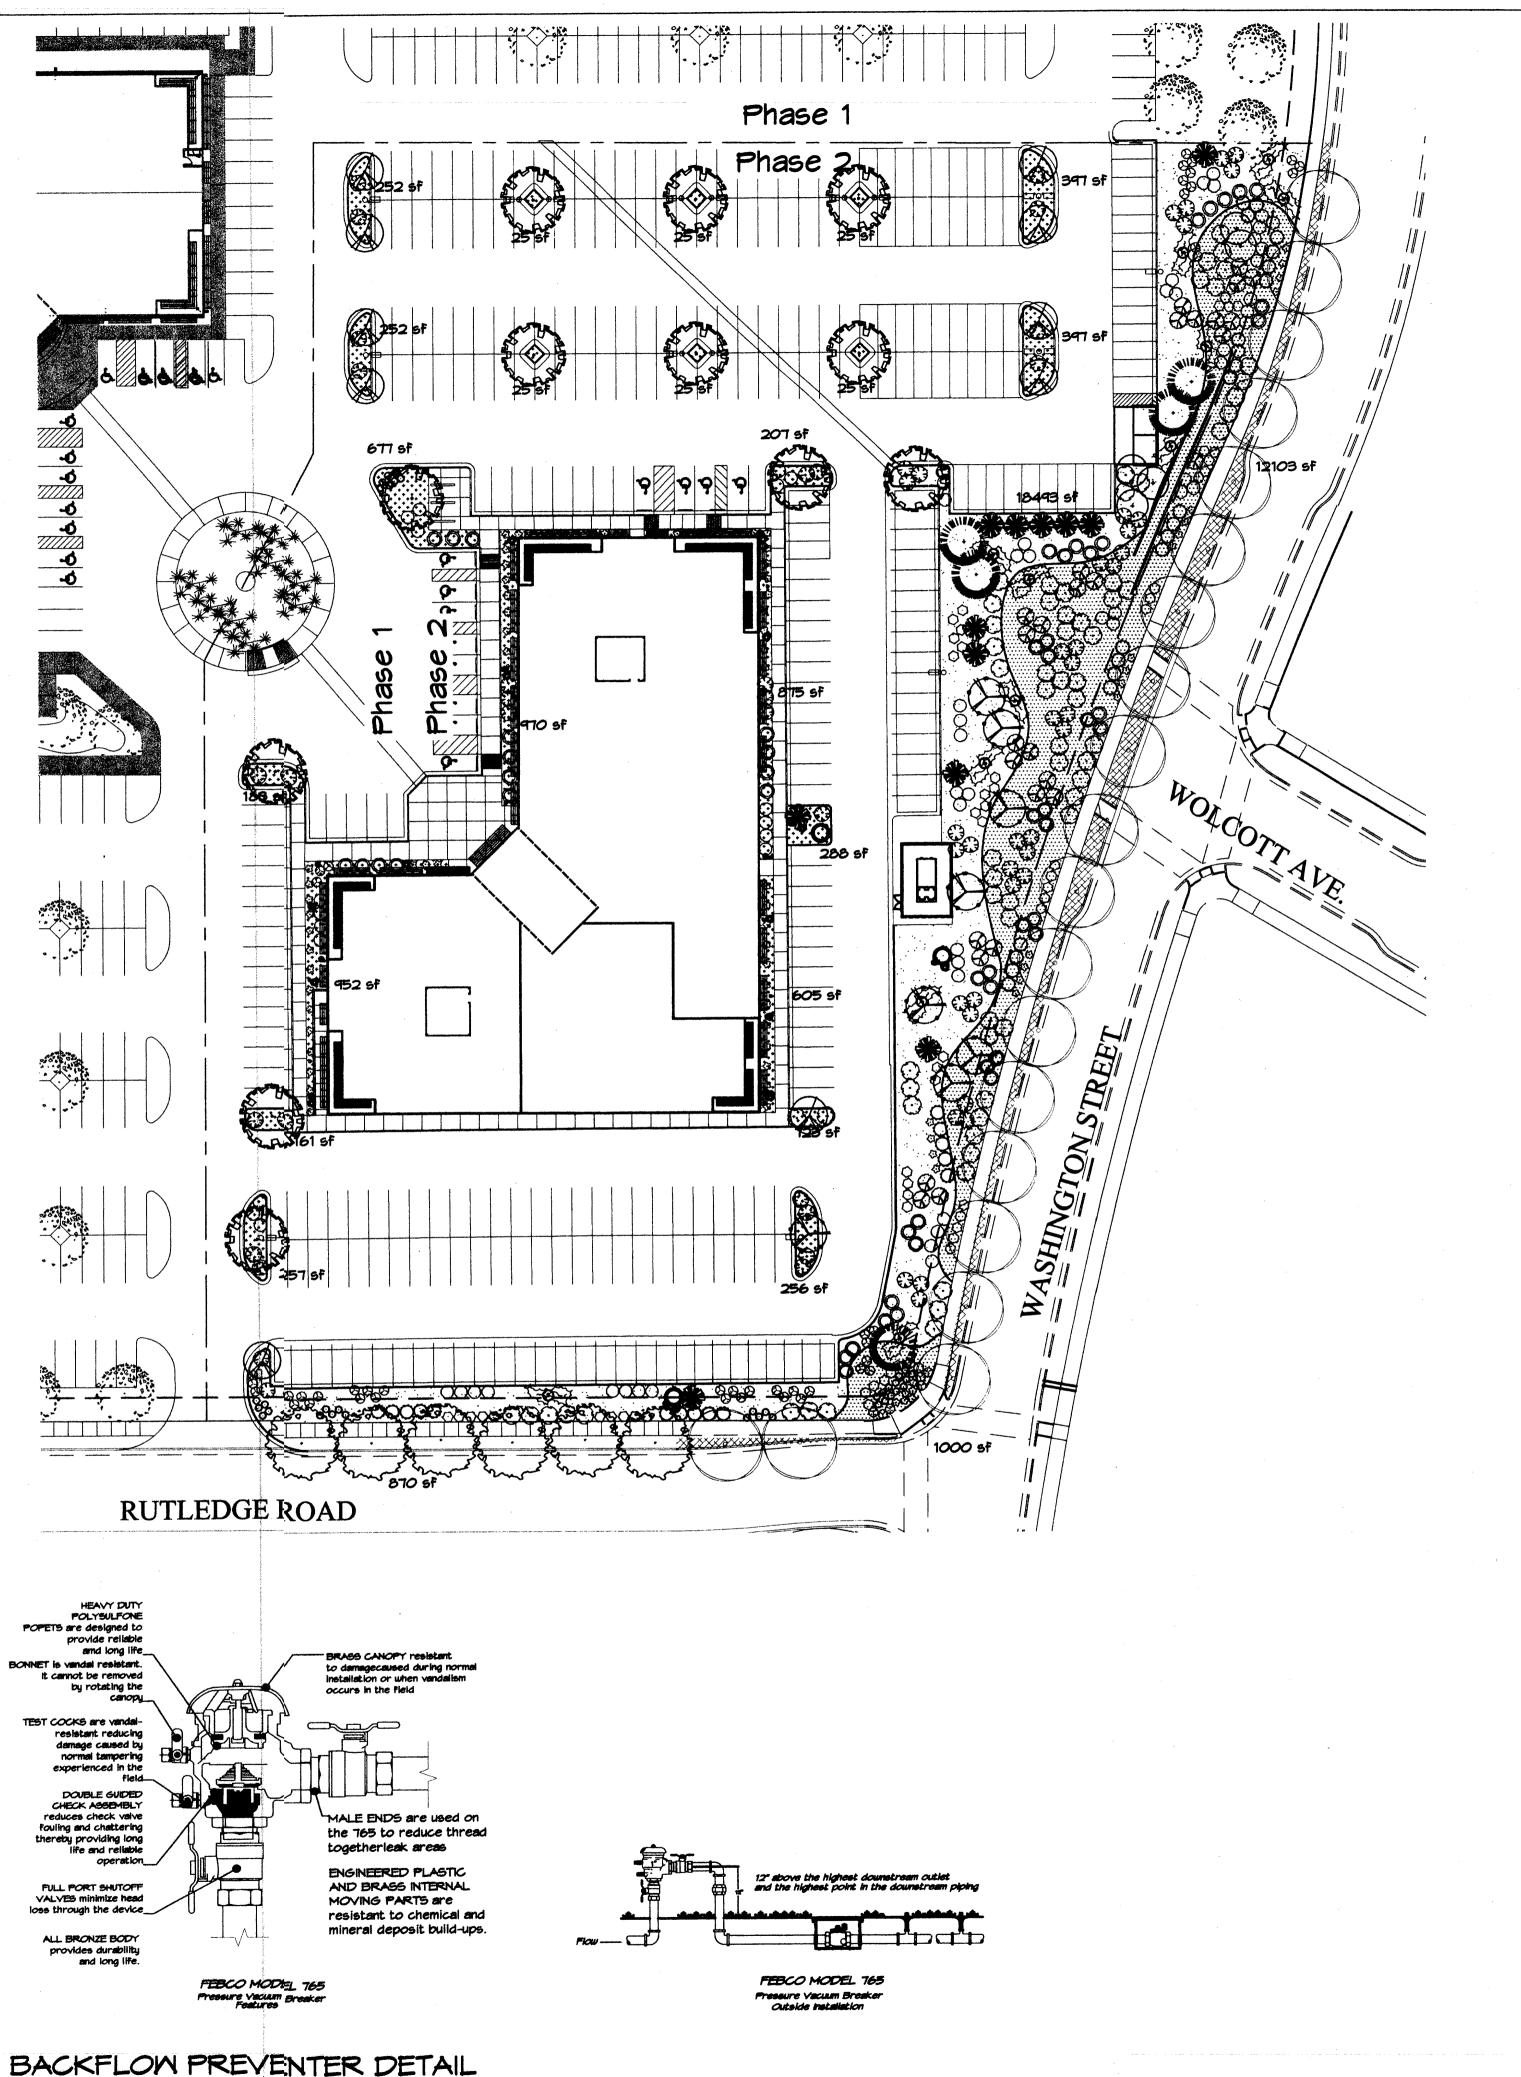
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FOR

Courtyard 1 7500 Jefferson St. NE Albuquerque, NM 87109-4335
ENGINEERING & SPATIAL DATA & ADVANCED TECHNOLOGIES

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188 - 185



PLANT LEGEND

EXISTING POWIS CASTLE SAGE (L) 28 MUGO PINE (M) 3 BERINDA ASH O Pinus mugo 5 Gal. 36sf Artimesia x powis castle 5 Gal. 25sf BERINDA ASH (H) 6 Fraxinus SPP. 2" Cal. WINTER JASMINE (L+) 68 CURLLEAF MTN MAHOGANY (L) 70 Carcorpus ledfolius 5 Gal. 1005F Jasminum nudiflorum 5 Gal. 144sf (PER THE JOURNAL CENTER REQUIREMENTS FOR STREET TREE **MILDFLOWER 50** THREE-LEAF SUMAC (L) 38 Rhus trilobata 5 Gal. 36sf 1 Gal. 4sf CHINESE PISTACHE (M) 12
Pistachia chinensis
2" Cal. GREYLEAF COTONEASTER 36 Cotoneaster buxifolius APACHE PLUME (L) 67 Fallugia paradoxa each symbol indicates 3 plants 42sf BOULDERS (41) THREADGRASS (M) 89 Stipa tennuisima NATURAL EDGE 1 Gal. 45f AUTUMN SAGE (M) 60 SANTA ANA TAN GRAVEL WITH FILTER FABRIC O Salvia greggii 5 Gal. SANTA FE BROWN GRAVEL WITH FILTER FABRIC LAVENDER (M) 34 GREY CRUSHERFINES WITH FILTER FABRIC Lavandula angustifolia 1 Gal. 95f THORNLESS HAWTHORN (M+) 5 OVERSIZED GRAVEL Crataegus crus-galli inermis ARP ROSEMARY (M) 54 WITH FILTER FABRIC 15 Gal. 225sf Rosmarinus officianalis 5 Gal. 36sf

LANDSCAPE NOTES: Landscape maintenance shall be the responsibility of the Property Owner.

SOTOL 12 Dasylirion wheeleri 5 Gal. 36sf

It is the intent of this plan to comply with the City Of Albuquerque Water Conservation Landscaping and Water Waste Ordinance planting restriction approach. Approval of this plan does not constitute or imply exemption from water waste provisions of the Water Conservation Landscaping and Water Waste Ordinance.

Water management is the sole responsibility of the Property Owner. All landscaping will be in conformance with the City of Albuquerque Zoning Code, Street Tree Ordinance, Pollen Ordinance, and Water Conservation Landscaping and Water Maste Ordinance. In general, water conservative, environmentally sound landscape principles will be followed in design and installation.

Plant beds shall achieve 75% live ground cover at maturity.

IRRIGATION NOTES: Irrigation shall be a complete underground system with Trees to receive (5) 1.0 GPH Drip Emitters and Shrubs to receive (2) 1.0 GPH Drip Emitters. Drip and Bubbler systems to be tied to 1/2" polypipe with flush caps at each end.

EXISTING LANDSCAPING

Run time per each drip valve will be approximately 15 minutes per day, to be adjusted according to the season.

Point of connection for irrigation system is unknown at current time and will be coordinated in the field. Irrigation will be operated by automatic controller.

Location of controller to be field determined and power source for controller to be provided by others.


Irrigation maintenance shall be the responsibility of the Property Owner.

Mater and Power source shall be the responsibility of the Developer/Builder.

Should The Hilltop not receive a Grading and Drainage plan during the design process or the on site grades differ from the Grading and Drainage plan received, The Hilltop reserves the right to apply slope stabilization materials where the specified gravel will not be suitable. This will be addressed as an infield-change order.

LANDSCAPE CALCULATIONS

182360	square feet
34975	square feet
078	_ square feet
146515	square feet
15%	
21977	square feet
39468	square feet
75%	square feet
29601	square feet
29601	square feet
39468	square feet
	34975 870 146515 15% 21977 39468 75% 5 29601 29601

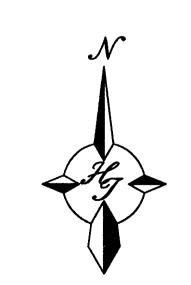

GRAPHIC SCALE

SCALE: 1"=40"



Cont. Lic. #26458 7909 Edith N.E. Albuquerque, NM 87184 Ph. (505) 898-9690 Fax (505) 898-7737 cjohnson@hilltoplandscaping.com All creative ideas contained Herein remains the property of The Hilltop Landscape Architects and Contractors and are protected by copyright laws. This is an original design and must not be released or copied

unless applicable fees have been paid or job order

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1306 RIO GRANDE BLVD NW


ALBUQUERQUE, NM 87104

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1 5-17-06 site revision adf MK DATE DESCRIPTION

> A0559 **NOVEMBER 2005**



DRAINAGE MANAGEMENT PLAN

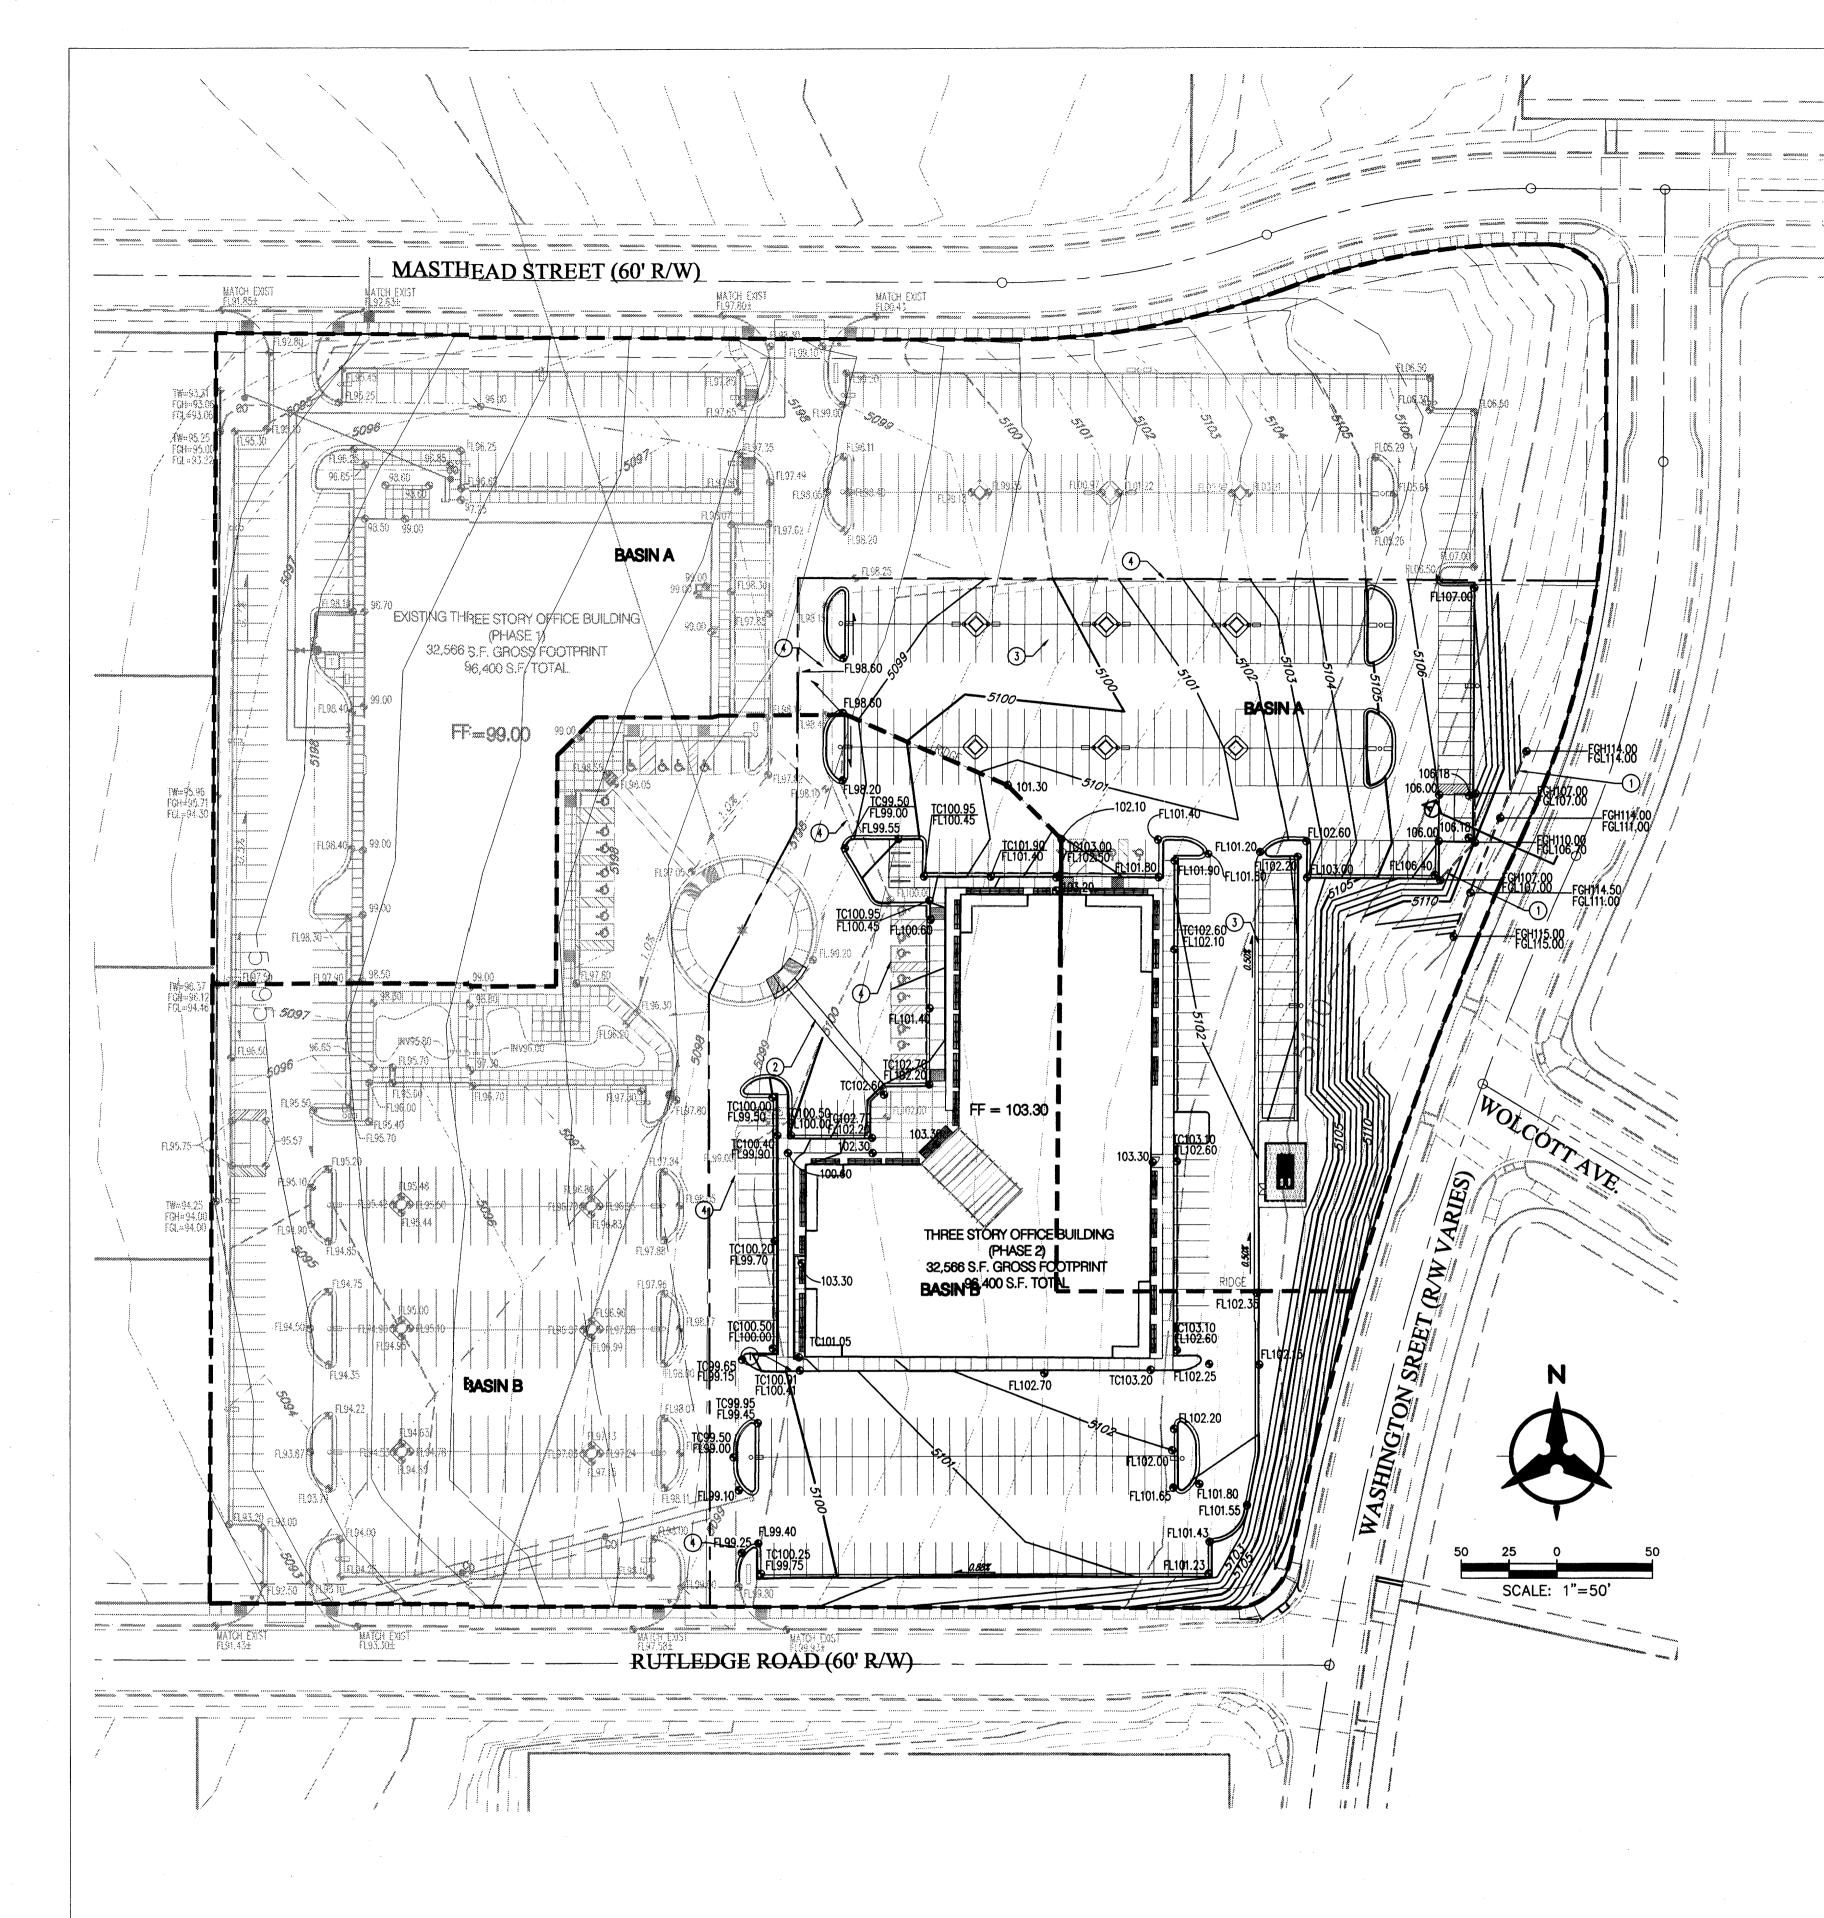I. INTRODUCTION

The purpose of this submittal is to provide a final Drainage Management Plan for development of the Masthead Office Complex at Journal Center 2 - Phase 2, located in the Journal Center, Phase 2, Unit 2, Lot 11-B in NE Albuquerque.

II. SITE LOCATION

The site is currently legally described as, Journal Center, Phase 2, Unit 2, Lot 11-B (+/- 4.4 acres). The site is located within zone atlas map #D-17, and is in hydrologic zone 2. The site is located at the southwest corner of Masthead and Washington, just west of Jefferson.

III. SITE TOPOGRAPHY

The site slopes evenly from east to west at a value of less than 5%. Washington Street has a high point at the intersection of Wolcott Avenue from which it slopes north to Masthead and south to Rutledge. The area surrounding the site maintains similar topography.

IV. EXISTING HYDROLOGIC CONDITIONS

Currently the site (4.4 ac.) is undeveloped land. The surrounding streets and infrastructure are in place and Phase 1 of the development is currently under construction. The site drains from east to west in a sheet flow condition. Per the approved Drainage Plan of Journal Center - Phase 2 located in file number D17/D3AA, this site has been approved as a fully developed site and can drain to both Masthead and Rutledge via surface flow out of the driveways. Both Masthead and Rutledge drain to the west of the site where the drainage is collected in an underground drainage system. This site is within Basins B1 and C1 of the mentioned drainage plan. Basin B1 drains into Rutledge and the development contained in B1 is allotted 20.11 cfs of outflow. Basin C1 drains into Masthead. The portion of the new development contained in C1 is allotted 24.53 cfs of outflow per the approved Drainage Plan of Journal Center-Phase 2.

V. PROPOSED HYDROLOGIC CONDITIONS

The proposed conditions for the Masthead Office Complex at Journal Center 2 are shown on this Conceptual Grading Plan. The hydrologic analysis for this area is based on drainage requirements for the 100-yr, 6-hr storm event. The total site (+/- 10.0 acres) will generate a total of 44.45 cfs under newly developed conditions and consists of approximately 85% D land treatment. Flows will be conveyed to Masthead and Rutledge by surface and curb and gutters. This split flow will travel west in both roadways to a common existing underground drainage system. This drainage system then flows north to the North Pino Arroyo, and then to the AMAFCA North Diversion Channel. Approximately 20.09cfs drains to Rutledge; the other 24.36 cfs drains to Masthead. These flow values comply with the restrictions placed on the site by the approved drainage plan referenced in Section IV of this document.


VI. CONCLUSION

This drainage management plan provides for grading and drainage elements which are capable of safely passing the 100 year storm and which meet city requirements and are in conformance with the previously approved master drainage plan for Journal Center, Phase 2. With this submittal we are requesting building permit approval.

				US	FORES	T SERV	ICE BUILD	ING			
				Pro	posed Co	nditions l	Basin Data 1	Table			
*************************	This table	is based	on the DP	M Section	22.2, Zone:	2		······································	······································	······	
BASIN	Area	Area	Land	Land Treatment Percentages				Q(100)	WTE	V(100) ₃₆₀	V(100) ₁₄₄₀
ID	(SQ. FT)	(AC.)	Α	В	C	D	(cfs/ac.)	(cfs)	(inches)	(CF)	(CF)
PROPOS	ED COND	ITIONS		***************************************			<u> </u>				
Α	239933	5.51	0.0%	5.0%	10.0%	85.0%	4.42	24.36	1.95	39069	48887
В	197855	4.54	0.0%	5.0%	10.0%	85.0%	4.42	20.09	1.95	32217	38664
TOTAL	437788	10.05	-	-	-	-	4.42	44.45	3.91	71286.48	71286

MIN

RETAINING WALL/REFUSE ENCLOSURE WALL

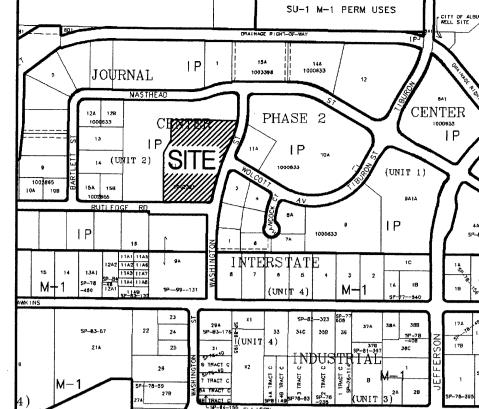

LEGAL DESCRIPTION

TRACT 11-B OF JOURNAL CENTER UNIT 2, PHASE 2 ALBUQUERQUE, NM, NOVEMBER, 2005

LEGEND

	EXISTING CONTOUR
35	PROPOSED INDEX CONTOUR
32	PROPOSED INTERMEDIATE CONTOUR

EXISTING SPOT ELEVATION

→ 32.40 FL = FLOWLINETS = TOP OF SIDEWALK

DIRECTION OF FLOW

1. 4' HIGH ± MASONRY RETAINING WALL.

2. 2% MAXIMUM CROSS-SLOPE AT SIDEWALK CROSSING.

3. CONCRETE VALLEY GUTTER, REFER TO SITE PLAN.

- EX. SIDEWALK

PROPOSED SPOT ELEVATION FGH = FINISHED GROUND HIGH SIDE FGL = FINISHED GROUND LOW SIDE TW = TOP OF WALL

○ <u>KEYED NOTES</u>

4. MATCH EXISTING PAVEMENT.

RETAINING WALL SECTION A-A

N.T.S.

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> A0559 DATE: MAY 17, 2006


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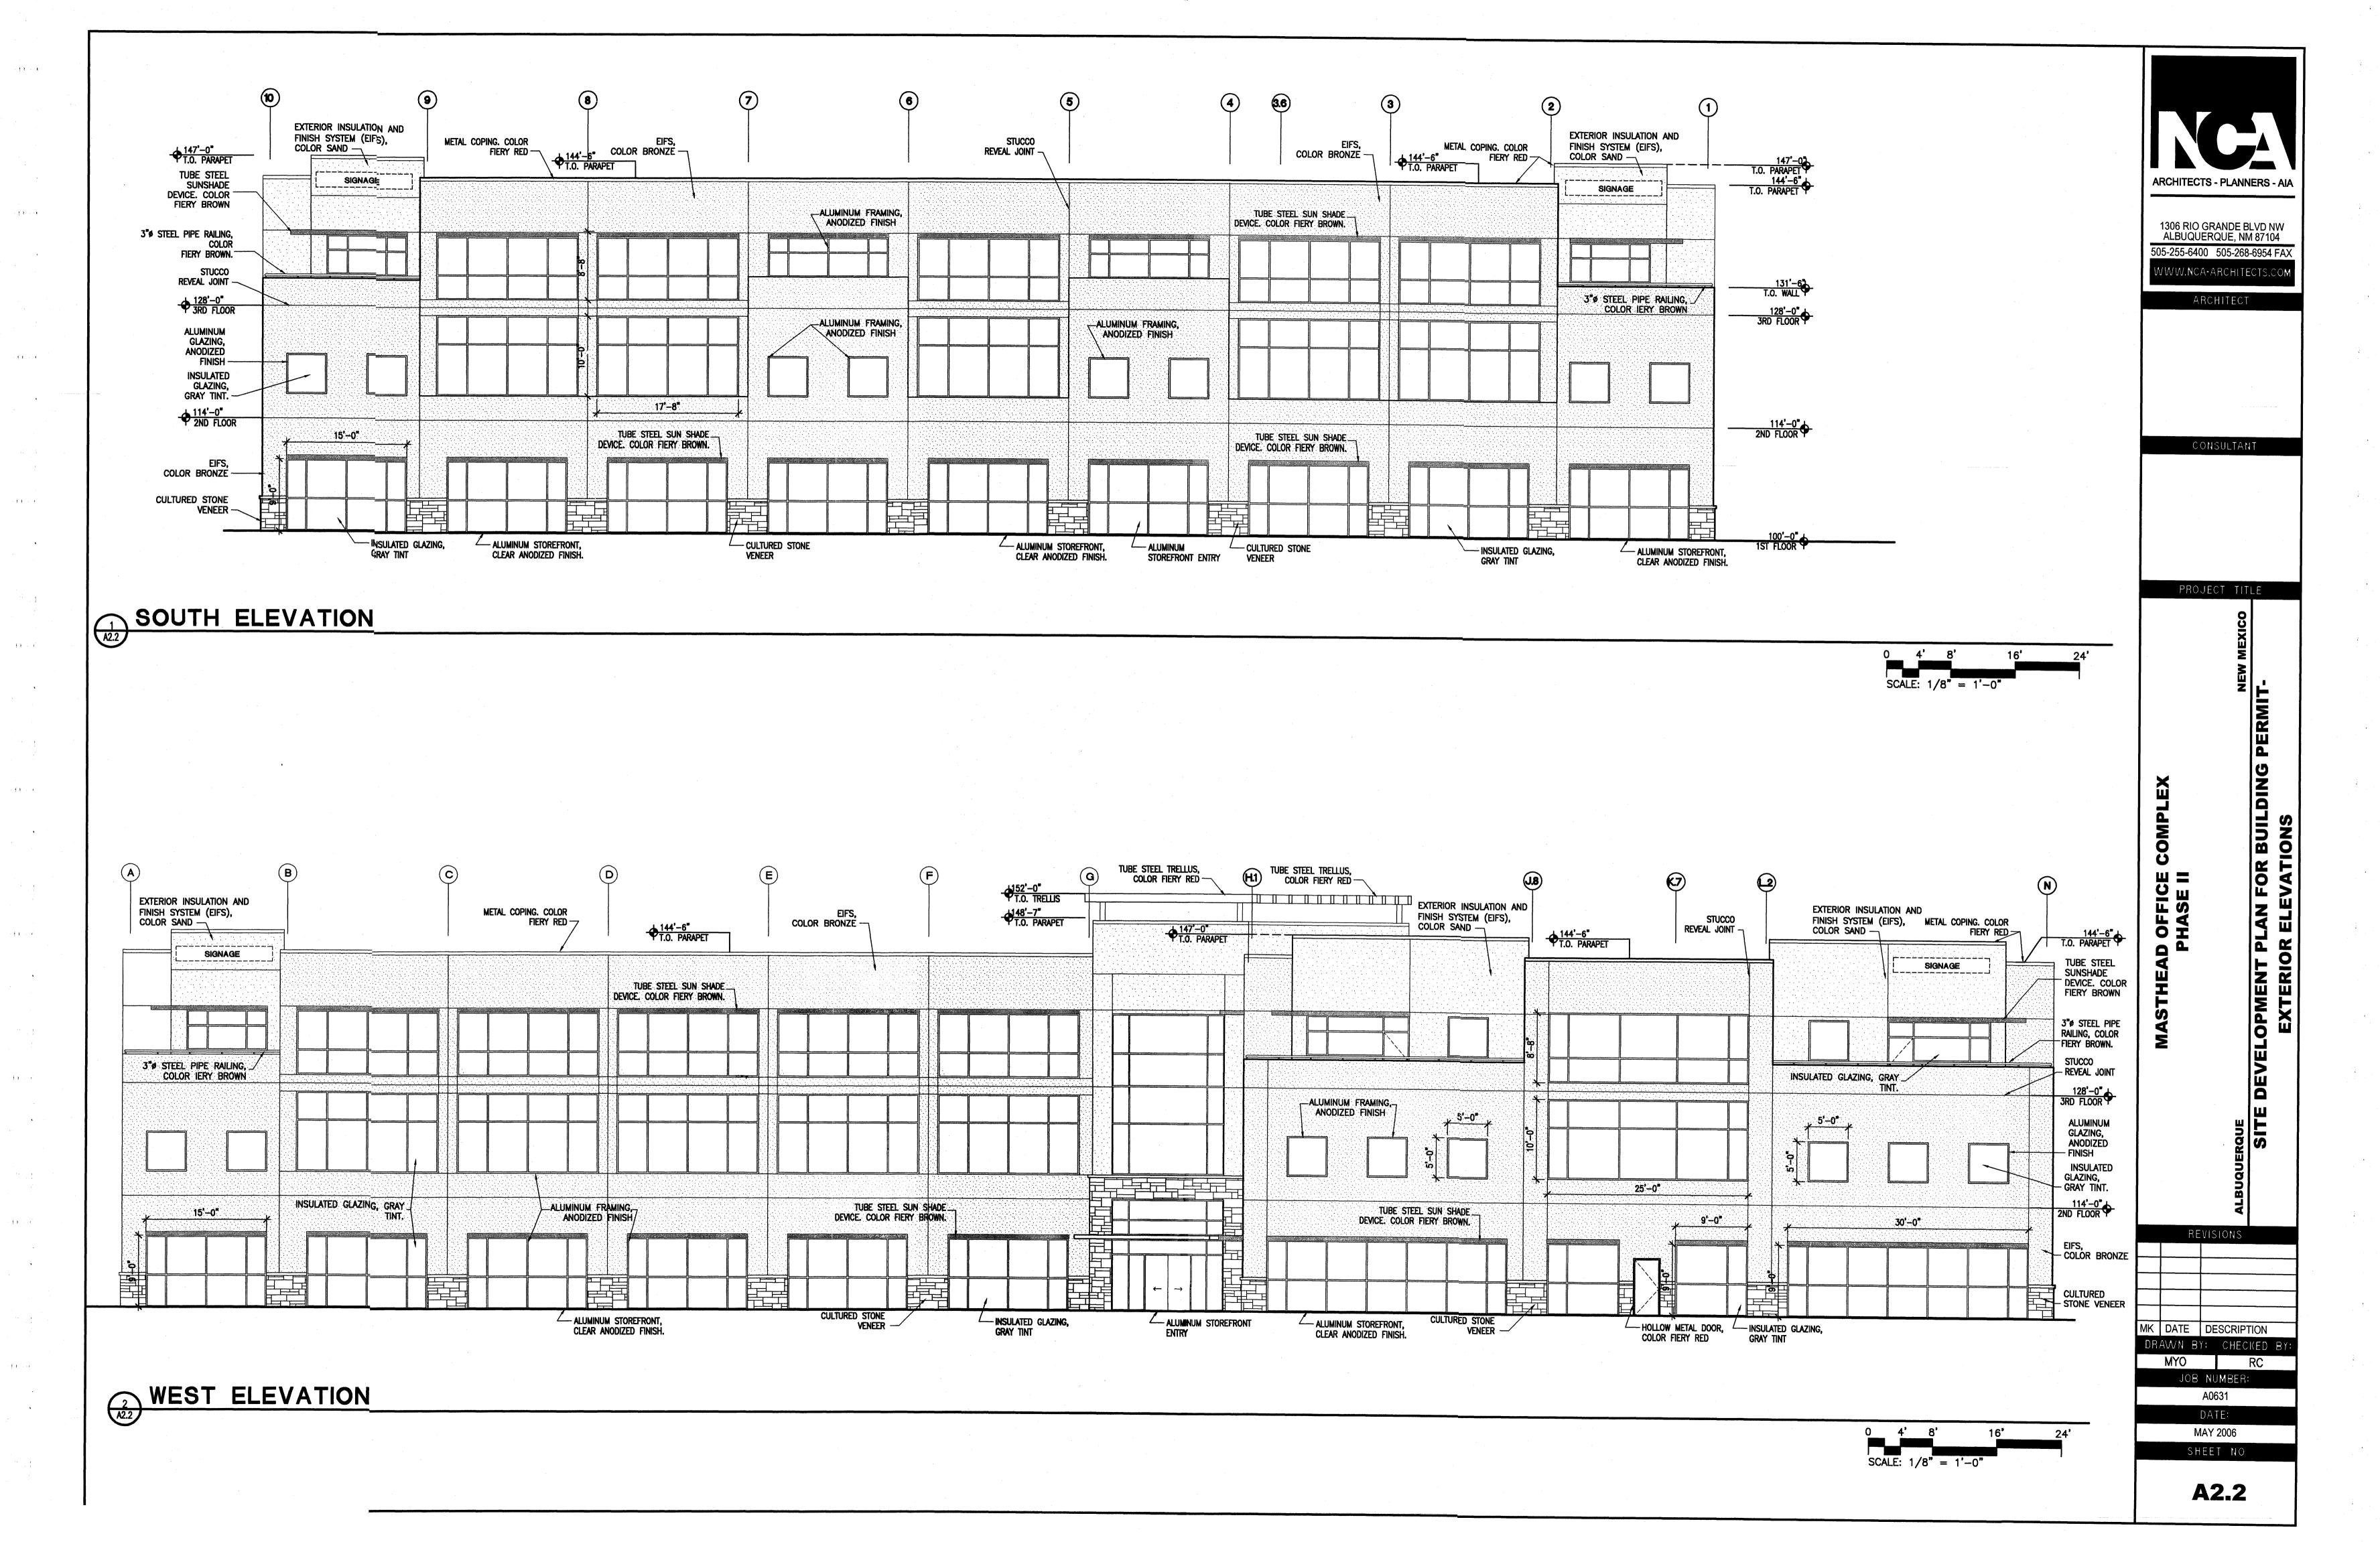
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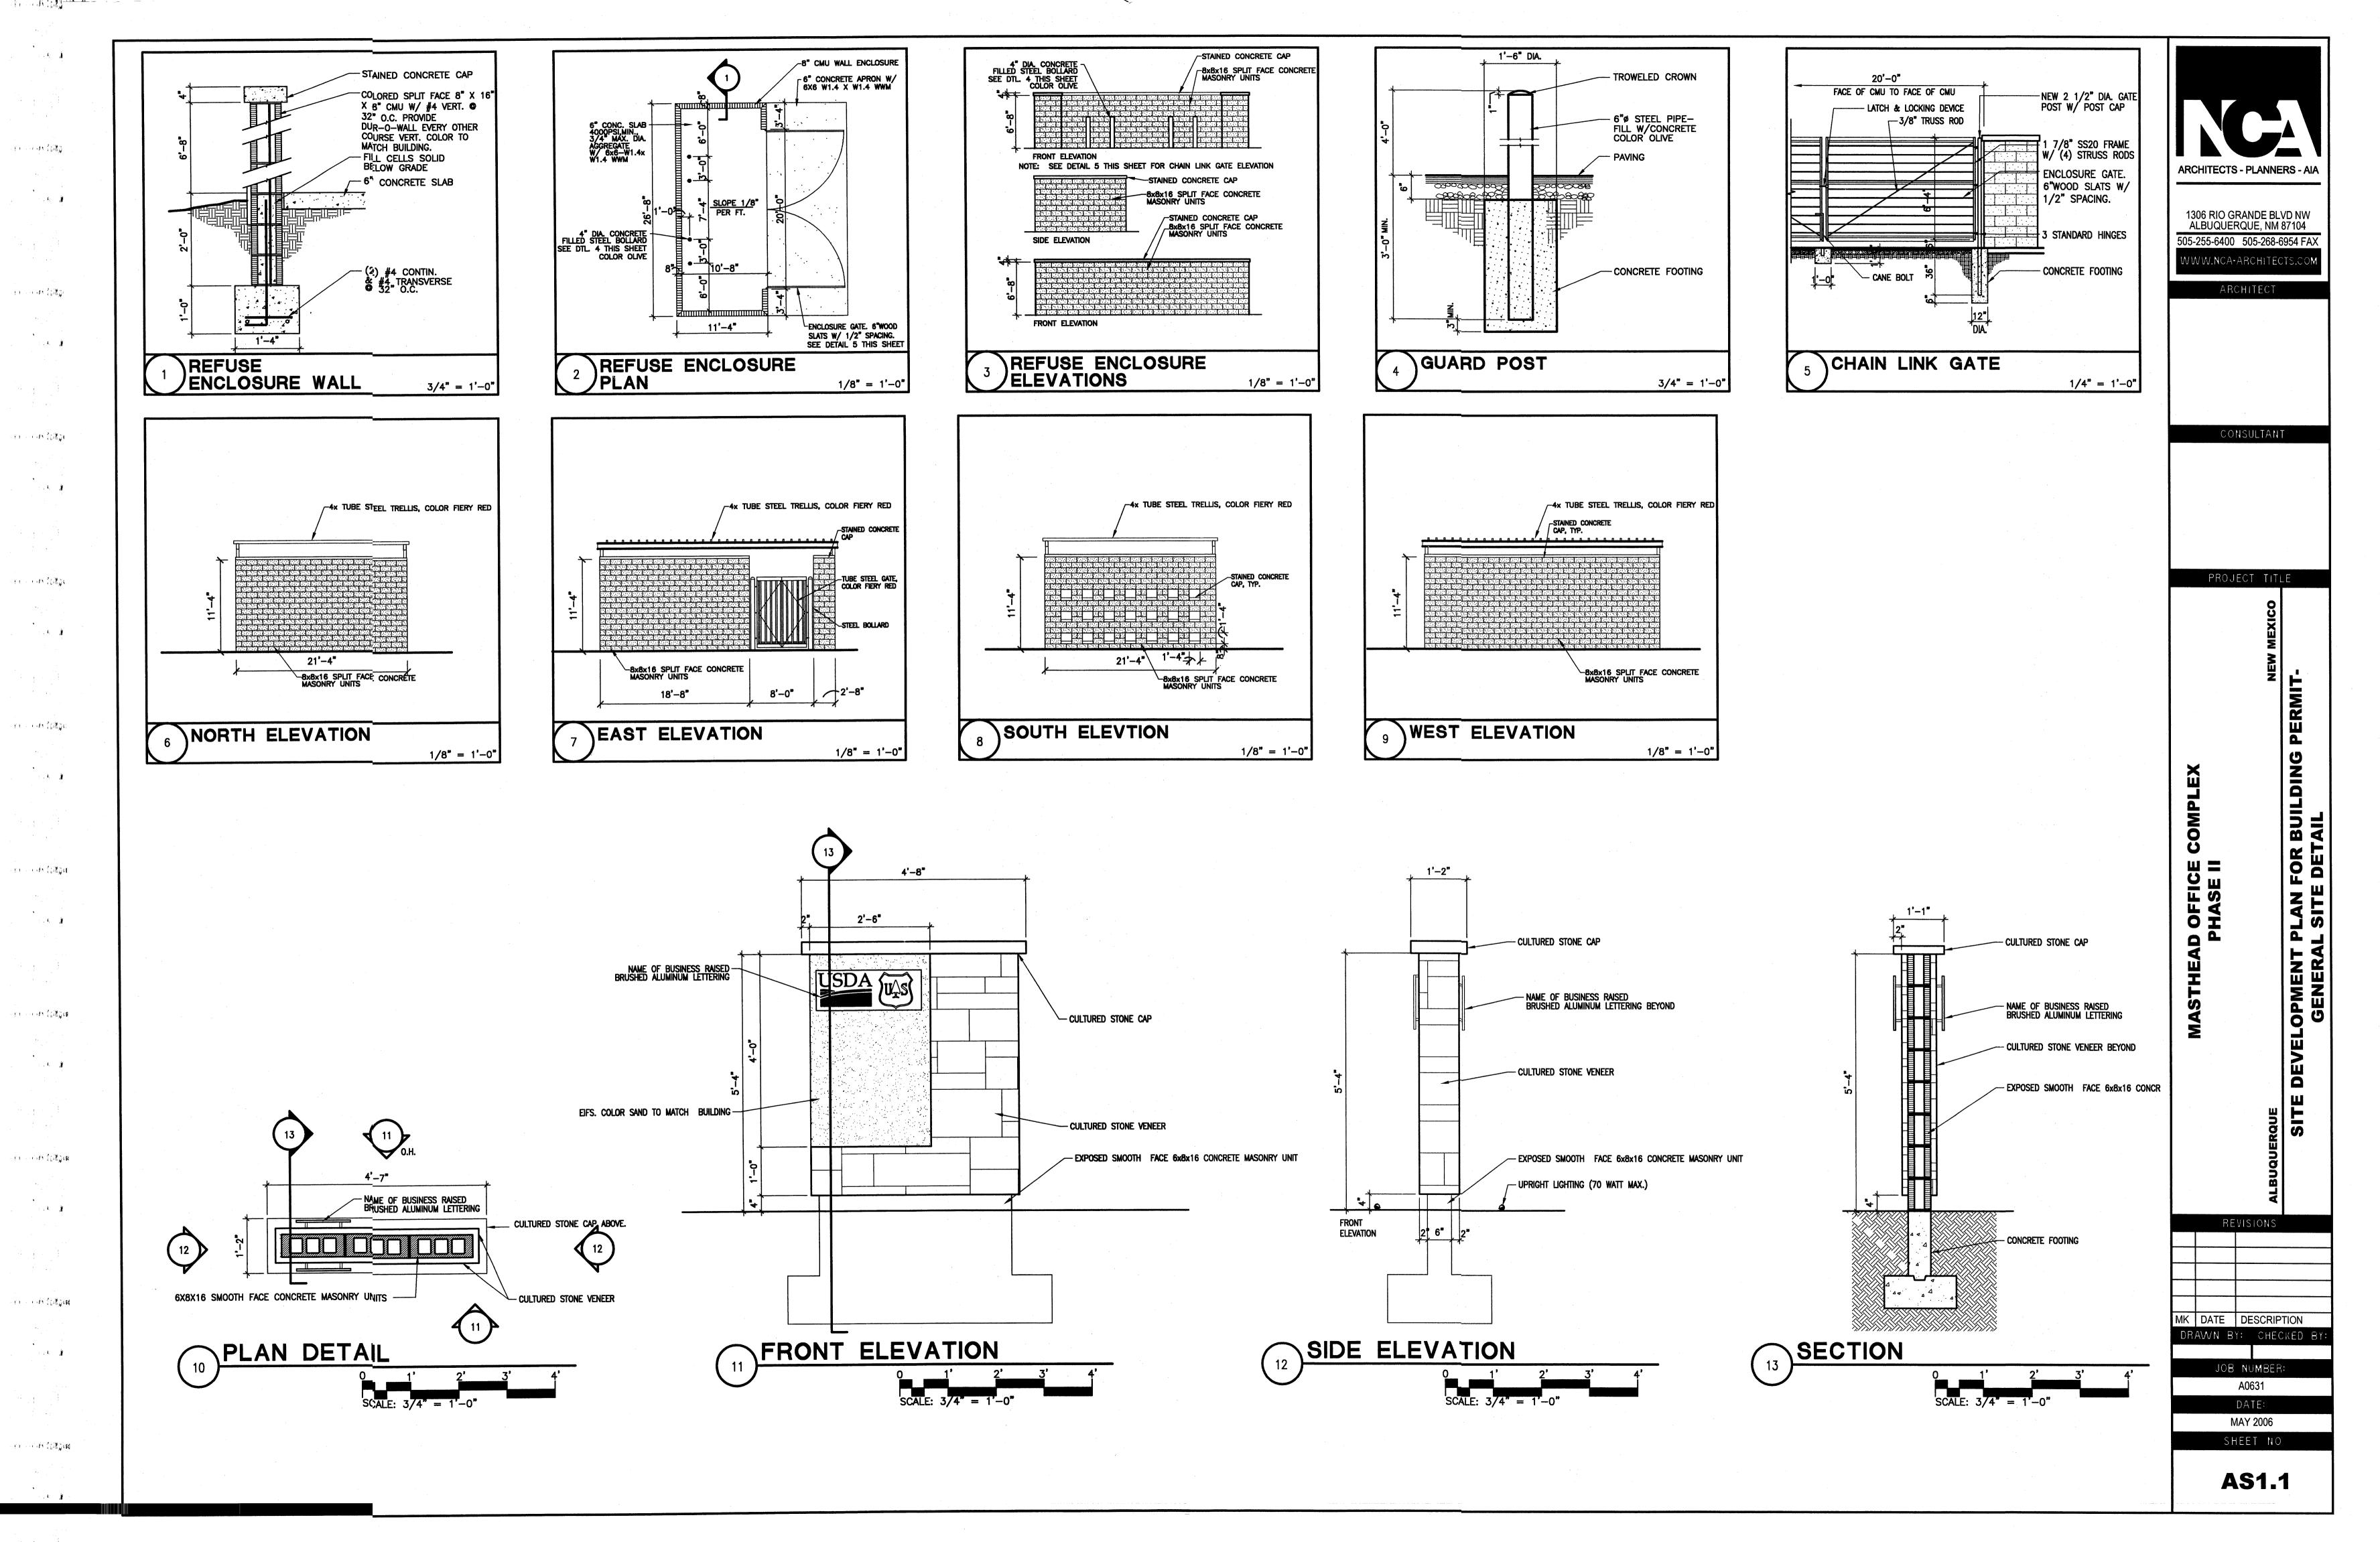
Bohannan A Huston


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UTILITY KEYED NOTES

- 1. 6" SANITARY SEWER STUB
- 2. NEW PRIVATE FIRE HYDRANT
- 3. 8" PRIVATE FIRE LINE SERVICE FOR BUILDING SPRINKLERS.
 BACKFLOW PREVENTER TO BE INSTALLED INSIDE MECHANICAL ROOM.
 FDC TO BE LOCATED ON BUILDING WALL.
- 4. NEW 1 1/2" METERED WATER SERVICE. CONNECT TO EXISTING 2" WATER LINE STUB OUT.
- 5. CONNECTION TO EXISTING 8" FIRE LINE STUB
- NEW 1 1/2" DOMESTIC WATER SERVICE TO BUILDING, BACKFLOW PREVENTER SHALL BE INSIDE MECHANICAL ROOM.
- 7. SANITARY SEWER CLEANOUT
- 8. CONNECT TO EX. 6" SAS STUB PROVIDED TO SITE WITH PHASE 1
- 9. POST INDICATOR VALVE.

LEGEND

	PROPERTY LINE
EX. 8" SAS	EX SANITARY SEWER & MANHOLE
	EX STORM DRAIN & MANHOLE
00000000000000000000000000000000000000	ex inlet
EX. 12" WL	EX WATER LINE
X	EX VALVE
	EX METER
⊗	EX FIRE HYDRANT
***	ex street light
SAS	PROPOSED SANITARY SEWER
● _{co}	PROPOSED CLEANOUT
WL	PROPOSED WATERLINE
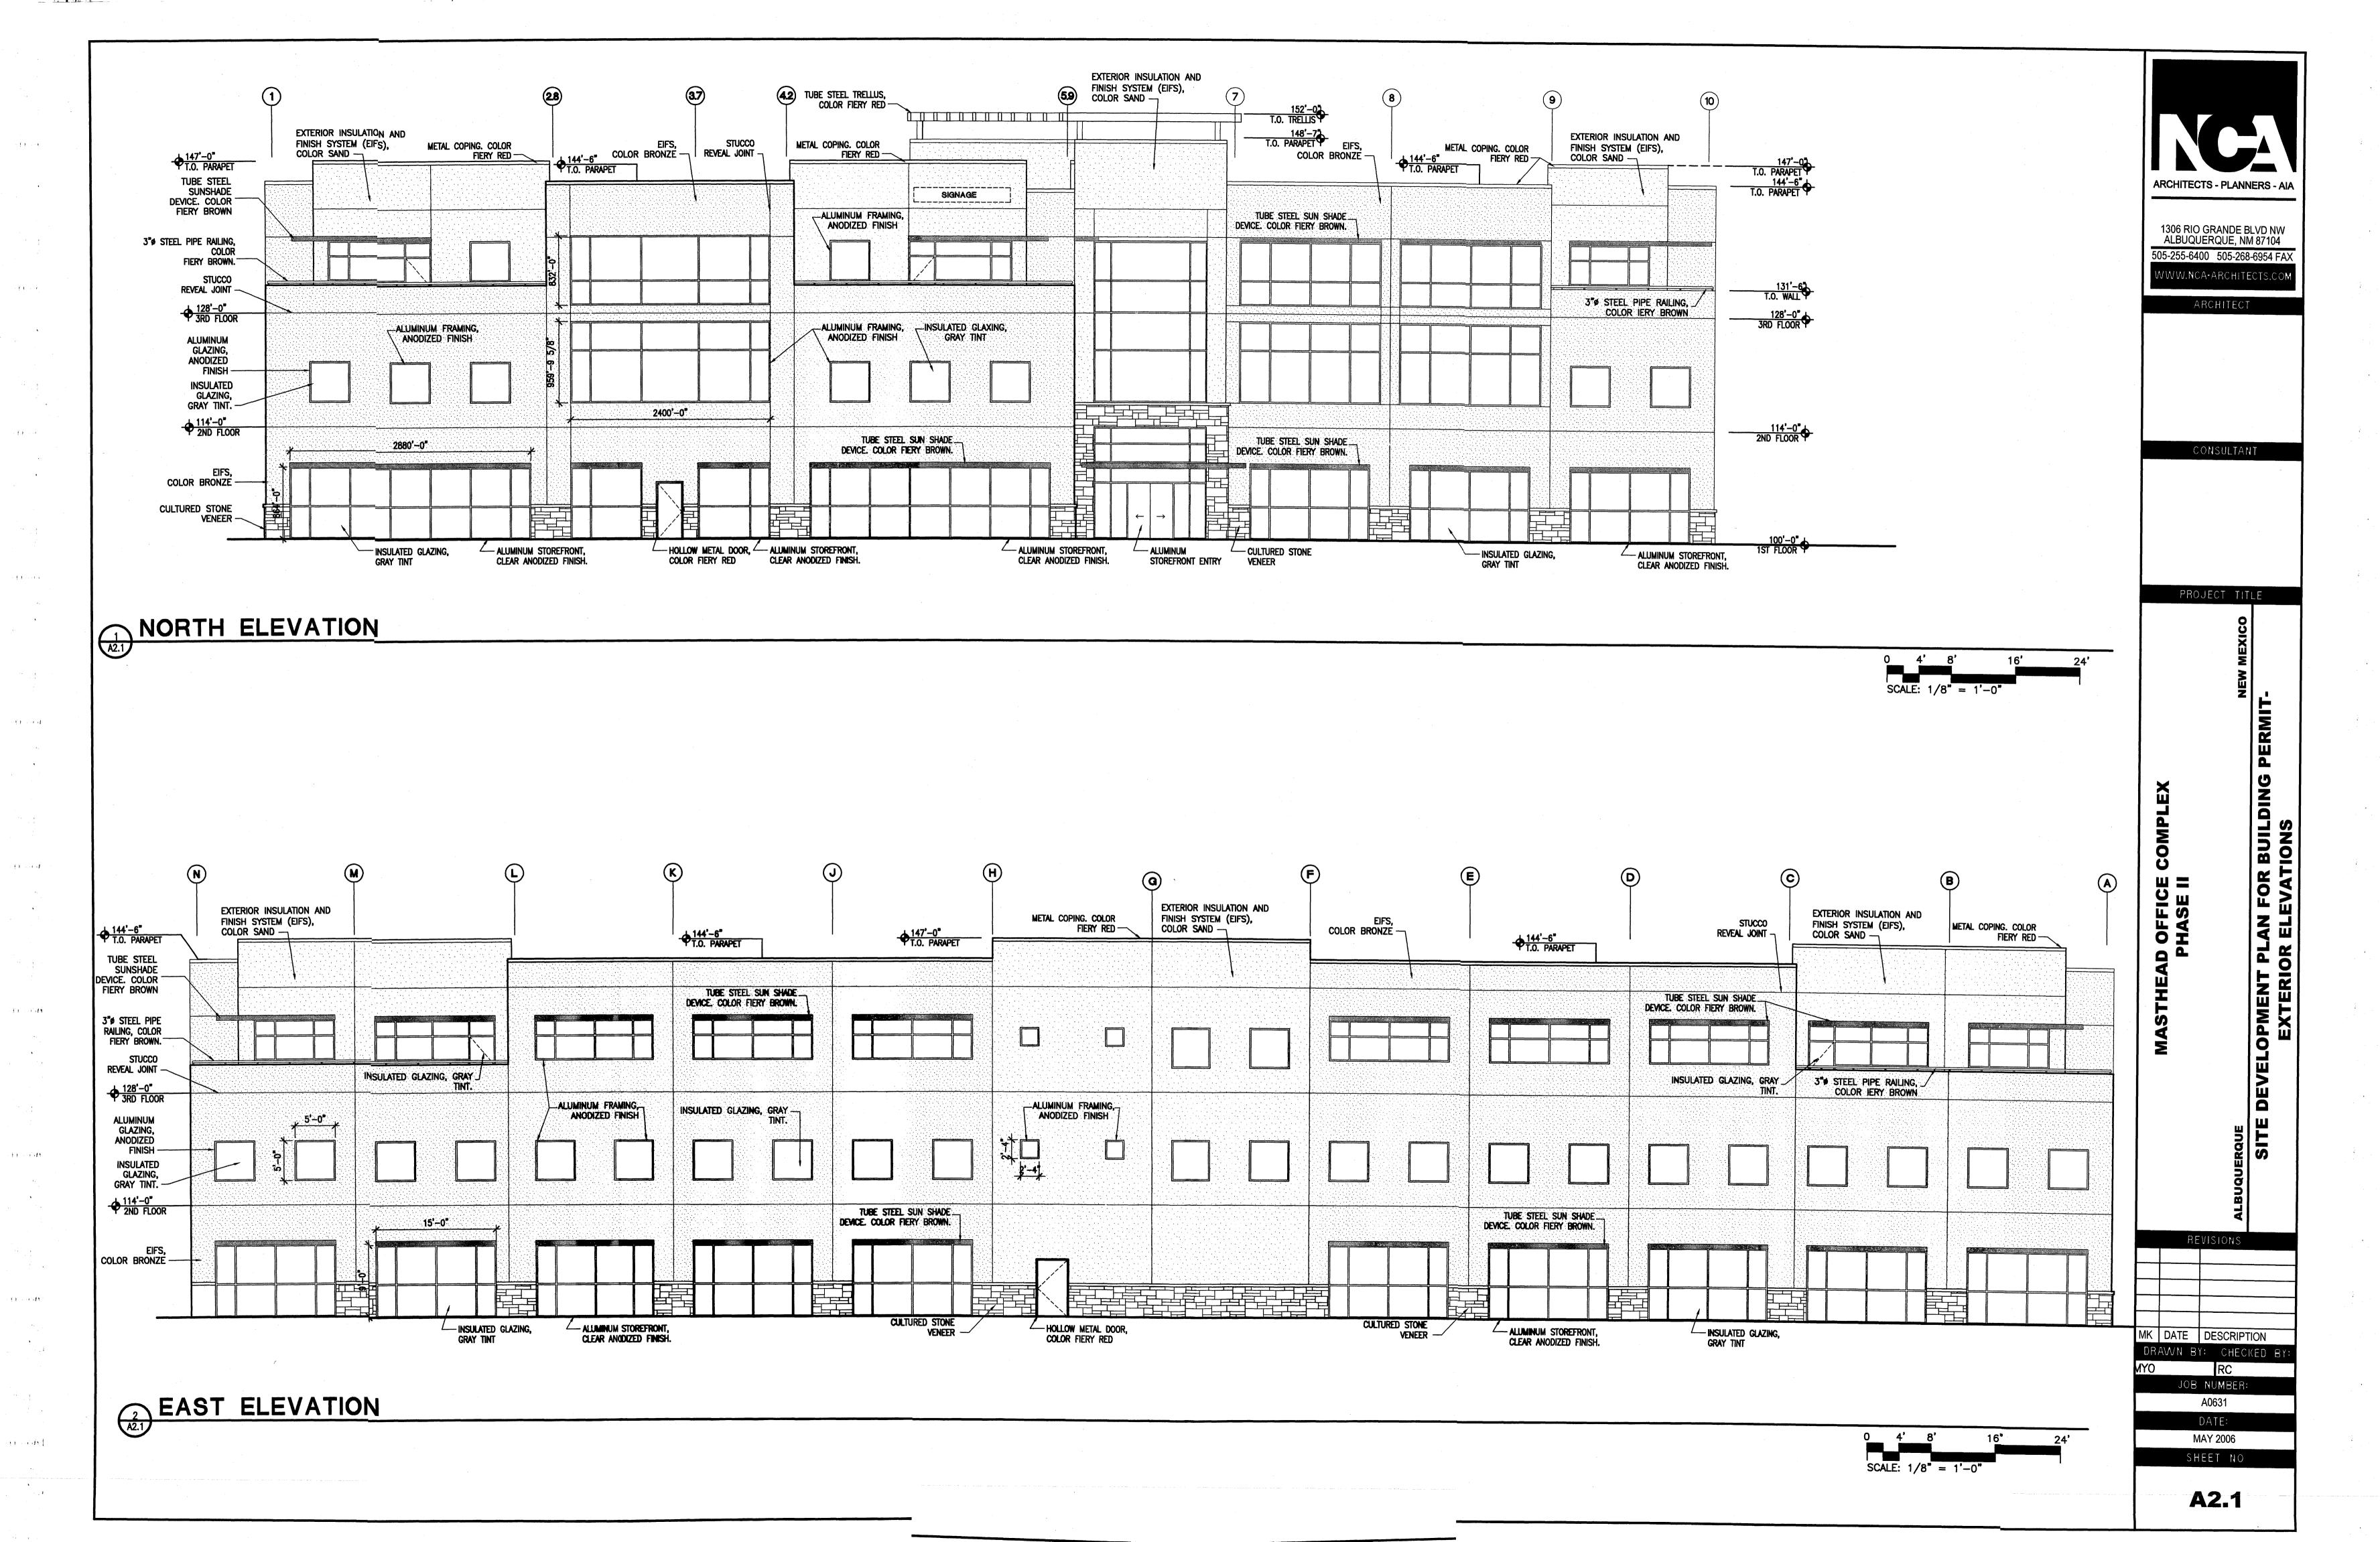
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DEVELOPEME

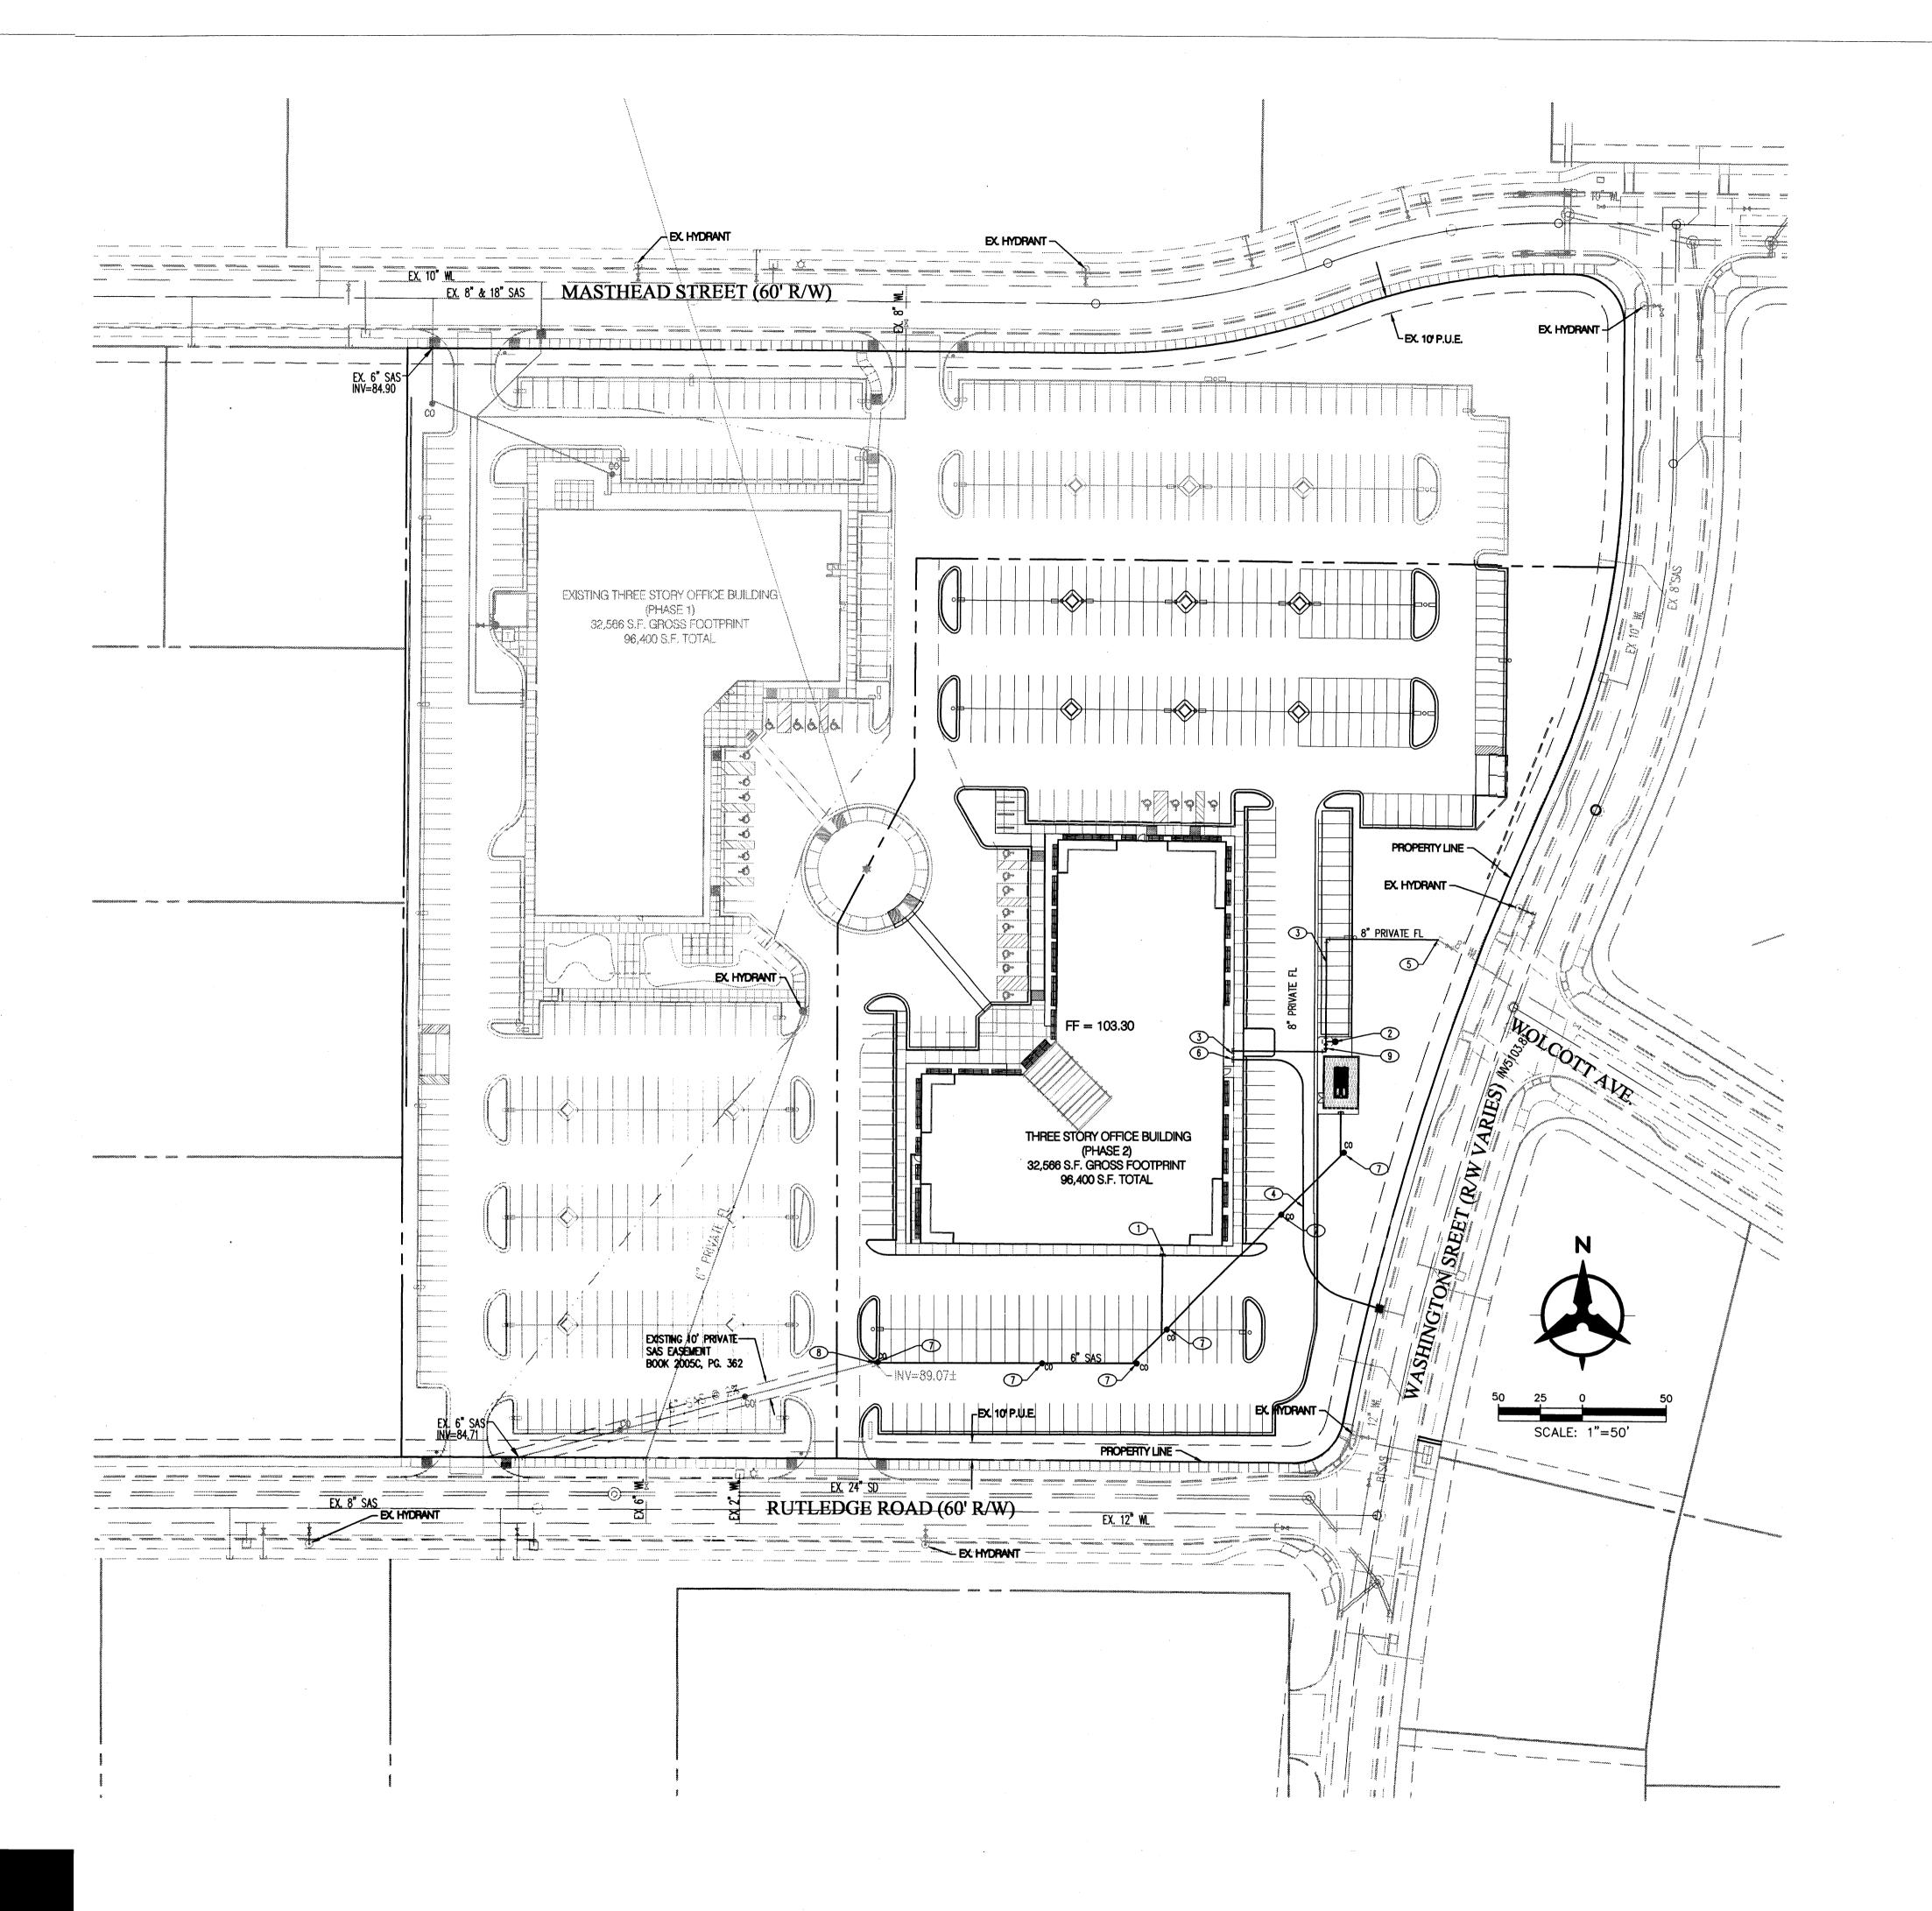ALBUQUERQUE SITE DEV

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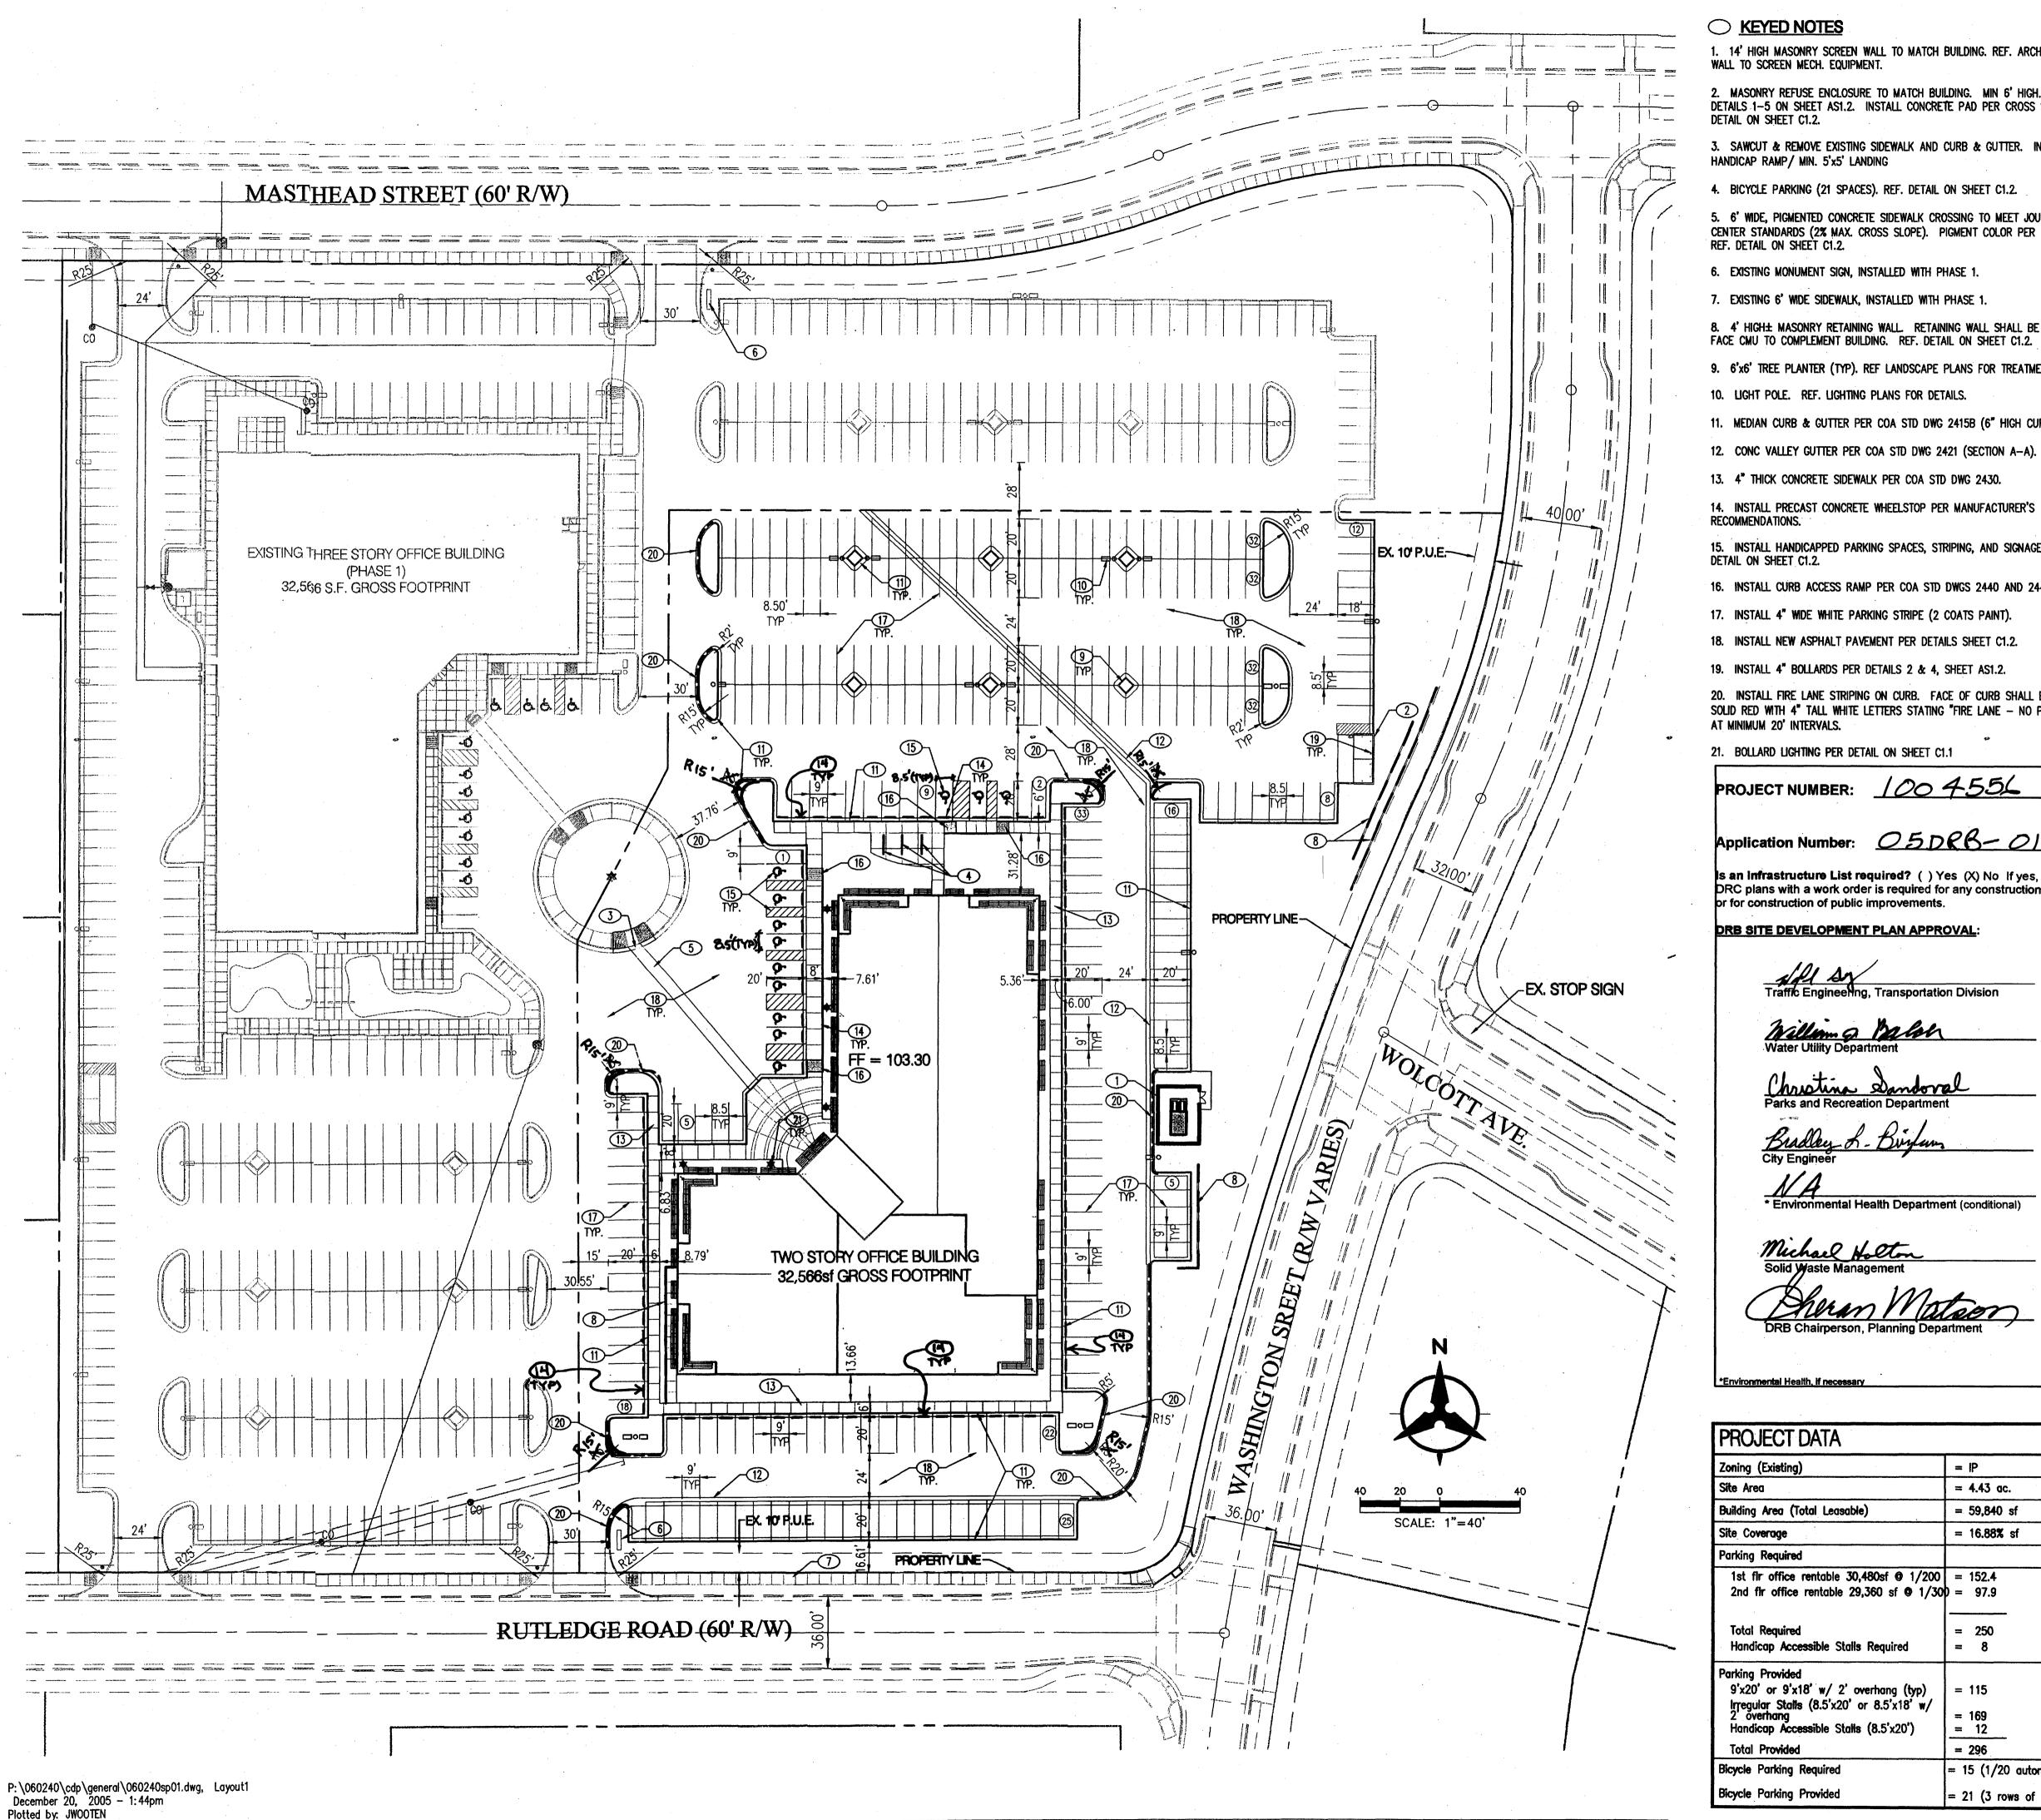
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ENGINEERING & SPATIAL DATA & ADVANCED TECHNOLOGIES



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○ KEYED NOTES

1. 14' HIGH MASONRY SCREEN WALL TO MATCH BUILDING. REF. ARCH. DETAILS. WALL TO SCREEN MECH. EQUIPMENT.

2. MASONRY REFUSE ENCLOSURE TO MATCH BUILDING. MIN 6' HIGH. SEE DETAILS 1-5 ON SHEET AS1.2. INSTALL CONCRETE PAD PER CROSS SECTION DETAIL ON SHEET C1.2.

3. SAWCUT & REMOVE EXISTING SIDEWALK AND CURB & GUTTER. INSTALL HANDICAP RAMP/ MIN. 5'x5' LANDING

4. BICYCLE PARKING (21 SPACES). REF. DETAIL ON SHEET C1.2.

5. 6' WIDE, PIGMENTED CONCRETE SIDEWALK CROSSING TO MEET JOURNAL CENTER STANDARDS (2% MAX. CROSS SLOPE). PIGMENT COLOR PER ARCHITECT. REF. DETAIL ON SHEET C1.2.

6. EXISTING MONUMENT SIGN, INSTALLED WITH PHASE 1.

7. EXISTING 6' WIDE SIDEWALK, INSTALLED WITH PHASE 1.

8. 4' HIGH± MASONRY RETAINING WALL. RETAINING WALL SHALL BE SPLIT FACE CMU TO COMPLEMENT BUILDING. REF. DETAIL ON SHEET C1.2.

9. 6'x6' TREE PLANTER (TYP). REF LANDSCAPE PLANS FOR TREATMENT.

10. LIGHT POLE. REF. LIGHTING PLANS FOR DETAILS.

11. MEDIAN CURB & GUTTER PER COA STD DWG 2415B (6" HIGH CURB).

12. CONC VALLEY GUTTER PER COA STD DWG 2421 (SECTION A-A).

15. INSTALL HANDICAPPED PARKING SPACES, STRIPING, AND SIGNAGE PER

16. INSTALL CURB ACCESS RAMP PER COA STD DWGS 2440 AND 2441.

18. INSTALL NEW ASPHALT PAVEMENT PER DETAILS SHEET C1.2.

20. INSTALL FIRE LANE STRIPING ON CURB. FACE OF CURB SHALL BE PAINTED SOLID RED WITH 4" TALL WHITE LETTERS STATING "FIRE LANE - NO PARKING" AT MINIMUM 20' INTERVALS.

21. BOLLARD LIGHTING PER DETAIL ON SHEET C1.1


PROJECT NUMBER: 100 455L Application Number: 05DRB-01781 s an Infrastructure List required? () Yes (X) No If yes, then a set of approved DRC plans with a work order is required for any construction within Public Right-of-Way

DRB SITE DEVELOPMENT PLAN APPROVAL:

3-10-06 12/21/05 Date Date 12/21/05 Environmental Health Department (conditional) 12/21/05 Date

Michael Holton

PROJECT DATA	
Zoning (Existing)	= IP
Site Area	= 4.43 ac.
Building Area (Total Leasable)	= 59,840 sf
Site Coverage	= 16.88% sf
Parking Required	
1st fir office rentable 30,480sf @ 1/200 2nd fir office rentable 29,360 sf @ 1/30	•
Total Required Handicap Accessible Stalls Required	= 250 = 8
Parking Provided 9'x20' or 9'x18' w/ 2' overhang (typ) Irregular Stalls (8.5'x20' or 8.5'x18' w/ 2' overhang Handicap Accessible Stalls (8.5'x20') Total Provided	= 115 = 169 = 12 = 296
Bicycle Parking Required	= 15 (1/20 automobile spaces)
Bicycle Parking Provided	= 21 (3 rows of 7 each)

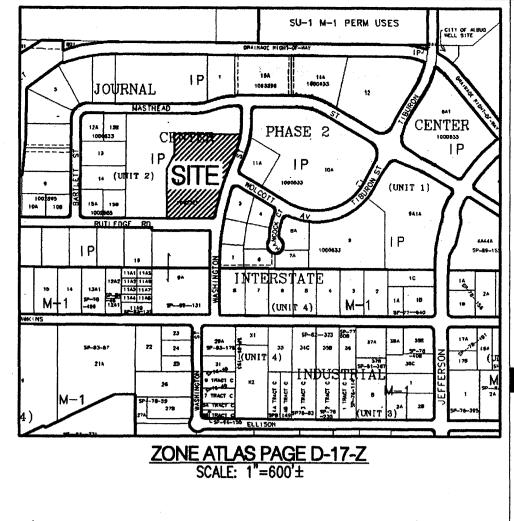

LEGAL DESCRIPTION
TRACT 11-B OF JOURNAL CENTER UNIT 2, PHASE 2 ALBUQUERQUE, NM, NOVEMBER, 2005

GENERAL NOTES

1. SCREEN WALLS AND REFUSE ENCLOSURE SHALL BE INTEGRAL TO BUILDING

2. UTILITY BOXES SHALL BE SCREENED WITH MATURE LANDSCAPING.

3. SITE LIGHTING SHALL BE HORIZONTAL CUT — OFF TYPE AND MAXIMUM 24' HIGH ABOVE GRADE. POLES AND FIXTURES SHALL BE PER JOURNAL CENTER

4. ALL ROOF MOUNTED MECHANICAL EQUIPMENT SHALL BE SCREENED.

5. AT THE TIME COMMON AREA IRRIGATION IS CONNECTED TO JOURNAL CENTER 2 COMMON AREA IRRIGATION SYSTEM, THE DEVELOPER "TIBURON INVESTMENT, LLC" MUST BE CONTACTED.

DRAWING INDEX
C1.0 - SITE PLAN
C1.1 - SITE DETAILS

L1.0 - LANDSCAPE PLAN C2.0 - PRELIMINARY GRADING PLAN A2.1 - BUILDING & STRUCTURE ELEVATIONS

A2.2 - BUILDING & STRUCTURE ELEVATIONS AS1.1 — REFUSE ENCLUSURE AND MONUMENTAL SIGN DETAILS C3.0 — CONCEPTUAL UTILITY PLAN

Bohannan A Huston #

Courtyard I 7500 Jefferson St. NE Albuquerque, NM 87109-4335 ENGINEERING . SPATIAL DATA . ADVANCED TECHNOLOGIES

1306 RIO GRANDE BLVD NW ALBUQUERQUE, NM 87104 505-255-6400 505-268-6954 FAX WWW.NCA-ARCHITECTS.COM

ARCHITECT

CONSULTANT

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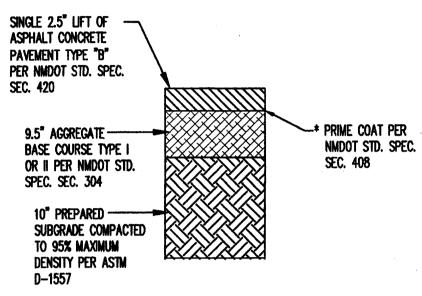
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REFUSE ENCLOSURE CONCRETE PAVEMENT

SINGLE 2.5" LIFT OF -ASPHALT CONCRETE PAVEMENT TYPE "B" PER NMDOT STD. SPEC. SEC. 420 6.5" AGGREGATE -----+ PRIME COAT PER NMDOT STD. SPEC. BASE COURSE TYPE I SEC. 408 OR II PER NMDOT STD. SPEC. SEC. 304 SUBGRADE COMPACTED TO 95% MAXIMUM DENSITY PER ASTM D-1557 * PRIME COAT IS INCIDENTAL TO ASPHALT

CONCRETE PAVEMENT * REFERENCE GEOTECHNICAL REPORT FOR ADDITIONAL INFORMATION.


LIGHT DUTY ASPHALT PAVEMENT SECTION



* PRIME COAT IS INCIDENTAL TO ASPHALT

CONCRETE PAVEMENT * REFERENCE GEOTECHNICAL REPORT FOR ADDITIONAL INFORMATION.

HEAVY DUTY ASPHALT PAVEMENT SECTION N.T.S.

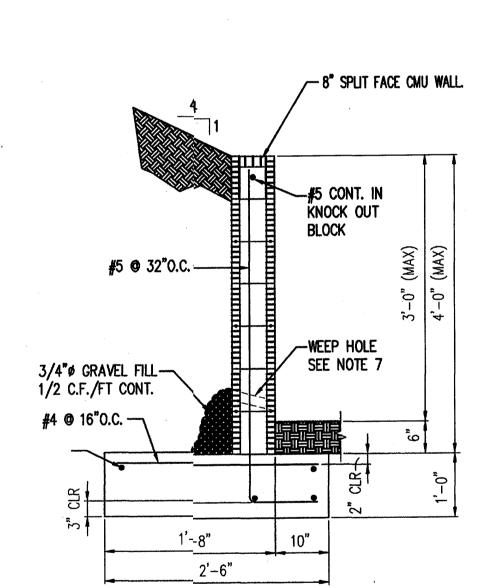


- RETAINING WALL SHALL NOT BE BACK-FILLED UNTIL AT LEAST 7 DAYS AFTER CASTING THE WALL.
- VERTICAL CONTROL JOINTS IN THE WALL SHALL BE PLACED AT 8'-0" O.C. MAX.
- CONSTRUCTION OF RETAINING WALLS SHALL CONFORM TO REQUIREMENTS OF THE 1997 UNIFORM BUILDING CODE.

EFP (ACTIVE) = 36 PCFSOIL BEARING PRESSURE = 1500 PCF (1/3 INCREASE FOR WIND/SEISMIC) COEFFICIENT OF FRICTION = 0.35EFP (PASSIVE) = 300 PCFCONCRETE F' C (28 DAYS) = 3000 PSI REINFORCEMENT = 60 ASTM A-615


CONTRACTOR SHALL NOTIFY OWNER PRIOR TO CONCRETE FOOTING POUR FOR INSPECTION OF COMPACTION UNDER FOOTING, FOOTING DEPTH AND WIDTH AND WALL STEEL AND SPACING. FINAL INSPECTION OF FOOTING AND WALL WILL BE REQUIRED.

- THE CONTRACTOR SHALL BE RESPONSIBLE TO SEE THAT ALL REBAR IS PROPERLY ALIGNED AND TIED IN PLACE BEFORE PLACING CONCRETE. ALL STEEL SHALL BE ACCURATELY LOCATED AND SECURED IN PLACE SO THAT IT REMAINS IN POSITION DURING (THE PLACEMENT OF THE CONCRETE. ANY REBAR IMPROPERLY INSTALLED SHALL BE REMOVED AT NO ADDITIONAL COST TO THE OWNER.
- WEEP HOLES: PLACE A 2" DIA. WEEP HOLE @ 5'-0" O.C. W/ 1/2 CUBIC FOOT/FOOT OF 3/4" GRAVEL IN FILTER FABRIC
- THE FIRST COURSE OF CMU BLOCK MAY BE PLACED IN FRESH FOOTING CONCRETE. SUBSEQUENT COURSES OF CMU BLOCK SHALL NOT BE PLACED UNTIL 7 DAYS AFTER THE FOOTING IS CAST.
- 9. ALL CMU BLOCK JOINTS SHALL BE TOOLED.
- 10. BACK FILL AND COMPACTION OF RETAINING WALL IS INCIDENTAL TO INSTALLATION OF RETAINING WALL.


SPLIT FACE CMU RETAINING WALL NOT TO SCALE

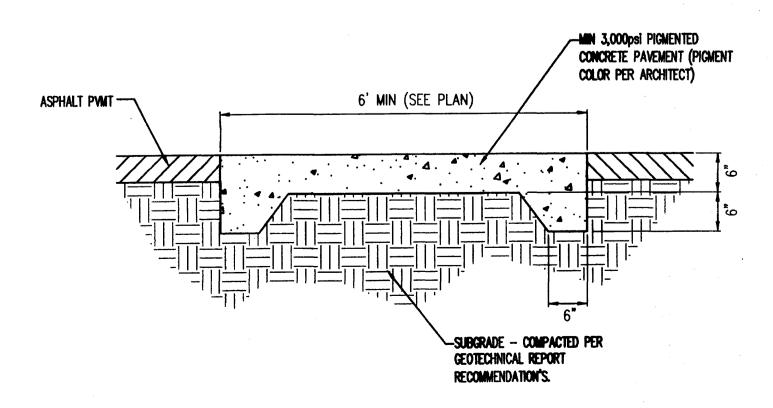


SIDEWALK CROSSING DETAIL

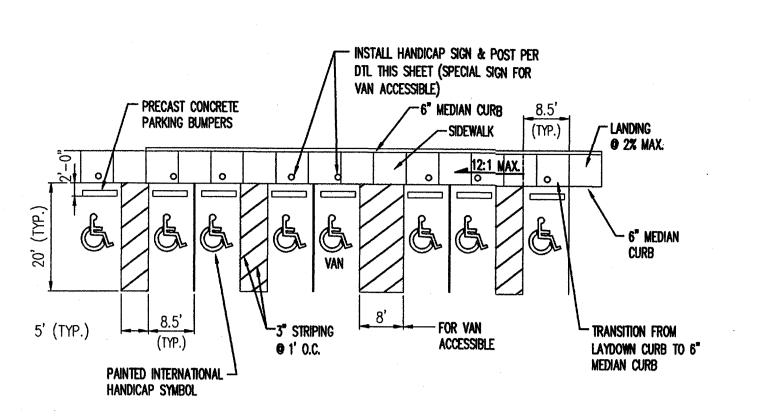


HANDICAP PARKING DETAIL

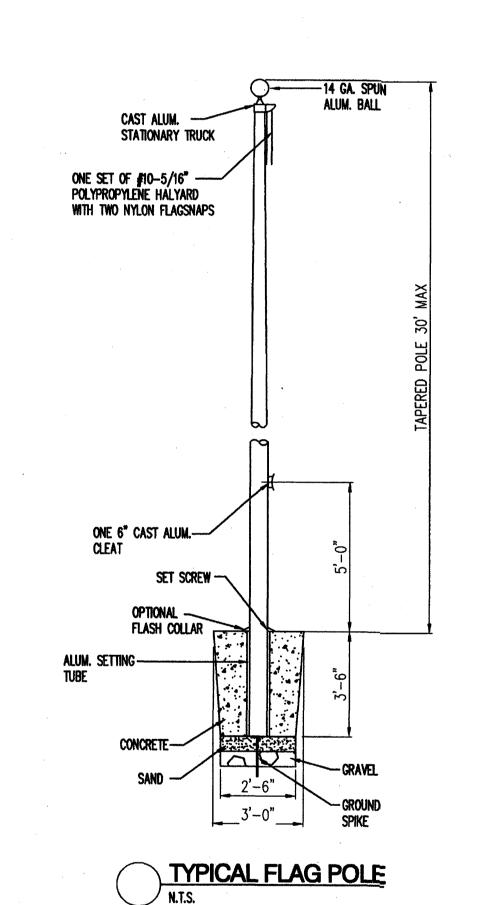

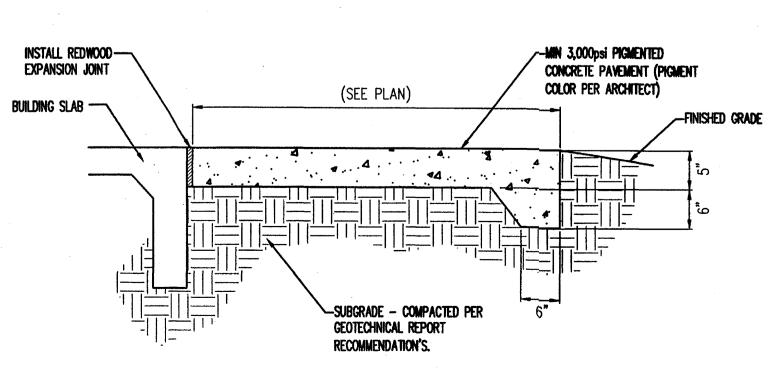


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NOT TO SCALE

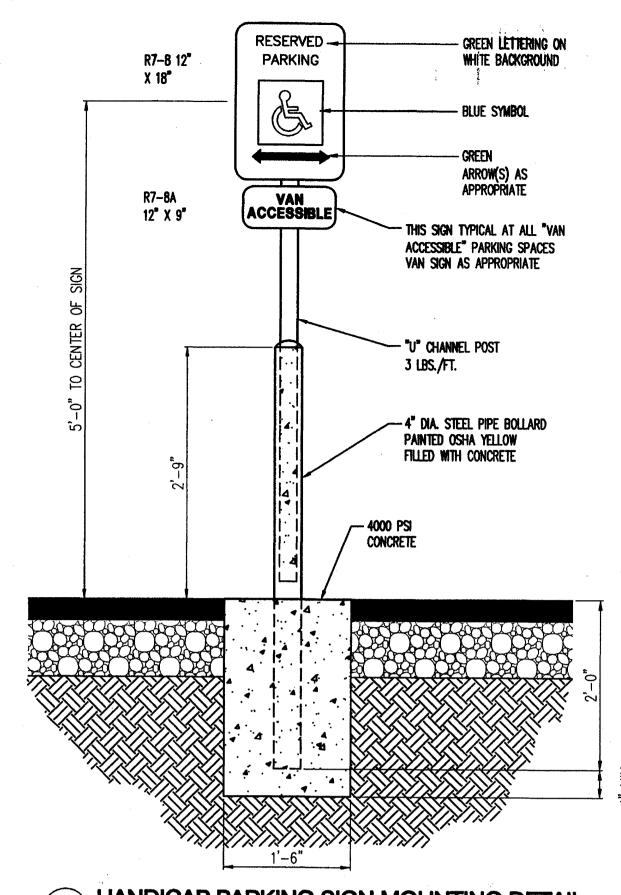

HANDICAP PARKING SIGN MOUNTING DETAIL

ONE SIGN SHALL BE INSTALLED AT EACH HANDICAP SPACE.

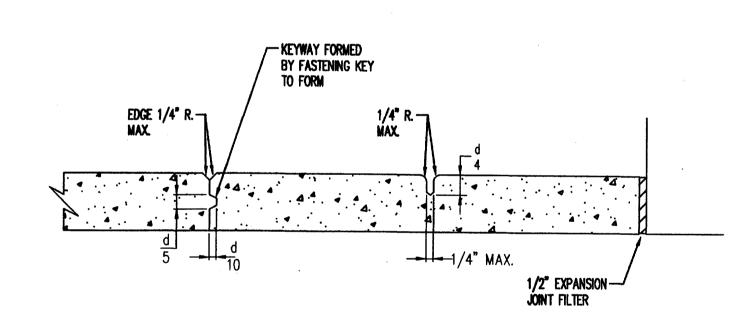


DETAIL A CONSTRUCTION JOINT 12'-0" SPACING (TYP.)

DETAIL B CONSTRUCTION FORMED JOINT 12'-0" Spacing (Typ.)

DETAIL C USE ONLY AT BUILDINGS OR OBJECTS ABUTTING THE PAVED AREA

CONCRETE PAVEMENT JOINT DETAILS

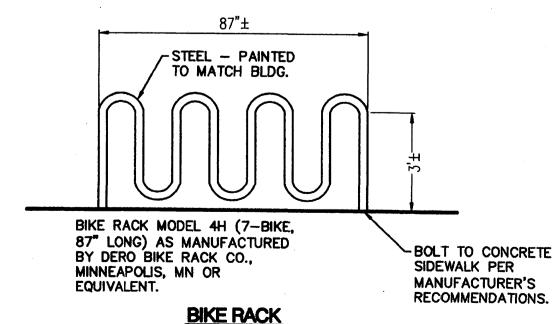

BIKE RACK NOT TO SCALE

Courtyard i 7500 Jefferson St. NE Albuquerque, NM 87109-4335 ENGINEERING . SPATIAL DATA . ADVANCED TECHNOLOGIES

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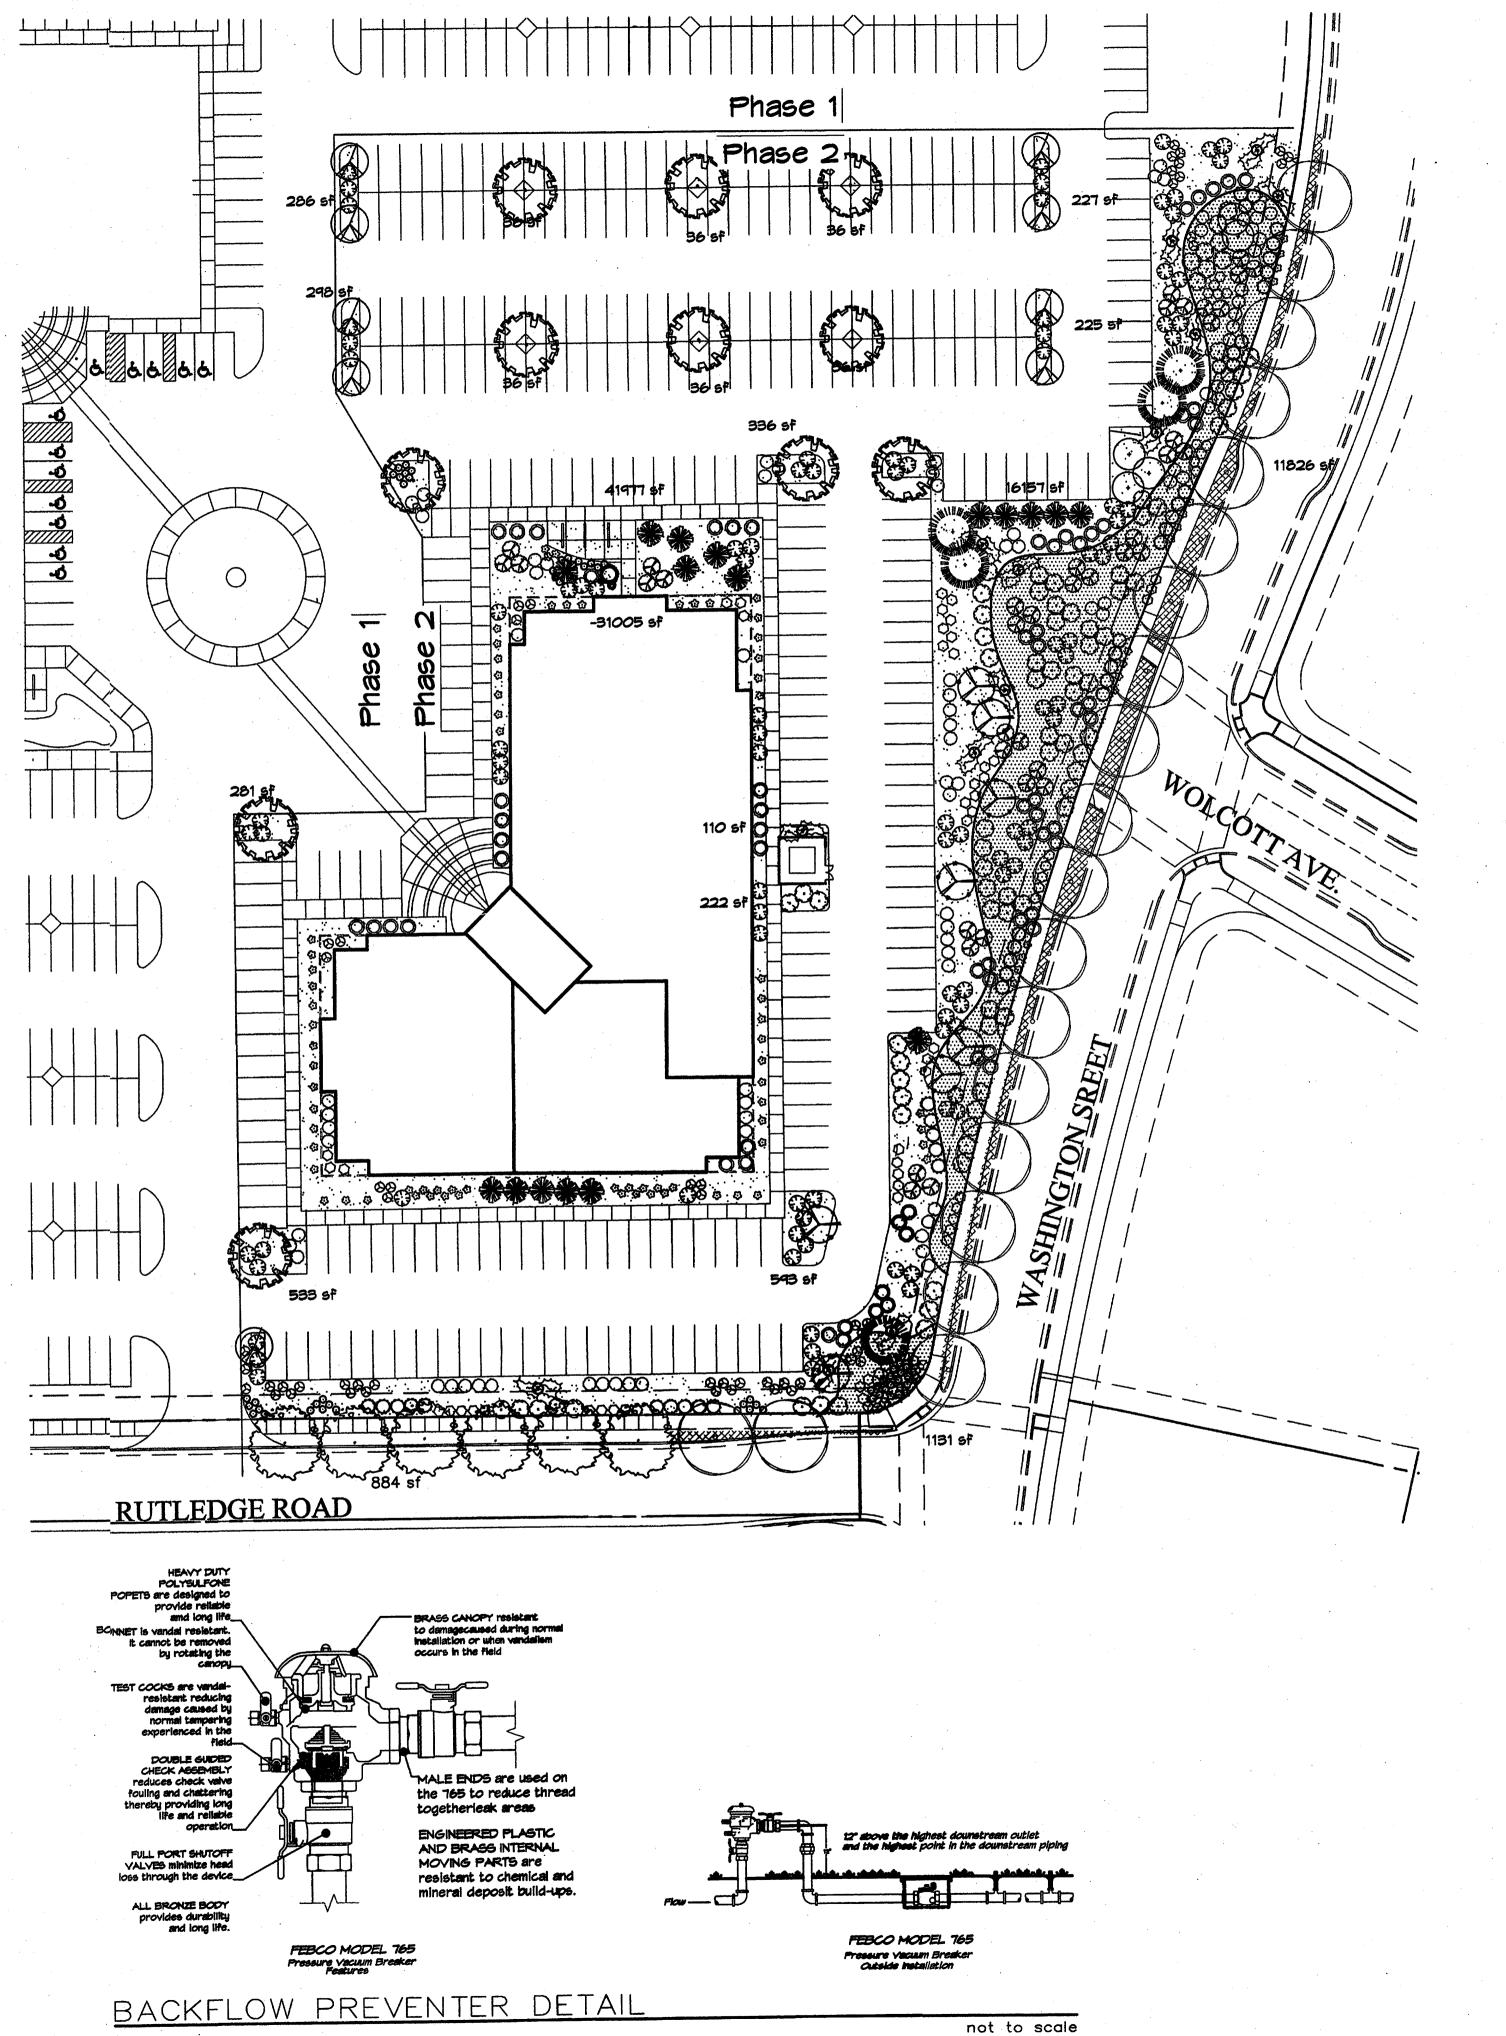
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PLANT LEGEND

SOTOL 17 Dasylirion wheeleri 5 Gai. 36sf

Landscape maintenance shall be the

responsibility of the Property Owner.

It is the intent of this plan to comply with the City Of Albuquerque Water Conservation Landscaping and Water Waste Ordinance

planting restriction approach. Approval of this

Water management is the sole responsibility of the Property Owner. All landscaping will be in

Ordinance, and Water Conservation Landscaping and Water Waste Ordinance. In general, water conservative, environmentally sound landscape

Plant beds shall achieve 75% live ground cover

Santa Ana Tan Gravel over Filter Fabric shall be placed in all landscape areas which are not

conformance with the City of Albuquerque

Zoning Code, Street Tree Ordinance, Pollen

principles will be followed in design and

designated to receive native seed.

plan does not constitute or imply exemption

from water waste provisions of the Water Conservation Landscaping and Water Waste

LANDSCAPE NOTES:

Ordinance.

at maturity.

POWIS CASTLE SAGE (L) 39 MUGO PINE (M) BERINDA ASH Artimesia x powis castle 5 Gal. 25sf O Pinus mugo 5 Gal. 36sf BERINDA ASH (H) 6 Fraxinus SPP. 2" Cal. WINTER JASMINE (L+) 99 CURLLEAF MTN MAHOGANY (L) 83 Carcorpus ledfolius 5 Gal. 100SF Jasminum nudiflorum 5 Gal. 144sf (PER THE JOURNAL CENTER REQUIREMENTS FOR STREET TREE MILDFLOMER 59 THREE-LEAF SUMAC (L) 43 Rhus trilobata 5 Gal. 36sf PARKSTRIP) 1 Gal. 4sf CHINESE PISTACHE (M) 11 Pistachia chinensis GREYLEAF COTONEASTER 39 Cotoneaster buxifolius APACHE PLUME (L) 83 Fallugia paradoxa 5 Gal. 42sf 5 Gal. 81sf OAK (M) 8 Quercus spp. 2" Cal. NATURAL EDGE THREADGRASS (M) 91 Stipa tennuisima 1 Gal. 4sf SANTA ANA TAN GRAVEL WITH FILTER FABRIC GREY CRUSHERFINES WITH FILTER FABRIC AUTUMN SAGE (M) 71 O Salvia greggii OVERSIZED GRAVEL 5 Gal. 99f MITH FILTER FABRIC LAVENDER (M) 49 EXISTING LANDSCAPING Lavandula angustifolia BOULDERS (6) 1 Gal. 95f THORNLESS HAWTHORN (M+) 5 Crataegus crus-gaili inermis 15 Gal. 225sf ARP ROSEMARY (M) 66 Rosmarinus officianalis

IRRIGATION NOTES:
Irrigation shall be a complete underground system with Trees to receive (5) 1.0 GPH Drip Emitters and Shrubs to receive (2) 1.0 GPH Drip Emitters. Drip and Bubbler systems to be tied to 1/2" polypipe with flush caps at each end.

5 Gal. 36sf

Run time per each drip valve will be approximately 15 minutes per day, to be adjusted according to the season.

Point of connection for irrigation system is unknown at current time and will be coordinated in the field. Irrigation will be operated by automatic controller.

Location of controller to be field determined and power source for controller to be provided by others.

Irrigation maintenance shall be the responsibility of the Property Owner.

Water and Power source shall be the responsibility of the Developer/Builder.

LANDSCAPE CALCULATIONS

TOTAL LOT AREA	181507	square feet
TOTAL BUILDINGS AREA	43401	square feet
OFFSITE AREA	884	square feet
NET LOT AREA	137222	square feet
LANDSCAPE REQUIREMENT	15%	
TOTAL LANDSCAPE REQUIREMENT	20583	square feet
TOTAL BED PROVIDED	44297	square feet
GROUNDCOVER REQ.	75%	square fee
TOTAL GROUNDCOVER REQUIREMEN	IT 33223	square fee
TOTAL GROUNDCOVER PROVIDED	34394 (77%)	square fee
TOTAL SOD AREA		square fee
(max. 20% of landscape required)		
TOTAL NATIVE SEED AREA		square fee
TOTAL LANDSCAPE PROVIDED	44297 (32%)	square fee



Cont. Lic. #26458
7909 Edith N.E.
Albuquerque, NM 87184
Ph. (505) 898—9690
Fax (505) 898—7737
cjohnson@hilltoplandscaping.com
All creative ideas contained Herein remains the property of The Hilliop Landscape Architects and Contractors and are protected by copyright laws. This is

property of The Hilliop Landscape Architectontractors and are protected by copyright law an original design and must not be released or unless applicable fees have been paid or job placed.

SCALE: 1"=40'

GRAPHIC SCALE
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DRR 11/22/05 REVISED SITE PLAN
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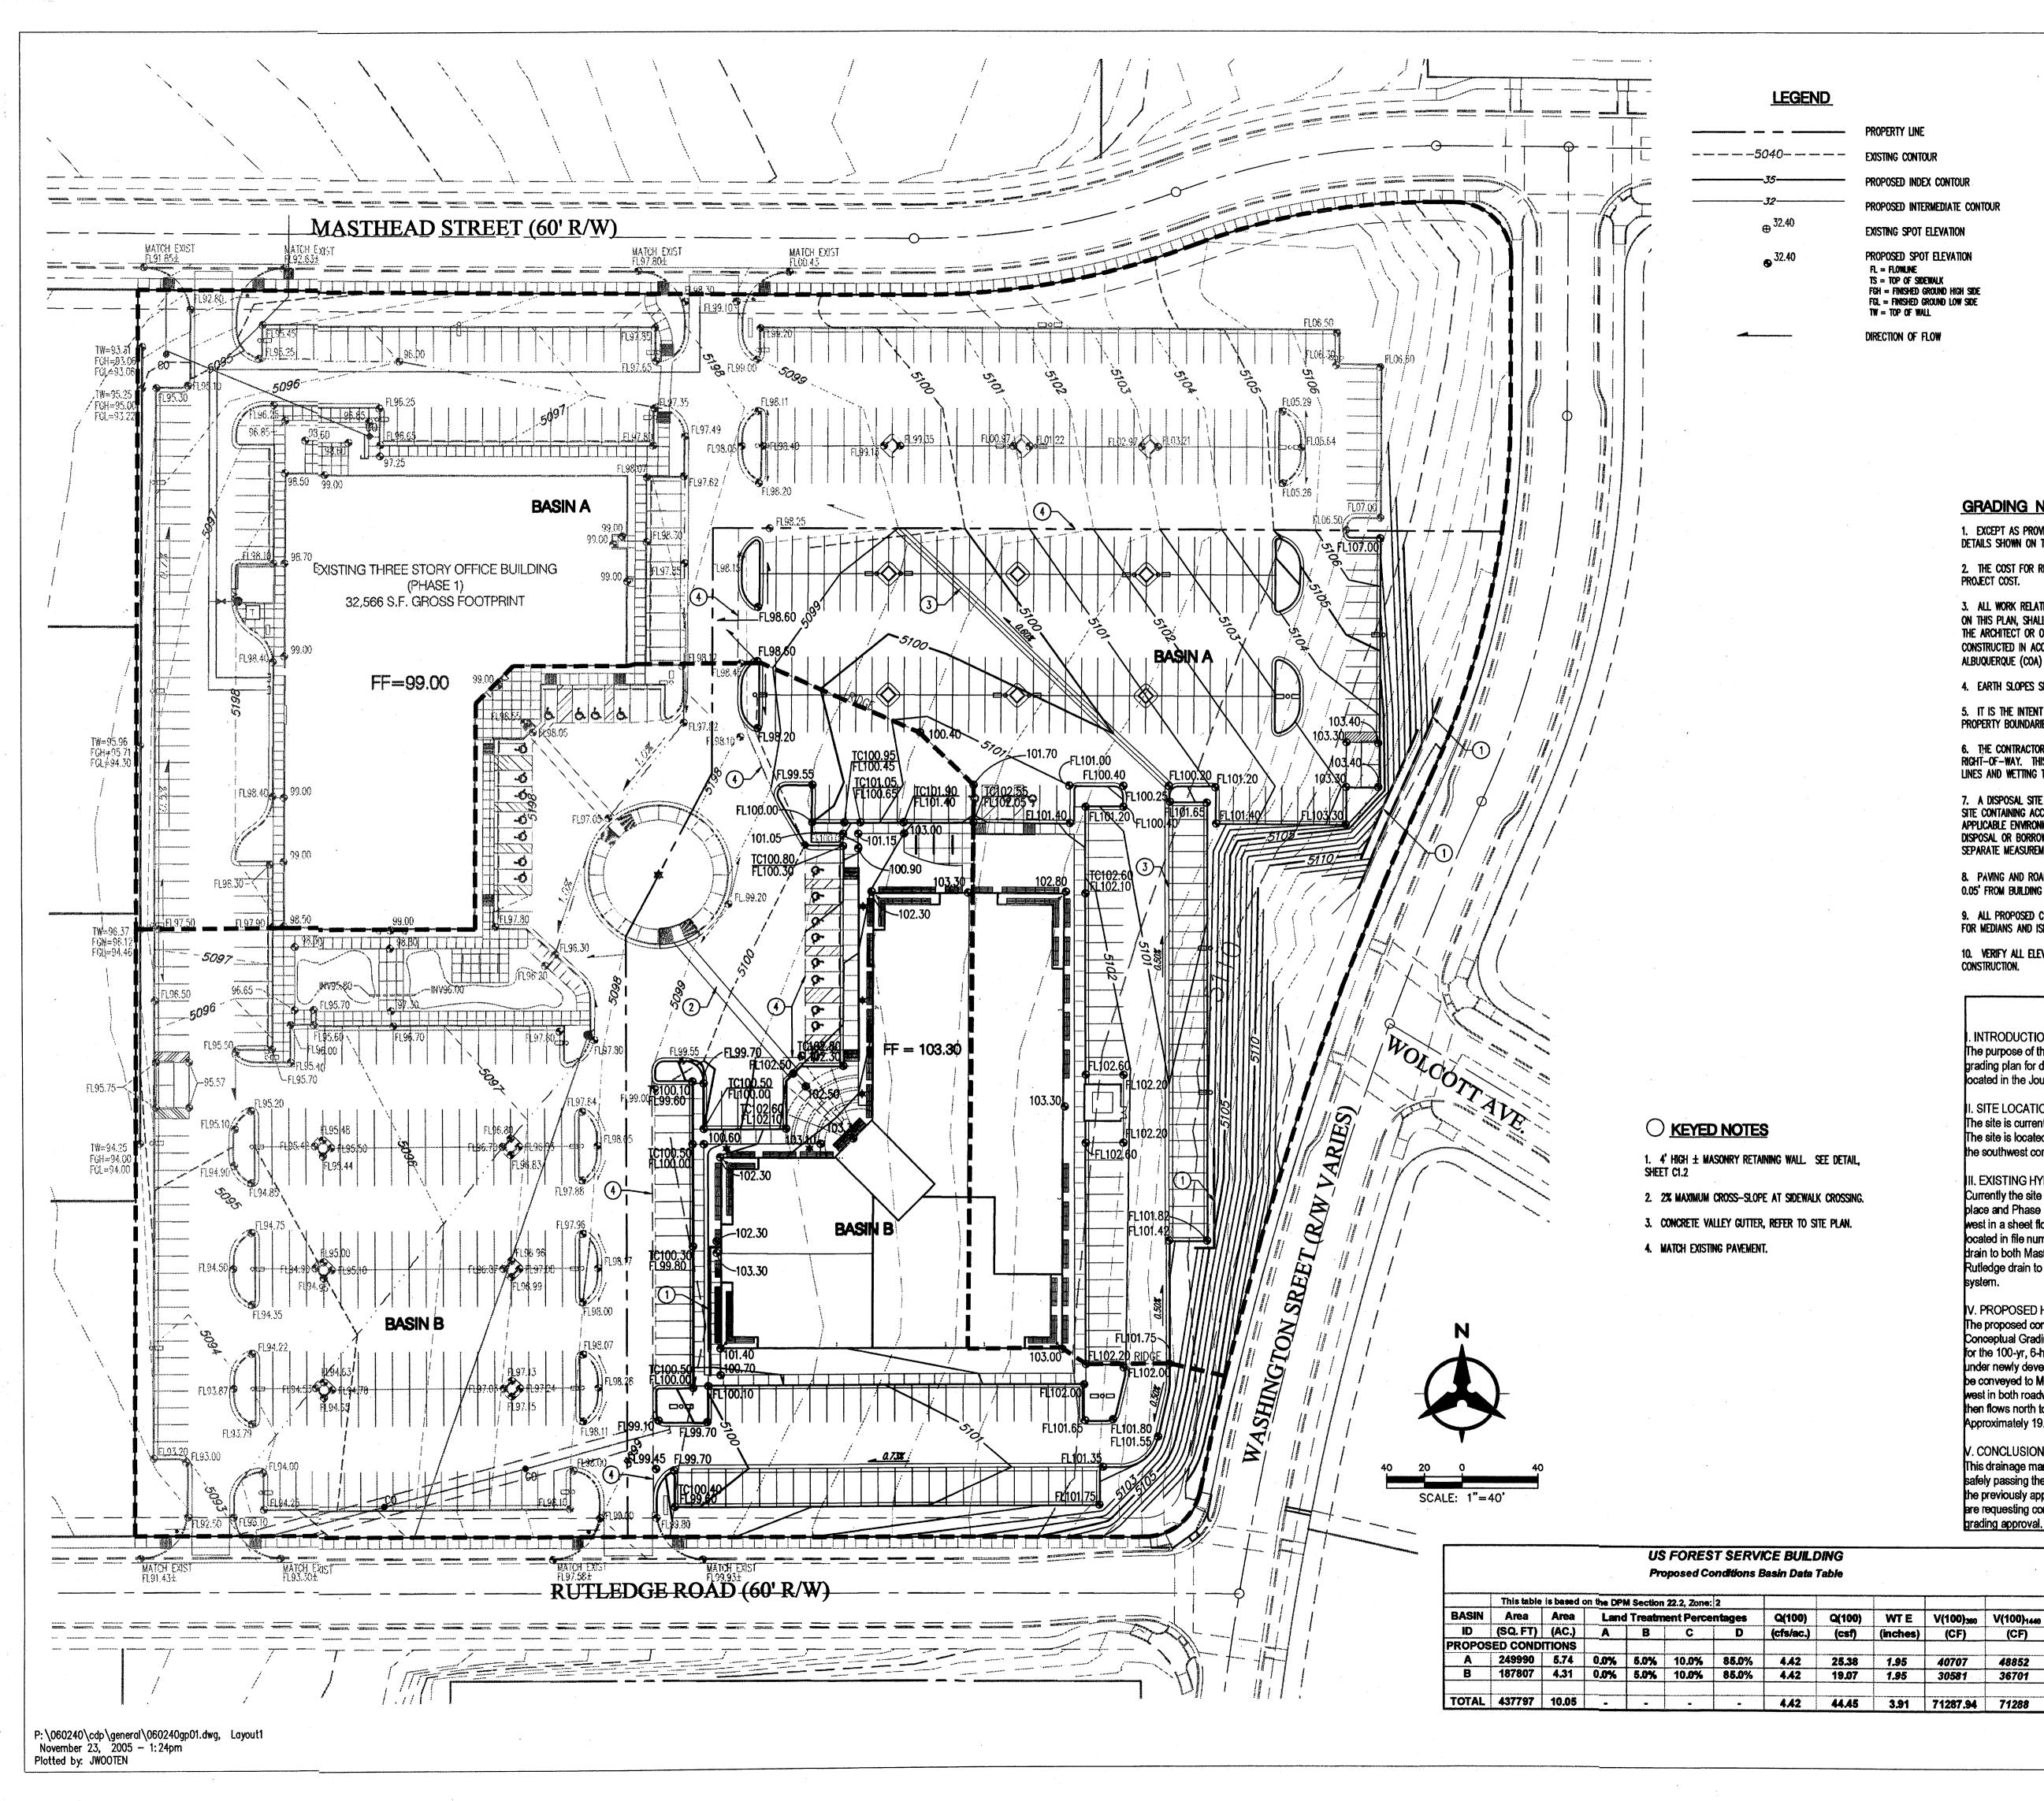
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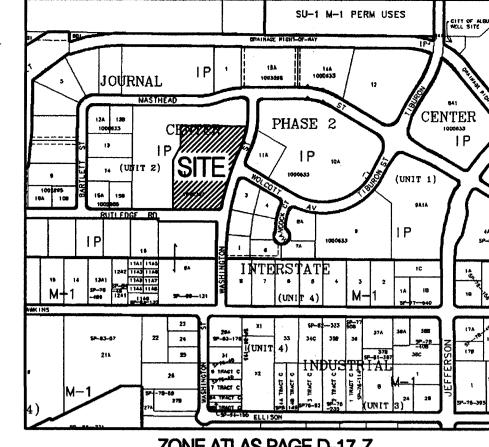
LEGEND

PROPOSED INTERMEDIATE CONTOUR

EXISTING SPOT ELEVATION PROPOSED SPOT ELEVATION FL = FLOWLINE ts = top of sidewalk FGH = FINISHED GROUND HIGH SIDE FGL = FINISHED GROUND LOW SIDE

DIRECTION OF FLOW

TW = TOP OF WALL



LEGAL DESCRIPTION TRACT 11-B OF JOURNAL CENTER UNIT 2, PHASE 2 ALBUQUERQUE, NM, NOVEMBER, 2005

GRADING NOTES

- 1. EXCEPT AS PROVIDED HEREIN, GRADING SHALL BE PERFORMED AT THE ELEVATIONS AND IN ACCORDANCE WITH THE DETAILS SHOWN ON THIS PLAN.
- 2. THE COST FOR REQUIRED CONSTRUCTION DUST AND EROSION CONTROL MEASURES SHALL BE INCIDENTAL TO THE
- 3. ALL WORK RELATIVE TO FOUNDATION CONSTRUCTION, SITE PREPARATION, AND PAVEMENT INSTALLATION, AS SHOWN ON THIS PLAN, SHALL BE CONSTRUCTED IN ACCORDANCE WITH THE "GEOTECHNICAL INVESTIGATION," AS PROVIDED BY THE ARCHITECT OR OWNER. ALL OTHER WORK SHALL, UNLESS OTHERWISE STATED OR PROVIDED FOR HEREON, BE CONSTRUCTED IN ACCORDANCE WITH THE PROJECT, (FIRST PRIORITY) SPECIFICATIONS, AND/OR THE CITY OF ALBUQUERQUE (COA) STANDARD SPECIFICATIONS FOR PUBLIC WORKS (SECOND PRIORITY).
- 4. EARTH SLOPES SHALL NOT EXCEED 3 HORIZONTAL TO 1 VERTICAL UNLESS SHOWN OTHERWISE.
- 5. IT IS THE INTENT OF THESE PLANS THAT THIS CONTRACTOR SHALL NOT PERFORM ANY WORK OUTSIDE OF THE PROPERTY BOUNDARIES EXCEPT AS REQUIRED BY THIS PLAN.
- 6. THE CONTRACTOR IS TO ENSURE THAT NO SOIL ERODES FROM THE SITE ONTO ADJACENT PROPERTY OR PUBLIC RIGHT-OF-WAY. THIS SHOULD BE ACHIEVED BY CONSTRUCTING TEMPORARY BERMS OR SILT FENCE AT THE PROPERTY LINES AND WETTING THE SOIL TO PROTECT IT FROM WIND EROSION.
- 7. A DISPOSAL SITE FOR ANY & ALL EXCESS EXCAVATION MATERIAL, AND UNSUITABLE MATERIAL AND/OR A BORROW SITE CONTAINING ACCEPTABLE FILL MATERIAL SHALL BE OBTAINED BY THE CONTRACTOR IN COMPLIANCE WITH APPLICABLE ENVIRONMENTAL REGULATIONS AND APPROVED BY THE OBSERVER. ALL COSTS INCURRED IN OBTAINING A DISPOSAL OR BORROW SITE AND HAUL TO OR FROM SHALL BE CONSIDERED INCIDENTAL TO THE PROJECT AND NO SEPARATE MEASUREMENT OR PAYMENT SHALL BE MADE.
- 8. PAVING AND ROADWAY GRADES SHALL BE +/- 0.1' FROM PLAN ELEVATIONS. PAD ELEVATION SHALL BE +/-0.05' FROM BUILDING PLAN ELEVATION.
- 9. ALL PROPOSED CONTOURS REFLECT TOP OF PAVEMENT ELEVATIONS IN THE PARKING AREA AND MUST BE ADJUSTED FOR MEDIANS AND ISLANDS.
- 10. VERIFY ALL ELEVATIONS SHOWN ON PLAN FROM BASIS OF ELEVATION CONTROL STATION PRIOR TO BEGINNING

DRAINAGE MANAGEMENT PLAN

INTRODUCTION

The purpose of this submittal is to provide a conceptual Drainage Management Plan and rough grading plan for development of the Masthead Office Complex at Journal Center 2 - Phase 2, ocated in the Journal Center, Phase 2, Unit 2, Lot 11-B in NE Albuquerque.

I. SITE LOCATION

The site is currently legally described as, Journal Center, Phase 2, Unit 2, Lot 11-B (+/- 4.4 acres). The site is located within zone atlas map #M-21, and is in hydrologic zone 2. The site is located at the southwest corner of Masthead and Washington, just west of Jefferson.

II. EXISTING HYDROLOGIC CONDITIONS

Currently the site (4.4 ac.) is undeveloped land. The surrounding streets and infrastructure are in place and Phase 1 of the development is currently under construction. The site drains from east to west in a sheet flow condition. Per the approved Drainage Plan of Journal Center – Phase 2 ocated in file number D17/D3AA, this site has been approved as a fully developed site and can drain to both Masthead and Rutledge via. surface flow out of the driveways. Both Masthead and Rutledge drain to the west of the site where the drainage is collected in an underground drainage

V. PROPOSED HYDROLOGIC CONDITIONS

The proposed conditions for the Masthead Office Complex at Journal Center 2 are shown on this Conceptual Grading Plan. The hydrologic analysis for this area is based on drainage requirements for the 100-yr, 6-hr storm event. The total site (+/- 10.0 acres) will generate a total of 44.45 cfs under newly developed conditions and consists of approximately 85% D land treatment. Flows will be conveyed to Masthead and Rutledge by surface and curb and gutters. This split flow will travel west in both roadways to a common existing underground drainage system. This drainage system then flows north to the North Pino Arroyo, and then to the AMAFCA North Diversion Channel. Approximately 19.07 cfs drains to Rutledge; the other 25.38 cfs drains to Masthead.

/. CONCLUSION

This drainage management plan provides for grading and drainage elements which are capable of safely passing the 100 year storm and which meet city requirements and are in conformance with the previously approved master drainage plan for Journal Center, Phase 2. With this submittal we are requesting conceptual grading and drainage plan approval for building permit and rough grading approval.

Bohannan A Huston

Courtyard I 7500 Jefferson St. NE Albuquerque, NM 87109-4335 ENGINEERING . SPATIAL DATA . ADVANCED TECHNOLOGIES

1306 RIO GRANDE BLVD NW **ALBUQUERQUE, NM 87104**

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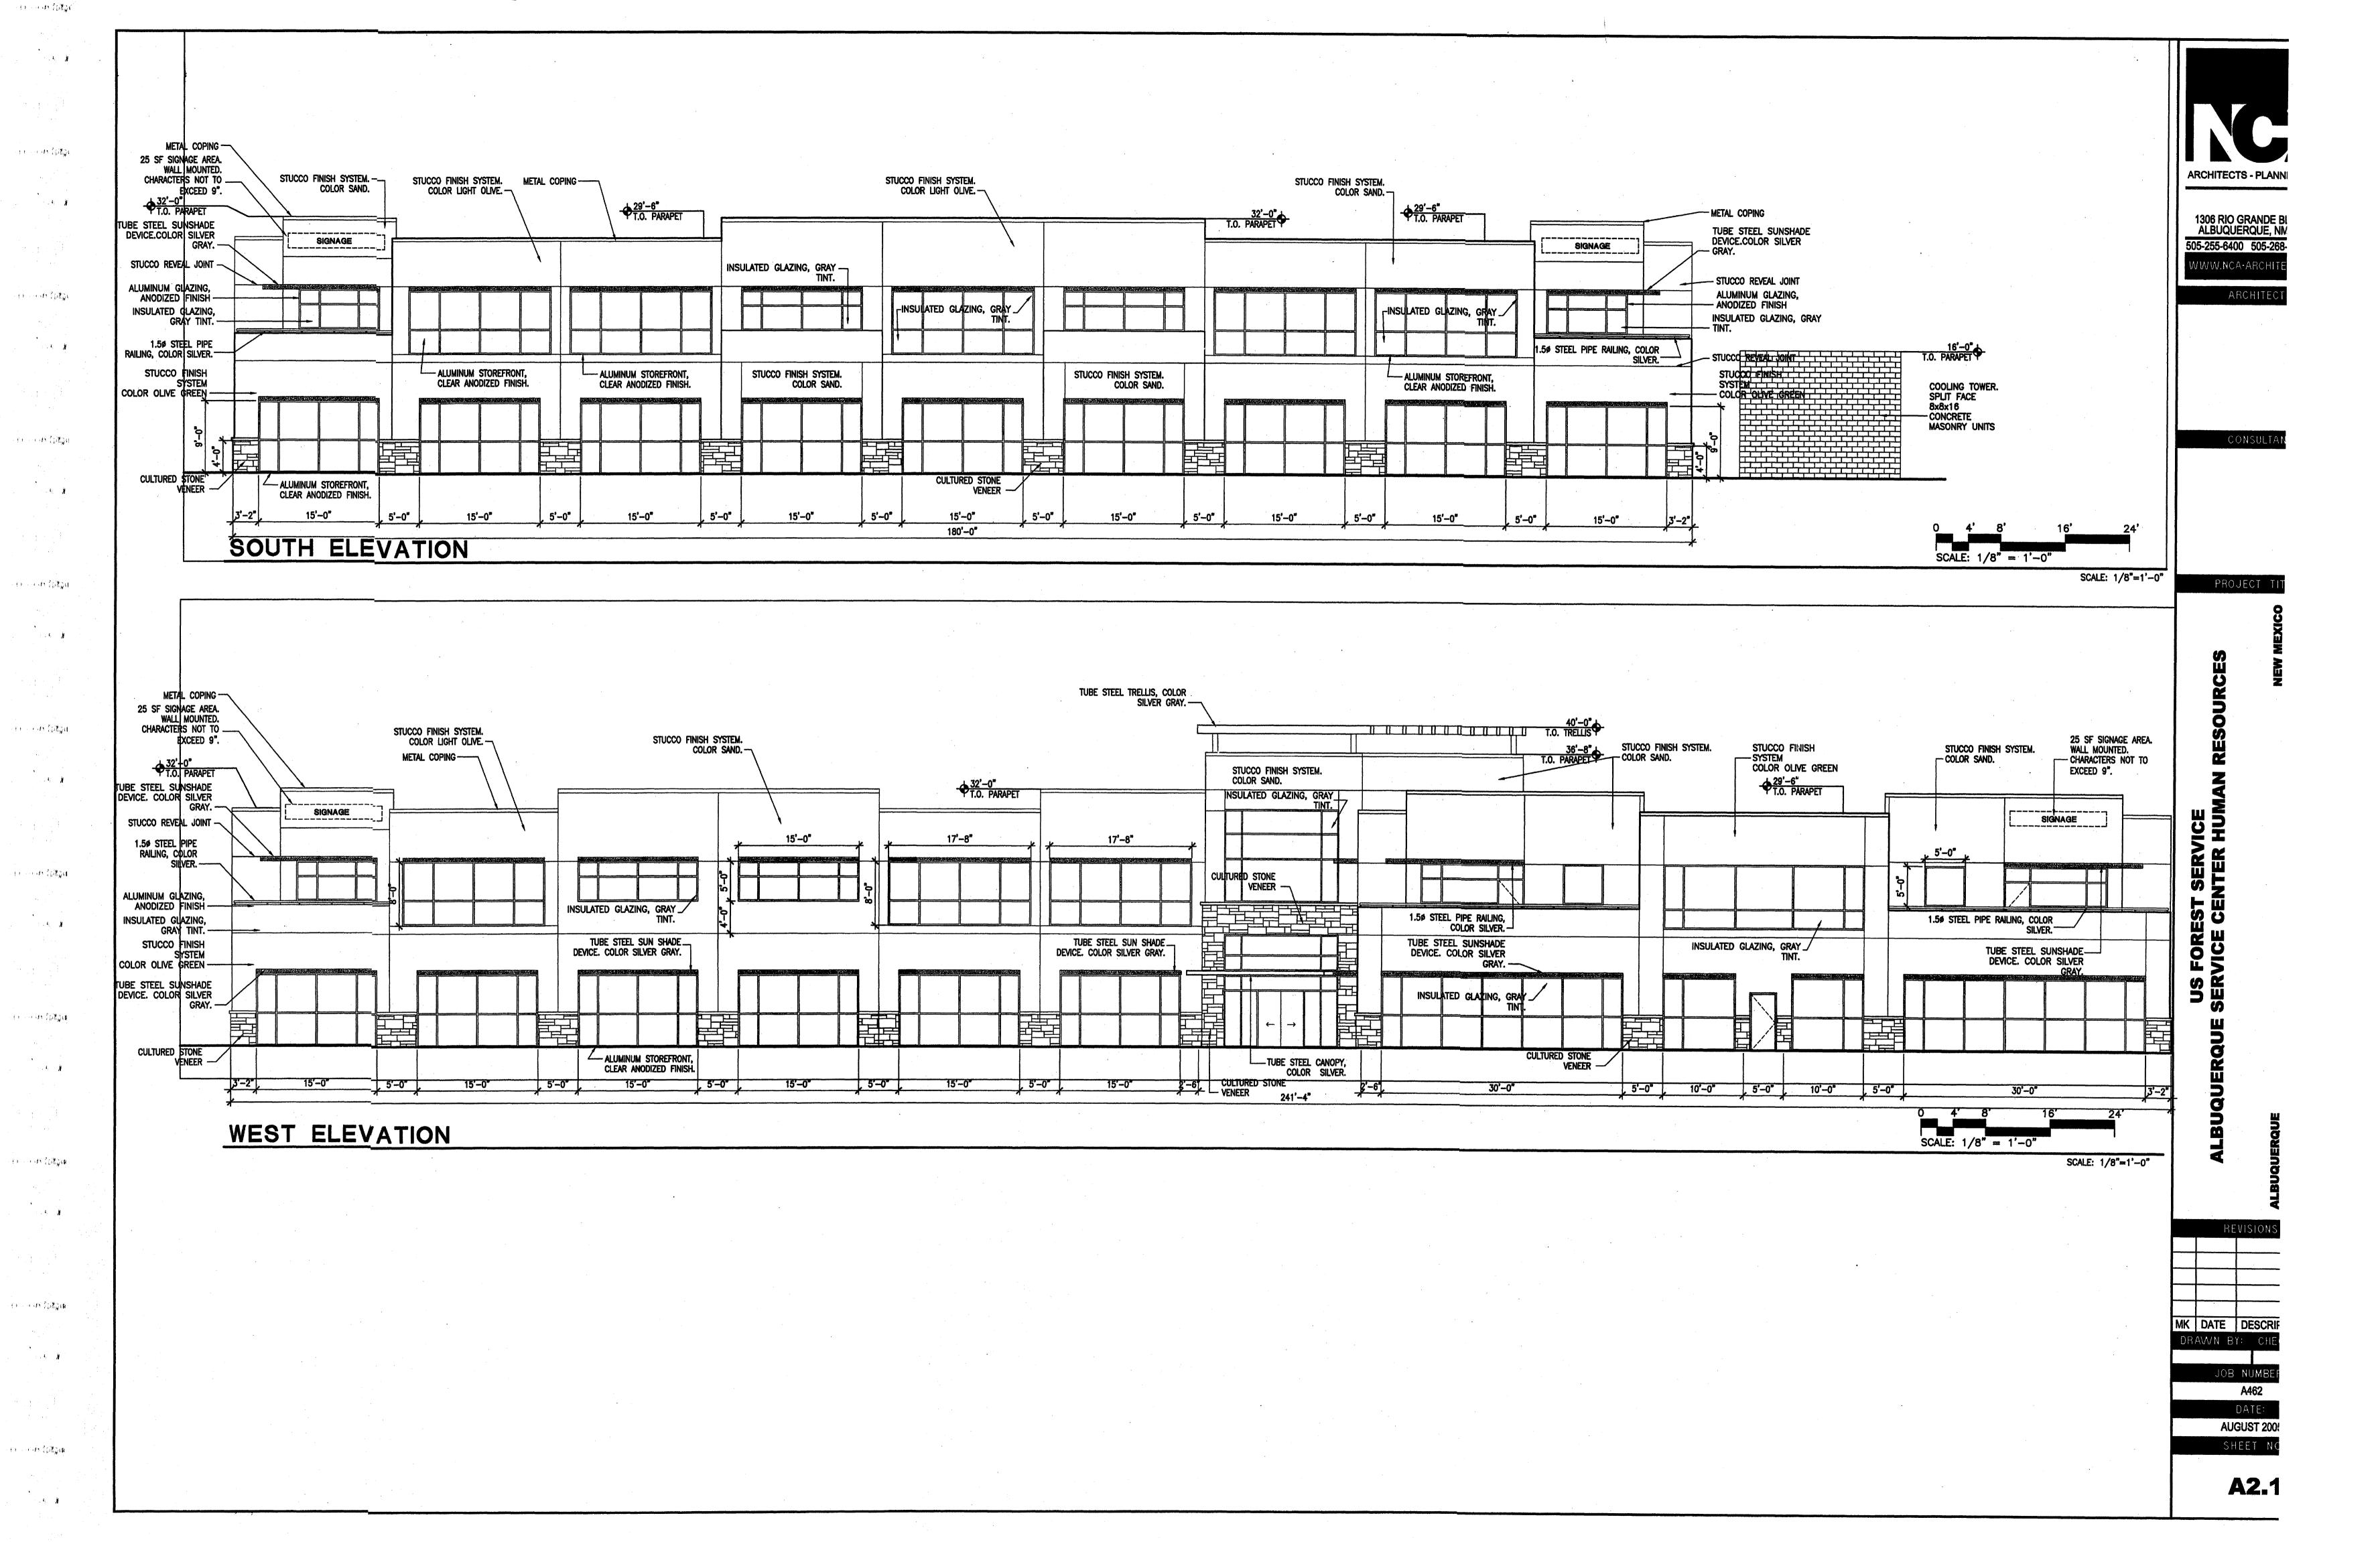
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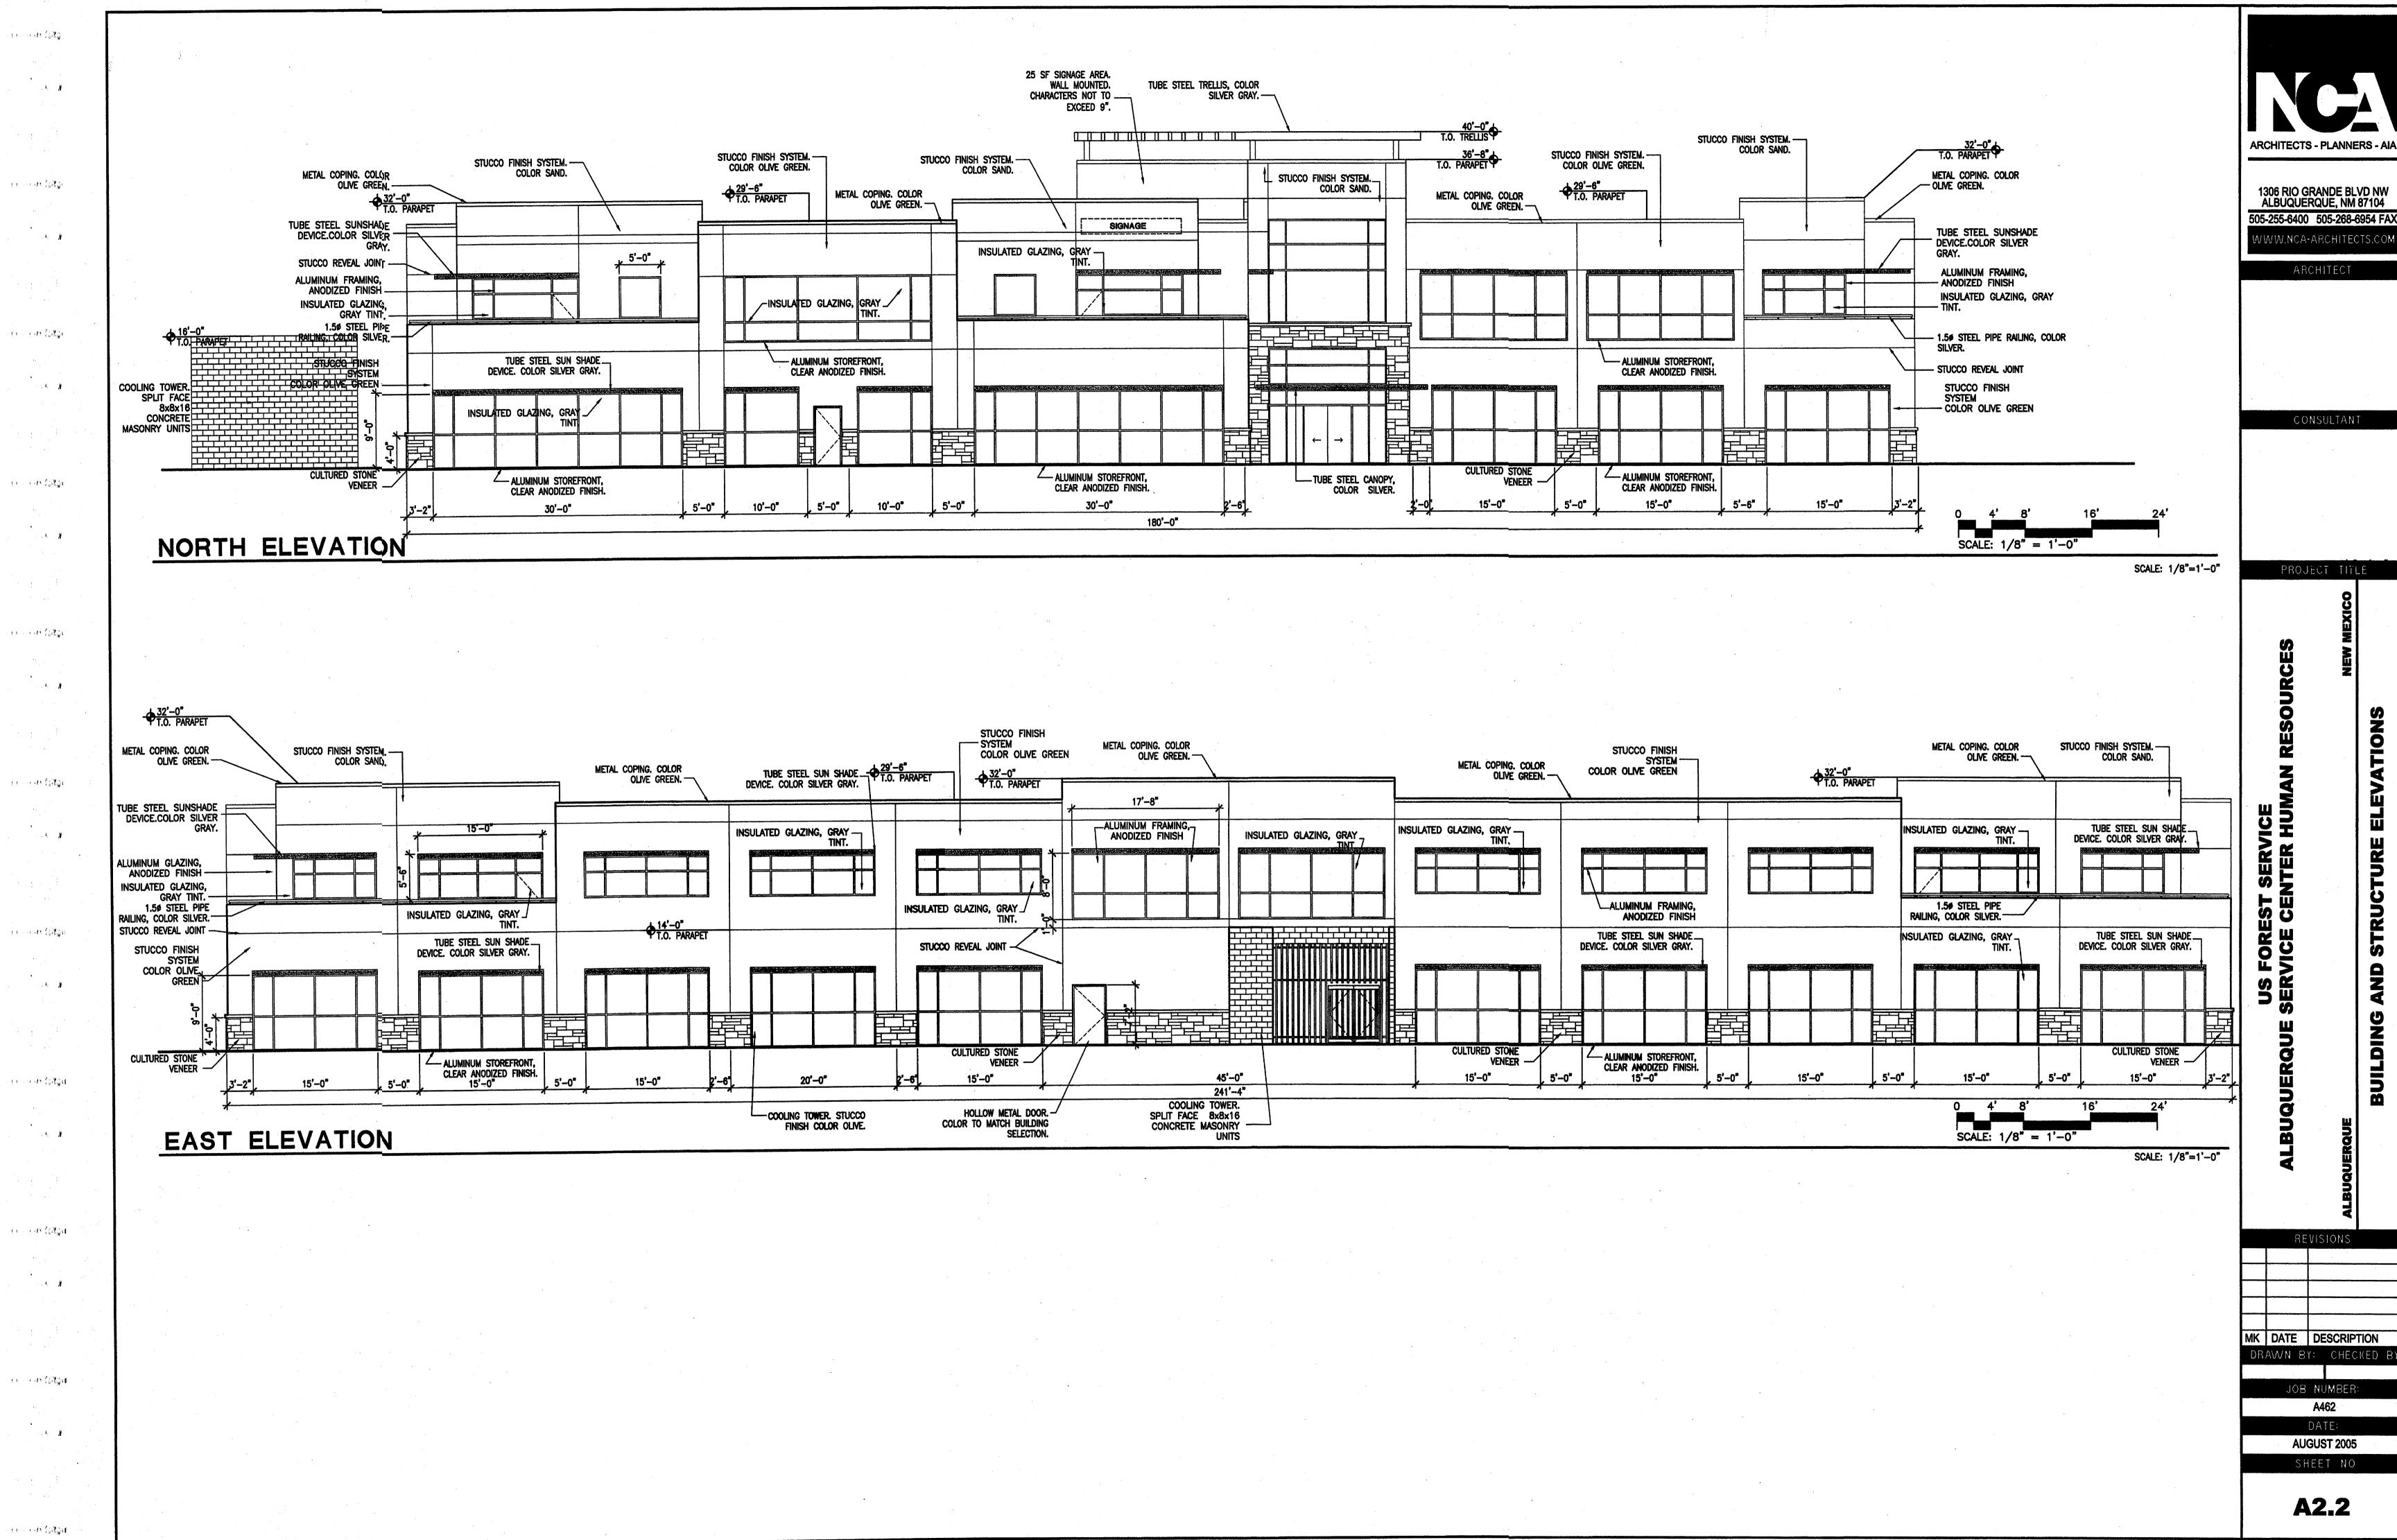
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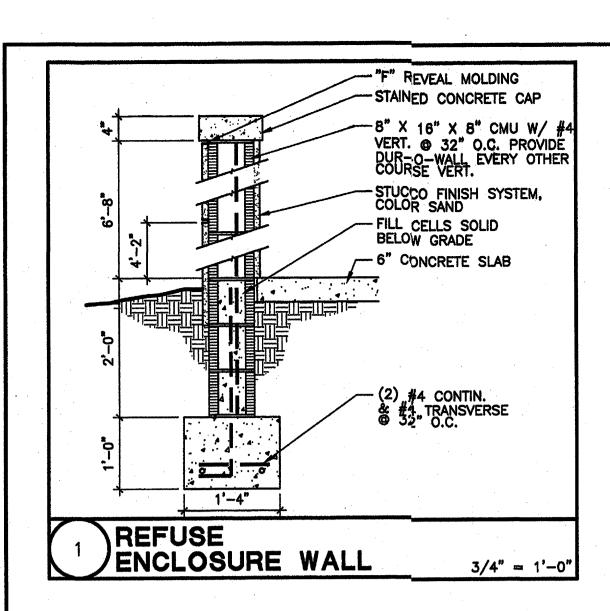
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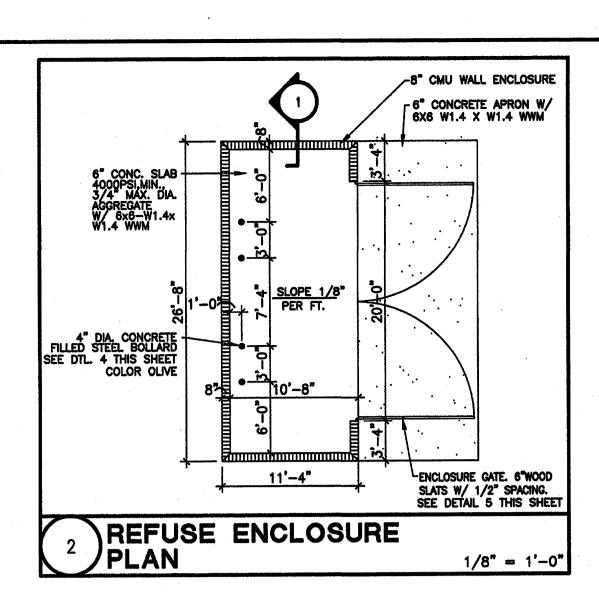
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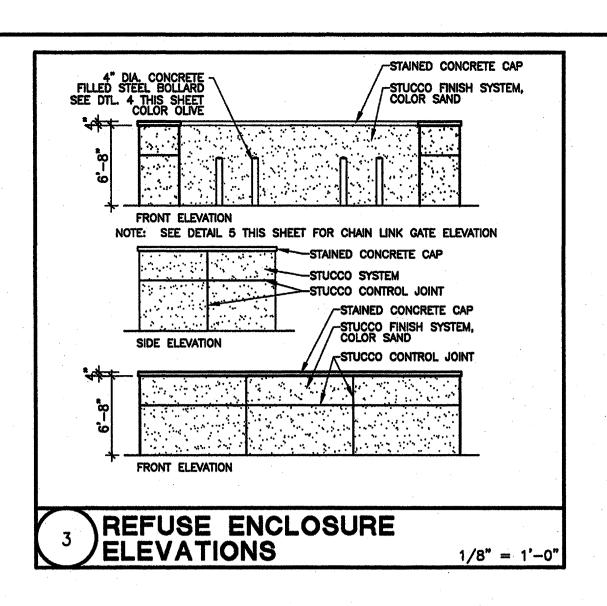



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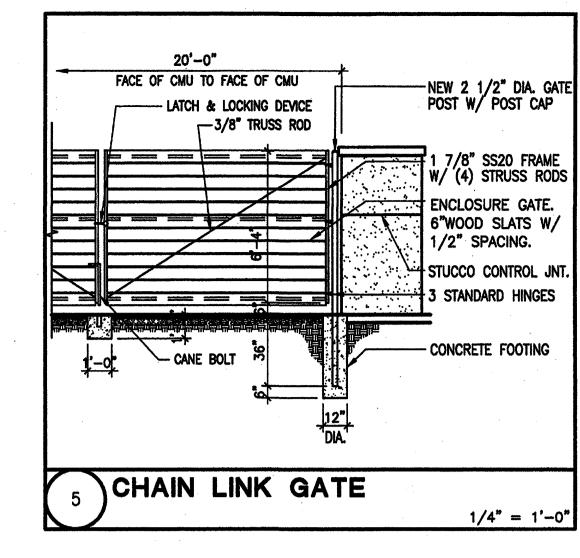
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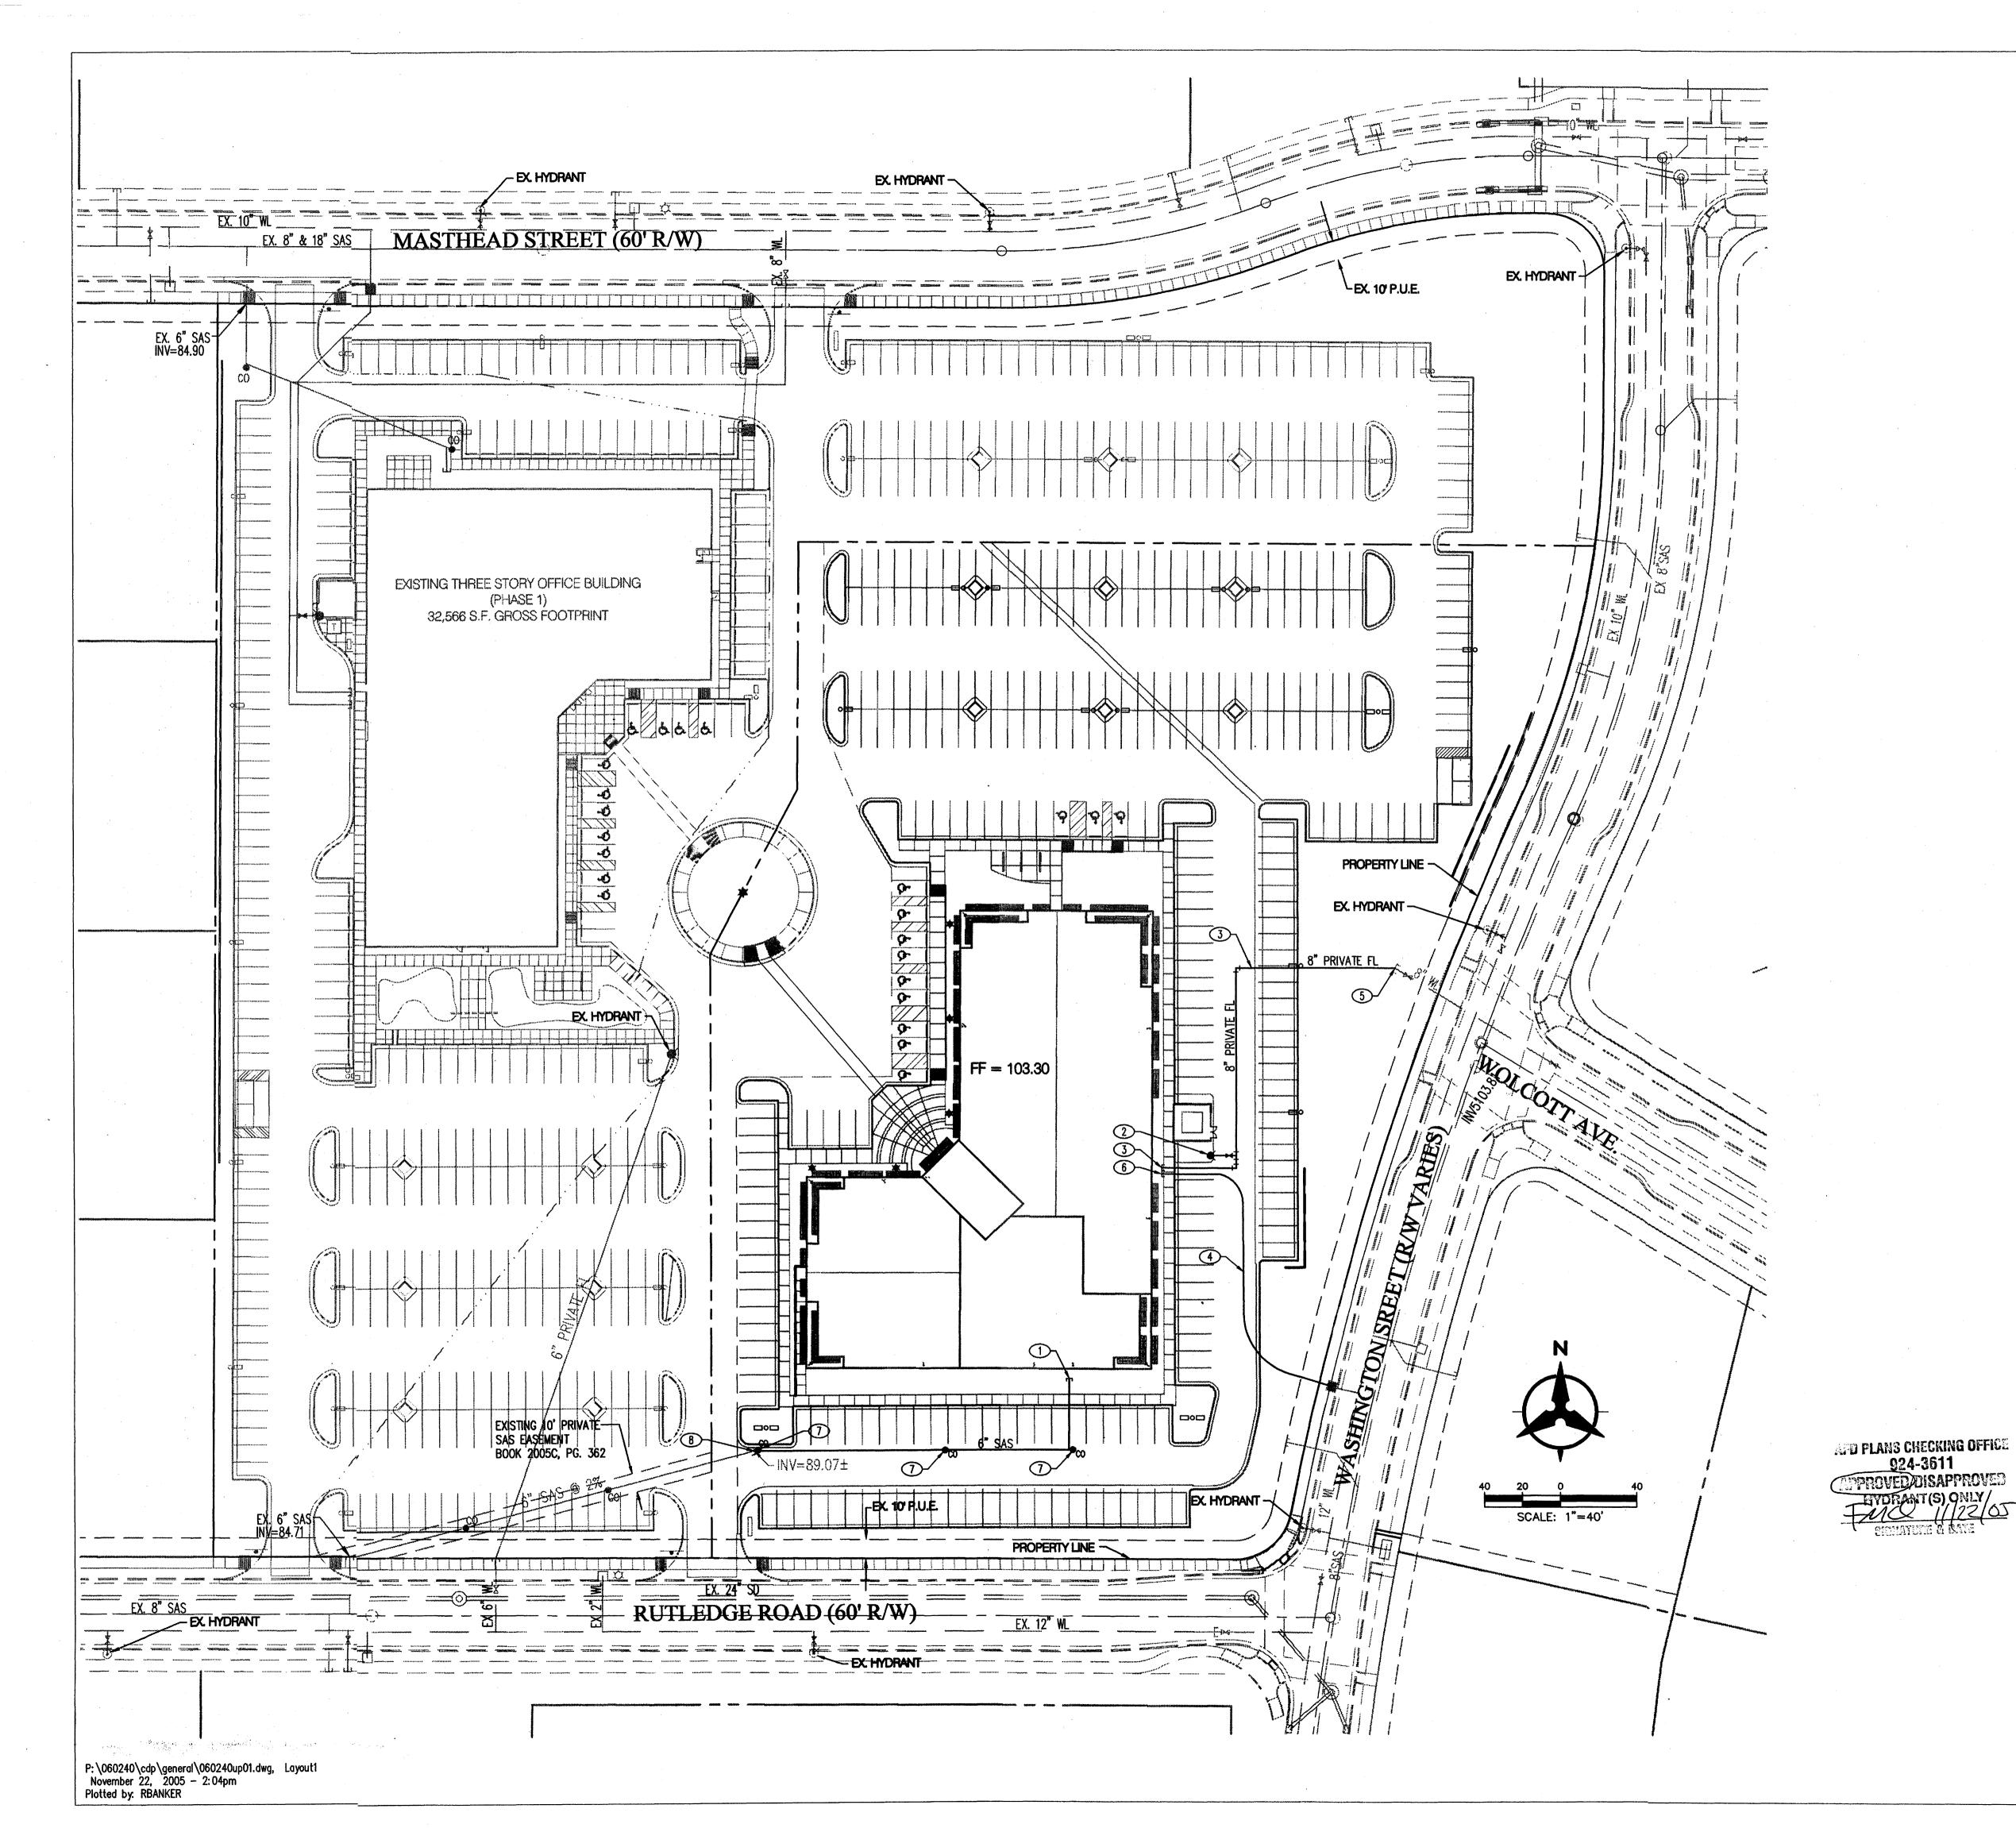
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UTILITY NOTES

- 1. THIS CONTRACTOR SHALL BE RESPONSIBLE FOR THE COMPLETE INSTALLATION OF ALL WORK RELATED TO MECHANICAL UTILITIES AS SHOWN ON THIS PLAN INCLUDING: TRENCHING, BACKFILL, SUPPORTS, CLEANOUT PADS, SERVICE STOPS AND BOXES, SERVICE LINES, TESTING, CLEANING, AND STERILIZING. ANY WORK NOT ACCEPTED BY THE ARCHITECT OR ENGINEER DUE TO IMPROPER WORKMANSHIP OR LACK OF PROPER COORDINATION SHALL BE REMOVED AND CORRECTLY INSTALLED AT THE CONTRACTOR'S EXPENSE, AS DIRECTED.
- 2. MINIMUM DEPTHS OF COVER SHALL BE: 36" FOR WATERLINES AND 48" FOR SEWER, EXCEPT AT BUILDING CONNECTION.
- 3. ALL WORK DETAILED ON THESE PLANS TO BE PERFORMED UNDER CONTRACT SHALL, EXCEPT AS OTHERWISE STATED OR PROVIDED OF HEREON, BE CONSTRUCTED IN ACCORDANCE WITH THE IAPMO UNIFORM PLUMBING CODE, LATEST EDITION.
- 4. UTILITY LINES SHALL BE INSTALLED PRIOR TO PAVEMENT, CURB AND GUTTER, AND/OR SIDEWALK, AS APPLICABLE.
- 5. ROUGH GRADING OF SITE (±0.5") SHALL BE COMPLETED PRIOR TO INSTALLATION OF UTILITY LINES.
- 6. CONTRACTOR WILL BE RESPONSIBLE FOR CONNECTIONS TO BUILDING DRAIN LINES AND ALL NECESSARY FITTINGS.
- 7. ALL VALVES SHALL BE ANCHORED PER COA STANDARD DWG. 2333.
- 8. FIRE LINES SHALL USE PIPE MATERIALS UNDERWRITERS LABORATORIES LISTED AND APPROVED FOR FIRE SERVICE.
- 9. CONTRACTOR SHALL BE RESPONSIBLE FOR ALL WATER METER, FIRE LINE, AND SEWER HOOKUP FEES FOR INSTALLATIONS. OWNER SHALL BE RESPONSIBLE FOR UTILITY EXPANSION CHARGES, PRORATA AND OTHER SPECIAL ASSESSMENTS.
- 10. CONTRACTOR SHALL VERIFY INVERTS AND LOCATIONS OF EXISTING WATER/SAS LINES PRIOR TO BEGINNING WORK. ALL CONFLICTS SHALL BE BROUGHT TO ATTENTION OF THE ENGINEER AND RESOLVED PRIOR TO BEGINNING WORK.

UTILITY KEYED NOTES

- 1. 6" SANITARY SEWER STUB
- 2. NEW PRIVATE FIRE HYDRANT
- 3. 8" PRIVATE FIRE LINE SERVICE FOR BUILDING SPRINKLERS.
 BACKFLOW PREVENTER TO BE INSTALLED INSIDE MECHANICAL ROOM.
 FDC TO BE LOCATED ON BUILDING WALL.
- 4. NEW 1 1/2" METERED WATER SERVICE. CONNECT TO EXISTING 2" WATER LINE STUB OUT.
- 5. CONNECTION TO EXISTING 8" FIRE LINE STUB
- 6. NEW 1 1/2" DOMESTIC WATER SERVICE TO BUILDING, BACKFLOW PREVENTER SHALL BE INSIDE MECHANICAL ROOM.
- 7. SANITARY SEWER CLEANOUT
- 8. CONNECT TO EX. 6" SAS STUB PROVIDED TO SITE WITH PHASE 1.

LEGEND

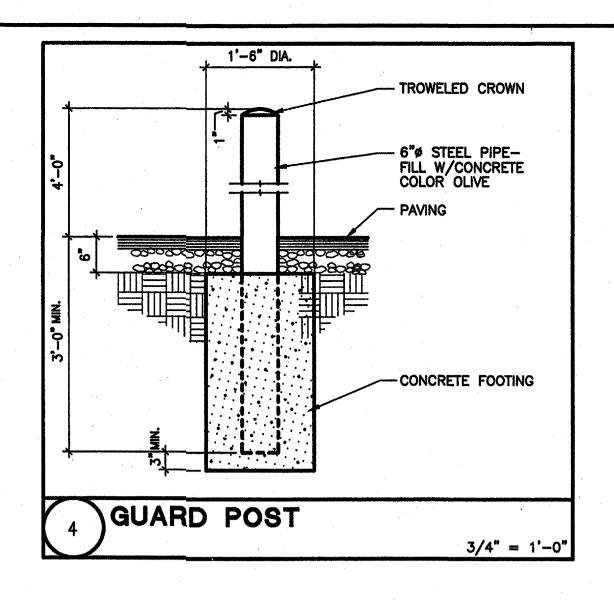	PROPERTY LINE
EX. 8° SAS	EX SANITARY SEWER & MANI-
<u>EX. 24" SO</u>	EX STORM DRAIN & MANHOLE
	EX INLET
EX_12" WL	EX WATER LINE
*	EX VALVE
	EX METER
छ	EX FIRE HYDRANT
\document	ex street light
SAS	PROPOSED SANITARY SEWER
$ullet_{\infty}$	PROPOSED CLEANOUT
WL	PROPOSED WATERLINE

Bohannan A Huston

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ARCHITECT

CONSULTANT

NEW MEXICO

AT JOURNAL CENTER 2

REVISIONS

MK DATE DESCRIPTION

DRAWN BY: CHECKED BY

RWB JTW

JOB NUMBER:

JOB NUMBER:


A0559

DATE:

NOVEMBER 2005

SHEET NO

C3.0

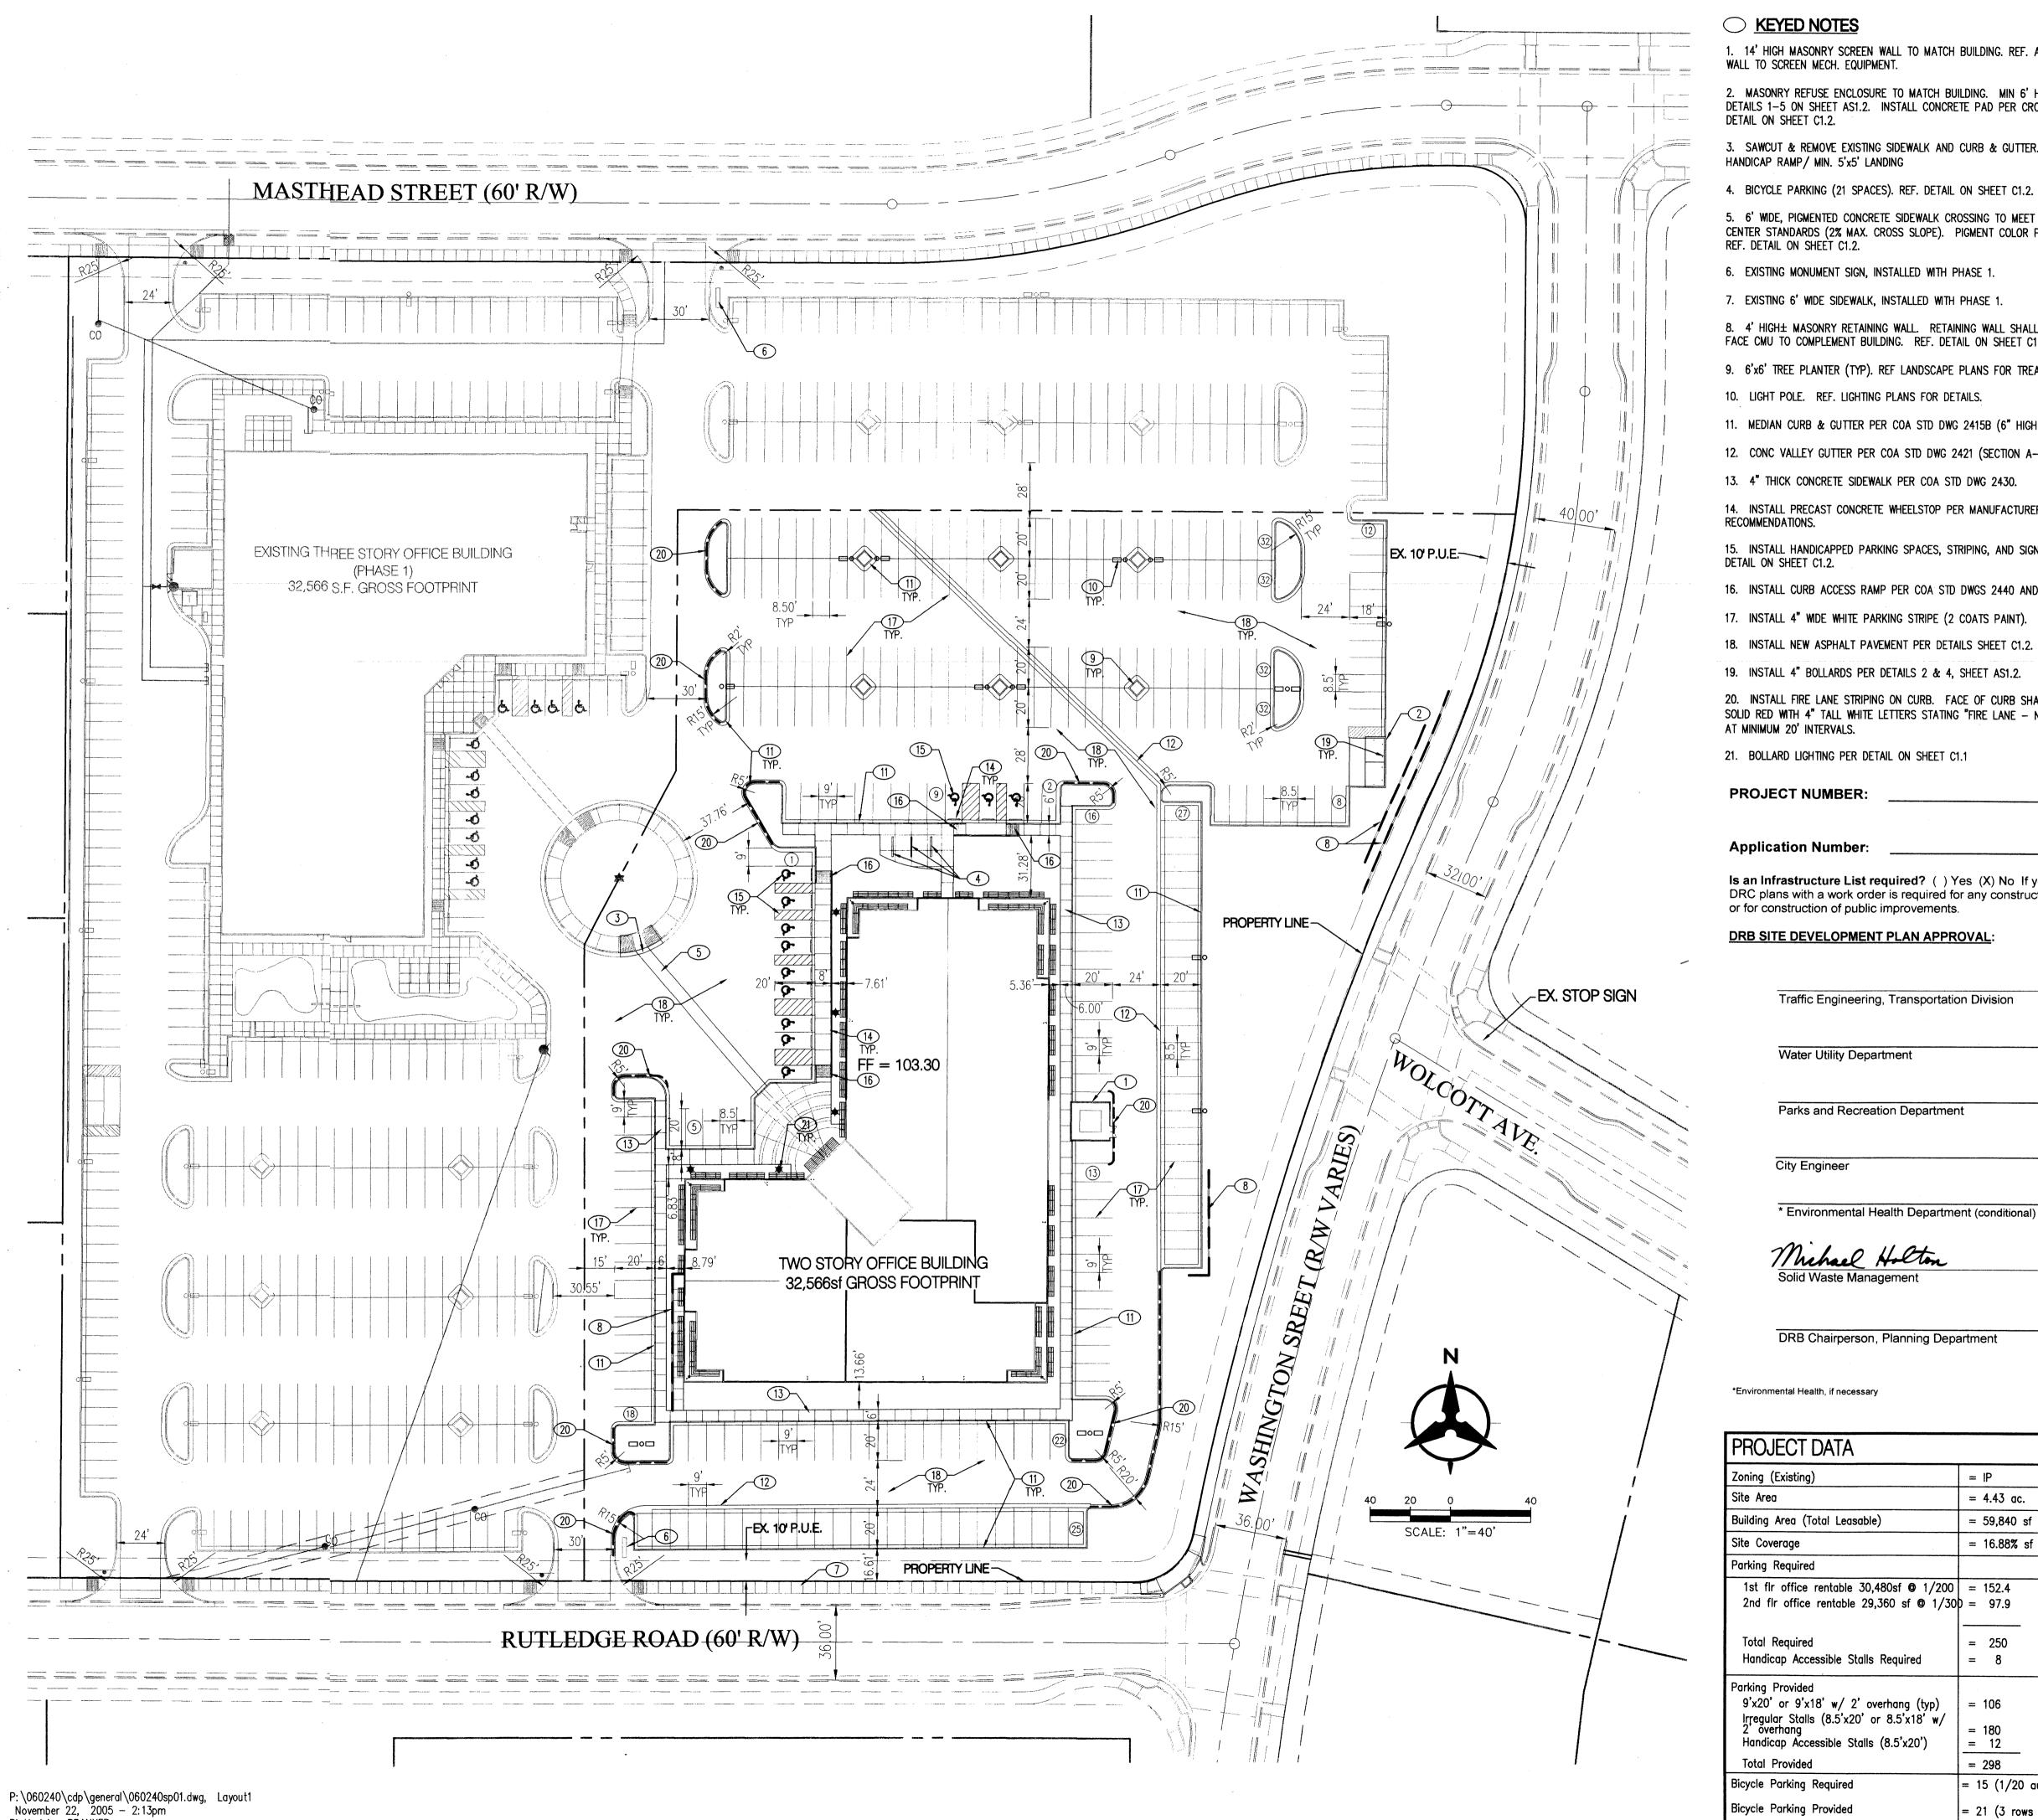

OFF CHAPT

Plotted by: RBANKER

1. 14' HIGH MASONRY SCREEN WALL TO MATCH BUILDING. REF. ARCH. DETAILS. WALL TO SCREEN MECH. EQUIPMENT.

2. MASONRY REFUSE ENCLOSURE TO MATCH BUILDING. MIN 6' HIGH. SEE DETAILS 1-5 ON SHEET AS1.2. INSTALL CONCRETE PAD PER CROSS SECTION DETAIL ON SHEET C1.2.

3. SAWCUT & REMOVE EXISTING SIDEWALK AND CURB & GUTTER. INSTALL HANDICAP RAMP/ MIN. 5'x5' LANDING

4. BICYCLE PARKING (21 SPACES). REF. DETAIL ON SHEET C1.2.

5. 6' WIDE, PIGMENTED CONCRETE SIDEWALK CROSSING TO MEET JOURNAL CENTER STANDARDS (2% MAX. CROSS SLOPE). PIGMENT COLOR PER ARCHITECT. REF. DETAIL ON SHEET C1.2.

- 6. EXISTING MONUMENT SIGN, INSTALLED WITH PHASE 1.
- 7. EXISTING 6' WIDE SIDEWALK, INSTALLED WITH PHASE 1.

8. 4' HIGH± MASONRY RETAINING WALL. RETAINING WALL SHALL BE SPLIT FACE CMU TO COMPLEMENT BUILDING. REF. DETAIL ON SHEET C1.2.

- 9. 6'x6' TREE PLANTER (TYP). REF LANDSCAPE PLANS FOR TREATMENT.
- 10. LIGHT POLE. REF. LIGHTING PLANS FOR DETAILS.
- 11. MEDIAN CURB & GUTTER PER COA STD DWG 2415B (6" HIGH CURB).
- 12. CONC VALLEY GUTTER PER COA STD DWG 2421 (SECTION A-A).
- 14. INSTALL PRECAST CONCRETE WHEELSTOP PER MANUFACTURER'S
- RECOMMENDATIONS. 15. INSTALL HANDICAPPED PARKING SPACES, STRIPING, AND SIGNAGE PER
- DETAIL ON SHEET C1.2. 16. INSTALL CURB ACCESS RAMP PER COA STD DWGS 2440 AND 2441.
- 17. INSTALL 4" WIDE WHITE PARKING STRIPE (2 COATS PAINT).
- 19. INSTALL 4" BOLLARDS PER DETAILS 2 & 4, SHEET AS1.2.
- 20. INSTALL FIRE LANE STRIPING ON CURB. FACE OF CURB SHALL BE PAINTED SOLID RED WITH 4" TALL WHITE LETTERS STATING "FIRE LANE - NO PARKING" AT MINIMUM 20' INTERVALS.
- 21. BOLLARD LIGHTING PER DETAIL ON SHEET C1.1

PROJECT NUMBER:	

Is an Infrastructure List required? () Yes (X) No If yes, then a set of approved DRC plans with a work order is required for any construction within Public Right-of-Way or for construction of public improvements.


DRB SITE DEVELOPMENT PLAN APPROVAL:

Traffic Engineering, Transportation Division	Date
Water Utility Department	Date
Parks and Recreation Department	Date
City Engineer	Date
* Environmental Health Department (conditional)	Date
Michael Holton Solid Waste Management	///23,

*Environmental Health, if necessary

PROJECT DATA	
Zoning (Existing)	= IP
Site Area	= 4.43 ac.
Building Area (Total Leasable)	= 59,840 sf
Site Coverage	= 16.88% sf
Parking Required	
1st flr office rentable 30,480sf © 1/200 2nd flr office rentable 29,360 sf © 1/30	
Total Required Handicap Accessible Stalls Required	= 250 = 8
Parking Provided 9'x20' or 9'x18' w/ 2' overhang (typ) Irregular Stalls (8.5'x20' or 8.5'x18' w/ 2' overhang Handicap Accessible Stalls (8.5'x20')	= 106 = 180 = 12
Total Provided	= 298
Bicycle Parking Required	= 15 (1/20 automobile spaces)
Bicycle Parking Provided	= 21 (3 rows of 7 each)

DRB Chairperson, Planning Department

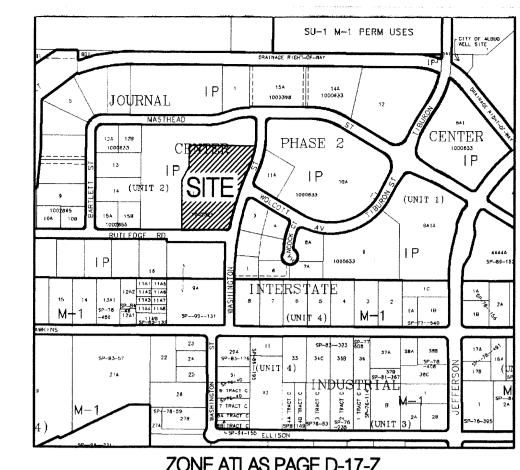

LEGAL DESCRIPTION
TRACT 11-B OF JOURNAL CENTER UNIT 2, PHASE 2
ALBUQUERQUE, NM, NOVEMBER, 2005



CONSULTANT

ARCHITECT

PROJECT TITLE

REVISIONS

MK DATE DESCRIPTION DRAWN BY: CHECKED BY: RWB

JOB NUMBER: A0559

NOVEMBER 2005 SHEET NO

C1.0

DRAWING INDEX
C1.0 - SITE PLAN
C1.1 - SITE DETAILS

L1.0 - LANDSCAPE PLAN

GENERAL NOTES

C2.0 - PRELIMINARY GRADING PLAN A2.1 - BUILDING & STRUCTURE ELEVATIONS A2.2 - BUILDING & STRUCTURE ELEVATIONS

AS1.1 - REFUSE ENCLUSURE AND MONUMENTAL SIGN DETAILS C3.0 - CONCEPTUAL UTILITY PLAN


1. SCREEN WALLS AND REFUSE ENCLOSURE SHALL BE INTEGRAL TO BUILDING

3. SITE LIGHTING SHALL BE HORIZONTAL CUT — OFF TYPE AND MAXIMUM 24' HICH ABOVE GRADE. POLES AND FIXTURES SHALL BE PER JOURNAL CENTER


2. UTILITY BOXES SHALL BE SCREENED WITH MATURE LANDSCAPING.

Bohannan 🔺 Hustong

ENGINEERING A SPATIAL DATA A ADVANCED TECHNOLOGIES

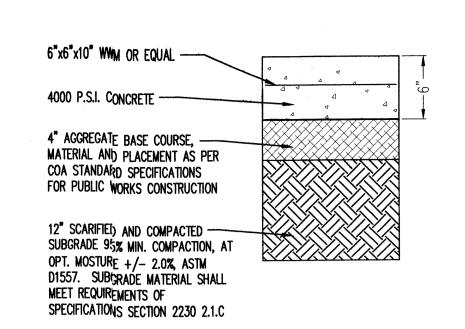


REFUSE ENCLOSURE CONCRETE PAVEMENT

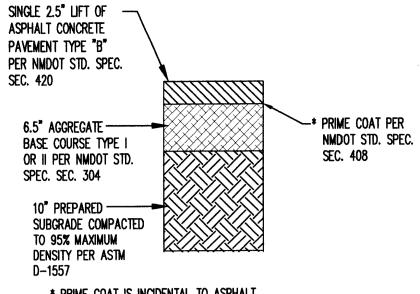


* PRIME COAT IS INCIDENTAL TO ASPHALT CONCRETE PAVEMENT * REFERENCE GEOTECHNICAL REPORT FOR ADDITIONAL INFORMATION.

LIGHT DUTY ASPHALT PAVEMENT SECTION

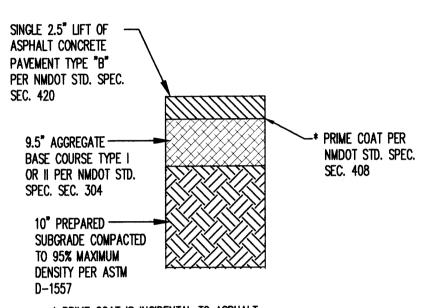


* PRIME COAT IS INCIDENTAL TO ASPHALT CONCRETE PAVEMENT * REFERENCE GEOTECHNICAL REPORT FOR ADDITIONAL INFORMATION.

HEAVY DUTY ASPHALT PAVEMENT SECTION

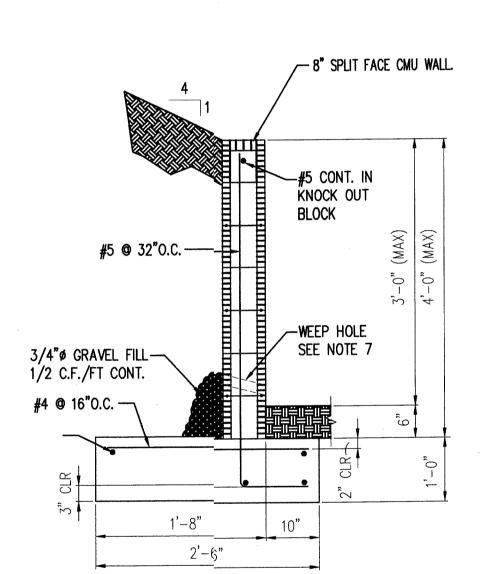


- RETAINING WALL SHALL NOT BE BACK-FILLED UNTIL AT LEAST 7 DAYS AFTER CASTING THE WALL.
- VERTICAL CONTROL JOINTS IN THE WALL SHALL BE PLACED AT 8'-0" O.C. MAX.
- CONSTRUCTION OF RETAINING WALLS SHALL CONFORM TO REQUIREMENTS OF THE 1997 UNIFORM BUILDING CODE.
- EFP (ACTIVE) = 36 PCFSOIL BEARING PRESSURE = 1500 PCF (1/3 INCREASE FOR WIND/SEISMIC) COEFFICIENT OF FRICTION = 0.35EFP (PASSIVE) = 300 PCFCONCRETE F' C (28 DAYS) = 3000 PSI REINFORCEMENT = 60 ASTM A-615
- CONTRACTOR SHALL NOTIFY OWNER PRIOR TO CONCRETE FOOTING POUR FOR INSPECTION OF COMPACTION UNDER FOOTING, FOOTING DEPTH AND WIDTH AND WALL STEEL AND SPACING. FINAL INSPECTION OF FOOTING AND WALL WILL BE REQUIRED.
- 6. THE CONTRACTOR SHALL BE RESPONSIBLE TO SEE THAT ALL REBAR IS PROPERLY ALIGNED AND TIED IN PLACE BEFORE PLACING CONCRETE. ALL STEEL SHALL BE ACCURATELY LOCATED AND SECURED IN PLACE SO THAT IT REMAINS IN POSITION DURING (THE PLACEMENT OF THE CONCRETE. ANY REBAR IMPROPERLY INSTALLED SHALL BE REMOVED AT NO ADDITIONAL COST TO
- WEEP HOLES: PLACE A 2" DIA. WEEP HOLE @ 5'-0" O.C. W/ 1/2 CUBIC FOOT/FOOT OF 3/4" GRAVEL IN FILTER FABRIC
- 8. THE FIRST COURSE OF CMU BLOCK MAY BE PLACED IN FRESH FOOTING CONCRETE. SUBSEQUENT COURSES OF CMU BLOCK SHALL NOT BE PLACED UNTIL 7 DAYS AFTER THE FOOTING IS CAST.
- 9. ALL CMU BLOCK JOINTS SHALL BE TOOLED.
- 10. BACK FILL AND COMPACTION OF RETAINING WALL IS INCIDENTAL TO INSTALLATION OF RETAINING WALL.

SPLIT FACE CMU RETAINING WALL

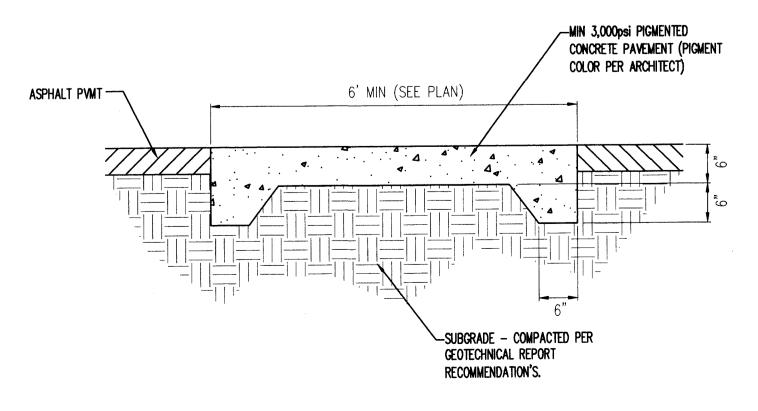



SIDEWALK CROSSING DETAIL

NOT TO SCALE

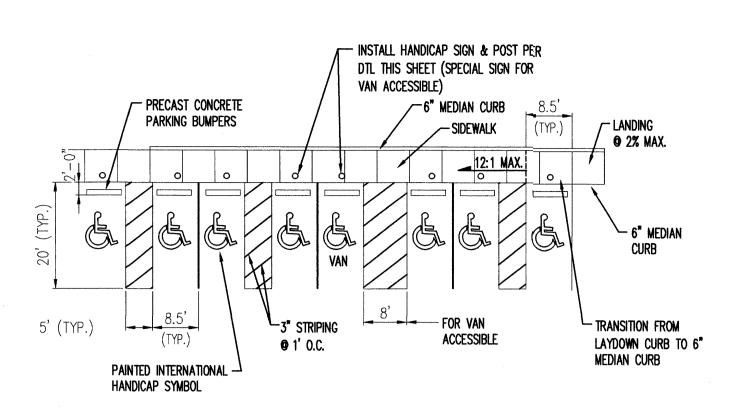


HANDICAP PARKING DETAIL

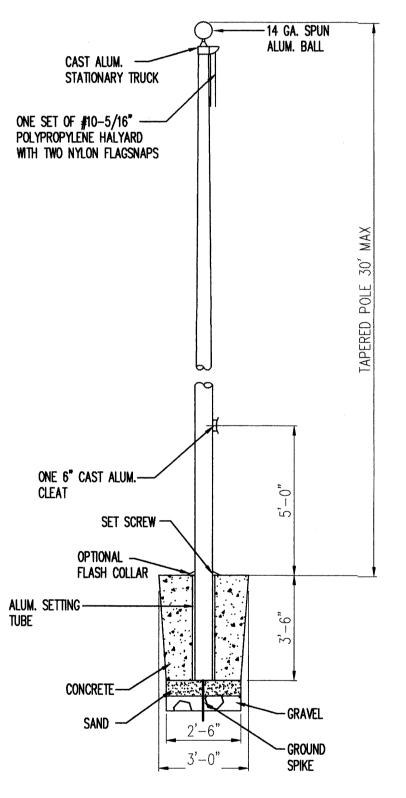

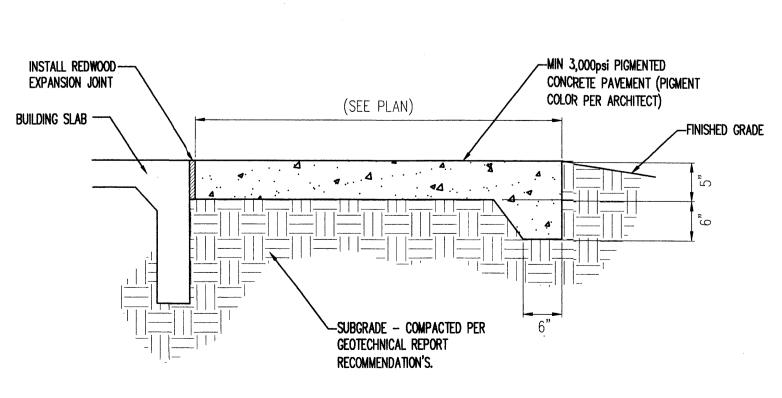


CONCRETE PATIO DETAIL

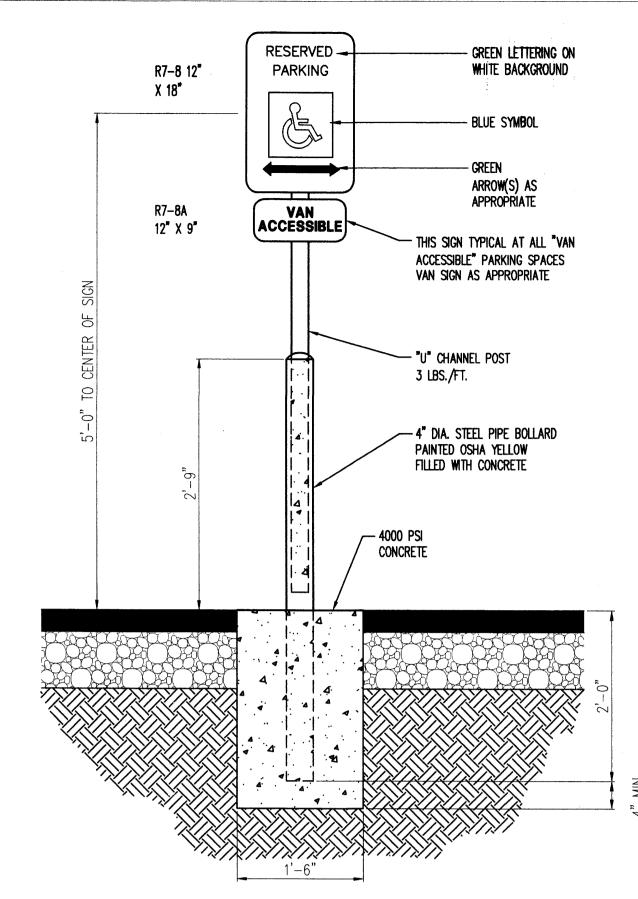

HANDICAP PARKING SIGN MOUNTING DETAIL

ONE SIGN SHALL BE INSTALLED AT EACH HANDICAP SPACE.

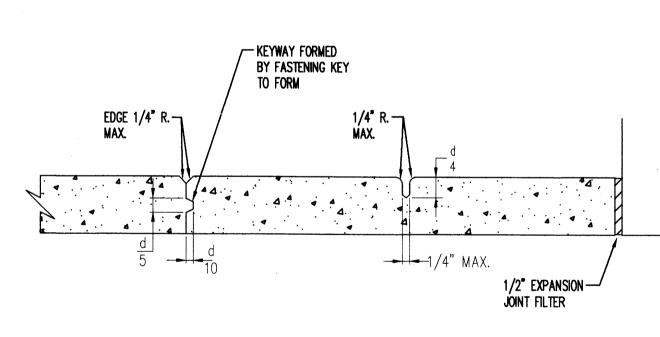


DETAIL A CONSTRUCTION JOINT 12'-0" SPACING (TYP.)

DETAIL B CONSTRUCTION FORMED JOINT 12'-0" SPACING (TYP.)

DETAIL C USE ONLY AT BUILDINGS OR OBJECTS ABUTTING THE PAVED AREA

CONCRETE PAVEMENT JOINT DETAILS

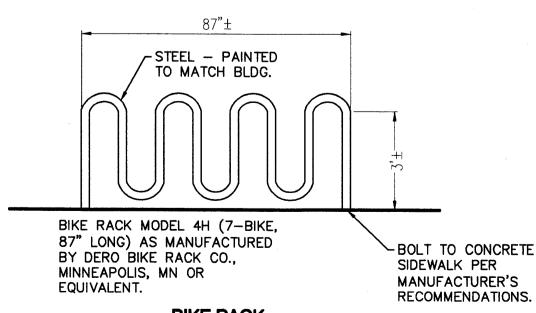

BIKE RACK NOT TO SCALE

Bohannan 🛦 Huston 🖹

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CONSULTANT

PROJECT TITLE

STHEAD OFFI

REVISIONS MK DATE DESCRIPTION DRAWN BY: CHECKED BY:

RWB JTW JOB NUMBER: A0559

DATE: **NOVEMBER 2005**

SHEET NO


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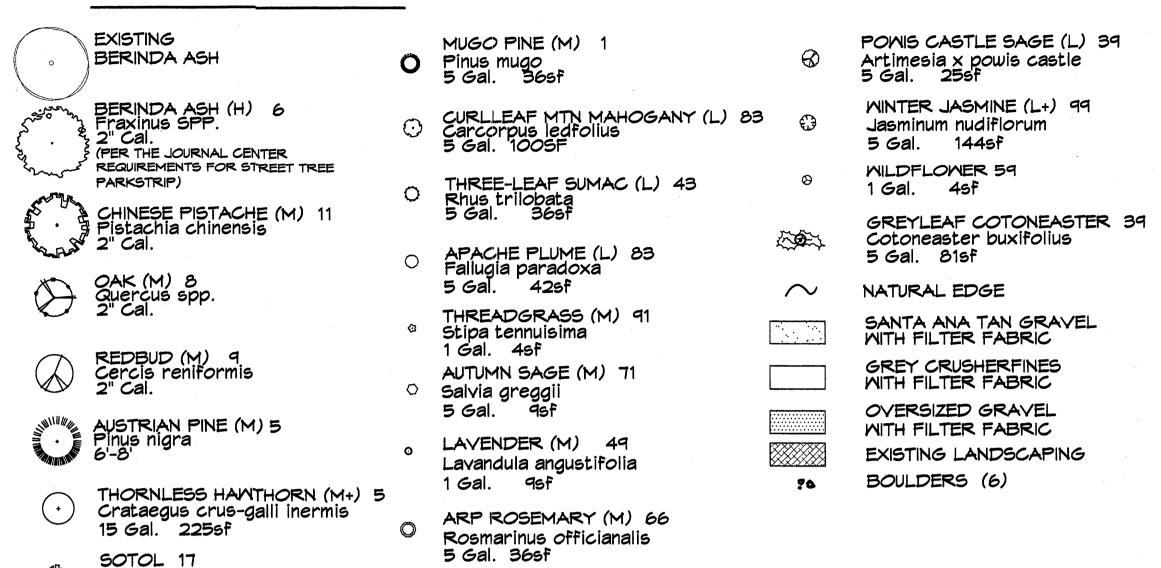
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11 15

PLANT LEGEND

SOTOL 17 Dasylirion wheeleri 5 Gal. 36sf



LANDSCAPE CALCULATIONS

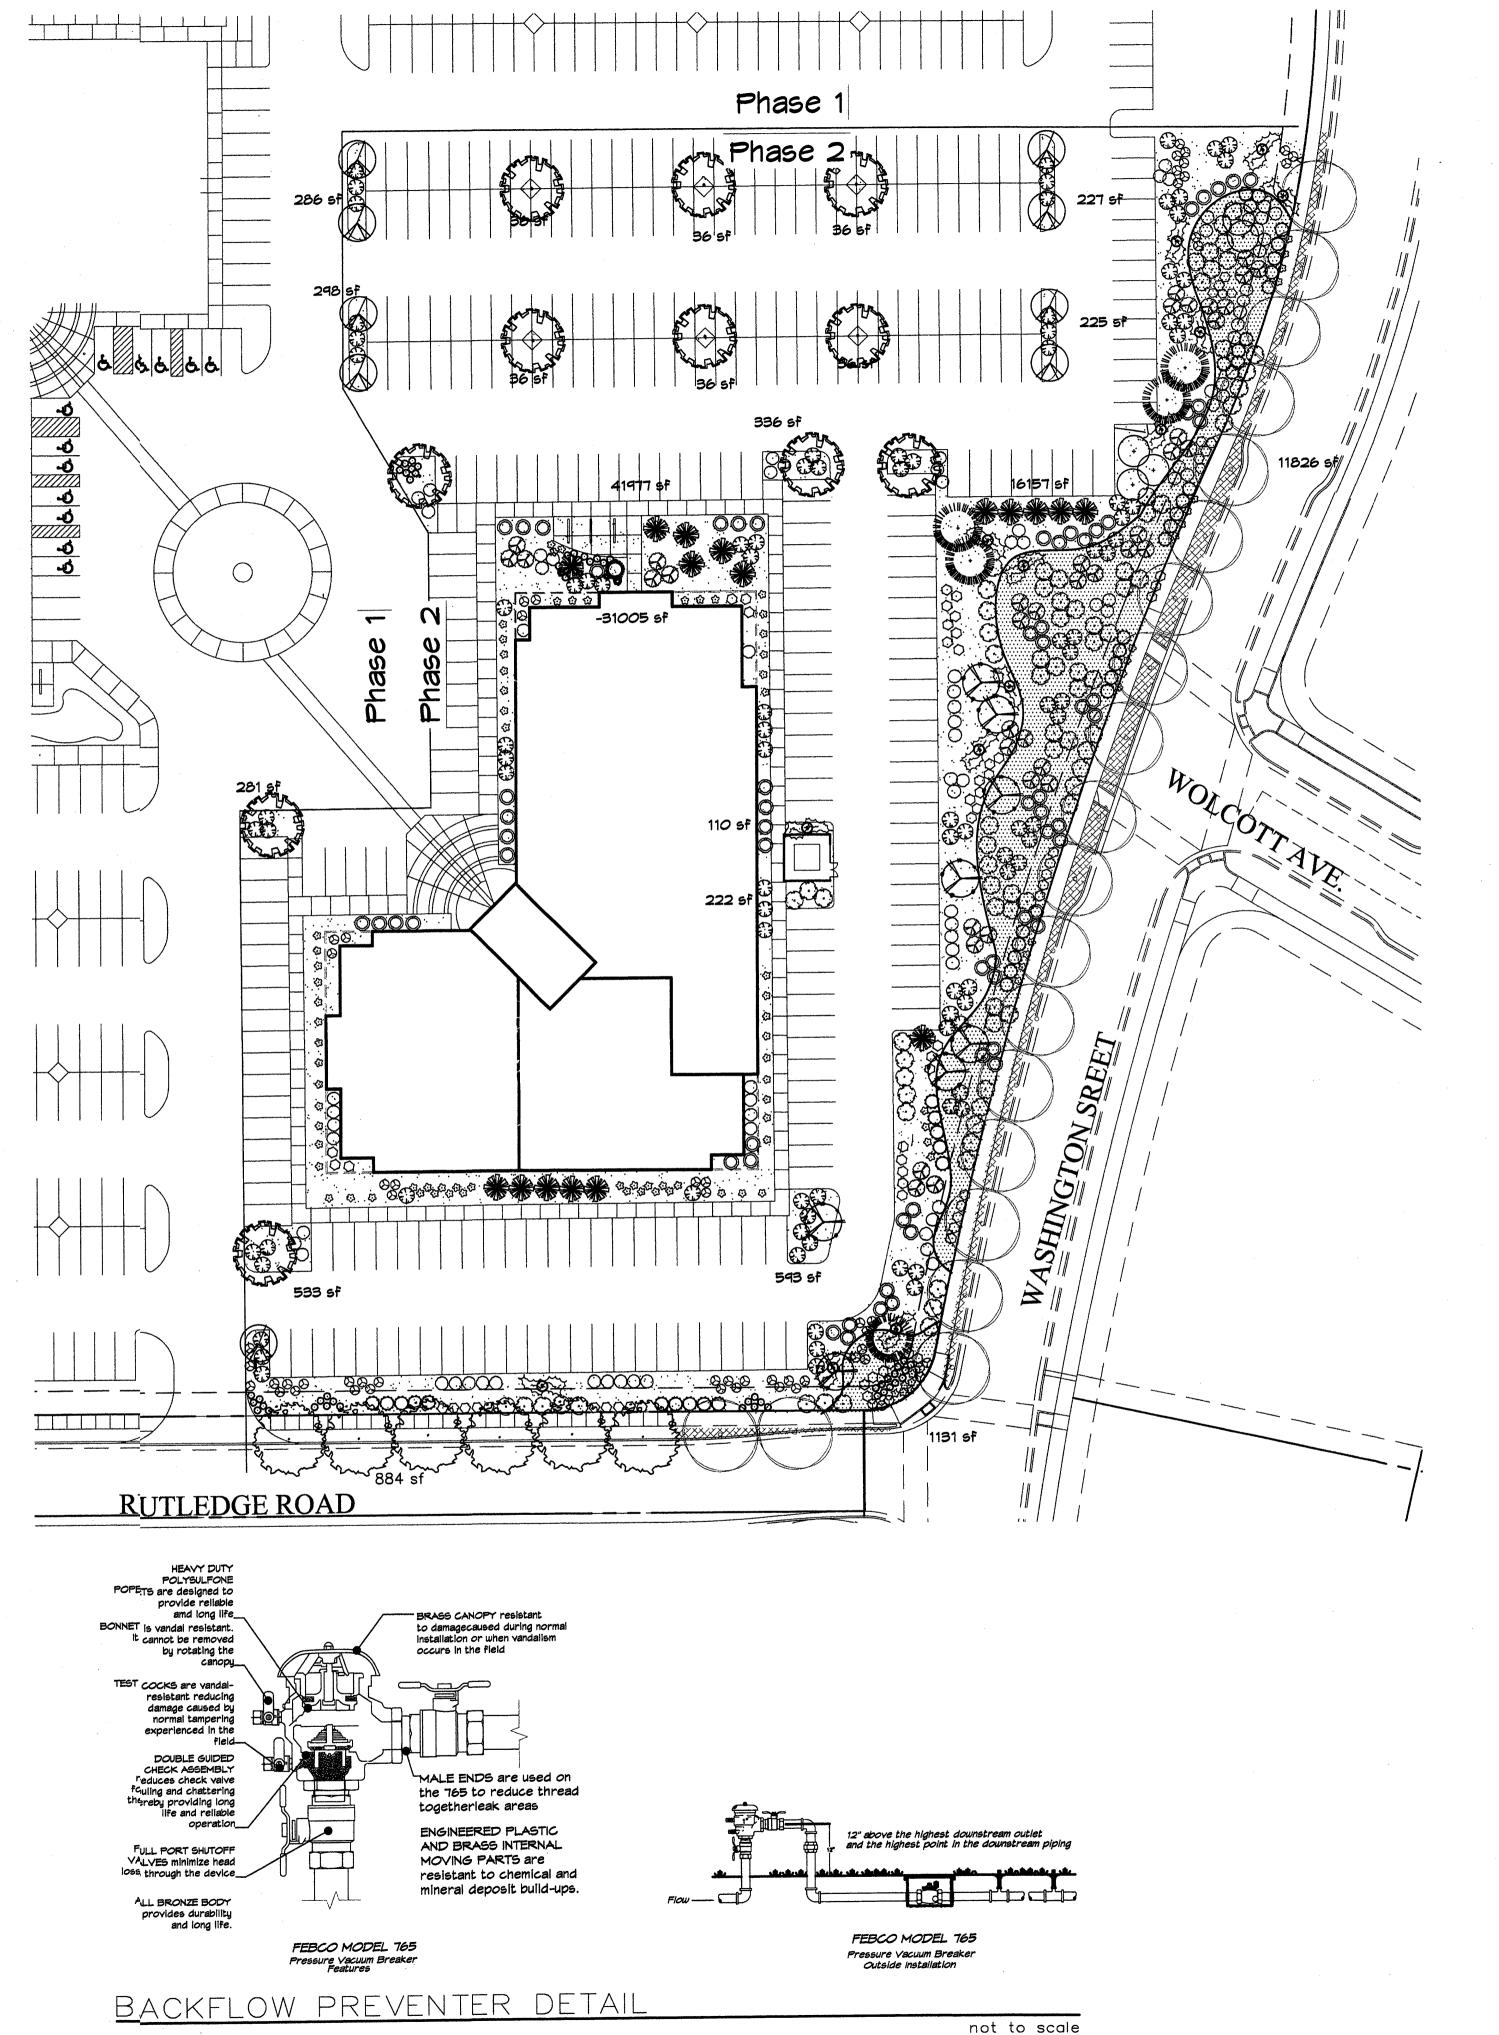
TOTAL LOT AREA	181507	square feet
TOTAL BUILDINGS AREA	43401	square feet
OFFSITE AREA	884	square feet
NET LOT AREA	137222	square feet
LANDSCAPE REQUIREMENT	15%	
TOTAL LANDSCAPE REQUIREMENT	20583	square feet
TOTAL BED PROVIDED	44297	square fee
GROUNDCOVER REQ.	75%	square fee
TOTAL GROUNDCOVER REQUIREMENT	T 33223	square fee
TOTAL GROUNDCOVER PROVIDED	34394 (77%)	square fee
TOTAL SOD AREA	0	square fee
(max. 20% of landscape required)		
TOTAL NATIVE SEED AREA	0	square fee
TOTAL LANDSCAPE PROVIDED	44297 (32%)	square fee



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Fax (505) 898—7737
cjohnson@hilltoplandscaping.com
All creative ideas contained Herein remains the property of The Hilltop Landscape Architects and

C johnson@hilltoplandscaping.c

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GRAPHIC SCALE

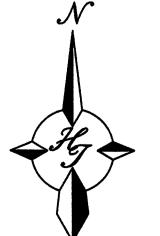40 20 0 20 40

SCALE: 1"=40'

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1306 RIO GRANDE BLVD NW
ALBUQUERQUE, NM 87104

505-255-6400 505-268-6954 FAX

NEW MEXICO

MASTHEAD OFFICE COMPLEX AT JOURNAL CENTER 2

DRR 11/22/05 REVISED SITE PLAN
MK DATE DESCRIPTION

DRR CL


DRR CJ

10 = (A) M = E

A0559

NOVEMBER 2005

L1

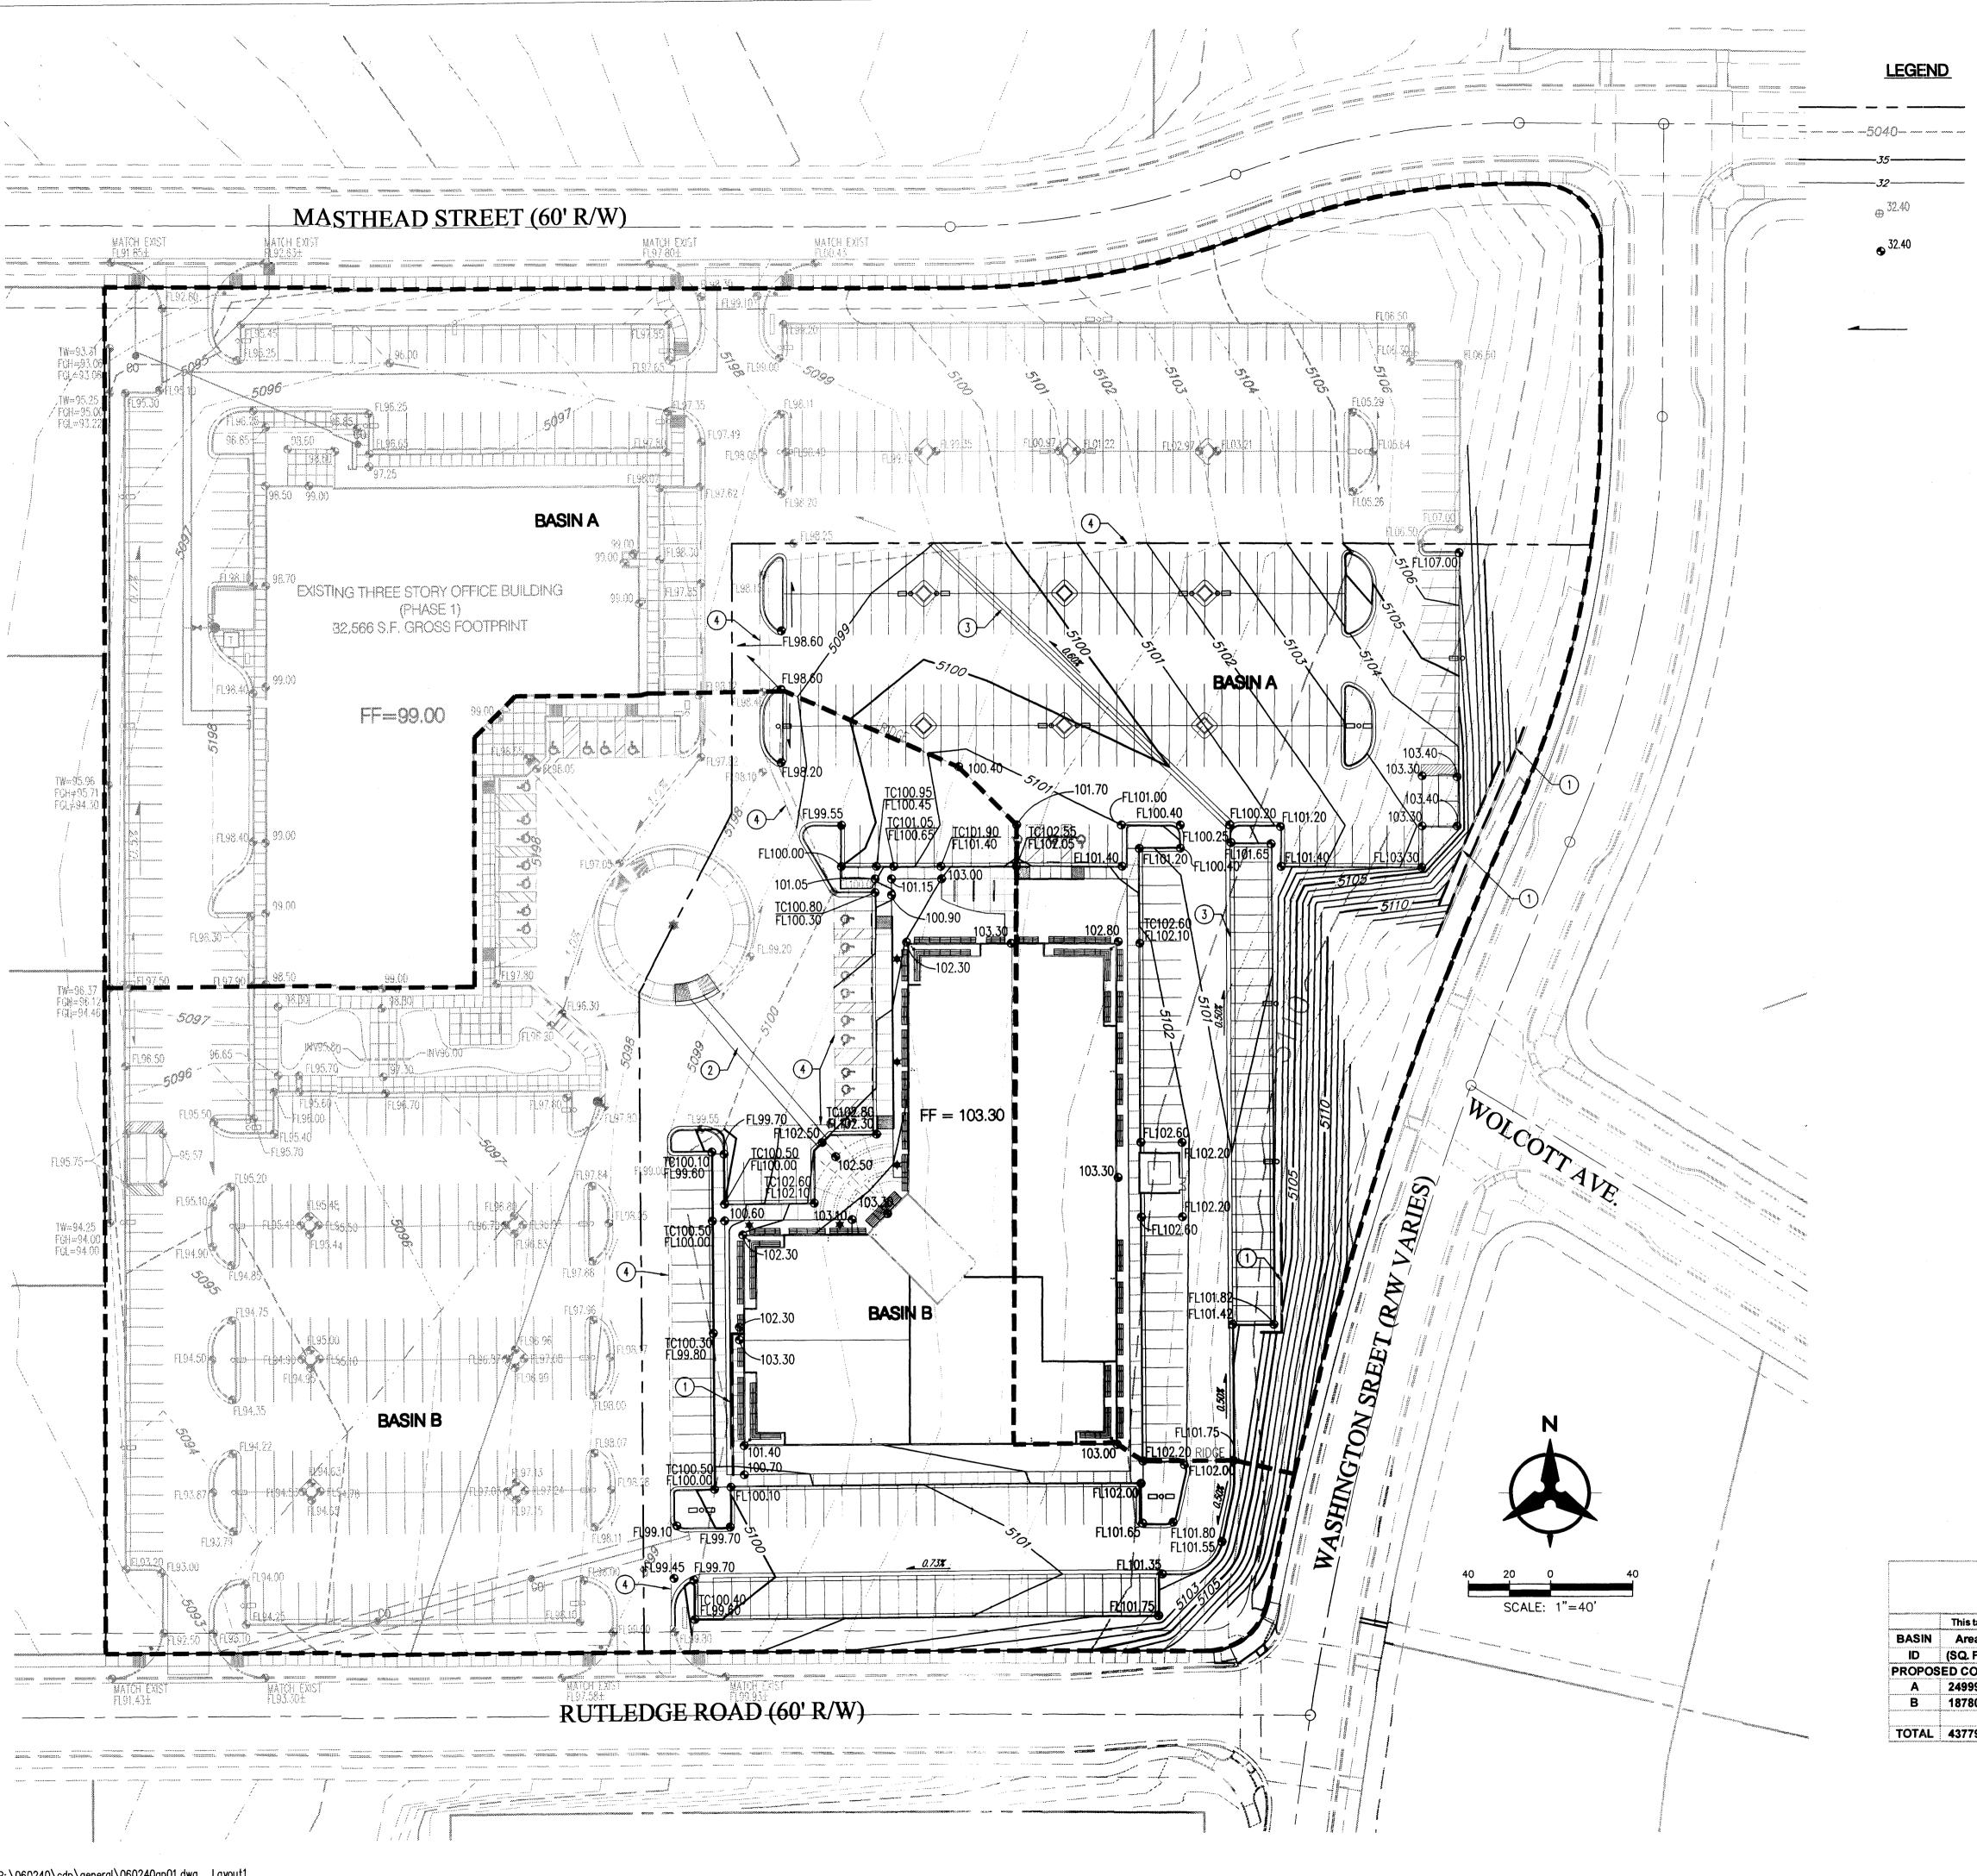

GRADING NOTES

EXISTING CONTOUR

FL = FLOWLINE

TS = TOP OF SIDEWALK

TW = TOP OF WALL

DIRECTION OF FLOW

PROPOSED INDEX CONTOUR

EXISTING SPOT ELEVATION

PROPOSED SPOT ELEVATION

FGH = FINISHED GROUND HIGH SIDE

FGL = FINISHED GROUND LOW SIDE

PROPOSED INTERMEDIATE CONTOUR

1. EXCEPT AS PROVIDED HEREIN, GRADING SHALL BE PERFORMED AT THE ELEVATIONS AND IN ACCORDANCE WITH THE DETAILS SHOWN ON THIS PLAN.

2. THE COST FOR REQUIRED CONSTRUCTION DUST AND EROSION CONTROL MEASURES SHALL BE INCIDENTAL TO THE PROJECT COST.

3. ALL WORK RELATIVE TO FOUNDATION CONSTRUCTION, SITE PREPARATION, AND PAVEMENT INSTALLATION, AS SHOWN ON THIS PLAN, SHALL BE CONSTRUCTED IN ACCORDANCE WITH THE "GEOTECHNICAL INVESTIGATION," AS PROVIDED BY THE ARCHITECT OR OWNER. ALL OTHER WORK SHALL, UNLESS OTHERWISE STATED OR PROVIDED FOR HEREON, BE CONSTRUCTED IN ACCORDANCE WITH THE PROJECT, (FIRST PRIORITY) SPECIFICATIONS, AND/OR THE CITY OF ALBUQUERQUE (COA) STANDARD SPECIFICATIONS FOR PUBLIC WORKS (SECOND PRIORITY).

4. EARTH SLOPES SHALL NOT EXCEED 3 HORIZONTAL TO 1 VERTICAL UNLESS SHOWN OTHERWISE.

5. IT IS THE INTENT OF THESE PLANS THAT THIS CONTRACTOR SHALL NOT PERFORM ANY WORK OUTSIDE OF THE PROPERTY BOUNDARIES EXCEPT AS REQUIRED BY THIS PLAN.

6. THE CONTRACTOR IS TO ENSURE THAT NO SOIL ERODES FROM THE SITE ONTO ADJACENT PROPERTY OR PUBLIC RIGHT—OF—WAY. THIS SHOULD BE ACHIEVED BY CONSTRUCTING TEMPORARY BERMS OR SILT FENCE AT THE PROPERTY LINES AND WETTING THE SOIL TO PROTECT IT FROM WIND EROSION.

7. A DISPOSAL SITE FOR ANY & ALL EXCESS EXCAVATION MATERIAL, AND UNSUITABLE MATERIAL AND/OR A BORROW SITE CONTAINING ACCEPTABLE FILL MATERIAL SHALL BE OBTAINED BY THE CONTRACTOR IN COMPLIANCE WITH APPLICABLE ENVIRONMENTAL REGULATIONS AND APPROVED BY THE OBSERVER. ALL COSTS INCURRED IN OBTAINING A DISPOSAL OR BORROW SITE AND HAUL TO OR FROM SHALL BE CONSIDERED INCIDENTAL TO THE PROJECT AND NO SEPARATE MEASUREMENT OR PAYMENT SHALL BE MADE.

8. PAVING AND ROADWAY GRADES SHALL BE +/- 0.1' From Plan Elevations. Pad Elevation Shall be +/- 0.05' from Building Plan Elevation.

9. ALL PROPOSED CONTOURS REFLECT TOP OF PAVEMENT ELEVATIONS IN THE PARKING AREA AND MUST BE ADJUSTED FOR MEDIANS AND ISLANDS.

10. VERIFY ALL ELEVATIONS SHOWN ON PLAN FROM BASIS OF ELEVATION CONTROL STATION PRIOR TO BEGINNING CONSTRUCTION.

○ <u>KEYED NOTES</u>

1. 4' HIGH ± MASONRY RETAINING WALL. SEE DETAIL, SHEET C1.2

2. 2% MAXIMUM CROSS-SLOPE AT SIDEWALK CROSSING.

3. CONCRETE VALLEY GUTTER, REFER TO SITE PLAN.

4. MATCH EXISTING PAVEMENT.

DRAINAGE MANAGEMENT PLAN

I. INTRODUCTION

The purpose of this submittal is to provide a conceptual Drainage Management Plan and rough grading plan for development of the Masthead Office Complex at Journal Center 2 – Phase 2, located in the Journal Center, Phase 2, Unit 2, Lot 11-B in NE Albuquerque.

II. SITE LOCATION

The site is currently legally described as, Journal Center, Phase 2, Unit 2, Lot 11-B (+/- 4.4 acres). The site is located within zone atlas map #M-21, and is in hydrologic zone 2. The site is located at the southwest comer of Masthead and Washington, just west of Jefferson.

III. EXISTING HYDROLOGIC CONDITIONS

Currently the site (4.4 ac.) is undeveloped land. The surrounding streets and infrastructure are in place and Phase 1 of the development is currently under construction. The site drains from east to west in a sheet flow condition. Per the approved Drainage Plan of Journal Center – Phase 2 located in file number D17/D3AA, this site has been approved as a fully developed site and can drain to both Masthead and Rutledge via. surface flow out of the driveways. Both Masthead and Rutledge drain to the west of the site where the drainage is collected in an underground drainage system.

IV. PROPOSED HYDROLOGIC CONDITIONS

The proposed conditions for the Masthead Office Complex at Journal Center 2 are shown on this Conceptual Grading Plan. The hydrologic analysis for this area is based on drainage requirements for the 100-yr, 6-hr storm event. The total site (+/- 10.0 acres) will generate a total of 44.45 cfs under newly developed conditions and consists of approximately 85% D land treatment. Flows will be conveyed to Masthead and Rutledge by surface and curb and gutters. This split flow will travel west in both roadways to a common existing underground drainage system. This drainage system then flows north to the North Pino Arroyo, and then to the AMAFCA North Diversion Channel. Approximately 19.07 cfs drains to Rutledge; the other 25.38 cfs drains to Masthead.

V. CONCLUSION

This drainage management plan provides for grading and drainage elements which are capable of safely passing the 100 year storm and which meet city requirements and are in conformance with the previously approved master drainage plan for Journal Center, Phase 2. With this submittal we are requesting conceptual grading and drainage plan approval for building permit and rough grading approval.

		***********************		US	FORES	T SERV	ICE BUILE	DING	n felikanakan selapi katalah kenassa salas salas sa	***************************************	***************************************
				Pro	posed Co	onditions l	Basin Data 1	Table			
	This table	is based	on the DP	M Section	22.2, Zone:	2		000000000000000000000000000000000000000	ritadishto kasa usabara saburibahuni usu ugu usa	***************************************	***************************************
BASIN	Area	Area	Land	d Treatm	ent Perce	ntages	Q(100)	Q(100)	WTE	V(100) ₃₆₀	V(100) ₁₄₄₀
ID	(SQ. FT)	(AC.)	Α	В	С	D	(cfs/ac.)	(csf)	(inches)	(CF)	(CF)
PROPOS	ED COND	ITIONS					******************************	ooroonooniin oo	:		······································
A	249990	5.74	0.0%	5.0%	10.0%	85.0%	4.42	25.38	1.95	40707	48852
В	187807	4.31	0.0%	5.0%	10.0%	85.0%	4.42	19.07	1.95	30581	36701
TOTAL	437797	10.05	-	-	-	-	4.42	44.45	3.91	71287.94	71288

Bohannan 🛦 Huston 🛚


Courtyard I 7500 Jefferson St. NE Albuquerque, NM 87109-4335
ENGINEERING & SPATIAL DATA & ADVANCED TECHNOLOGIES



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ARCHITECT

CONSULTANT

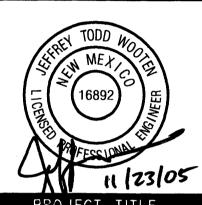

MEXICO STATE TO

MASTHEAD OFFICE COMPLEX AT JOURNAL CENTER 2

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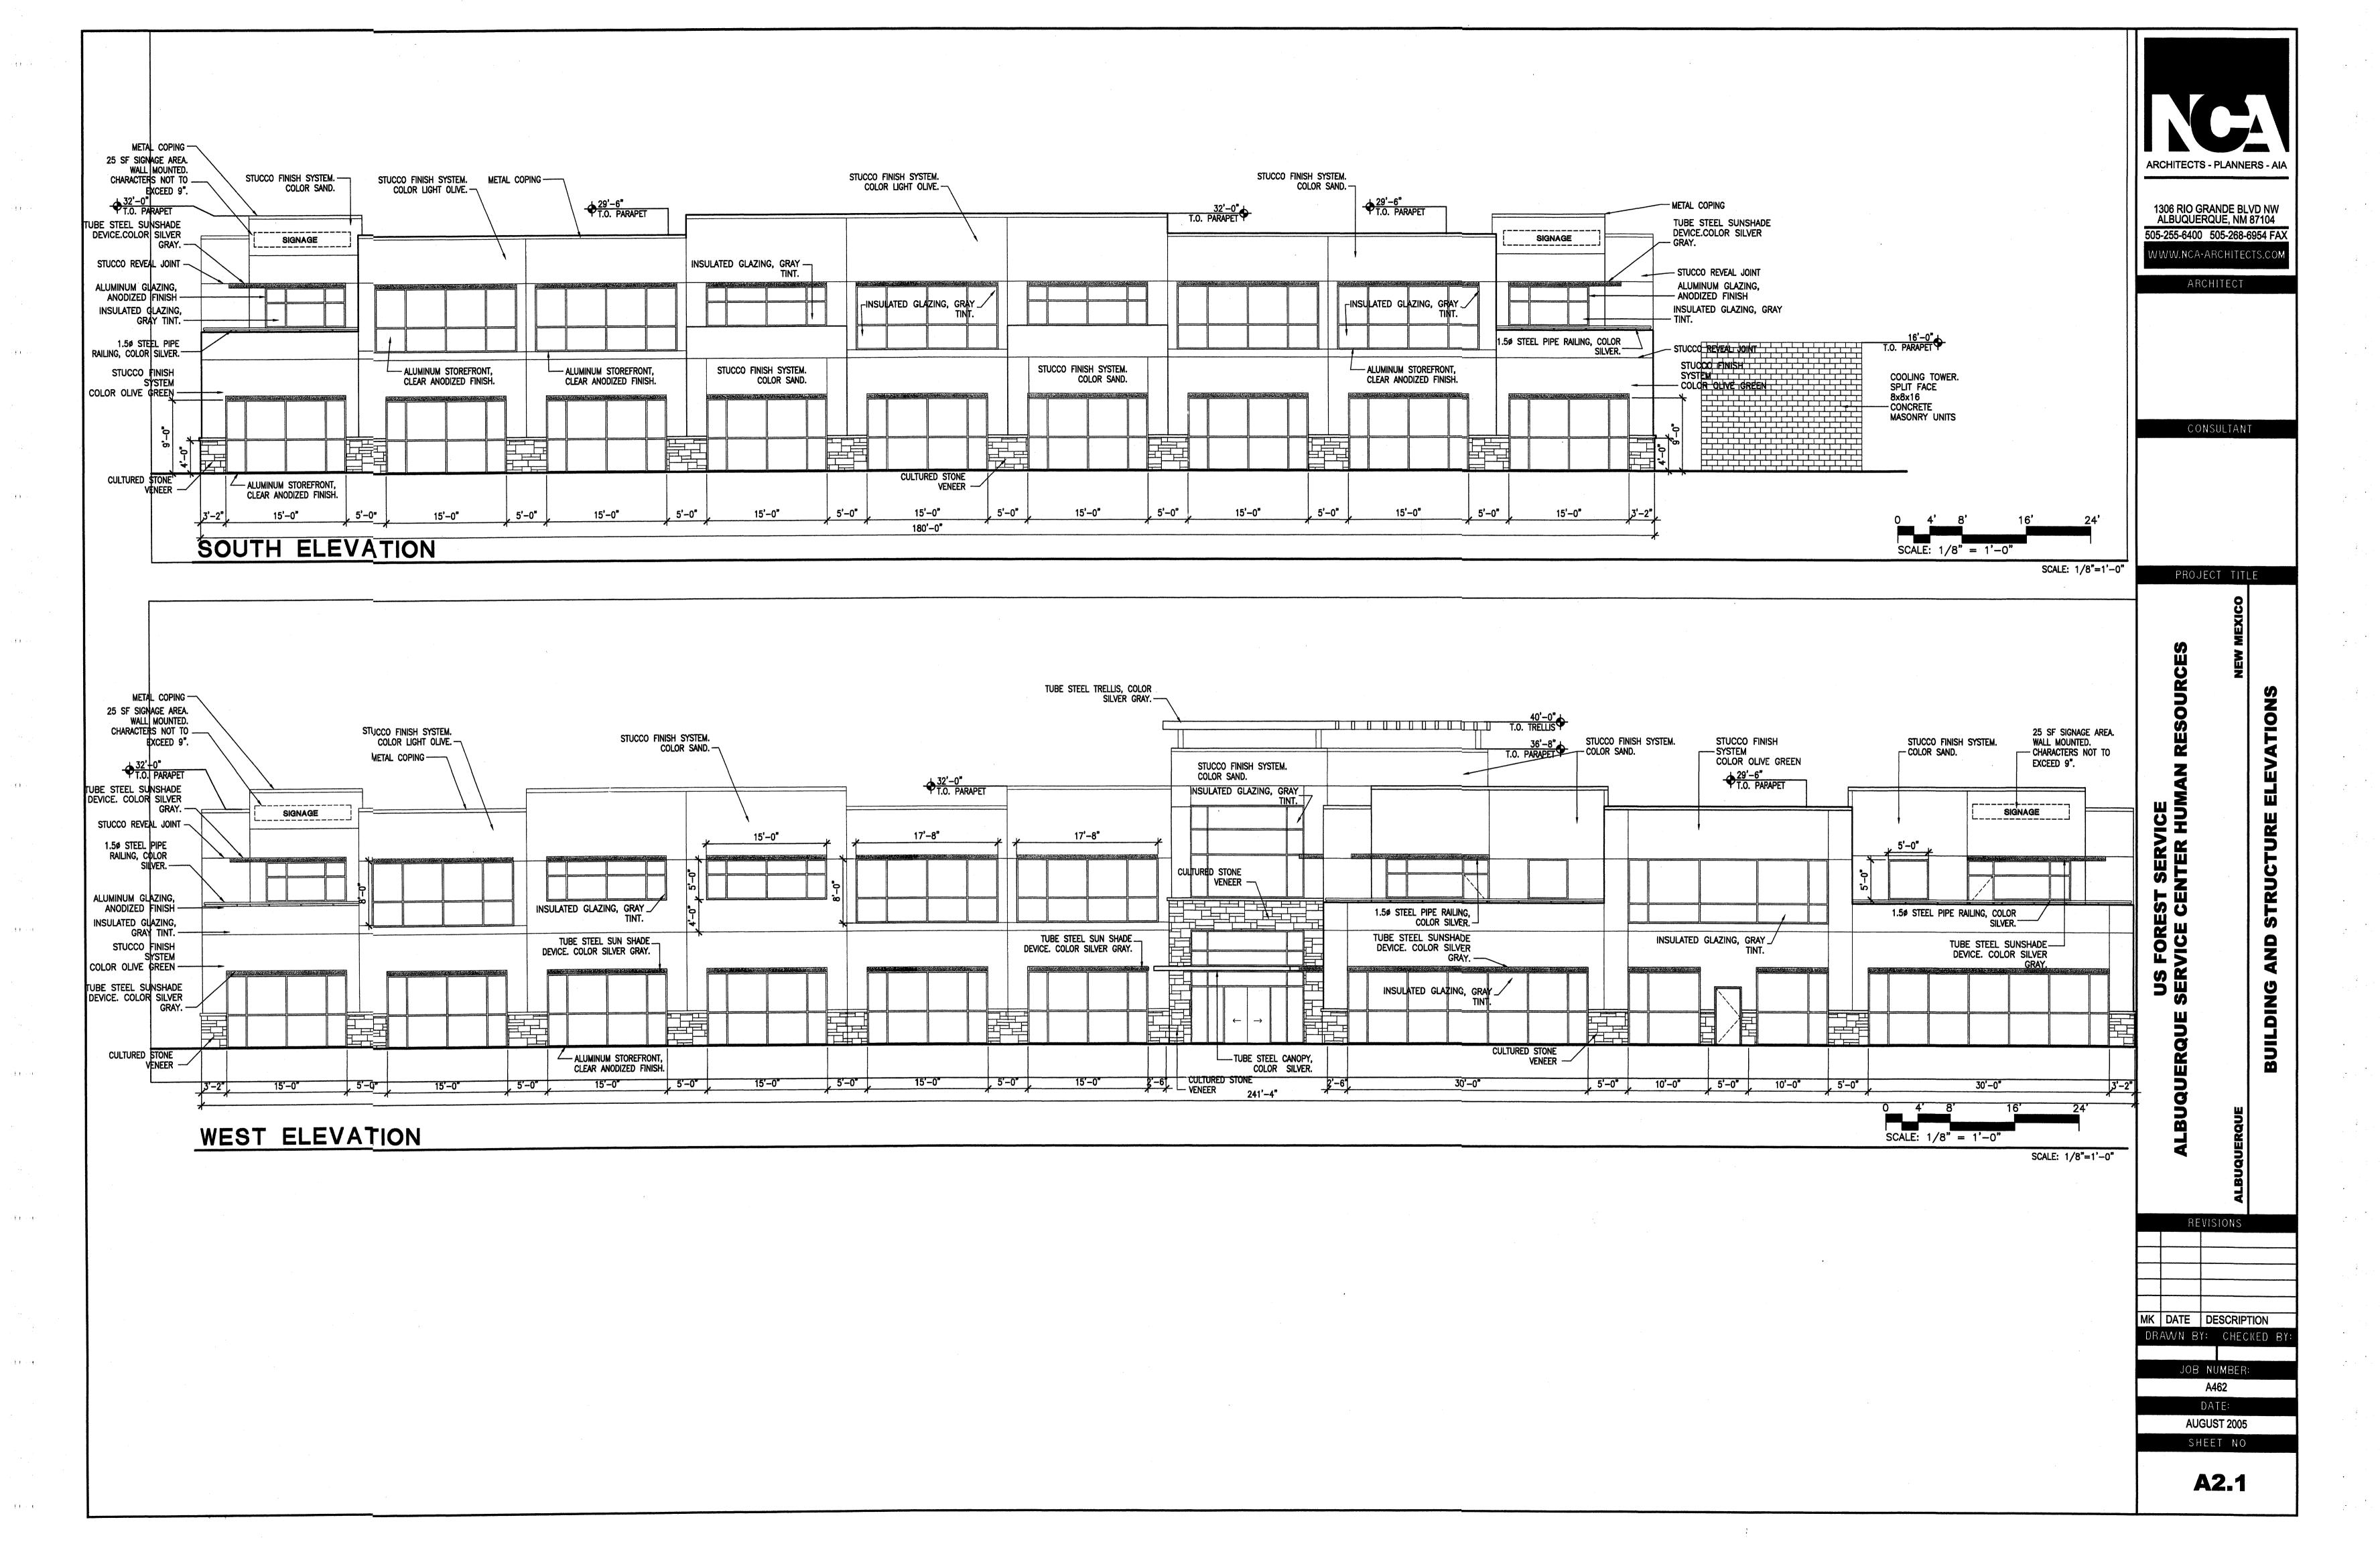
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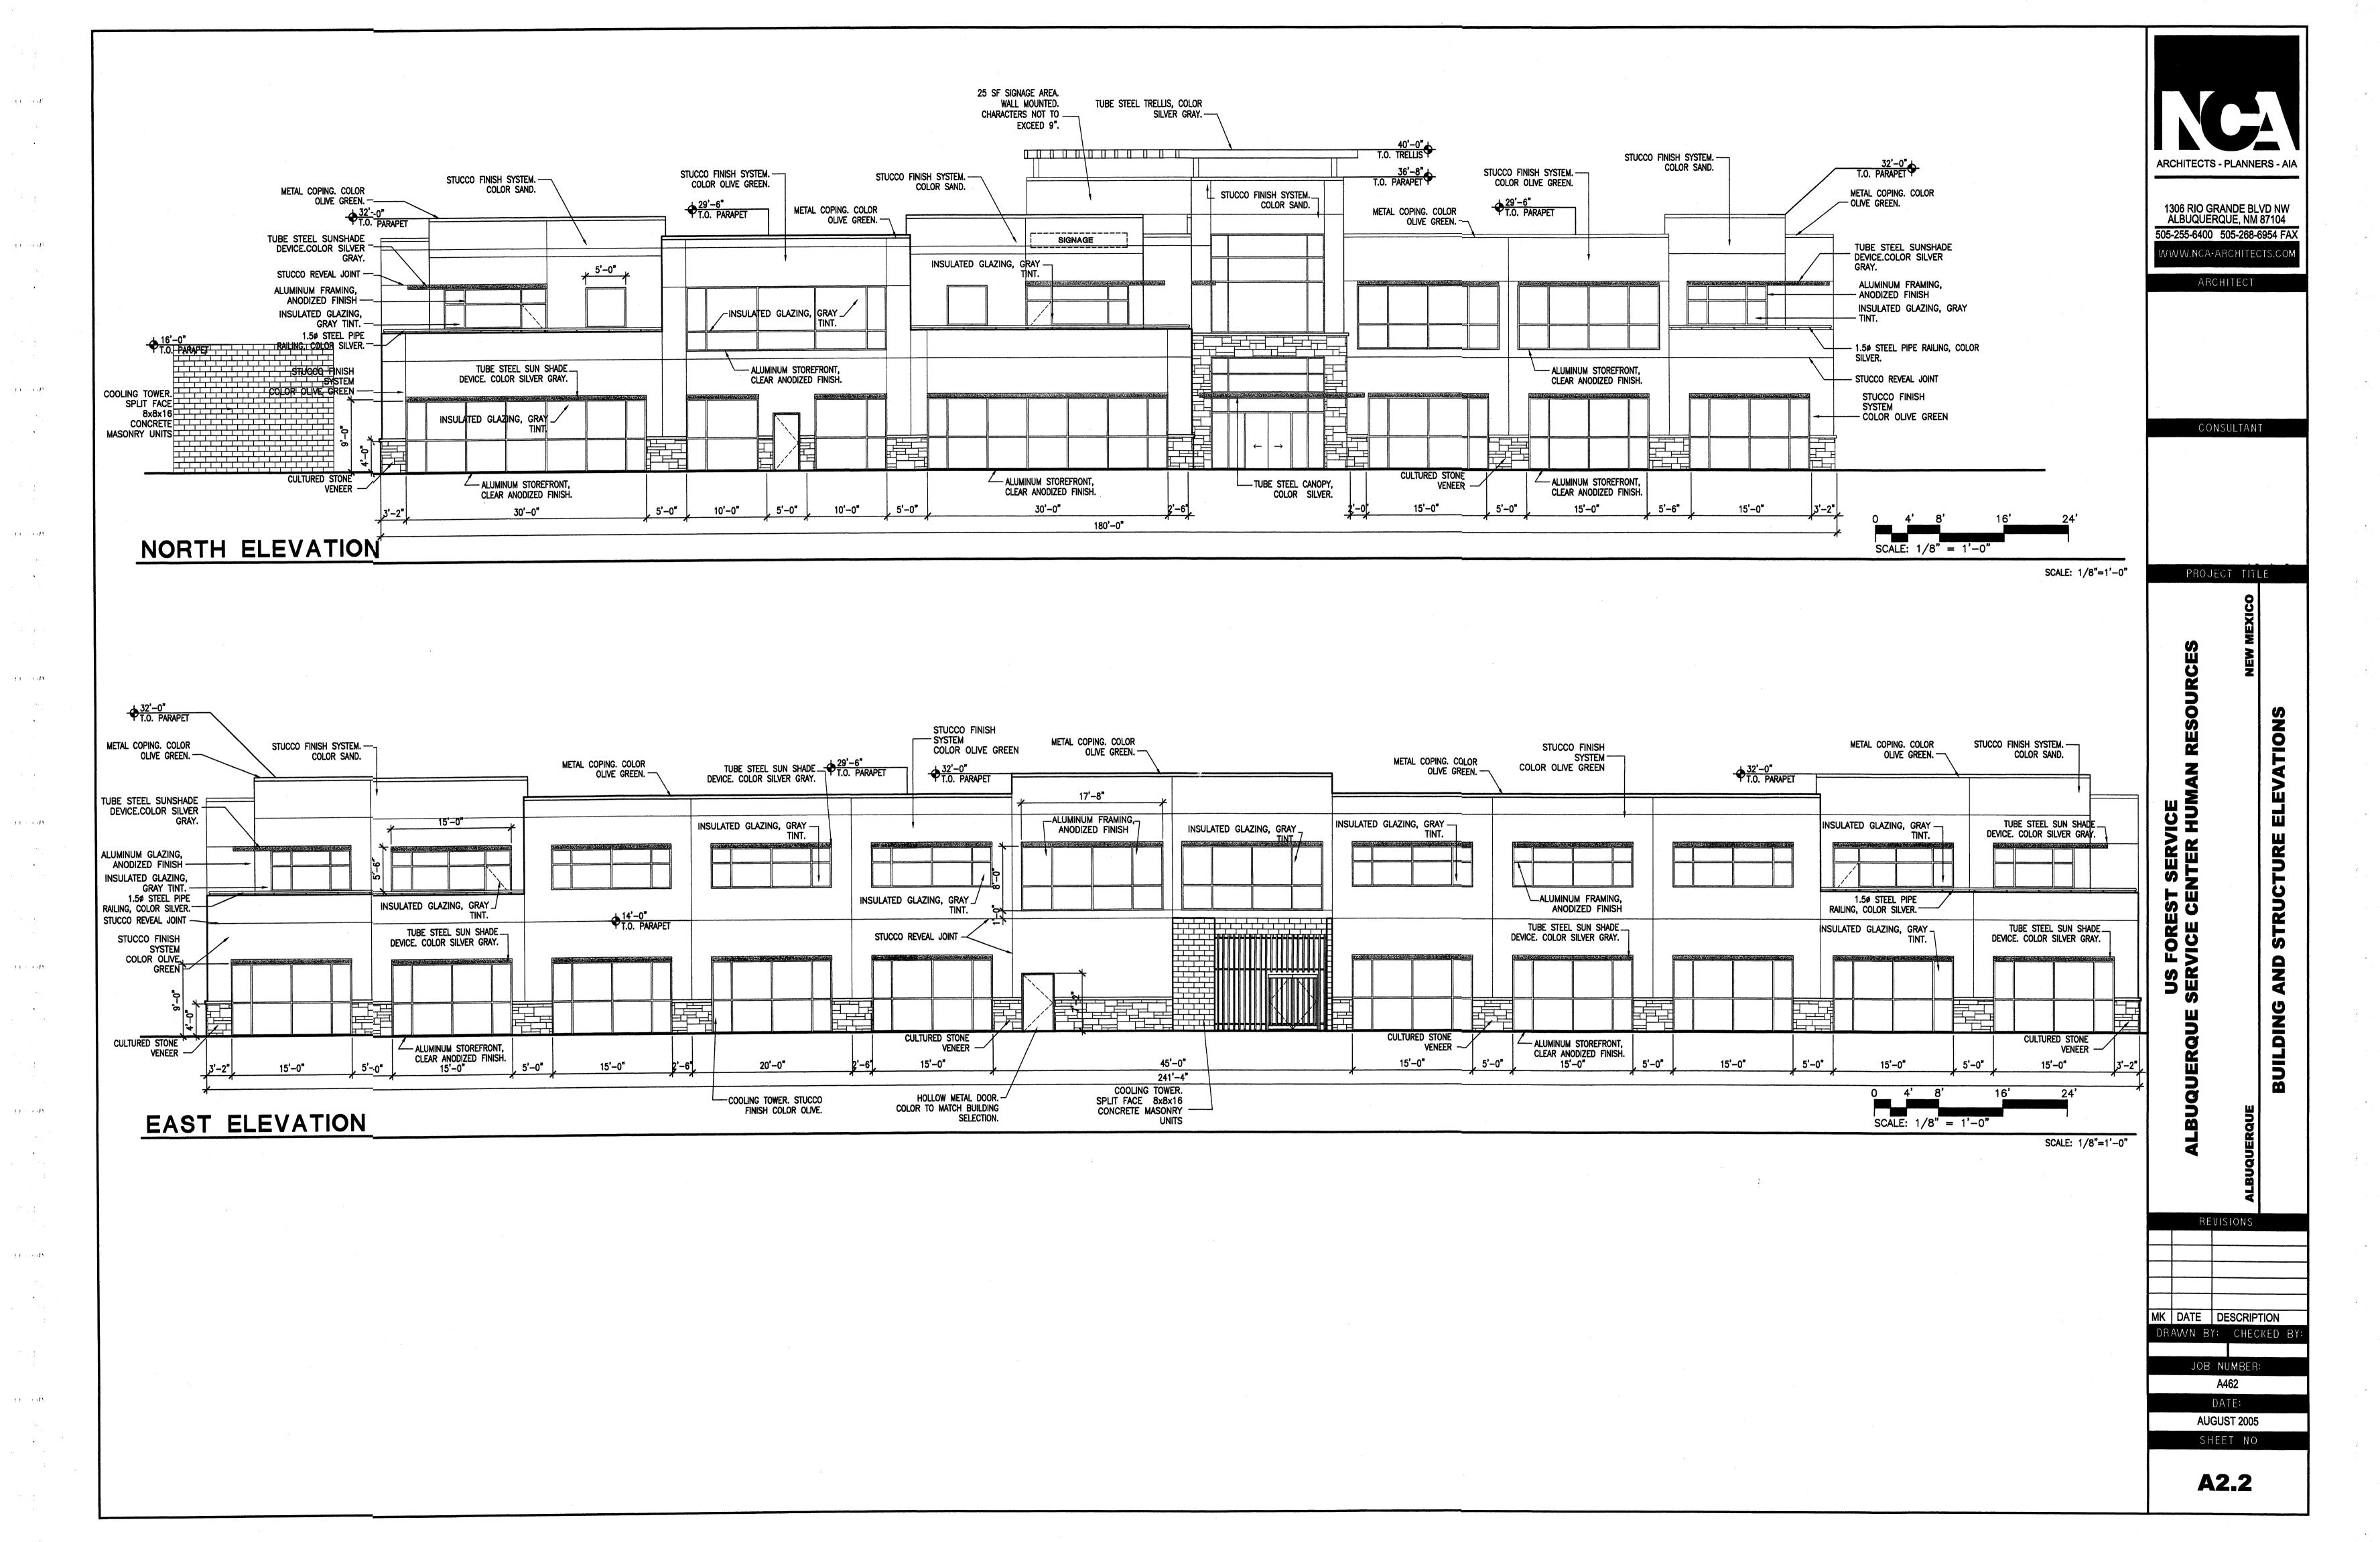
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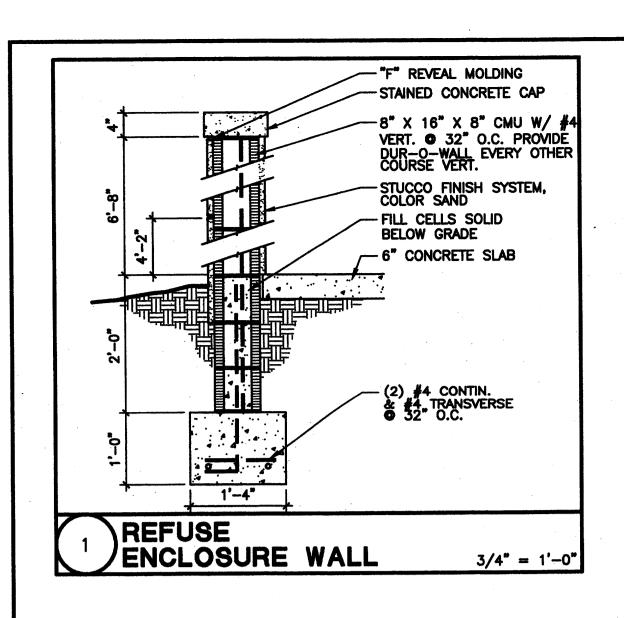
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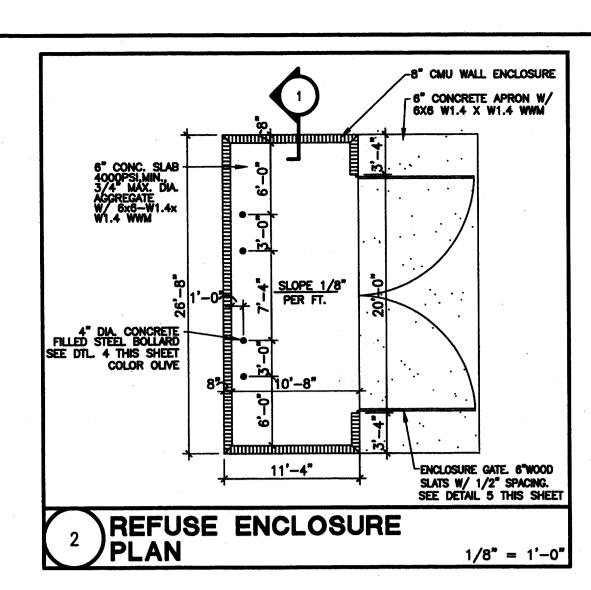
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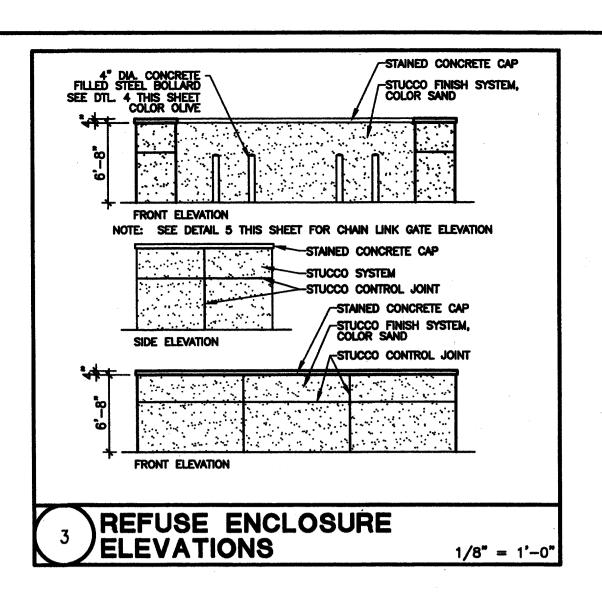
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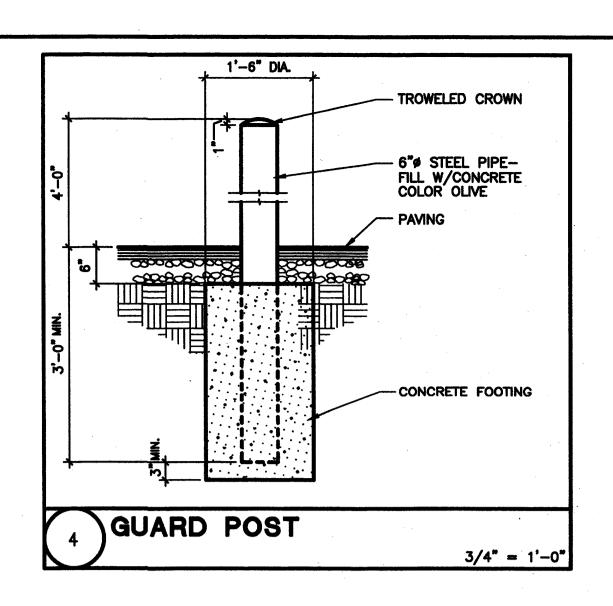













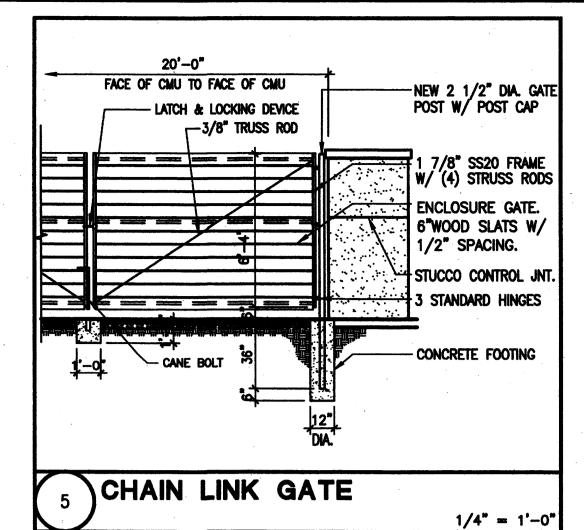



ALL SPLIT FACE MASONRY UNITS AND STUCCO COLORS TO MATCH AND HARMONIZE WITH THE BUILDING'S OVERALL COLOR SCHEME.


ALBUQUERQUE

REFUSE ENCLOSURE AND SITE DETAILS

MK DATE DESCRIPTION

NOVEMBER 2005

AS1.1

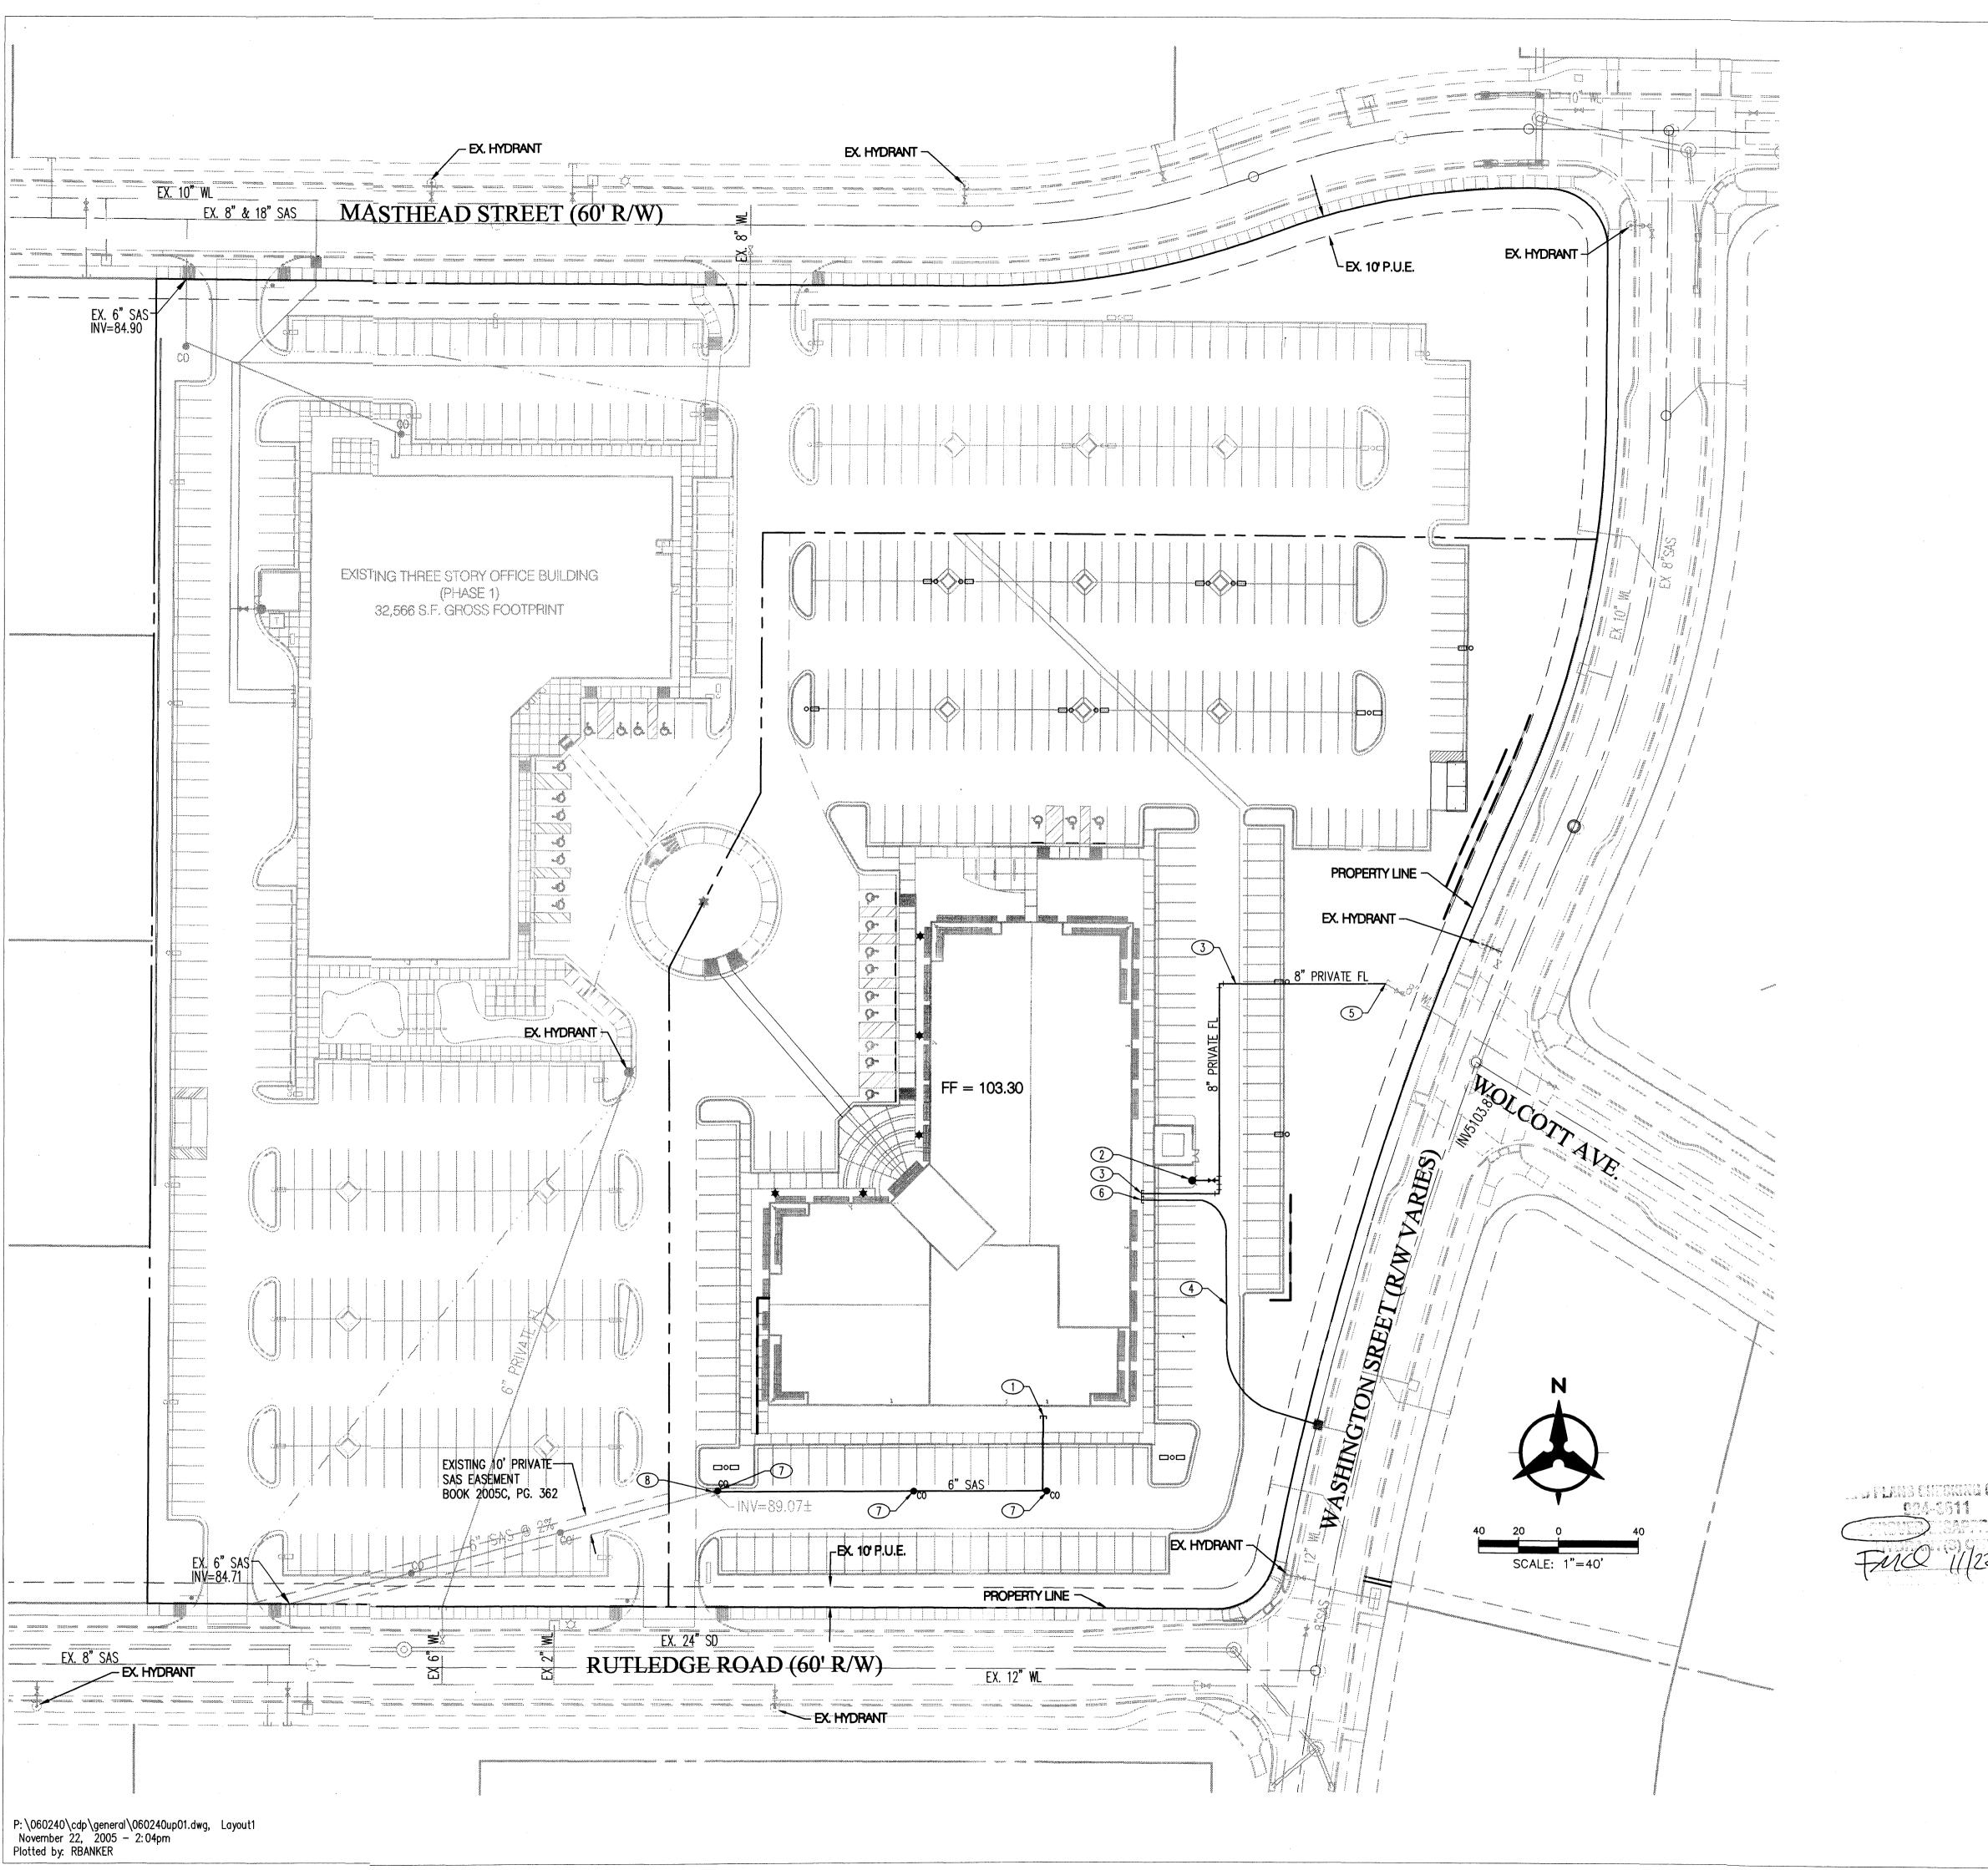

UTILITY NOTES

1. THIS CONTRACTOR SHALL BE RESPONSIBLE FOR THE COMPLETE INSTALLATION OF ALL WORK RELATED TO MECHANICAL UTILITIES AS SHOWN ON THIS PLAN INCLUDING: TRENCHING, BACKFILL, SUPPORTS, CLEANOUT PADS, SERVICE STOPS AND BOXES, SERVICE LINES, TESTING, CLEANING, AND STERILIZING. ANY WORK NOT ACCEPTED BY THE ARCHITECT OR ENGINEER DUE TO IMPROPER WORKMANSHIP OR LACK OF PROPER COORDINATION SHALL BE REMOVED AND CORRECTLY INSTALLED AT THE CONTRACTOR'S EXPENSE, AS

2. MINIMUM DEPTHS OF COVER SHALL BE: 36" FOR WATERLINES AND 48" FOR SEWER, EXCEPT AT BUILDING CONNECTION.

3. ALL WORK DETAILED ON THESE PLANS TO BE PERFORMED UNDER CONTRACT SHALL, EXCEPT AS OTHERWISE STATED OR PROVIDED OF HEREON, BE CONSTRUCTED IN ACCORDANCE WITH THE IAPMO UNIFORM PLUMBING CODE, LATEST EDITION.

4. UTILITY LINES SHALL BE INSTALLED PRIOR TO PAVEMENT, CURB AND GUTTER, AND/OR SIDEWALK, AS

5. ROUGH GRADING OF SITE (±0.5') SHALL BE COMPLETED PRIOR TO INSTALLATION OF UTILITY LINES.

6. CONTRACTOR WILL BE RESPONSIBLE FOR CONNECTIONS TO BUILDING DRAIN LINES AND ALL NECESSARY

7. ALL VALVES SHALL BE ANCHORED PER COA STANDARD DWG. 2333.

8. FIRE LINES SHALL USE PIPE MATERIALS UNDERWRITERS LABORATORIES LISTED AND APPROVED FOR FIRE

9. CONTRACTOR SHALL BE RESPONSIBLE FOR ALL WATER METER, FIRE LINE, AND SEWER HOOKUP FEES FOR INSTALLATIONS. OWNER SHALL BE RESPONSIBLE FOR UTILITY EXPANSION CHARGES, PRORATA AND OTHER SPECIAL ASSESSMENTS.

10. CONTRACTOR SHALL VERIFY INVERTS AND LOCATIONS OF EXISTING WATER/SAS LINES PRIOR TO BEGINNING WORK. ALL CONFLICTS SHALL BE BROUGHT TO ATTENTION OF THE ENGINEER AND RESOLVED PRIOR TO BEGINNING WORK.

UTILITY KEYED NOTES

- 1. 6" SANITARY SEWER STUB
- 2. NEW PRIVATE FIRE HYDRANT
- 3. 8" PRIVATE FIRE LINE SERVICE FOR BUILDING SPRINKLERS. BACKFLOW PREVENTER TO BE INSTALLED INSIDE MECHANICAL ROOM. FDC TO BE LOCATED ON BUILDING WALL.

4. NEW 1 1/2" METERED WATER SERVICE. CONNECT TO EXISTING 2" WATER LINE STUB OUT.

5. CONNECTION TO EXISTING 8" FIRE LINE STUB

6. NEW 1 1/2" DOMESTIC WATER SERVICE TO BUILDING, BACKFLOW PREVENTER SHALL BE INSIDE MECHANICAL ROOM.

7. SANITARY SEWER CLEANOUT

8. CONNECT TO EX. 6" SAS STUB PROVIDED TO SITE WITH PHASE 1.

LEGEND

	- PROPERTY LINE
EX. 8" SAS	EX SANITARY SEWER & MANHOL
EX. 24" SD	EX STORM DRAIN & MANHOLE
	ex inlet
EX. 12" WL	EX WATER LINE
*	EX VALVE
O	ex meter
Ø	ex fire hydrant
χ̈́X	EX STREET LIGHT
SAS	- PROPOSED SANITARY SEWER
● _{co}	PROPOSED CLEANOUT
WL	- PROPOSED WATERLINE

Bohannan \land Huston

ENGINEERING & SPATIAL DATA & ADVANCED TECHNOLOGIES



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