


interiors planning



Mr. Walter Spill

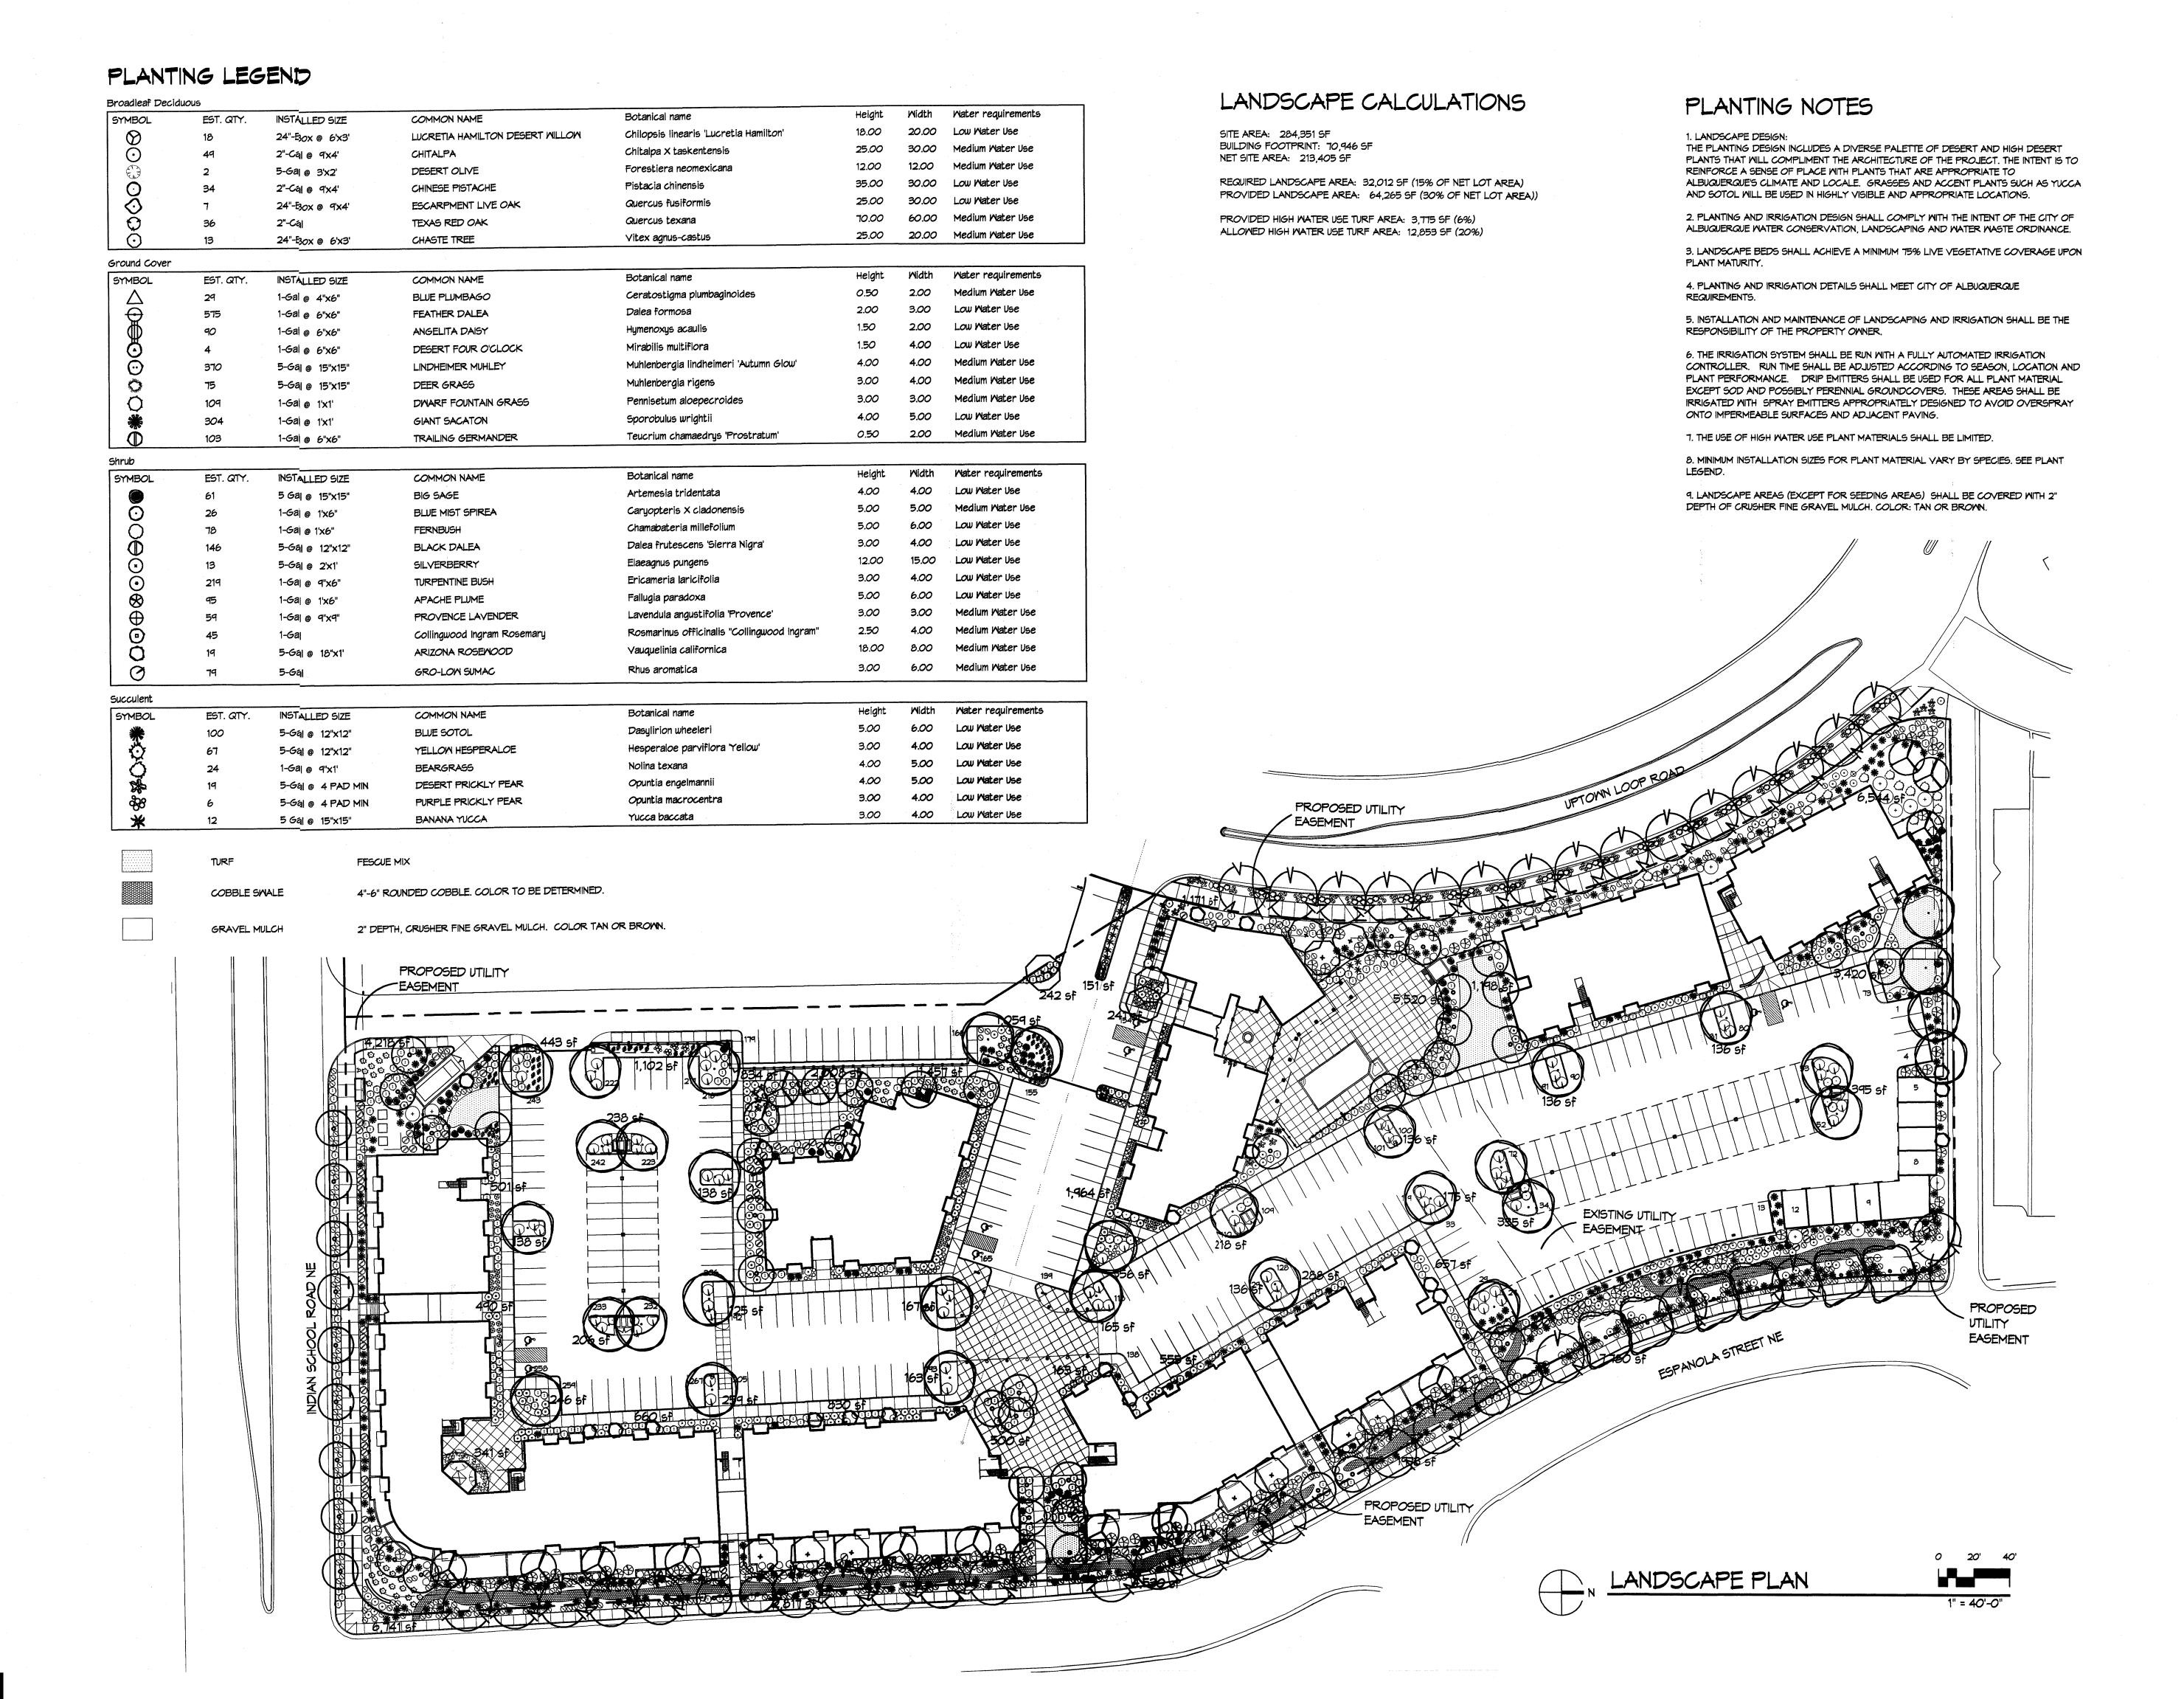

architectur interior Plannin engineerin

Dekker Perich Sabatini

> 6801 Jefferson NE Suite 100 Albuquerque, NM 8710! 505761-9700 fax 761-4222 dps@dpsabq.com

ARCHITECT

ENGINEER


PIOWN VILLAGO Apartments 2220 Uptown Loop Road Albuquerque, New Mexico


DRAWN BY
MC, LB
REVIEWED BY
MC
DATE
June 16, 2006
PROJECT NO.
DRAWING NAME


LANDSCAPE PLAN


SHEET NO.


L001

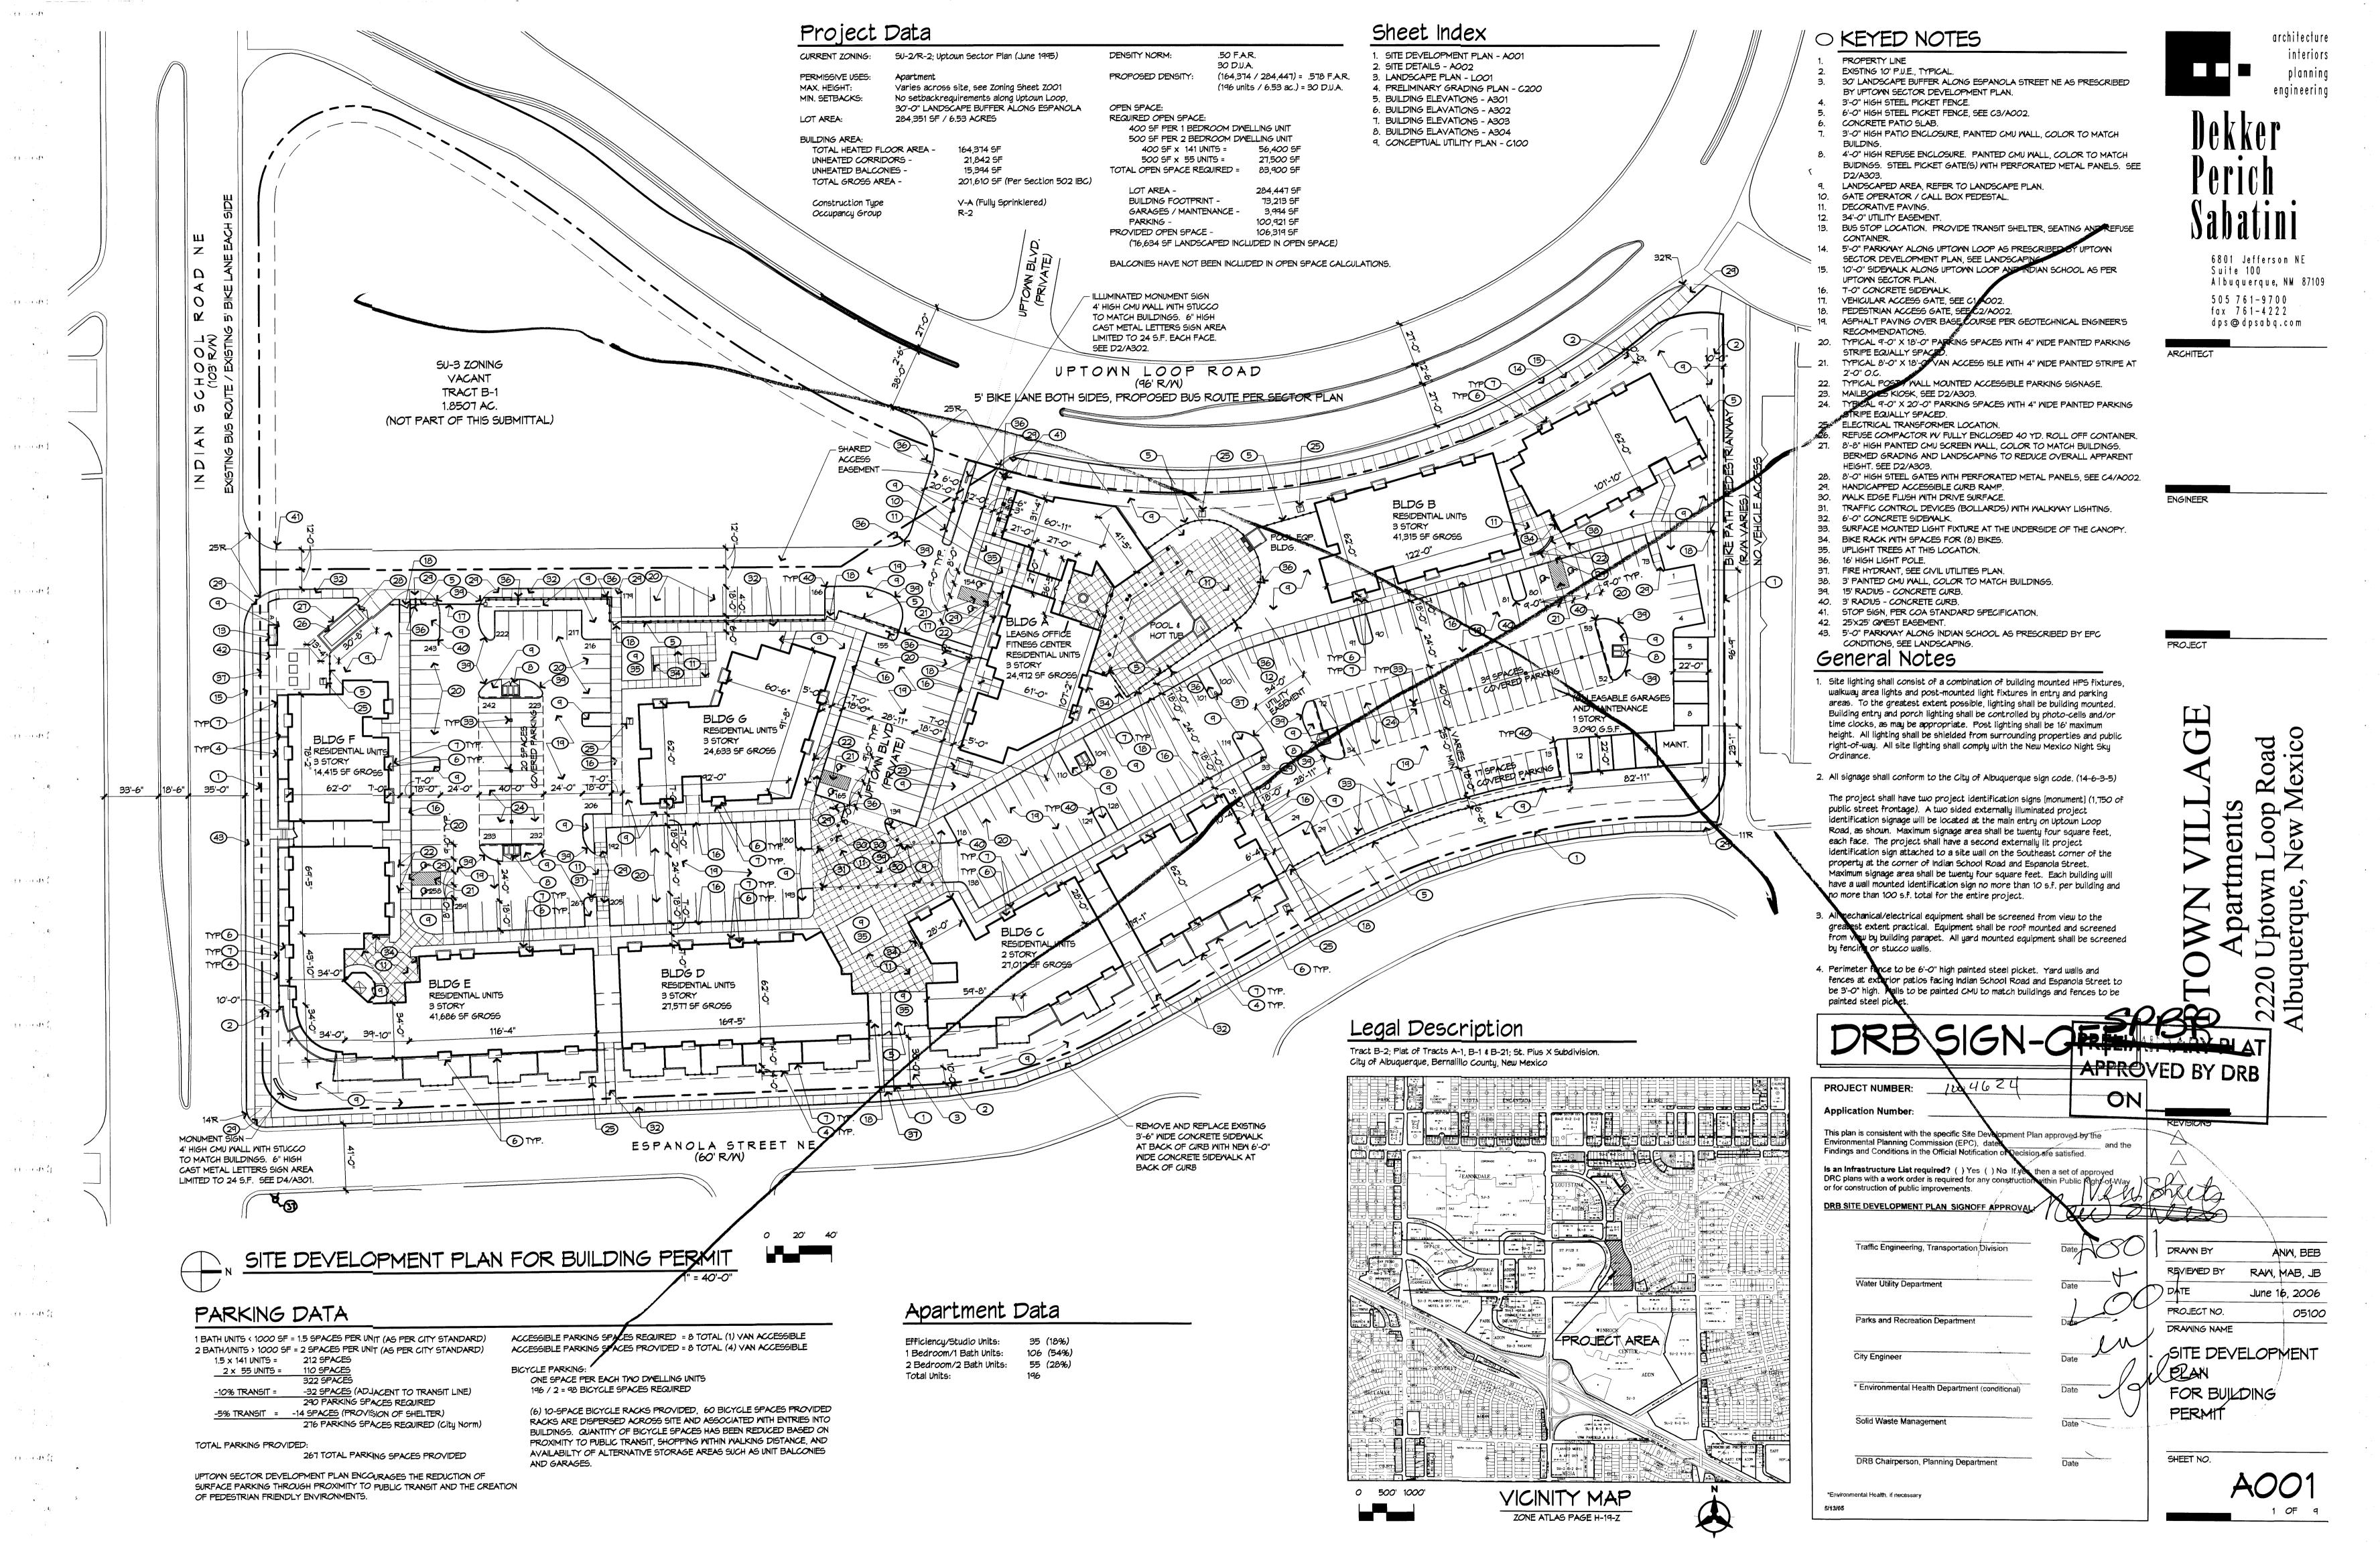


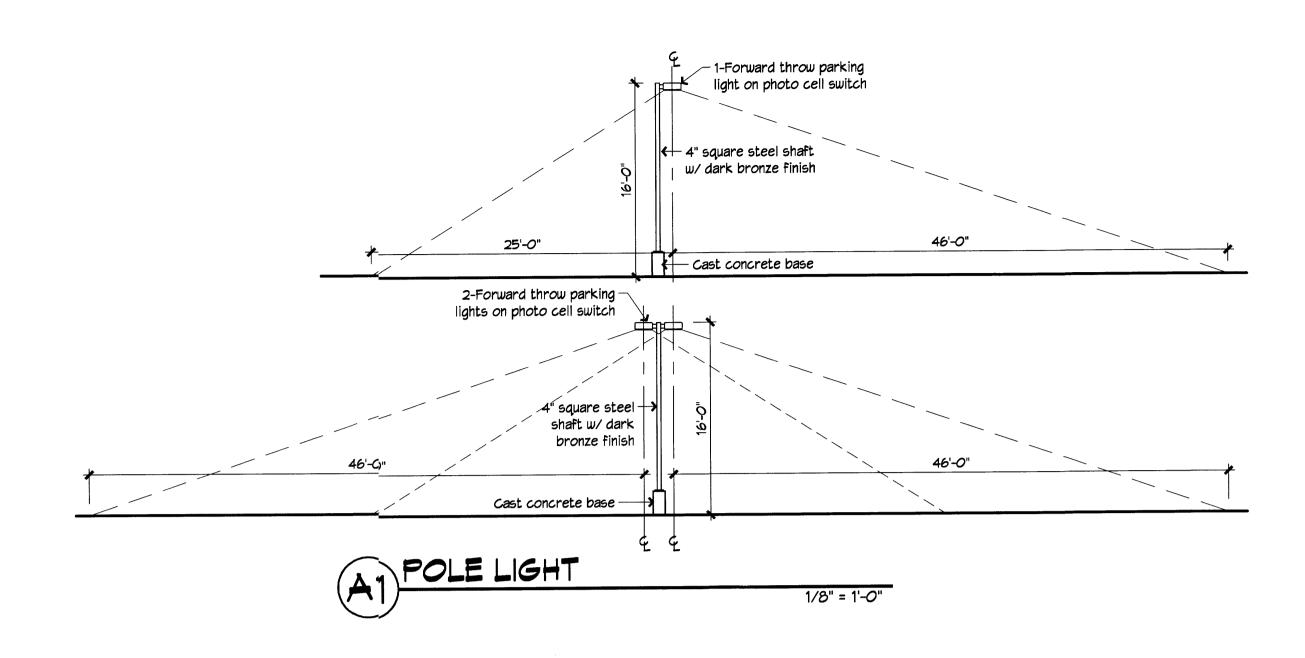


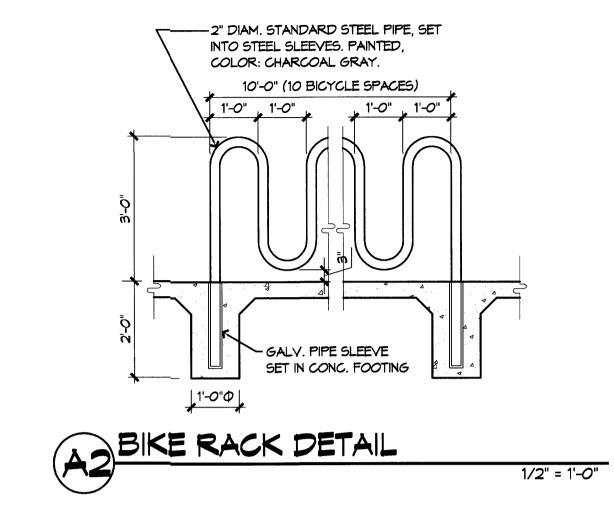

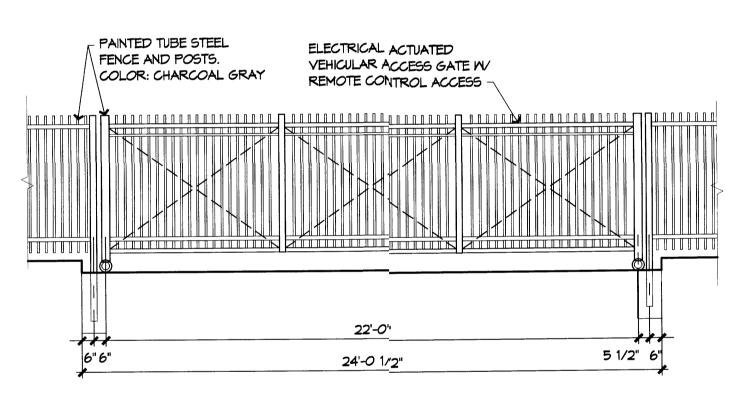

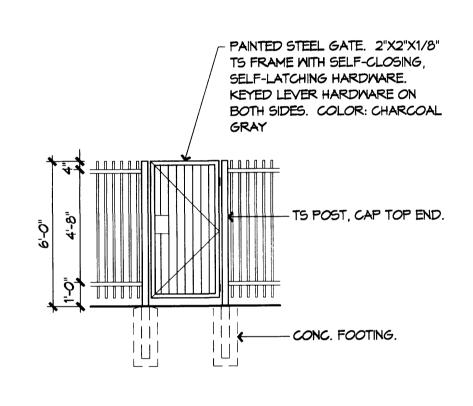

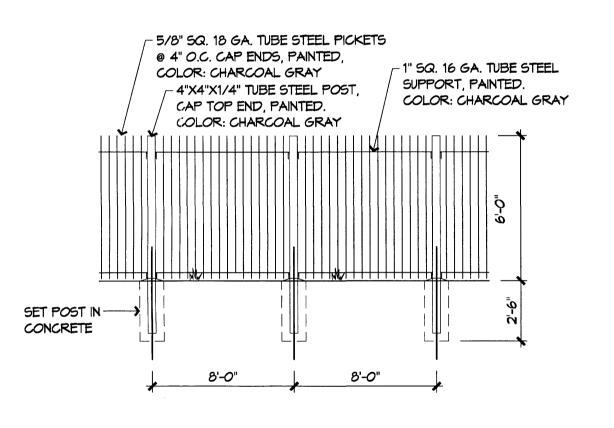

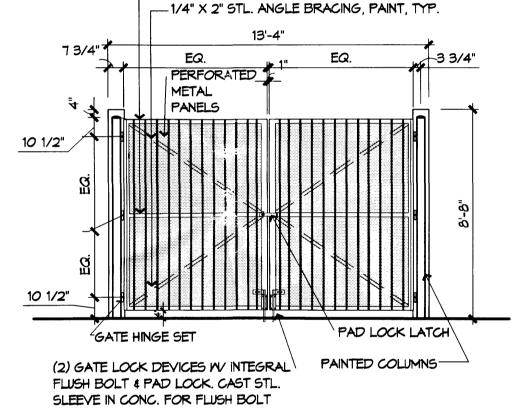


— 1/4" X 3" X 2" STL. ANGLES, WELDED CONNECTIONS, PAINT, TYPICAL




At the state






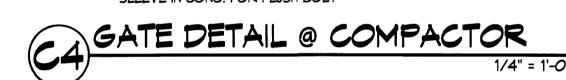

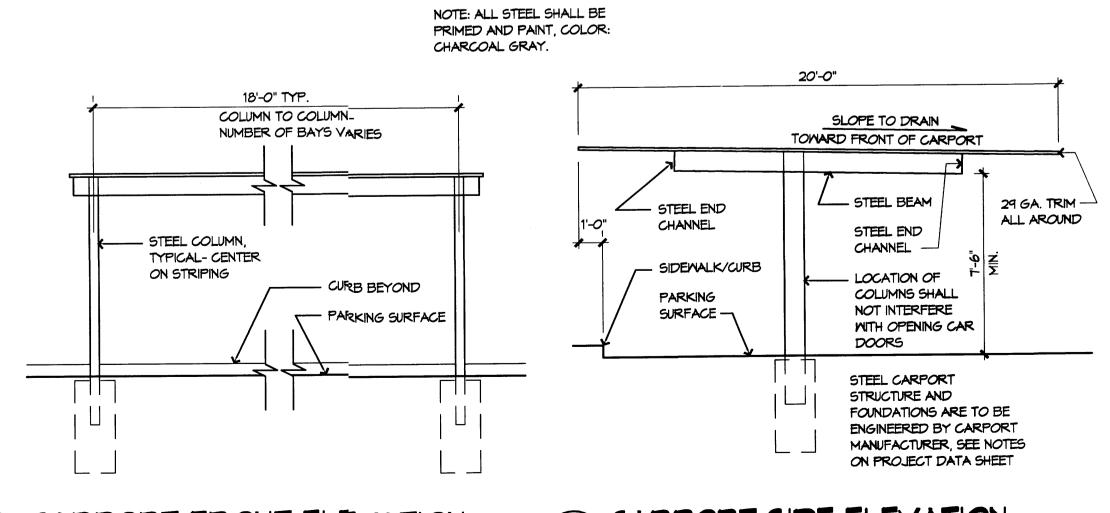



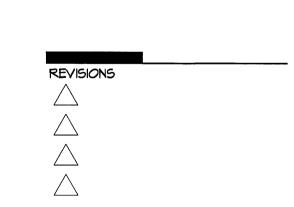

ents

oop

architecture

6801 Jefferson NE

dps@dpsabq.com

Albuquerque, NM 87109

Suite 100

505 761-9700 fax 761-4222

interiors

DRAWN BY	ANM, BEE
REVIEWED BY	RAW, MAB, JE
DATE	June 16, 2008
PROJECT NO.	0510

SITE DETAILS

DRAWING NAME



PLANTING NOTES PLANTING LEGEND LANDSCAPE CALCULATIONS Mater requirements Height Midth THE PLANTING DESIGN INCLUDES A DIVERSE PALETTE OF DESERT AND HIGH DESERT PLANTS THAT WILL COMPLIMENT THE RCHITECTURE OF THE PROJECT. THE INTENT IS TO Broadleaf Deciduous Botanical name SITE AREA: 284,351 SF COMMON NAME Low Water Use INSTALLED SIZE EST. QTY. Chilopsis linearis 'Lucretia Hamilton' REINFORCE A SENSE OF PLACE WITH PLANTS THAT ARE APPROPRIATE TO ALBUQUERQUE'S CLIMATE AND LOCALE. GRASSES AND ACCENT PLANTS SUCH AS YUCCA AND SOTOL WILL BE USED IN HIGHLY VISIBLE AND APPROPRIATE LOCATIONS. SYMBOL BUILDING FOOTPRINT: 70,946 SF LUCRETIA HAMILTON DESERT WILLOW Medium Water Use NET SITE AREA: 213,405 SF 24"-Box @ 6'x3' Chitalpa X taskentensis CHITALPA Medium Water Use 2"-Cal @ 9'x4' REQUIRED LANDSCAPE AREA: 32,012 SF (15% OF NET LOT AREA) Forestiera neomexicana PROVIDED LANDSCAPE AREA: 64,265 SF (30% OF NET LOT AREA)) DESERT OLIVE Low Water Use 5-Gal @ 3'x2' 2. PLANTING AND IRRIGATION DESIGN SHALL COMPLY WITH THE INTENT OF THE CITY OF Pistacia chinensis ALBUQUERQUE WATER CONSTRUCTION, LANDSCAPING AND WATER WASTE ORDINANCE. CHINESE PISTACHE 2"-Cal @ 9'x4' PROVIDED HIGH WATER USE TURF AREA: 3,775 SF (6%) Quercus fusiformis Medium Water Use ESCARPMENT LIVE OAK ALLOWED HIGH WATER USE TURF AREA: 12,853 SF (20%) 3. LANDSCAPE BEDS SHAUL ACHIEVE A MINIMUM 75% LIVE VEGETATIVE COVERAGE UPON 24"-Box @ 9'x4' Quercus texana TEXAS RED OAK Medium Water Use 2"-Cal PLANT MATURITY. Vitex agnus-castus CHASTE TREE 24"-Box @ 6'x3' 4. PLANTING AND IRRUGATION DETAILS SHALL MEET CITY OF ALBUQUERQUE Mater requirements REQUIREMENTS. Ground Cover Botanical name COMMON NAME 5. INSTALLATION AND MAINTENANCE OF LANDSCAPING AND IRRIGATION SHALL BE THE Medium Water Use INSTALLED SIZE SYMBOL EST. QTY. Ceratostigma plumbaginoides RESPONSIBILITY OF THE PROPERTY OWNER. BLUE PLUMBAGO Low Water Use 1-Gal @ 4"x6" Dalea formosa 6. THE IRRESATION SYSTEM SHALL BE RUN WITH A FULLY AUTOMATED IRRIGATION FEATHER DALEA Low Water Use 1-Gal @ 6'x6" CONTROLLER. RUN TIME SHALL BE ADJUSTED ACCORDING TO SEASON, LOCATION AND Hymenoxys acaulis ANGELITA DAISY Low Water Use 1-Gal @ 6''x6" PLANT ERFORMANCE. DRIP EMITTERS SHALL BE USED FOR ALL PLANT MATERIAL Mirabilis multiflora EXCENT SOD AND POSSIBLY PERENNIAL GROUNDCOVERS. THESE AREAS SHALL BE IRRESTED WITH SPRAY EMITTERS APPROPRIATELY DESIGNED TO AVOID OVERSPRAY Medium Water Use DESERT FOUR O'CLOCK 1-6al @ 6'x6" Muhlenbergia lindheimeri 'Autumn Glow' LINDHEIMER MUHLEY Medium Water Use 5-Gal @ 15"x15" 370 NTO IMPERMEABLE SURFACES AND ADJACENT PAVING. Muhlenbergia rigens DEER GRASS Medium Water Use 5-Gal @ 15"x15" Pennisetum aloepecroides 7. THE USE OF HIGH WATER USE PLANT MATERIALS SHALL BE LIMITED. DWARF FOUNTAIN GRASS Low Water Use 1-6al @ 1'x1' 109 sporobulus wrightii 8. MINIMUM INSTALLATION SIZES FOR PLANT MATERIAL VARY BY SPECIES. SEE PLANT GIANT SACATON 2.00 Medium Water Use 1-Gal @ 1'x1' 304 Teucrium chamaedrys 'Prostratum' TRAILING GERMANDER 1-6al @ 6'x6" 103 9. LANDSCAPE AREAS (EXCEPT FOR SEEDING AREAS) SHALL BE COVERED WITH 2" Midth Water requirements DEPTH OF CRUSHER FINE GRAVEL MULCH. COLOR: TAN OR BROWN. Botanical name COMMON NAME Low Water Use INSTALLED SIZE EST. QTY. 4.00 SYMBOL Artemesia tridentata Medium Water Use BIG SAGE 5 Gal @ 15"x15" Caryopteris X cladonensis BLUE MIST SPIREA Low Water Use 1-Gal @ 1'x6" 5.00 Chamabateria millefolium Low Water Use FERNBUSH 1-Gal @ 1'x6" 4.00 Dalea frutescens 'Sierra Nigra' BLACK DALEA Low Water Use 15.00 5-Gal @ 12"x12" Elaeagnus pungens SILVERBERRY Low Water Use 5-Gal @ 2:x1' Ericameria laricifolia TURPENTINE BUSH Low Water Use 1-6al @ 9'x6" 6.00 Fallugia paradoxa APACHE PLUME Medium Water Use 3.00 1-6al @ 1'x6" Lavendula angustifolia 'Provence' PROVENCE LAVENDER Medium Water Use 4.00 1-6al @ 9'x9" Rosmarinus officinalis "Collingwood Ingram" Medium Mater Use Collingwood Ingram Rosemary 8.00 Vauquelinia californica ARIZONA ROSEMOOD Medium Water Use 5-Gal @ 18"x1" 6.00 Rhus aromatica GRO-LOW SUMAC 5-Gal Water requirements Succulent Botanical name COMMON NAME Low Water Use INSTALLED SIZE EST. QTY. SYMBOL Dasylirion wheeleri BLUE SOTOL Low Water Use 5-Gal @ 12"x12" Hesperaloe parviflora 'Yellow' YELLOW HESPERALOE Low Water Use 5-Gal @ 12"x12" Nolina texana Low Water Use BEARGRASS 1-Gal @ 9"x1" Opuntia engelmannii DESERT PRICKLY PEAR Low Water Use 5-Gal @ 4 PAD MIN Opuntia macrocentra PURPLE PRICKLY PEAR EASEMENT 4.00 Low Water Use 5-Gal @ 4 PAD MIN Yucca baccata BANANA YUCCA 5 Gal @ 15"x15" 4"-6" ROUNDED COBBLE. COLOR TO BE DETERMINED. 2" DEPTH, CRUSHER FINE GRAVEL MULCH. COLOR TAN OR BROWN. PROPOSED UTILITY -EASEMENT EASEMENT LANDSCAPE PLAN 1" = 40'-0"



interio planni engineeri

architectur

Dekker Perich Sabatin

6801 Jefferson NE Suite 100 Albuquerque, NM 8710! 505 761-9700 fax 761-4222 dps@dpsabq.com

ARCHITEC

ENGINE

JPTOWN VILLAGE
Apartments
2220 Uptown Loop Road

REVISIONS

A

A

DRAWN BY MC, LB
REVIEWED BY MC


DATE June 16, 2006
PROJECT NO. 05100


DRAWING NAME

LANDSCAPE PLAN

EET NO.

L001

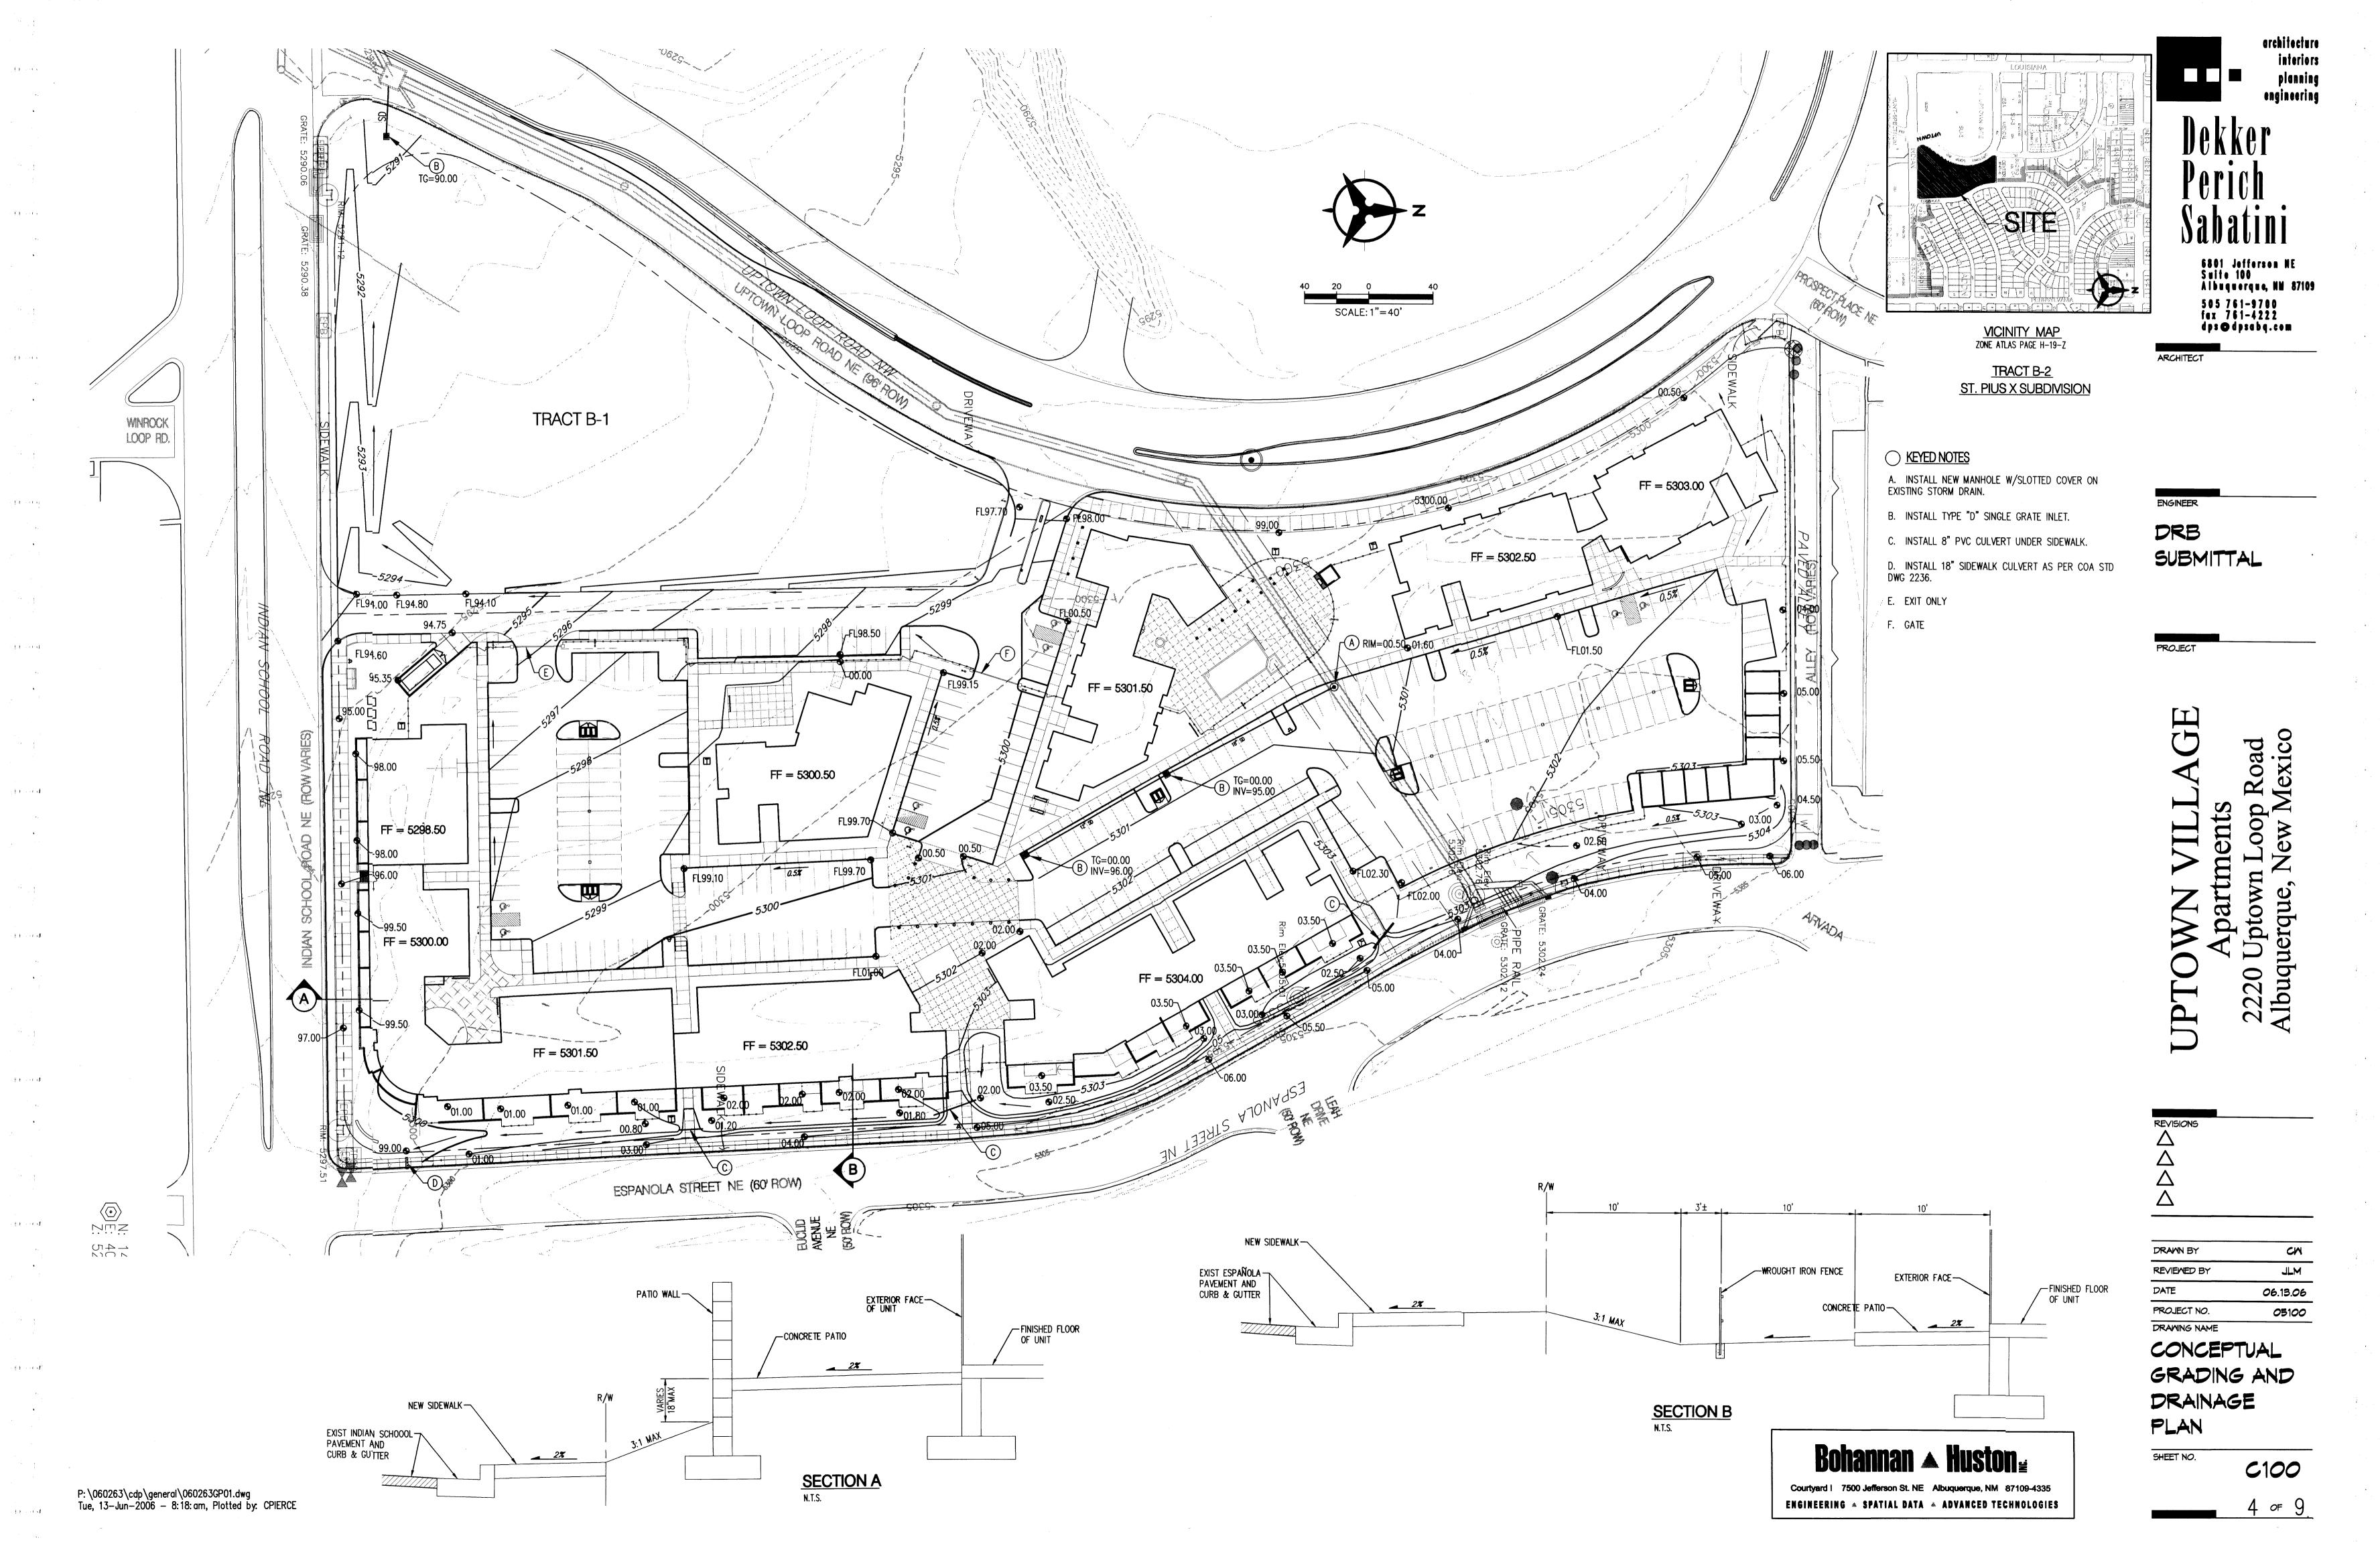

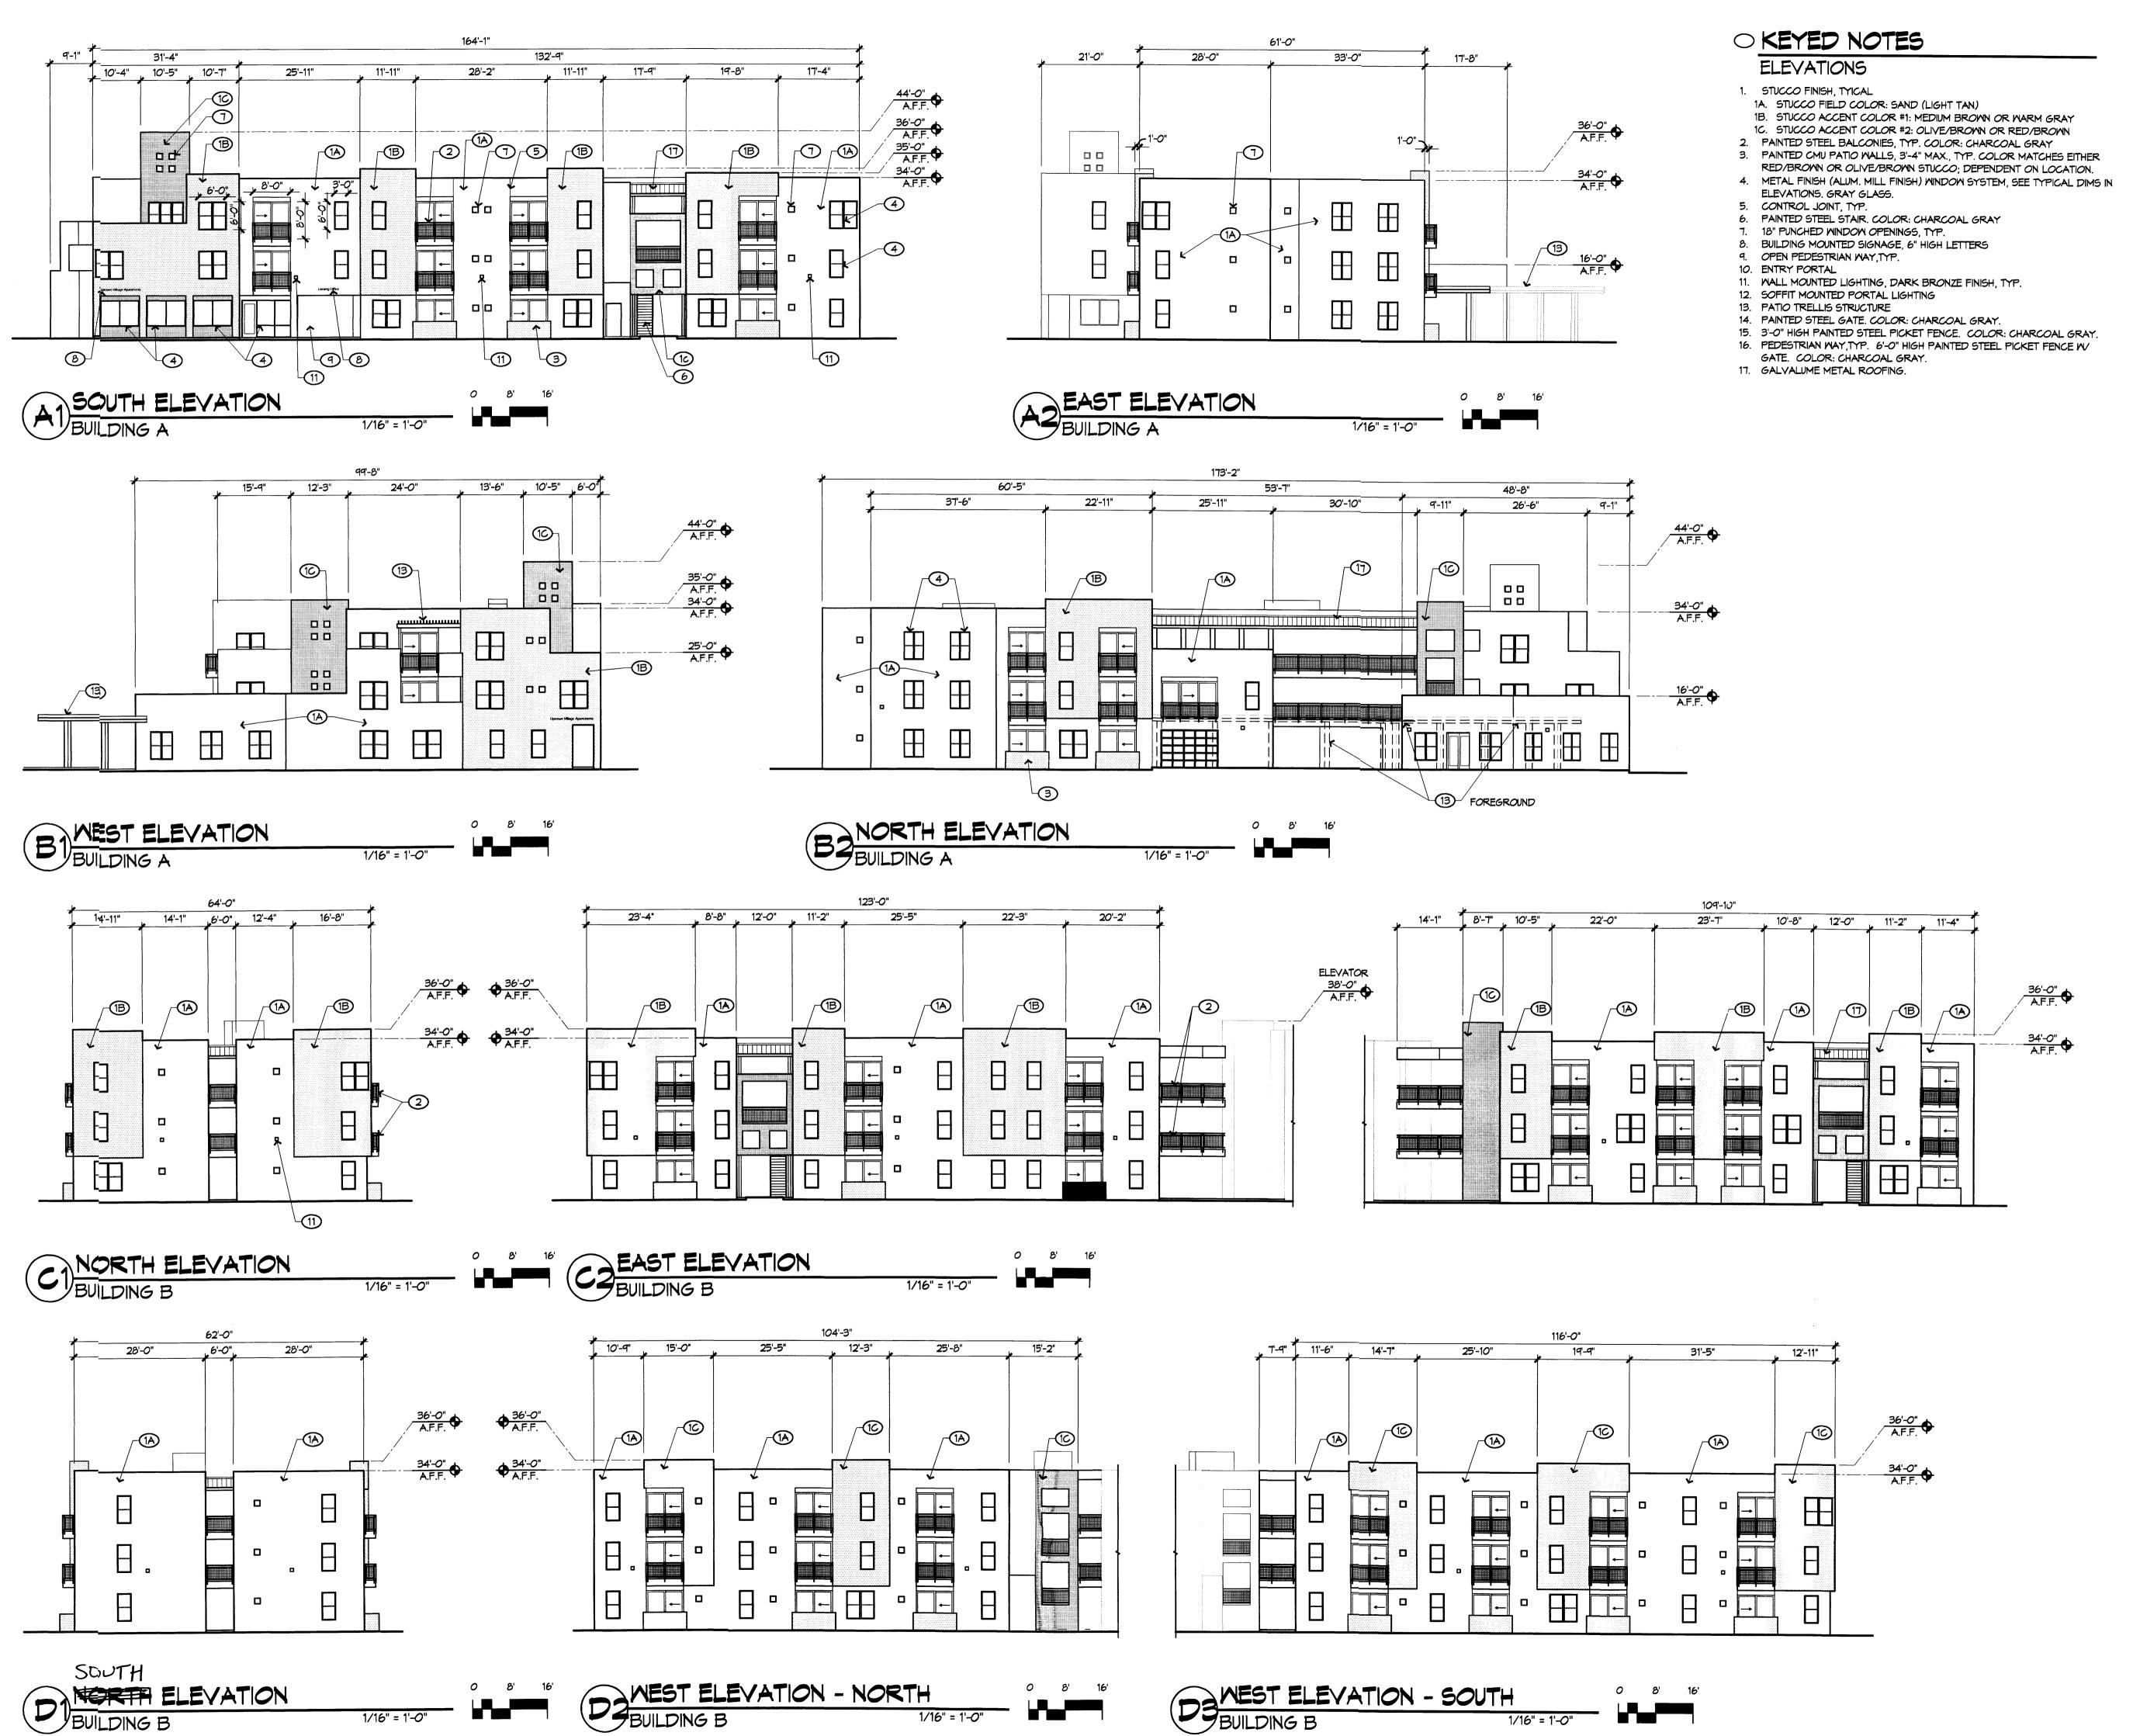

A P. B. Cole of

architecture interiors planning engineering

6801 Jefferson NE Suite 100 Albuquerque, NM 87109 505 761-9700

fax 761-4222

dps@dpsabq.com

ARCHITECT

Loop New M Apartments **Iptown**


DRAWN BY

REVIEWED BY June 16, 2006 05100

PROJECT NO. DRAWING NAME

> BUILDING ELEVATIONS

SHEET NO.

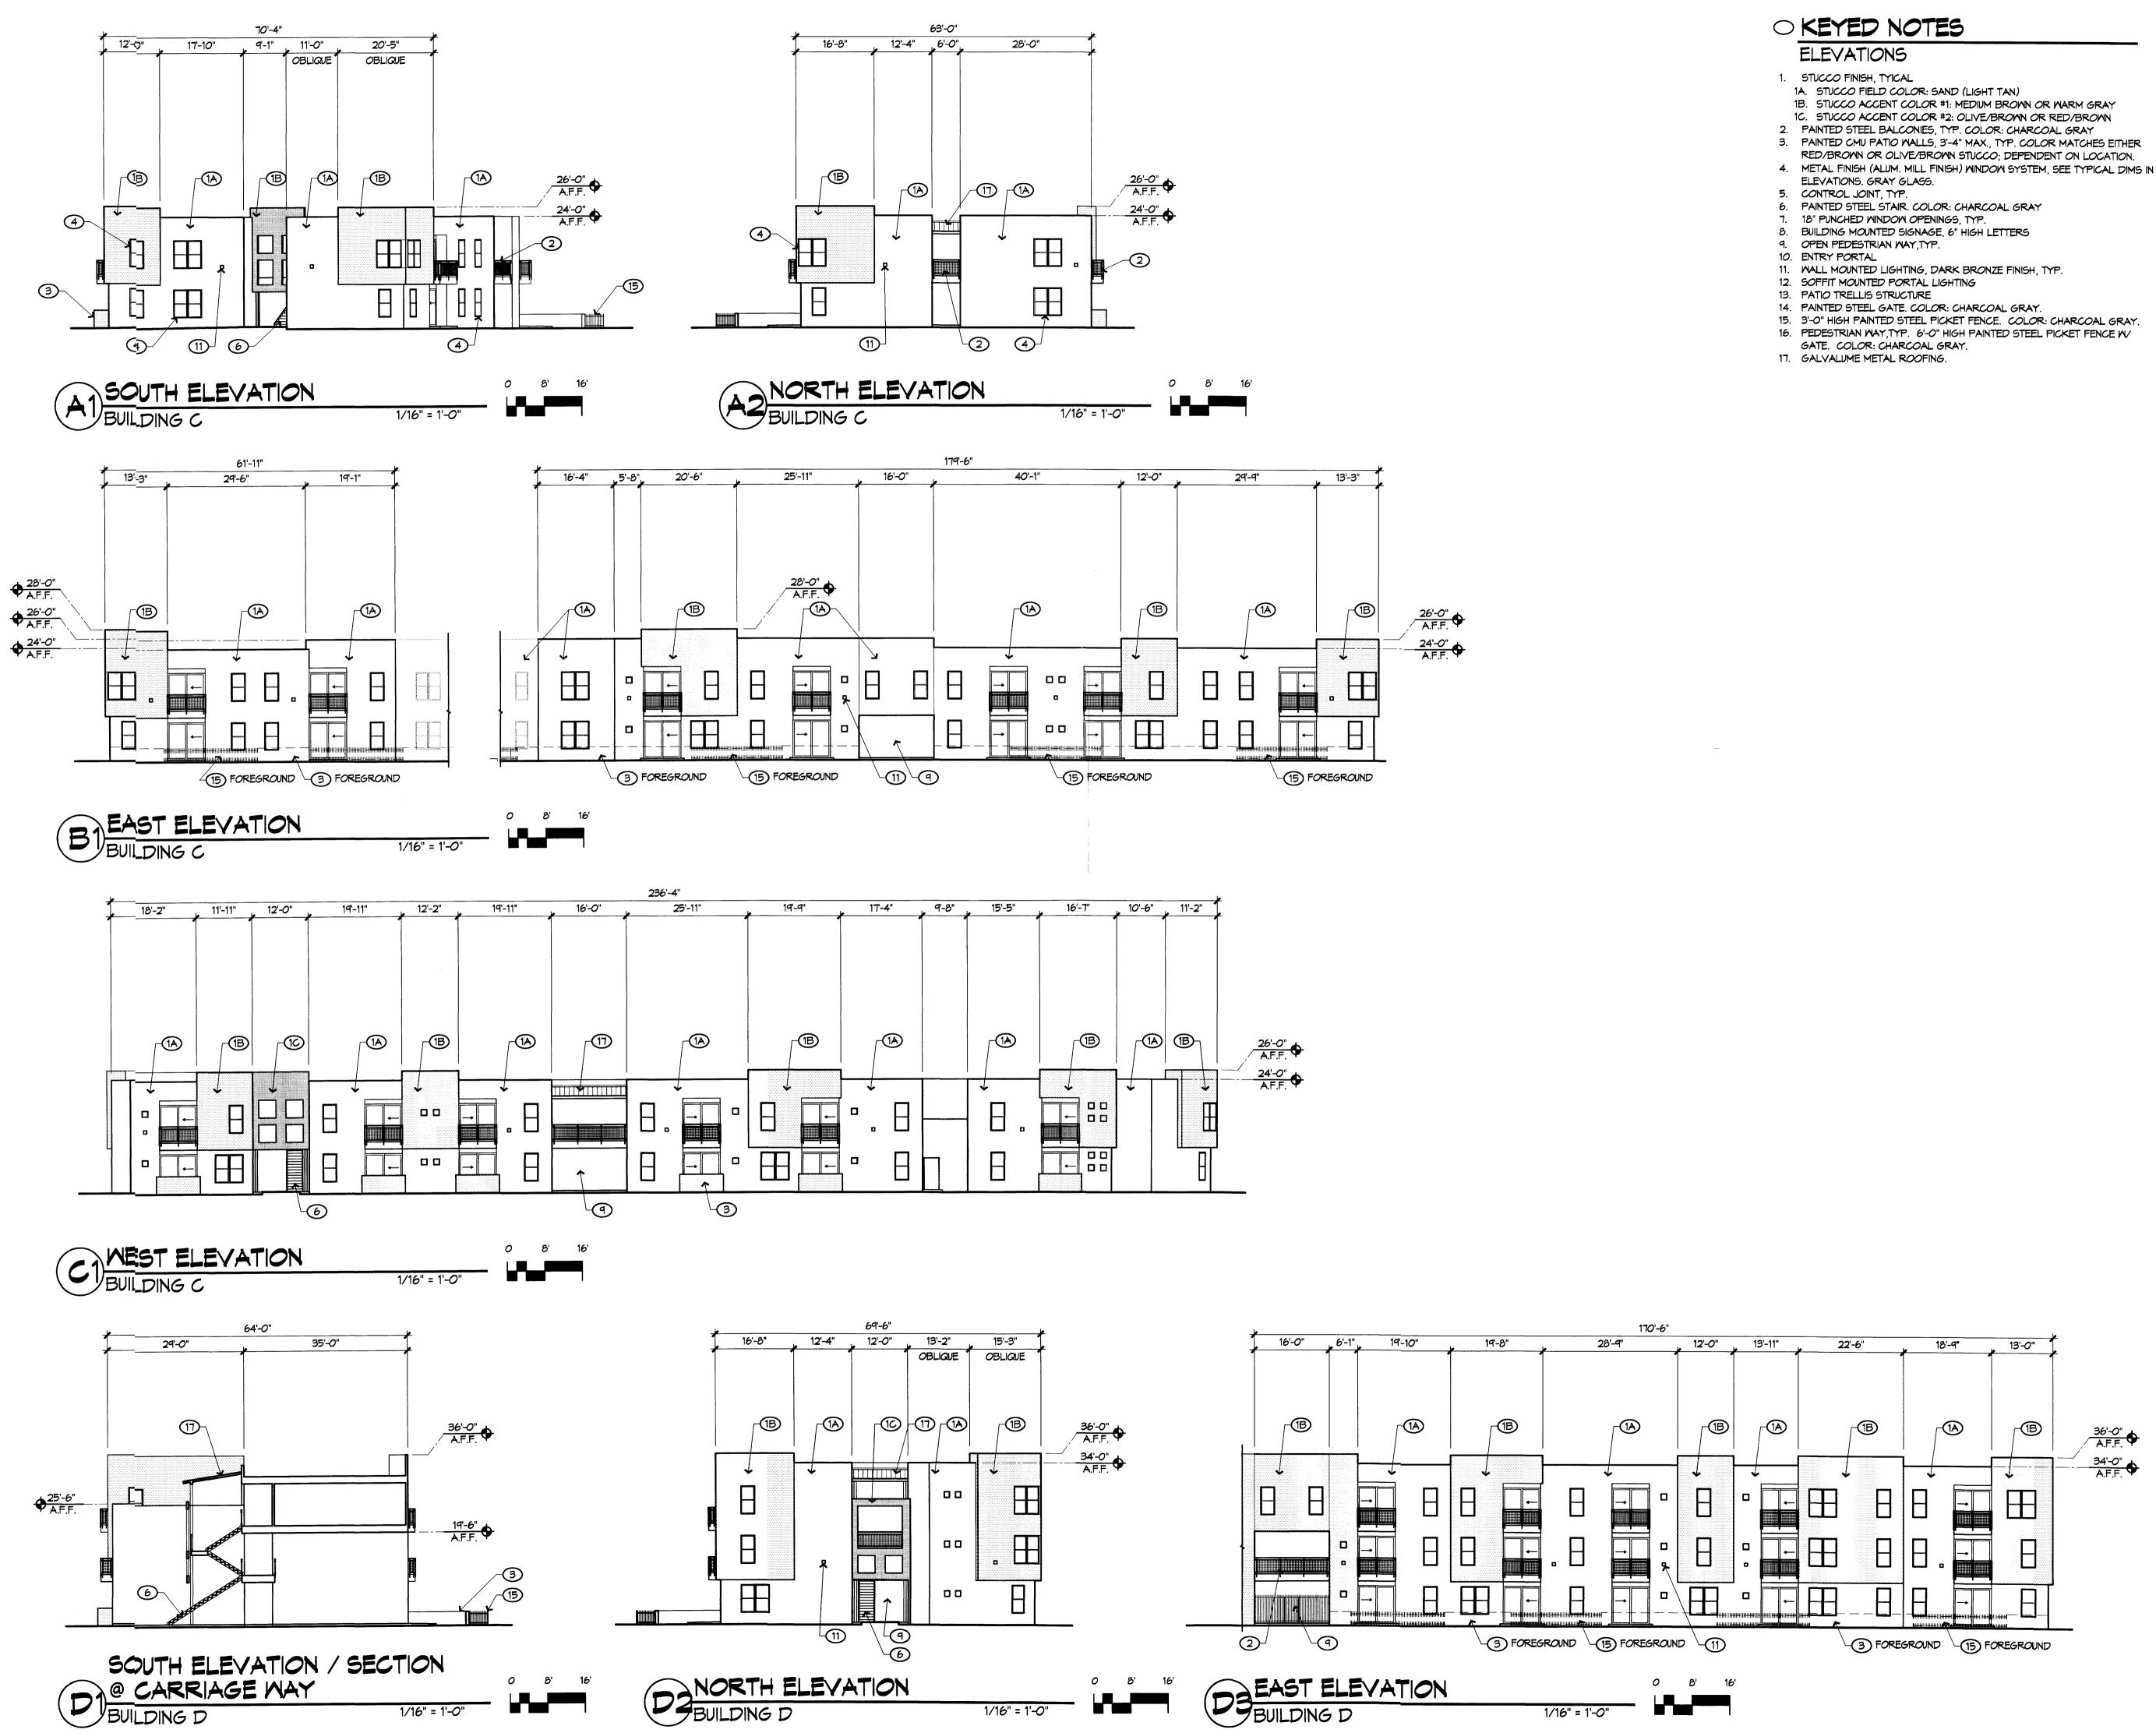

engineering

architecture

interiors

planning

6801 Jefferson NE Suite 100 Albuquerque, NM 87109 505 761-9700 fax 761-4222

dps@dpsabq.com


ARCHITECT

2220 U Albuque

DRAWN BY REVIEWED BY DATE June 16, 2006 PROJECT NO. DRAWING NAME

BUILDING ELEVATIONS

SHEET NO.

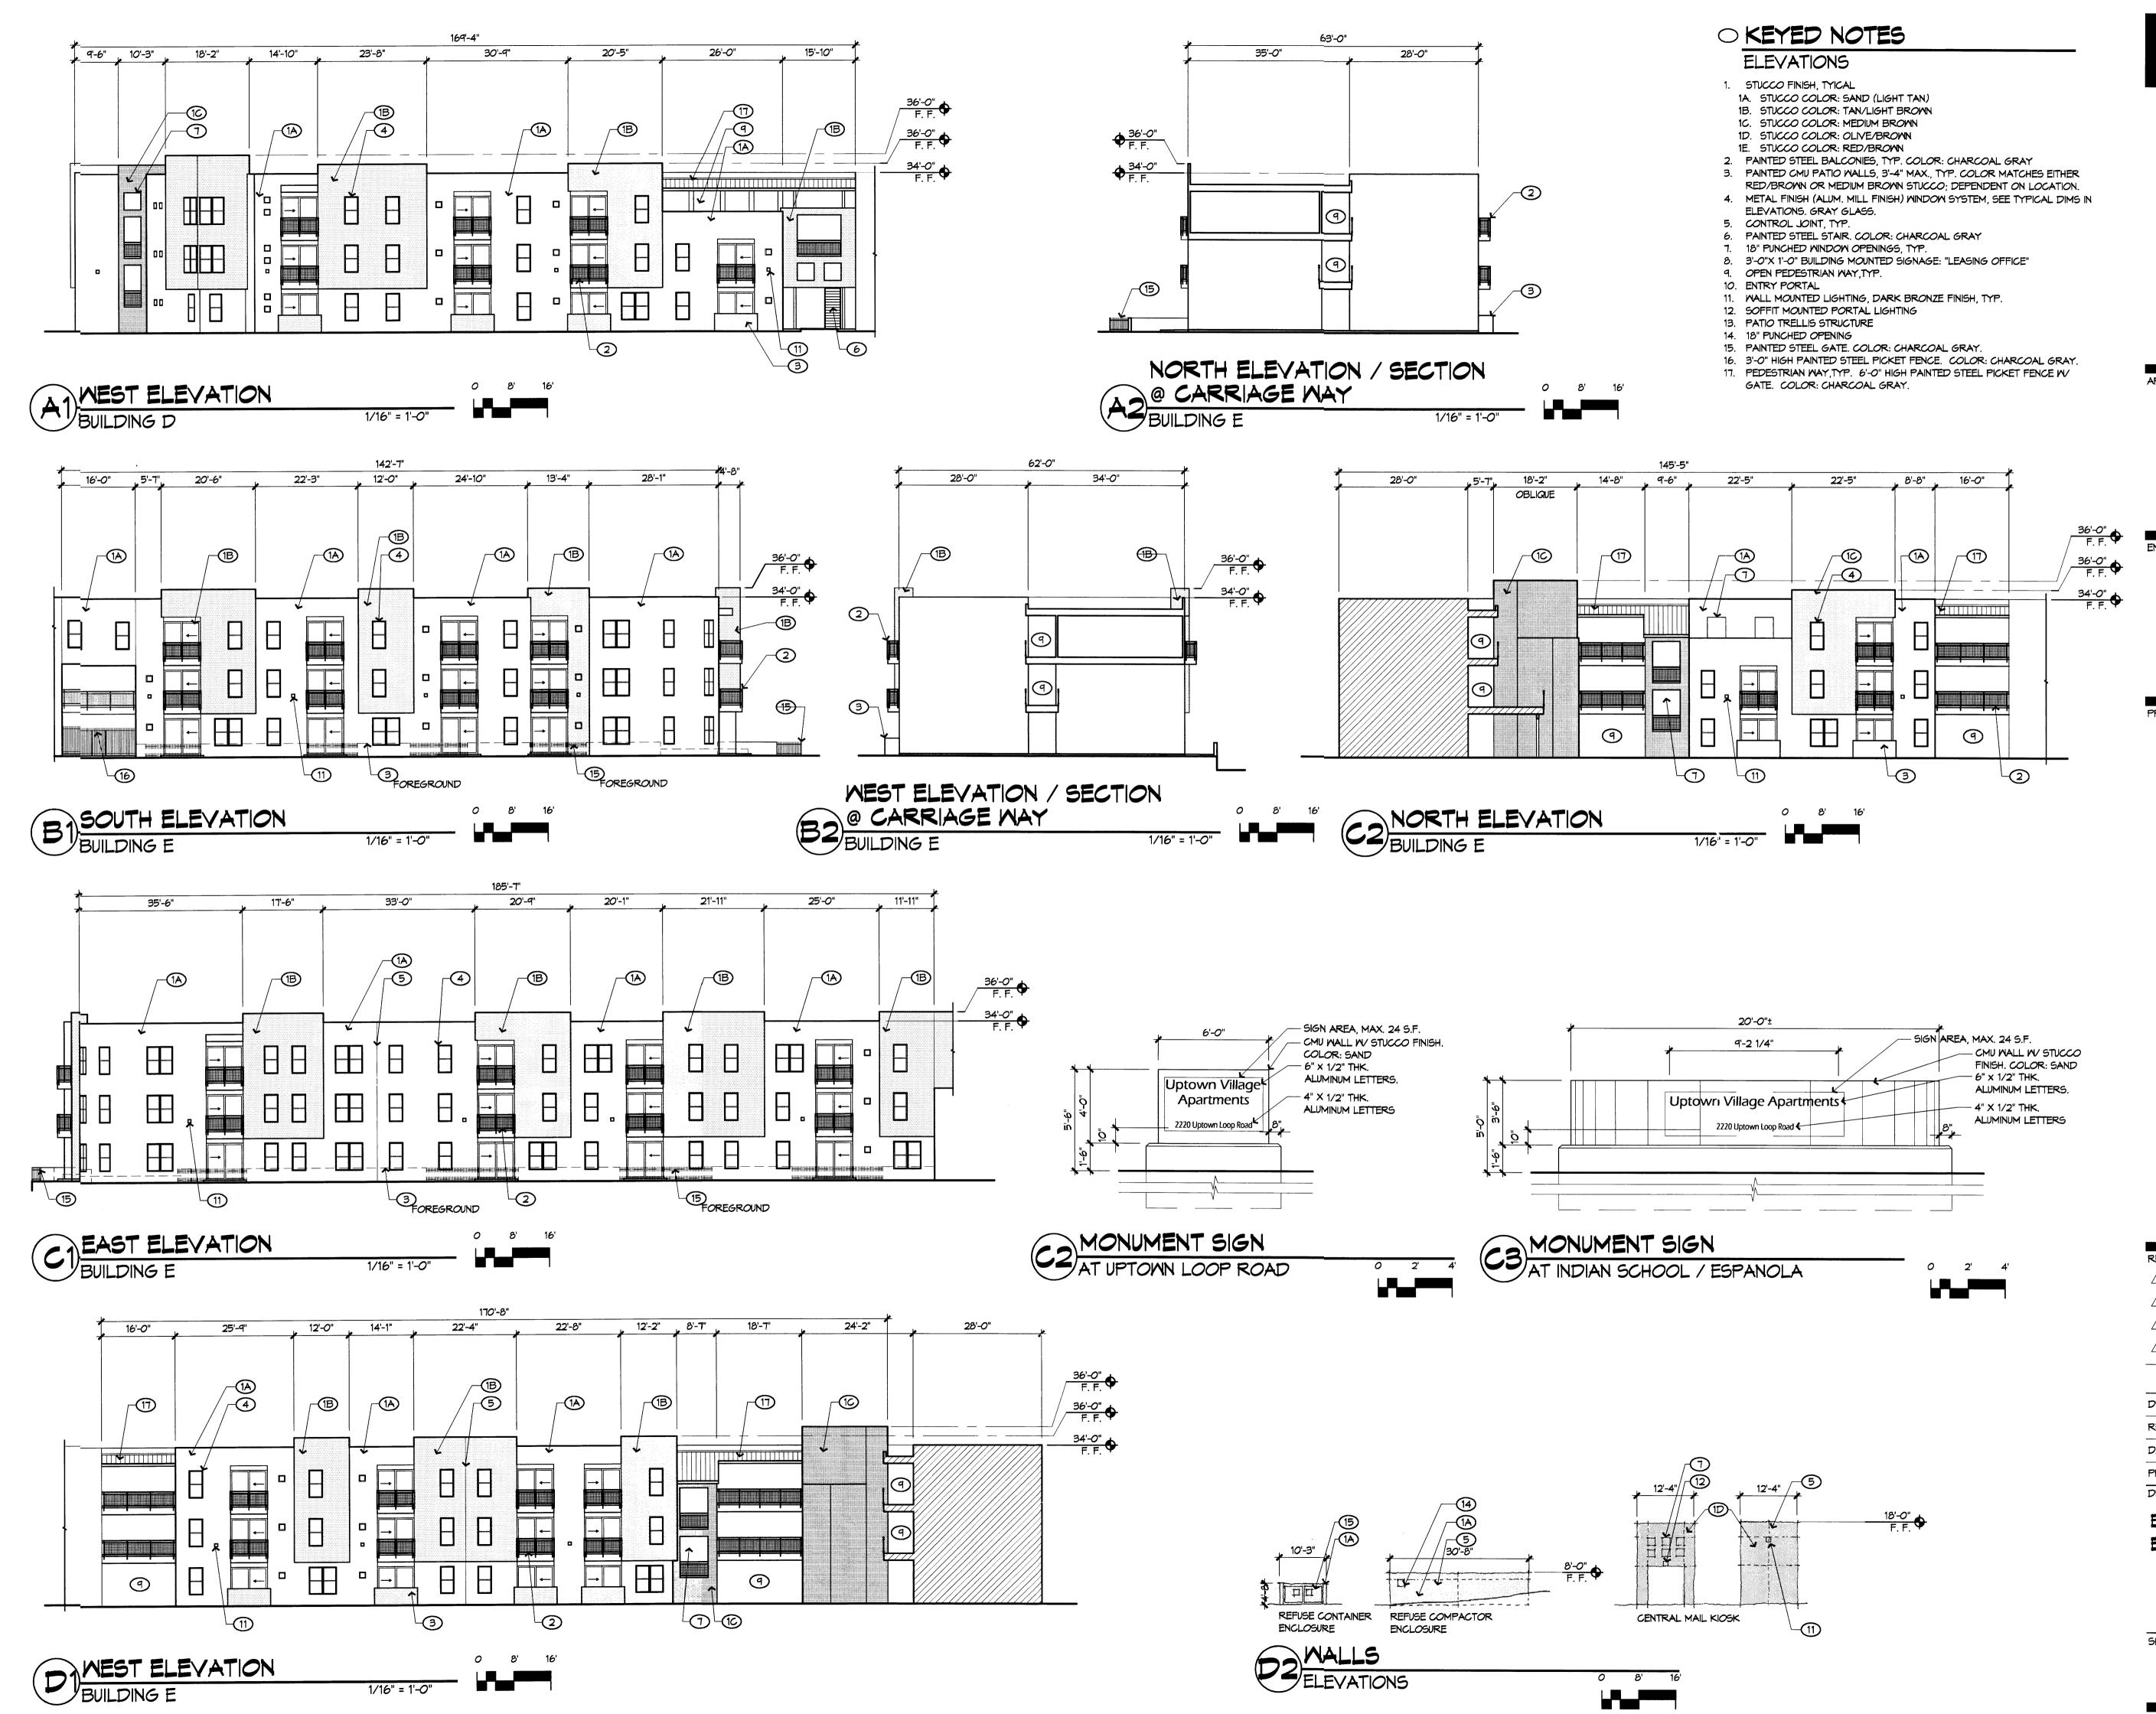

- Ar - Hart Arting

or the or of the

- 11 - 11 A 6 18 3

4: 🛔

4: A

1 A

· 4, 🕻

: 4

4. 4: J

architecture

interiors engineering

6801 Jefferson NE Suite 100 Albuquerque, NM 87109 505 761-9700 fax 761-4222 dps@dpsabq.com

ARCHITECT

ENGINEER

PROJECT

nents Loop Road New Mexico 2220 Uptown Albuquerque,


DRAWN BY REVIEWED BY DATE June 16, 2006

05100

PROJECT NO. DRAWING NAME

BUILDING ELEVATIONS



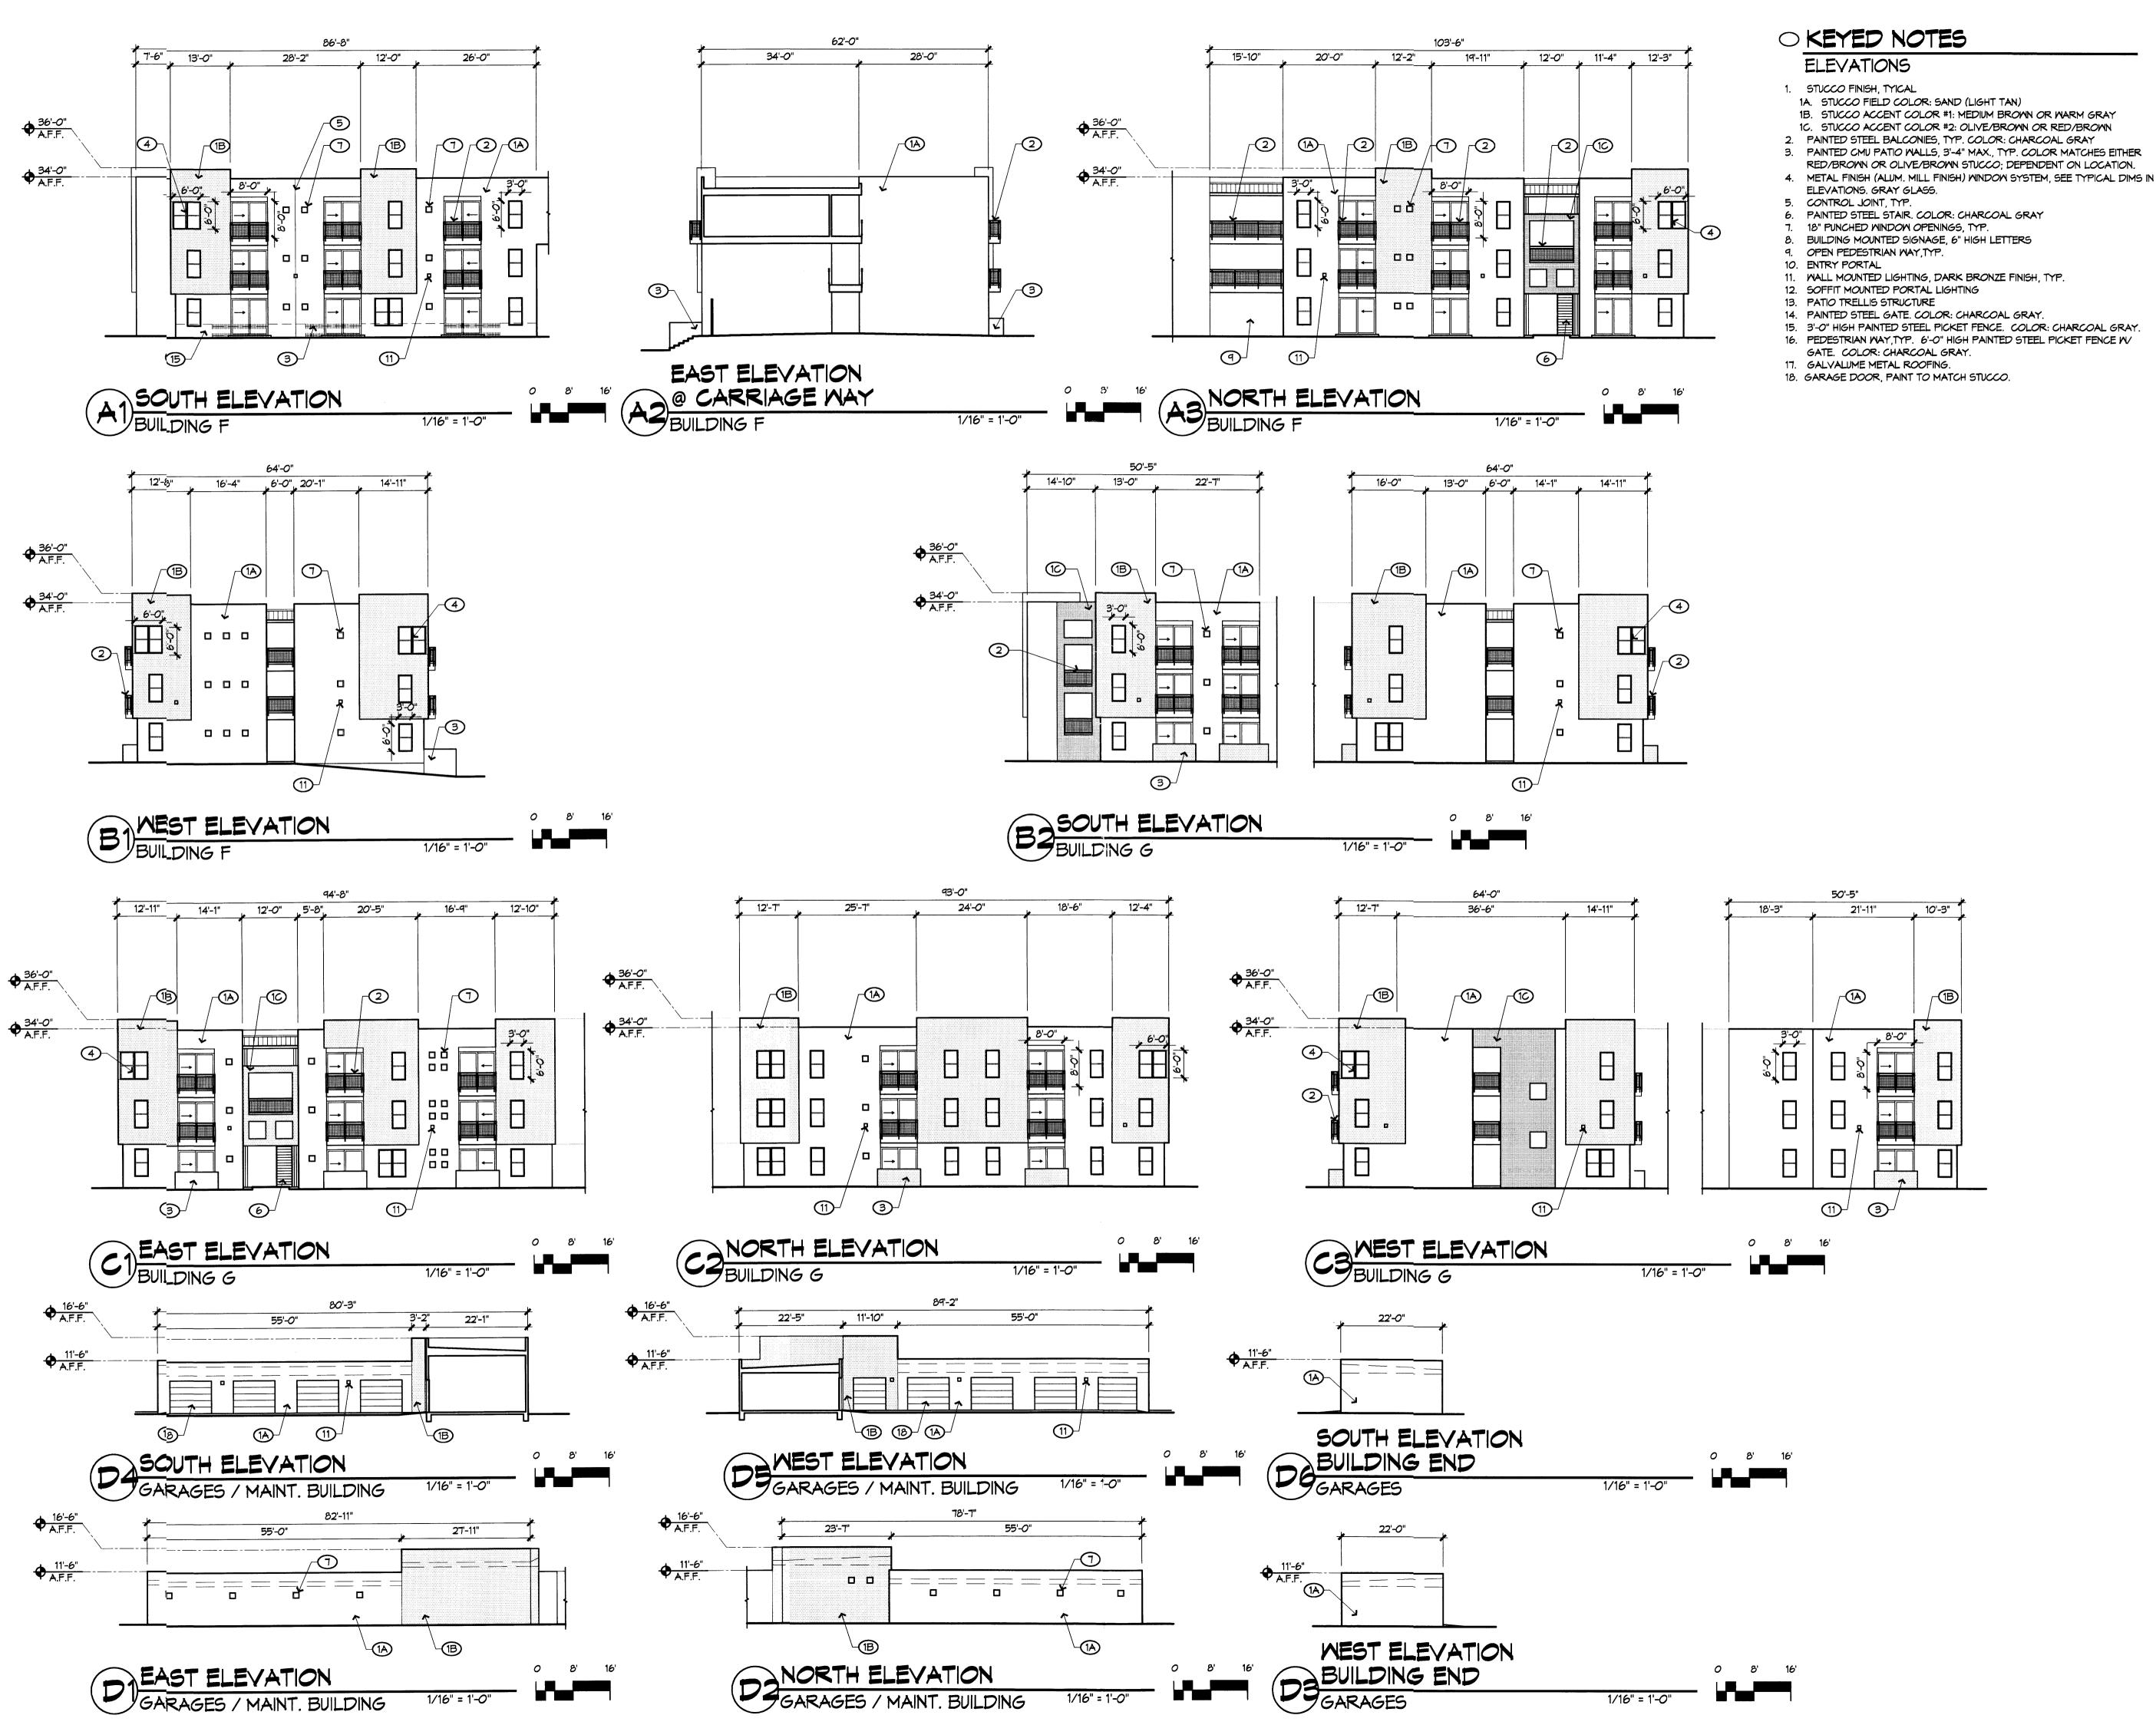

architecture interiors planning engineering

Dekker Perich

6801 Jefferson NE Suite 100 Albuquerque, NM 87109 505 761-9700 fax 761-4222 dps @dpsabq.com

CUITCT

ENGINEER

PROJEC

JPTOWN VILLAGE
Apartments
2220 Uptown Loop Road
Albuquerque, New Mexico

DRAWN BY


REVIEWED BY


DATE June 16, 2006
PROJECT NO. 05100
DRAWING NAME

BUILDING ELEVATIONS

SHEET NO.

A304

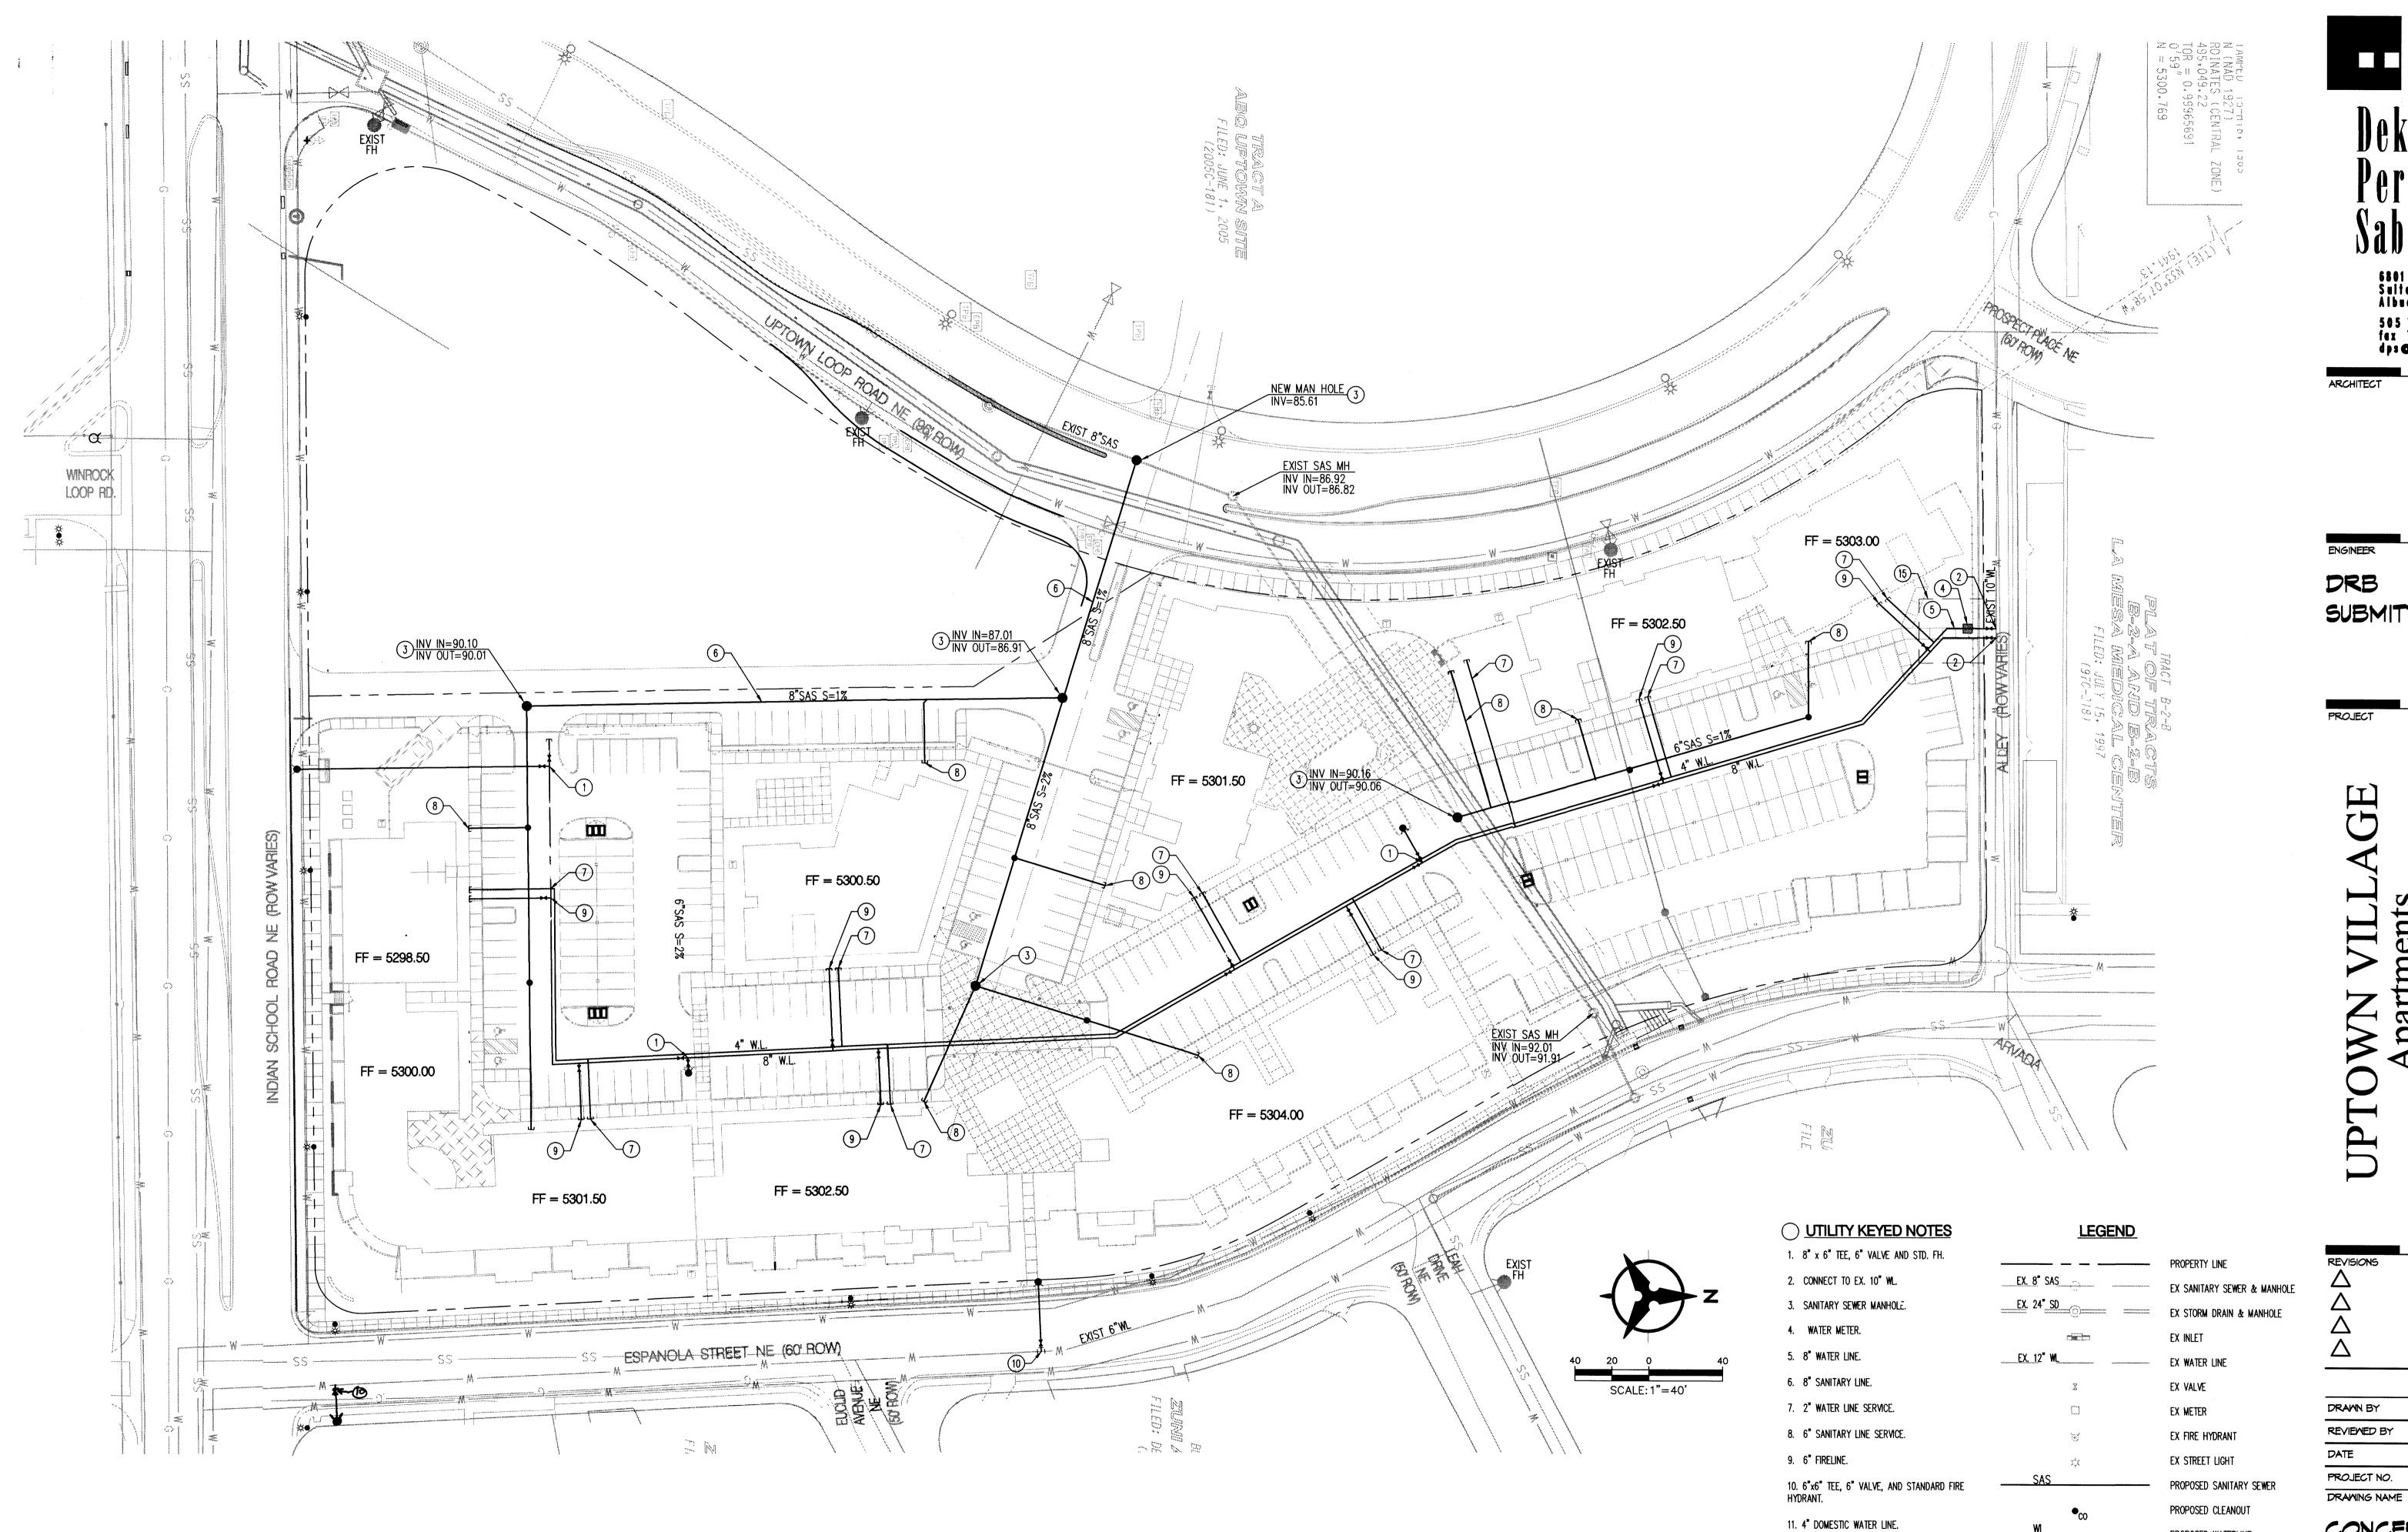

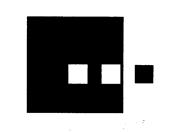

6801 Jefferson NE Suite 100 Albuquerque, NN 87109 505 761-9700 fax 761-4222 dp:⊕dp:abq.com

DRB SUBMITTAL

CM DRAWN BY MLL REVIEWED BY DATE 06.13.06 05100 PROJECT NO.

CONCEPTUAL UTILITY PLAN

VALVE

PROPOSED WATERLINE

Courtyard I 7500 Jefferson St. NE Albuquerque, NM 87109-4335 ENGINEERING * SPATIAL DATA * ADVANCED TECHNOLOGIES

12. 35'x35' WATER EASMENT.

C200