



PROPOSED LOT AREA

SCALE: 1"=40'

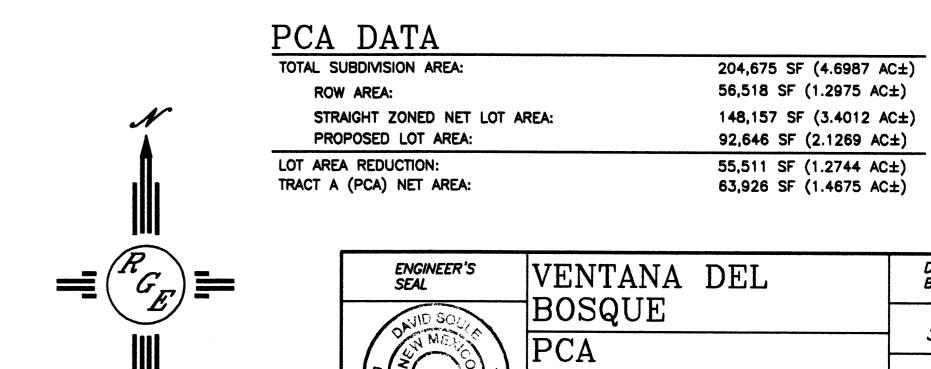

A	(PCA) NET AREA:	63,926 SF (1.4675 A	C±)
	ENGINEER'S SEAL	VENTANA DEL BOSQUE	DRAWN BY WCWJ DATE
		PCA EXHIBIT	3-24-06 2600-SP-1-10-0
	TOFESSION BY	Rio Grande Engineering	SHEET #
	DAVID SOULE P.E. #14522	1806 CENTRAL AVENUE SE SUITE 201 ALBUQUERQUE, NM 87106 (305) 872-0999	JOB # 2600

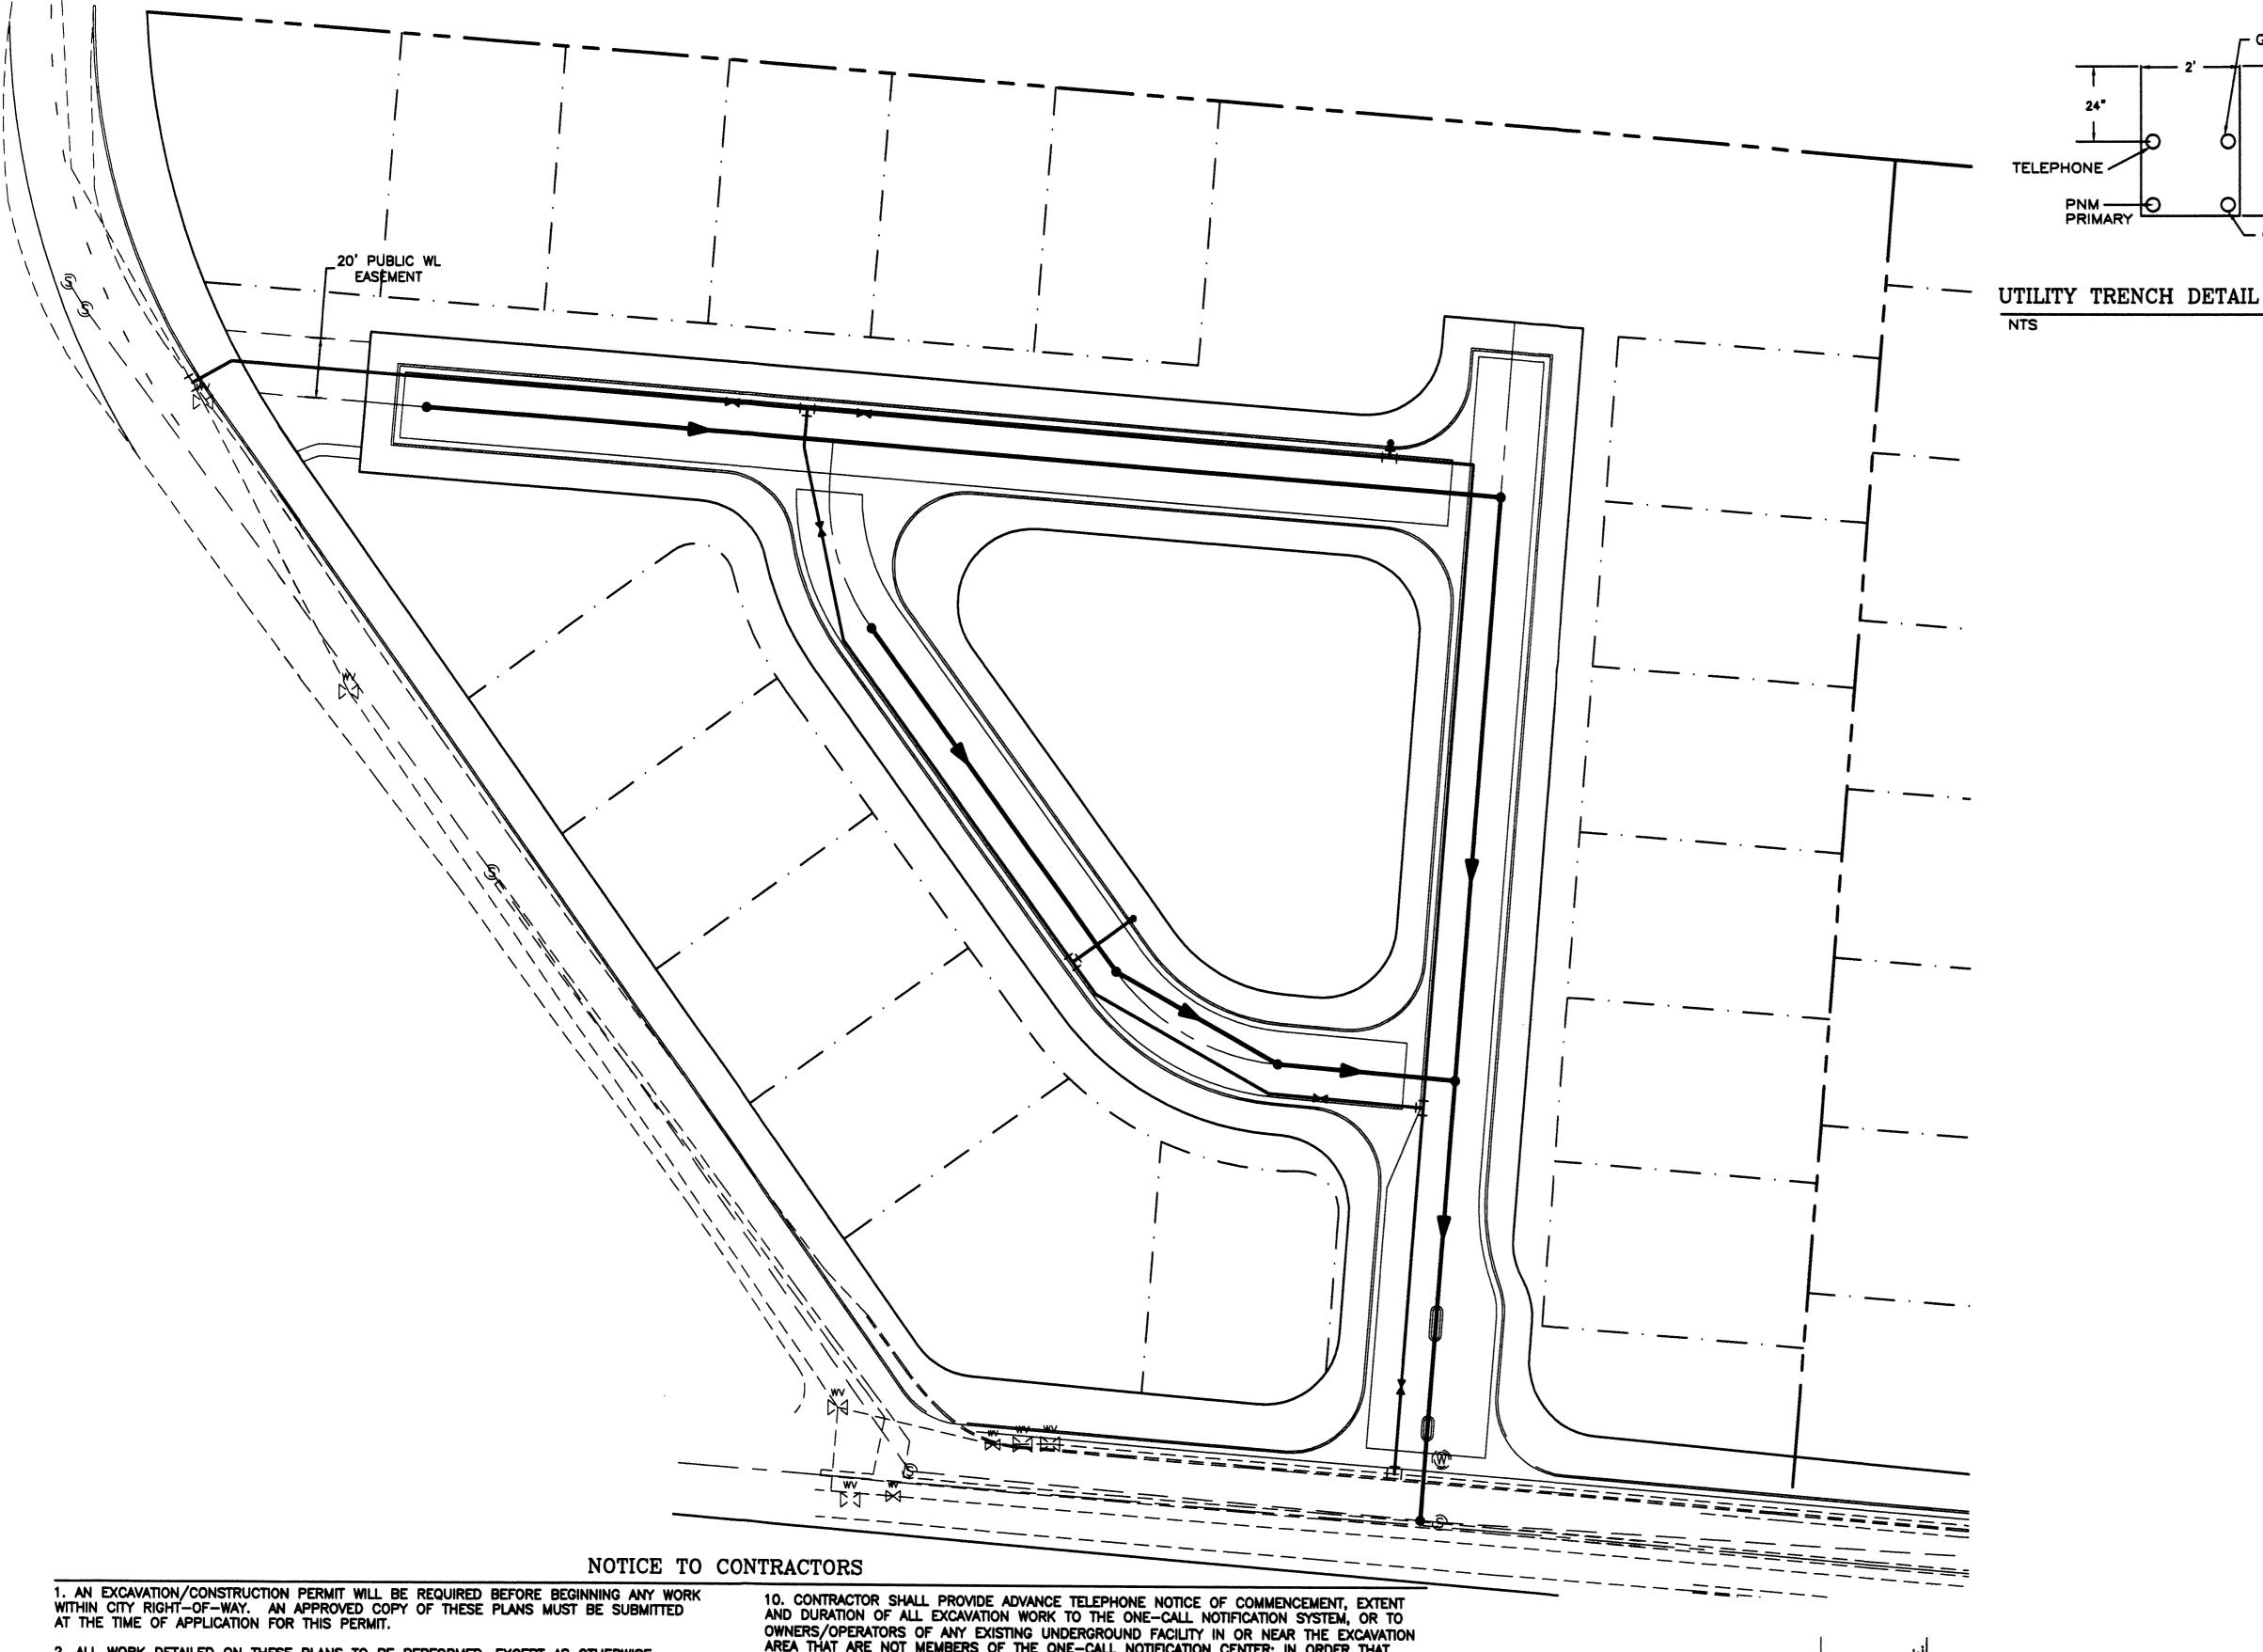

2. ALL WORK DETAILED ON THESE PLANS TO BE PERFORMED, EXCEPT AS OTHERWISE STATED OR PROVIDED HEREON, SHALL BE CONSTRUCTED IN ACCORDANCE WITH CITY OF ALBUQUERQUE INTERIM STANDARD SPECIFICATIONS FOR PUBLIC WORKS CONSTRUCTION, 1985.

- 3. TWO WORKING DAYS PRIOR TO ANY EXCAVATION, CONTRACTOR MUST CONTACT LINE LOCATING SERVICE, 765-1234, FOR LOCATION OF EXISTING UTILITIES.
- 4. PRIOR TO CONSTRUCTION, THE CONTRACTOR SHALL EXCAVATE AND VERIFY THE HORIZONTAL AND VERTICAL LOCATIONS OF ALL CONSTRUCTIONS. SHOULD A CONFLICT EXIST, THE CONTRACTOR SHALL NOTIFY THE ENGINEER SO THAT THE CONFLICT CAN BE RESOLVED
- 5. BACKFILL COMPACTION SHALL BE ACCORDING TO RESIDENTIAL STREET USE. 6. MAINTENANCE OF THESE FACILITIES SHALL BE THE RESPONSIBILITY OF THE OWNER OF
- 7. WORK ON ARTERIAL STREETS SHALL BE PERFORMED ON A 24-HOUR BASIS.
- 8. CONTRACTOR SHALL DETERMINE LOCATION OF ANY UNDERGROUND FACILITY IN OR NEAR WORK AREAS, INCLUDING REQUESTS TO OWNERS/OPERATORS OF SAID FACILITIES PER
- 9. CONTRACTOR SHALL PLAN ALL EXCAVATION TO MINIMIZE INTERFERENCE OR DAMAGE OF

OWNERS/OPERATORS OF ANY EXISTING UNDERGROUND FACILITY IN OR NEAR THE EXCAVATION AREA THAT ARE NOT MEMBERS OF THE ONE-CALL NOTIFICATION CENTER; IN ORDER THAT OWNERS/OPERATORS MAY LOCATE AND MARK UNDERGROUND FACILITY PER SECTION 62-14-5 NMSA 1978 PRIOR TO ANY COMMENCEMENT OF WORK. CONTRACTOR SHALL REQUEST REAFFIRMATION OF LOCATION EVERY TEN (10) WORKING DAYS AFTER INITIAL


11. CONTRACTOR SHALL MAINTAIN EIGHTEEN (18) INCHES BETWEEN EXISTING UNDERGROUND FACILITIES FOR WHICH HAVE BEEN PREVIOUSLY IDENTIFIED AND MARKED BY THE OWNERS/OPERATORS OF SAID FACILITIES. CUTTING EDGE OR POINT OF ANY MECHANICAL EXCAVATING EQUIPMENT UTILIZED IN EXCAVATION AREA WILL BE USED IN A MANNER NECESSARY TO PREVENT DAMAGE TO EXISTING UNDERGROUND FACILITIES.

12. CONTRACTOR SHALL PROVIDE SUPPORT FOR EXISTING UNDERGROUND FACILITIES IN OR NEAR EXCAVATION AREA AS NECESSARY TO PREVENT DAMAGE TO SAID FACILITIES.


13. CONTRACTOR SHALL BACKFILL ALL EXCAVATIONS IN A MANNER AND WITH MATERIALS AS MAY BE NECESSARY TO PREVENT DAMAGE TO AND PROVIDE RELIABLE SUPPORT DURING AND FOLLOWING BACK FILLING ACTIVITIES FOR PREEXISTING UNDERGROUND FACILITIES IN OR NEAR

14. CONTRACTOR SHALL IMMEDIATELY NOTIFY BY TELEPHONE THE OWNER/OPERATOR OF ANY UNDERGROUND FACILITY WHICH MAY HAVE BEEN DAMAGED OR DISLODGED DURING

15. CONTRACTOR SHALL NOT MOVE OR OBLITERATE MARKINGS MADE PURSUANT TO CHAPTER 62, ARTICLE 14 NMSA 1978, OR FABRICATE MARKINGS IN A UNMARKED LOCATION FOR THE PURPOSE OF CONCEALING OR AVOIDING LIABILITY FOR VIOLATION OF OR NONCOMPLIANCE WITH THE PROVISIONS OF CHAPTER 62, ARTICLE 11 NMSA 1978.

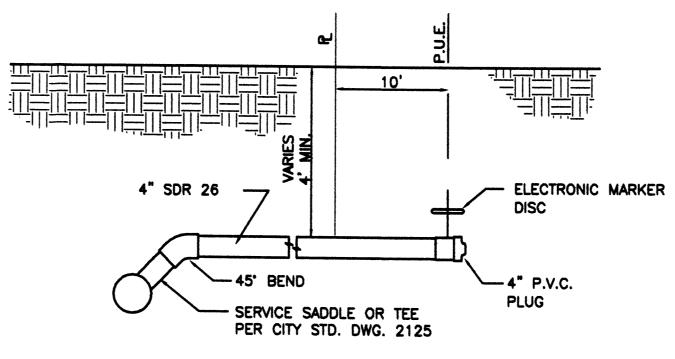

TYP. SANITARY SYSTEM SERVICE CONNECTION NTS

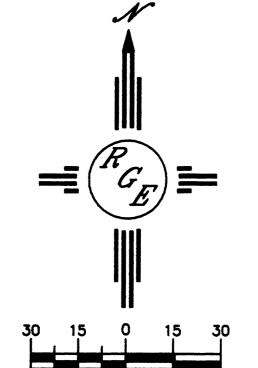

SCALE: 1"=30"

WATER SHUTOFF PLAN

- GAS LINE

- CABLE TV

SHUTOFF VALVES:

WATER SHUTOFF NOTES:

1. ONLY WATER SYSTEMS PERSONNEL ARE AUTHORIZED TO OPERATE VALVES. 2. NOTIFY CITY OF ALBUQUERQUE, WATER SYSTEMS DIVISION (PHONE 857-8200) SEVEN (7) WORKING DAYS IN ADVANCE OF NEEDING EXECUTION OF THE WATER SHUT OFF PLAN


- 3. APPROXIMATE SHUT OFF TIME WILL BE 24 HOURS.
- 4. SHUTOFF THE VALVES INDICATED IN THE PLAN ABOVE.


LEGEND EXISTING SAS MANHOLE **EXISTING SANITARY SEWER LINE** PROPOSED SAS MANHOLE PROPOSED SAS CLEANOUT -- PROPOSED SANITARY SEWER LINE - SANITARY SEWER SERVICE LINE - - - EX. 12" WL - - EXISTING WATER LINE PROPOSED METER PROPOSED VALVE W/BOX PROPOSED FIRE HYDRANT - WATER SERVICE LINE - PROPOSED STORM SEWER LINE ======= EXISTING CURB & GUTTER PROPOSED CURB & GUTTER CENTERLINE - RIGHT-OF-WAY --- DRY UTILITY TRENCH --- BOUNDARY LINE --- EASEMENT

GENERAL NOTES: 1. 4' MINIMUM BURY REQUIRED FOR ALL UTILITIES UNLESS OTHERWISE NOTED. 2. REFERENCE ARCHITECTURAL PLANS FOR WATER LINE RISER LOCATIONS. 3. CLEAN OUTS ARE TO BE BUILT PER UNIFORM PLUMBING CODE STANDARDS. 4. ALL BLOCKING IS PER CITY OF ALBUQUERQUE STANDARD

5. ALL PIPE MATERIAL TO BE USED PER UPC.


ENGINEER'S SEAL	VENTANA DEL	DRAWN BY WCWJ
14522 W	BOSQUE	DATE 2-22-06
	CONCEPTUAL MASTER UTILITY PLAN	2600-MU-1-10-06AX
APOPESSION LITTURE	Engineering	7
DAVID SOULE P.E. #14522	1606 CENTRAL AVENUE S SUITE 201 ALBUQUERQUE, NM 87106 (505) 872-0999	

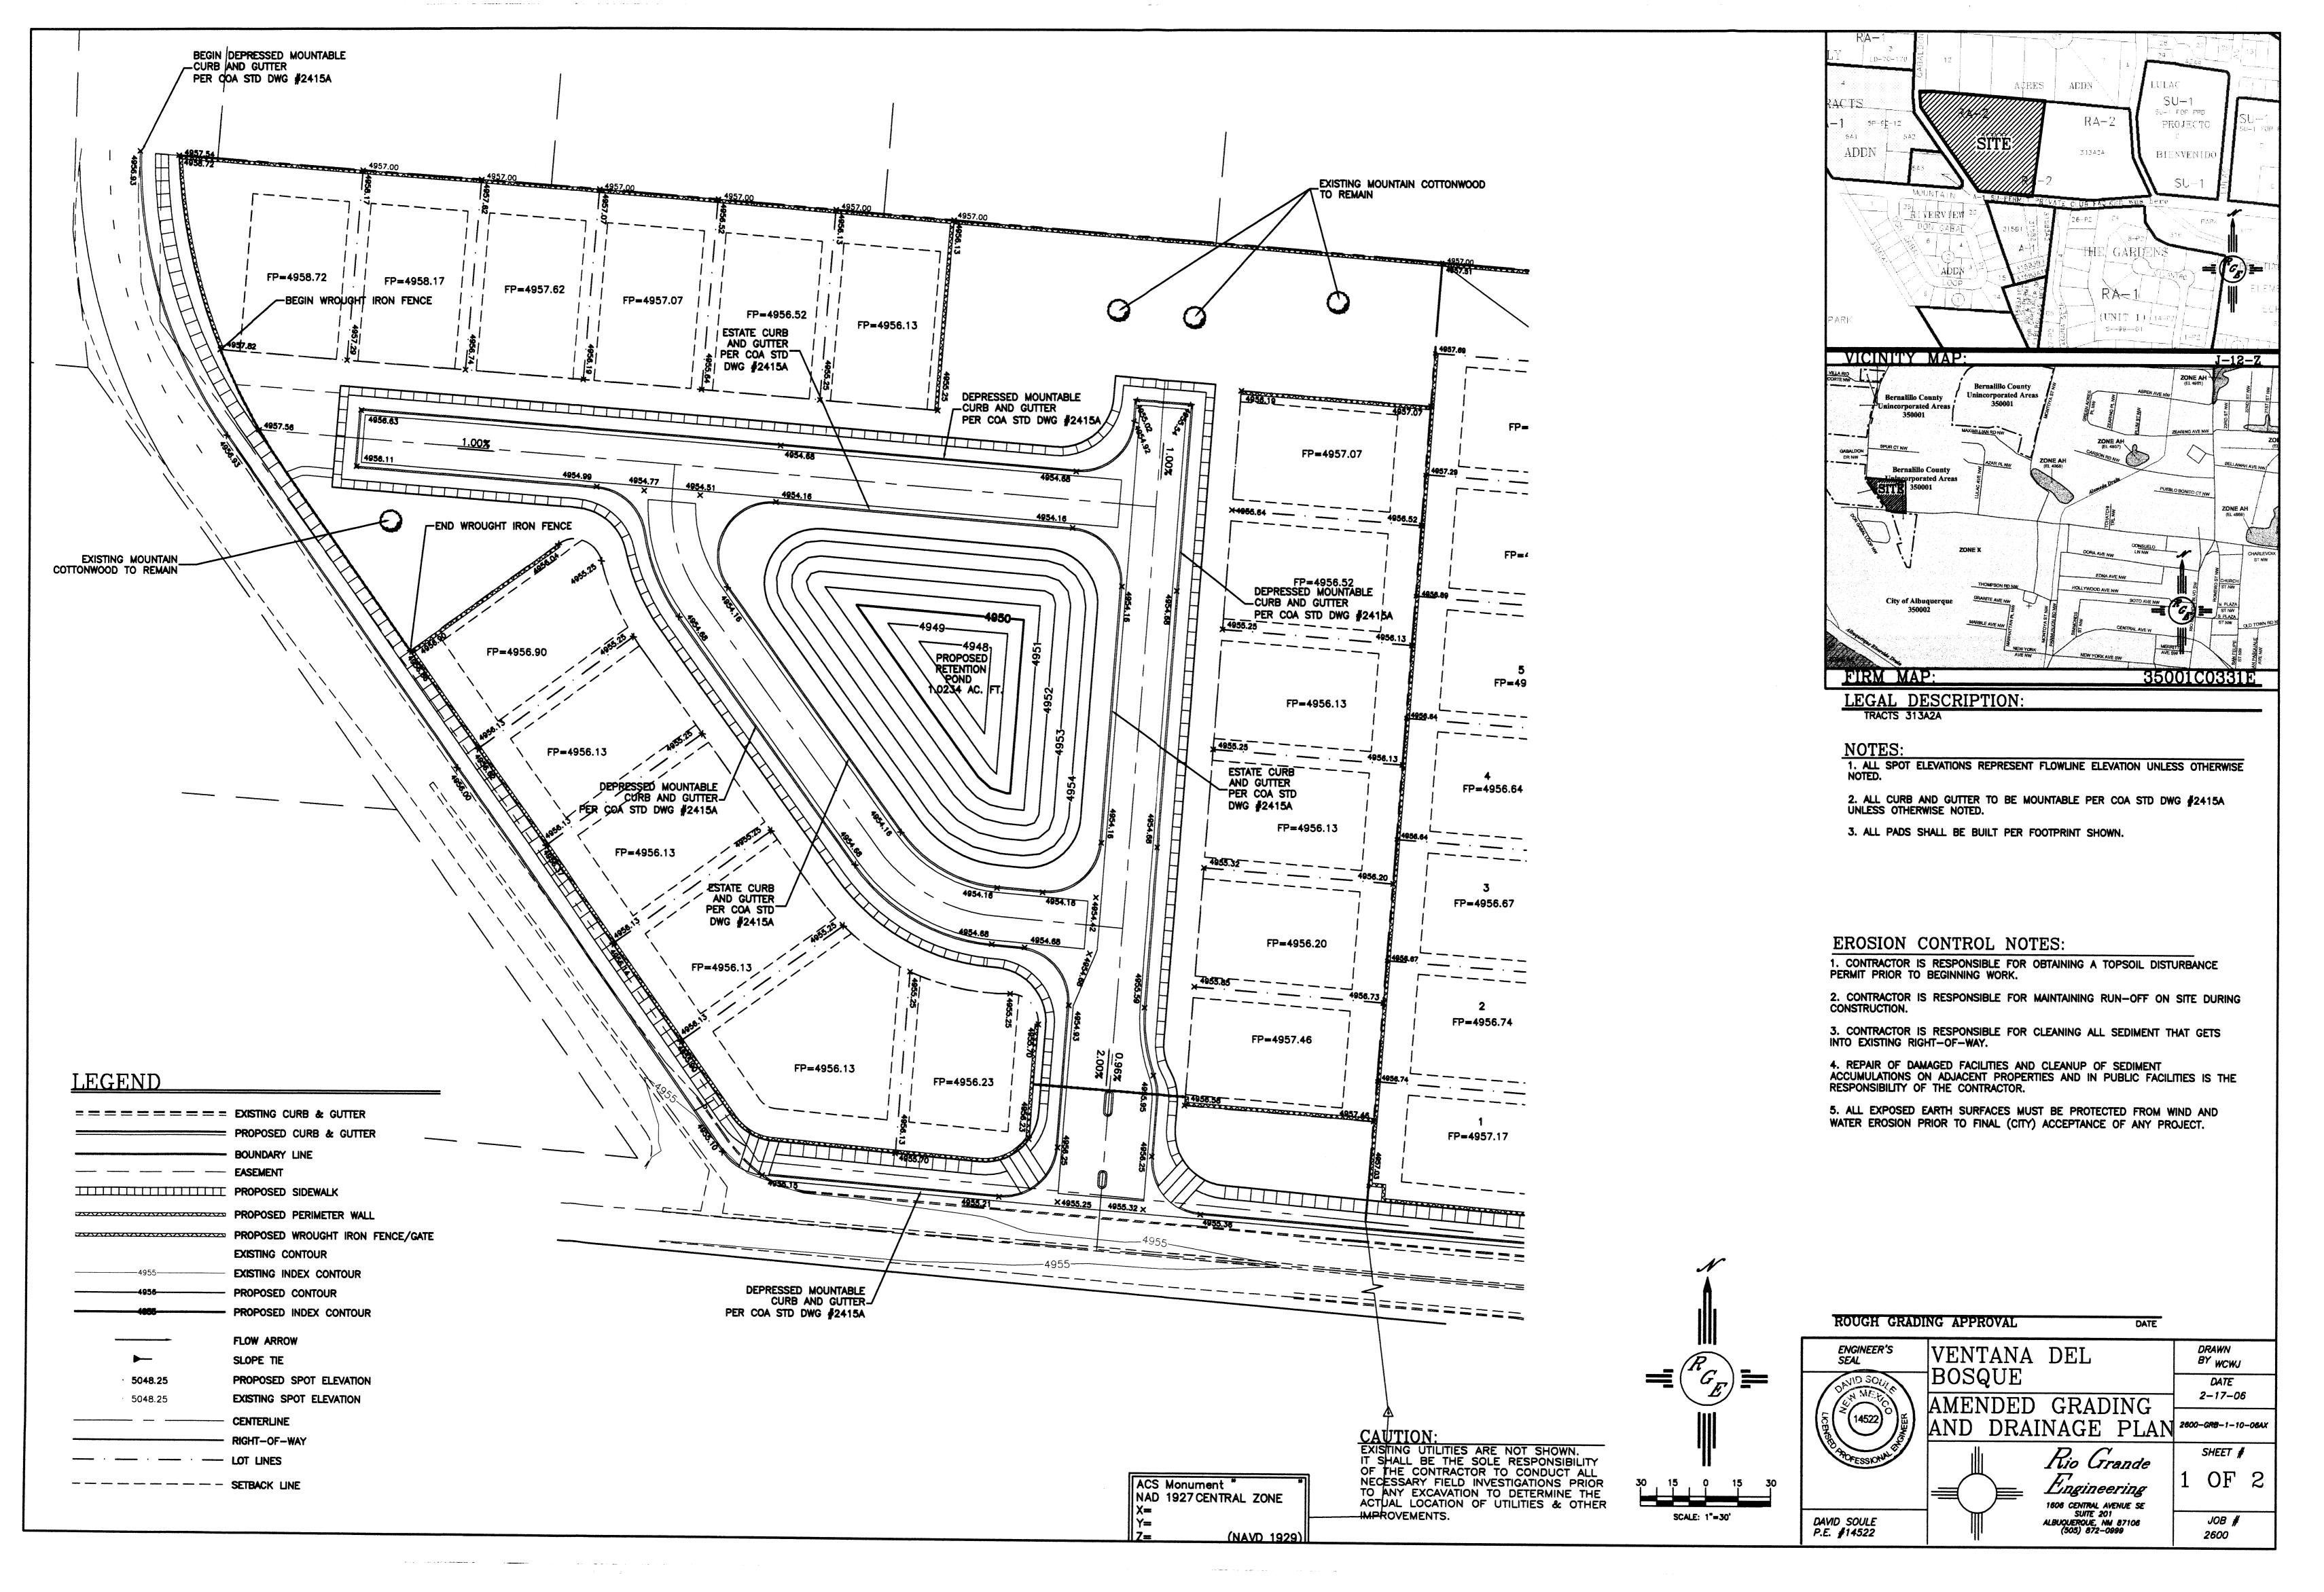

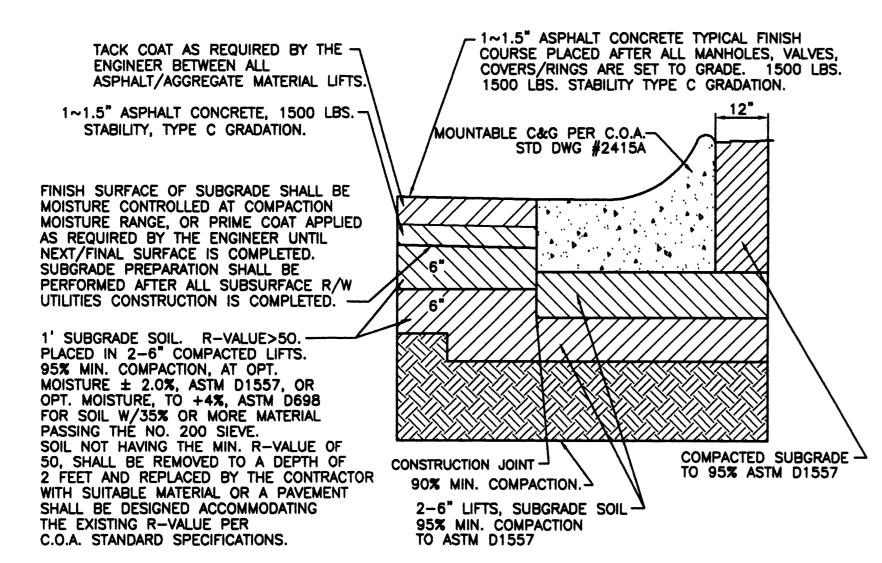


والمسامعة مداعي المرابر المرابر والفرامين فالمتعاصم فيتنا أأراز أأراز الرابر والمرابي المرابي

RESIDENTIAL PAYING SECTION (MOUNTABLE CURB)

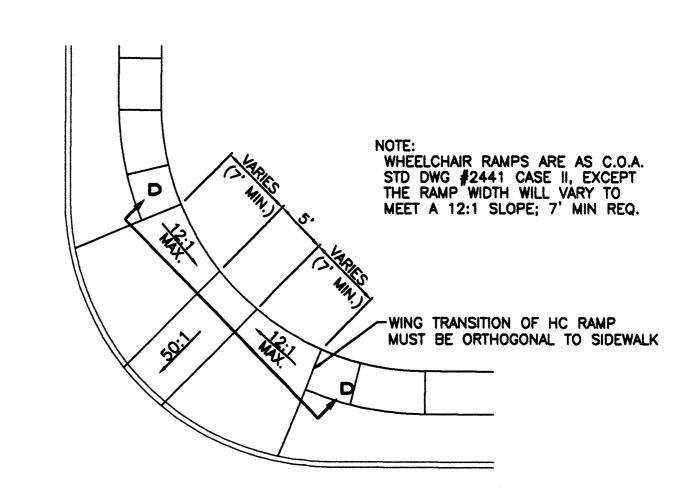

WHEELCHAIR RAMP DETAIL (TYP.)

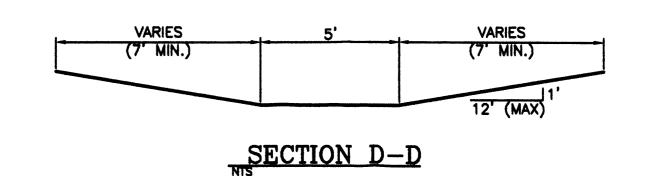

ENGINEER'S SEAL	VENTANA DEL		DRAWN BY _{WCWJ}	
NO 30 NO SOLUTION MESSION MESS	BOSQUE	GRADING	DATE 2-17-06 2600-GRB-1-10-06AX	
		INAGE PLAN		
		Rio Grande	SHEET	
		Engineering 1808 CENTRAL AVENUE SE	2 OI	7 2
DAVID SOULE P.E. #14522		SUITE 201 ALBUQUERQUE, NM 87106 (505) 872-0999	JOB 2600	#

