

SUBDIVISION DATA:

- 1. PRIOR DRB CASE #97-267
2. PRIOR EPC CASE #Z-97-27
3. NEW EPC CASE #07EPC00441/00443
4. ZONE ATLATZ MAP #Z-22-2
5. CURRENT ZONING SU-1 (OFFICE, INSTITUTIONAL & COMMERCIAL)

THIS PROPERTY DOES NOT FALL WITHIN A FLOOD PLAIN. PER FLOOD PANEL INSURANCE RATE MAP, COMMUNITY PANEL #0163F DATED NOV. 19, 2003

BUILDING AREA SUMMARIES

LOT AREA 3.9880 ACRES OR 171,539.28 s.f.

PHASED BUILDING AREA/GROSS FIRST FLOOR AREAS (FOOTPRINT)



Table with 2 columns: PHASE, AREA (s.f.). Rows include PHASE I (15,305 s.f.), PHASE II (5,812 s.f.), PHASE III (2,043 s.f.), PHASE IV (1,200 s.f.), and TOTAL (36,511 s.f.).

Table with 2 columns: SECOND FLOOR AREA, AREA (s.f.). Rows include EXISTING (2,943 s.f.), PHASE I (6,430 s.f.), and TOTAL (9,373 s.f.).

Table with 2 columns: GARDEN LEVEL AREA, AREA (s.f.). Rows include PHASE I (12,300 s.f.) and TOTAL AREA (58,184 s.f.).

MAXIMUM PLANNED BUILDING TO LOT DENSITY = 21.2 % FAR=0.34

Tramway Boulevard NE

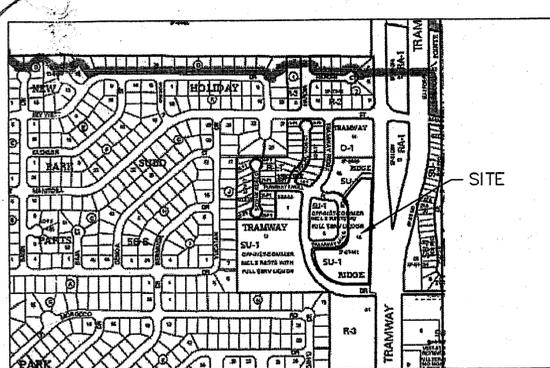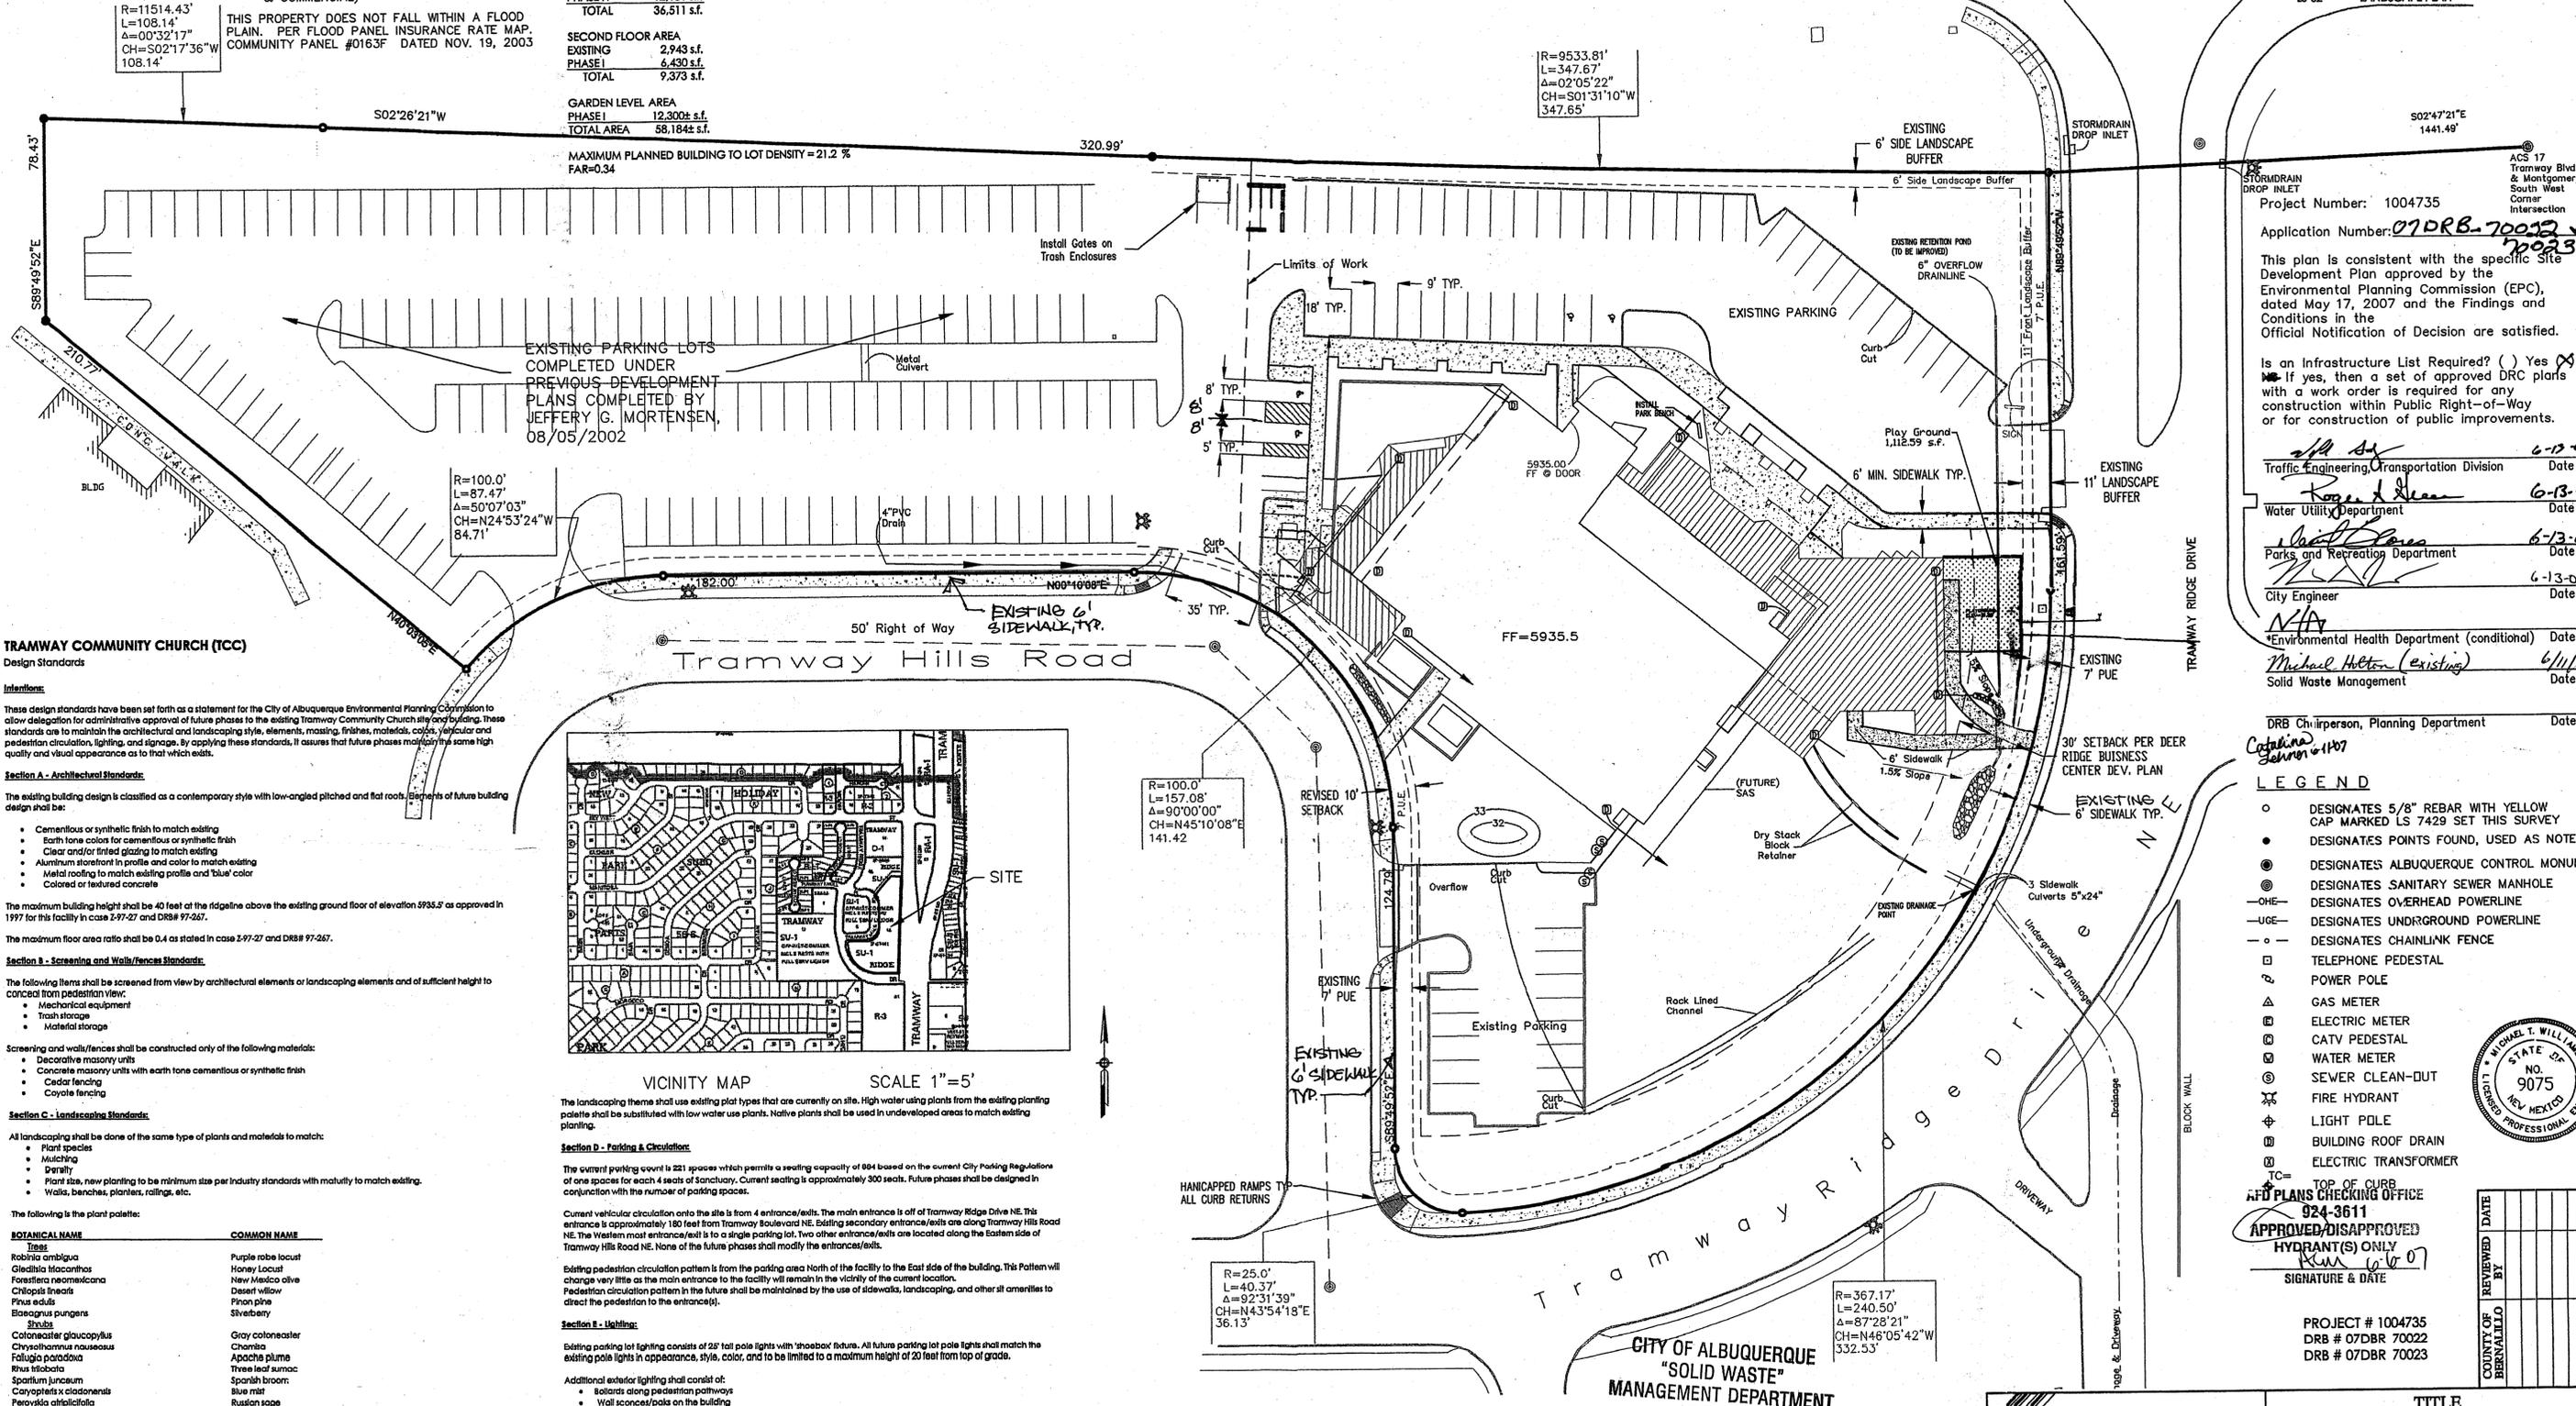

DRAWING INDEX table listing drawing numbers (C-1, C-2, C-2.1, C-3, C-4, A-1.0, LS-02) and their corresponding titles (SITE DEVELOPMENT PLAN, GRADING & DRAINAGE, etc.).

Project Number: 1004735
Application Number: 07DRB-70022 + 70023
This plan is consistent with the specific Site Development Plan approved by the Environmental Planning Commission (EPC), dated May 17, 2007 and the Findings and Conditions in the Official Notification of Decision are satisfied.

DRB Chairperson, Planning Department Date
Michael Holton (Existing) 6/11/07

LEGEND table defining symbols for designations such as 5/8" REBAR WITH YELLOW CAP, ALBUQUERQUE CONTROL MONUMENT, SANITARY SEWER MANHOLE, etc.



TRAMWAY COMMUNITY CHURCH (TCC) Design Standards
Intentions: These design standards have been set forth as a statement for the City of Albuquerque Environmental Planning Commission to allow delegation for administrative approval of future phases to the existing Tramway Community Church site.

Section D - Parking & Circulation
The current parking count is 221 spaces which permits a seating capacity of 884 based on the current City Parking Regulations of one space for each 4 seats of Sanctuary. Current seating is approximately 300 seats.

PLAT OF LOT 1-A BEING A REPLAT OF LOTS 1, 2, 3-A & 6 OF TRAMWAY RIDGE WITHIN THE ELENA GALLEGOS GRANT PROJECTED SECTION 34, T11N, R4E, N.M.P.M AS RECORDED IN THE RECORDS OF BERNALILLO COUNTY CLERKS OFFICE. VOLUME 97C FOLIO 217


CITY OF ALBUQUERQUE "SOLID WASTE" MANAGEMENT DEPARTMENT APPROVED

LAND DEVELOPMENT CONSULTANTS, LLC
5620 B. SAN FRANCISCO DRIVE NE, ALBUQUERQUE, NEW MEXICO 87109
PHONE: (505) 797-4120 FAX: (505) 821-0392

Table with columns for JOB # (07-7001), DATE (APRIL 2007), DRAWN BY (CW), SHEET NO. (C-1), and PROJECT TITLE (TRAMWAY COMMUNITY CHURCH ADDITION AND REMODEL).

1004735

Right of Way Varies
Tramway Boulevard NE

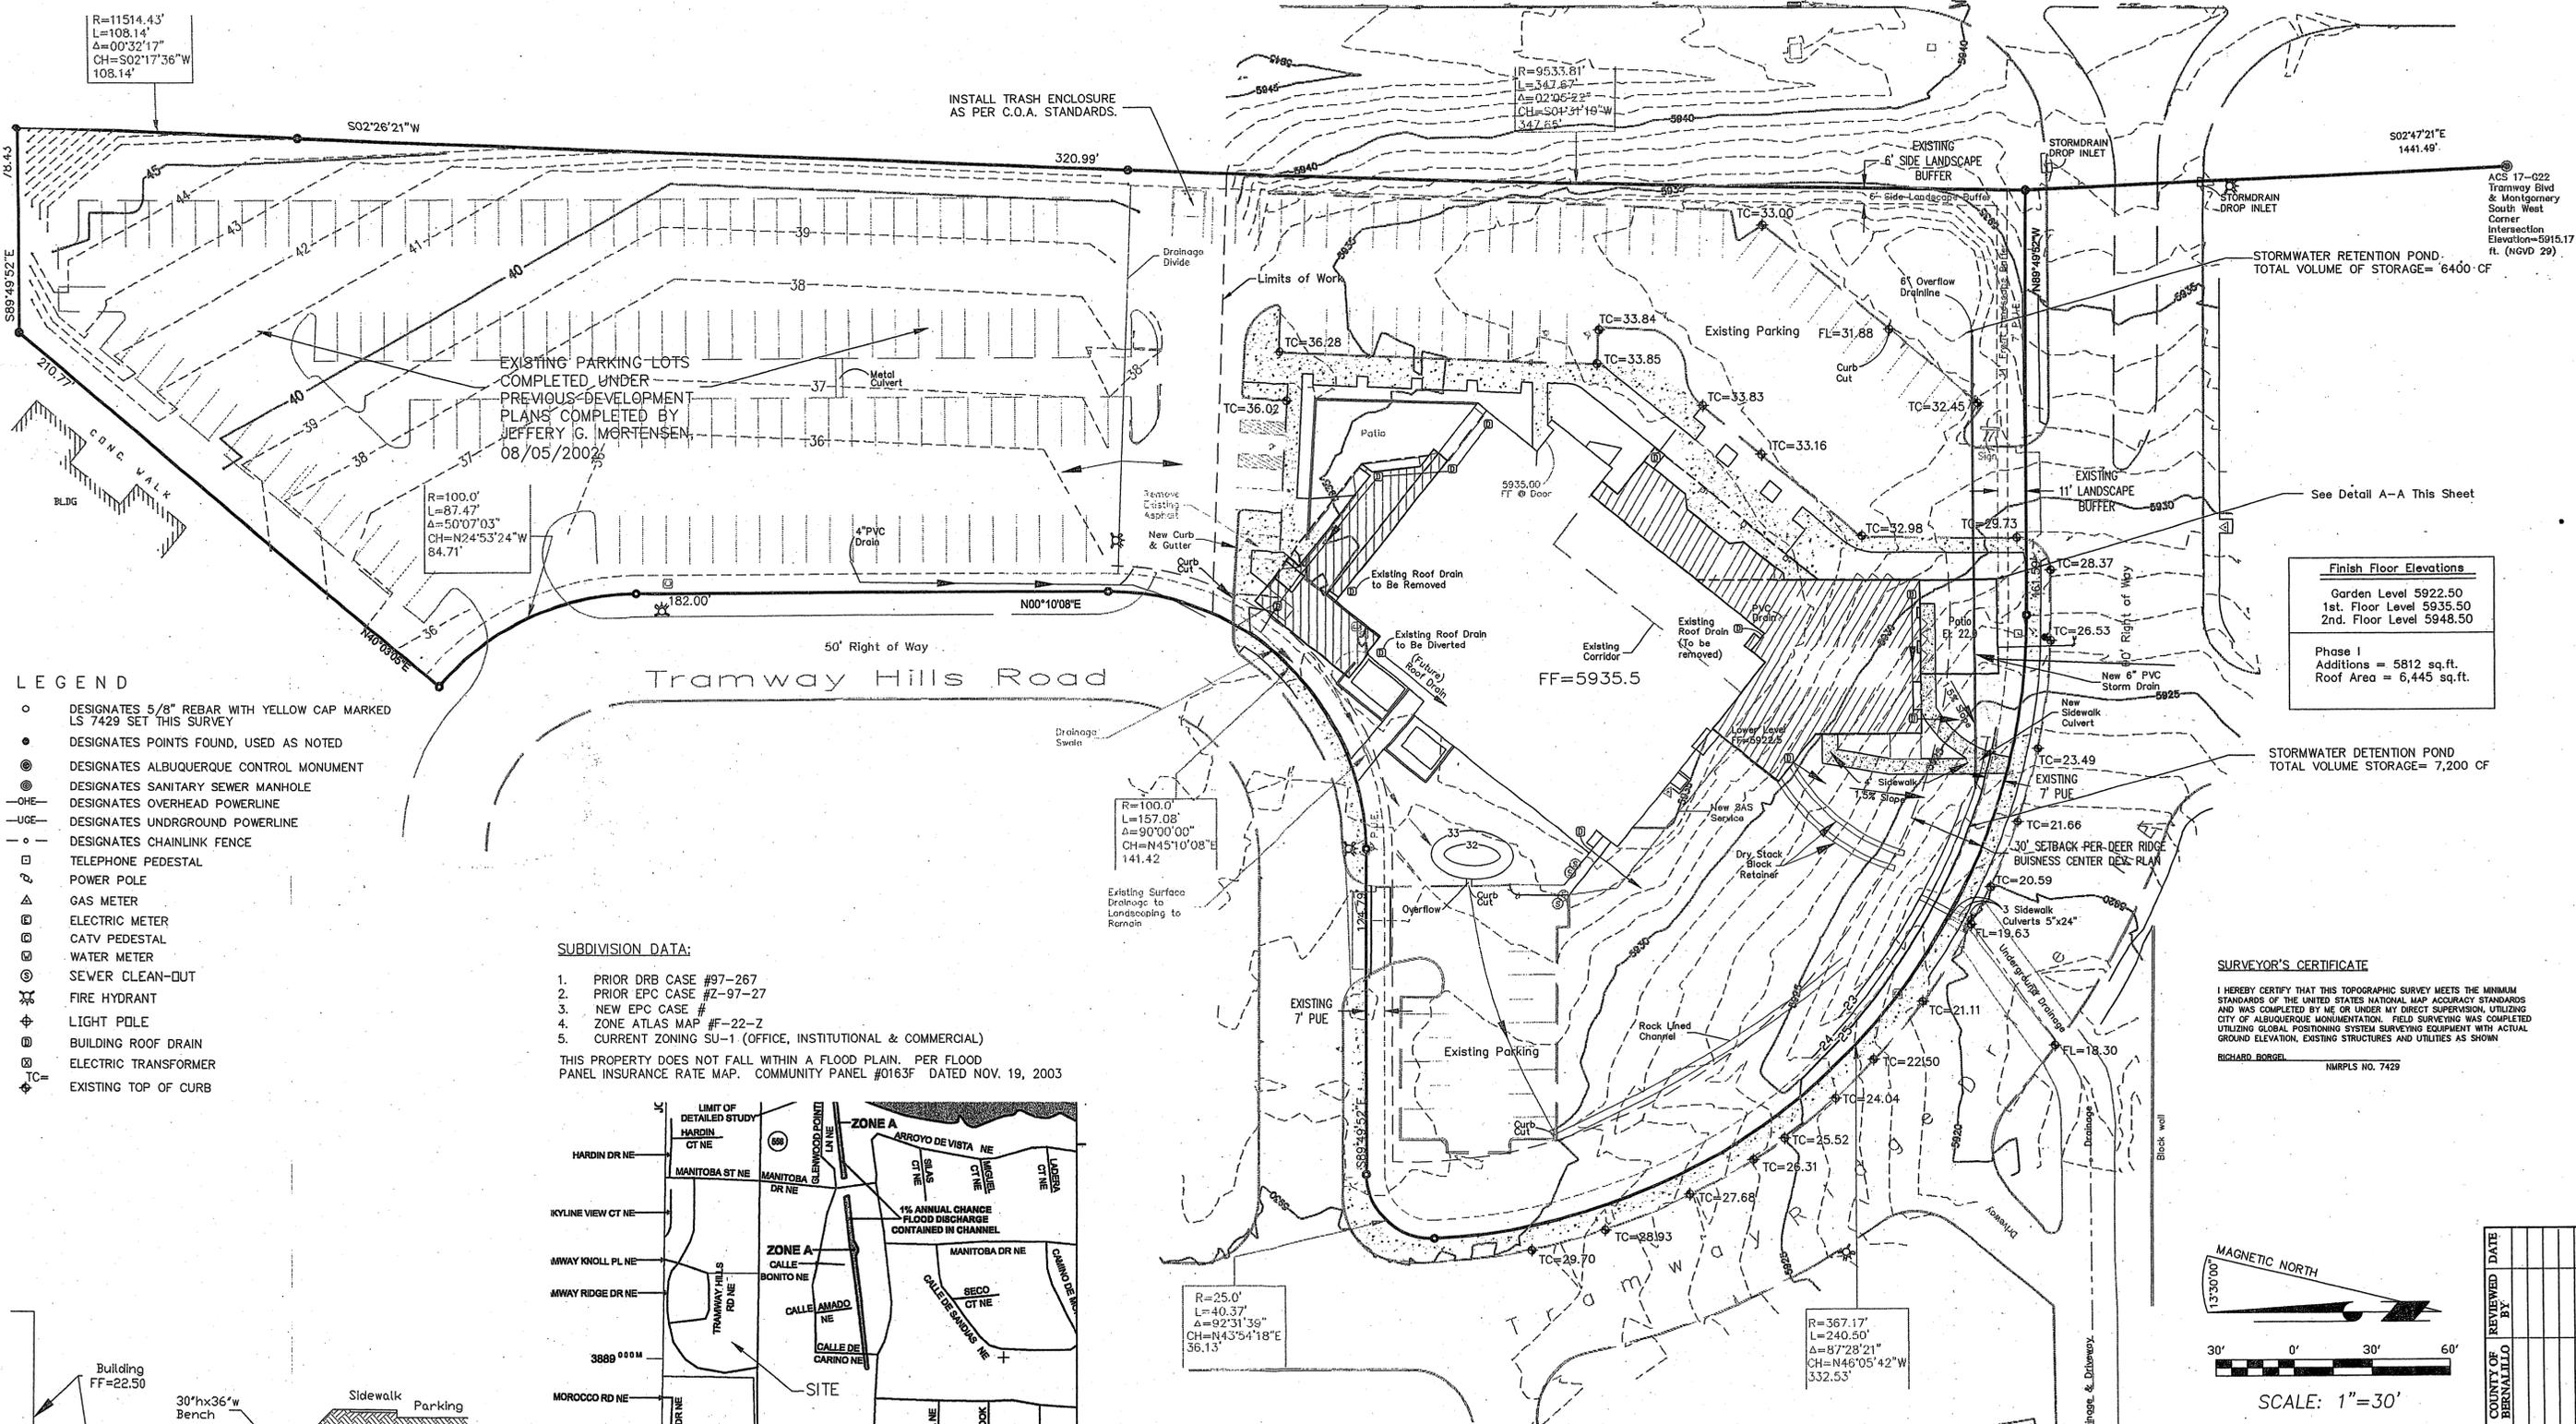

R=11514.43'
L=108.14'
Δ=0°32'17"
CH=S02°17'36"W
108.14'

R=9533.81'
L=347.67'
Δ=02°06'22"
CH=S04°31'19"W
347.65'

R=100.0'
L=87.47'
Δ=50°07'03"
CH=N24°53'24"W
84.71'

R=100.0'
L=157.08'
Δ=90°00'00"
CH=N45°10'08"E
141.42'

R=25.0'
L=40.37'
Δ=92°31'39"
CH=N43°54'18"E
36.13'

R=367.17'
L=240.50'
Δ=87°28'21"
CH=N46°05'42"W
332.53'

LEGEND

- DESIGNATES 5/8" REBAR WITH YELLOW CAP MARKED LS 7429 SET THIS SURVEY
- DESIGNATES POINTS FOUND, USED AS NOTED
- ⊙ DESIGNATES ALBUQUERQUE CONTROL MONUMENT
- ⊕ DESIGNATES SANITARY SEWER MANHOLE
- O—O— DESIGNATES OVERHEAD POWERLINE
- U—U— DESIGNATES UNDERGROUND POWERLINE
- D—D— DESIGNATES CHAINLINK FENCE
- TELEPHONE PEDESTAL
- ⊕ POWER POLE
- ⊕ GAS METER
- ⊕ ELECTRIC METER
- ⊕ CATV PEDESTAL
- ⊕ WATER METER
- ⊕ SEWER CLEAN-OUT
- ⊕ FIRE HYDRANT
- ⊕ LIGHT POLE
- ⊕ BUILDING ROOF DRAIN
- ⊕ ELECTRIC TRANSFORMER
- ⊕ EXISTING TOP OF CURB

EXISTING PARKING LOTS COMPLETED UNDER PREVIOUS DEVELOPMENT PLANS COMPLETED BY JEFFERY G. MORTENSEN 08/05/2002

INSTALL TRASH ENCLOSURE AS PER C.O.A. STANDARDS.

STORMWATER RETENTION POND TOTAL VOLUME OF STORAGE= 6400 CF

Finish Floor Elevations	
Garden Level	5922.50
1st. Floor Level	5935.50
2nd. Floor Level	5948.50
Phase I Additions = 5812 sq.ft. Roof Area = 6,445 sq.ft.	


STORMWATER DETENTION POND TOTAL VOLUME STORAGE= 7,200 CF

SUBDIVISION DATA:




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THIS PROPERTY DOES NOT FALL WITHIN A FLOOD PLAIN. PER FLOOD PANEL INSURANCE RATE MAP. COMMUNITY PANEL #0163F DATED NOV. 19, 2003

SURVEYOR'S CERTIFICATE
I HEREBY CERTIFY THAT THIS TOPOGRAPHIC SURVEY MEETS THE MINIMUM STANDARDS OF THE UNITED STATES NATIONAL MAP ACCURACY STANDARDS AND WAS COMPLETED BY ME OR UNDER MY DIRECT SUPERVISION, UTILIZING CITY OF ALBUQUERQUE MONUMENTATION. FIELD SURVEYING WAS COMPLETED UTILIZING GLOBAL POSITIONING SYSTEM SURVEYING EQUIPMENT WITH ACTUAL GROUND ELEVATION, EXISTING STRUCTURES AND UTILITIES AS SHOWN.
RICHARD BORDEL NMRPLS No. 7429

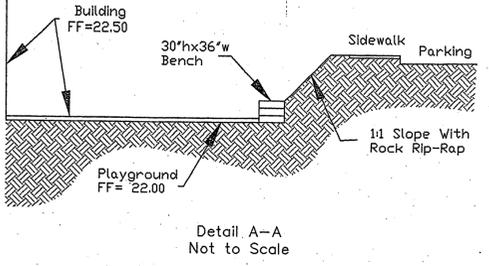

Detail A-A Not to Scale

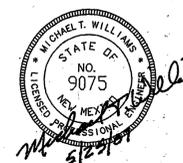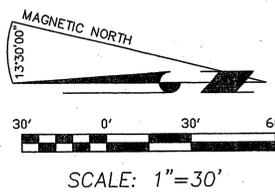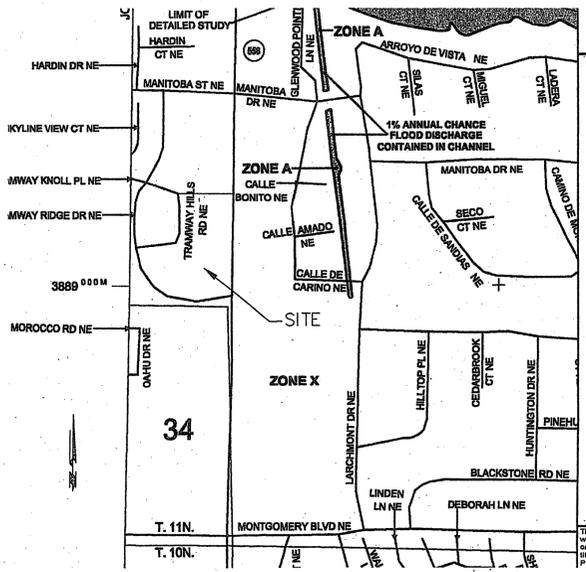

<p>TITLE GRADING & DRAINAGE</p> <p>CITY OF ALBUQUERQUE, BERNALILLO COUNTY, NEW MEXICO</p> <p>PROJECT FOR: TRAMWAY COMMUNITY CHURCH ADDITION AND REMODEL 4800 TRAMWAY RIDGE DR. NE ALBUQUERQUE NEW MEXICO 87111</p>		
<p>5620 B. SAN FRANCISCO DRIVE NE, ALBUQUERQUE, NEW MEXICO 87109 PHONE: (505) 797-4120 FAX: (505) 821-0392 E-MAIL: ldc_jlc@msn.com</p>	<p>JOB #. 07-7001 DATE: APRIL 2007</p>	<p>DRAWN BY: CW SHEET NO. C-2</p>

COUNTY OF	REVIEWED	DATE
BERNALILLO		

MAP NO.

TRAMWAY COMMUNITY CHURCH DRAINAGE PLAN

1. Executive Summary

This project represents a phased expansion of the existing Tramway Community Church. The site is located on the west side of Tramway Boulevard approximately 1/2 mile north of Montgomery Boulevard.

In accordance with the Conceptual Master Drainage Plan (F22/D11A) and the Drainage Grading Plan (F22/D11A5) prepared in 1997, the Tramway Church site is divided into two distinct drainage basins. The southern portion of the site, which contains the church building, limited parking and an existing storm water detention pond, is identified as Basin I. Basin I outlets at a controlled rate to an existing drainage easement at the southwest corner of the site. The northern portion of the site is primarily devoted to parking and is identified as Basin II. Basin II outlets at a controlled rate to Knoll Place, a public street that borders the west side of the Basin II area.

This project will involve the phased expansion of the Church building facilities located in the Basin I drainage area. Storm water runoff will continue to be discharged to the existing drainage easement at a controlled rate in accordance with the previously established limits.

The submittal is made in support of the foundation and grading permit approvals for construction purposes.

2. Project Description

As shown on the vicinity map, the site is located on the west side of Tramway Boulevard NE at the northeast corner of the intersection with Tramway Ridge NE. The legal description of the site is Lot 1A, Tramway Ridge.

Panel 163 of 825 of the National Flood Insurance Program Flood Insurance Rate Maps for Bernalillo County, New Mexico, and dated November 19, 2003 shows that the site does not lie within or adjacent to a designated flood hazard zone. However, in accordance with the previously approved Conceptual Drainage Plan and Drainage/Grading Plan (F22/D11A) and F22/D11A5, the site is subject to a controlled storm water discharge.

The project consists of the phased expansion of the existing church building that is located within the boundaries of the previously defined Basin I drainage area. Phases I & II are included in the current project and Phases III & IV are to be constructed in the future.

3. Background Documents

The preparation of this drainage plan utilized the following previous submittal documents for the Tramway Church Site.

- A. F22/D11A: Original Master Drainage Plan prepared by Espey-Huston Associates identifying downstream capacity limits and designing the downstream improvements that are now in place.
- B. F22/D11A5: Original Drainage/Grading Plan for the Tramway Church site prepared by C.L. Weiss Engineering Inc. and dated 6-19-97. This plan defined the allowable discharge limit for the Basin I drainage area as 3.3 cfs/acre and the allowable discharge limit for the Basin II drainage area as 2.9 cfs/acre. This plan also designed the existing drainage improvements for the Basin I drainage area.
- C. F22/D11A: Drainage/Grading Plan for Phase 2 prepared by Jeff Mortensen & Associates Inc. and dated 8-05-2002. This plan designed the drainage improvements for the Basin II drainage area.

4. Existing Conditions

The site is already developed. The existing conditions are shown on the Grading & Drainage Plan of this submittal. As discussed above, the site is divided into two distinct drainage basins. The basin boundaries are shown on the Plan sheet.

The southern portion of the site, identified as Basin I, is occupied by the existing church building as well as limited amounts of parking areas and the existing storm water detention pond. Flows from this basin discharge to the existing drainage easement at the southwest corner of the site.

The northern portion of the site, identified as Basin II, is primarily composed of paved parking areas. Basin II discharges to the Knoll Place right-of-way along the western side of the site.

Offsite drainage that enters the site is from the westerly portion of the Tramway Boulevard right-of-way that borders the eastern side of the site. The right-of-way is characterized by native landscaping.

5. Proposed Conditions

The proposed development is shown on the Grading & Drainage Plan and consists of the phased expansion of the existing church building facilities. The proposed development is confined to the Basin I drainage area. The drainage is designed to limit the maximum rate of discharge to the previously approved rate of 3.3 cfs/acre.

6. Grading Plan

The Grading & Drainage Plan shows the following:

- A. The boundaries of Basin I, Basin II, and the sub-basins used in the storm water analyses.
- B. The existing site grades.
- C. The proposed site grades.
- D. The proposed phased building additions.

As previously stated, the proposed improvements will impact the Basin I drainage area only. The drainage for the Basin II area will not be altered. The grading plans show that the existing drainage patterns for the Basin I area will not be significantly altered.

7. Calculations

Storm water drainage calculations have been performed for the Basin I area analyzing the proposed conditions. The analyses were based on the 100-Year, 6-Hour rainfall event. The analyses procedures were in accordance with the methodology set forth in Chapter 22 of the City of Albuquerque Development Process Manual, October 2006 revision.

As shown by the calculation results, the discharge from the Basin I area for the proposed conditions will be limited to a maximum of 3.3 cfs/acre in accordance with the previously determined allowable discharge rates.

8. Conclusions

The proposed control and discharge of runoff from the Basin I area resulting from the proposed development is appropriate based upon the following:

- A. The rate of runoff conforms to the previously established limited downstream capacity conditions.
- B. The existing drainage pattern will not be significantly altered.
- C. The drainage plan is consistent with previously approved submittals.

All onsite drainage improvements will be owned, operated and maintained by the Church. The downstream streets and storm drainage systems are owned, operated maintained by either Albuquerque Public Works Department or the underlying property owner.

Tramway Community Church
Projected Storm Water Runoff

Note: Basis of design per Albuquerque Development Process Manual Chapter 22, October 2006 Revision

A. Precipitation Zone: Zone 4 per Table A-1

B. Precipitation Depth: per Table A-2

1. 100 Year, 6 Hour Storm = 2.80 inches

C. Excess Precipitation: per Table A-8

Treatment	100 Yr	2 Yr	10 Yr
A	0.89	0.02	0.28
B	1.08	0.11	0.46
C	1.48	0.27	0.73
D	2.84	1.01	1.88

D. Peak Discharges: per Table A-9

Treatment	Peak Discharge: CFS/Acre
A	2.20
B	2.92
C	3.75
D	5.25

E. Sub Basin 1

1. Drainage Areas and Treatment Classifications

Description	Area: SF	Treatment Class
Parking Lot	17,457	D
Sidewalk	4,245	D
Exist. Bldg	9,110	D
Phase I Addition	6,141	D
Open area	4,128	B

Total Area = 40,181 SF
Treatment B = 4,128 SF
Treatment D = 35,973 SF

2. Runoff Volumes

a. 100 Year - 6 Hour Storm
Volume = (4,128)(1.08/12) + (35,973)(2.84/12) = 7,588 CF

3. Peak Discharge
Qp = (4,128/43560)(2.92) + (35,973/43560)(5.25) = 0.28 + 4.34 = 4.62 CFS

F. Sub Basin 2

1. Drainage Areas and Treatment Classifications

Description	Area: SF	Treatment Class
Parking Lot	987	D
Sidewalk	242	D
Open area	480	B

Total Area = 1,709 SF
Treatment B = 480 SF
Treatment D = 1,220 SF

2. Runoff Volumes

a. 100 Year - 6 Hour Storm
Volume = (480)(1.08/12) + (1,220)(2.84/12) = 311 CF

3. Peak Discharge
Qp = (480/43560)(2.92) + (1,220/43560)(5.25) = 0.03 + 0.15 = 0.18 CFS

G. Sub Basin 3

1. Drainage Areas and Treatment Classifications

Description	Area: SF	Treatment Class
Parking Lot	0	D
Sidewalk	38	D
Exist. Bldg	7,895	D
Future Bldg (Phase IV)	12,420	D
Open area	1,430	B

Total Area = 21,583 SF
Treatment B = 1,430 SF
Treatment D = 20,153 SF

2. Runoff Volumes

a. 100 Year - 6 Hour Storm
Volume = (1,430)(1.08/12) + (20,153)(2.84/12) = 4,563 CF

3. Peak Discharge
Qp = (1,430/43560)(2.92) + (20,153/43560)(5.25) = 0.10 + 2.43 = 2.53 CFS

H. Sub Basin 4

1. Drainage Areas and Treatment Classifications

Description	Area: SF	Treatment Class
Parking Lot	5,840	D
Sidewalk	2,149	D
Future Bldg (Phase III)	1,839	D
Open area	5,800	B

Total Area = 15,428 SF
Treatment B = 5,800 SF
Treatment D = 9,628 SF

2. Runoff Volumes

a. 100 Year - 6 Hour Storm
Volume = (5,800)(1.08/12) + (9,628)(2.84/12) = 2,840 CF

3. Peak Discharge
Qp = (5,800/43560)(2.92) + (9,628/43560)(5.25) = 0.39 + 1.18 = 1.55 CFS

I. Sub Basin 5

1. Drainage Areas and Treatment Classifications

Description	Area: SF	Treatment Class
Pond Area	4,806	C

Total Area = 4,806 SF
Treatment C = 4,806 SF

2. Runoff Volumes

a. 100 Year - 6 Hour Storm
Volume = (4,806)(1.48/12) = 585 CF

3. Peak Discharge
Qp = (4,806/43560)(3.73) = 0.41 CFS

J. Sub Basin 6

1. Drainage Areas and Treatment Classifications

Description	Area: SF	Treatment Class
Open Area	8,733	B
Playground	1,295	C

Total Area = 10,028 SF
Treatment B = 8,733 SF
Treatment C = 1,295 SF

2. Runoff Volumes

a. 100 Year - 6 Hour Storm
Volume = (8,733)(1.08/12) + (1,295)(1.48/12) = 943 CF

3. Peak Discharge
Qp = (8,733/43560)(2.92) + (1,295/43560)(3.73) = 0.58 + 0.11 = 0.69 CFS

K. Sub Basin 7

1. Drainage Areas and Treatment Classifications

Description	Area: SF	Treatment Class
Parking Lot	10,360	D
Sidewalk	480	D
Phase II Addition	1,150	D
Open Area	480	B

Total Area = 12,400 SF
Treatment B = 480 SF
Treatment D = 12,000 SF

2. Runoff Volumes

a. 100 Year - 6 Hour Storm
Volume = (400)(1.08/12) + (12,000)(2.84/12) = 2,676 CF

3. Peak Discharge
Qp = (400/43560)(2.92) + (12,000/43560)(5.25) = 0.03 + 1.45 = 1.48 CFS

Total Area for Basin I
Total Area = A1 + A2 + A3 + A4 + A5 + A6 + A7

Total Area = 49,101 + 1,709 + 21,583 + 15,428 + 4,800 + 10,028 + 12,400 = 104,049 SF = 2.43 Acres

M. Maximum Allowable Discharge:

In accordance with the originally approved Master Drainage Plan (F22/D11A), the maximum allowable discharge for the Basin I drainage area was based upon an allowable discharge of 3.3 cfs/acre. Thus, the maximum allowable discharge based upon the total drainage area of 4.02 acres is 0.02 cfs.

N. Control of Basin I Discharge:

A. Maximum Uncontrolled Discharge
Q total = Q1 + Q2 + Q3 + Q4 + Q5 + Q6 + Q7
= 4.93 + 0.18 + 2.53 + 1.55 + 0.81 + 0.89 + 1.48 = 11.48 cfs


B. Maximum Allowable Discharge (see M above) = 0.02 cfs. Therefore, need to provide outlet control to reduce the maximum uncontrolled discharge by 3.44 cfs.

C. Use of Existing Stormwater Detention Basin at Southwest Corner of Site to Control Discharge

1. Hydrograph of Flow to Detention Basin

a. Contributing Areas = Sub Basins 1 and 5
b. Base Time: Tbase = (2.107)(E)(A total)(Q peak) / (0.25)(Area D)(A total)
A total = 40,181 + 4,800 = 44,987 sf = 1.03 acres
Q peak = 4.82 + 0.41 = 5.03 cfs
Area D = 35,973 + 0 = 35,973 sf = 0.83 acres
E = (V1 + V5) / A total = (7,588 + 585) / 44,987 = 0.18 ft = 2.16 inches
Tbase = (2.107)(2.16)(44,987)(5.03) / (0.25)(35,973)(11.48) = 0.94 = 0.71 hr

c. Time to Peak: T peak = (0.7)(Tc) + ((1.8 - Area D/A total)(Tc))
Tc = 0.2 hr, thus T peak = (0.7)(0.2) + ((1.8 - 0.83/1.03)(0.2)) = 0.21 hr

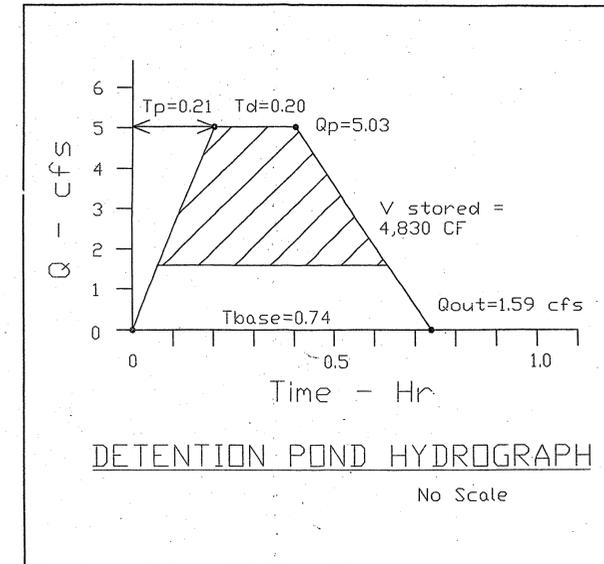

1. Allowable Basin Discharge
Q allow = 0.02 - (Q2 + Q3 + Q4 + Q6 + Q7)
= 0.02 - (0.18 + 2.53 + 1.55 + 0.89 + 1.48) = 1.59 cfs

2. Detention Pond Storage Required
From Hydrograph analysis, storage required = 4,830 CF

3. Available Detention Pond Storage

Contour Elevation	Area - SF	Volume - CF
5931	1,220	1,830
5932	2,440	4,830
5932.5	5,200	3,820
Total Volume		5,850

Since available storage of 5,850 cf exceeds required storage of 4,830 cf, the existing pond is adequate.


4. Pond Outlet
The existing detention pond outlet standpipe is a 6-inch pipe with seven 1-inch diameter outlet orifices. From the above computations, the outlet must pass 1.59 cfs. Using the available head of 1.5 feet, the total orifice area required is:
Q = (C)(A)(2gh)^{0.5}
1.59 = (0.6)(A)(98.6)^{0.5} = (0.6)(A)(9.83), Thus A = 0.27 SF
A 2-inch diameter orifice has an area of 0.022 SF. Thus, re-drill standpipe to provide twelve 2-inch diameter orifices.

TITLE DRAINAGE PLANS & CALCULATIONS	
CITY OF ALBUQUERQUE, BERNALILLO COUNTY, NEW MEXICO	
PROJECT FOR: TRAMWAY COMMUNITY CHURCH ADDITION AND RENOVEL 4800 TRAMWAY RIDGE DR. NE ALBUQUERQUE NEW MEXICO 87111	
LAND DEVELOPMENT CONSULTANTS, LLC An Associate Firm of Williams & Beck, Inc.	5620 B. SAN FRANCISCO DRIVE NE, ALBUQUERQUE, NEW MEXICO 87109 PHONE: (505) 797-4120 FAX: (505) 821-0392 E-MAIL: ldc_llc@msn.com
JOB # 07-7001	DRAWN BY: CW
DATE: APRIL 2007	SHEET NO. C-2.1

COUNTY OF BERNALILLO	REVIEWED BY	DATE


MAP NO.

Tramway Boulevard NE

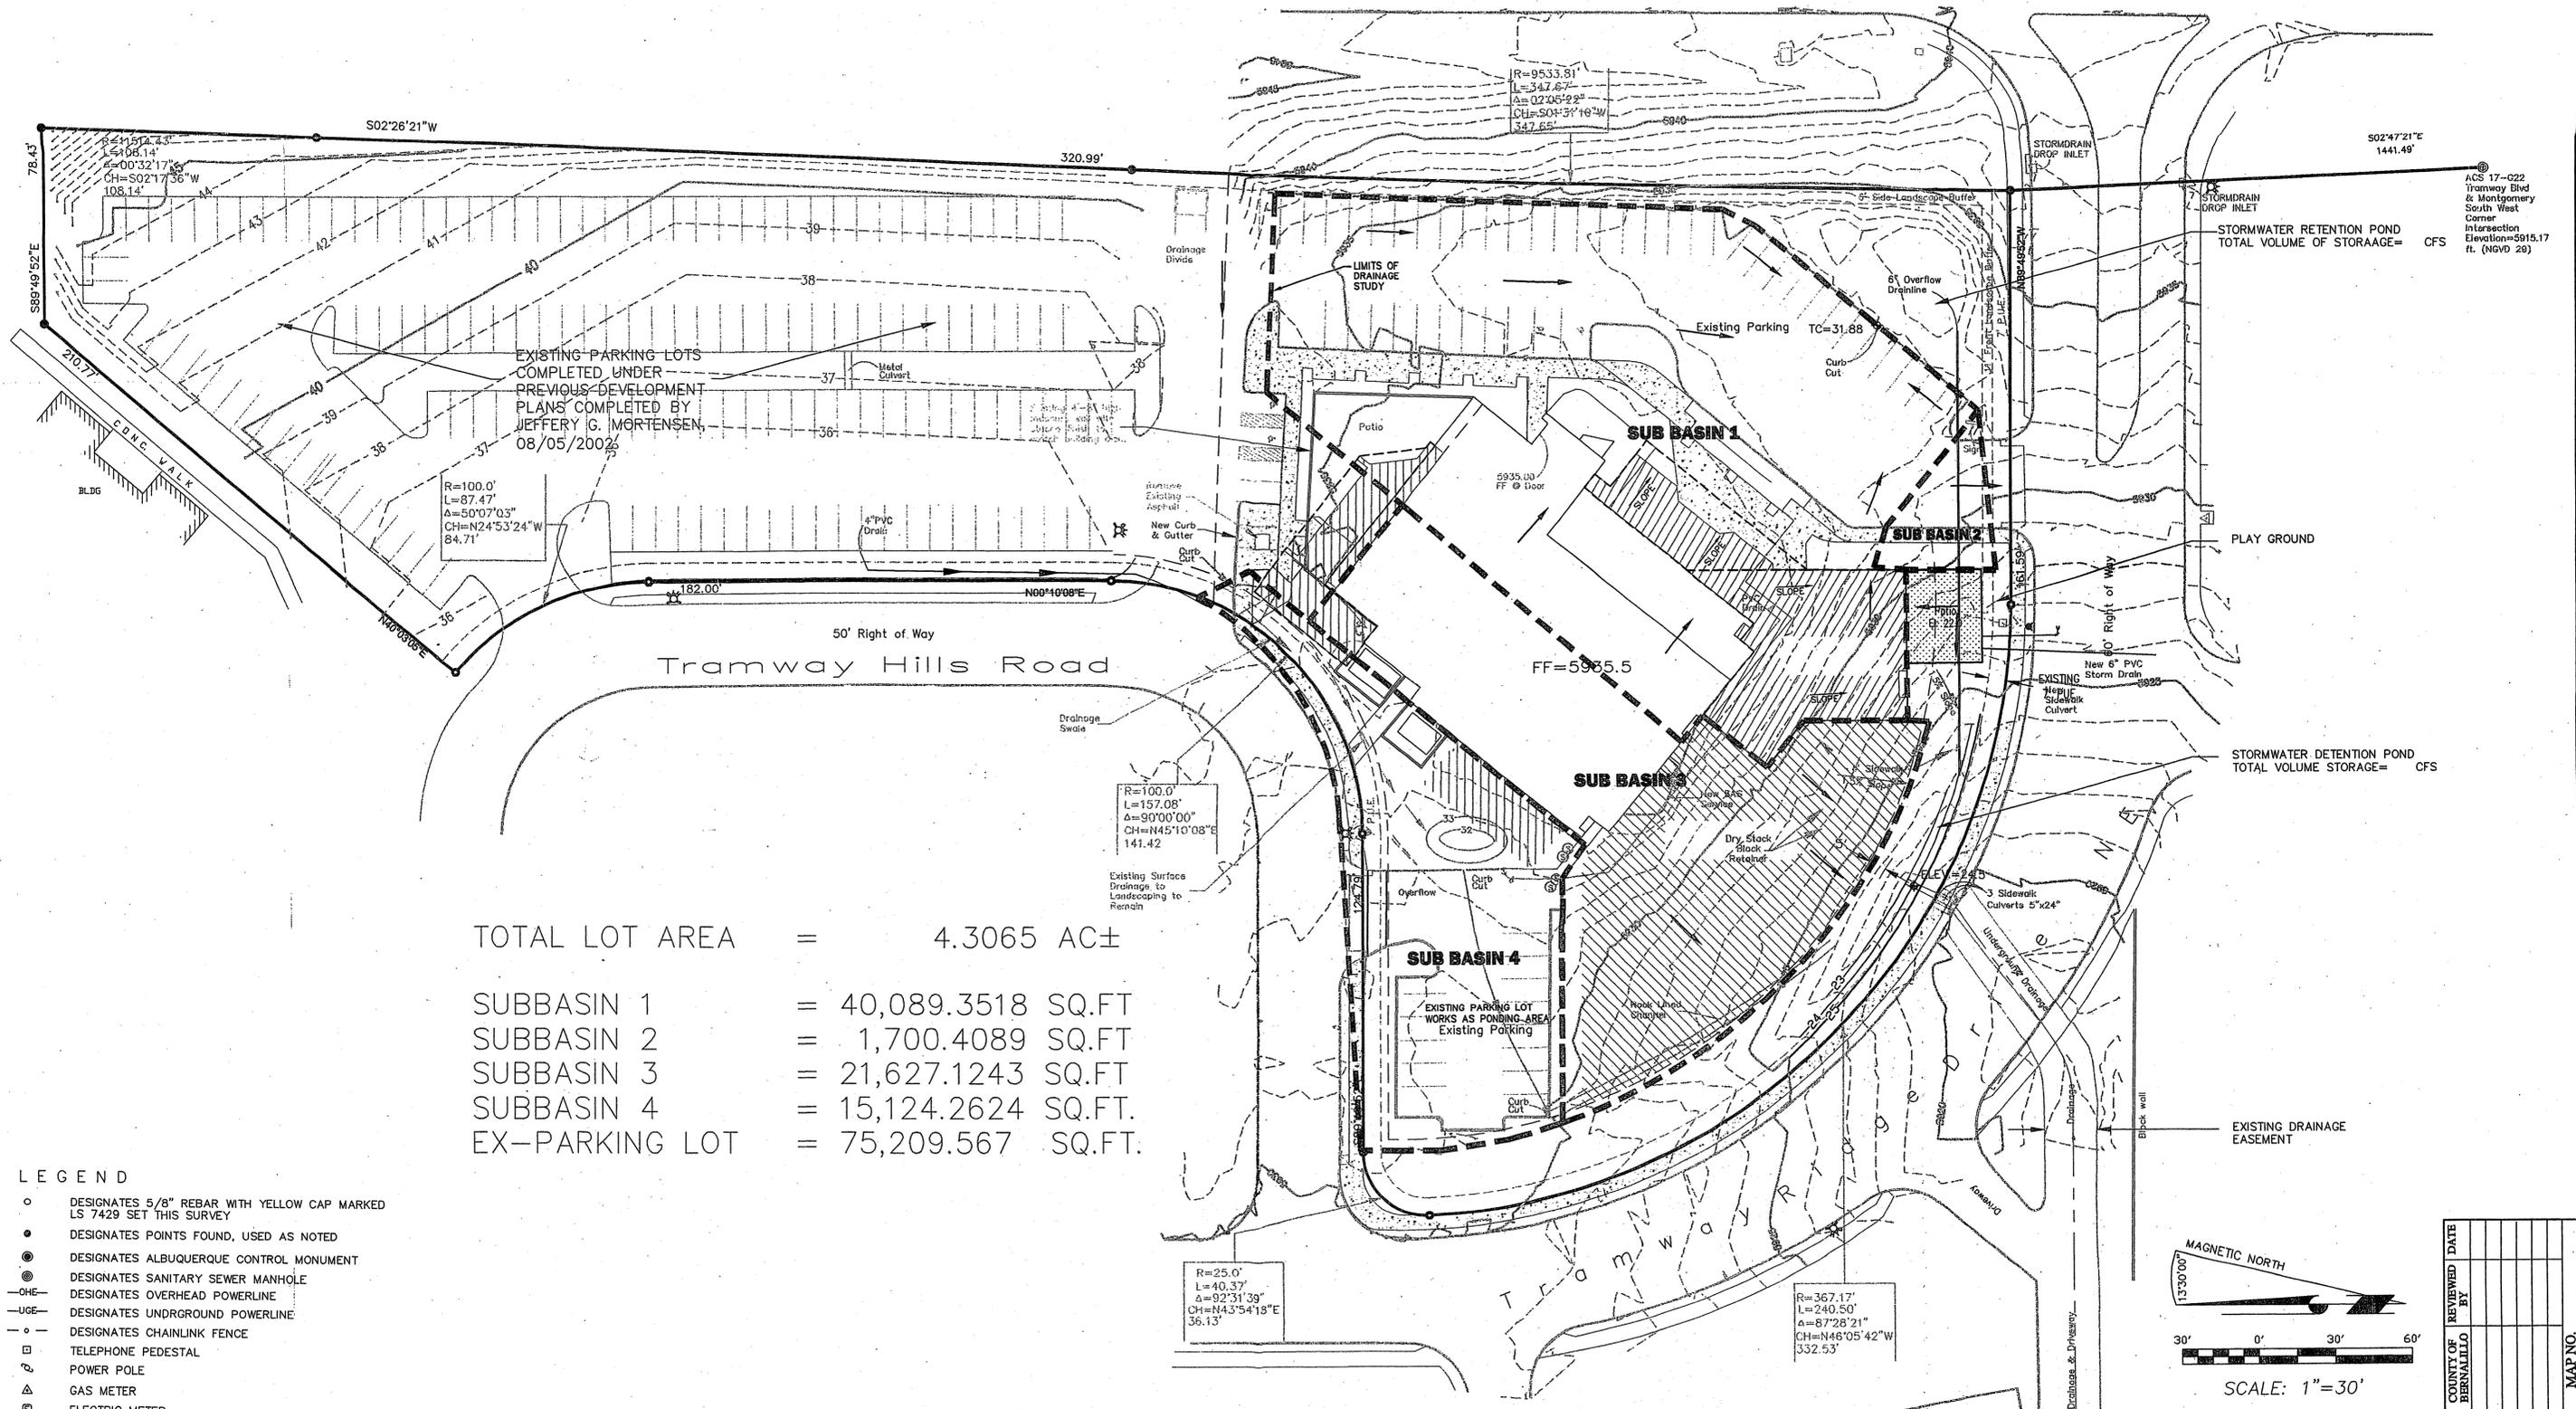

TOTAL LOT AREA	=	4.3065 AC±
SUBBASIN 1	=	40,089.3518 SQ.FT
SUBBASIN 2	=	1,700.4089 SQ.FT
SUBBASIN 3	=	21,627.1243 SQ.FT
SUBBASIN 4	=	15,124.2624 SQ.FT.
EX-PARKING LOT	=	75,209.567 SQ.FT.

- LEGEND**
- DESIGNATES 5/8" REBAR WITH YELLOW CAP MARKED LS 7429 SET THIS SURVEY
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 - ⊠ WATER METER
 - ⊠ SEWER CLEAN-OUT
 - ⊠ FIRE HYDRANT
 - ⊠ LIGHT POLE
 - ⊠ BUILDING ROOF DRAIN
 - ⊠ ELECTRIC TRANSFORMER
 - ⊠ TOP OF CURB

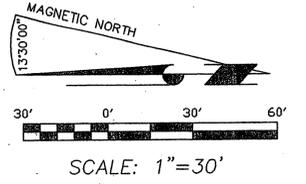


<p>LAND DEVELOPMENT CONSULTANTS, LLC An Associate Firm of Williams & Beck, Inc.</p> <p>5620 B. SAN FRANCISCO DRIVE NE, ALBUQUERQUE, NEW MEXICO 87109 PHONE: (505) 797-4120 FAX: (505) 821-0392 E-MAIL: ldc_llc@msn.com</p>	<p>TITLE STORM WATER MANAGEMENT PLAN</p> <p>CITY OF ALBUQUERQUE, BERNALILLO COUNTY, NEW MEXICO</p> <p>PROJECT FOR: TRAMWAY COMMUNITY CHURCH ADDITION AND REMODEL 4800 TRAMWAY RIDGE DR. NE ALBUQUERQUE NEW MEXICO 87111</p>	
	<p>DATE: APRIL 2007</p>	<p>JOB #: 07-7001</p> <p>DRAWN BY: CW</p> <p>SHEET NO. C-3</p>




COUNTY OF BERNALILLO	REVIEWED DATE	BY	DATE	BY	DATE

MAP NO.

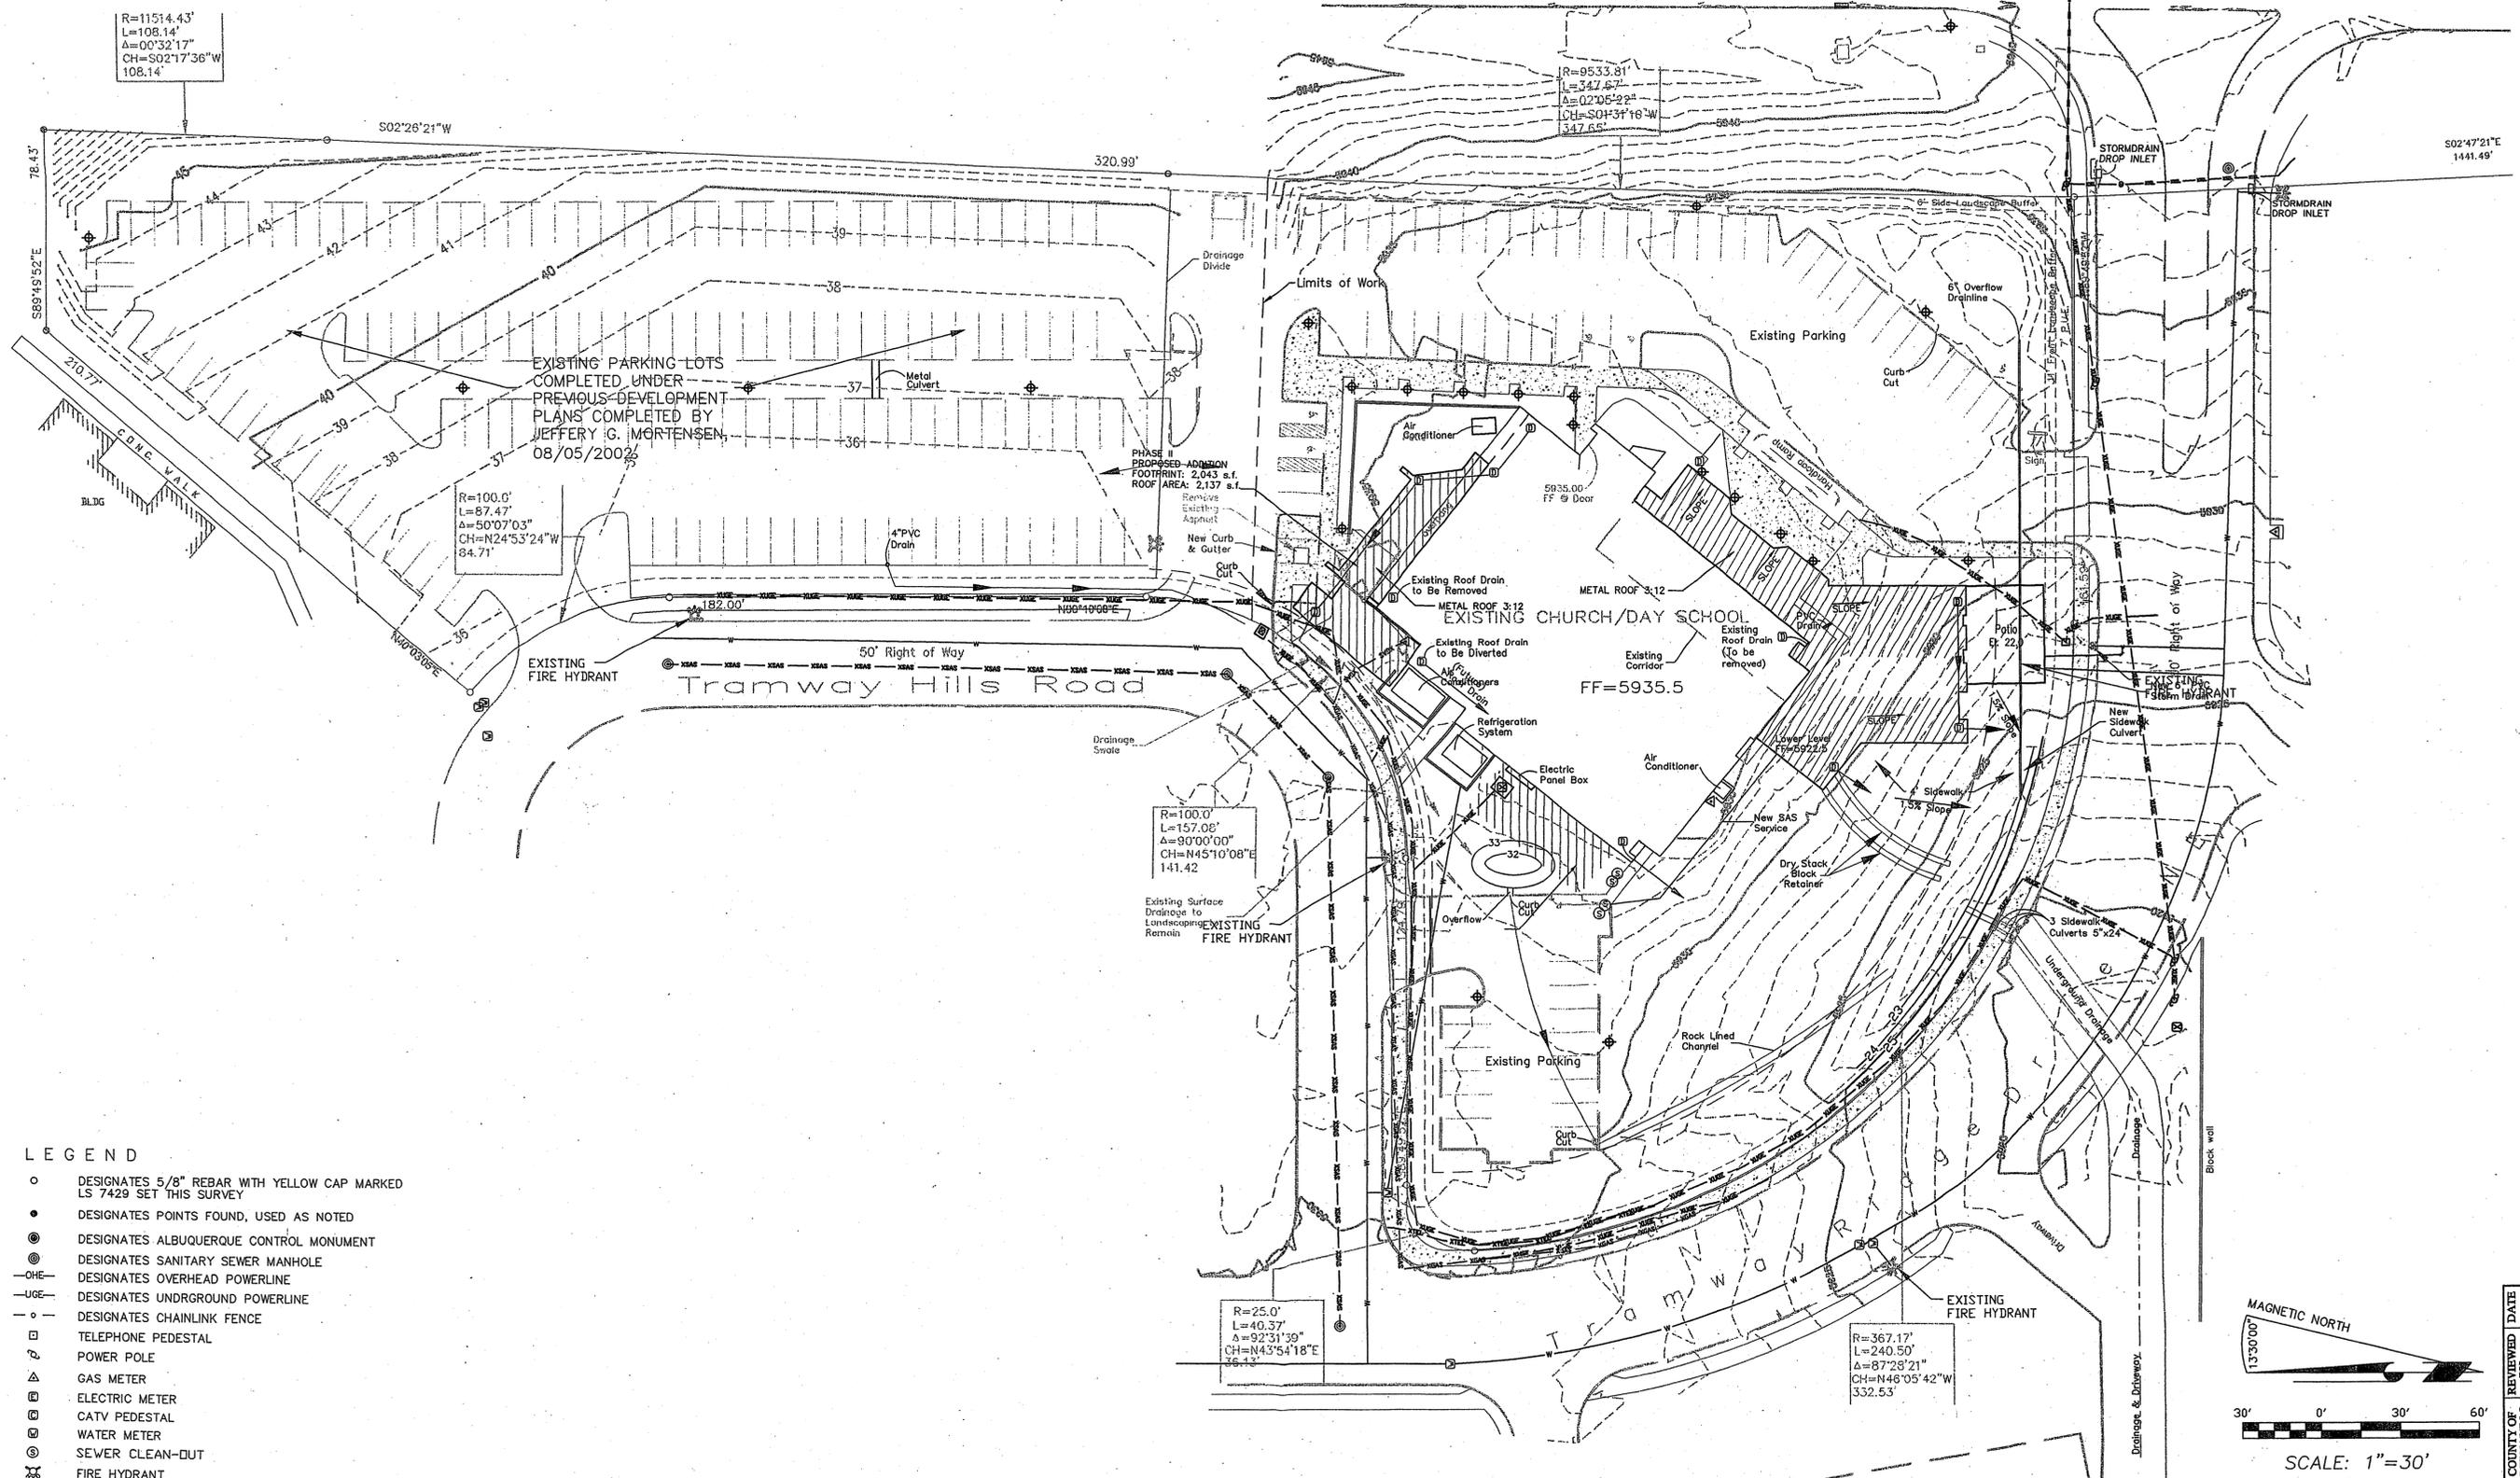


- LEGEND**
- DESIGNATES 5/8" REBAR WITH YELLOW CAP MARKED LS 7429 SET THIS SURVEY
 - DESIGNATES POINTS FOUND, USED AS NOTED
 - ⊙ DESIGNATES ALBUQUERQUE CONTROL MONUMENT
 - ⊙ DESIGNATES SANITARY SEWER MANHOLE
 - O—O— DESIGNATES OVERHEAD POWERLINE
 - U—U— DESIGNATES UNDERGROUND POWERLINE
 - C—C— DESIGNATES CHAINLINK FENCE
 - TELEPHONE PEDESTAL
 - POWER POLE
 - △ GAS METER
 - ELECTRIC METER
 - CATV PEDESTAL
 - WATER METER
 - ⊙ SEWER CLEAN-OUT
 - ⊙ FIRE HYDRANT
 - ⊙ LIGHT POLE
 - ⊙ BUILDING ROOF DRAIN
 - ⊙ ELECTRIC TRANSFORMER
 - ⊙ TC= TOP OF CURB

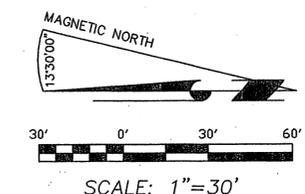

LAND DEVELOPMENT CONSULTANTS, LLC An Associate Firm of Williams & Beck, Inc. 5620 B. SAN FRANCISCO DRIVE NE, ALBUQUERQUE, NEW MEXICO 87109 PHONE: (505) 797-4120 FAX: (505) 821-0392 E-MAIL: ldc_llc@msn.com	TITLE UTILITY PLAN CITY OF ALBUQUERQUE, BERNALILLO COUNTY, NEW MEXICO PROJECT FOR: TRAMWAY COMMUNITY CHURCH ADDITION AND REMODEL 4800 TRAMWAY RIDGE DR. NE ALBUQUERQUE NEW MEXICO 87111	
	JOB #: 07-7001 DATE: APRIL 2007	DRAWN BY: CW SHEET NO. C-4


COUNTY OF	REVIEWED	DATE
BERNALILLO	BY	

MAP NO.

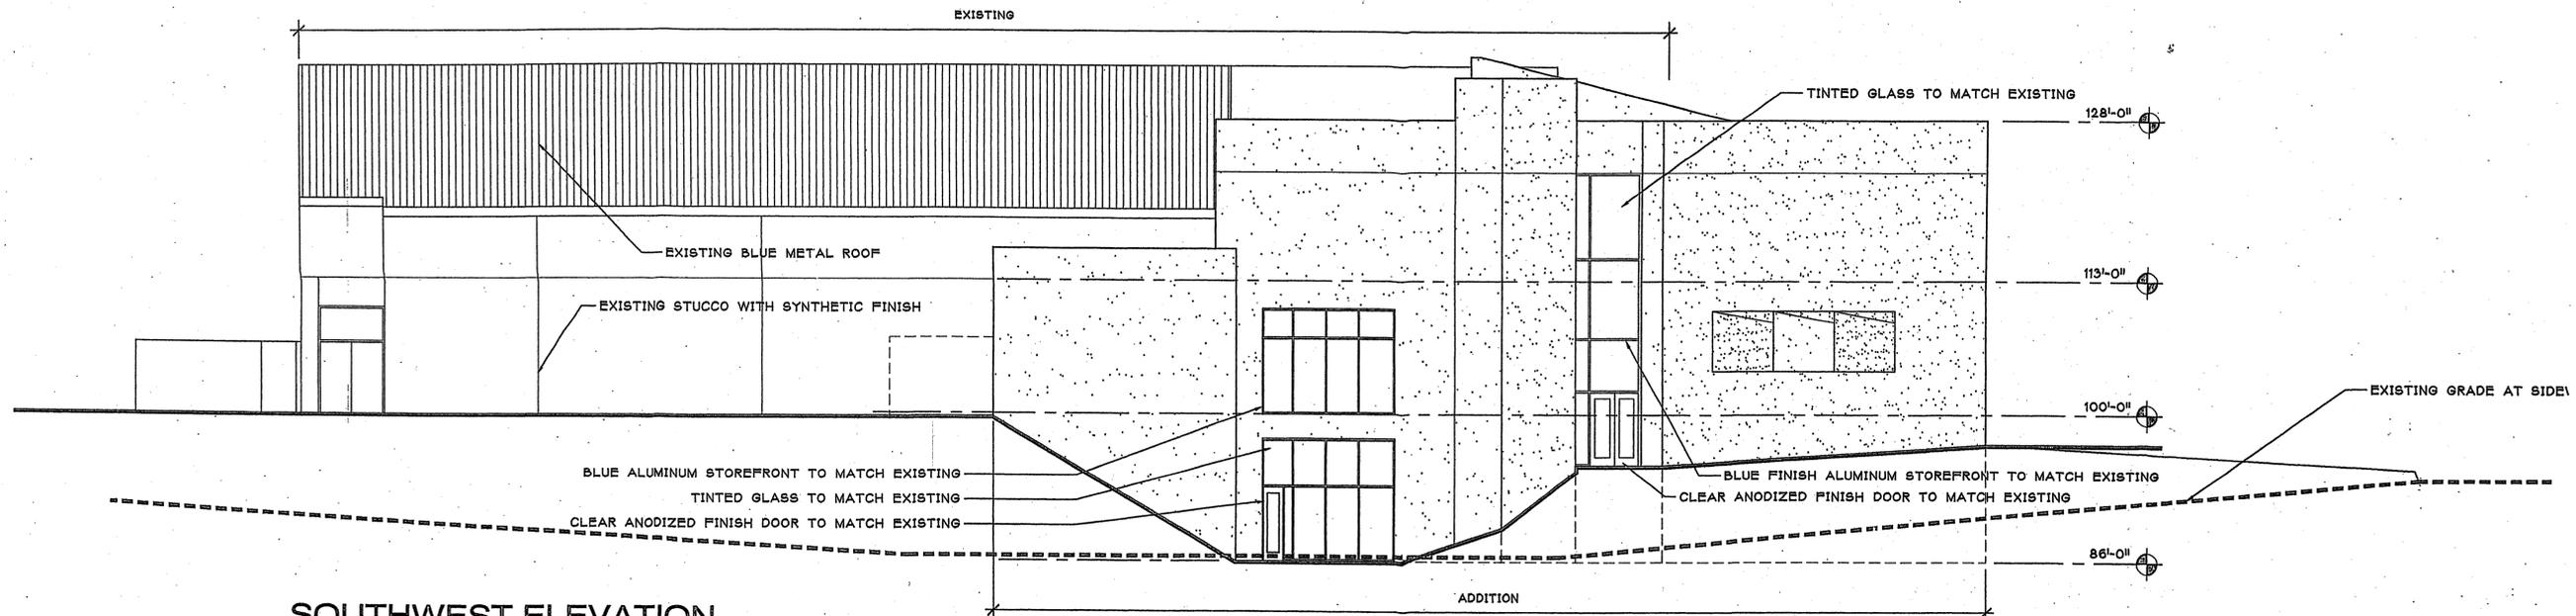


SOUTHWEST ELEVATION

SCALE: 1/8" = 1' - 0"

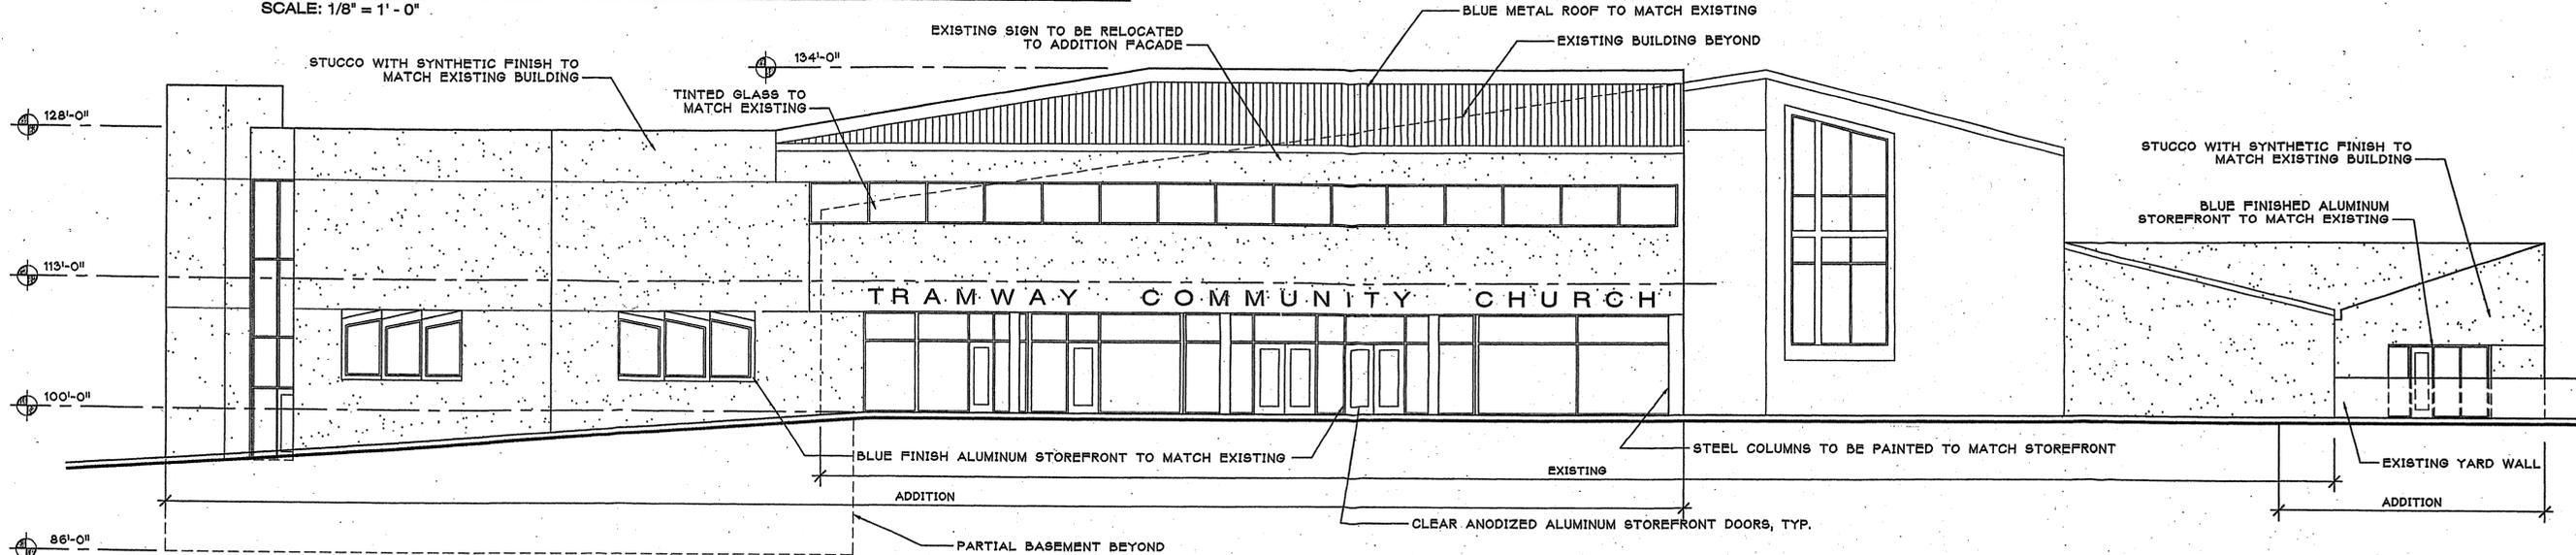


SOUTHEAST ELEVATION

SCALE: 1/8" = 1' - 0"

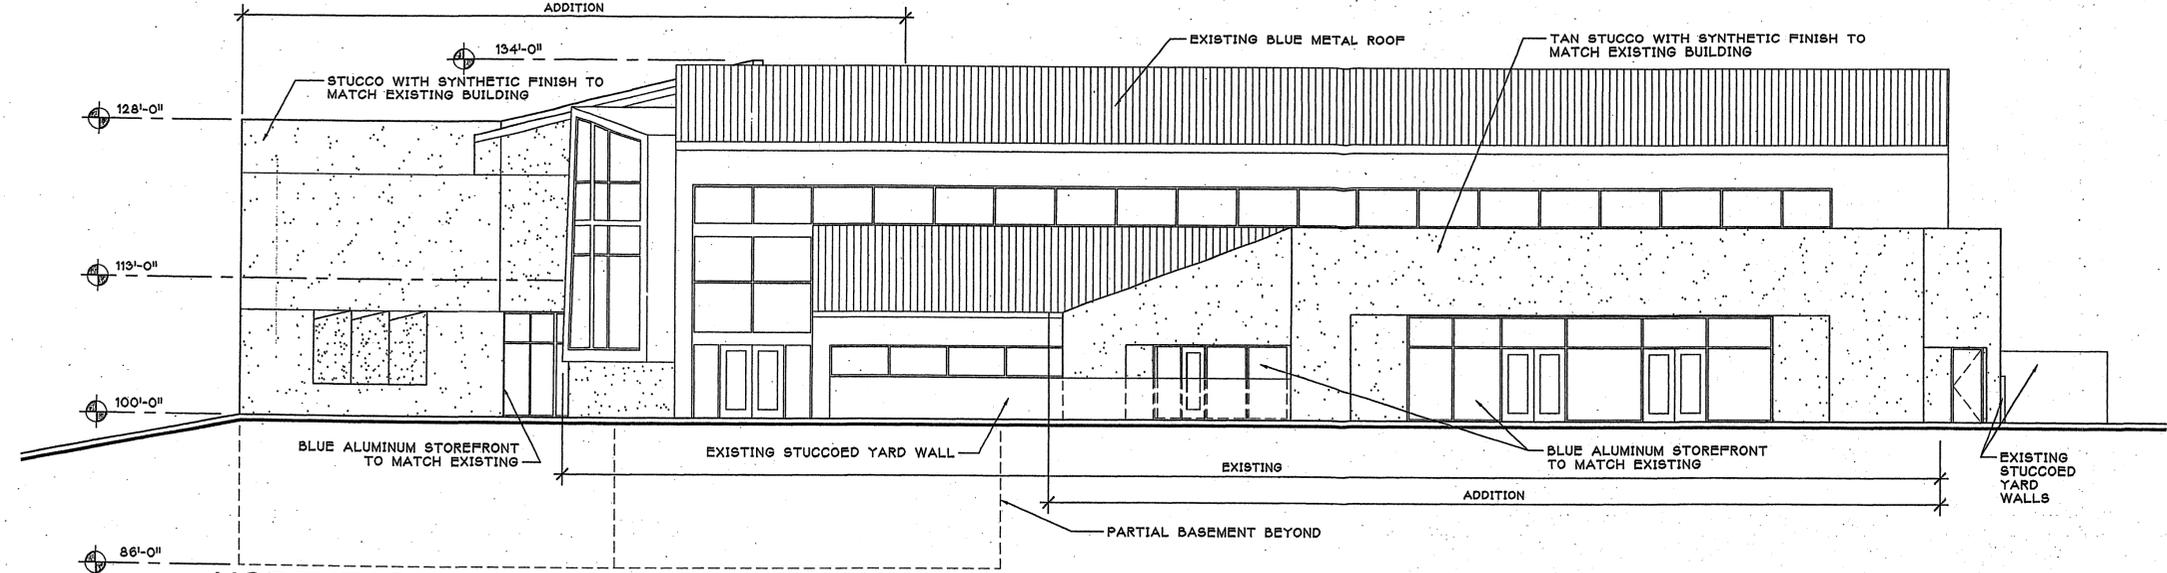

NORTHEAST ELEVATION

SCALE: 1/8" = 1' - 0"

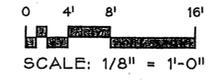

DORMAN and BREEN
 LAURENCE BREEN F.A.I.A.
 SANTA FE, NM 505-982-9196

RICHARD DORMAN F.A.I.A.
 ALBUQUERQUE, NM 505-299-5940

Tramway Community Church
Addition and Remodel
 4800 Tramway Ridge Dr N E
 Albuquerque, New Mexico




SHEET TITLE:
EXTERIOR ELEVATIONS

JOB NUMBER:
0406

DATE:
4/3/07

REVISION:	DATE:

SHEET:
A-1.0

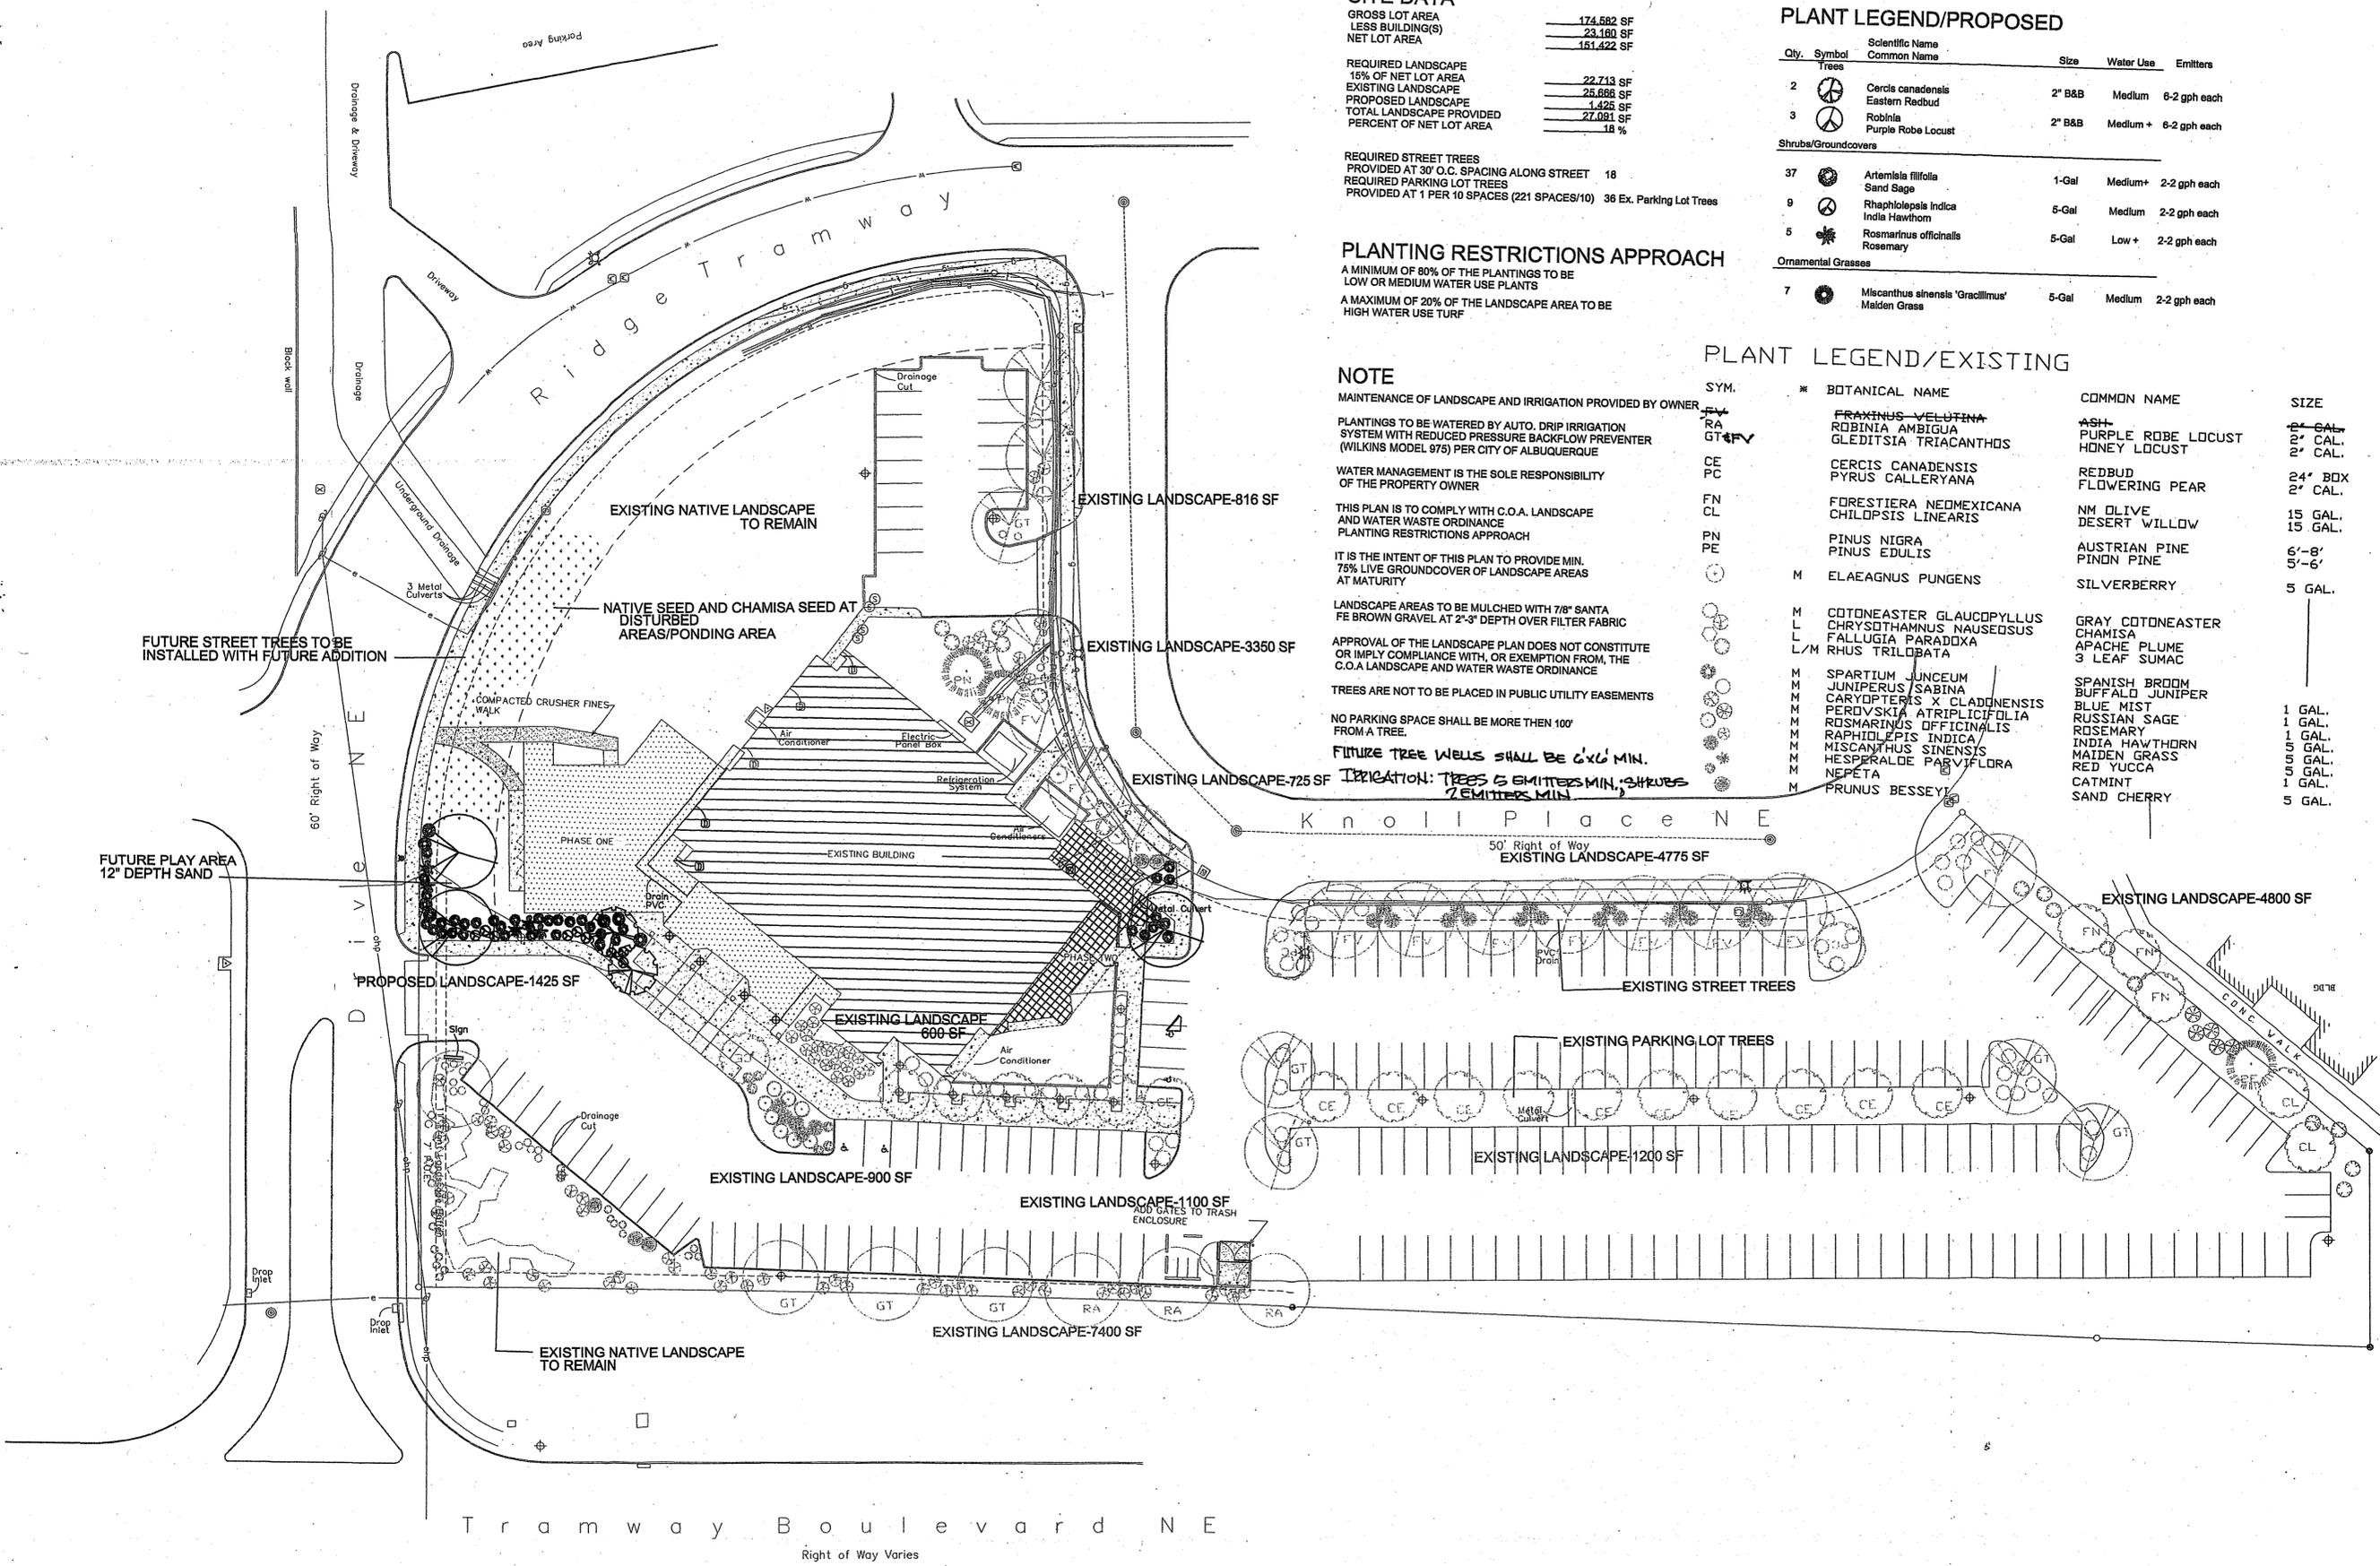

SITE DATA

GROSS LOT AREA	174,582 SF
LESS BUILDING(S)	23,180 SF
NET LOT AREA	151,422 SF
REQUIRED LANDSCAPE 15% OF NET LOT AREA	22,713 SF
EXISTING LANDSCAPE	25,666 SF
PROPOSED LANDSCAPE	1,425 SF
TOTAL LANDSCAPE PROVIDED	27,091 SF
PERCENT OF NET LOT AREA	18 %

REQUIRED STREET TREES PROVIDED AT 30' O.C. SPACING ALONG STREET 18
 REQUIRED PARKING LOT TREES PROVIDED AT 1 PER 10 SPACES (221 SPACES/10) 36 Ex. Parking Lot Trees

PLANTING RESTRICTIONS APPROACH
 A MINIMUM OF 80% OF THE PLANTINGS TO BE LOW OR MEDIUM WATER USE PLANTS
 A MAXIMUM OF 20% OF THE LANDSCAPE AREA TO BE HIGH WATER USE TURF

NOTE
 MAINTENANCE OF LANDSCAPE AND IRRIGATION PROVIDED BY OWNER
 PLANTINGS TO BE WATERED BY AUTO. DRIP IRRIGATION SYSTEM WITH REDUCED PRESSURE BACKFLOW PREVENTER (WILKINS MODEL 975) PER CITY OF ALBUQUERQUE
 WATER MANAGEMENT IS THE SOLE RESPONSIBILITY OF THE PROPERTY OWNER
 THIS PLAN IS TO COMPLY WITH C.O.A. LANDSCAPE AND WATER WASTE ORDINANCE PLANTING RESTRICTIONS APPROACH
 IT IS THE INTENT OF THIS PLAN TO PROVIDE MIN. 75% LIVE GROUNDCOVER OF LANDSCAPE AREAS AT MATURITY
 LANDSCAPE AREAS TO BE MULCHED WITH 7/8" SANTA FE BROWN GRAVEL AT 2"-3" DEPTH OVER FILTER FABRIC
 APPROVAL OF THE LANDSCAPE PLAN DOES NOT CONSTITUTE OR IMPLY COMPLIANCE WITH, OR EXEMPTION FROM, THE C.O.A. LANDSCAPE AND WATER WASTE ORDINANCE
 TREES ARE NOT TO BE PLACED IN PUBLIC UTILITY EASEMENTS
 NO PARKING SPACE SHALL BE MORE THEN 100' FROM A TREE.
 FUTURE TREE WELLS SHALL BE 6'x6' MIN.
 IRRIGATION: TREES 6 EMITTERS MIN., SHRUBS 7 EMITTERS MIN.

PLANT LEGEND/PROPOSED

Qty.	Symbol	Scientific Name Common Name	Size	Water Use	Emitters
2	(Symbol)	Cercis canadensis Eastern Redbud	2" B&B	Medium	6-2 gph each
3	(Symbol)	Robinia Purple Robe Locust	2" B&B	Medium +	6-2 gph each
Shrubs/Groundcovers					
37	(Symbol)	Artemisia filifolia Sand Sage	1-Gal	Medium+	2-2 gph each
9	(Symbol)	Rhaphtolepis Indica India Hawthorn	5-Gal	Medium	2-2 gph each
5	(Symbol)	Rosmarinus officinalis Rosemary	5-Gal	Low +	2-2 gph each
Ornamental Grasses					
7	(Symbol)	Miscanthus sinensis 'Gracillimus' Maiden Grass	5-Gal	Medium	2-2 gph each

PLANT LEGEND/EXISTING


SYM.	* BOTANICAL NAME	COMMON NAME	SIZE
FR	FRAXINUS VELUTINA	ASH	2" GAL.
RA	ROBINIA AMBIGUA	PURPLE ROBE LOCUST	2" CAL.
GT	GLETTISIA TRIACANTHOS	HONEY LOCUST	2" CAL.
CE	CERCIS CANADENSIS	REDBUD	24" BDX
PC	PYRUS CALLERYANA	FLOWERING PEAR	2" CAL.
FN	FORESTIERA NEOMEXICANA	NM OLIVE	15 GAL.
CL	CHILDPSIS LINEARIS	DESERT WILLOW	15 GAL.
PN	PINUS NIGRA	AUSTRIAN PINE	6'-8'
PE	PINUS EDULIS	PINON PINE	5'-6'
M	ELAEAGNUS PUNGENS	SILVERBERRY	5 GAL.
M	COTONEASTER GLAUCOPYLLUS	GRAY COTONEASTER	
L	CHRYSOTHAMUS NAUSEOSUS	CHAMISA	
L	FALLUGIA PARADIXA	APACHE PLUME	
L/M	RHUS TRILOBATA	3 LEAF SUMAC	
M	SPARTIUM JUNCEUM	SPANISH BROOM	1 GAL.
M	JUNIPERUS SABINA	BUFFALO JUNIPER	1 GAL.
M	CARYOPTERIS X CLADINENSIS	BLUE MIST	1 GAL.
M	PEROVSKIA ATRIPLICIFOLIA	RUSSIAN SAGE	5 GAL.
M	ROSMARINUS OFFICINALIS	ROSEMARY	1 GAL.
M	RAPHIDOLEPIS INDICA	INDIA HAWTHORN	5 GAL.
M	MISCANTHUS SINENSIS	MAIDEN GRASS	5 GAL.
M	HESPERALOE PARVIFLORA	RED YUCCA	1 GAL.
M	NEPETA	CATMINT	1 GAL.
M	FRUNUS BESSEYI	SAND CHERRY	5 GAL.

Growing Better Heads
 LANDSCAPE CONTRACT
 www.headsuplandscap.com
 P O Box 10597
 Albuquerque, NM 87111
 505.898.9615
 505.898.2105 (fax)
 design@hulc.com



Date: 3/28/07
 Revisions:
 ▲
 ▲
 ▲
 ▲
 Drawn by: JC
 Reviewed by: MS


Tramway Community Church/Addition & Remodel
 4800 Tramway Ridge Dr. NE
 Albuquerque, New Mexico

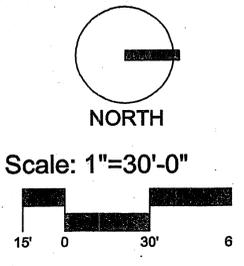

Sheet Title:
Landscape Plan

Sheet Number:
LS-01

LANDSCAPE PLAN
 SCALE: 1" = 30' - 0"

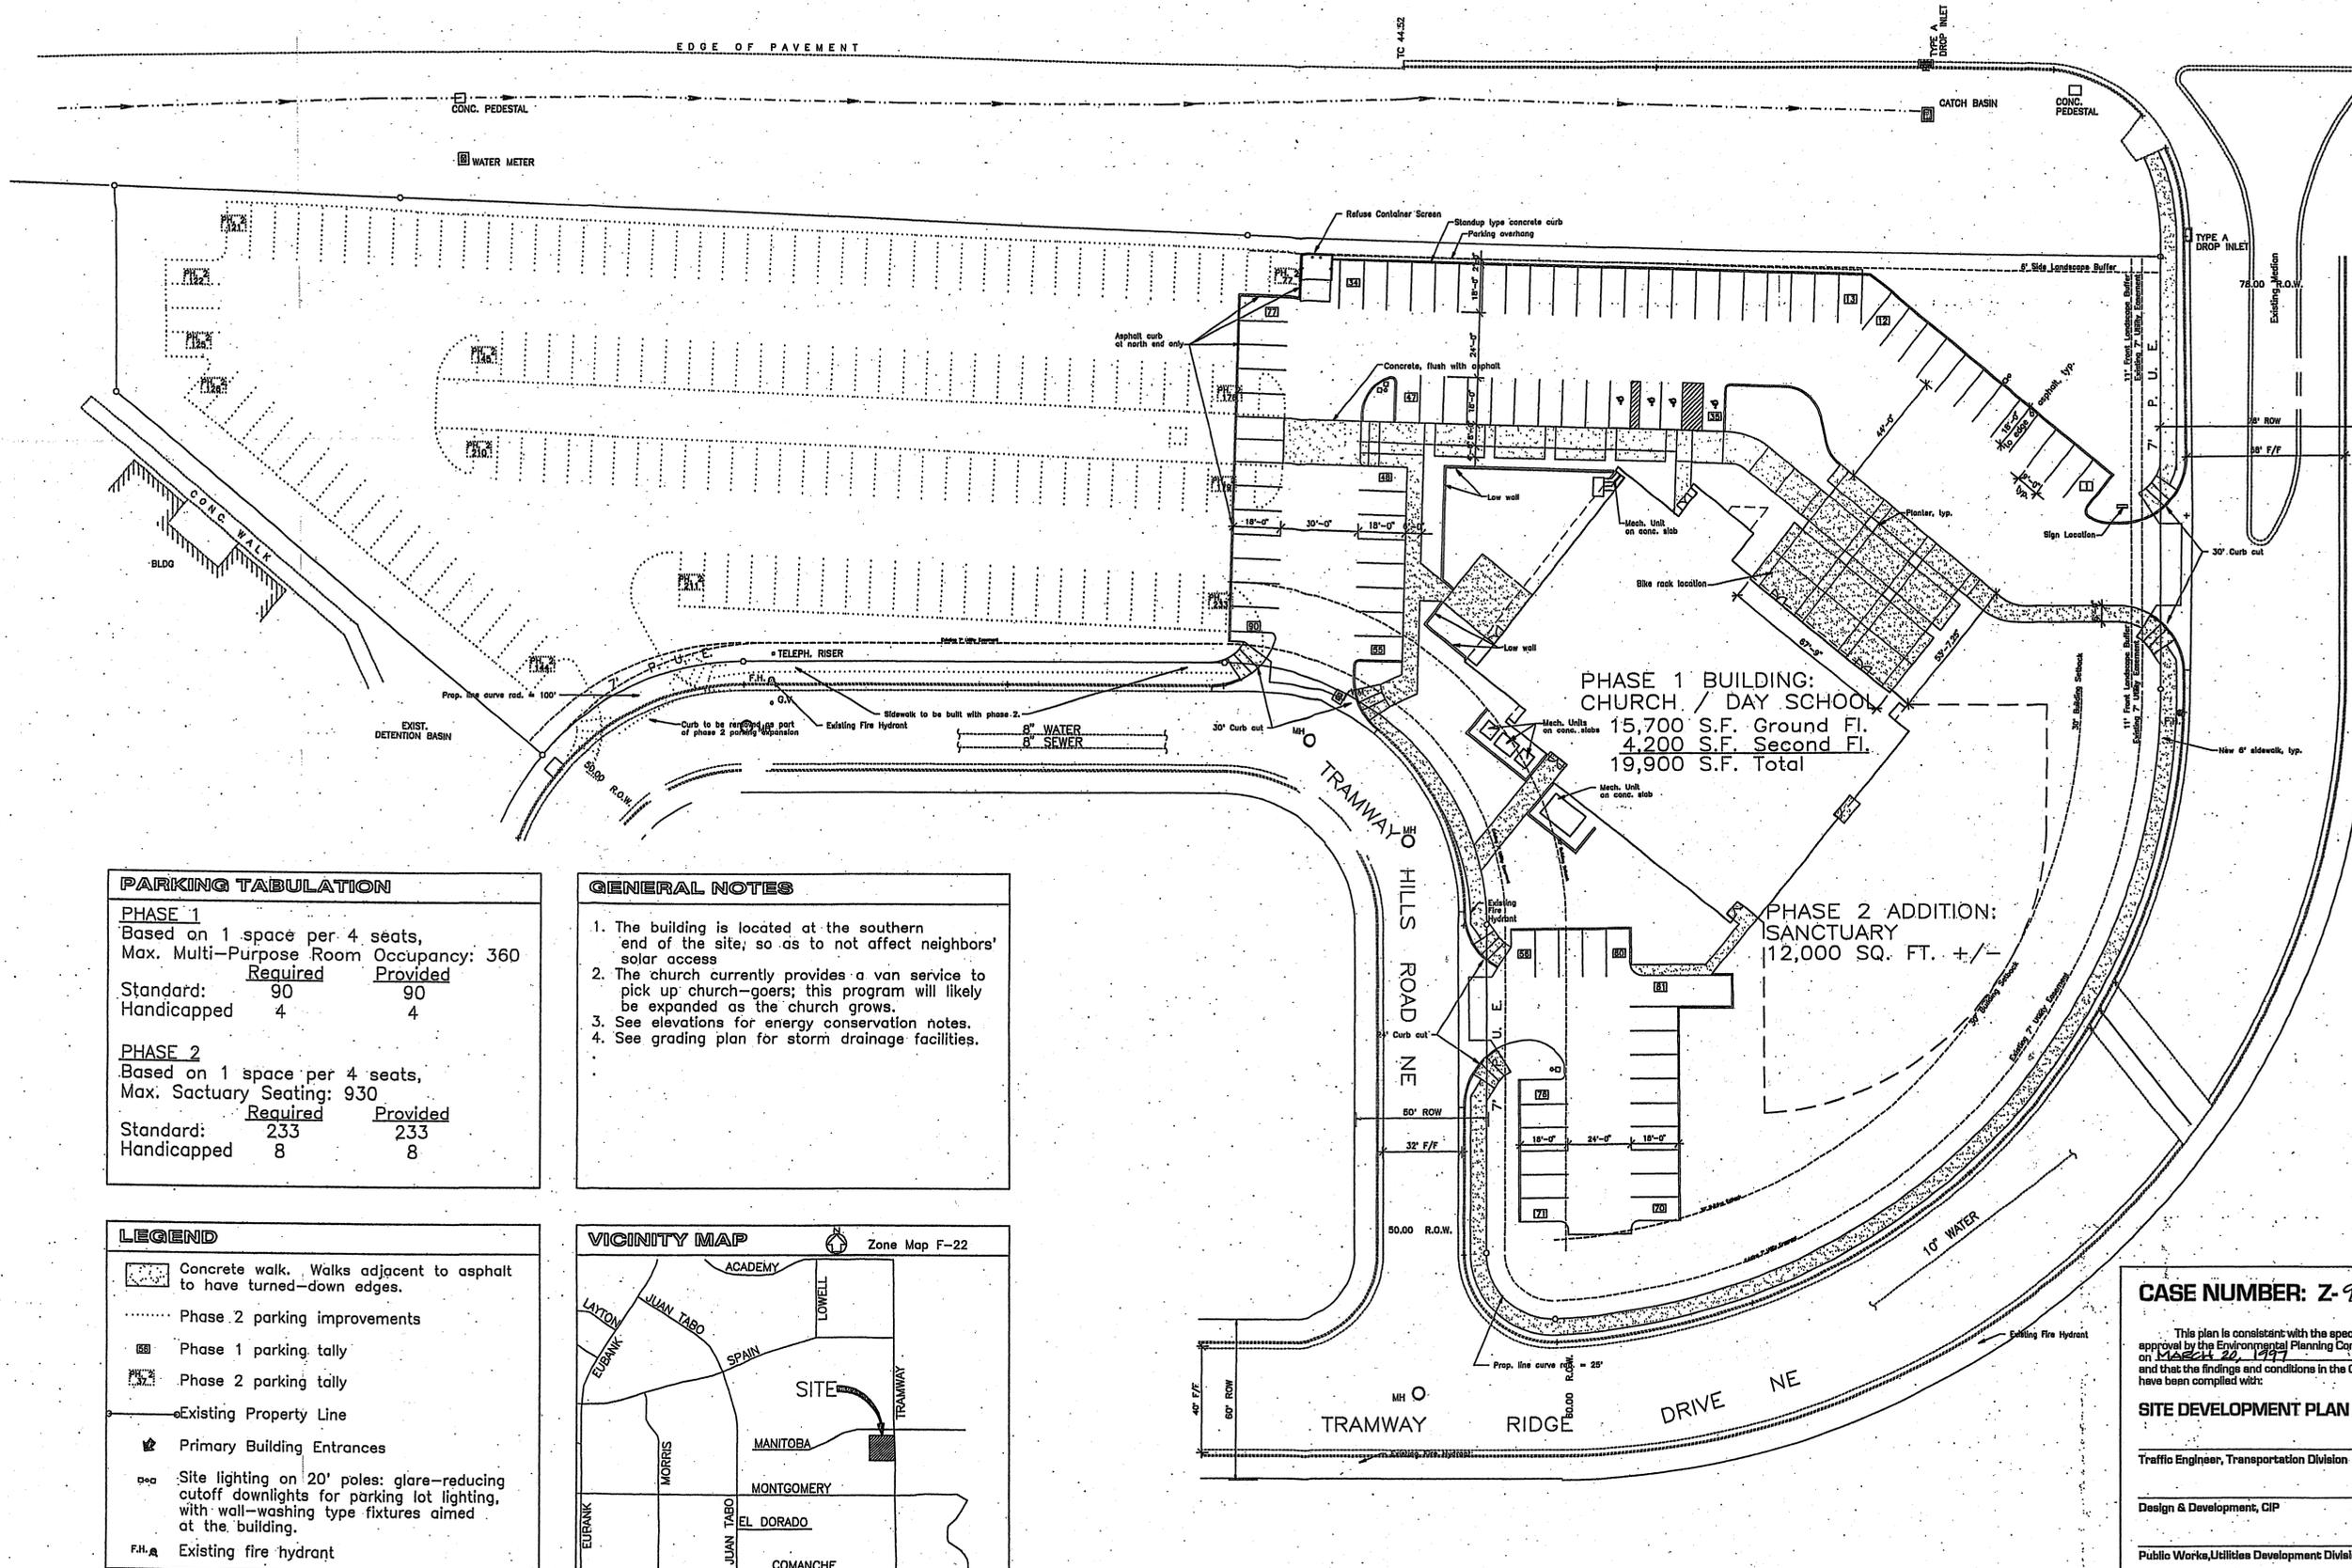

PARKING TABULATION

PHASE 1
Based on 1 space per 4 seats,
Max. Multi-Purpose Room Occupancy: 360


	Required	Provided
Standard:	90	90
Handicapped:	4	4

PHASE 2
Based on 1 space per 4 seats,
Max. Sanctuary Seating: 930


	Required	Provided
Standard:	233	233
Handicapped:	8	8

- GENERAL NOTES**
1. The building is located at the southern end of the site, so as to not affect neighbors' solar access.
 2. The church currently provides a van service to pick up church-goers; this program will likely be expanded as the church grows.
 3. See elevations for energy conservation notes.
 4. See grading plan for storm drainage facilities.

- LEGEND**
- Concrete walk. Walks adjacent to asphalt to have turned-down edges.
 - Phase 2 parking improvements
 - Phase 1 parking tally
 - Phase 2 parking tally
 - Existing Property Line
 - Primary Building Entrances
 - Site lighting on 20' poles; glare-reducing cutoff downlights for parking lot lighting, with wall-washing type fixtures aimed at the building.
 - Existing fire hydrant

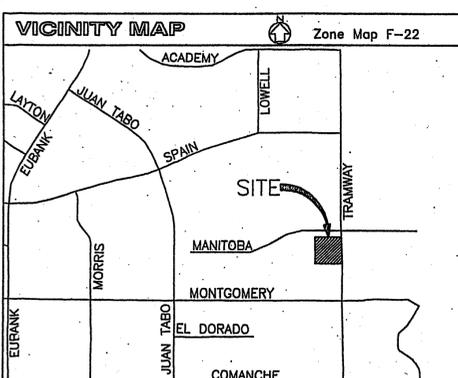

SITE DEVELOPMENT PLAN
SCALE: 1" = 30'-0"

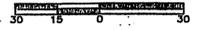

CASE NUMBER: Z-97-27

This plan is consistent with the specific site development plan approval by the Environmental Planning Commission (EPC) on March 24, 1997 and that the findings and conditions in the Official Notification of Decision have been complied with:

SITE DEVELOPMENT PLAN

Traffic Engineer, Transportation Division	Date
Design & Development, CIP	Date
Public Works, Utilities Development Division	Date
City Engineer, Engineering Division/AMA/FA	Date

APPROVAL AND CONDITIONAL ACCEPTANCE: as specified by the Development Process Manual.

City Planner, Albuquerque Planning Department	Date
---	------

PLNZ (10708) 4/98

SITE DEVELOPMENT PLAN
TRAMWAY COMMUNITY CHURCH
DEER RIDGE BUSINESS CENTER
ALBUQUERQUE, NEW MEXICO

DORMAN and BREEN
LAURENCE BREEN A.I.A.
RICHARD DORMAN F.A.I.A.
ALBUQUERQUE, NM 505-299-5940 SANTA FE, NM 505-982-9196

SHEET TITLE: SITE DEVELOPMENT PLAN

JOB NUMBER: 9605

DATE: JUNE 2, 1997

REVISIONS:

NO.	DATE	DESCRIPTION

SHEET: DRB-1

1 of 3

