



DRB SUBMITTAL

Mesa Del Sol Film Studio ouquerque, New Mexic

06/14/06

RNB DRAWN BY REVIEWED BY DATE 06/06/06 06023 PROJECT NO. DRAWING NAME

CONCEPTUAL UTILITY PLAN

SHEET NO.

\\bhi.corp\bh-shares\ABQ-Projects\060348\cdp\general\060348up01.dwg Wed, 14-Jun-2006 - 9:20:am, Plotted by: CPIERCE

Bohannan 📤 Huston 🗉

NOTE: OFFSITE UTILITIES TO BE COMPLETED BY SEPERATE CONTRACT

ENGINEERING . SPATIAL DATA . ADVANCED TECHNOLOGIES

1004818

KEYED NOTES O

- 1. VEHICLE INGRESS INTO STUDIO PROPERTY
- 2. VEHICLE EGRESS OUT OF STUDIO PROPERTY
- 3. CONCRETE SIDEMALK 6' WIDE UNLESS OTHERWISE NOTED
- $1\sqrt{4}$. PEDESTRIAN WALKWAY TO LINK WITH CONCRETE SIDEWALKS TYP. WALKWAYS SHALL BE DISTINGUISHABLE FROM DRIVEWAY PAVING BY PATTERN OR COLOR. TEMPORARY 14'-0 " HIGH CHAIN-LINK SECURITY FENCE WITH CLOTHE FABRIC SCREENING
- MATERIAL. FENCE SHALL REMAIN IN PLACE FOR A MAXIMUM OF 3 YEARS. 6. WEST SECURITY WALL; RE: 3 & 4/SHEET 15.
- 7. TYPICAL PARKING SPACE 8. TYPICAL CONCRETE SIDEWALK ACCESSIBILITY RAMP; RE: 5/SHEET 02.
- 9. FIRE HYDRANT LOCATION
- 10. DECORATIVE FEATURE WALL; RE: 4/SHEET 16 11. REFUSE AREA TO CONTAIN TRASH COMPACTOR AND RECYCLE CONTAINERS ALL REFUSE SHALL BE MOVED TO THIS LOCATION BY INTERNALLY STUDIO STAFF
- FOR WASTE MANAGEMENT PICK-UP.
- 12. BIKE RACK; RE: SITE DATA FOR QUANTITY
- 13. PARALLEL PARKING ALONG STREET 14. REFUSE AREA FOR MIXED-USE BUILDINGS TRASH PICK-UP BY WASTE MANAGEMENT. 15. GUARD HOUSE AT GATED STUDIO ENTRANCE; RE: 1/SHEET 12 FOR TYP. ENTRANCE.
- 16. FLEX-USE AREA FOR STUDIO TO BE USED FOR OVERFLOW PARKING WHEN
- NEEDED OR FOR STUDIO OPERATION PURPOSES.
- 17. FUTURE BUILDING TO BE DEVELOPED IN A LATTER PHASE; BUILDING SHALL FOLLOW SAME DESIGN PRESIDENT BASED ON THIS SUBMITTAL.
- 18. CONCRETE ACCESSIBILITY RAMP LOCATED ALONG PEDESTRIAN PATH
- 19. FUTURE ENTRANCE GATE ONTO STUDIO PROPERTY TO BE BUILT WHEN TOWER ROAD IS CONSTRUCTED; RE: 3/SHEET 02
- 20. TYPICAL LIGHT POLE; RE: 4/SHEET 02
- 21. CONCRETE PEDESTRIAN PATH, 6'-0" WIDE UNLESS OTHERWISE NOTED.
- SOUTH SECURITY WALL; RE: 3 & 4/SHEET 16.
- 23. 6" CONCRETE CURB TYPICAL.
- 24. SECURED PEDESTRIAN ACCESS POINT 25. SECURITY WALL @ GATE; RE: 1/SHEET 02
- 26. SECURITY WALL @ GATE; RE: 2/SHEET 02
- 27. MOTORCYCLE PARKING SPACE. EACH SPACE SHALL BE DESIGNATED WITH ITS OWN POSTED UPRIGHT FREESTANDING OR WALL MOUNTED SIGN.
- 28. PEDESTRIAN CROSSMALK; SHALL DIFFERENTIATE FROM ROADWAY PAVING BY PATTERN AND COLOR.
- 29. TYPICAL BUILDING MOUNTED LIGHT FIXTURE; RE: ELEVATIONS FOR MOUNTING HEIGHT. 30. FUTURE PEDESTRIAN CROSSMALK; SHALL DIFFERENTIATE FROM ROADWAY PAVING BY PATTERN AND COLOR.

GENERAL NOTES

- A. PLEASE REFER TO SHEET 02 FOR ENLARGED PLANS OF TYPICAL AREAS OF THE SITE.
- WATER HARVESTING METHODS OR OTHER SUSTAINABLE METHODS THAT UTILIZE STORM WATER RUNOFF SHALL BE INCORPORATED INTO THE SITE PLAN.
- SOLAR PANELS FOR PURPOSING OF WATER HEATING OR COOLING, SPACE HEATING OR COOLING, OR POWER GENERATION ARE PERMITTED AND ENCOURAGED.
- D. SITE PLAN SHALL COMPLY WITH THE DESIGN STANDARDS CONTAINED IN THE MESA DEL SOL LEVEL A MASTER PLAN AND ITS TECHNICAL APPENDIX.

AREA

BUILDING COMPLEX - 3 (73,000 S.F.)

BUILDING

NORTH FOR BUILDING ORIENTATION PURPOSES

TRUE NORTH

COMPLEX - 2 (78,000 S.F.)

BUILDING COMPLEX -

(58,500 S.F.)

E. CONNECTOR ROAD 'A' AND TOWER ROAD SHALL BE CONSTRUCTED IN A FUTURE PHASE. A PORTION OF CONNECTOR ROAD 'A' ADJACENT TO THE MIXED USE BUILDING 'B' AND THE PARKING BEHIND IT WILL BE THE ONLY PORTION OF THE ROAD TO BE CONSTRUCTED AT THIS TIME. PLEASE ALSO REFER TO KEYED NOTES #5 19 AND 30. ALSO PLEASE REFER TO CLOUDED AREA AT CONNECTOR ROAD 'A' AND TOWER ROAD.

LEGAL DESCRIPTION

A certain tract of land being a portion of the south one-half of Section 22, Township 9 North, Range 3 East, New Mexico Principal Meridian, Bernalillo County, New Mexico, being more particularly described by New Mexico State Plane Grid Bearings (Central Zone, NAD 83) and ground distances as follows:

BEGINNING at the most northerly corner of the tract herein described, whence the City of Albuquerque survey monument "1-R16", having New Mexico State Plane Grid Coordinates for the Central Zone: X=1,532,715.520, Y=1,453,439.511, bears N37°35'49"E a distance of 1538.77 feet; thence,

543°57'36"E a distance of 682.79 feet; thence,

586°42'58"E a distance of 200.00 feet to the most easterly corner of the tract herein described; thence, 503°17'02"W a distance of 273.44 feet to a point of curvature; thence,

406.39 feet along the arc of a curve to the right, having a radius of 544.59 feet and a chord bearing 524°39'43"W a distance of 397.03 feet to a point of tangency; thence,

546°02'24"W a distance of 498.29 feet to the most southerly corner of the tract herein described; thence, N43°57'36"W a distance of 67.00 feet to a point of curvature; thence,

198.09 feet along the arc of a curve to the left, having a radius of 454.00 feet and a chord bearing N56°27'36"M a distance of 196.53 feet to a

point of tangency; thence, N68°57'36"W a distance of 330.00 feet; thence,

N43°57'36"W a distance of 602.05 feet to the most westerly corner of the tract herein described; thence, N46°02'24"E a distance of 1115.00 feet to the point and place of beginning.


This tract contains 27.9721 acres, more or less.

BUILDING COMPLEX - 5 (36,000 S.F.)

1" = 100'-0"

COMPLEX - 6 (73,000 S.F.)

SITE DEVELOPMENT PLAN

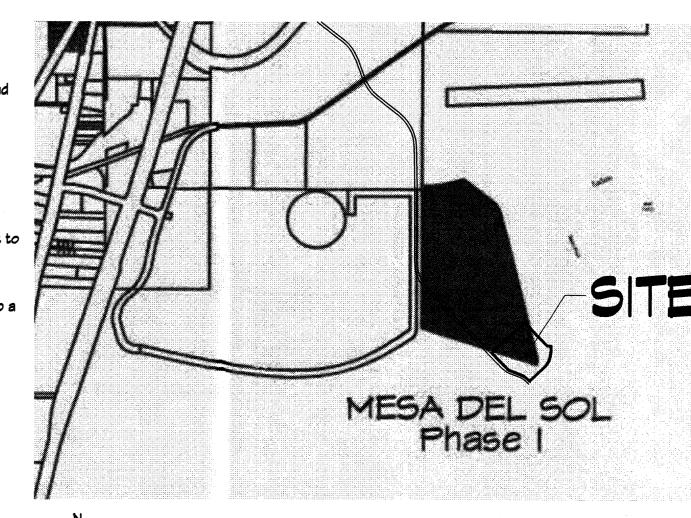

SITE DATA

ZONE ATLAS MAP NUMBER: Q-16 & Q-17

PRESENT ZONING: PLANNED COMMUNITY



BUILDING AREA SUMMARY AND PARKING CALCULATIONS

USE FL	OOR AREA	COA PARKING RATIO
BUILDING COMPLEX 1		
STAGE 1	18000	1/2000 SF
STAGE 2 SROUND FLOOR OFFICE	18000 11250	1/2000 SF 1/200 SF
SECOND FLOOR OFFICE	11250	1/200 5F
TOTAL	58500	1/300 5
BUILDING COMPLEY 2		
BUILDING COMPLEX 2 BUPPORT SPACE A	35000	NONE
SUPPORT SPACE B	35000	NONE
CENTRAL PLANT	8000	NONE
TOTAL	78000	
BUILDING COMPLEX 3		
STAGE 7	24000	1/2000 SF
STAGE 8	24000	1/2000 5F
GROUND FLOOR OFFICE GECOND FLOOR OFFICE	12500 12500	1/200 SF 1/300 SF
TOTAL	T3000	1/ 300 5F
BUILDING COMPLEX 4 - NOT USED		
BUILDING COMPLEX 5 STAGE 5	19.000	1/2000 55
STAGE 5	18000 18000	1/2000 SF 1/2000 SF
TOTAL	36000	1/2000 31
BUILDING COMPLEX 6		
STAGE 3	24000	1/2000 SF
STAGE 4	24000	1/2000 SF
SROUND FLOOR OFFICE	12500	1/200 SF
SECOND FLOOR OFFICE FOTAL	12500 73000	1/300 SF
MIXED USE A		
SROUND FLOOR RETAIL & OFFICE	21000	1/200 SF
SECOND FLOOR OFFICE	23000	1/300 SF
THIRD FLOOR OFFICE	20000	1/300 SF
OURTH FLOOR BUNGALONG OTAL	6500 70500	2/DU (THREE UNITS)
MIXED USE B SROUND FLOOR RETAIL & OFFICE.	24000	1/200 SF
SECOND FLOOR OFFICE	27500	1/200 9F 1/300 9F
THIRD FLOOR OFFICE	23500	1/300 SF
OURTH FLOOR BUNGALONS	6500	2/DU (THREE UNITS)
TOTAL	81500	-
SITE TOTAL	470500	
PARKING REDUCTIONS 25% FOR MIXED USE (EXCLUDING RET) 50% REDUCTION FOR RETAIL FOR ON FOTAL PARKING REQUIRED WITH REDU	-SITE DEMAND (225x0.5=	
OTAL PARKING PROVIDED ON-SITE 1/2 ON-STREET PARKING ALONG UNIV	/ERSITY BLVD. & CONNEC	CTOR RD. A
TOTAL PARKING PROVIDED		
TOTAL HANDICAP PARKING REQUIRED	PER ZONE CODE	801 - 1000
FOTAL HANDICAP PARKING PROVIDED)	No.
BICYCLE PARKING REQUIRED		1/20 VEHICLE SPACES
BICYCLE PARKING PROVIDED		
MOTORCYCLE PARKING REQUIRED		
MOTORCYCLE PARKING PROVIDED		

06EPC-00466

APPLICATION NUMBER:

Is an Infrastructure List Required? (X) Yes () No If yes, then a set of approved DRC plans with a work order is required for any construction within Public Right-of-Way or for construction of public

DRB SITE DEVELOPMENT PLAN APPROVAL:

SOLID WASTE MANAGEMENT

TRAFFIC ENGINEER, TRANSPORTATION DIVISION	
UTILITIES DIVISION	
PARKS AND RECREATION DEPARTMENT	
OVEN ENGINEER	
CITY ENGINEER	
DRB CHAIRPERSON, PLANNING DEPARTMENT	

AFD Plans Checking Office 924-3611 HYDRANTS ONLY Hydrants shall be installed prior to construction (APPROVED/DISAPPROVED Signature & Date



engineering

architecture

interiors

planning

6801 Jefferson NE Suite 100 Albuquerque, NM 87109 505 761-9700 fax 761-4222 dps@dpsabq.com

1" = 200'-0"


PRELIMINARYPLAT APPROVED BY DRB ON 6/14/06

ENGINEER

PROJECT

DRAWN BY REVIEWED BY 06/06/06 PROJECT NO. 06023

DRAWING NAME SITE DEVELOPMENT PLAN FOR BUILDING PERMIT

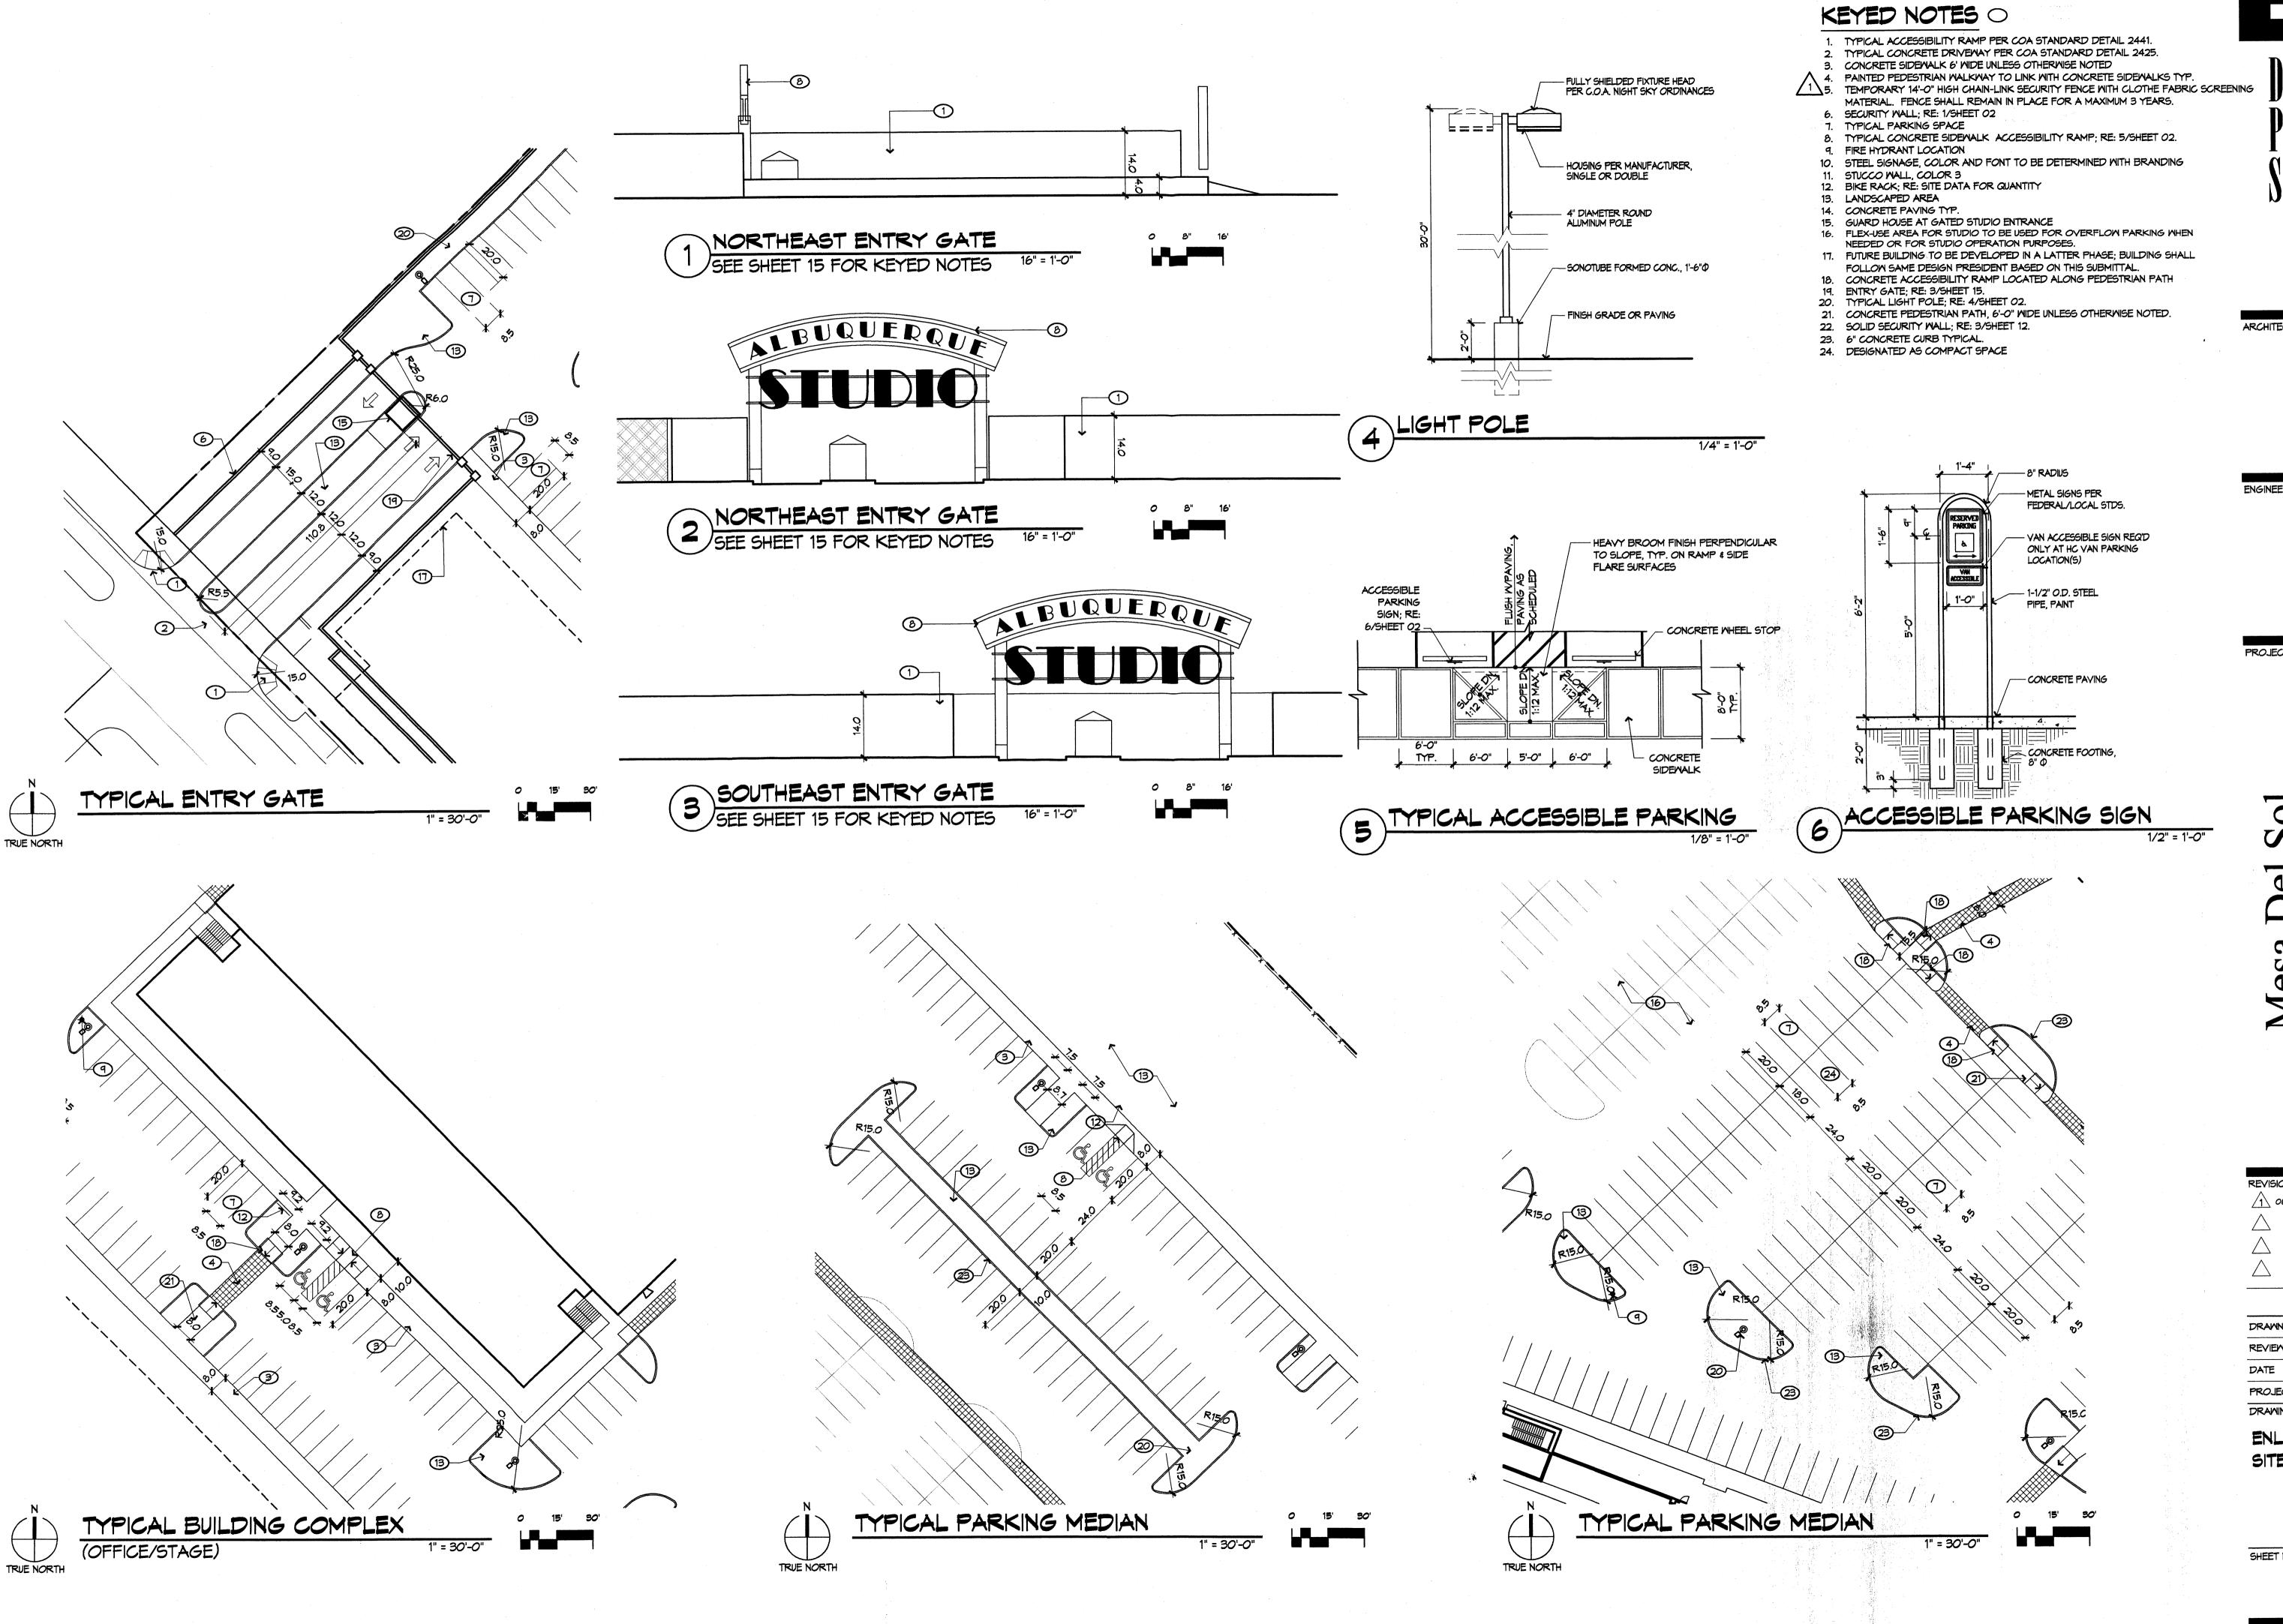

architecture interiors planning engineering

6801 Jefferson NE Suite 100 Albuquerque, NM 87109 5 0 5 7 6 1 - 9 7 0 0 fax 7 6 1 - 4 2 2 2 dps 🕲 dpsabq.com

ARCHITECT


1 06/06/06 EPC Conditions

DRAWN BY

REVIEWED BY

PROJECT NO. DRAWING NAME

ENLARGED SITE PLANS

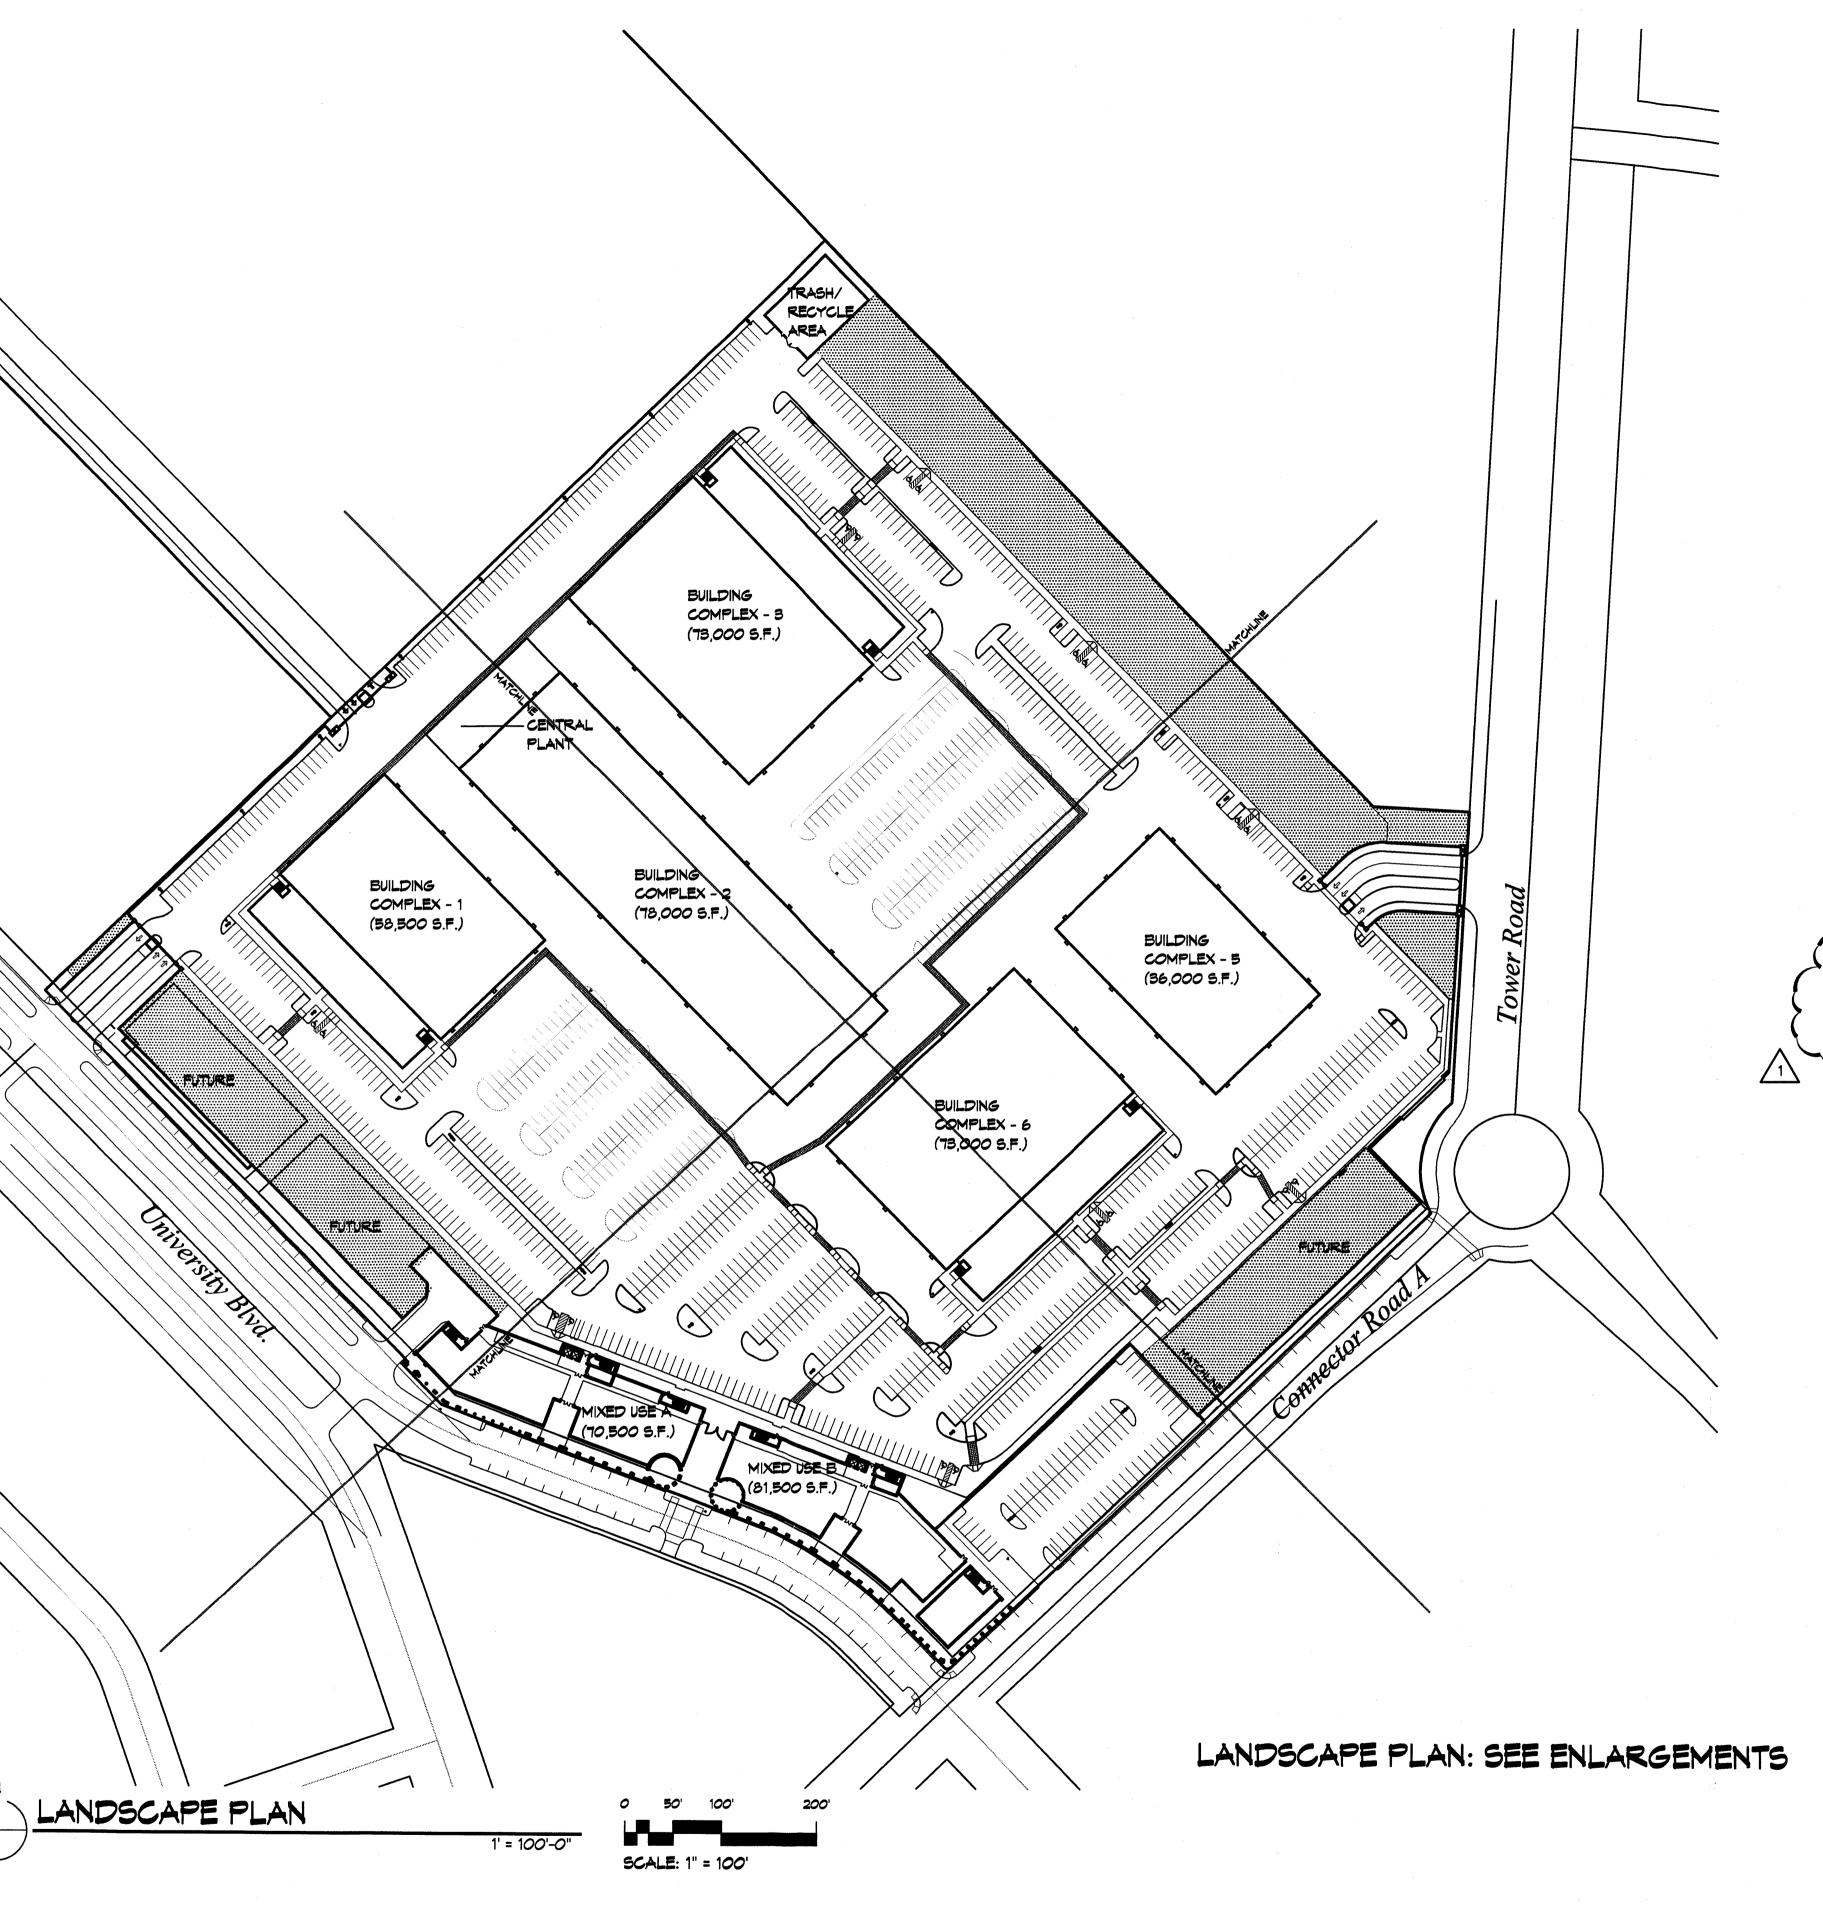

Continues of the Contin

PLANTING NOTES

1. LANDSCAPE DESCRIPTION THE LANDSCAPE DESIGN UTILIZES HIGHLY VISIBLE AREAS OF NATIVE GRASSES TO REINFORCE THE SPECIAL LOCATION OF THE PROJECT - ON A HIGH DESERT GRASSLAND MESA. NATIVE SHRUBS, TREES AND ACCENTS ADD SEASONAL COLOR AND SCALE TO THE

> 2. EXISTING PLANT MATERIAL THERE IS NO LARGE SIZEVEGETATION ON THE SITE. THE EXISTING VEGETATION IS COMPRISED OF GRASSES AND FORBS AND SOME SHRUBS AT LOW DENSITIES.

PROJECT, AND ESTABLISH WILDLIFE HABITAT.

3. INSTALLATION AND MAINTENANCE OF LANDSCAPING AND IRRIGATION SHALL BE THE RESPONSIBILITY OF THE PROPERTY

4. THE LANDSCAPE DESIGN SHALL COMPLY WITH THE INTENT OF THE CITY OF ALBUQUERQUE WATER CONSERVATION LANDSCAPING AND WATER WASTE ORDINANCE.

5. THE USE OF HIGH WATER USE PLANT MATERIALS SHALL BE LIMITED. THERE IS NO HIGH WATER USE TURF USED ON THIS PROJECT.

KEYED NOTES

1) SIDEMALK, CONCRETE 2) PAVING, ASPHALT

3 SPECIAL PAVING 4 CURB (5) SCREEN WALL, SEE SITE PLAN

6 LANDSCAPE AREA TISTE LIGHTING, SEE SITE PLAN 1 PROPERTY LINE

6. MINIMUM INSTALLATION SIZES FOR PLANT MATERIAL VARY BY SPECIES. SEE PLANT

LEGEND. 7. LANDSCAPE AREAS (EXCEPT FOR SEEDING AREAS) SHALL BE COVERED WITH 2" DEPTH

TAN OR BROWN. 8. IRRIGATION: IRRIGATION SHALL BE PROVIDED TO ALL CONTAINER PLANTS AND POTENTIALLY TO

SEEDED AREAS. THE IRRIGATION SYSTEM

DESIGN SHALL BE FULLY AUTOMATED.

OF CRUSHER FINE GRAVEL MULCH. COLOR:

9. PASSIVE WATER HARVESTING: PASSIVE WATER HARVESTING, SUCH AS HARVESTING OF STORMWATER SURFACE RUNOFF AND ROOF RUNOFF, SHALL BE UTILIZED WHERE FEASIBLE.

10. WATER USE DESCRIPTION: THE IRRIGATION SYSTEM DESIGN SHALL ACCOMODATE NON-POTABLE WATER. PLANT MATERIALS HAVE BEEN CHOSEN FOR THEIR XERIC QUALITIES IN ADDITION TO THEIR AESTHETIC AND HABITAT VALUES.

11. PONDING AREA IS LOCATED OFFSITE. SEE CONCEPTUAL GRADING AND DRAINAGE PLAN.

LANDSCAPE CALCULATIONS

SITE AREA: 1,204,596 SF BUILDING FOOTPRINTS TOTAL: 326,000 SF NET SITE AREA: 878,596 SF

REQUIRED LANDSCAPE AREA: 131,789 SF (15% OF NET LOT AREA) PROVIDED LANDSCAPE AREA: 194,880 SF

PLANTING LEGEND

SYMBOL	EST. QTY.	INSTALLED SIZE	COMMON NAME	Botanical name	Height	Midth	Mater requirements
		Oll Col multi haund	Second Millery				
	17	2"-Cal multi-trunk	Desert Willow	Chilopsis linearis	20.00	25.00	Low
{ }	8	2"-Cal multi-trunk	Maverick Honey Mesquite	Prosopis glandulosa 'Maverick'	20.00	25.00	Low)
					ノ 人		
EN 3	44	2"-Cal multi-trunk	Chitalpa	Chitalpa X taskentensis	25. <i>00</i>	30.00	Low
THE PARTY OF THE P	22	8' High	Pinon	Pinus edulis	20.00	12.00	Medium
No. of the last of	29	12' High	Afghan Or Mondell Pine	Pinus eldarica	50.00	20.00	Medium
\odot	17	3" Cal	Chinese Pistache	Pistacia chinensis	35.00	30.00	Medium
\otimes	1	24"-Box multi-trunk	Chaste Tree	∨itex agnus-castus	25.00	20.00	Medium
\hat{O}	11	3" Cal.	Columnar English Oak	Quercus robur "Fastigiata"	55.00	15.00	Medium
nrub							
SYMBOL	EST. QTY.	INSTALLED SIZE	COMMON NAME	Botanical name	Height	Midth	Water requirements
	40	5 Gal	Yellow Bird Of Paradise	Caesalpinia gilliesii	10.00	8.00	Low
()	566	1-Gal	Blue Mist Spirea	Caryopteris × clandonensis	5.00	5.00	Medium
	300	5- <i>Ga</i> l	Deer Grass	Muhlenbergia rigens	3.00	4.00	Medium
Q	107	5-Gal	Black Dalea	Dalea frutescens 'Sierra Nigra'	3.00	4.00	Low
Φ	449	1-Gal	Mormon Tea	Ephedra nevadensis	2.00	3.00	Low
	141	1-Gal	Threeleaf Sumac	Rhus trilobata	6.00	8.00	Low
(Ö , ,	251	1-Gal	Silver Sage	Artemisia 'Powis Castle'	3.00	2.00	Medium
S. Comments	154	15-Gal multi-trunk	Gambel Oak	Quercus gambelii	20.00	6.00	Medium
* 1	233	1-Gal	Thompson Broom	Baccharis x Starns	2.00	6.00	Low
round Cover							
5YMBOL	EST. QTY.	INSTALLED SIZE	COMMON NAME	Botanical name	Height	Midth	Water requirements
Q .	616	1-Gal	Minecups	Callirhoe involucrata	1.00	2.50	L <i>o</i> w
Q	310	1-Gal	"Sierra Gold" Dalea	Dalea capitata	1.50	3.00	Low
\odot	209	1-Gal	Angelita Daisy	Hymenoxys acaulis	1.50	2.00	Low
$\langle \rangle$	294	1-Gal	Blue Flax	Linum perenne "Lewisii"	1.50	1.50	Medium
	293	5-Gal	Rock Penstemon	Penstemon baccharifolius 'Del Rio'	2.00	2.00	Low
	16	1-Gal	Giant Sacaton	Sporobulus wrightii	4.00	5.00	Medium
icculent							
SYMBOL	EST. QTY.	INSTALLED SIZE	COMMON NAME	Botanical name	Height	Midth	Water requirements
×	74	5-Gal @ 8"x8"	Parry's Agave	Agave parryi	2.00	2.00	Low
** 8 8	151	1-Gal @ 9"x1"	Beargrass	Nolina erumpens	4.00	5.00	Low
88	34	5-Gal @ 4 PAD MIN	Purple Prickly Pear	Opuntia macrocentra	3.00	4.00	Low
Seeding/Amendments							

NO 100,000 SF Rate:

2lbs/1000SF (Curtis&Curtis)

(Soil Secrets 505-2000lb/Acre Terra-Pro Commercial 800lb/Acre Protein Crumblies

Crusher fine gravel mulch

Crusher Fine 2" depth, Color: Santa Fe Brown

except for loading and future expansion areas. In landscape areas apply only over plant wells/pits.

Assume application over approx. 60% of non-seeded landscape area. For use in all landscape (except for

architecture interiors planning engineering

6801 Jefferson NE Suite 100 Albuquerque, NM 87109 505 761-9700 fax 761-4222 dps @ dpsabq.com


ARCHITECT

tudio esa

1 06/06/06 EPC Conditions

DRAWN BY REVIEWED BY DATE 06/06/06 PROJECT NO. 06023 DRAWING NAME


LANDSCAPE PLAN

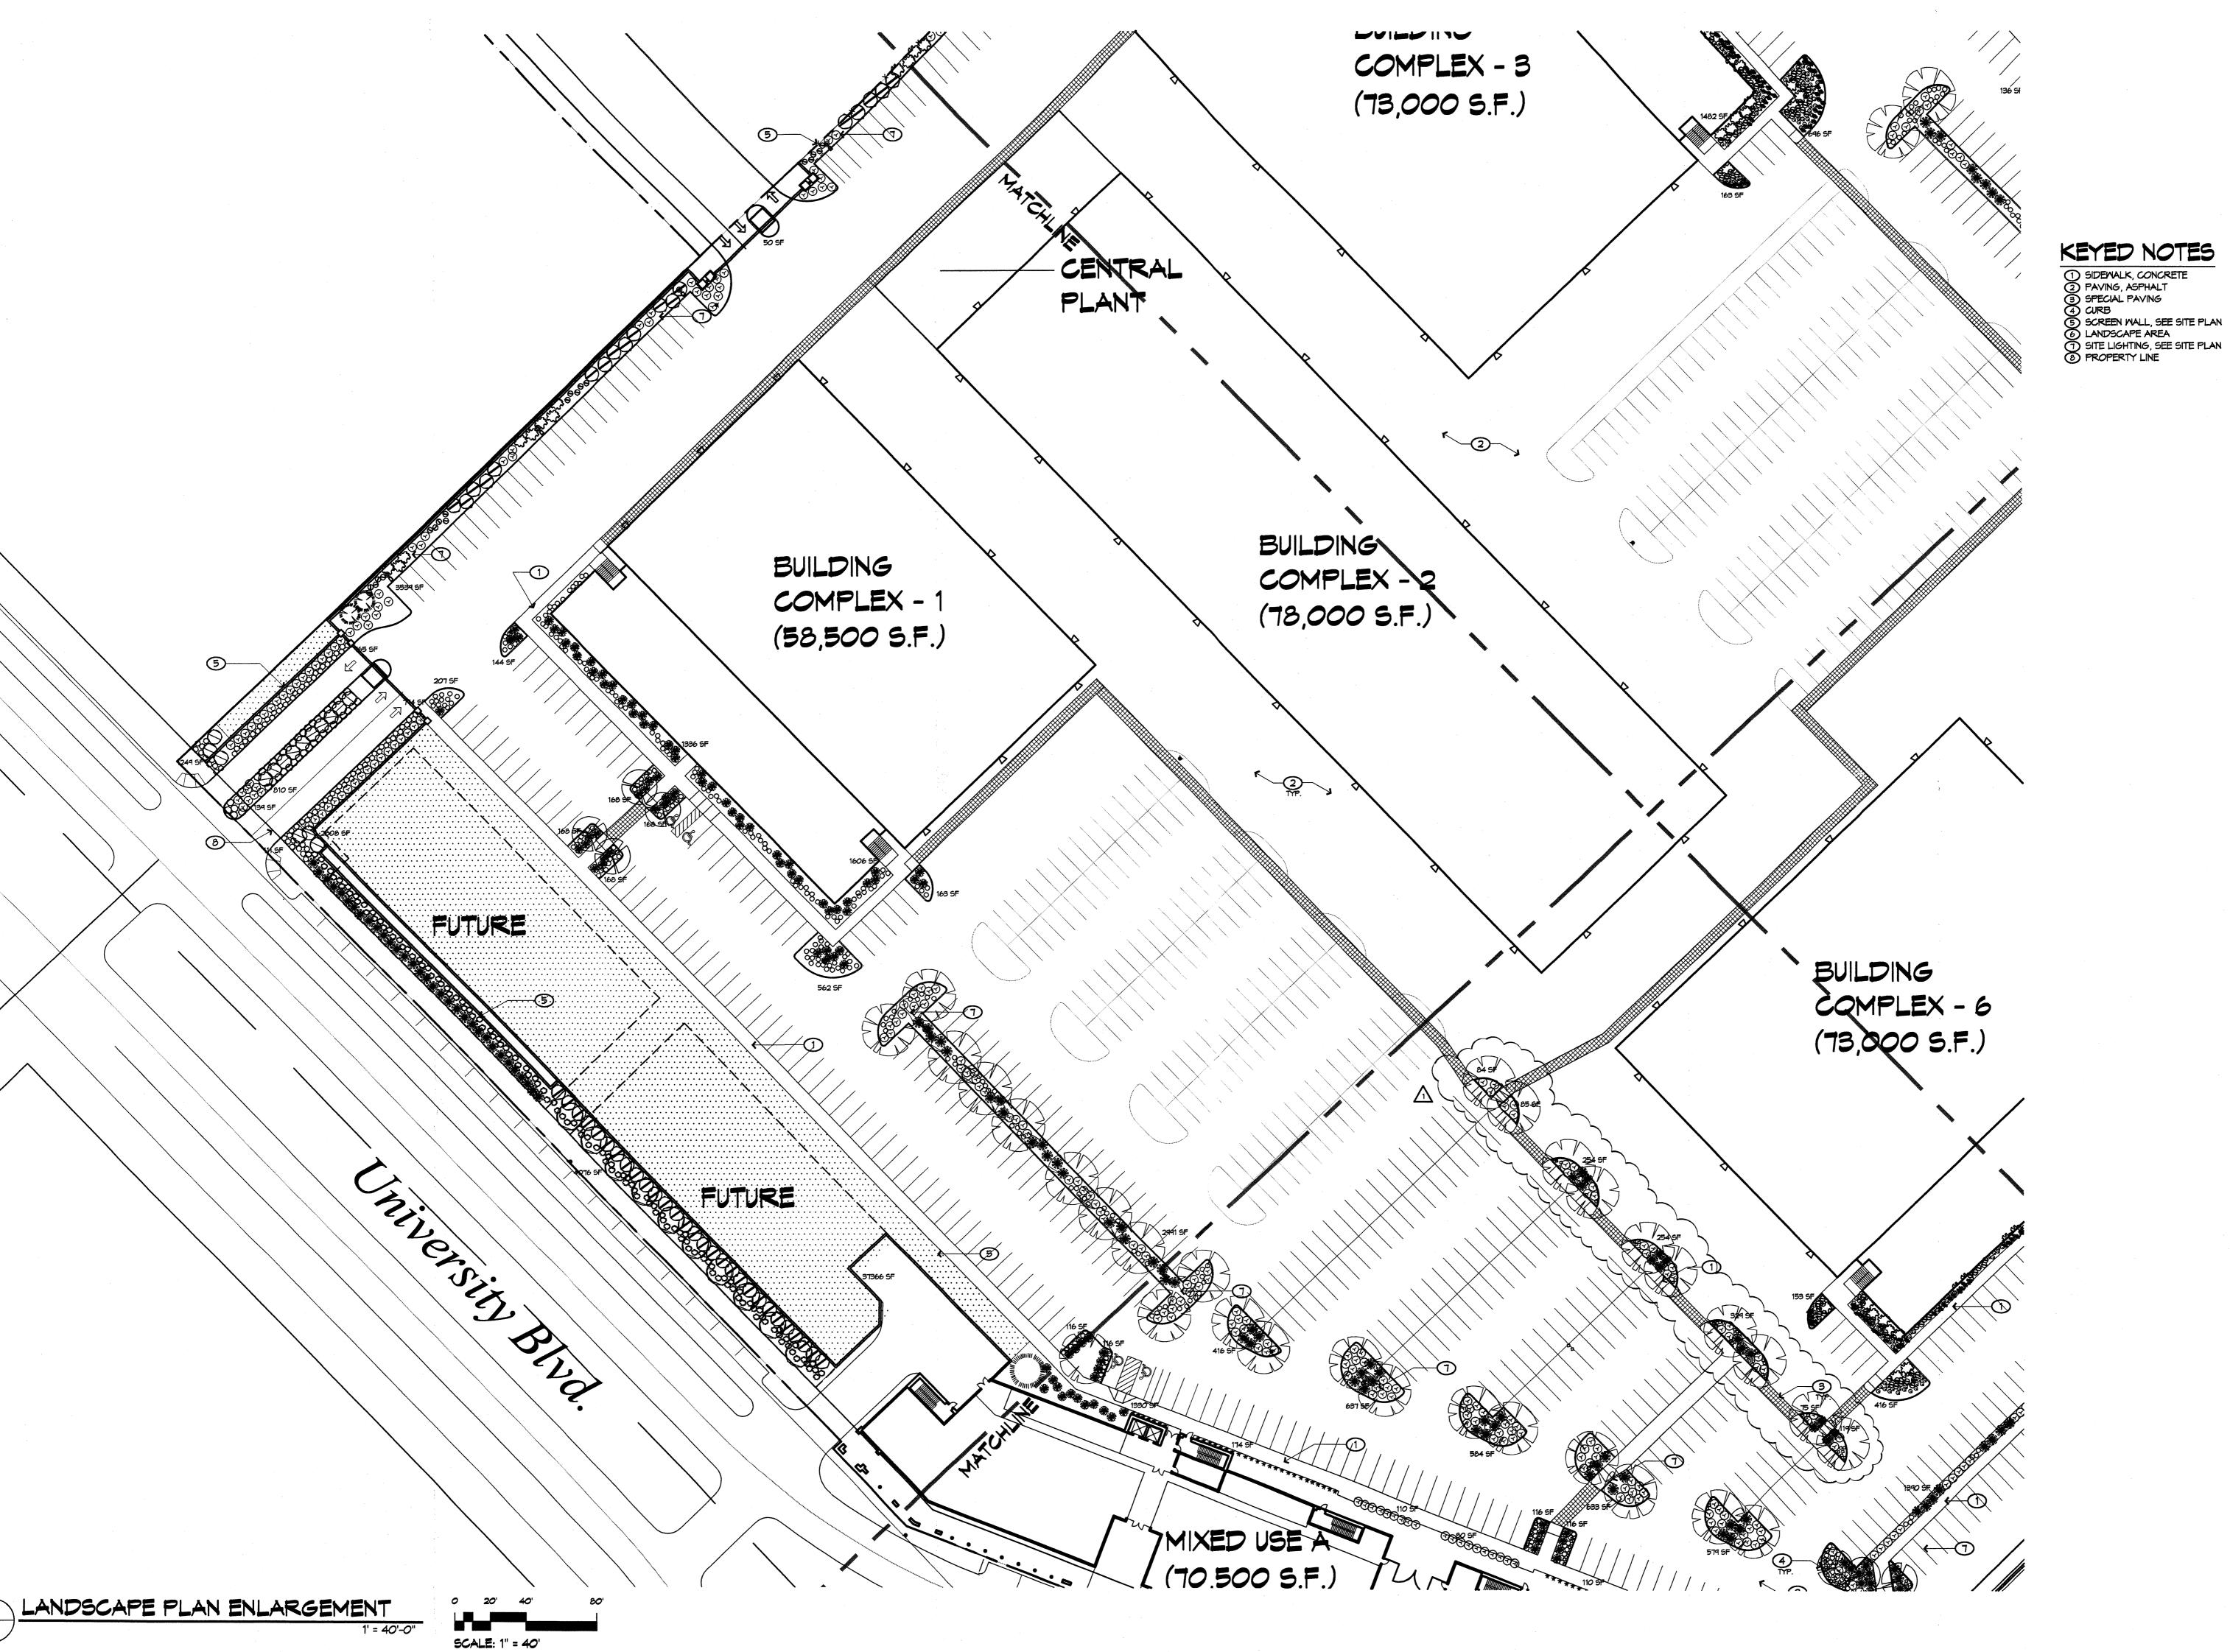



DATE 06/06/06 PROJECT NO. 06023 DRAWING NAME

LANDSCAPE PLAN ENLARGEMENT #1

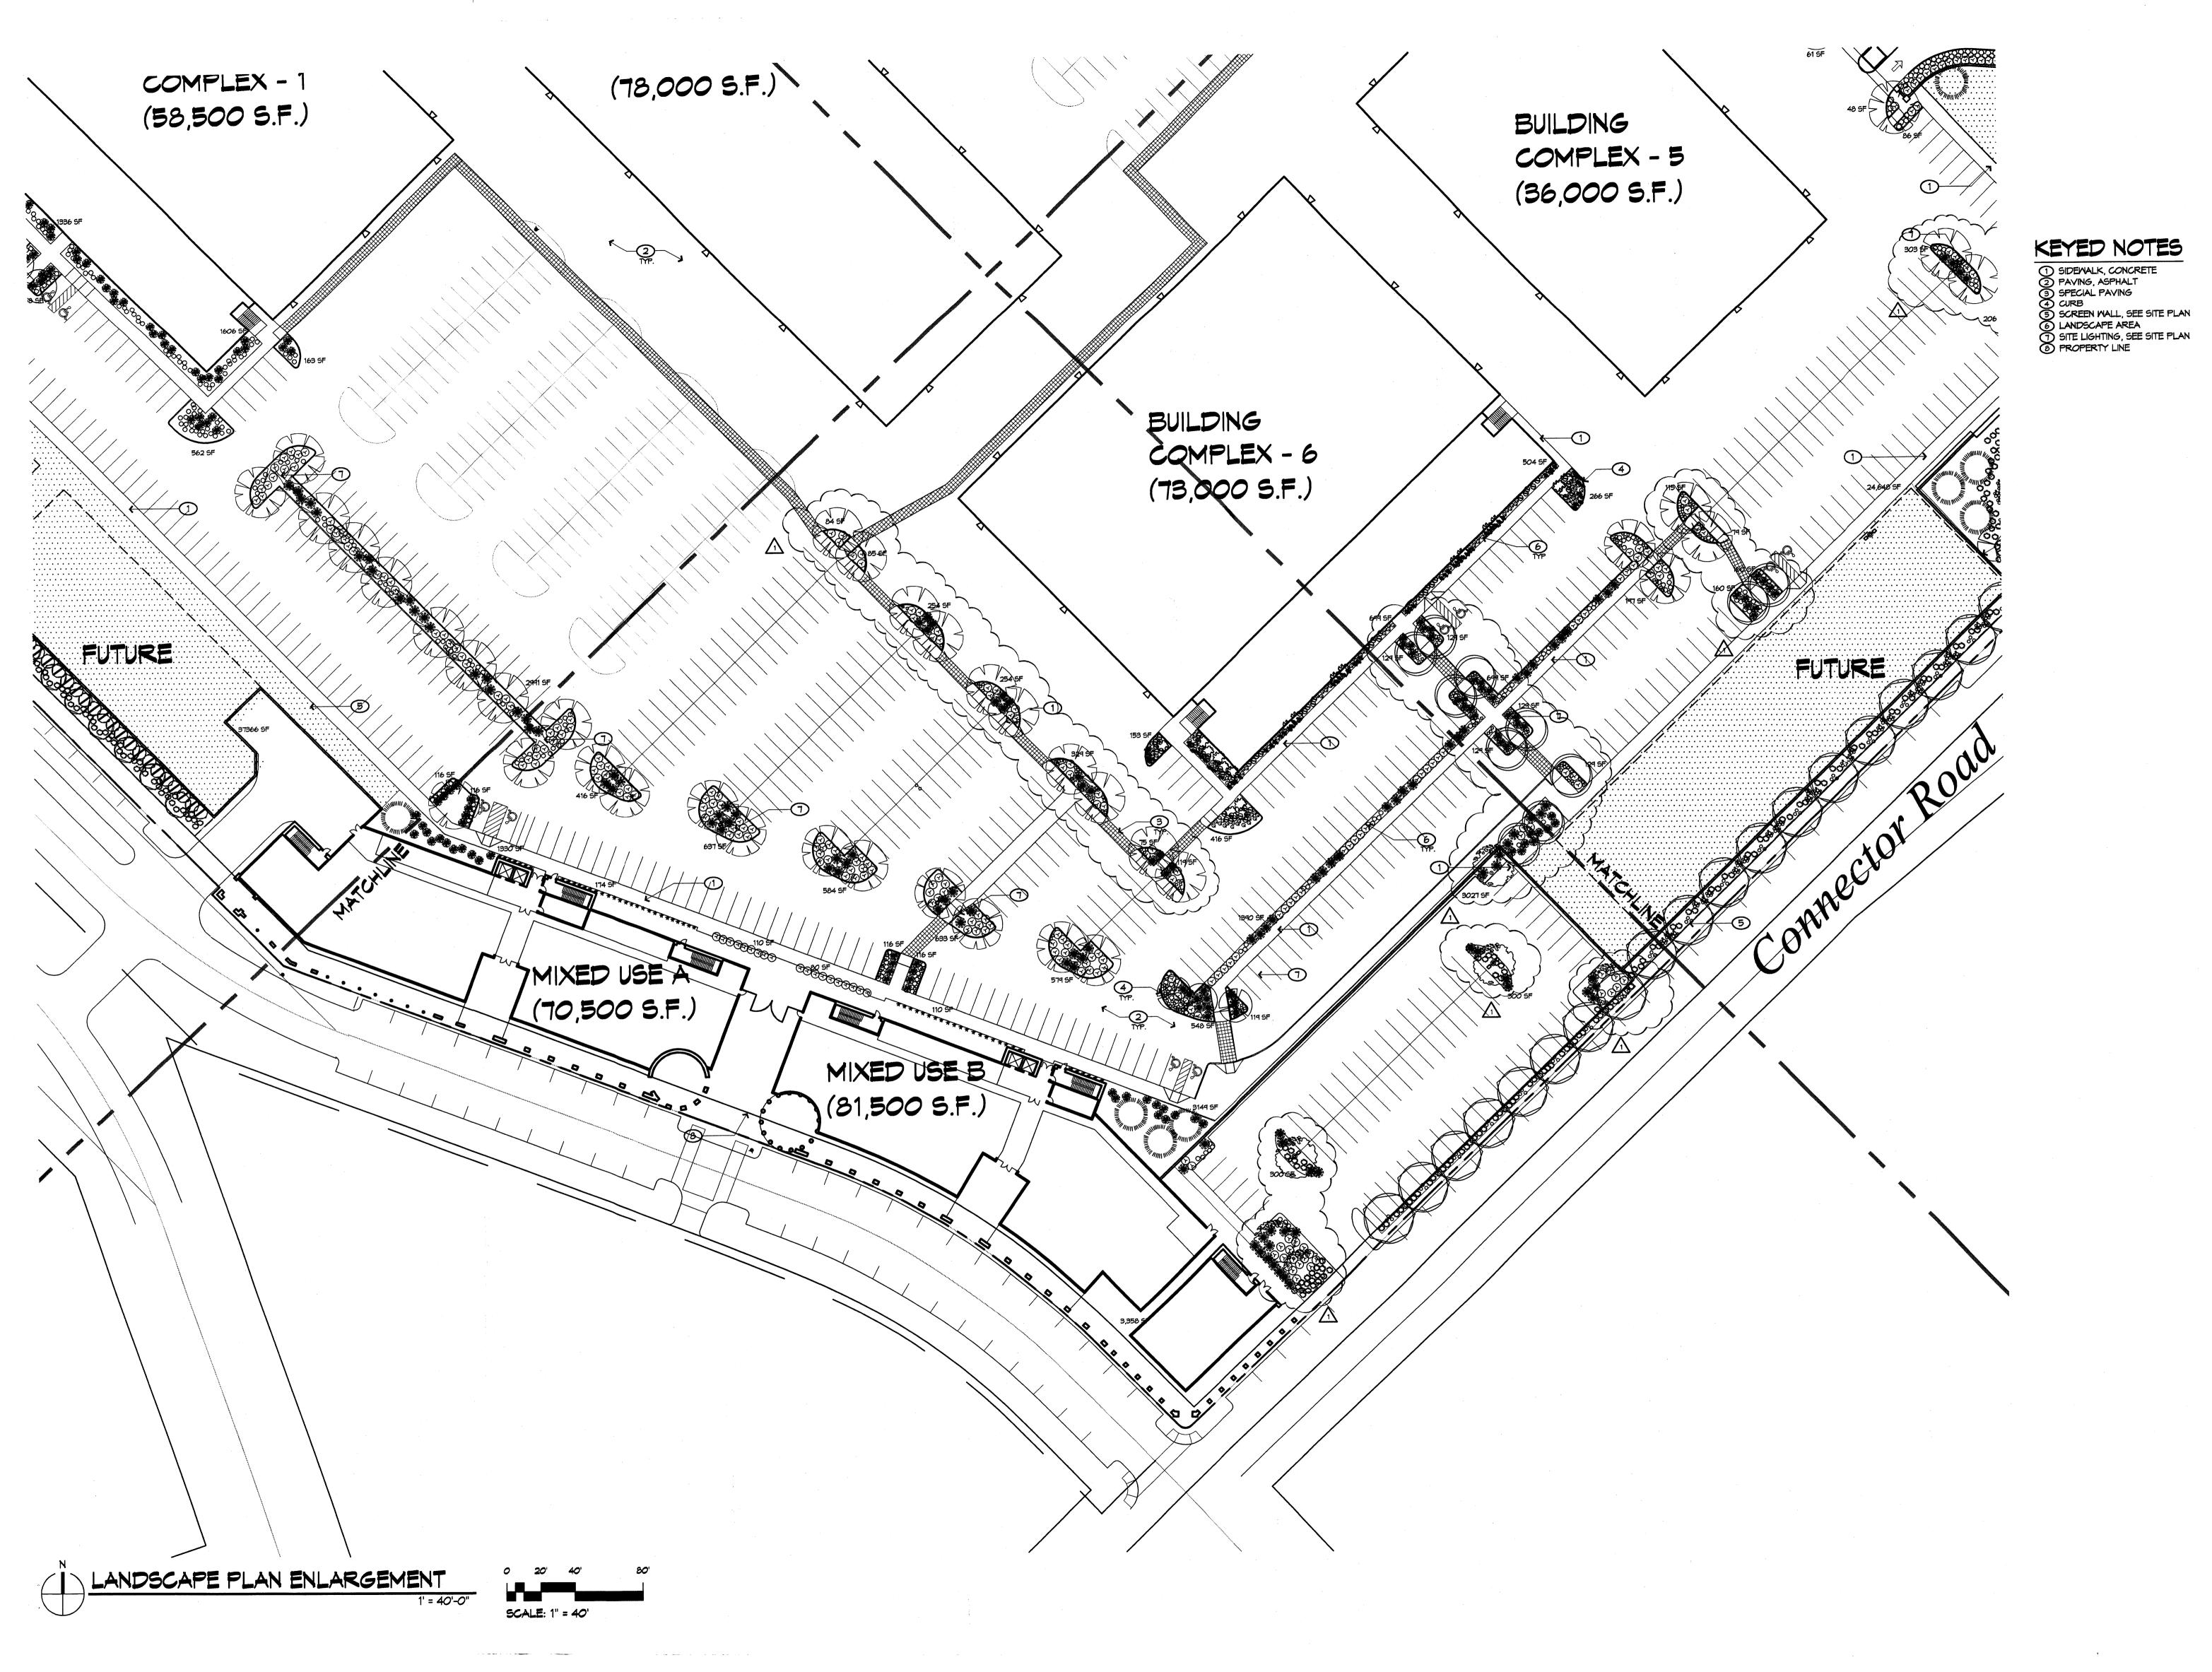



Dekker Perich Sabatin

> 6801 Jefferson NE Suite 100 Albuquerque, NM 87109 505 761-9700 fax 761-4222 dps @ dpsabq.com

architecture interiors

CHITECT

ENGINEER

PPO IFCT

Mesa Del Sol Film Studio Ibuquerque, New Mexico

REVISIONS


1 06/06/06 EPC Conditions


DRAWN BY	SZ
REVIEWED BY	MB
DATE	06/06/06
PROJECT NO.	06023
DRAWING NAME	

Landscape Plan Enlargement #2

SHEET NO.

05

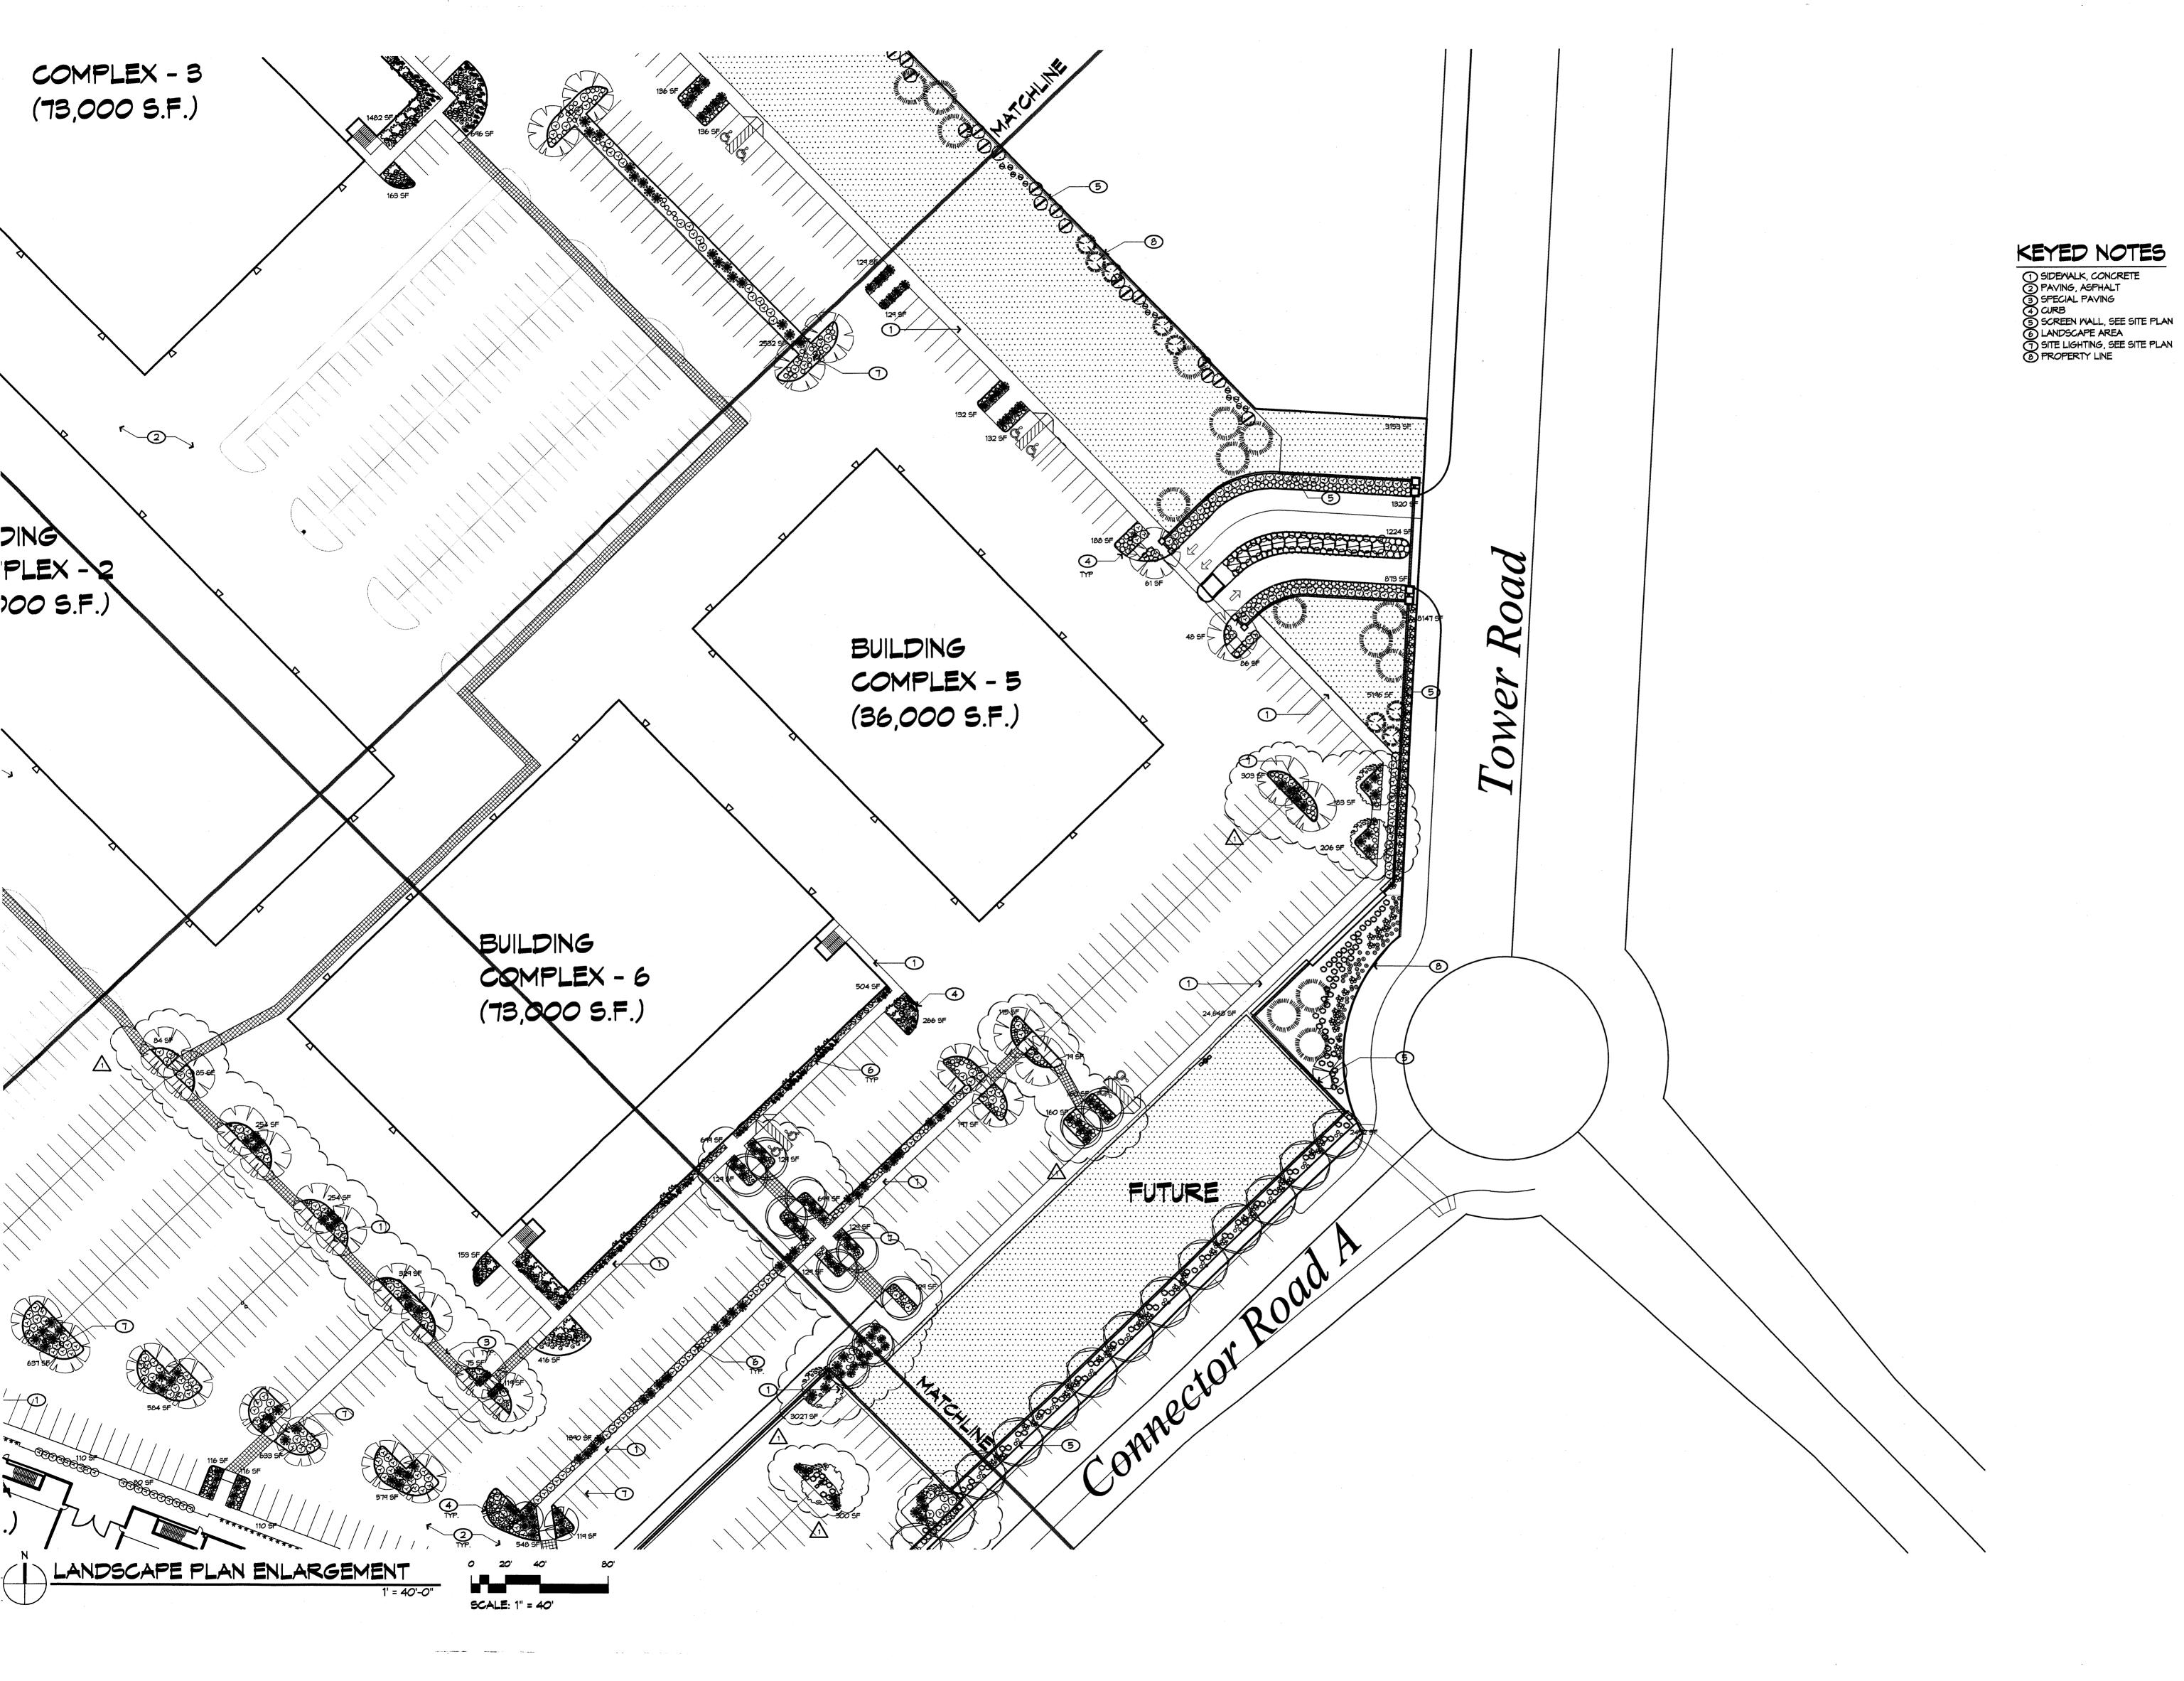

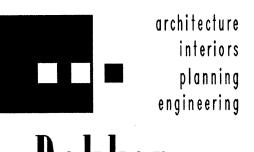


6801 Jefferson NE Suite 100 Albuquerque, NM 87109 505 761-9700 fax 761-4222 dps @dpsabq.com


ARCHITECT

DRAWN BY

REVIEWED BY DATE 06/06/06 06023 PROJECT NO. DRAWING NAME

ENLARGEMENT #3

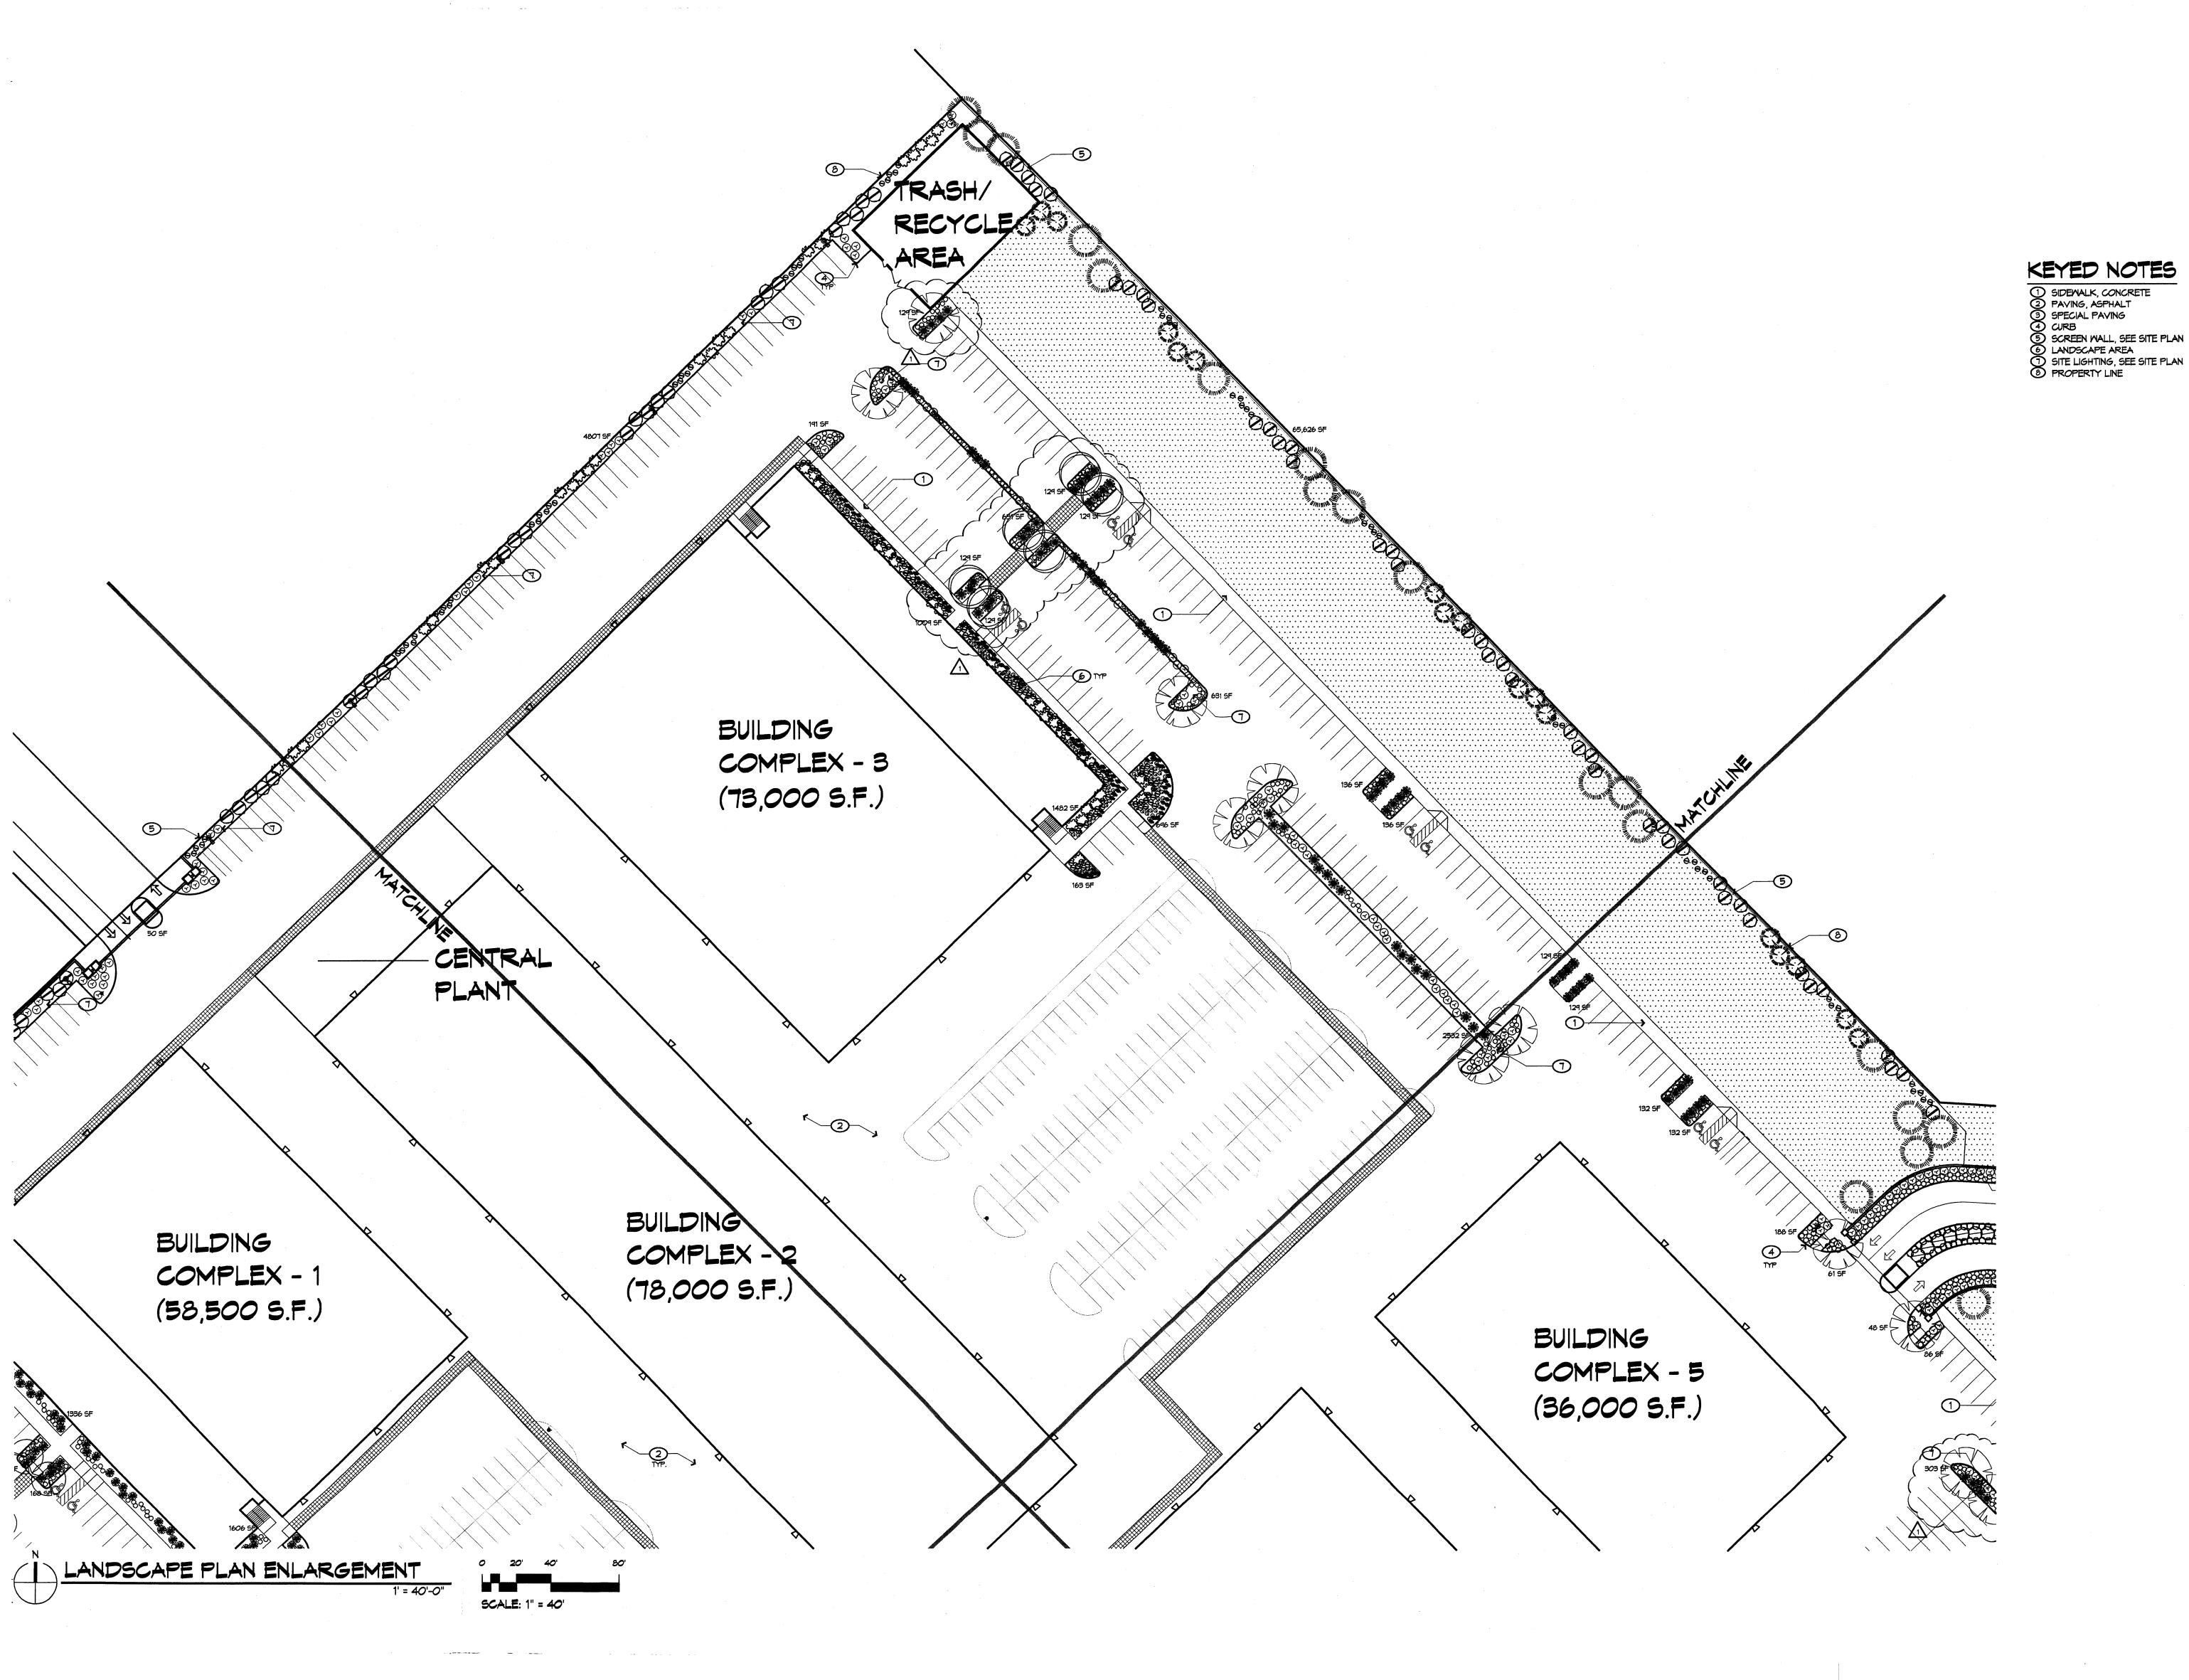

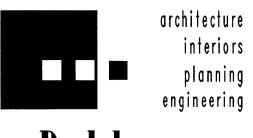

Dekker Perich Sabatini

6801 Jefferson NE Suite 100 Albuquerque, NM 87109 505761-9700 fax 761-4222 dps⊕dpsabq.com

ARCHITECT

ENGINEER

Film Studio

buquerque, New Mexico

REVISIONS

1 06/06/06 EPC Conditions

DRAWN BY SZ
REVIEWED BY MB

DATE 06/06/06


PROJECT NO. 06023

DRAWING NAME

Landscape plan Enlargement #4

SHEET NO.

OF OF

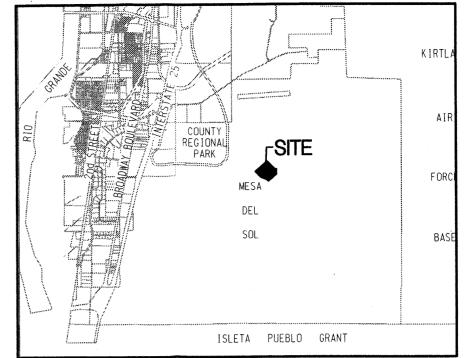

LOCATION MAP ZONE ATLAS INDEX MAP R-16 NOT TO SCALE

DRB SUBMITTAL

architecture

6801 Jefferson NE Suite 100 Albuquerque, NM 87109

505 761-9700 fax 761-4222 dps⊕dpsabq.com

GRADING NOTES

- 1. EXCEPT AS PROVIDED HEREIN, GRADING SHALL BE PERFORMED AT THE ELEVATIONS AND IN ACCORDANCE WITH THE DETAILS SHOWN ON THIS PLAN.
- 2. THE COST FOR REQUIRED CONSTRUCTION DUST AND EROSION CONTROL MEASURES SHALL BE INCIDENTAL
- 3. ALL WORK RELATIVE TO FOUNDATION CONSTRUCTION, SITE PREPARATION, AND PAVEMENT INSTALLATION, AS SHOWN ON THIS PLAN, SHALL BE CONSTRUCTED IN ACCORDANCE WITH THE "GEOTECHNICAL INVESTIGATION," AS PROVIDED BY THE ARCHITECT OR OWNER. ALL OTHER WORK SHALL, UNLESS OTHERWISE STATED OR PROVIDED FOR HEREON, BE CONSTRUCTED IN ACCORDANCE WITH THE PROJECT, (FIRST PRIORITY) SPECIFICATIONS, AND/OR THE CITY OF ALBUQUERQUE (COA) STANDARD SPECIFICATIONS FOR PUBLIC WORKS (SECOND PRIORITY).
- 4. EARTH SLOPES SHALL NOT EXCEED 3 HORIZONTAL TO 1 VERTICAL UNLESS SHOWN OTHERWISE.
- 5. IT IS THE INTENT OF THESE PLANS THAT THIS CONTRACTOR SHALL NOT PERFORM ANY WORK OUTSIDE OF THE PROPERTY BOUNDARIES EXCEPT AS REQUIRED BY THIS PLAN.
- 6. THE CONTRACTOR IS TO ENSURE THAT NO SOIL ERODES FROM THE SITE ONTO ADJACENT PROPERTY OR PUBLIC RIGHT-OF-WAY. THIS SHOULD BE ACHIEVED BY CONSTRUCTING TEMPORARY BERMS OR SILT FENCE AT THE PROPERTY LINES AND WETTING THE SOIL TO PROTECT IT FROM WIND EROSION.
- 7. A DISPOSAL SITE FOR ANY & ALL EXCESS EXCAVATION MATERIAL, AND UNSUITABLE MATERIAL AND/OR A BORROW SITE CONTAINING ACCEPTABLE FILL MATERIAL SHALL BE OBTAINED BY THE CONTRACTOR IN COMPLIANCE WITH APPLICABLE ENVIRONMENTAL REGULATIONS AND APPROVED BY THE OBSERVER. ALL COSTS INCURRED IN OBTAINING A DISPOSAL OR BORROW SITE AND HAUL TO OR FROM SHALL BE CONSIDERED INCIDENTAL TO THE PROJECT AND NO SEPARATE MEASUREMENT OR PAYMENT SHALL BE MADE.
- 8. PAVING AND ROADWAY GRADES SHALL BE +/- 0.1' FROM PLAN ELEVATIONS. PAD ELEVATION SHALL BE +/- 0.05' FROM BUILDING PLAN ELEVATION.
- 9. ALL PROPOSED CONTOURS REFLECT TOP OF PAVEMENT ELEVATIONS IN THE PARKING AREA AND MUST BE ADJUSTED FOR MEDIANS AND ISLANDS.
- 10. VERIFY ALL ELEVATIONS SHOWN ON PLAN FROM BASIS OF ELEVATION CONTROL STATION PRIOR TO BEGINNING CONSTRUCTION.

NOTE: OFFSITE FLOWS UPSTREAM OF UNIVERSITY BLVD WILL BE RETAINED IN MASTER PLANNED DRAINAGE FACILITY (LOCATED WEST OF UNIVERSITY BLVD)


Bohannan \land Huston


Courtyard I 7500 Jefferson St. NE Albuquerque, NM 87109-4335 ENGINEERING A SPATIAL DATA A ADVANCED TECHNOLOGIES **REVISIONS**

Sa

RNB DRAWN BY JLM REVIEWED BY 06/06/06 06023 PROJECT NO.

DRAWING NAME CONCEPTUAL GRADING AND DRAINAGE PLAN

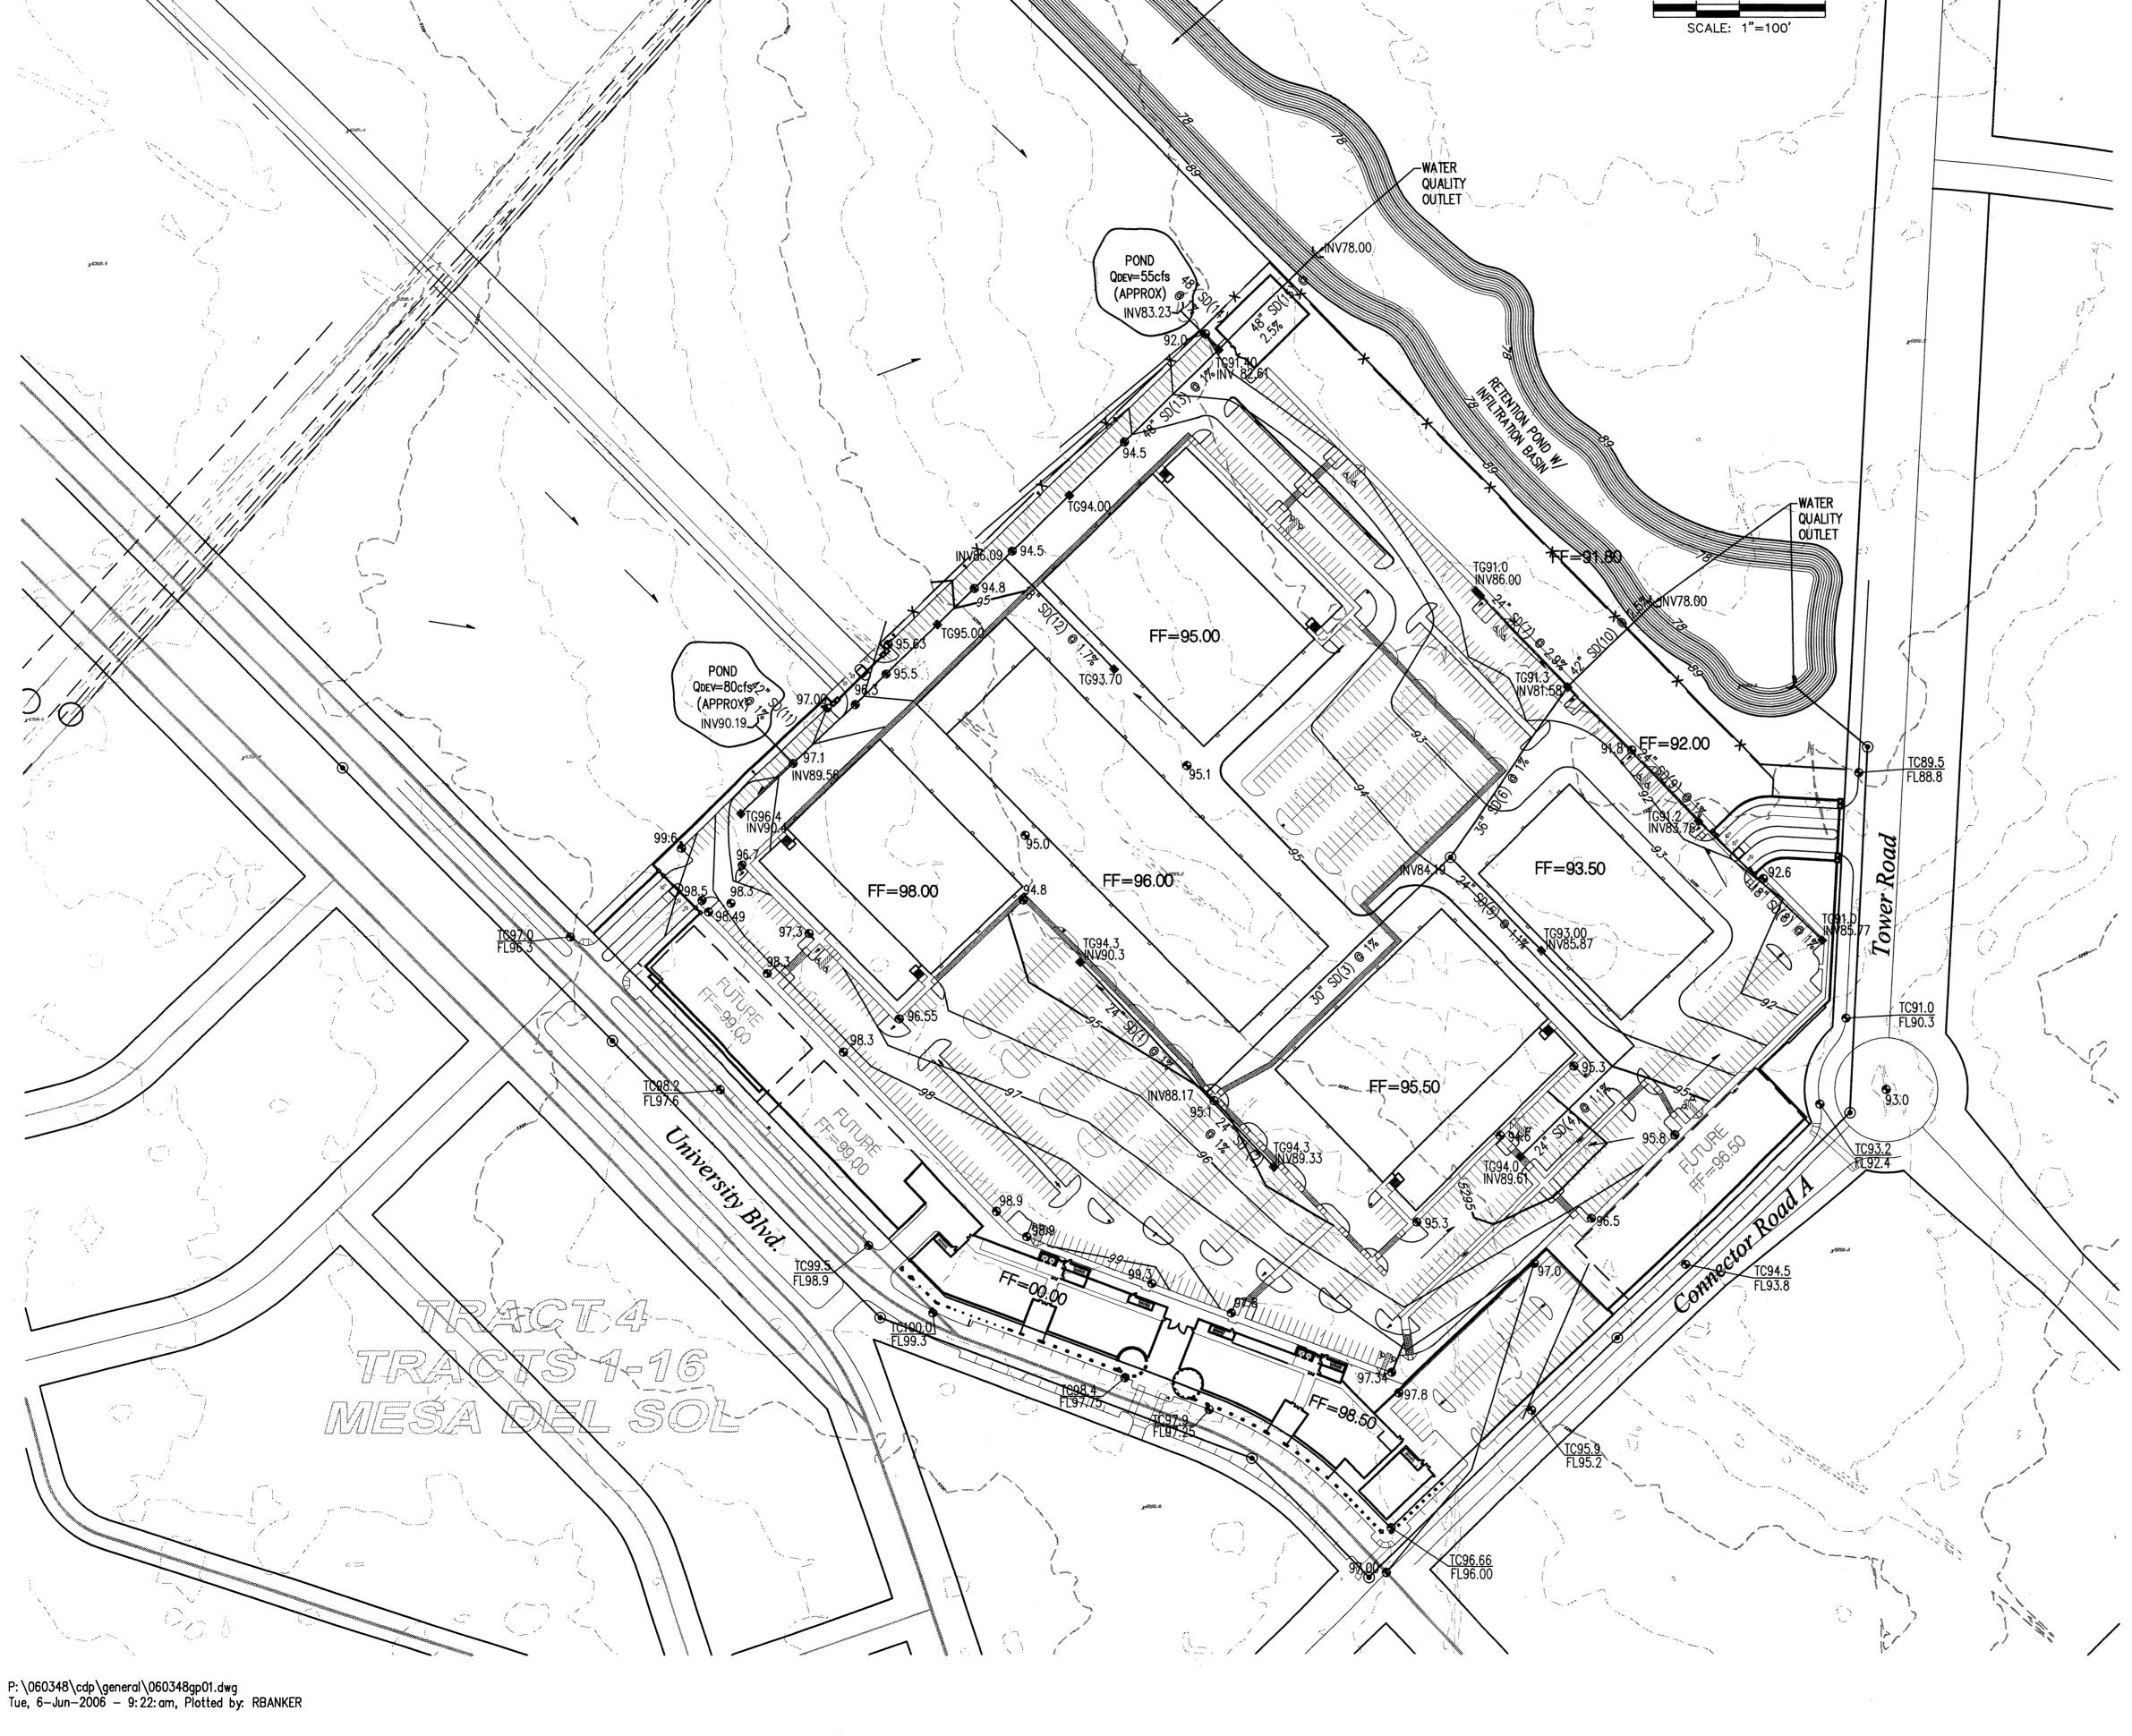

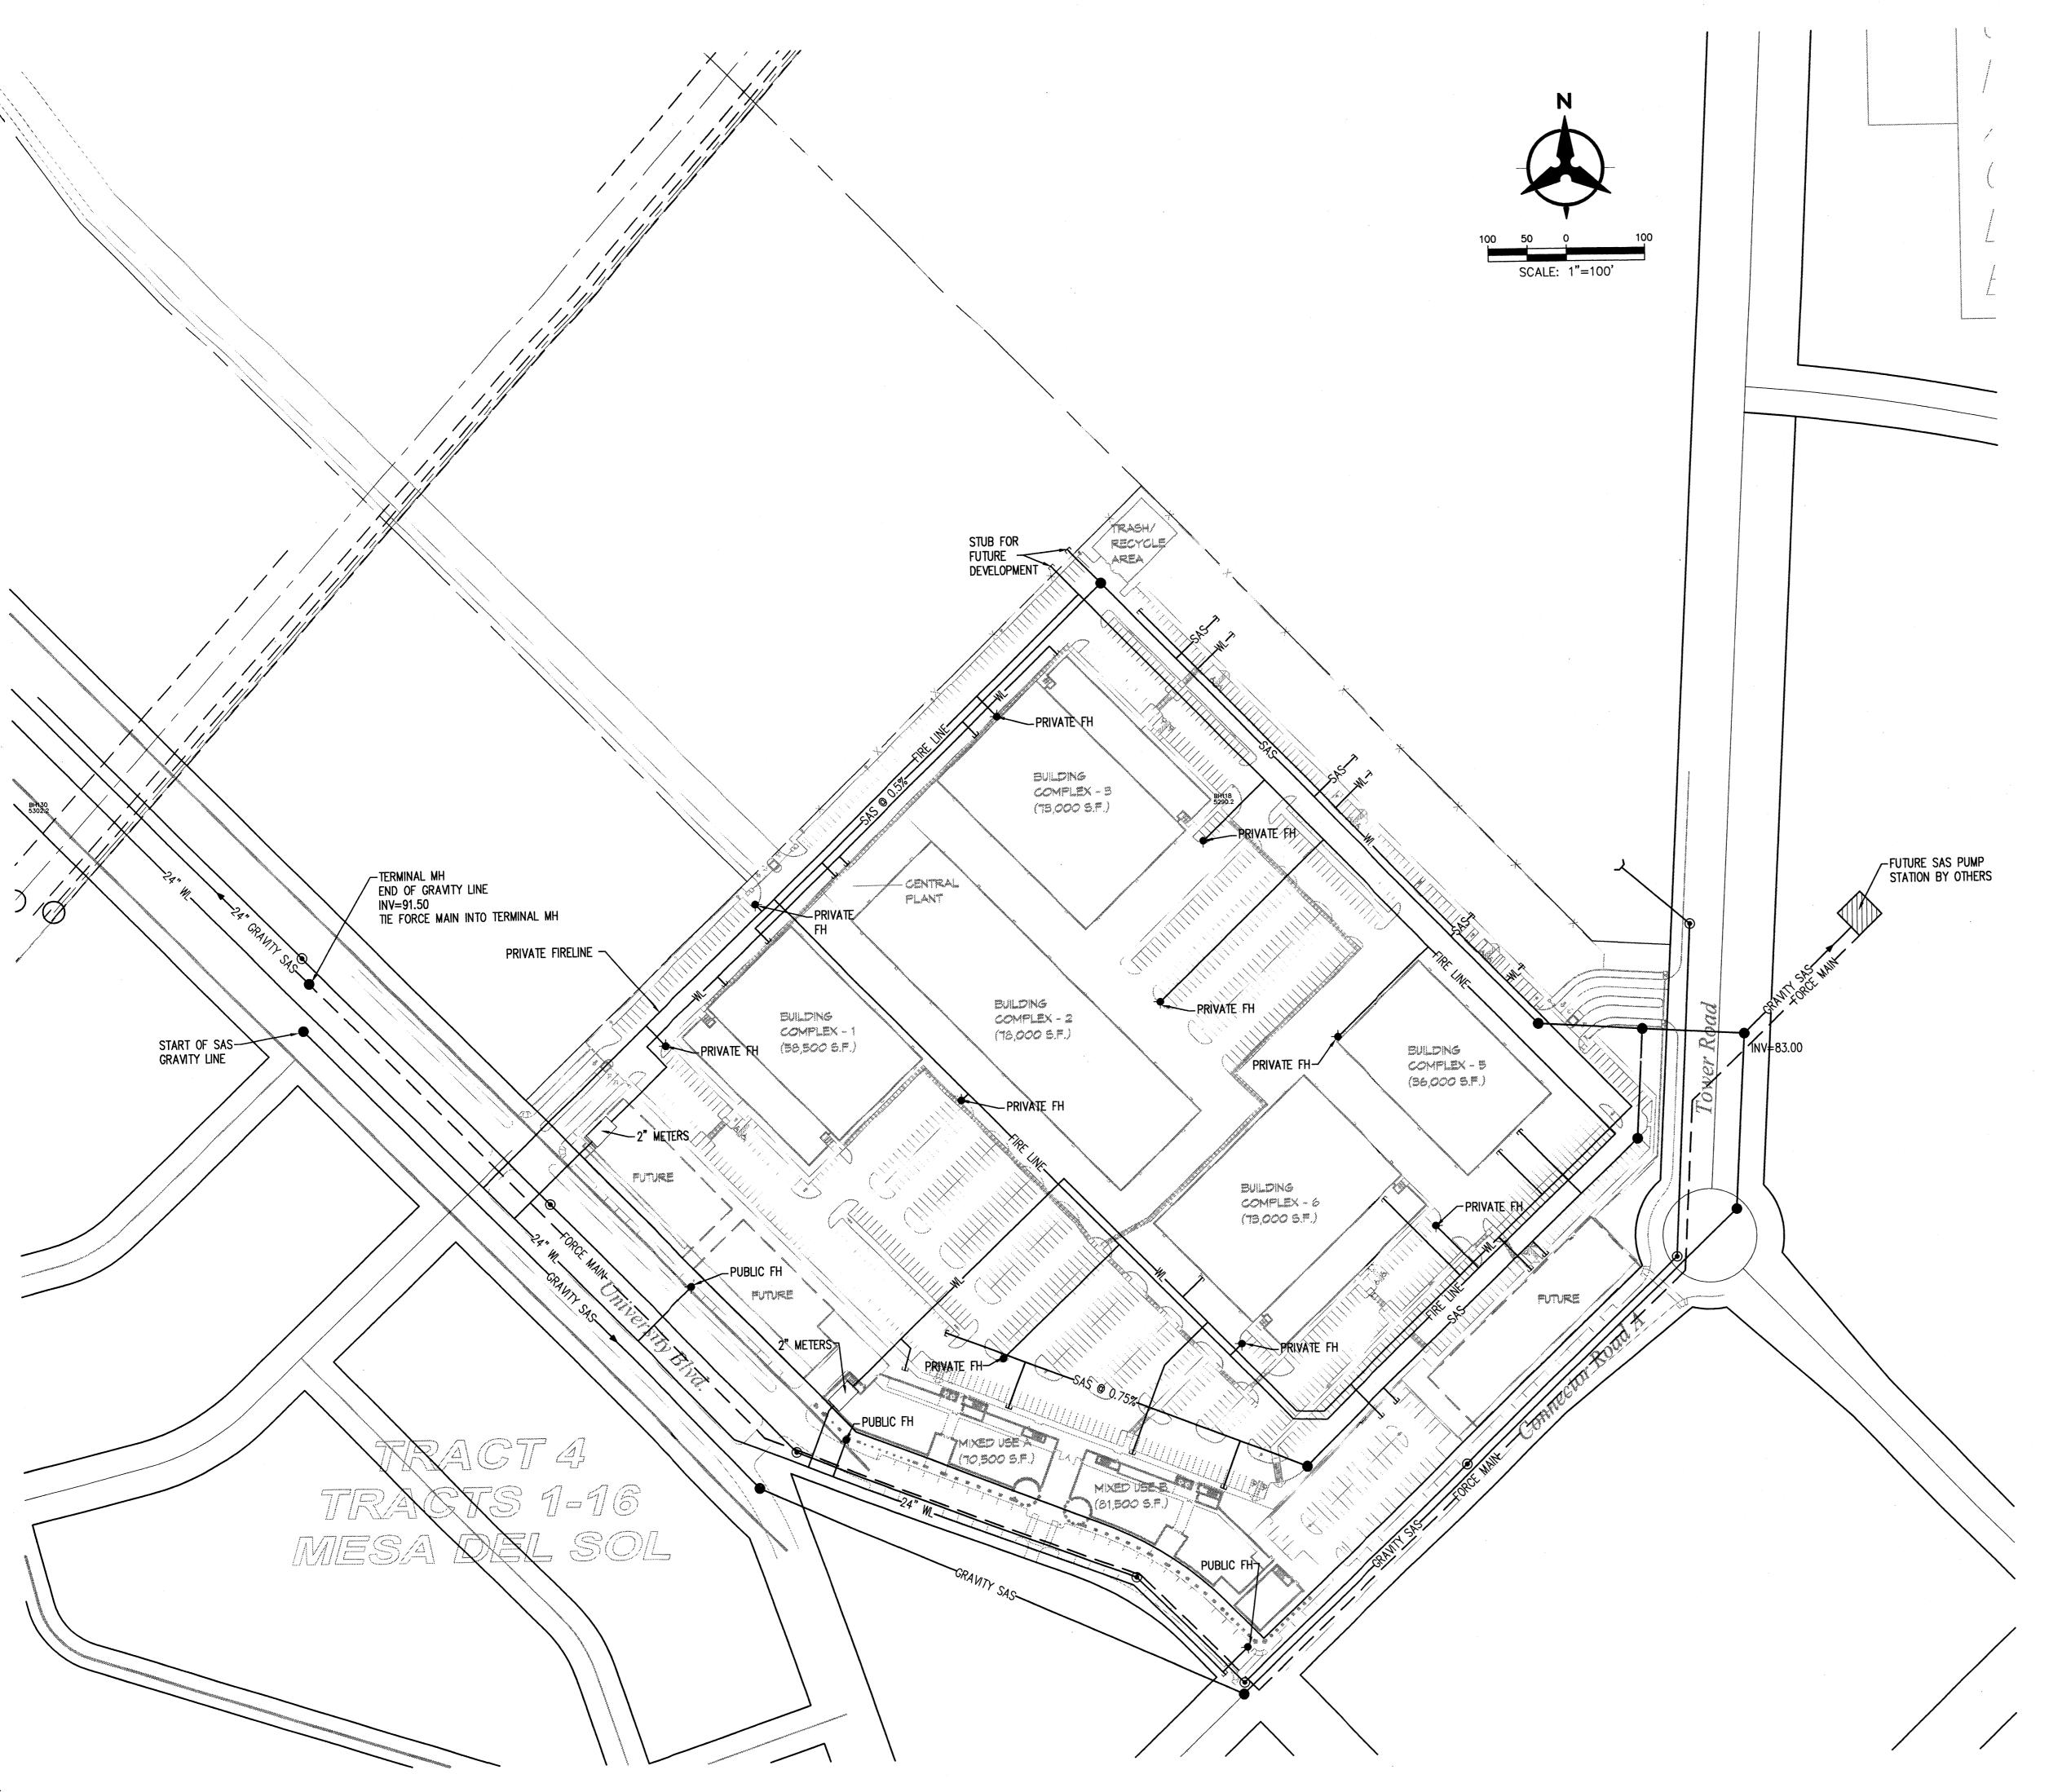

Dekke

Dekker Perich Sabatini

6801 Jefferson NE Suite 100 Albuquerque, NM 87109 505 761-9700 fax 761-4222 dps⊕dpsabq.com

ARCHITECT

DRB SUBMITTAL

NGINEER

PROJECT

Film Studio
Abuquerque, New Mexico

DRAWN BY

REVIEWED BY

DATE

06/06/06

PROJECT NO.

06023

DRAWING NAME


CONCEPTUAL UTILITY PLAN


SHEET NO


09

Courtyard | 7500 Jefferson St. NE Albuquerque, NM 87109-4335
ENGINEERING & SPATIAL DATA & ADVANCED TECHNOLOGIES

NOTE: OFFSITE UTILITIES TO BE COMPLETED BY SEPERATE CONTRACT

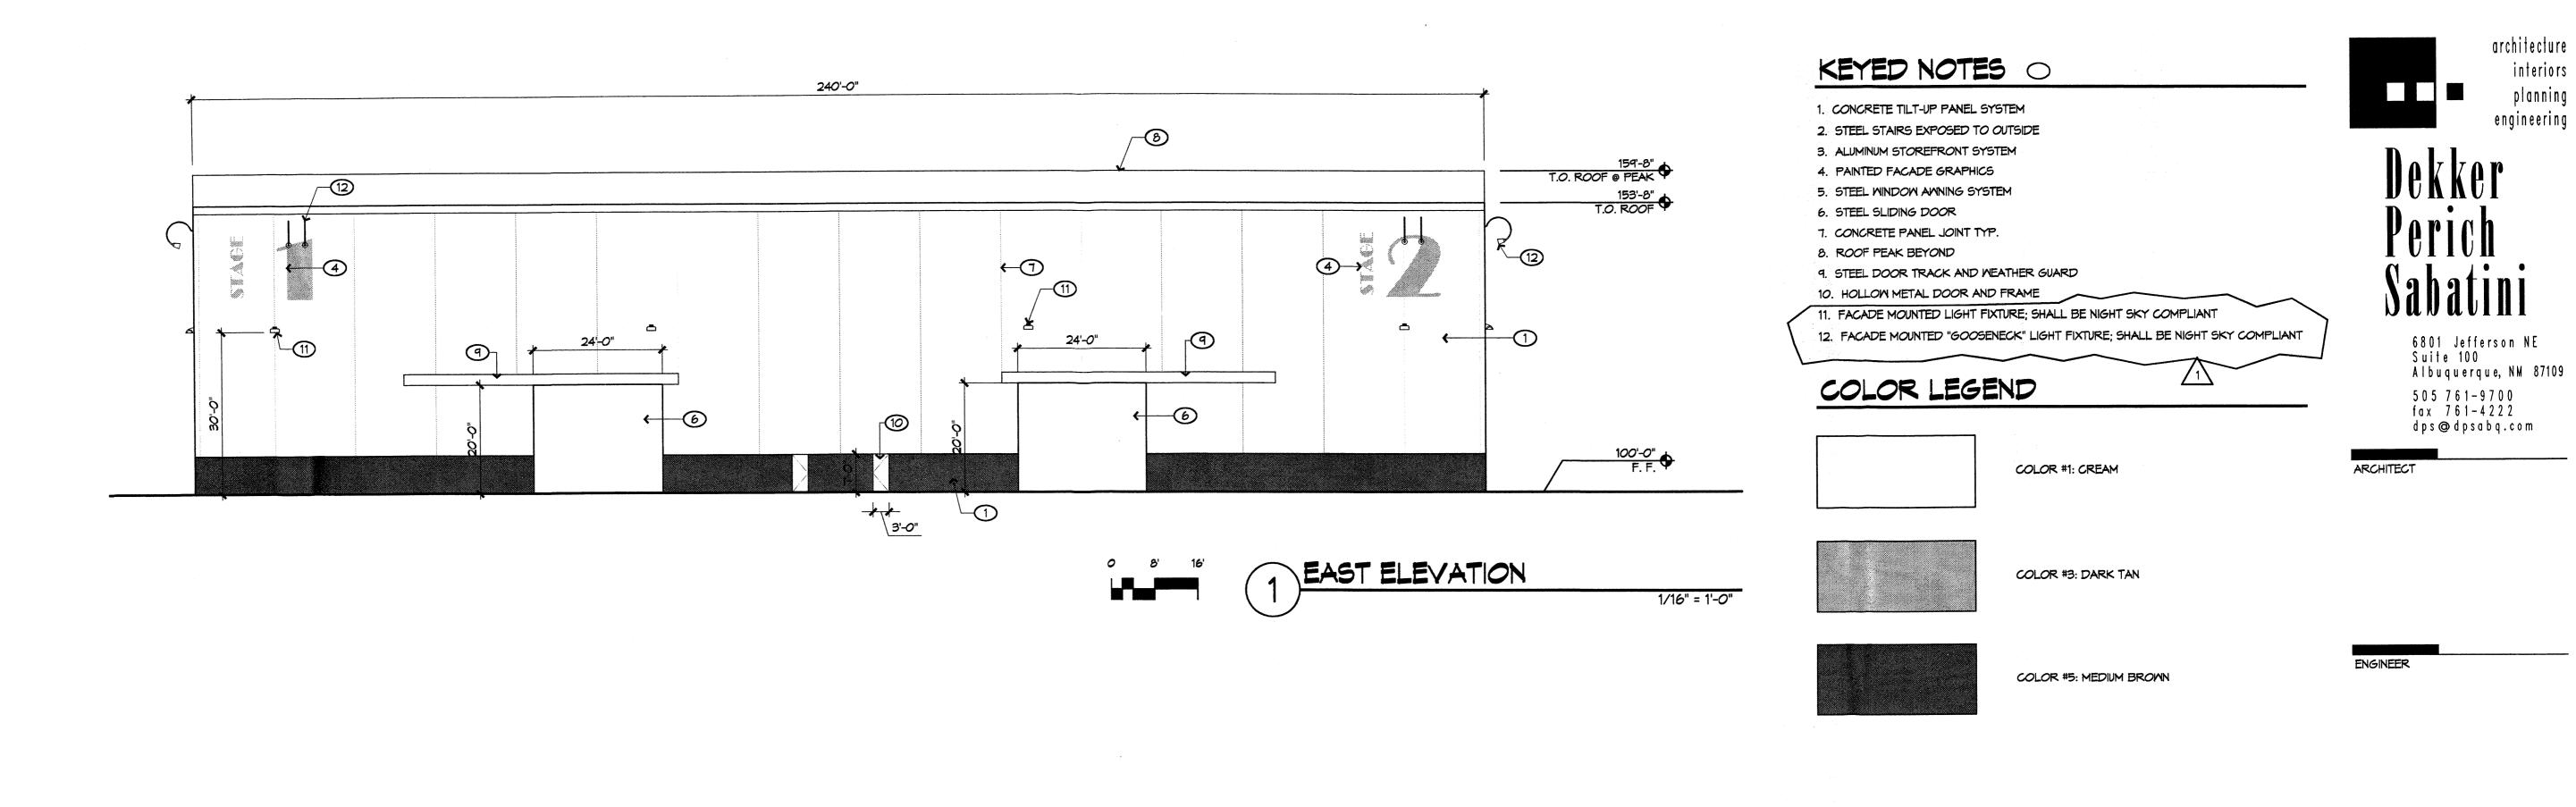

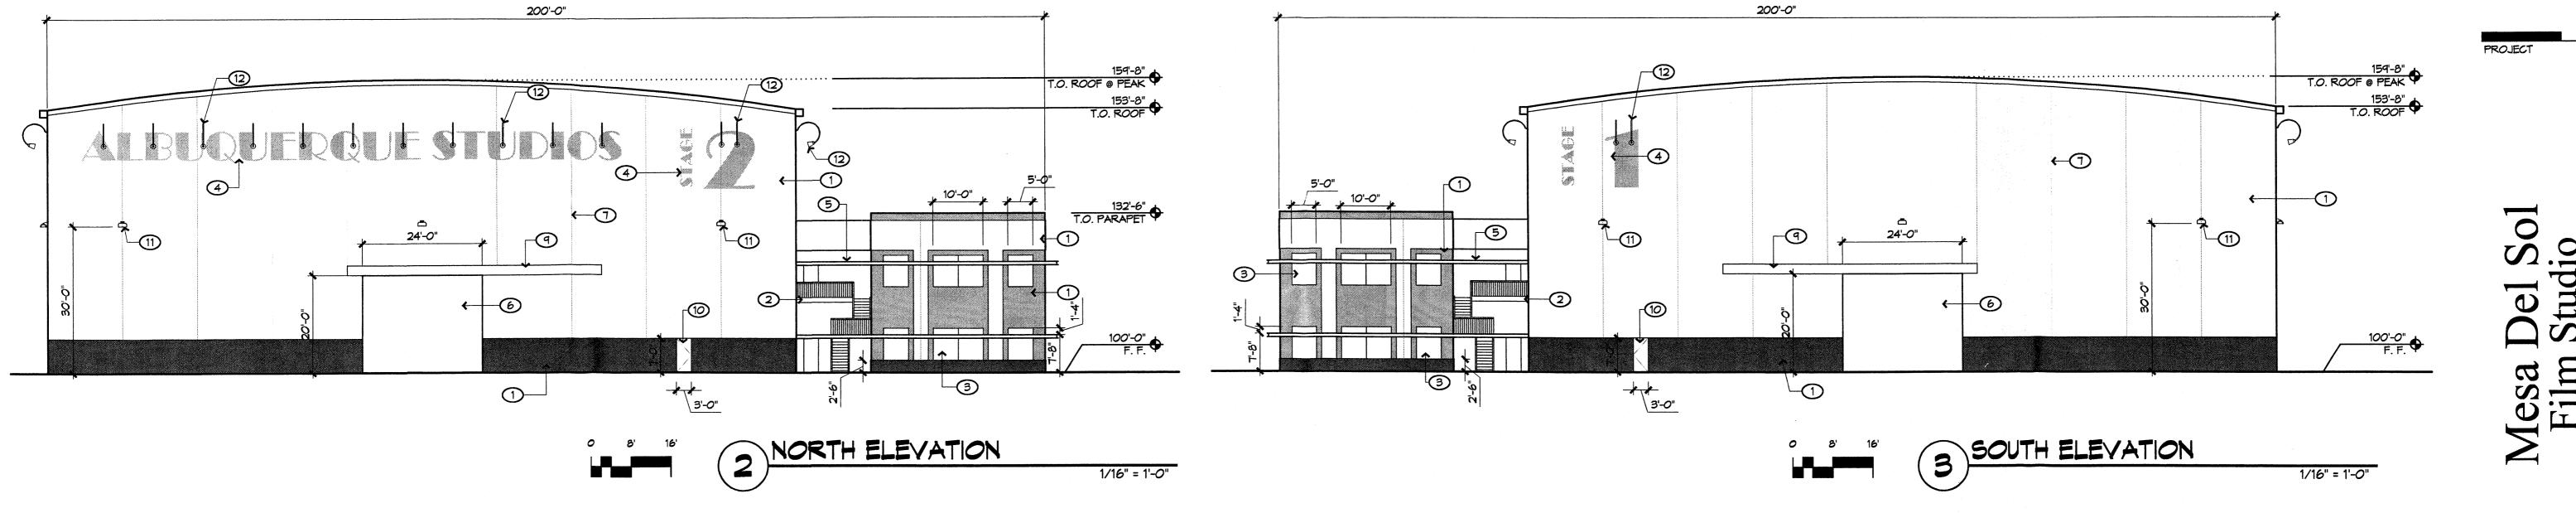


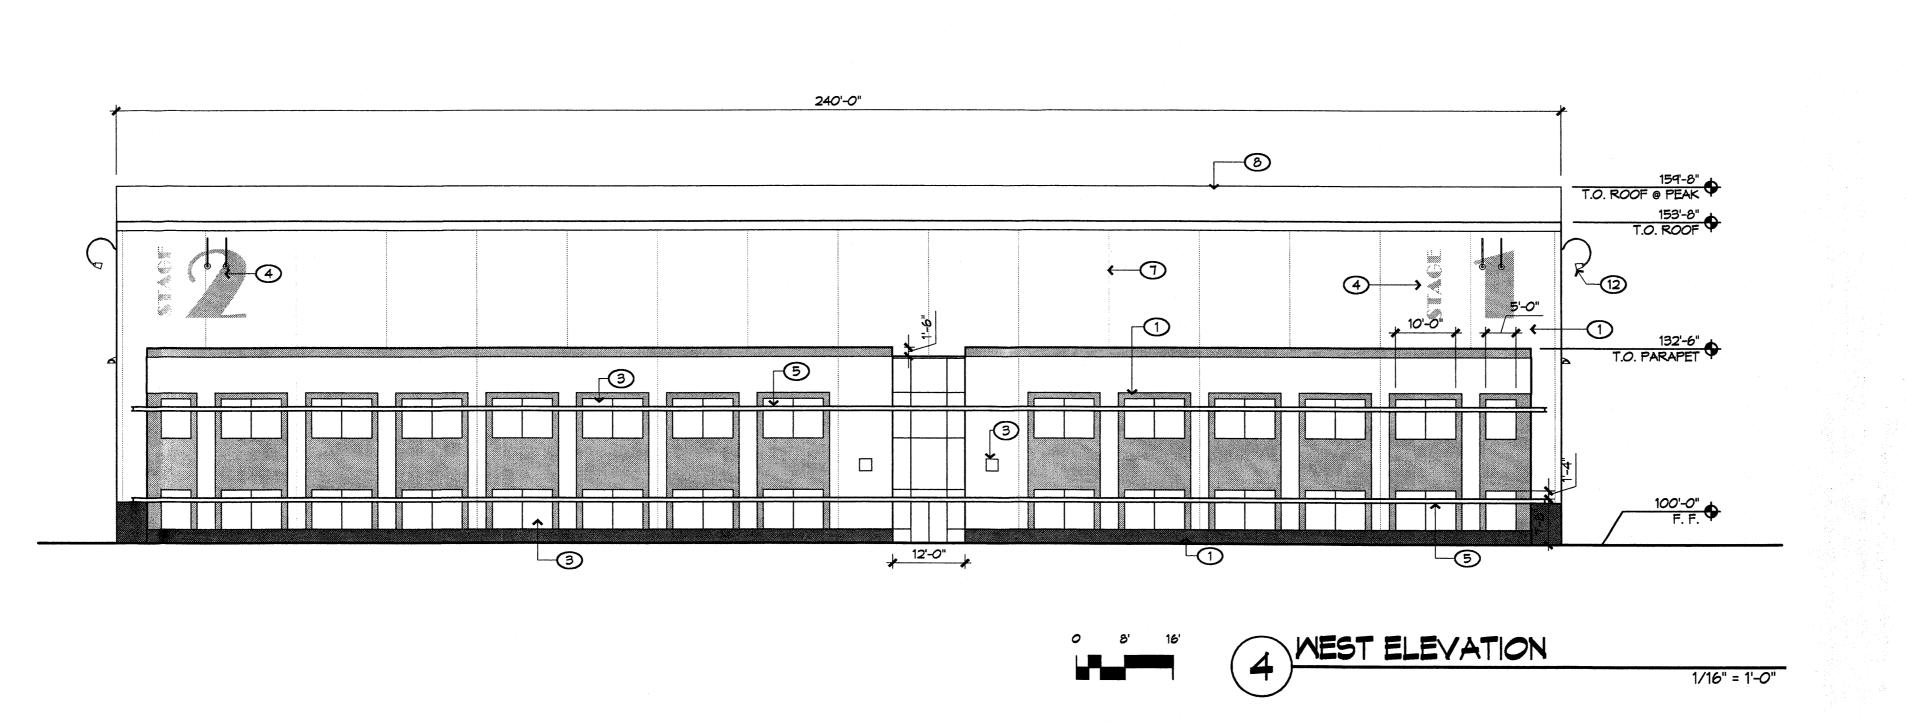



REVISIONS 1 06/06/06 EPC Conditions

DRAWN BY REVIEWED BY 06/06/06 DATE PROJECT NO. 06023 DRAWING NAME

ELEVATIONS-BUILDING COMPLEX - 1

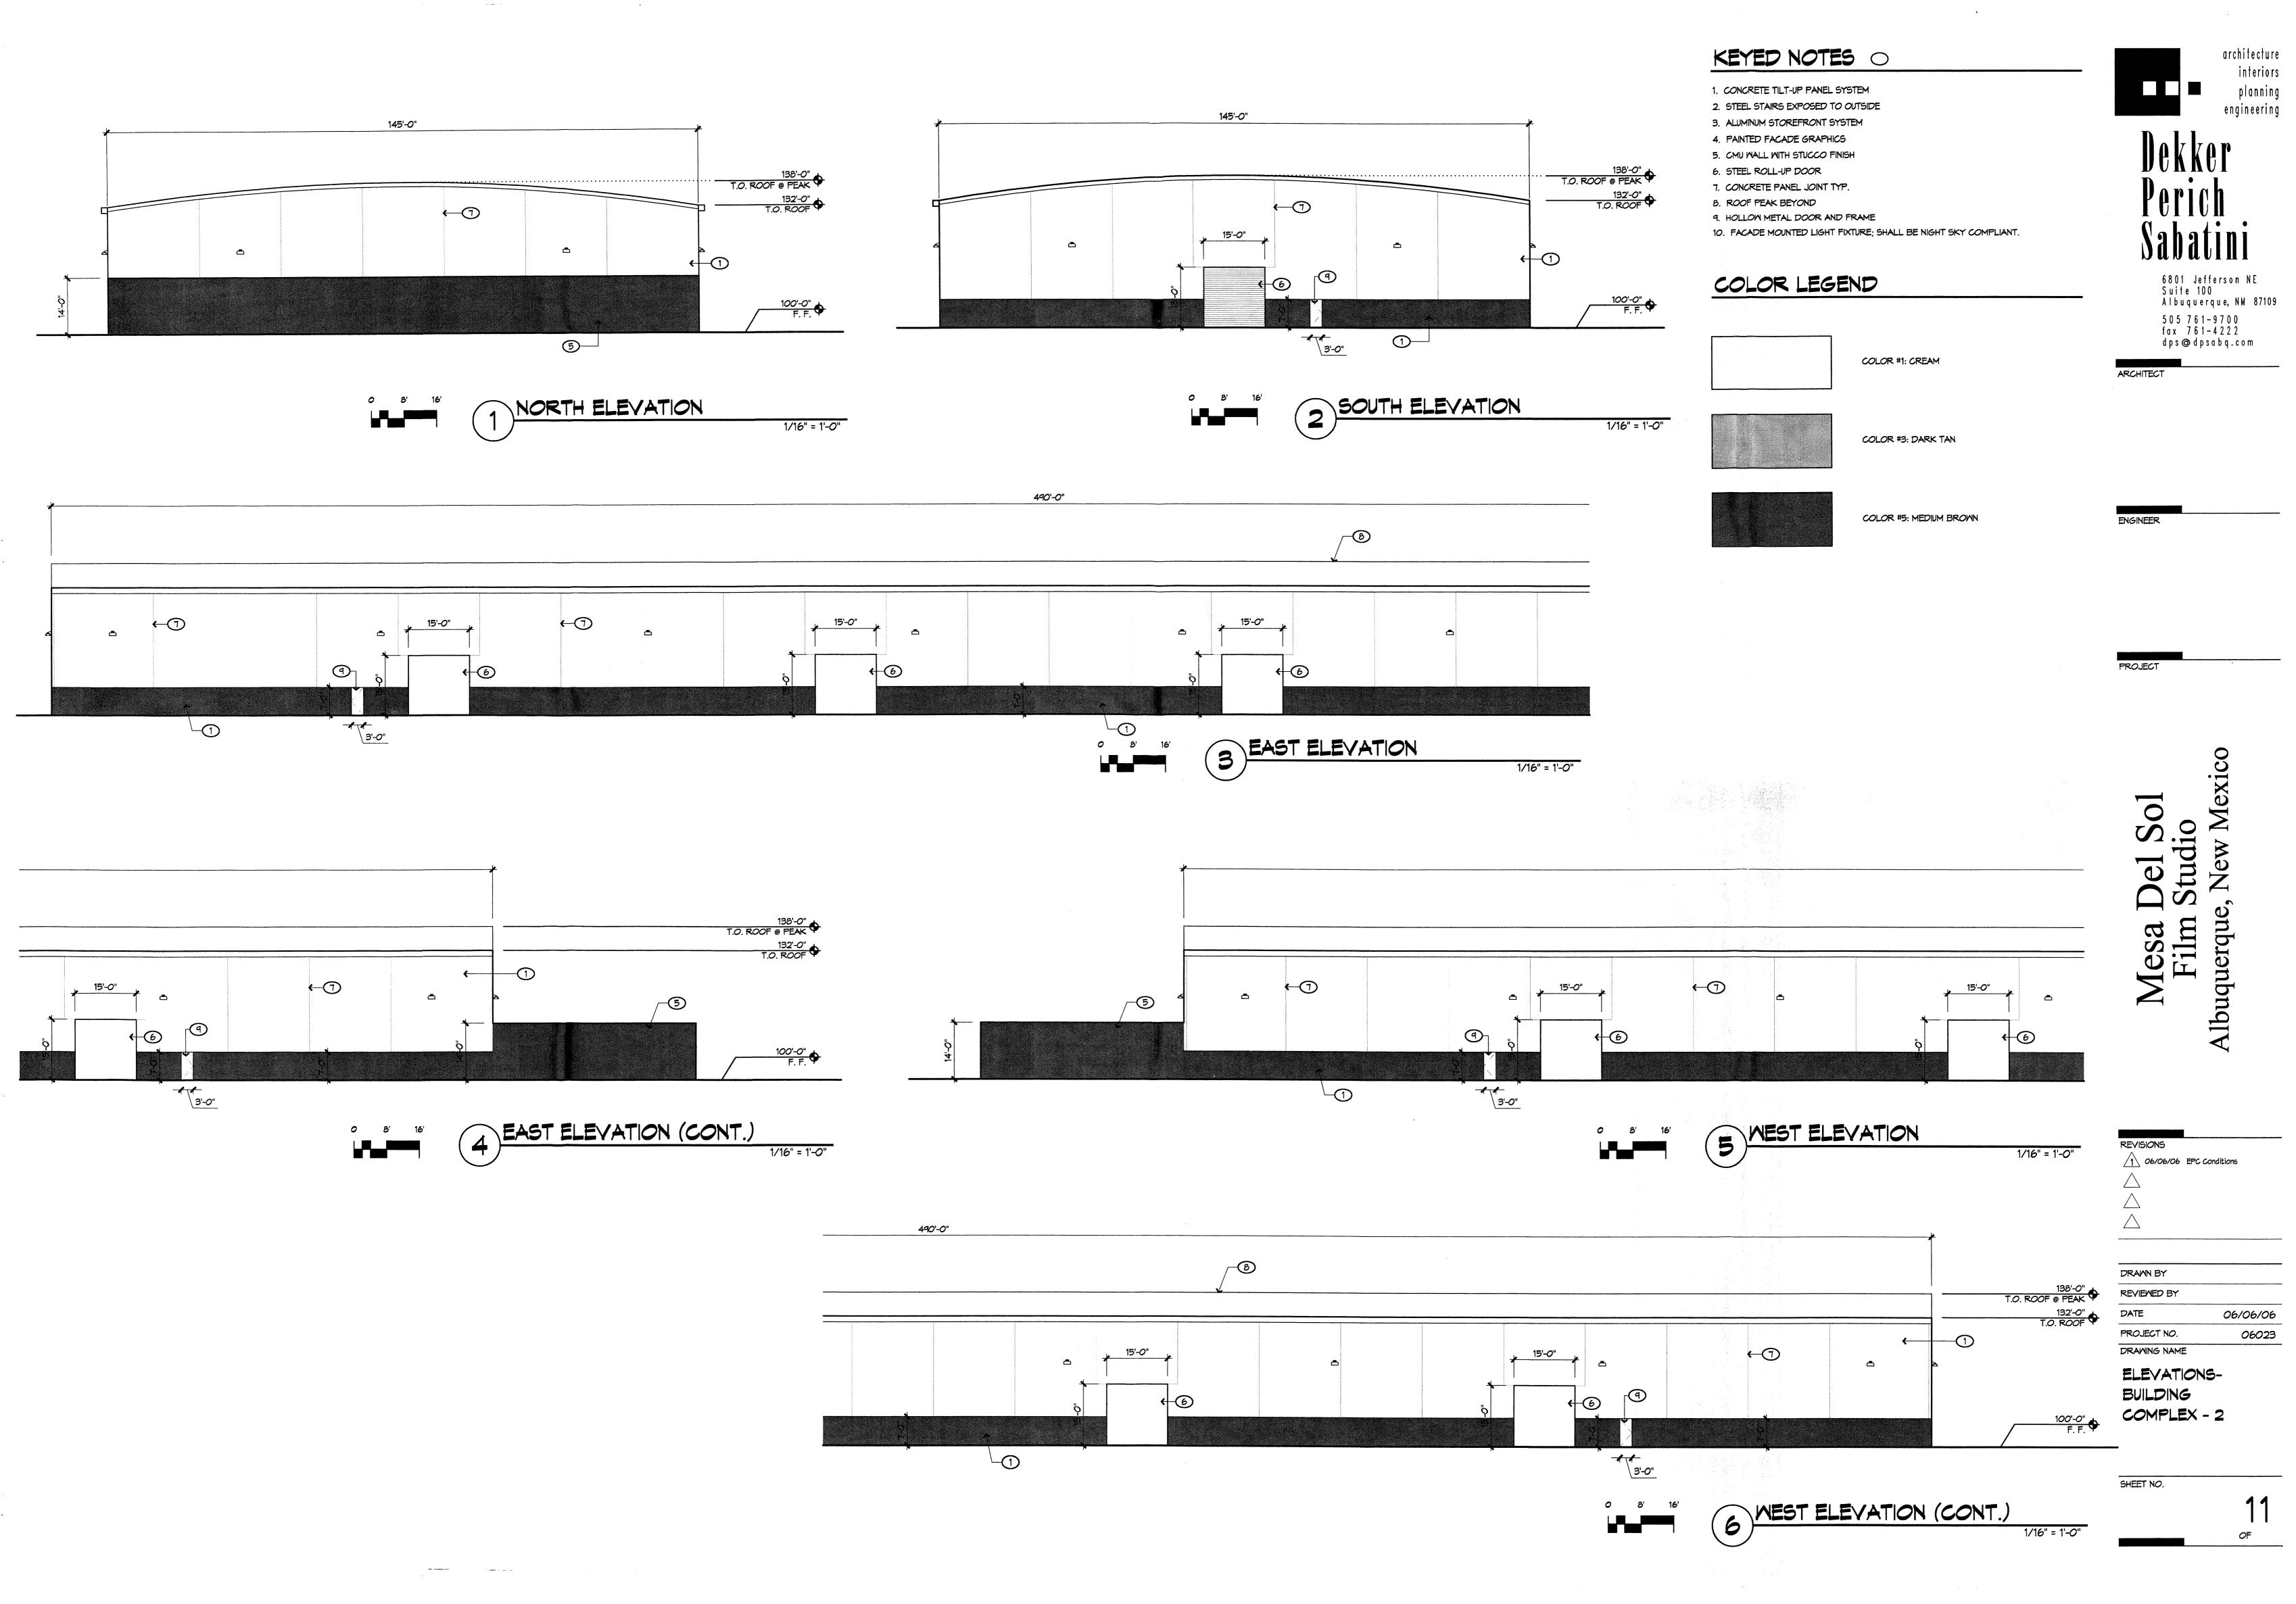

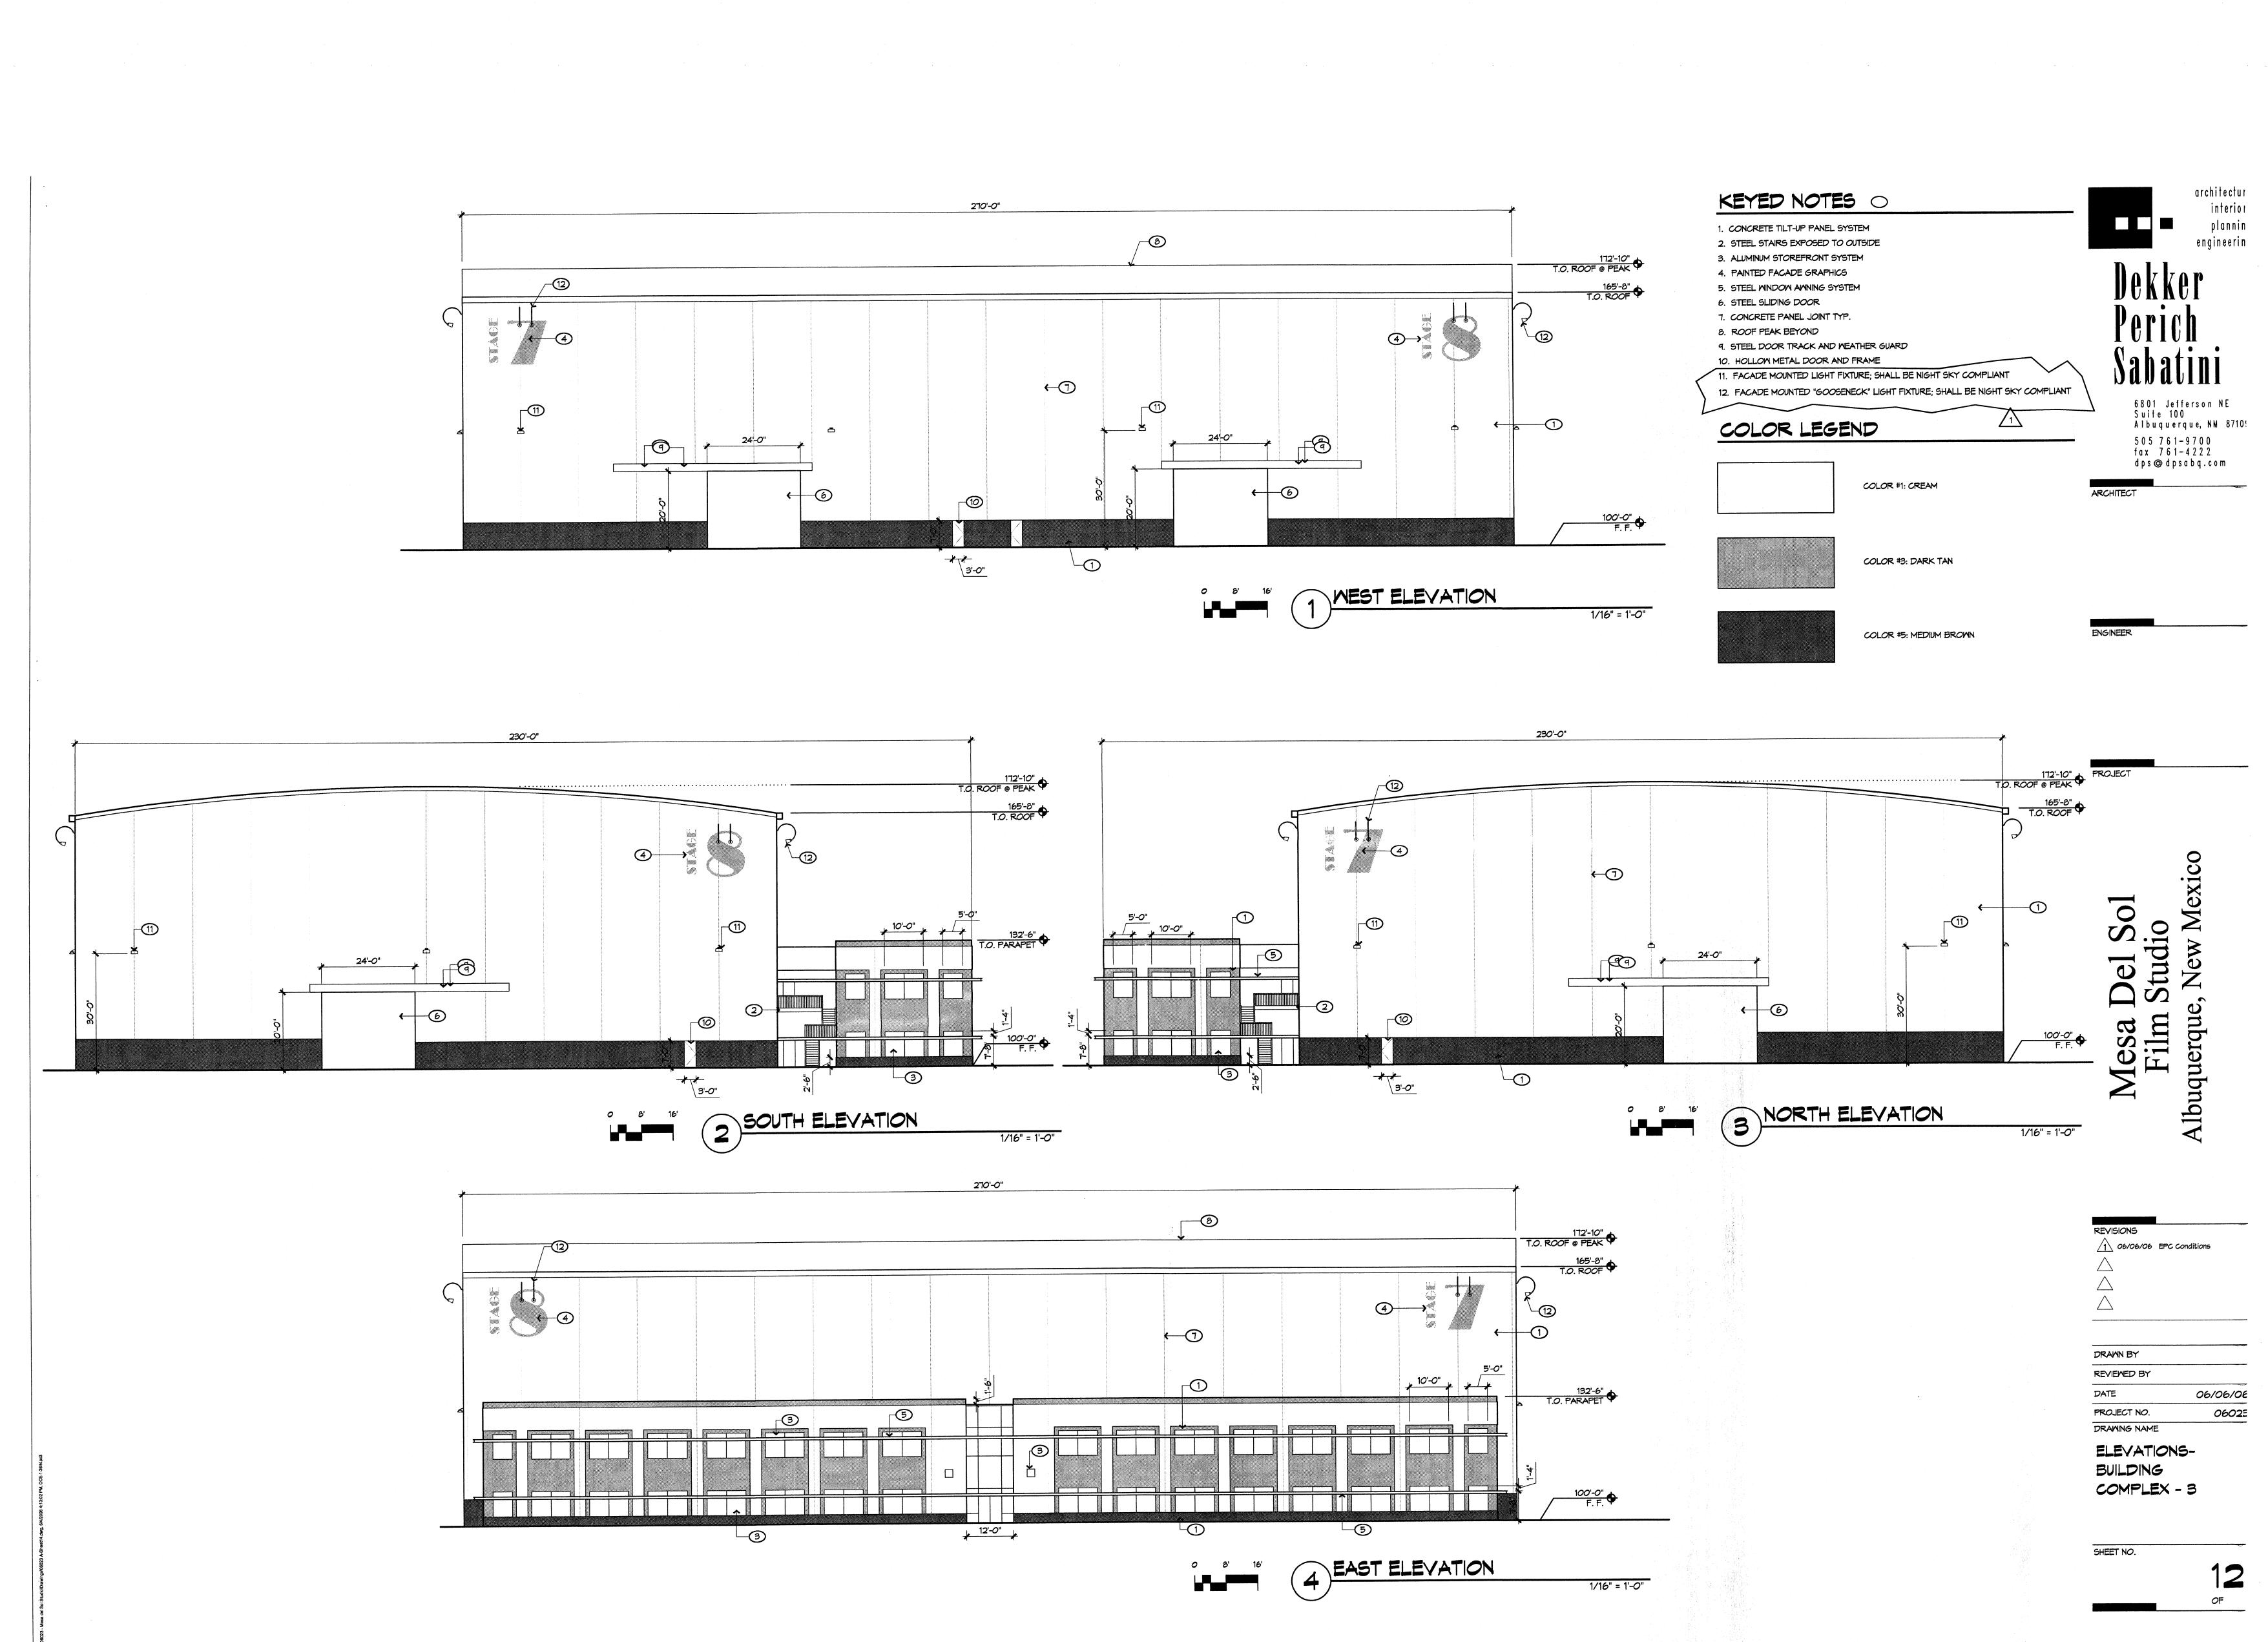

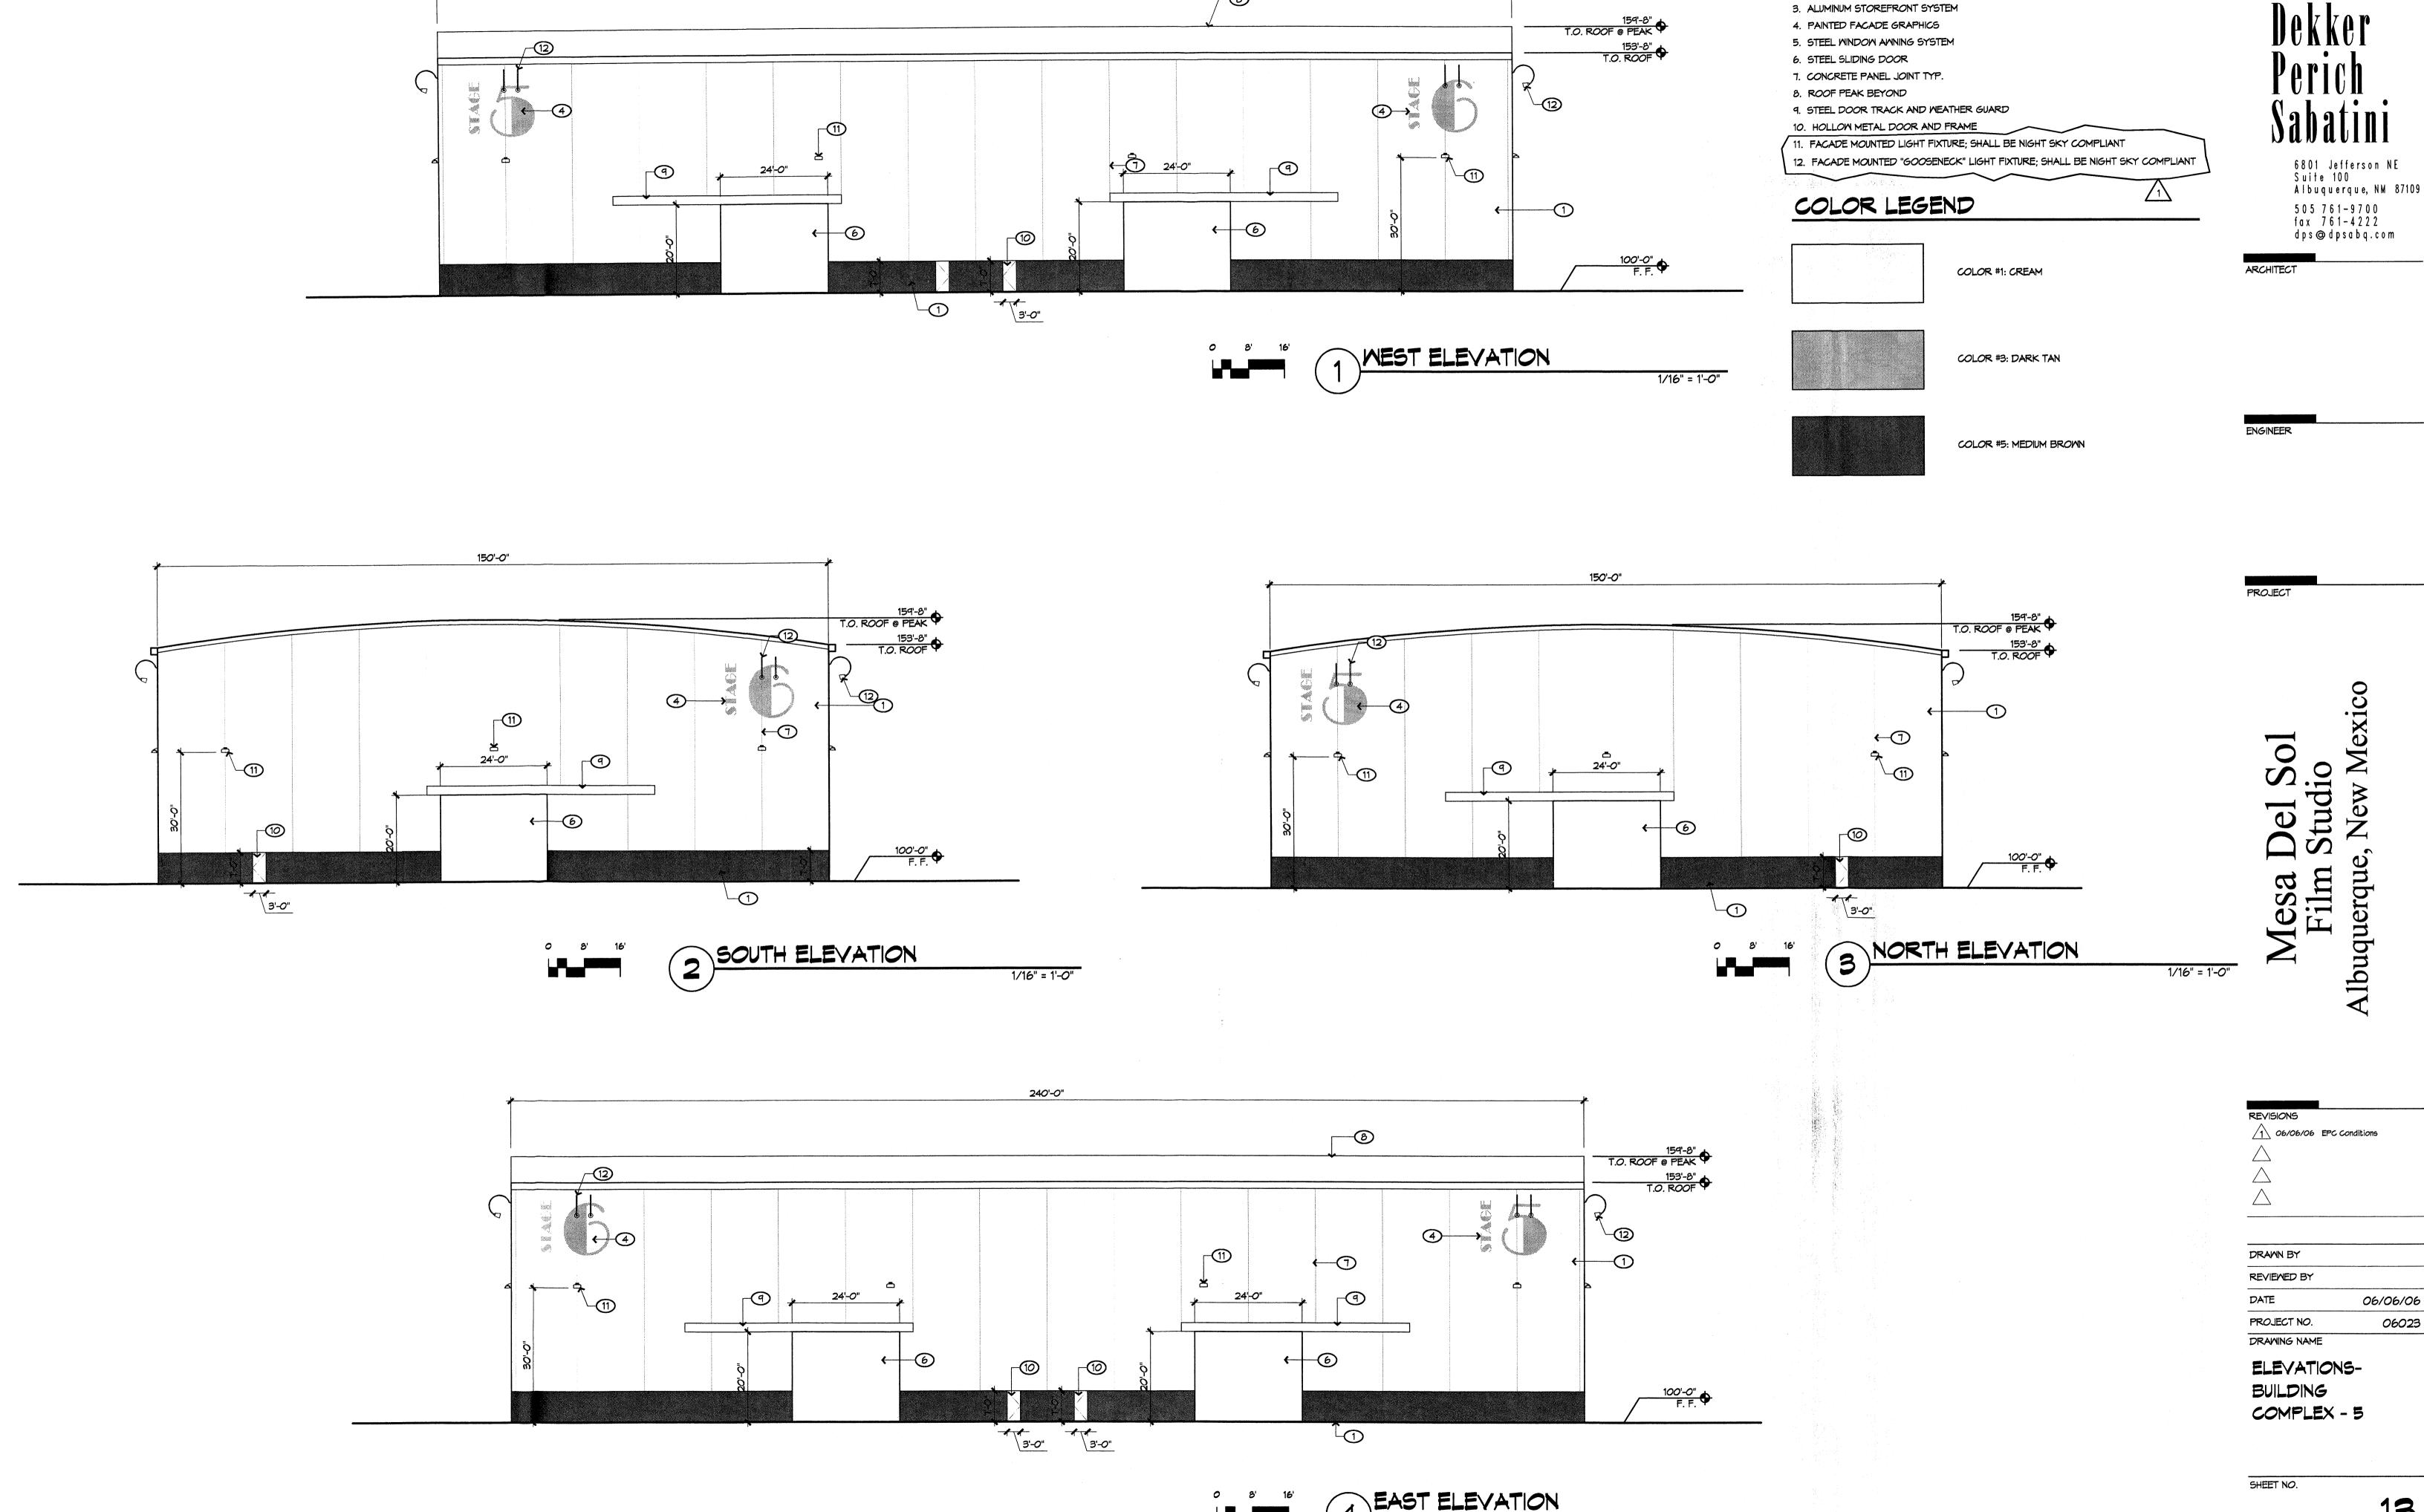

240'-0"


architecture interiors planning


KEYED NOTES O


1. CONCRETE TILT-UP PANEL SYSTEM 2. STEEL STAIRS EXPOSED TO OUTSIDE

1/16" = 1'-0"

6801 Jefferson NE Suite 100 Albuquerque, NM 87109 505 761-9700 fax 761-4222 dps @dpsabq.com

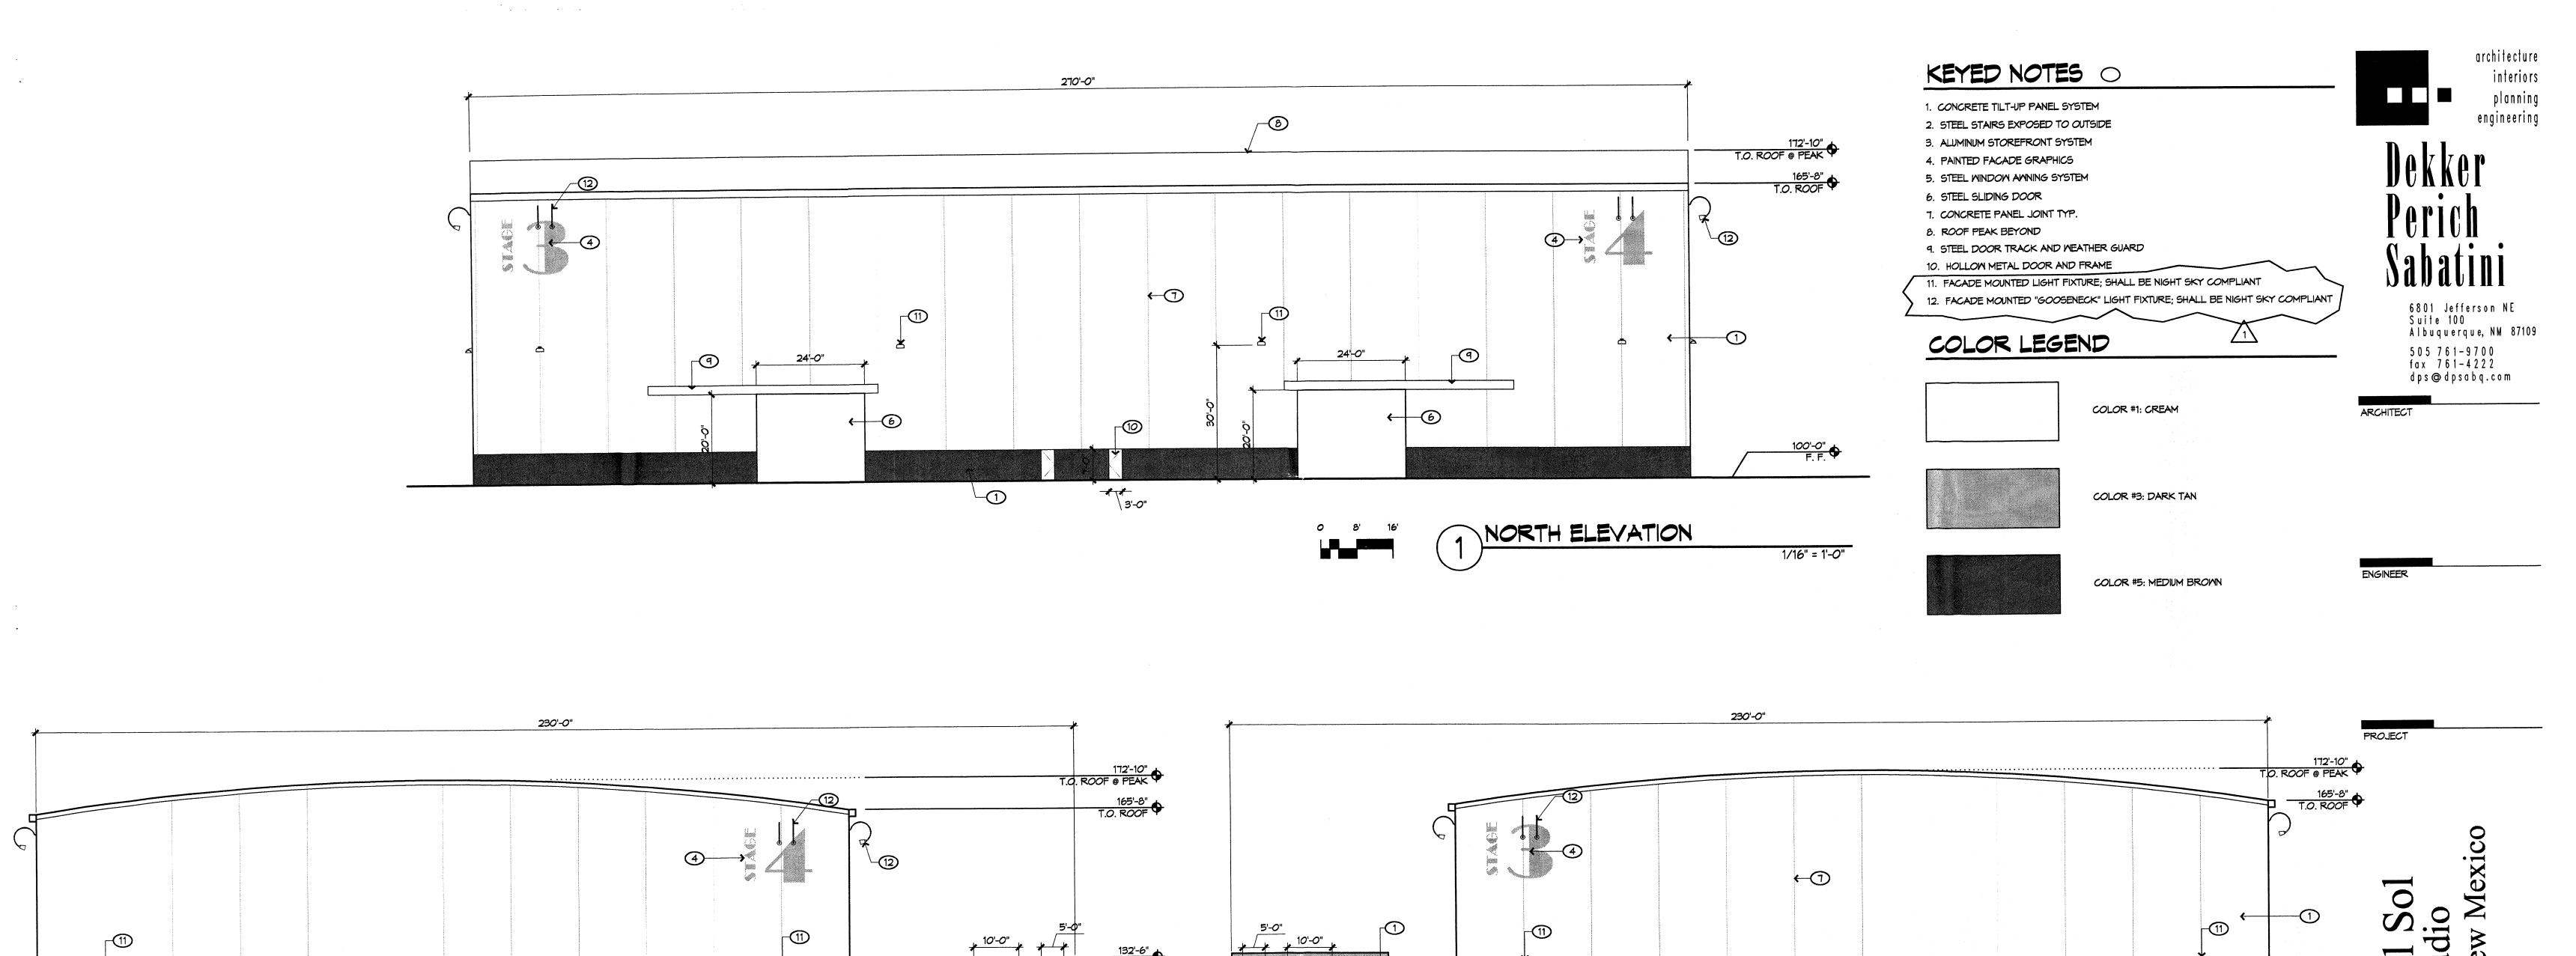

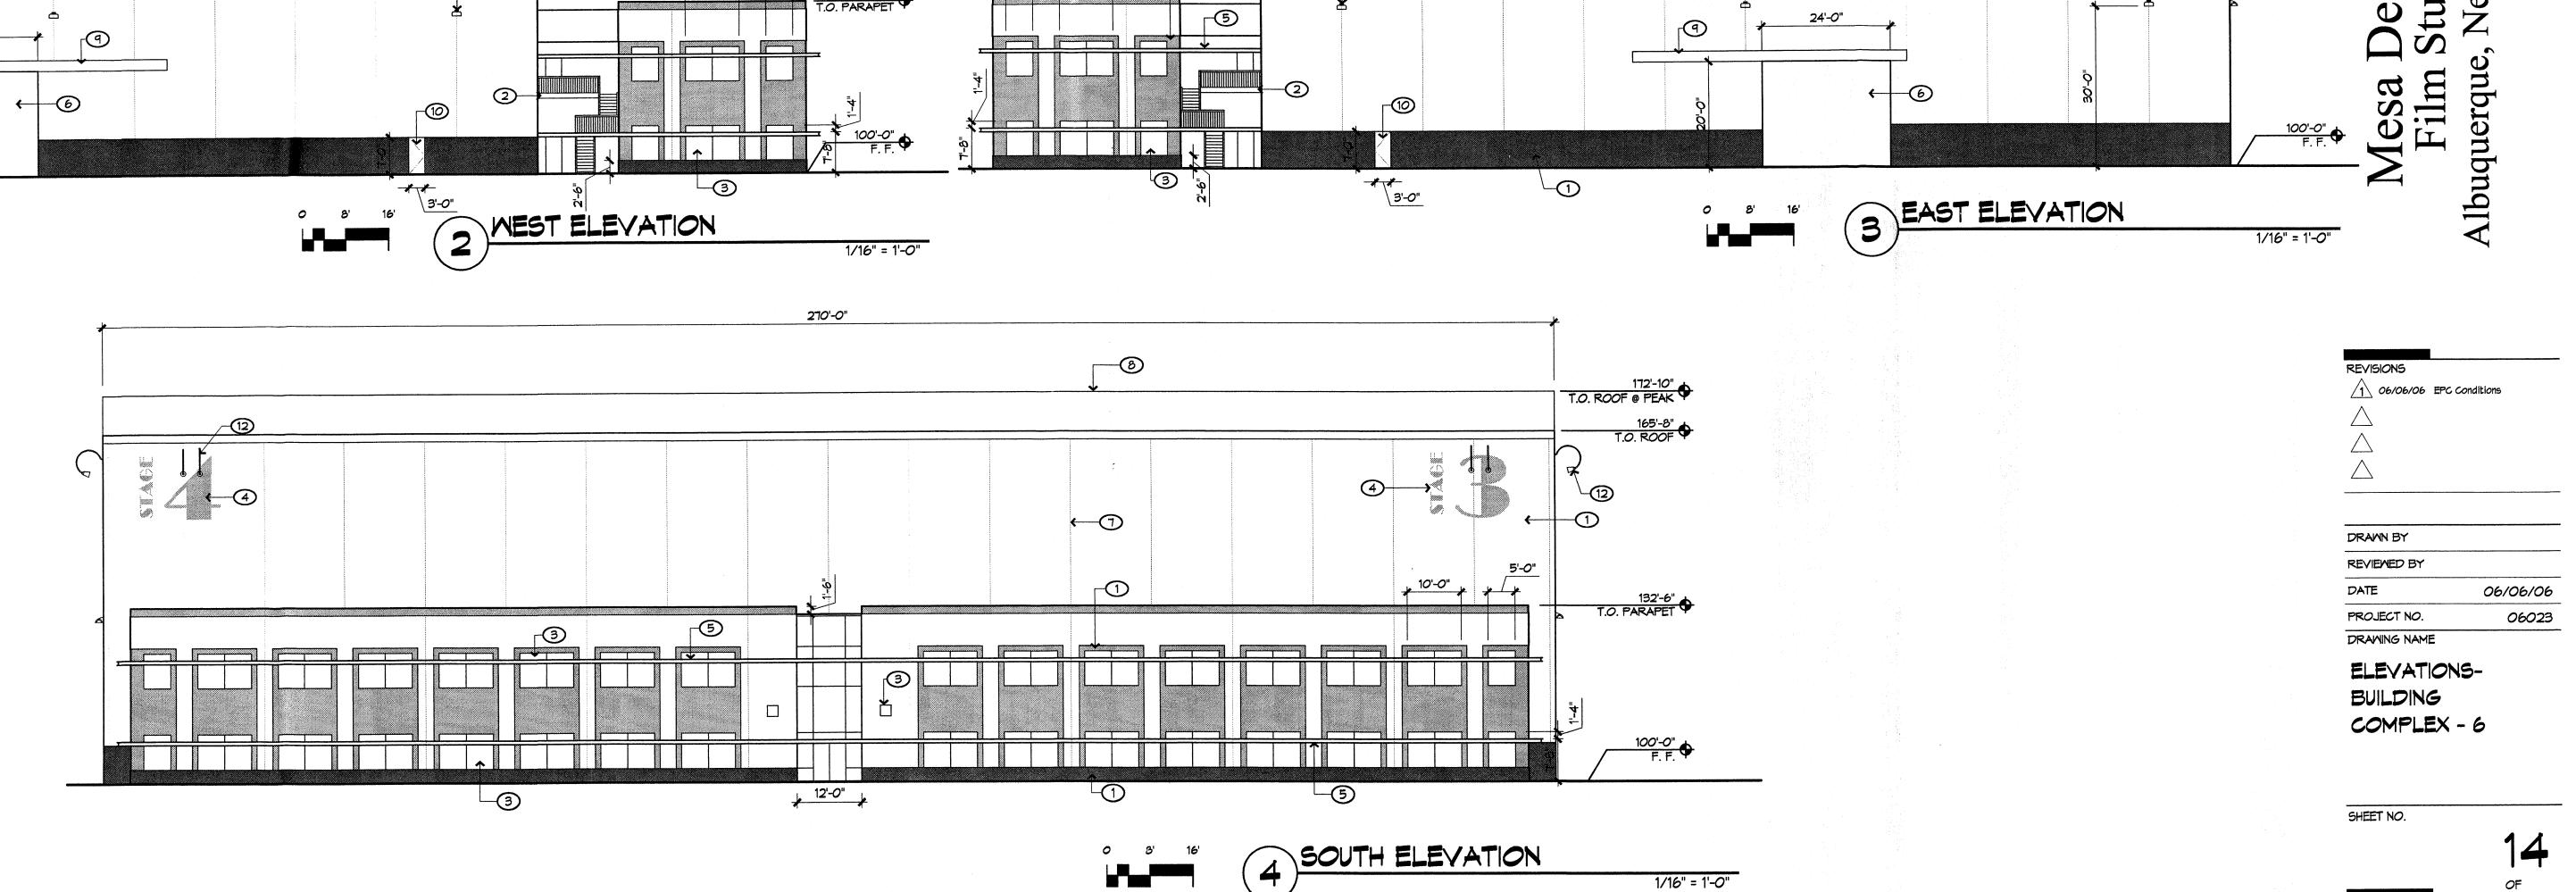

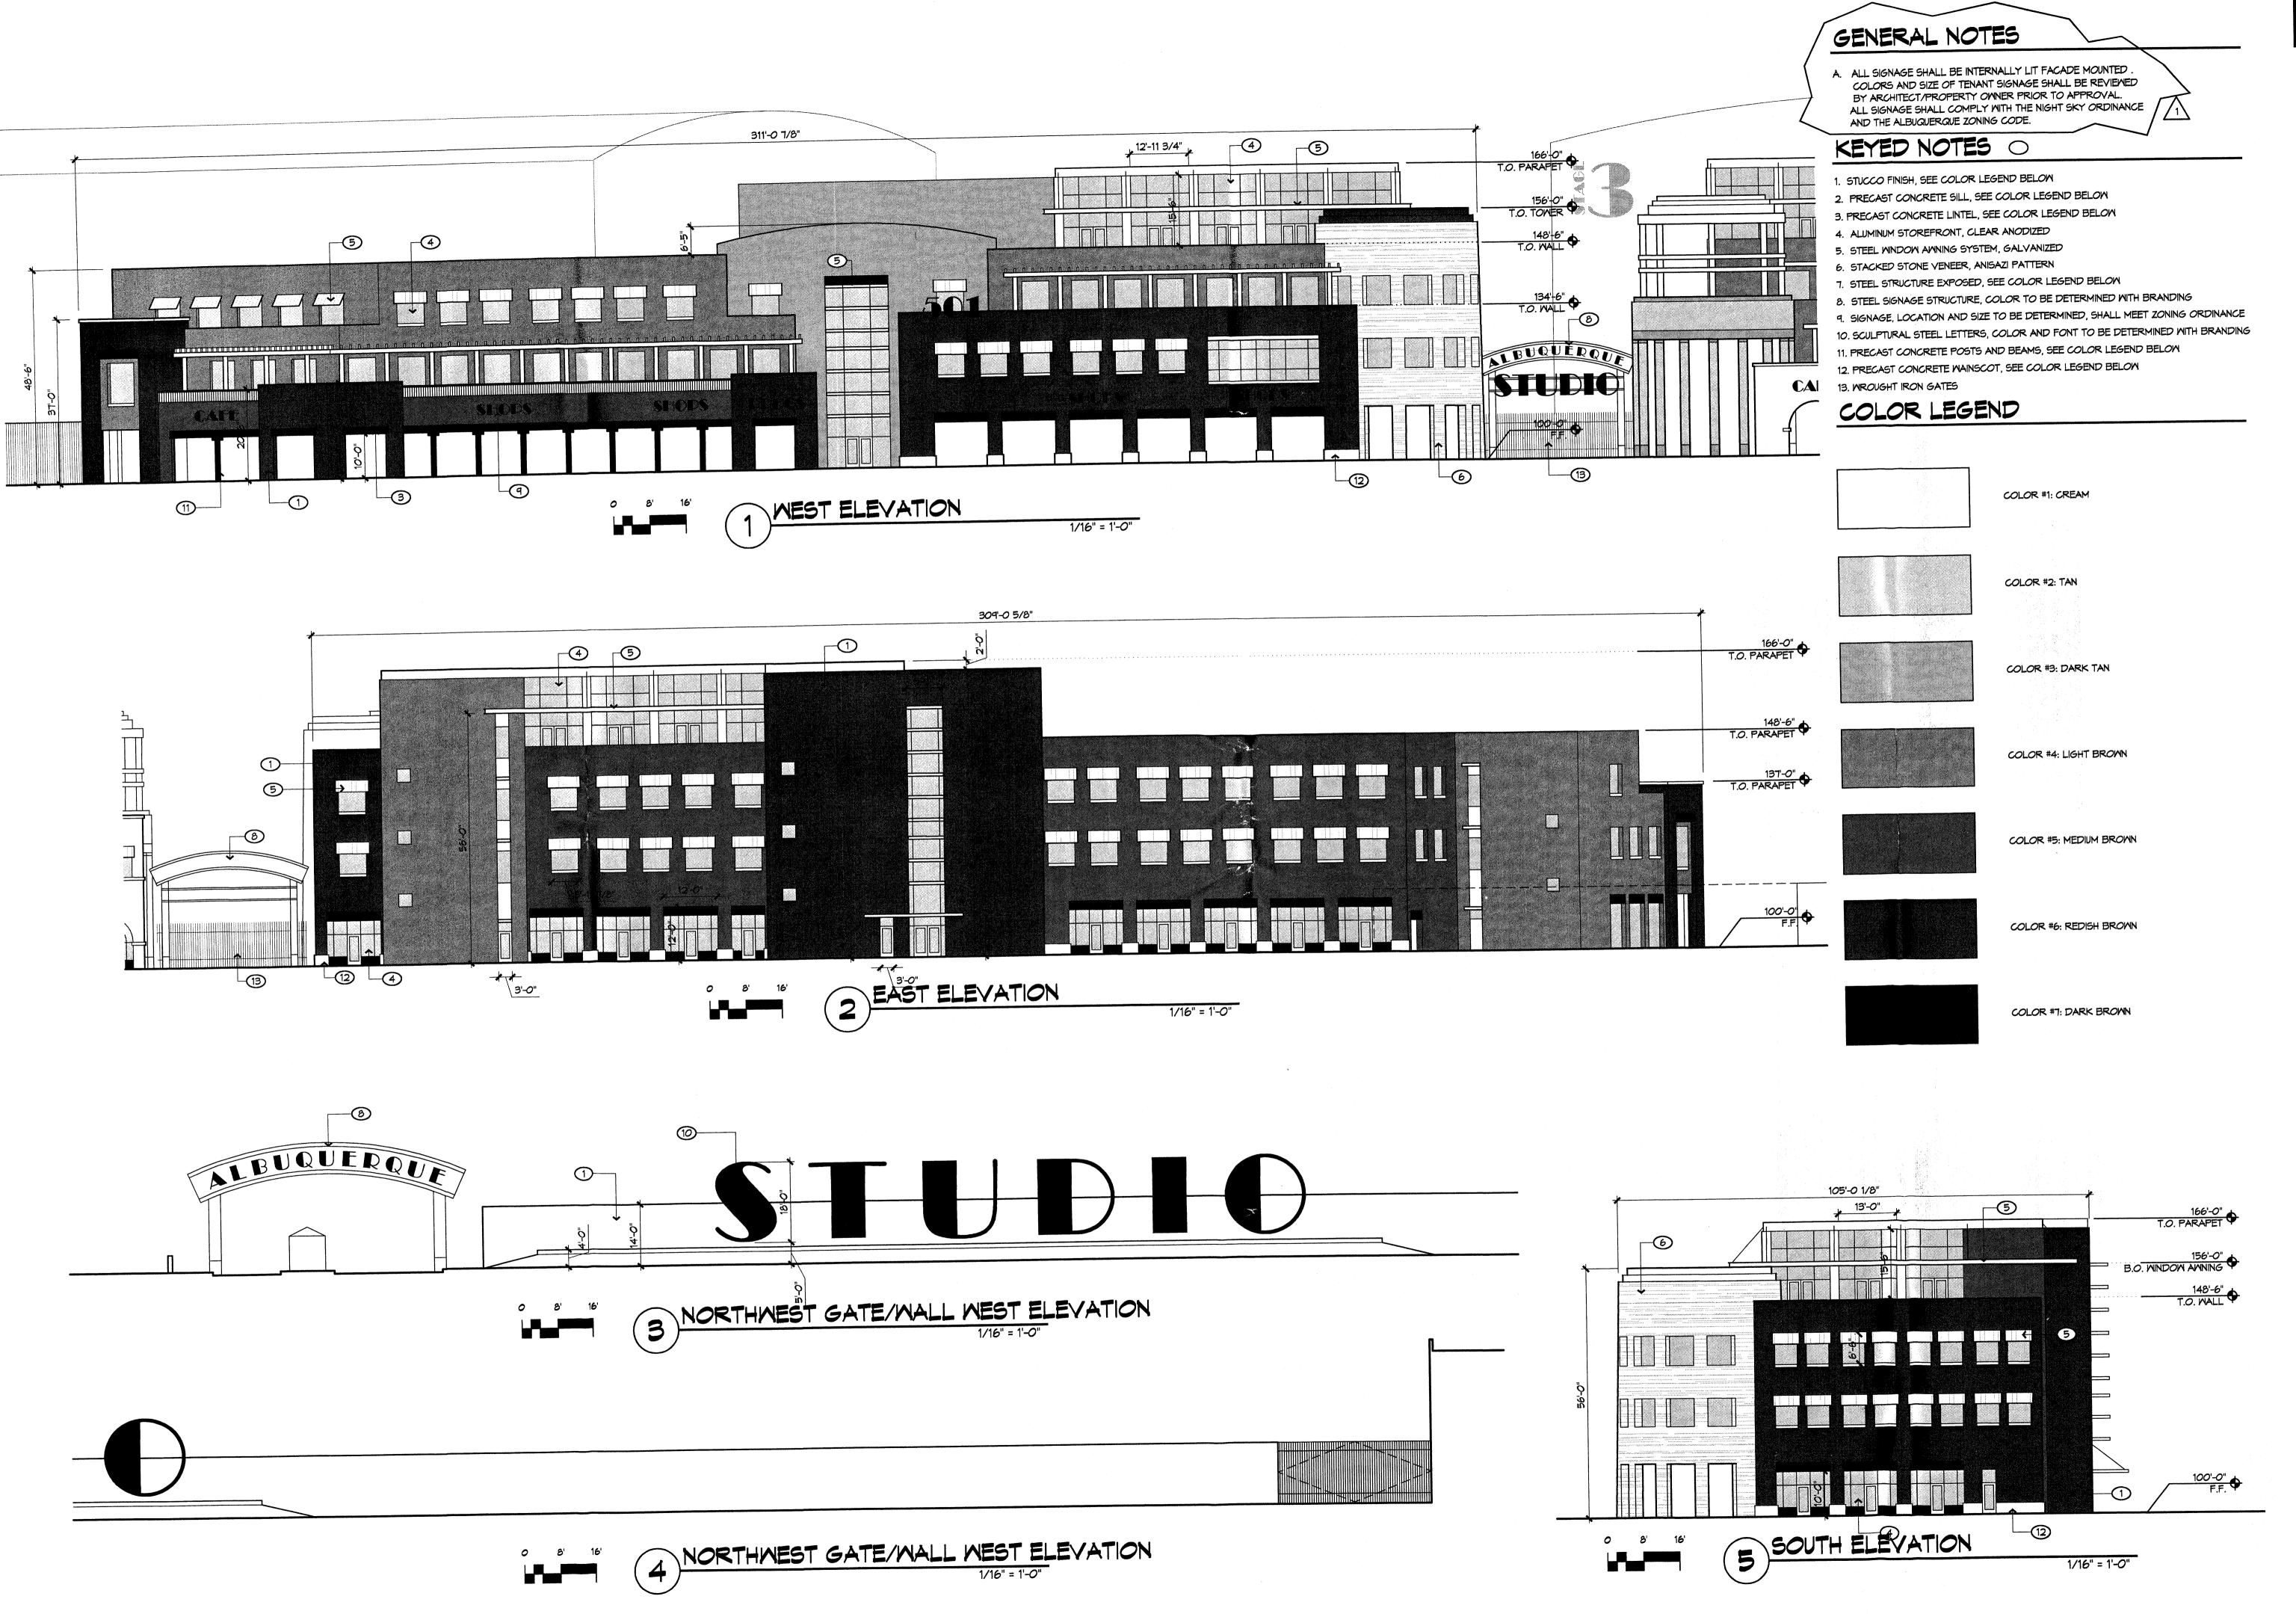

-

interiors
planning
engineering

Dekker Perich Sabatini

6801 Jefferson NE Suite 100 Albuquerque, NM 87109 505 761-9700 fax 761-4222 dps@dpsabq.com

PCUITECT

Mesa Del Sol Film Studio Albuquerque, New Mexico

REVISIONS

1 06/06/06 EPC Conditions

1 OFFICE OFFI

REVIEWED BY

DATE 06/06/06

PROJECT NO. 06023

DRAWING NAME

ELEVATIONS-MIXED-USE BUILDING A

SHEET NO.

1**E**

