

October 20, 2008

Mr. Jack Cloud, Chair **Development Review Board** City of Albuquerque PO Box 1293 Albuquerque, NM 87103

HAND-DELIVERED

Re: Project # 1004872 / 06EPC-00621

City Engineer Project Nos. 7754.83 and 7754.84

Mesa del Sol Buildings #2 and #3

Request for withdrawal of SIA and Financial Guarantee 10 10 -08

Dear Mr. Cloud:

By this letter we request withdrawal of the Subdivision Improvement Agreement and the Financial Guarantees associated with Buildings Two and Three, located in Innovation Park at Mesa del Sol. The Site Plan for Building Permit was approved by the Planning Commission on June 16, 2006 for a site of approximately 11.9 acres located at the corner of Watson Loop and Fritts Crossing. The site plan proposed two 95,000 square foot warehouse/office buildings. The applicant for the project was Forest City Covington New Mexico. This office acted as agent for the original application.

Current economic conditions make the construction of these buildings improbable at this time. We request that the City void the financial guarantee and cancel the Letter of Credit associated with each of the City Engineer Project Numbers referenced above. The applicant understands that all approvals, including DRB site-plan sign-off, would be voided, and when the project does start again, the applicant would be required to return to the DRB with a new site plan submittal, infrastructure list, SIA, and financial guarantee, and have the same re-approved.

Please let us know if you have any questions or need additional information.

Lawrence Kline FAICF cc: Harry Relkin

Sincerely.

James Topmiller PE John Myers Esq.



September 26, 2006

Mr. Russell Brito
Division Manager
City of Albuquerque Planning Department
Plaza del Sol
600 2<sup>nd</sup> St. NW
Albuquerque, NM 87103

### HAND DELIVERED

Re: Request for Administrative Amendment: Project # 1004872, 06EPC-00621 EPC Site Development Plan – Building Permit Mesa del Sol Employment Center Buildings # 2 & 3

Dear Mr. Brito,

This is a request for administrative amendment of the Site Development Plan for Building Permit for two 95,000 +/- square foot buildings on 12 acres in the Mesa del Sol Employment Center. Due to several factors since approval of the site plan by the EPC on June 15, 2006, Forest City Covington would like to amend the current site plan.

The major proposed change involves moving the location of the building two blocks to the east. The site plan and elevations are essentially the same as in the original submittal although the orientation of the two structures has flipped, with the main entrances now facing east rather than west. The site layout, relationship of the buildings to the street, the landscaping and parking are all virtually identical to the original layout.

There are two major factors behind the decision to shift the location of the buildings. The first is the result of negotiations with the City over access along University Boulevard. The City has advocated for a minimum of 400' between median breaks along University Boulevard. The original location of Buildings Two and Three was less than 400' from the intersection of Street "C" and University Boulevard. This would have limited access to the site and made truck circulation problematic. By moving the site two blocks east, this allows access from Street "D" and works with the general strategy of 400 foot median breaks that the City desires along University Boulevard. The second factor behind the decision to relocate two blocks to the east is the desire to concentrate large, predominately industrial buildings in the core of the Employment District and leave frontage along University Boulevard for more office-oriented buildings. Moving these buildings two blocks to the east will leave the highly visible parcel along University Boulevard for a more urban and pedestrian-oriented office building near the gateway to Mesa del Sol.

Any conditions in the Notice of Decision dated June 16, 2006 would apply to the new site. Conditions that referenced University Boulevard would apply equally to "Street X" along the east side of the new site. Revisions to the site plan resulting from the Notice of Decision are noted on the new set of plans slated for submittal to the DRB.

architecture

architecture

interiors

landscape

planning

engineering

This request for an administrative amendment complies with the standard of not making major alterations to the original floor plan or elevations. It is unusual in that the location of the approved site plan is moving but given the nature of the Mesa del Sol project and the fact that the land is still within the Employment Center, this seems to be a minor modification to the original submittal and does not warrant a new submittal to the EPC. The new site for these buildings is in keeping with the overall intent of the Employment Center to concentrate larger, primarily industrial users in the interior of the Employment Center and locate more office-oriented buildings along the primary streets and entrances to the District. These buildings will further the creation of a desirable, state of the art Employment Center that will serve as a gateway to Mesa del Sol. Thank you for consideration of this amendment and we look forward to your decision.

Very truly yours,

Dekker/Perich/Sabatini-Ltd.

Will Gleason, AICP

Planner

FILENAME \p S:\06002 Mesa SPEC\General\Correspondence\L-name yyyy-mm-dd.doc

Attachments: Revised site plan Present and proposed site exhibit

architecture

interiors

landscape

planning

engineering

# Mesa Del Sol

Employment Center - Phase One BUILDING 2 and BUILDING 3 Albuquerque, New Mexico

# EPC SUBMITTAL: Site Plan for Building Permit Revised

10-10-06 to DRB

# DRAWING INDEX

SHEET 1 OF 8 COVER SITE PLAN SHEET 2 OF 8 LANDSCAPE PLAN SHEET 3 OF 8 PRELIMINARY GRADING PLAN SHEET 4 OF 8 BUILDING 2 ELEVATIONS SHEET 5 OF 8 BUILDING 3 ELEVATIONS SHEET 6 OF 8 BUILDINGS 2 AND 3 ELEVATIONS SHEET 7 OF 8 CONCEPTUAL UTILITY PLAN SHEET 8 OF 8

PROJECT TEAM

# OWNER

FOREST CITY COVINGTON NM, LLC 801 UNIVERSITY BLVD SE ALBUQUERQUE, NM 87106 (505) 400-3021 FAX: (505) 242-2978

# ARCHITECT/PLANNER

DEKKER/PERICH/SABATINI, LTD.
6801 JEFFERSON ST., N.E. SUITE 100
ALBUQUERQUE, NM 87109
(505) 761-9700
FAX: (505) 761-4222

# LANDSCAPE ARCHITECT


DEKKER/PERICH/SABATINI, LTD.
6801 JEFFERSON ST., N.E. SUITE 100
ALBUQUERQUE, NM 87109
(505) 761-9700
FAX: (505) 761-4222

## AGENT

DENISH + KLINE ASSOCIATES 500 MARQUETTE NW STE 350 ALBUQUERQUE, NM 87103 (505) 842-6461 FAX: (505) 842-6471

# CIVIL ENGINEER

BOHANNAN HUSTON, INC. 7500 JEFFERSON ST., NE ALBUQUERQUE, NM 87109-4335 505-623-1000 FAX: 505-798-7988

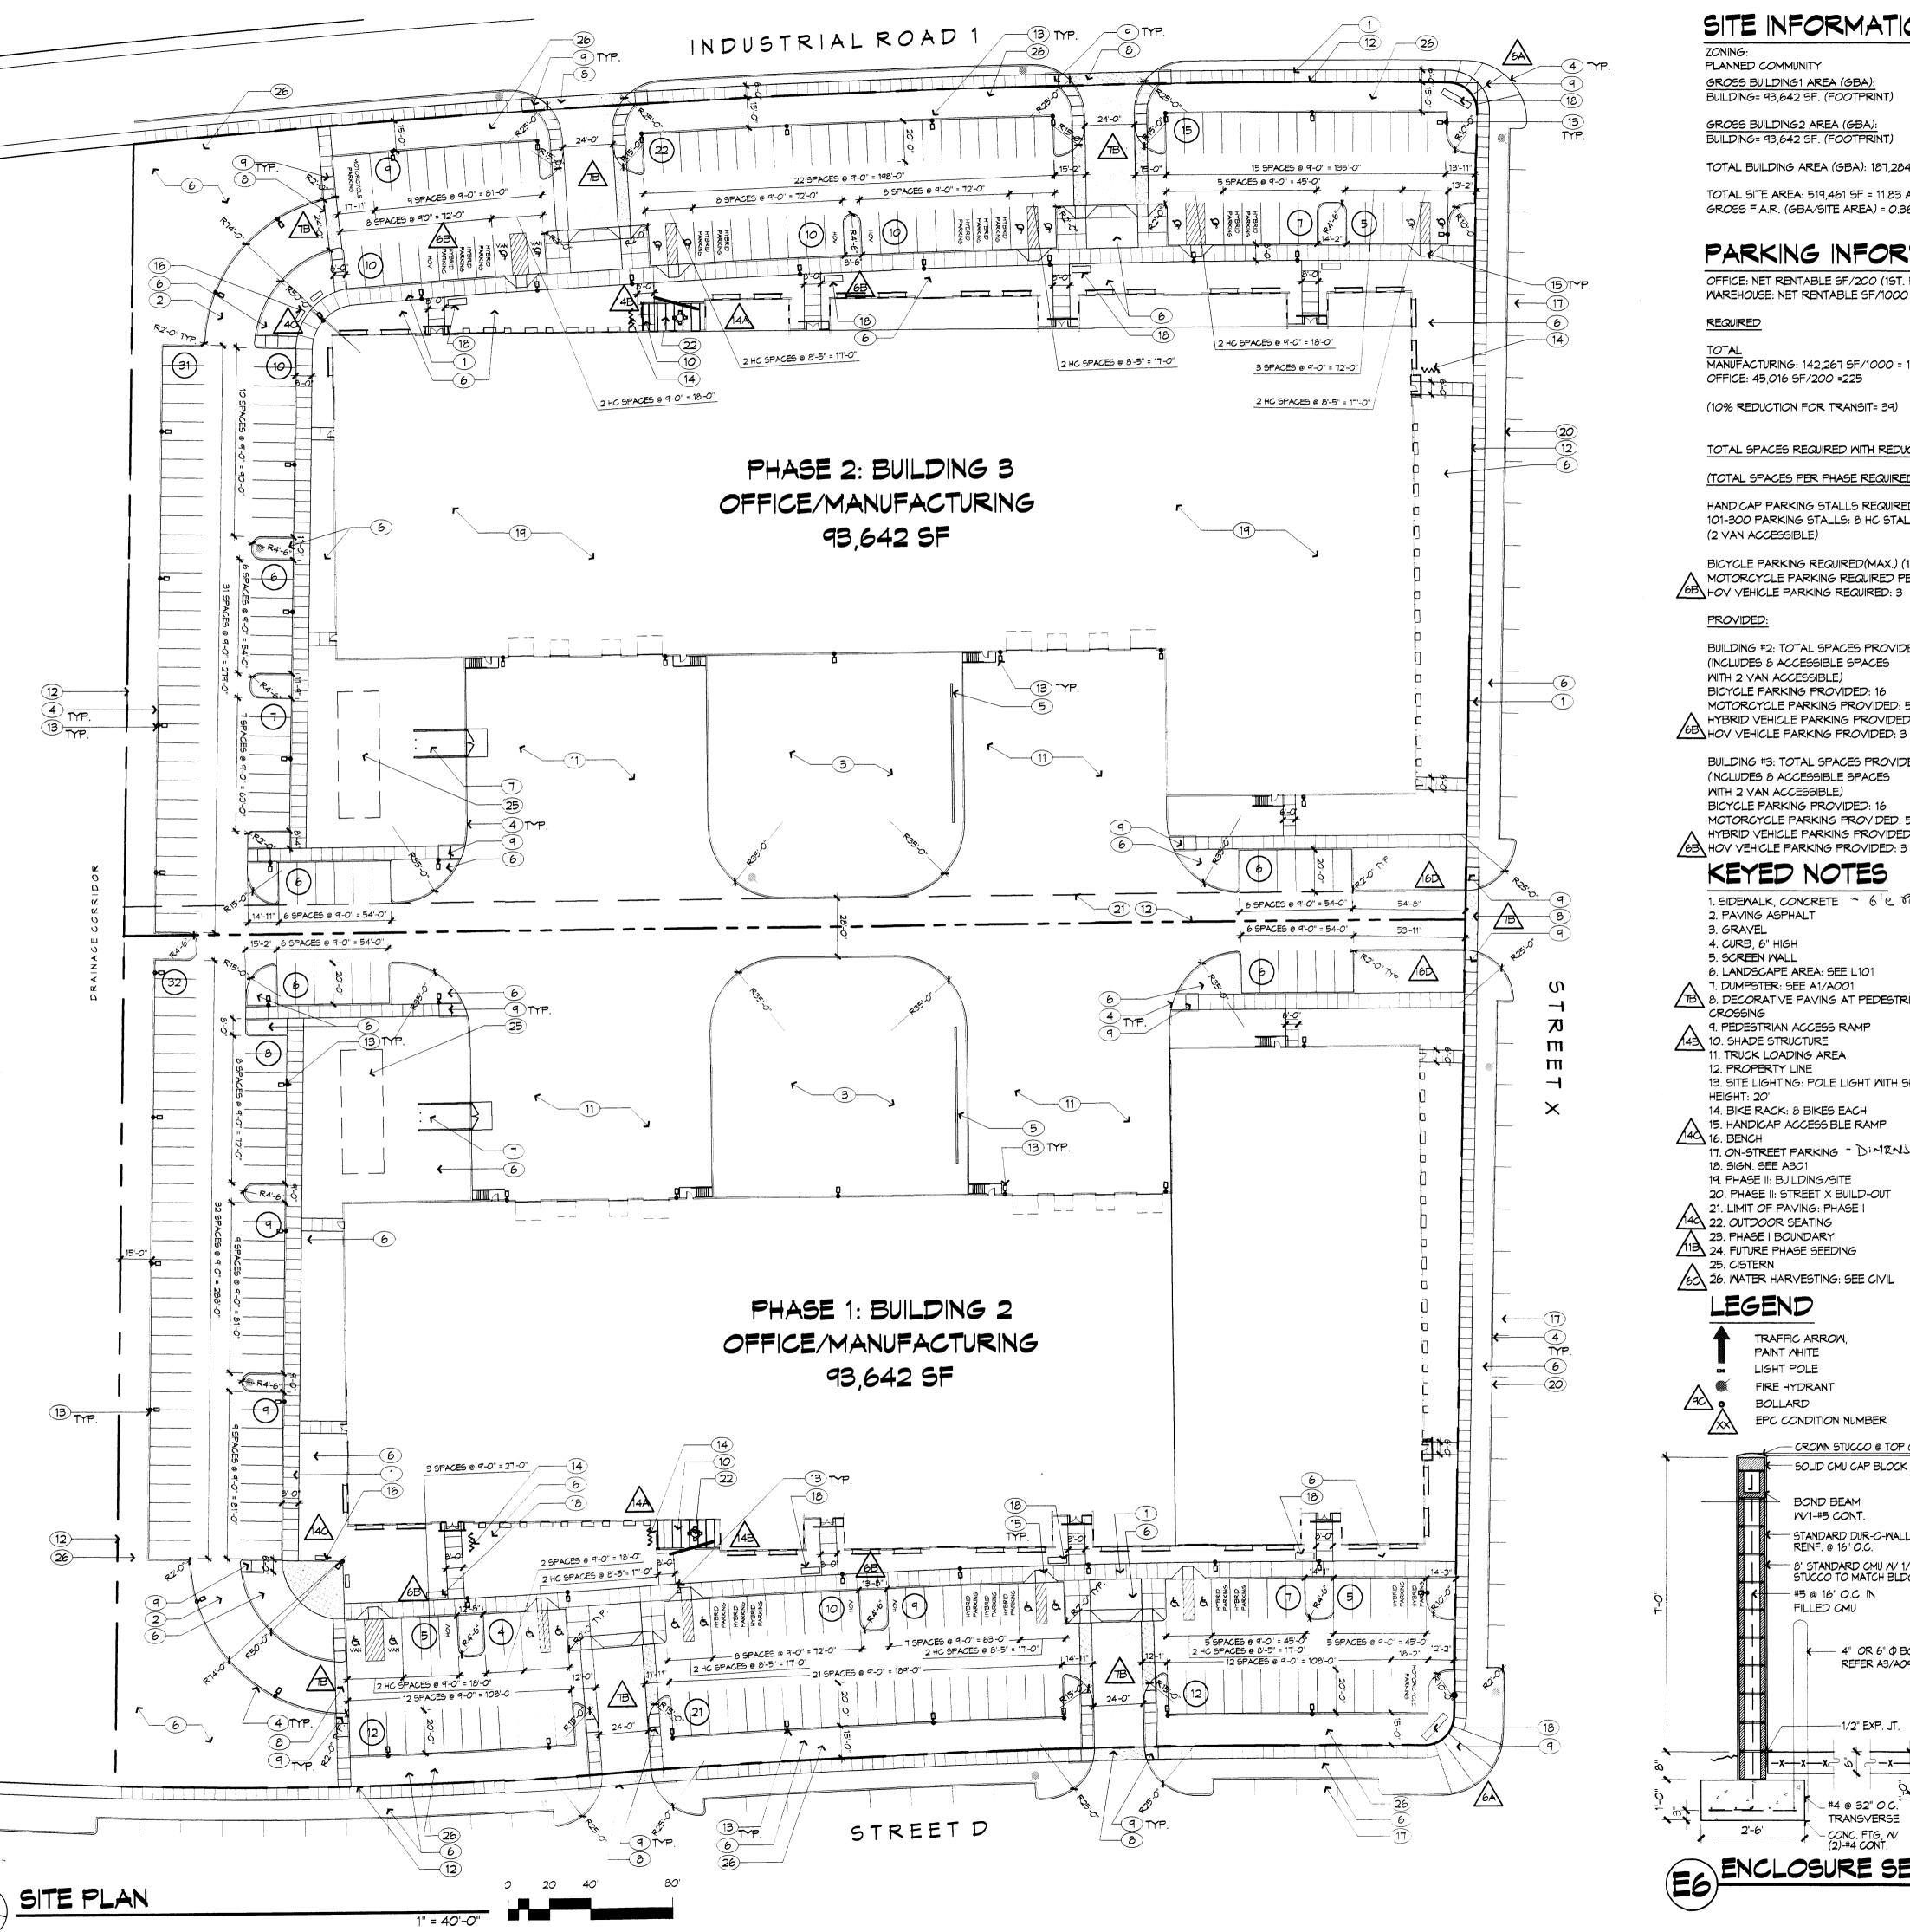

# SITE INFORMATION

PLANNED COMMUNITY GROSS BUILDING1 AREA (GBA):

BUILDING= 93,642 SF. (FOOTPRINT)

## GROSS BUILDING2 AREA (GBA): BUILDING= 93,642 SF. (FOOTPRINT)

TOTAL BUILDING AREA (GBA): 187,284 SF

TOTAL SITE AREA: 519,461 SF = 11.83 ACRES GROSS F.A.R. (GBA/SITE AREA) = 0.36

# PARKING INFORMATION

OFFICE: NET RENTABLE SF/200 (1ST. FL) AND 300 (2ND. FL) WAREHOUSE: NET RENTABLE SF/1000

## REQUIRED

TOTAL MANUFACTURING: 142,267 SF/1000 = 142 OFFICE: 45,016 SF/200 =225

(10% REDUCTION FOR TRANSIT= 39)

TOTAL SPACES REQUIRED WITH REDUCTIONS (BOTH PHASES): 328

## (TOTAL SPACES PER PHASE REQUIRED: 164)

HANDICAP PARKING STALLS REQUIRED: 101-300 PARKING STALLS: 8 HC STALLS REQUIRED (2 VAN ACCESSIBLE)

BICYCLE PARKING REQUIRED (MAX.) (1:20 AUTOS): 10 MOTORCYCLE PARKING REQUIRED PER EPC CONDITIONS: 3 68 HOY VEHICLE PARKING REQUIRED: 3

## PROVIDED:

BUILDING #2: TOTAL SPACES PROVIDED: 165 (INCLUDES 8 ACCESSIBLE SPACES MITH 2 VAN ACCESSIBLE) BICYCLE PARKING PROVIDED: 16 MOTORCYCLE PARKING PROVIDED: 5

HYBRID VEHICLE PARKING PROVIDED: 9 6B HOV VEHICLE PARKING PROVIDED: 3

BUILDING #3: TOTAL SPACES PROVIDED: 164 (INCLUDES 8 ACCESSIBLE SPACES

WITH 2 VAN ACCESSIBLE) BICYCLE PARKING PROVIDED: 16 MOTORCYCLE PARKING PROVIDED: 5 HYBRID VEHICLE PARKING PROVIDED: 9

1. SIDEMALK, CONCRETE - 6 C PUBLIC ROW 2. PAVING ASPHALT 3. GRAVEL

5. SCREEN WALL 6. LANDSCAPE AREA: SEE L101

7. DUMPSTER: SEE A1/A001 7. DUMPSTER: SEE ALVACO.

8. DECORATIVE PAVING AT PEDESTRIAN CROSSING 9. PEDESTRIAN ACCESS RAMP

1. TRUCK LOADING AREA 12. PROPERTY LINE 13. SITE LIGHTING: POLE LIGHT WITH SHIELD, HEIGHT: 20'

14. BIKE RACK: 8 BIKES EACH 15. HANDICAP ACCESSIBLE RAMP 16. BENCH

17. ON-STREET PARKING - DIMENSIGALS PER DPM 18. SIGN. SEE A301


19. PHASE II: BUILDING/SITE 20. PHASE II: STREET X BUILD-OUT 21. LIMIT OF PAVING: PHASE I 22. OUTDOOR SEATING

A 25. CISTERN 60 26. WATER HARVESTING: SEE CIVIL

# LEGEND

TRAFFIC ARROW, PAINT WHITE LIGHT POLE

FIRE HYDRANT BOLLARD EPC CONDITION NUMBER

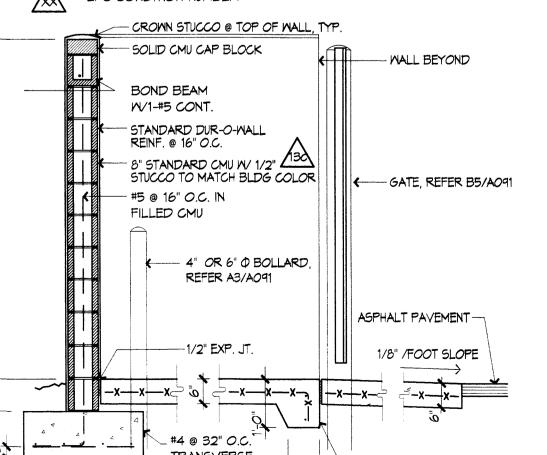

TRANSVERSE 2'-6"

ENCLOSURE SECTION

# GENERAL NOTES

A. PARKING AREA SHALL BE DESIGNED & BUILT TO CURRENT DPM STANDARDS.

B. PERMISSION TO USE 40 SCALE FOR THIS SITE PLAN HAS BEEN APPROVED BY STAFF.

C. THERE ARE NO EXISTING STRUCTURES MITHIN 20 FEET OF THE SITE.

D. CROSS LOT ACCESS WILL BE GRANTED WITH REQUIRED REPLAT.

E. SIGNAGE SHALL COMPLY WITH THE REQUIREMENTS OF THE CITY OF ALBUQUERQUE'S IP INDUSTRIAL PARK ZONE.

10\ TENANT SIGN B: F. TRACT REFERENCES ARE TO THE TRACTS CORNER. AS CONFIGURED AND ALIGNED IN THE SITE SIZE: BASE - 3' WIDE X 15' LONG. DEVELOPMENT PLAN. TRACT LINES ARE TO HEIGHT: 15' MAX.

G. STREET X TO HAVE TWO TRAVEL LANES ON EACH SIDE AT ULTIMATE BUILDOUT.

BE ADJUSTED/FIXED WITH REQUIRED REPLAT.

H. SEE CONCEPTUAL CIVIL PLANS FOR ADDITIONAL GRADING, DRAINAGE, AND

UTILITY INFORMATION. I. CISTERN WATER TO BE USED TO

SUPPLEMENT WATER FOR IRRIGATION.

J. A FUTURE TRANSIT STOP MAY BE LOCATED ON THE EAST SIDE OF UNIVERSITY BOULEVARD, JUST NORTH OF STREET D. THERE ARE NO FUTURE TRANSIT STOPS PLANNED DIRECTLY ADJACENT TO THE PROPERTY.

K. ALL GRAVEL AREA TO BE USED AS STORAGE AREAS SHALL BE SCREENED WITH A WALL OR FENCE AT FULL BUILD-OUT.

L. THERE ARE NO PEDESTRIAN TRAILS CURRENTLY LOCATED IN THE VICINITY. A FUTURE TRAIL MAY BE LOCATED ON THE WEST SIDE OF UNIVERSITY BOULEVARD, OUTSIDE OF THE RIGHT-OF-WAY.

PROJECT NUMBER:

**APPLICATION NUMBER:** 

DRB SITE DEVELOPMENT PLAN APPROVAL:

PARKS AND RECREATION DEPARTMENT

Michael Holton Campasters

DRB CHAIRPERSON, PLANNING DEPARTMENT

Bradley 2. Dopan

JOLID WASTE MANAGEMENT

JOURNAL-PAVILION ENTRANCE

TRAFFIC ENGINEER, TRANSPORTATION DIVISION

alfel Se

UTILITIES DIVISION

CITY ENGINEER

M. SIGNS: SEE BUILDING ELEVATIONS FOR DESCRIPTION OF SIGNAGE ON BUILDING. TWO TYPES OF SITE SIGNS ARE LOCATED ON THE PROPERTY.

HEIGHT: 5' MAX.

LIGHTING: INTERNAL OR

LIGHTING: INTERNAL OR

BACKLIT/SILHOUETTE

OTHERWISE NOTED.

MATERIALS: PER EPC SUBMITTAL

MATERIALS: PER EPC SUBMITTAL

/11B O. ANY LAND THAT IS NOT IMMEDIATLY


COVERED BY A BUILDING, PAVING,

PROVIDE REQUIRED BICYCLE STORAGE

WALL, OR EDGE OF PAVEMENT UNLESS

BACKLIT/SILHOUETTE

10 TENANT SIGN A: LOCATED AT THE NORTH SIDE OF BUILDING 2 AND SOUTH SIDE BUILDING 3.

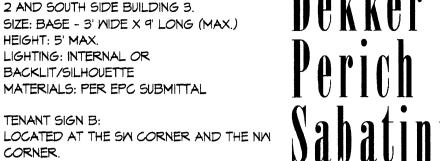

7601 Jefferson NE Suite 100

architecture

interiors

planning

landscape

engineering

Albuquerque, NM 87109 505 761-9700 fax 761-4222 N. DIMENSIONS ARE TO FACE OF CURB, OR

dps@dpsdesign.org

ARCHITECT

LANDSCAPE OR MULCH WILL BE SEEDED. P. BICYCLE AMENITIES: TENANT WILL

WITHIN THE BUILDING. Q. ALL CURBS WILL BE DESIGNED AND BUILT ACCORDING TO THE CITY OF ALBUQUERQUE STANDARDS. CURBS WILL ALSO BE DESIGNED TO ALLOW WATER HARVESTING IN LANDSCAPE MEDIANS

RUN-OFF AND SUPPLEMENT IRRIGATION. 4A R. ALL LIGHTING SHALL COMPLY TO LIGHTING STANDARD 3 AND LIGHTING STANDARD 5 OF THE MESA DEL SOL

EMPLOYMENT CENTER MASTER

DEVLOPMENT PLAN.

EPC Site Development Plan-Building Permit

1004872

Is an Infrastructure List Required? (x) Yes () No If yes, then a set of approved DRC plans with a

work order is required for any construction within Public Right-of-Way or for construction of public

WHEREVER POSSIBLE TO REDUCE SURFACE

10-75-06

0 25/04

3/20/07

3/20/07

3/20/07

DATE

DATE

DATE

DAŢE

0 enter a

Emplor REVISIONS 10/10/06 DRB SUBMITTAL

DRAWN BY REVIEWED BY MB DATE 10.10.06 PROJECT NO.

06002

DRAWING NAME


SITE PLAN FOR BUILDING PERMIT

SHEET NO.

1" = 1000'-0"

VICINITY MAP Q-16 AND Q-17

1/2" = 1'-0"

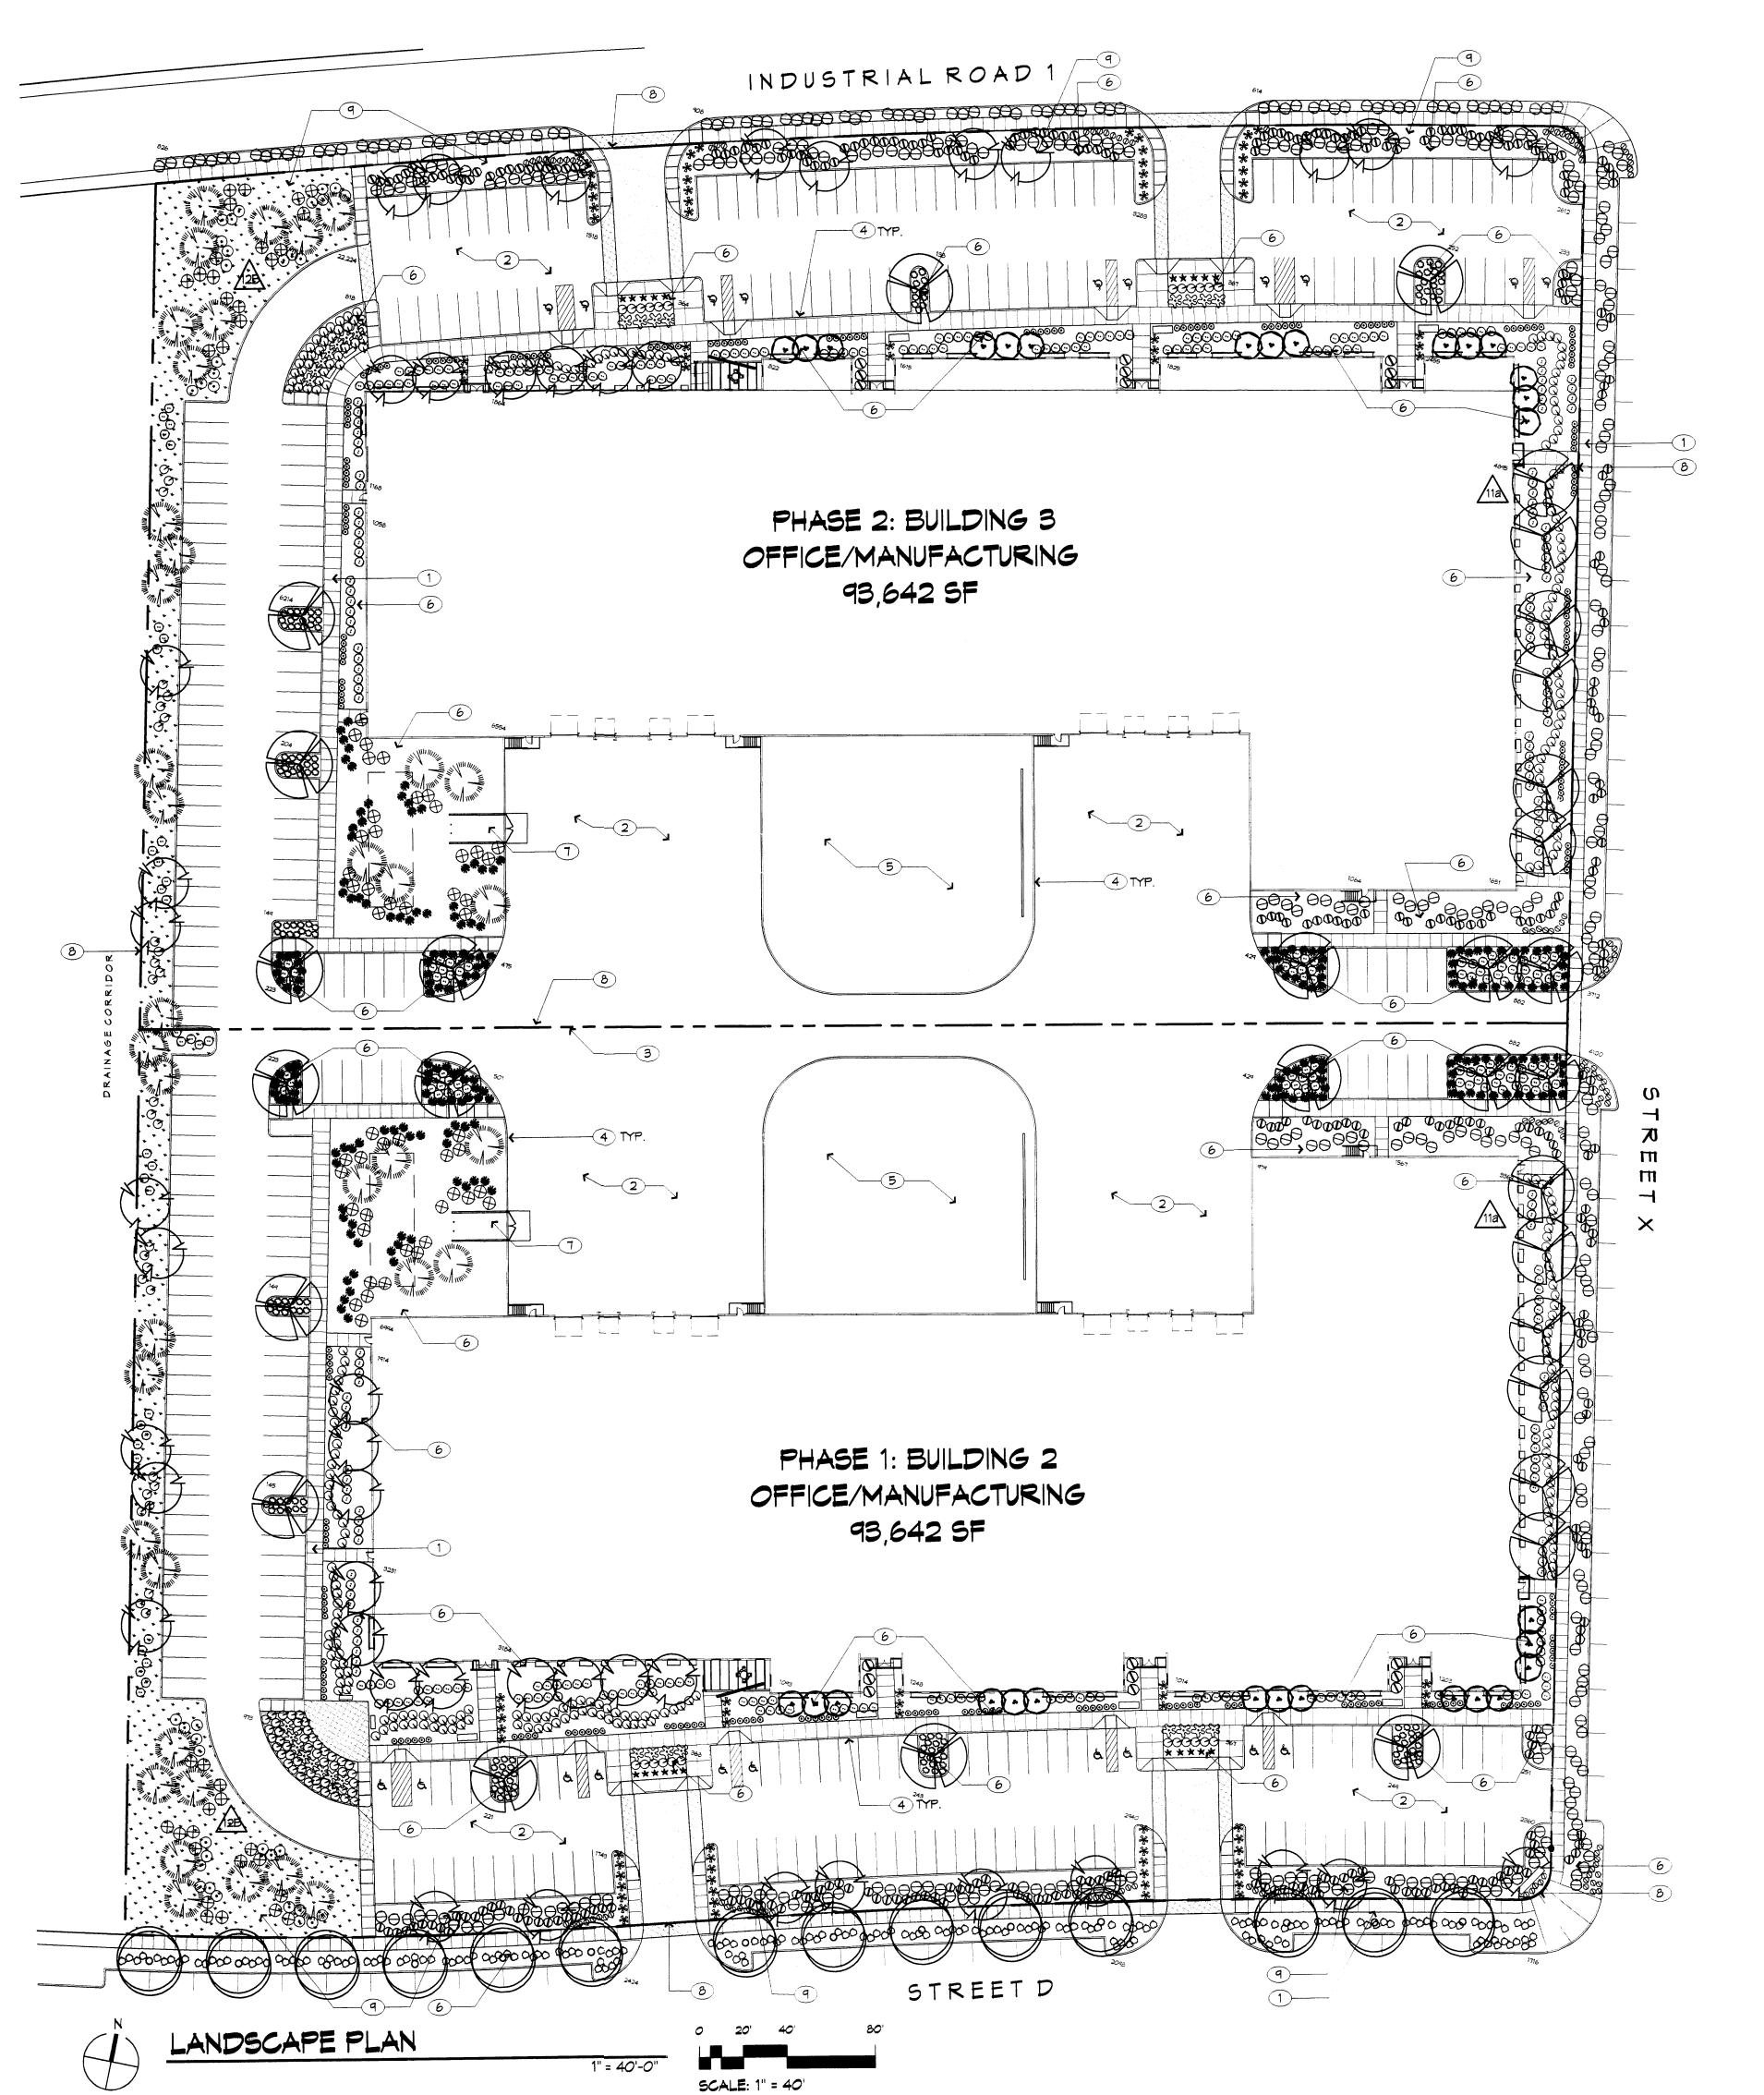

# LANDSCAPE CALCULATIONS

SITE AREA: 515,623 SF BUILDING FOOTPRINT 1: 93,642 SF BUILDING FOOTPRINT 2: 93,642 SF TOTAL BUILDING: 187,284 SF NET SITE AREA: 328,339 SF

REQUIRED LANDSCAPE AREA: 49,250 SF (15% OF NET LOT AREA) PROVIDED LANDSCAPE AREA: 97,034 SF

- 1. SIDEMALK, CONCRETE 2. PAVING ASPHALT
- 3. PHASE I: BOUNDARY 4. CURB, 6" HIGH 5. GRAVEL
- 6. LANDSCAPE AREA 7. DUMPSTER: SEE A1/A001
- 8. PROPERTY LINE 9. WATER HARVESTING: SEE CIVIL

# PLANTING NOTES

1. LANDSCAPE DESCRIPTION THE LANDSCAPE DESIGN UTILIZES HIGHLY VISIBLE AREAS OF NATIVE GRASSES TO REINFORCE THE SPECIAL LOCATION OF THE PROJECT - ON A HIGH DESERT GRASSLAND MESA. NATIVE SHRUBS, TREES AND ACCENTS ADD SEASONAL COLOR AND SCALE TO THE PROJECT, AND ESTABLISH WILDLIFE HABITAT.

2. EXISTING PLANT MATERIAL THERE IS NO LARGE SIZE VEGETATION ON THE SITE. THE EXISTING VEGETATION IS COMPRISED OF GRASSES AND FORBS AND SOME SHRUBS AT LOW DENSITIES.

3. INSTALLATION AND MAINTENANCE OF LANDSCAPING AND IRRIGATION SHALL BE THE RESPONSIBILITY OF THE PROPERTY OWNER.

4. THE LANDSCAPE DESIGN SHALL COMPLY WITH THE INTENT OF THE CITY OF ALBUQUERQUE WATER CONSERVATION LANDSCAPING AND WATER WASTE ORDINANCE.

5. THE USE OF HIGH WATER USE PLANT MATERIALS SHALL BE LIMITED. THERE IS NO HIGH WATER USE TURF USED ON THIS PROJECT.

MATERIAL VARY BY SPECIES. SEE PLANT

OF CRUSHER FINE GRAVEL MULCH. 8. IRRIGATION:

9. PASSIVE WATER HARVESTING: PASSIVE WATER HARVESTING, SUCH AS HARVESTING OF STORMWATER SURFACE RUNOFF AND ROOF RUNOFF, SHALL BE

UTILIZED WHERE FEASIBLE. 10. WATER USE DESCRIPTION: THE IRRIGATION SYSTEM DESIGN SHALL ACCOMMODATE NON-POTABLE WATER. CISTERNS WILL BE USED TO COLLECT ROOF

RUNOFF FOR IRRIGATION USE. PLANT

11. PONDING AREA IS LOCATED OFFSITE. SEE CONCEPTUAL GRADING AND DRAINAGE PLAN.

MATERIALS HAVE BEEN CHOSEN FOR THEIR XERIC QUALITIES IN ADDITION TO THEIR AESTHETIC AND HABITAT VALUES.

6. MINIMUM INSTALLATION SIZES FOR PLANT

7. LANDSCAPE AREAS (EXCEPT FOR SEEDING AREAS) SHALL BE COVERED WITH 2" DEPTH

IRRIGATION SHALL BE PROVIDED TO ALL CONTAINER PLANTS AND POTENTIALLY TO SEEDED AREAS. THE IRRIGATION SYSTEM DESIGN SHALL BE FULLY AUTOMATED. 7601 Jefferson NE Suite 100

Albuquerque, NM 87109 505 761-9700 fax 761-4222

> dps@dpsdesign.org ARCHITECT

architecture

engineering

interiors landscape

1 10/10/06 DRB SUBMITTAL

DRAWN BY	SZ
REVIEWED BY	MB
DATE	10.10.06
PROJECT NO.	06002
DRAWING NAME	

FOR BUILDING PERMIT


SHEET NO.

PLANTING LEGEND

Trees							
SYMBOL	EST. QTY.	INSTALLED SIZE	COMMON NAME	Botanical name	Height	Midth	Mater requirement
	41	2"-Cal Multi-Trunk	Chitalpa	Chitalpa X taskentensis	25.00	30.00	Medium Water Use
<u>•</u>	30	24" Box Multi-trunk	New Mexico Olive	Forestiera neomexicana	15.00	12.00	Medium Mater Use
No. Comments	28	15-Gal	Oneseed Juniper	Juniperus monosperma	15.00	18.00	Low Mater Use
	34	15-Gal @ 5'x2'	Desert Millow	Chilopsis linearis	20.00	25.00	Low Water Use
$\odot$	14	15-Gal @ 7'x2'	Chinese Pistache	Pistacia chinensis	35.00	30.00	Low Water Use
Shrub					(1-1-1-1-1	IAI! JEI-	
SYMBOL	EST. QTY.	INSTALLED SIZE	COMMON NAME	Botanical name	Height	Midth	Mater requirement
$\bigoplus$	320	1-Gal	Turpentine Bush	Ericameria laricifolia	3.00	4.00	Low Mater Use
$\bigoplus$	<i>8</i> 5	1-Gal	Apache Plume	Fallugia paradoxa	5.00 2.50 3.00	5.00 2.50 4.00	Low Mater Use Medium Mater Use Low Mater Use
( ©	235	1-Gal	Grosso Lavender	Lavendula x intermedia 'Grosso'			
$ \stackrel{\bullet}{\bigcirc} \bigcirc $	38	1-Gal	Blue Mist Spirea	Caryopteris clandonensis 'Dark Knight'			
<b>⊘</b>	367	1-Gal	Pink Autumn Sage	Salvia greggii	2.50	3.00	Medium Mater Use
**	222	1- <i>Ga</i> l	Thompson Broom	Baccharis x Starns	3.00	3.00	Low Water Use
Succulent/0	Srasses						
SYMBOL	EST. QTY.	INSTALLED SIZE	COMMON NAME	Botanical name	Height	Midth	Mater requiremen
- AS	21	5-Gal	Parry's Agave	Agave parryi	2.50	2.50	Low Water Use
○○○○ ○○○○	31	5-Gal	Blue Sotol	Dasylirion wheeleri	4.00	5.00	Low Water Use
×	86	5-Gal	Red Hesperaloe	Hesperaloe parviflora	4.00	4.00	Low Water Use
$\Theta$	394	1-Gal	Beargrass	Nolina texana	4.00	5.00	Low Water Use
$\bigcirc$	18	1-Gal	Maiden Grass	Miscanthus sinensis	8.00	5.00	Medium Water Use
$\bigcirc$	181	1-Gal	El Toro Muhley	Muhlenbergia emersleyi El Toro	3.00	3.00	Medium Water Us
$\Diamond$	161	1-Gal	Regal Mist Grass	Muhlenbergia capillaris 'Regal Mist'	3.00	3.00	Medium Water Use
$\odot$	462	1- <i>Ga</i> l	Deer Grass	Muhlenbergia rigens	3.00	4.00	Medium Mater Use
Perennials							
SYMBOL	EST. QTY.	INSTALLED SIZE	COMMON NAME	Botanical name	Height	Midth	Mater requiremen
$\odot$	235	1-Gal	Grosso Lavender	Lavendula $\times$ intermedia 'Grosso'	2.50	2.50	Medium Water Us
Ø	299	1-Gal	Minecups	Callirhoe involucrata	1.00	2.50	Low Mater Use
Seeding			Fack City Vi	Ean use in all lands some and send server	518		
* * *	22,224 SF	Rate: 2lbs/1000SF	East Side Mix (Curtis&Curtis)	For use in all landscape and seed areas except for loading and future expansion	areas.		
	97,034 SF	Rate: 2000lb/Acre 800lb/Acre	Soil Biology Amendment Terra-Pro Commercial Protein Crumblies	For use over plant pits in all landscape a	areas		
	= 4 040 65	Ciro	Cruichan fina anaval mulch				

Crusher fine gravel mulch 2" depth, Color: Santa Fe Brown

Size: Crusher Fine

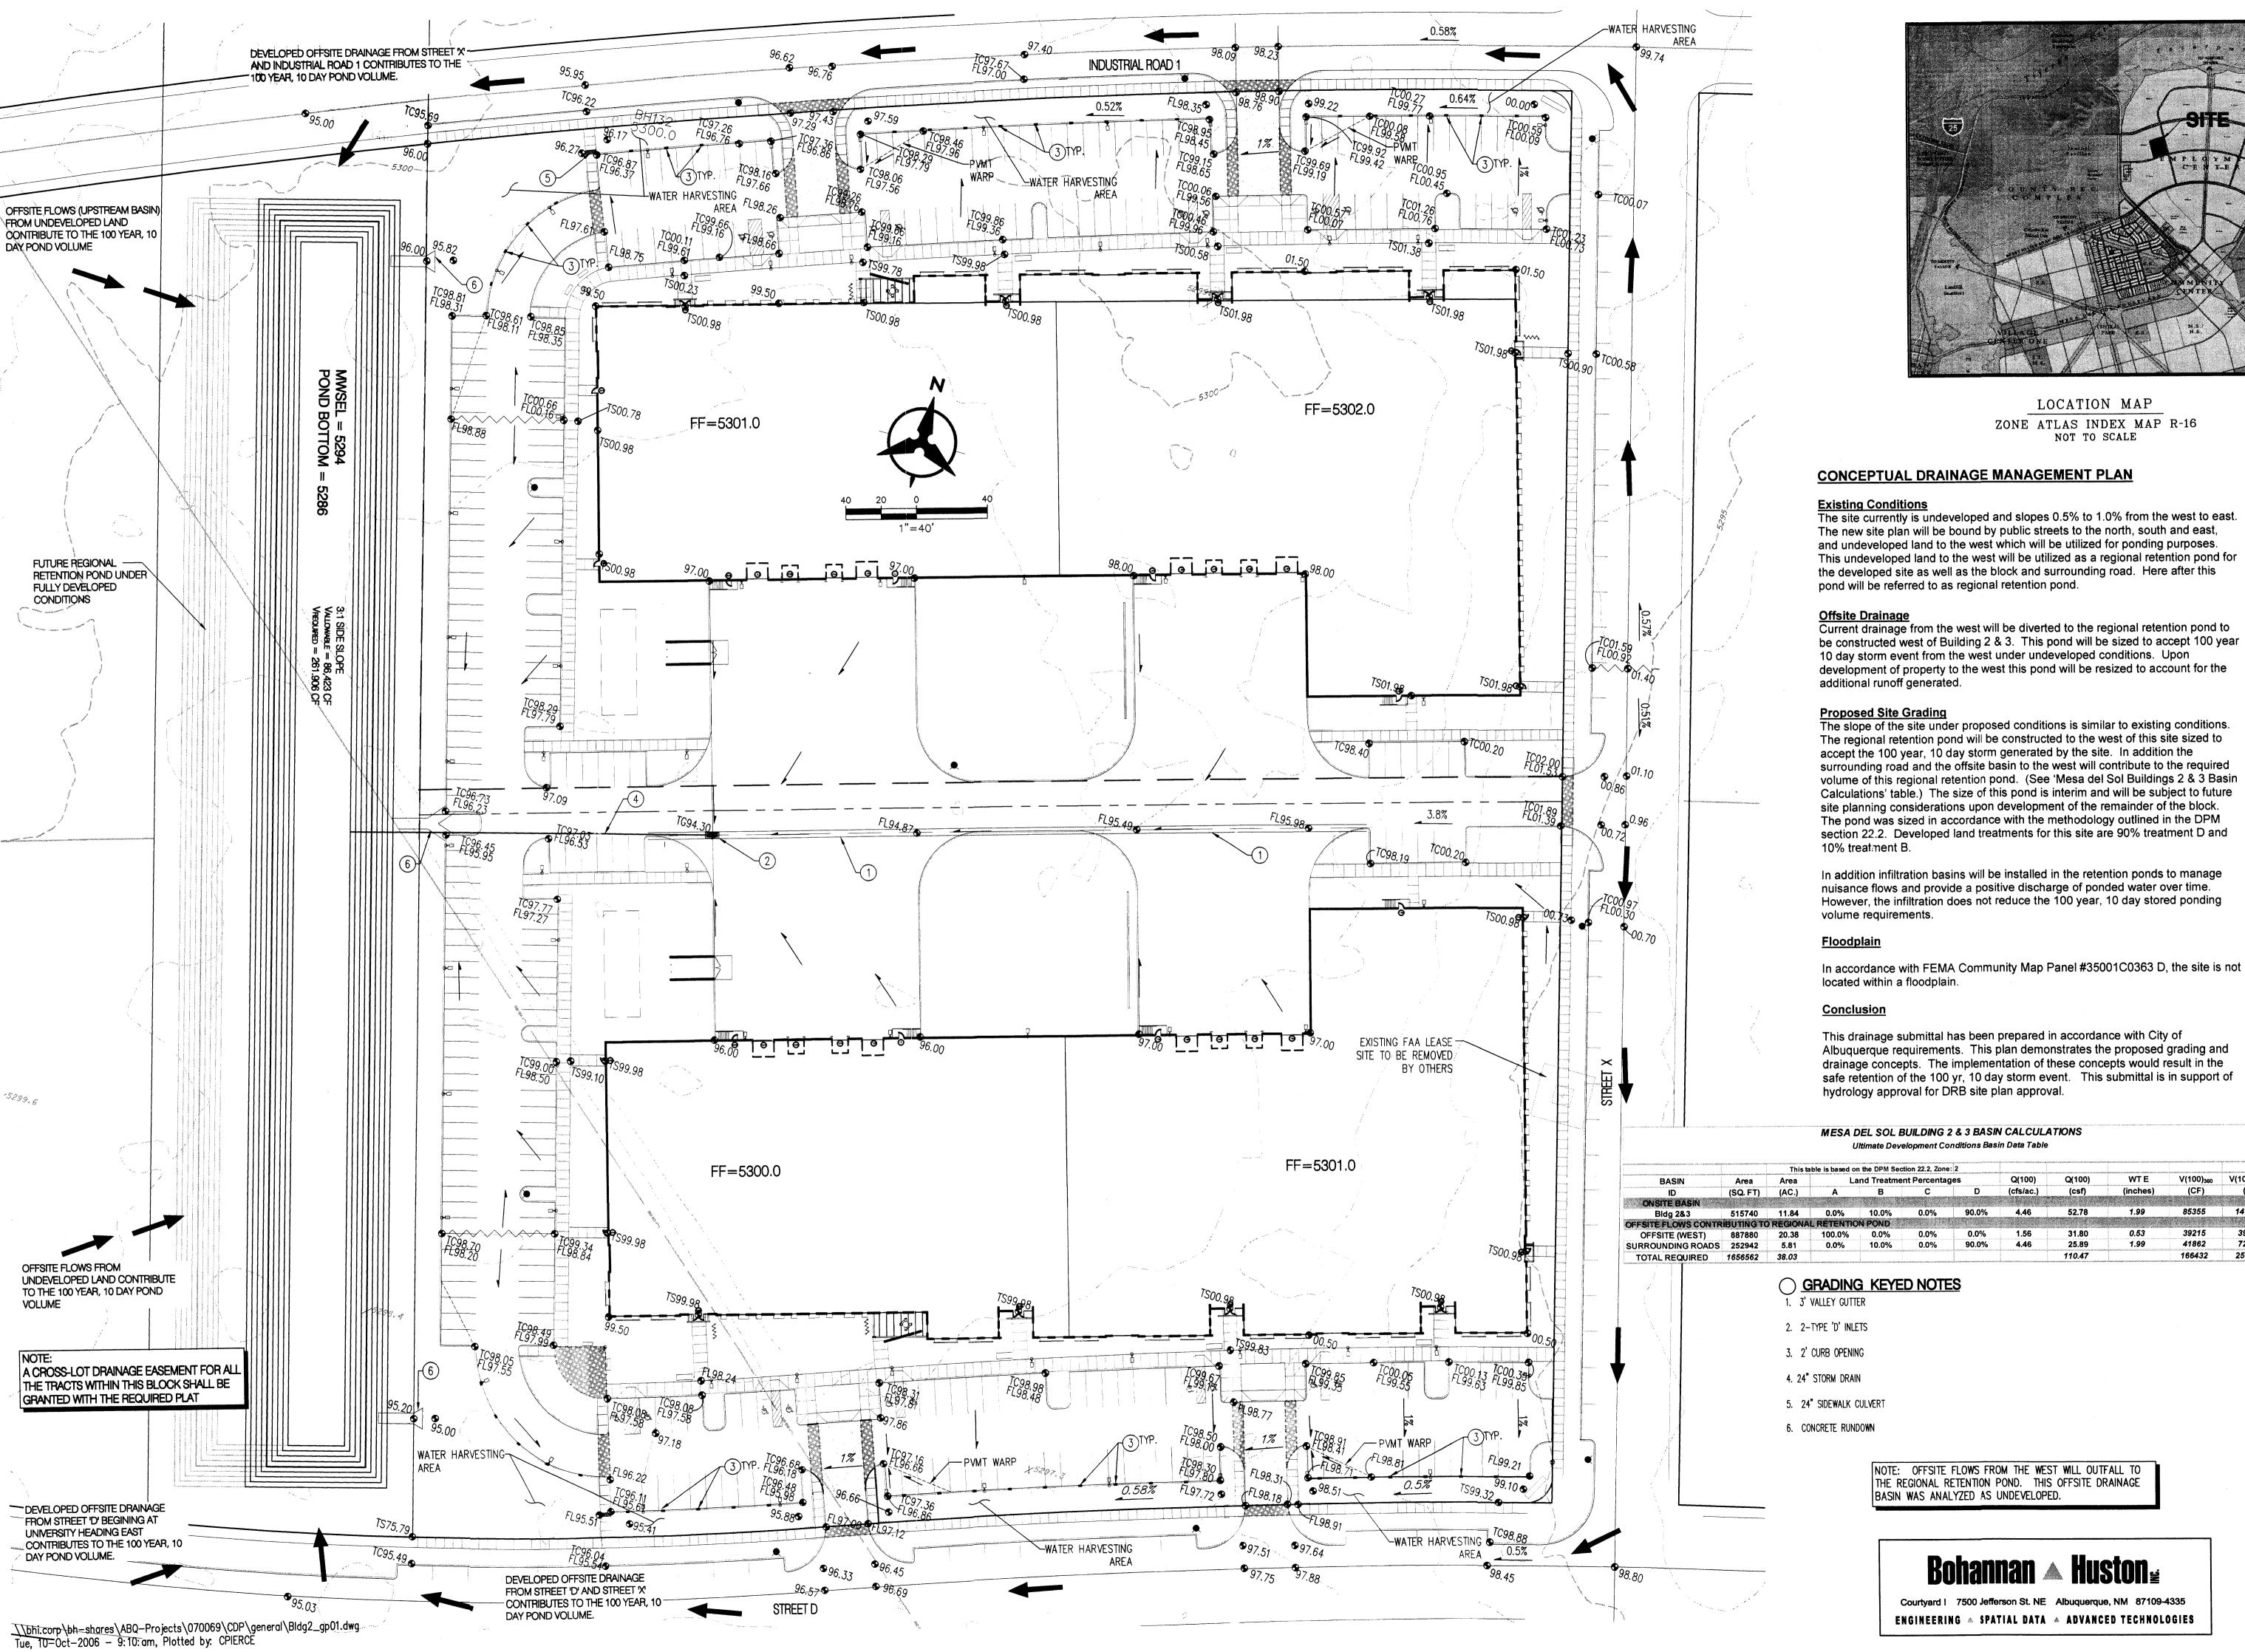


architecture interiors planning engineering

6801 Jefferson NE Suite 100 Albuquerque, NM 87109 505 761-9700 fax 761-4222 dps Odpsabq.com

ARCHITECT

DRB SUBMITTAL

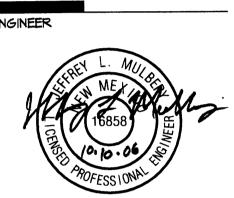

						v.v.v.eeeeee.v.ccccecceccccccc	90000000000000000000000000000000000000				uga-saccascascascascascascascascascascascasc
		This ta	ble is based on	the DPM Se	ction 22.2, Zone:	2					
BASIN	Area	Area	La	nd Treatme	ent Percentage	es	Q(100)	Q(100)	WTE	V(100) <sub>360</sub>	V(100) <sub>10 DAY</sub>
ID	(SQ. FT)	(AC.)	Α	В	С	D	(cfs/ac.)	(csf)	(inches)	(CF)	(CF)
ONSITE BASIN											
Bldg 2&3	515740	11.84	0.0%	10.0%	0.0%	90.0%	4.46	52.78	1.99	85355	147244
SITE FLOWS CONTRI	BUTING TO	REGIONA	L RETENTIO	N POND							
OFFSITE (WEST)	887880	20.38	100.0%	0.0%	0.0%	0.0%	1.56	31.80	0.53	39215	39215
ROUNDING ROADS	252942	5.81	0.0%	10.0%	0.0%	90.0%	4.46	25.89	1.99	41862	72215

DRAINAGE PLAN

CONCEPTUAL

GRADING AND

Employ BUI

REVISIONS

DRAWN BY


REVIEWED BY

PROJECT NO. DRAWING NAME

DATE

SHEET NO.

10/10/06

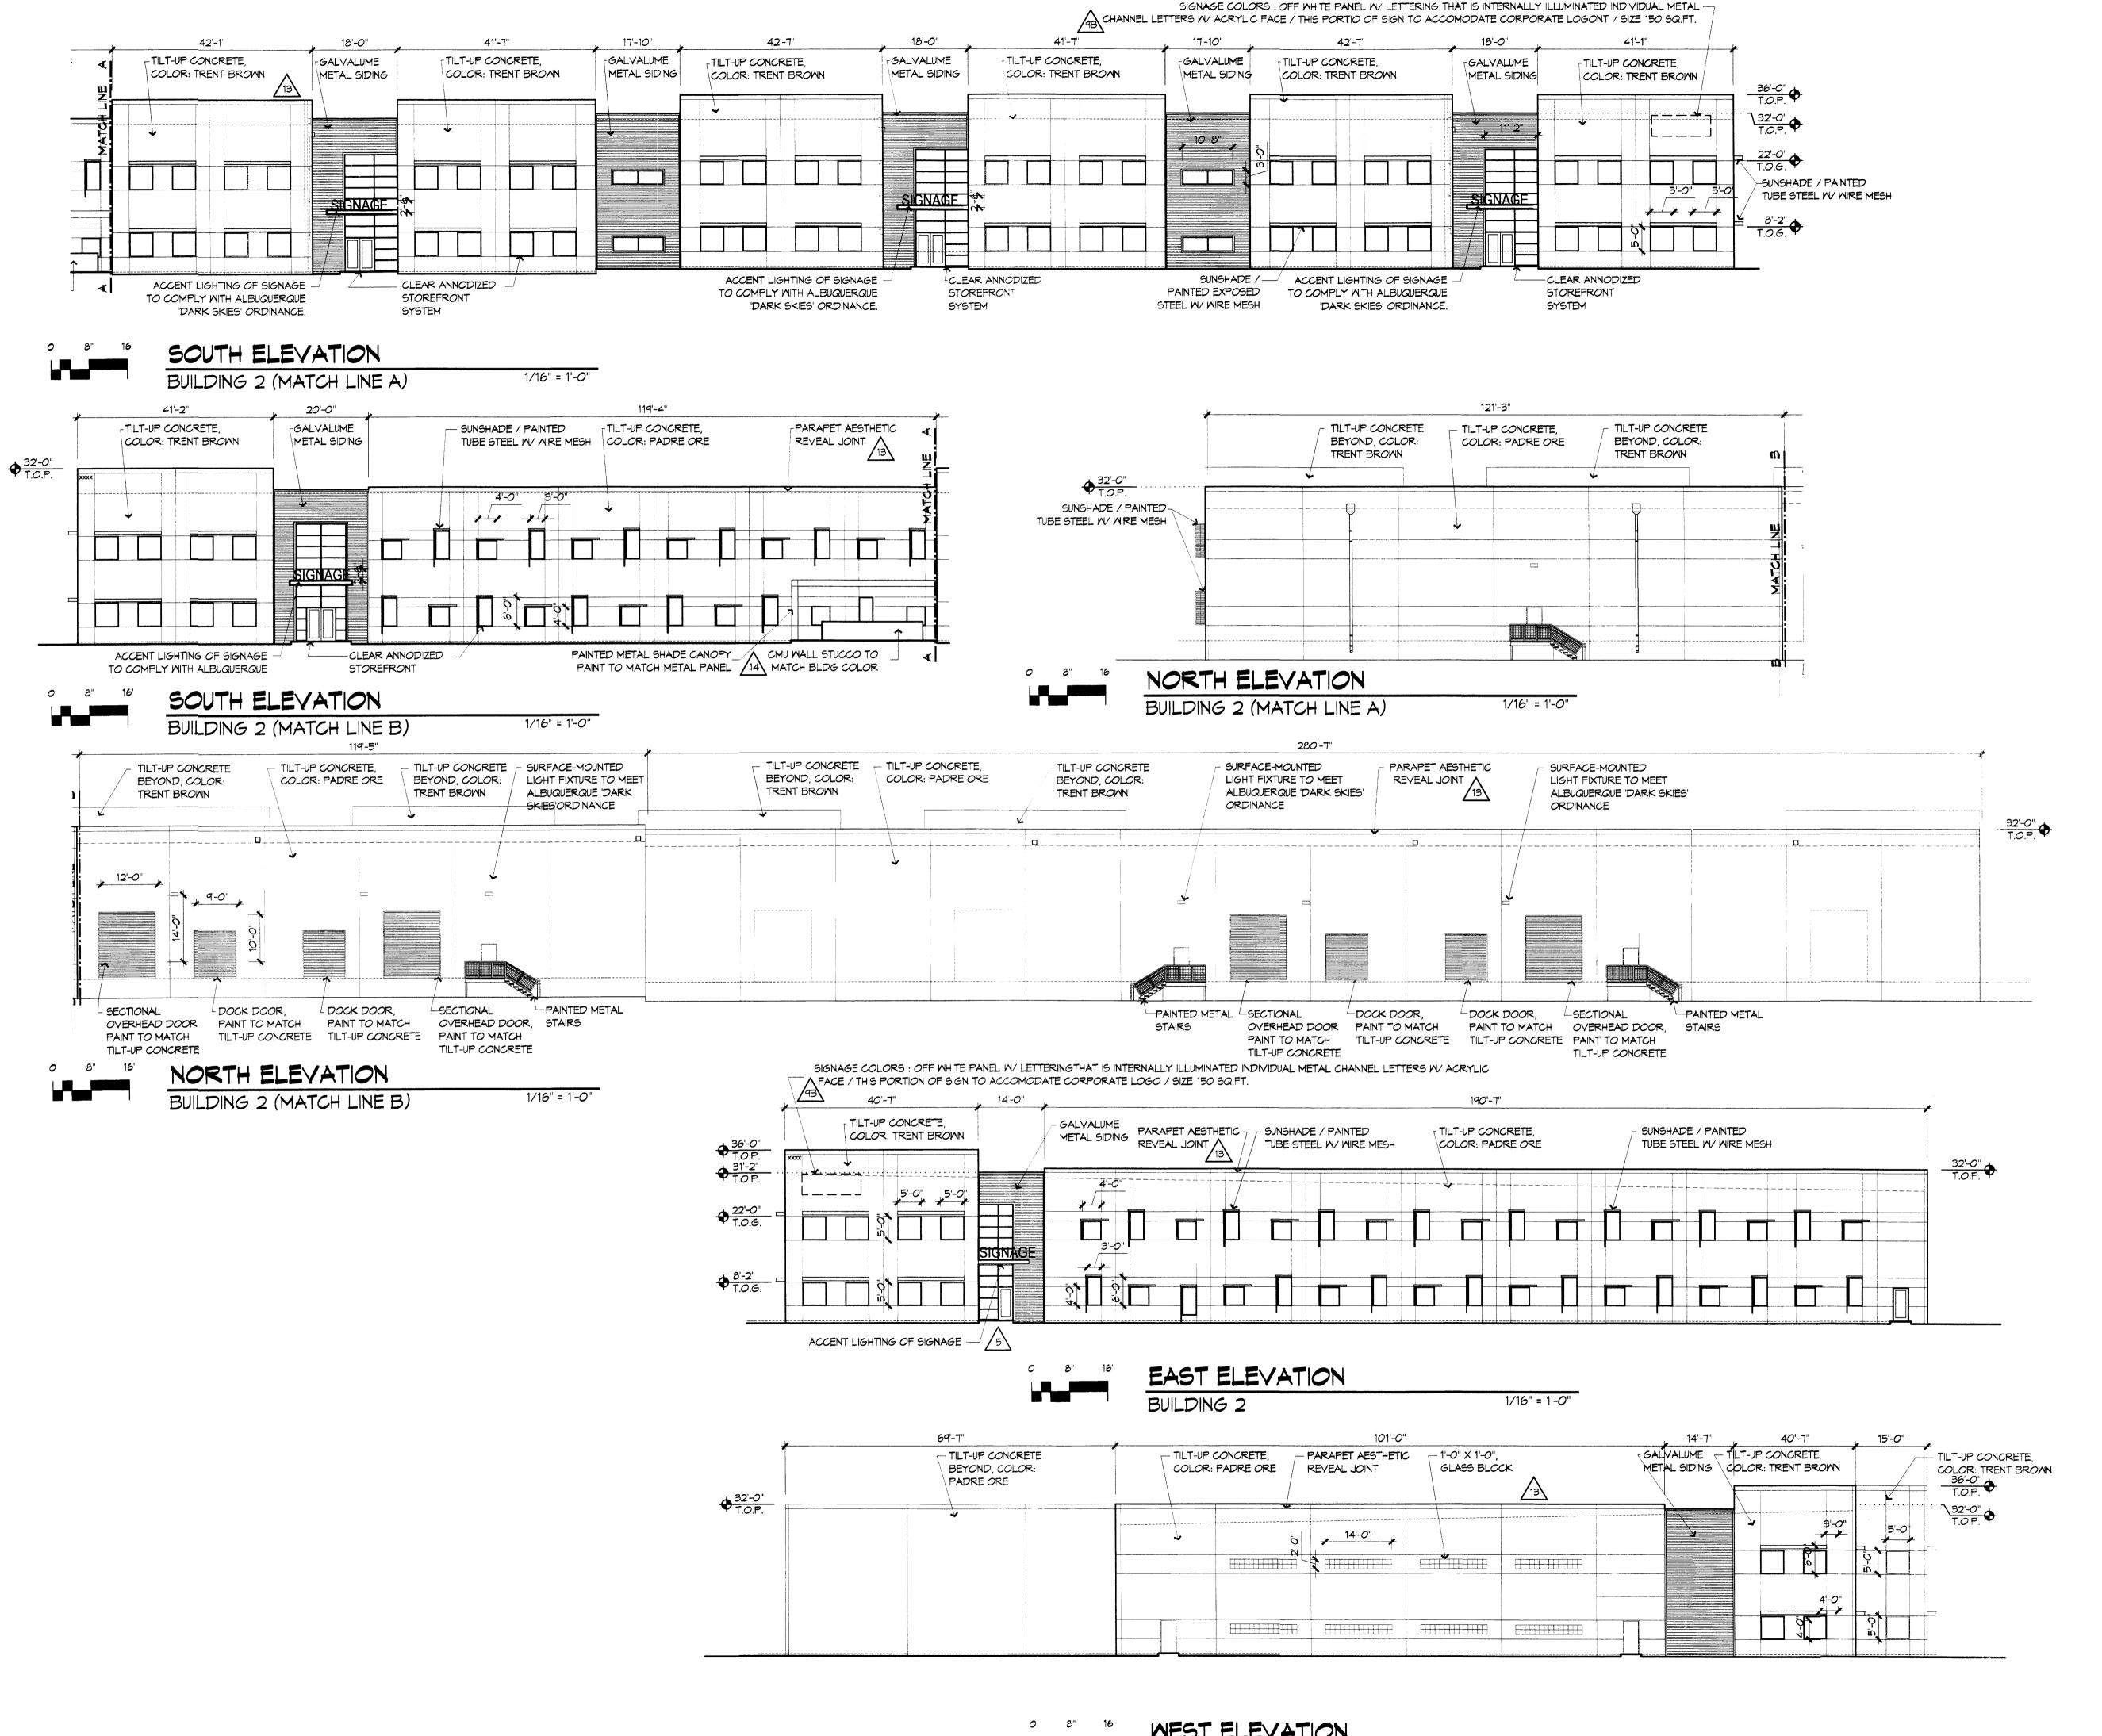

BUILDING 3

WEST ELEVATION

1/16" = 1'-0"

architecture
interiors
landscape
planning
engineering

Dekker Perich Sabatin

7601 Jefferson NE Suite 100 A!buquerque, NM 87109 505761-9700 fax 761-4222 dps @dpsdesign.org

ARCHITECT

ENGINEER

Mesa Del Sol
Employment Center - Phase One
BUILDING #2 AND BUILDING 3
Albuquerque, New Mexico

REVISIONS

10/03/06 DRB SUBMITTAL

DRAWN BY 51.


REVIEWED BY

DATE 10.09.05

PROJECT NO. 06002

DRANING NAME
ELEVATIONS
BUILDING 2

энеет No. **430** 

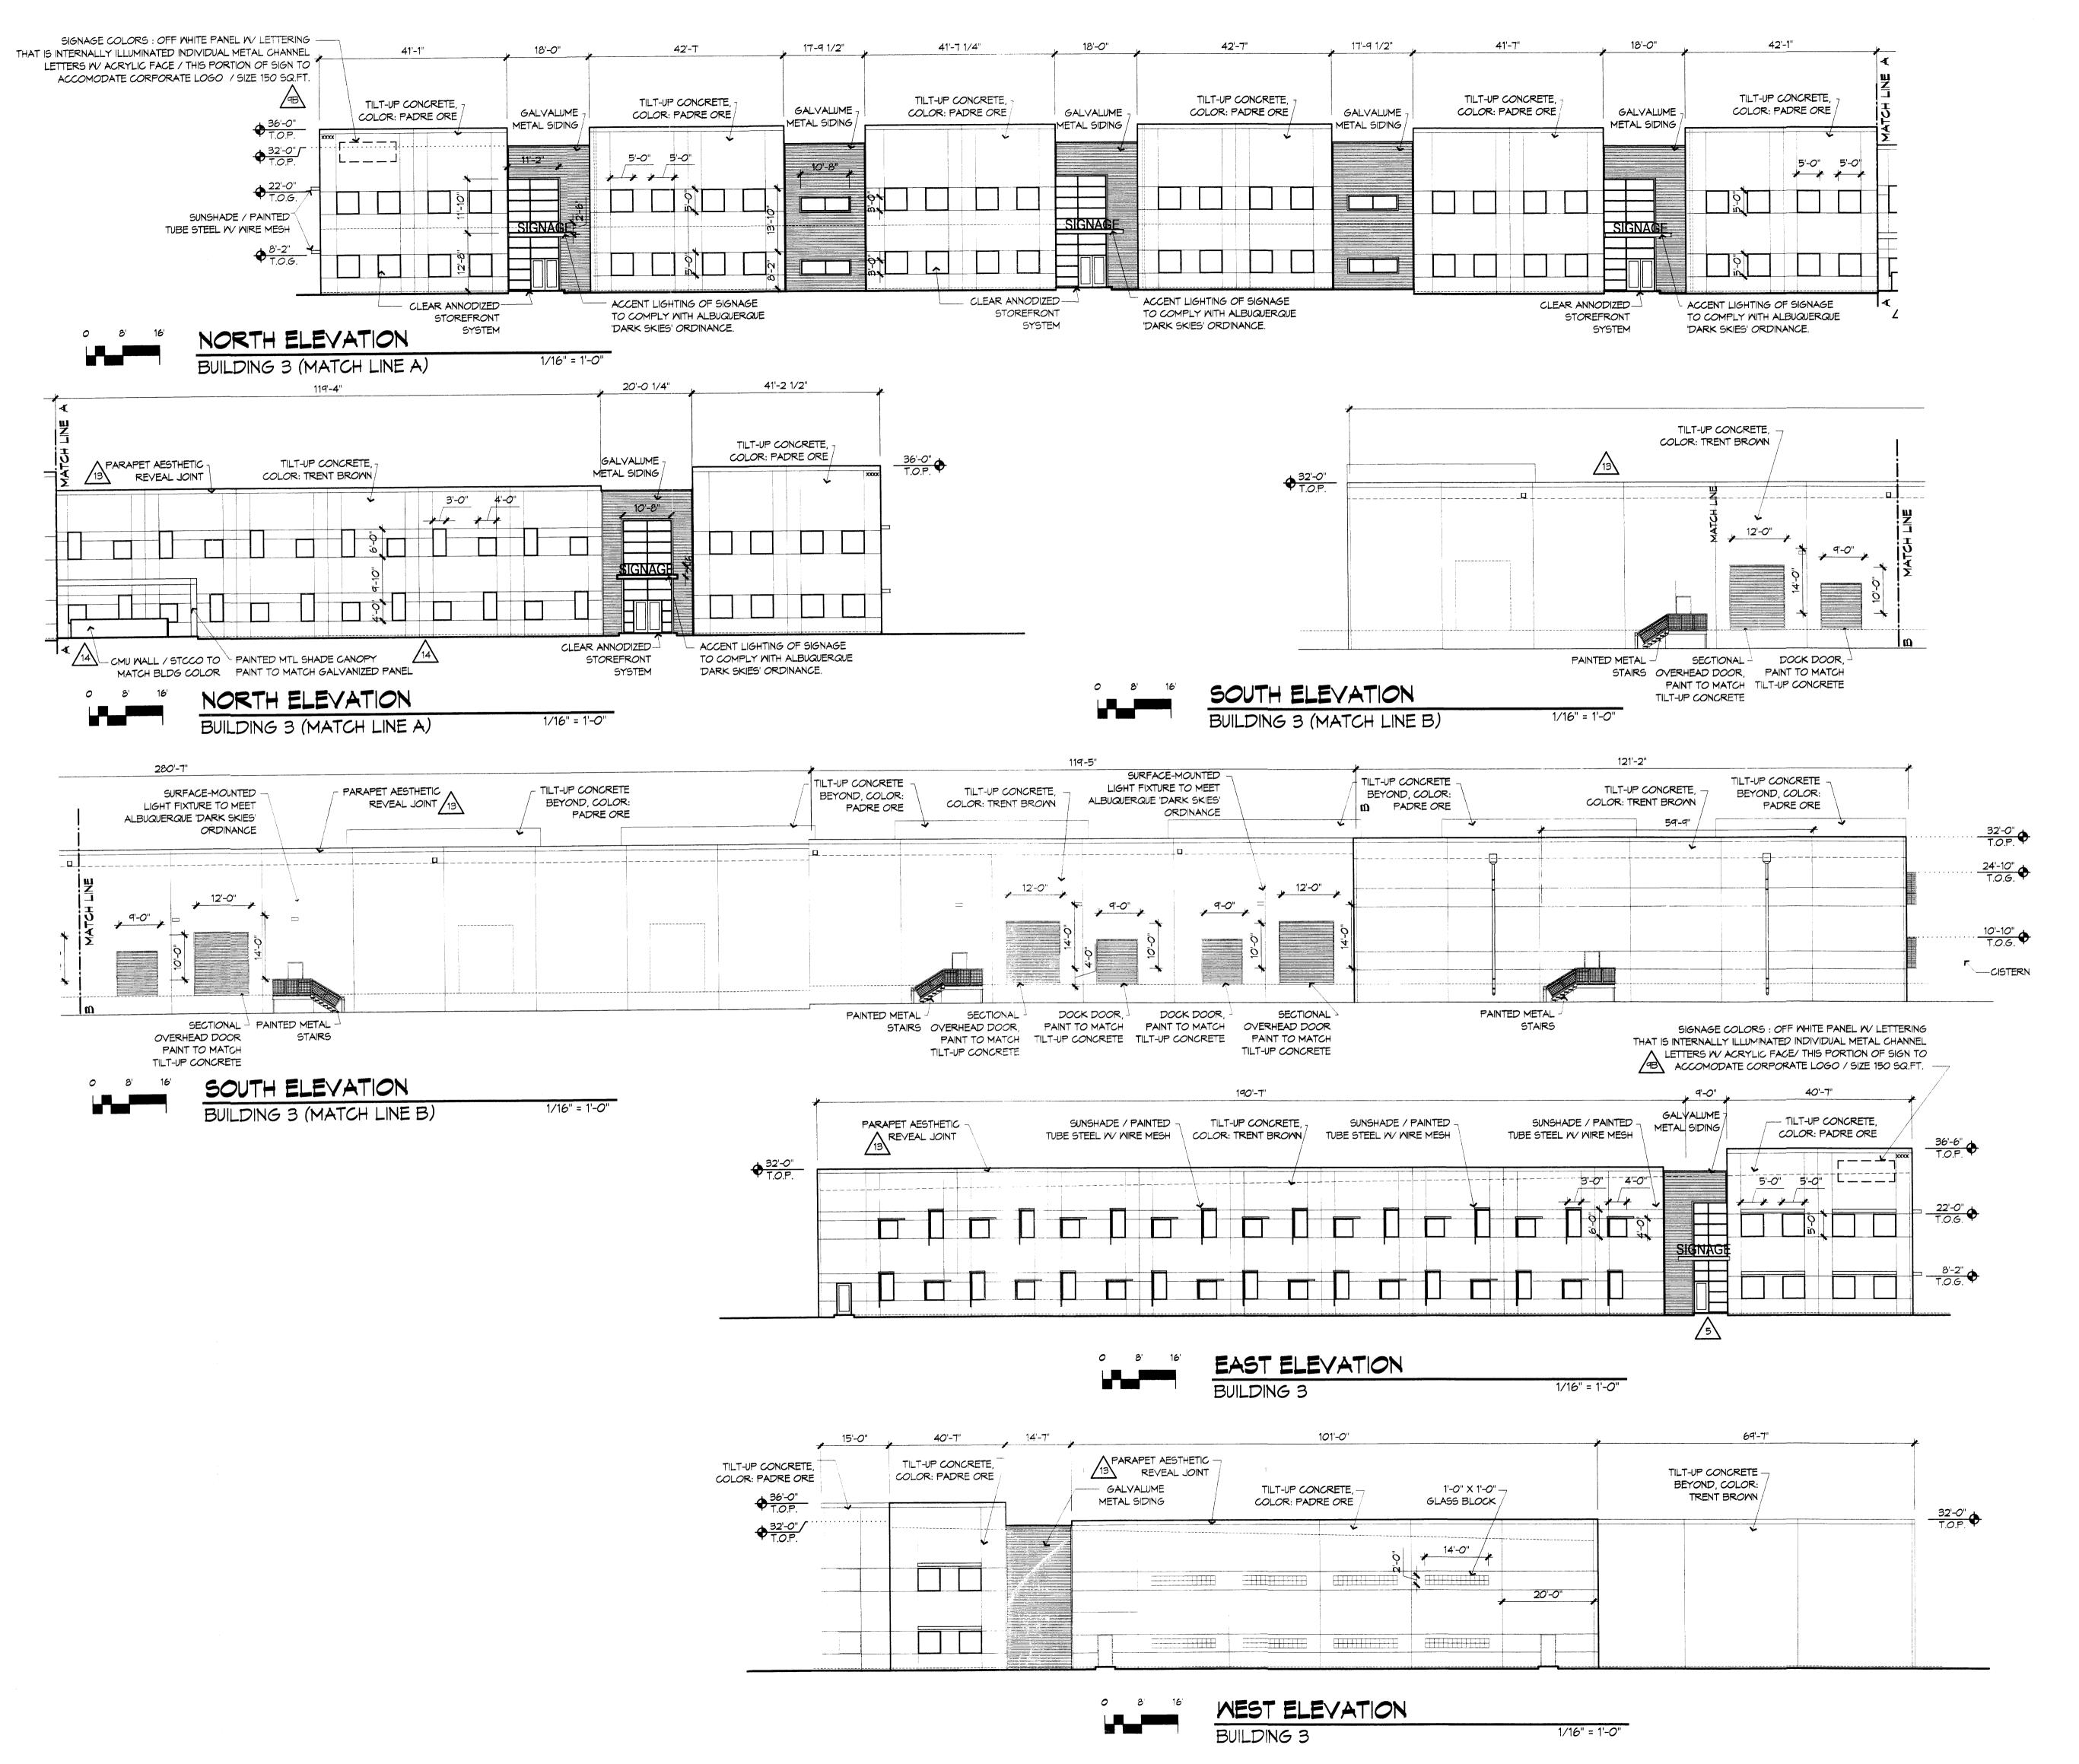

interiors landscape planning engineering

architecture

Dekker Perich Sahatin

7601 Jefferson NE Suite 100 Albuquerque, NM 87109 505 761-9700 fax 761-4222 dps@dpsdesign.org

ARCHITECT

ENGINEER

| Mesa Del Sol |Employment Center - Phase One |BUILDING #2 AND BUILDING 3 | Albuquerque, New Mexico

REVISIONS

10/03/06 DRB SUBMITTAL

DRAWN BY SL
REVIEWED BY


DATE 10.09.06

PROJECT NO. 06002

DRAWING NAME
ELEVATIONS
BUILDING 3

SHEET NO.

A302

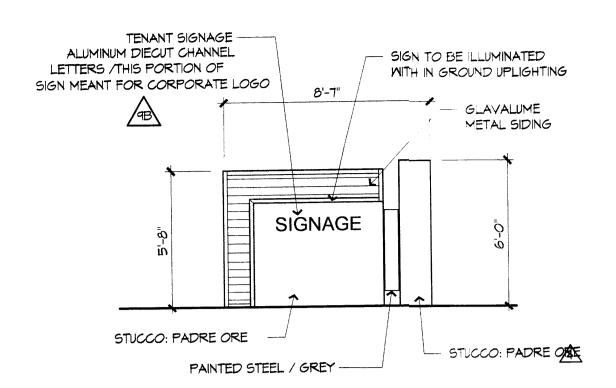


# TENANT SIGNAGE A

BUILDING ENTRY SIGN 1/4" =1'-0"


1/4"=1'-0"

1/4"=1'-0"

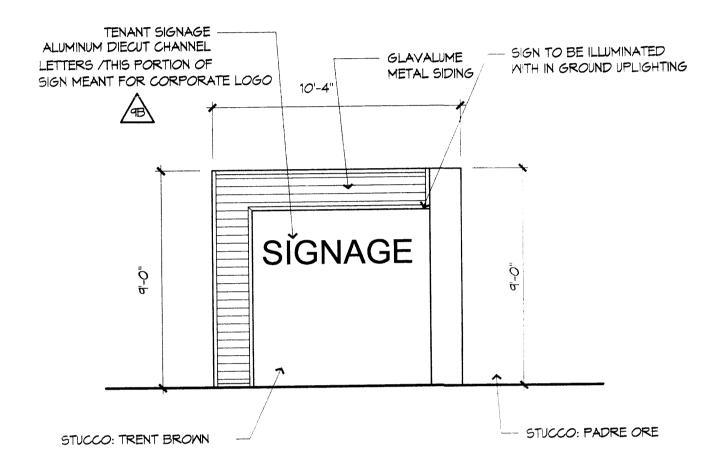

# TENANT SIGNAGE B

MONUMENT SIGN

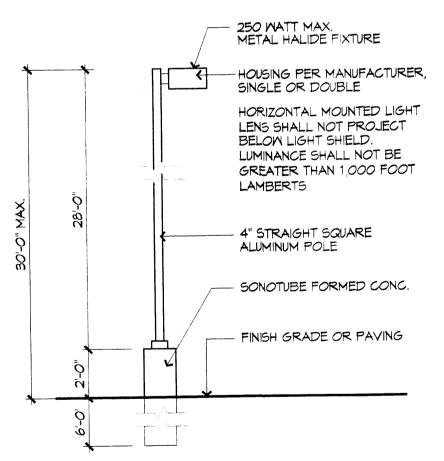

PARKING LOT LIGHT POLE


DETAIL


521-2 1/2"

521-2 1/2"

521-2 1/2"


521-2 1/2"

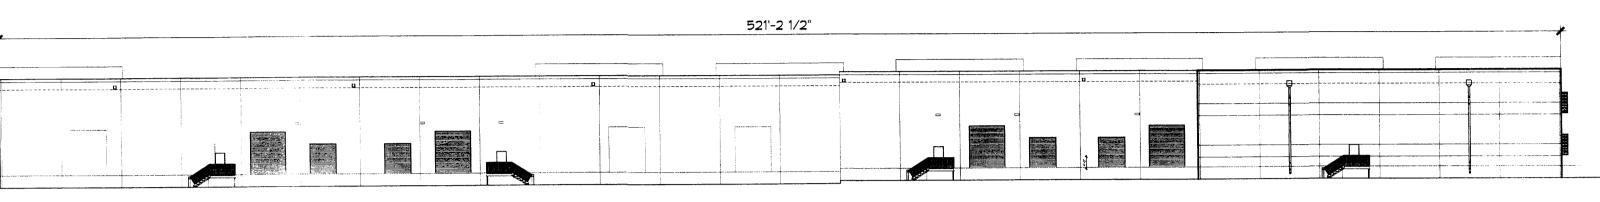

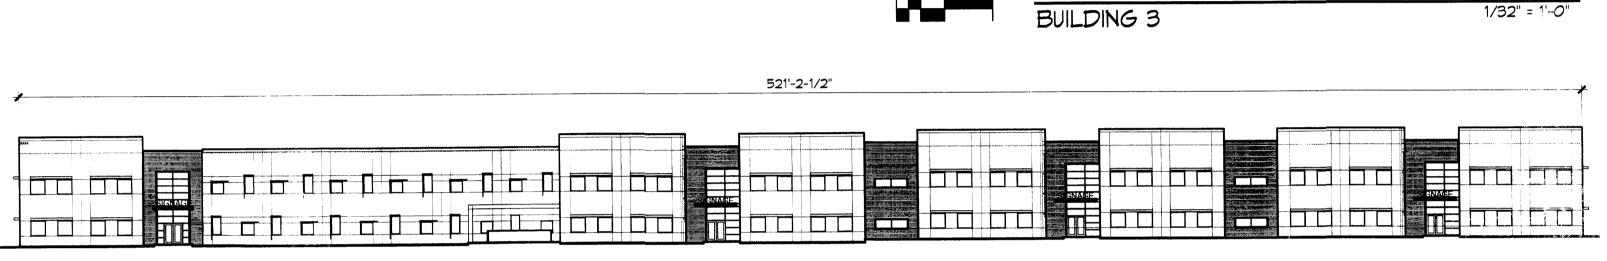





SOUTH ELEVATION

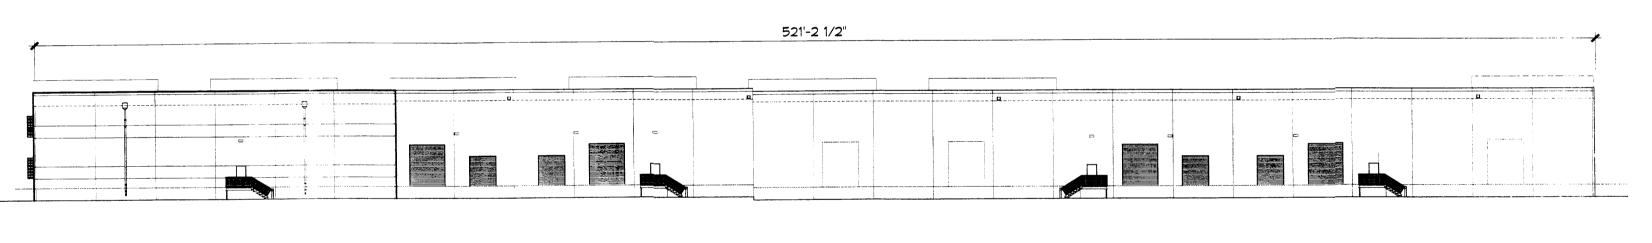




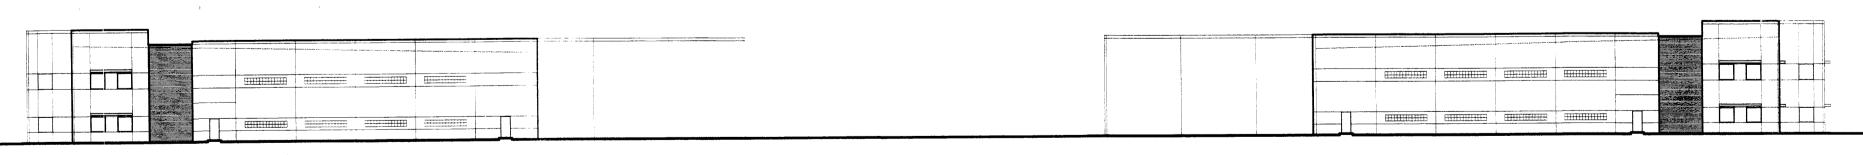



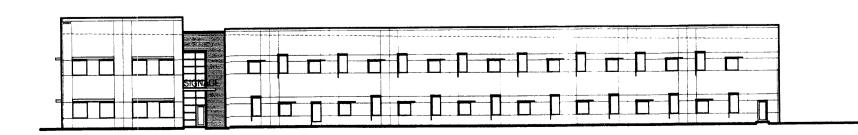

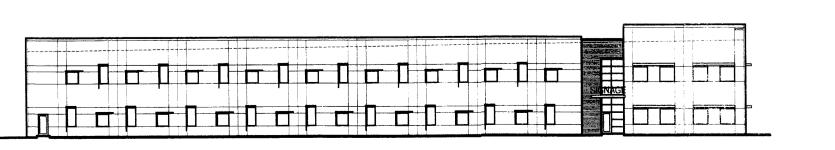



architecture interiors landscape planning engineering

Dekker Perich Sabatini

7601 Jetferson NE Suite 100 Albuquerque, NM 87109 505 761-9700 fax 761-4222

ARCHITECT

dps @ dpsdesign.org

ENGINEER

Employment Center - Phase One BUILDING #2 AND BUILDING 3
Albuquerque, New Mexico

REVISIONS

DRAWN BY SL

REVIEWED BY


DATE 10.10.06

PROJECT NO. 06002

DRAWING NAME
ELEVATIONS
BUILDING A AND B

1/32" = 1'-*0*"



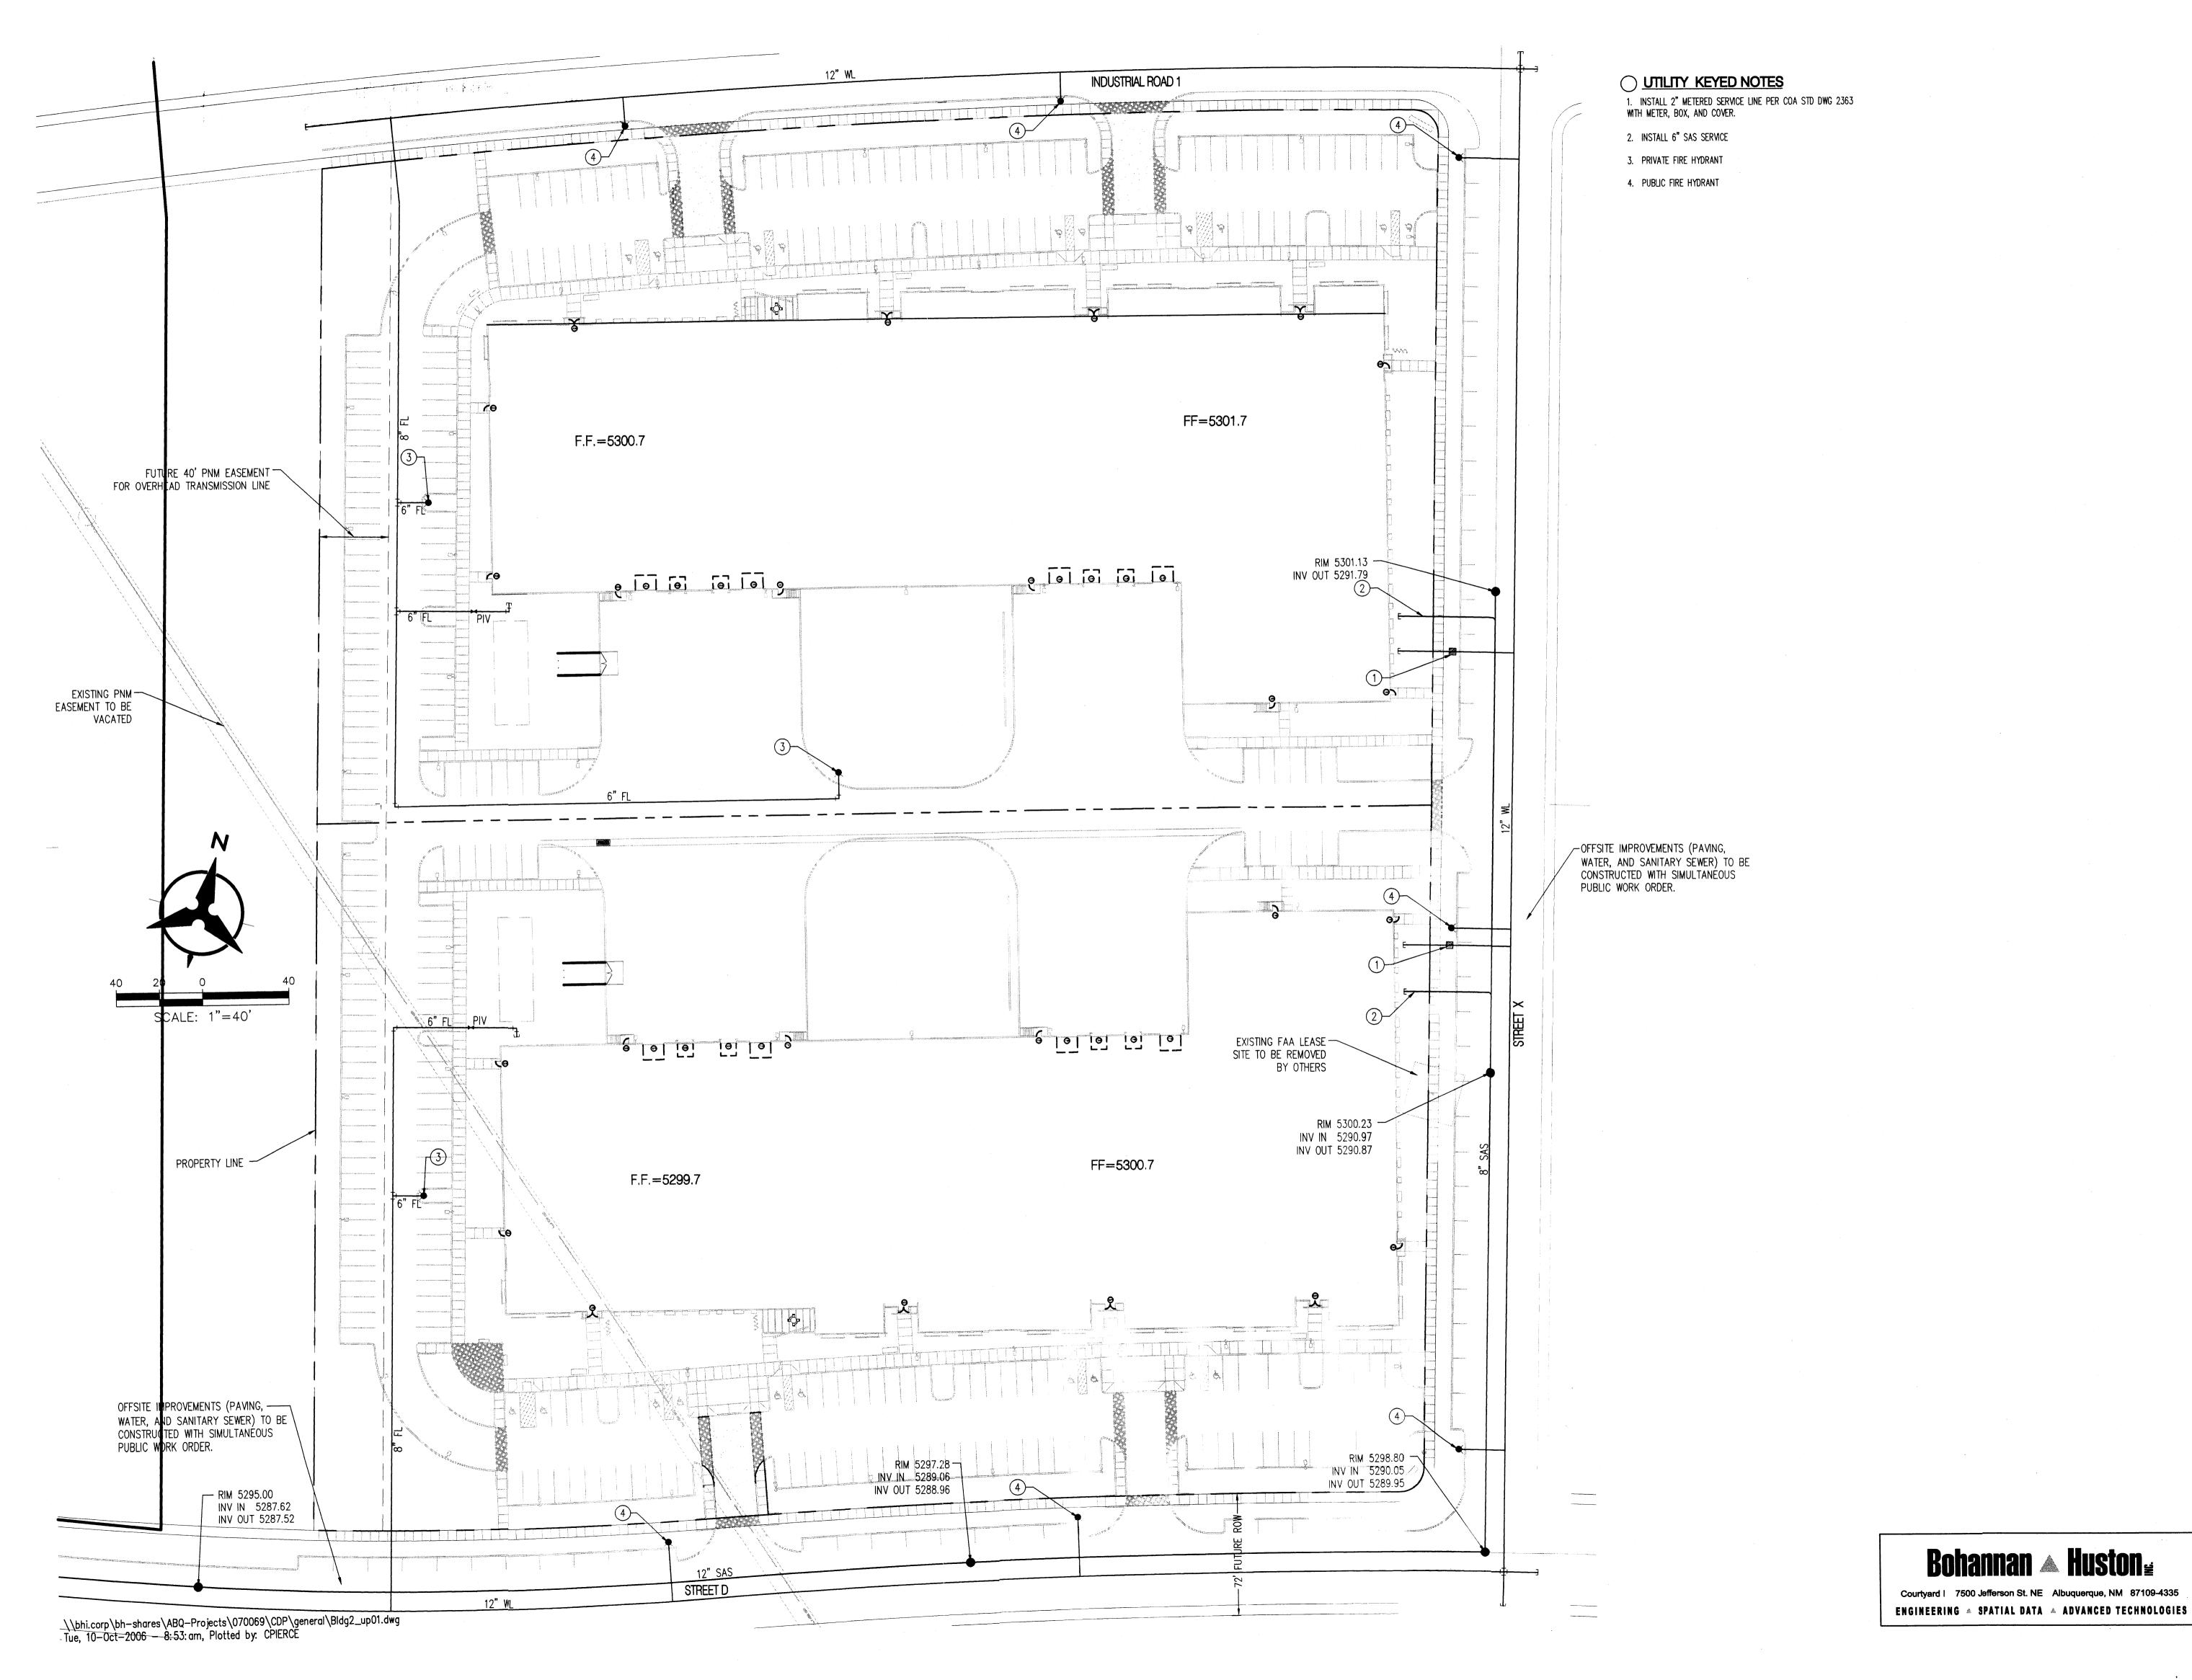

engineering


6801 Jefferson NE Suite 100 Albuquerque, NM 87109

architecture

planning

505 761-9700 fax 761-4222 dps⊕dpsabq.com

DRB SUBMITTAL

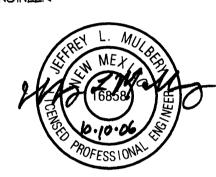

| Employment | BUILDING

REVISIONS

DRAWN BY


REVIEWED BY 10/10/06

DATE PROJECT NO.

DRAWING NAME

CONCEPTUAL UTILITY PLAN

SHEET NO.

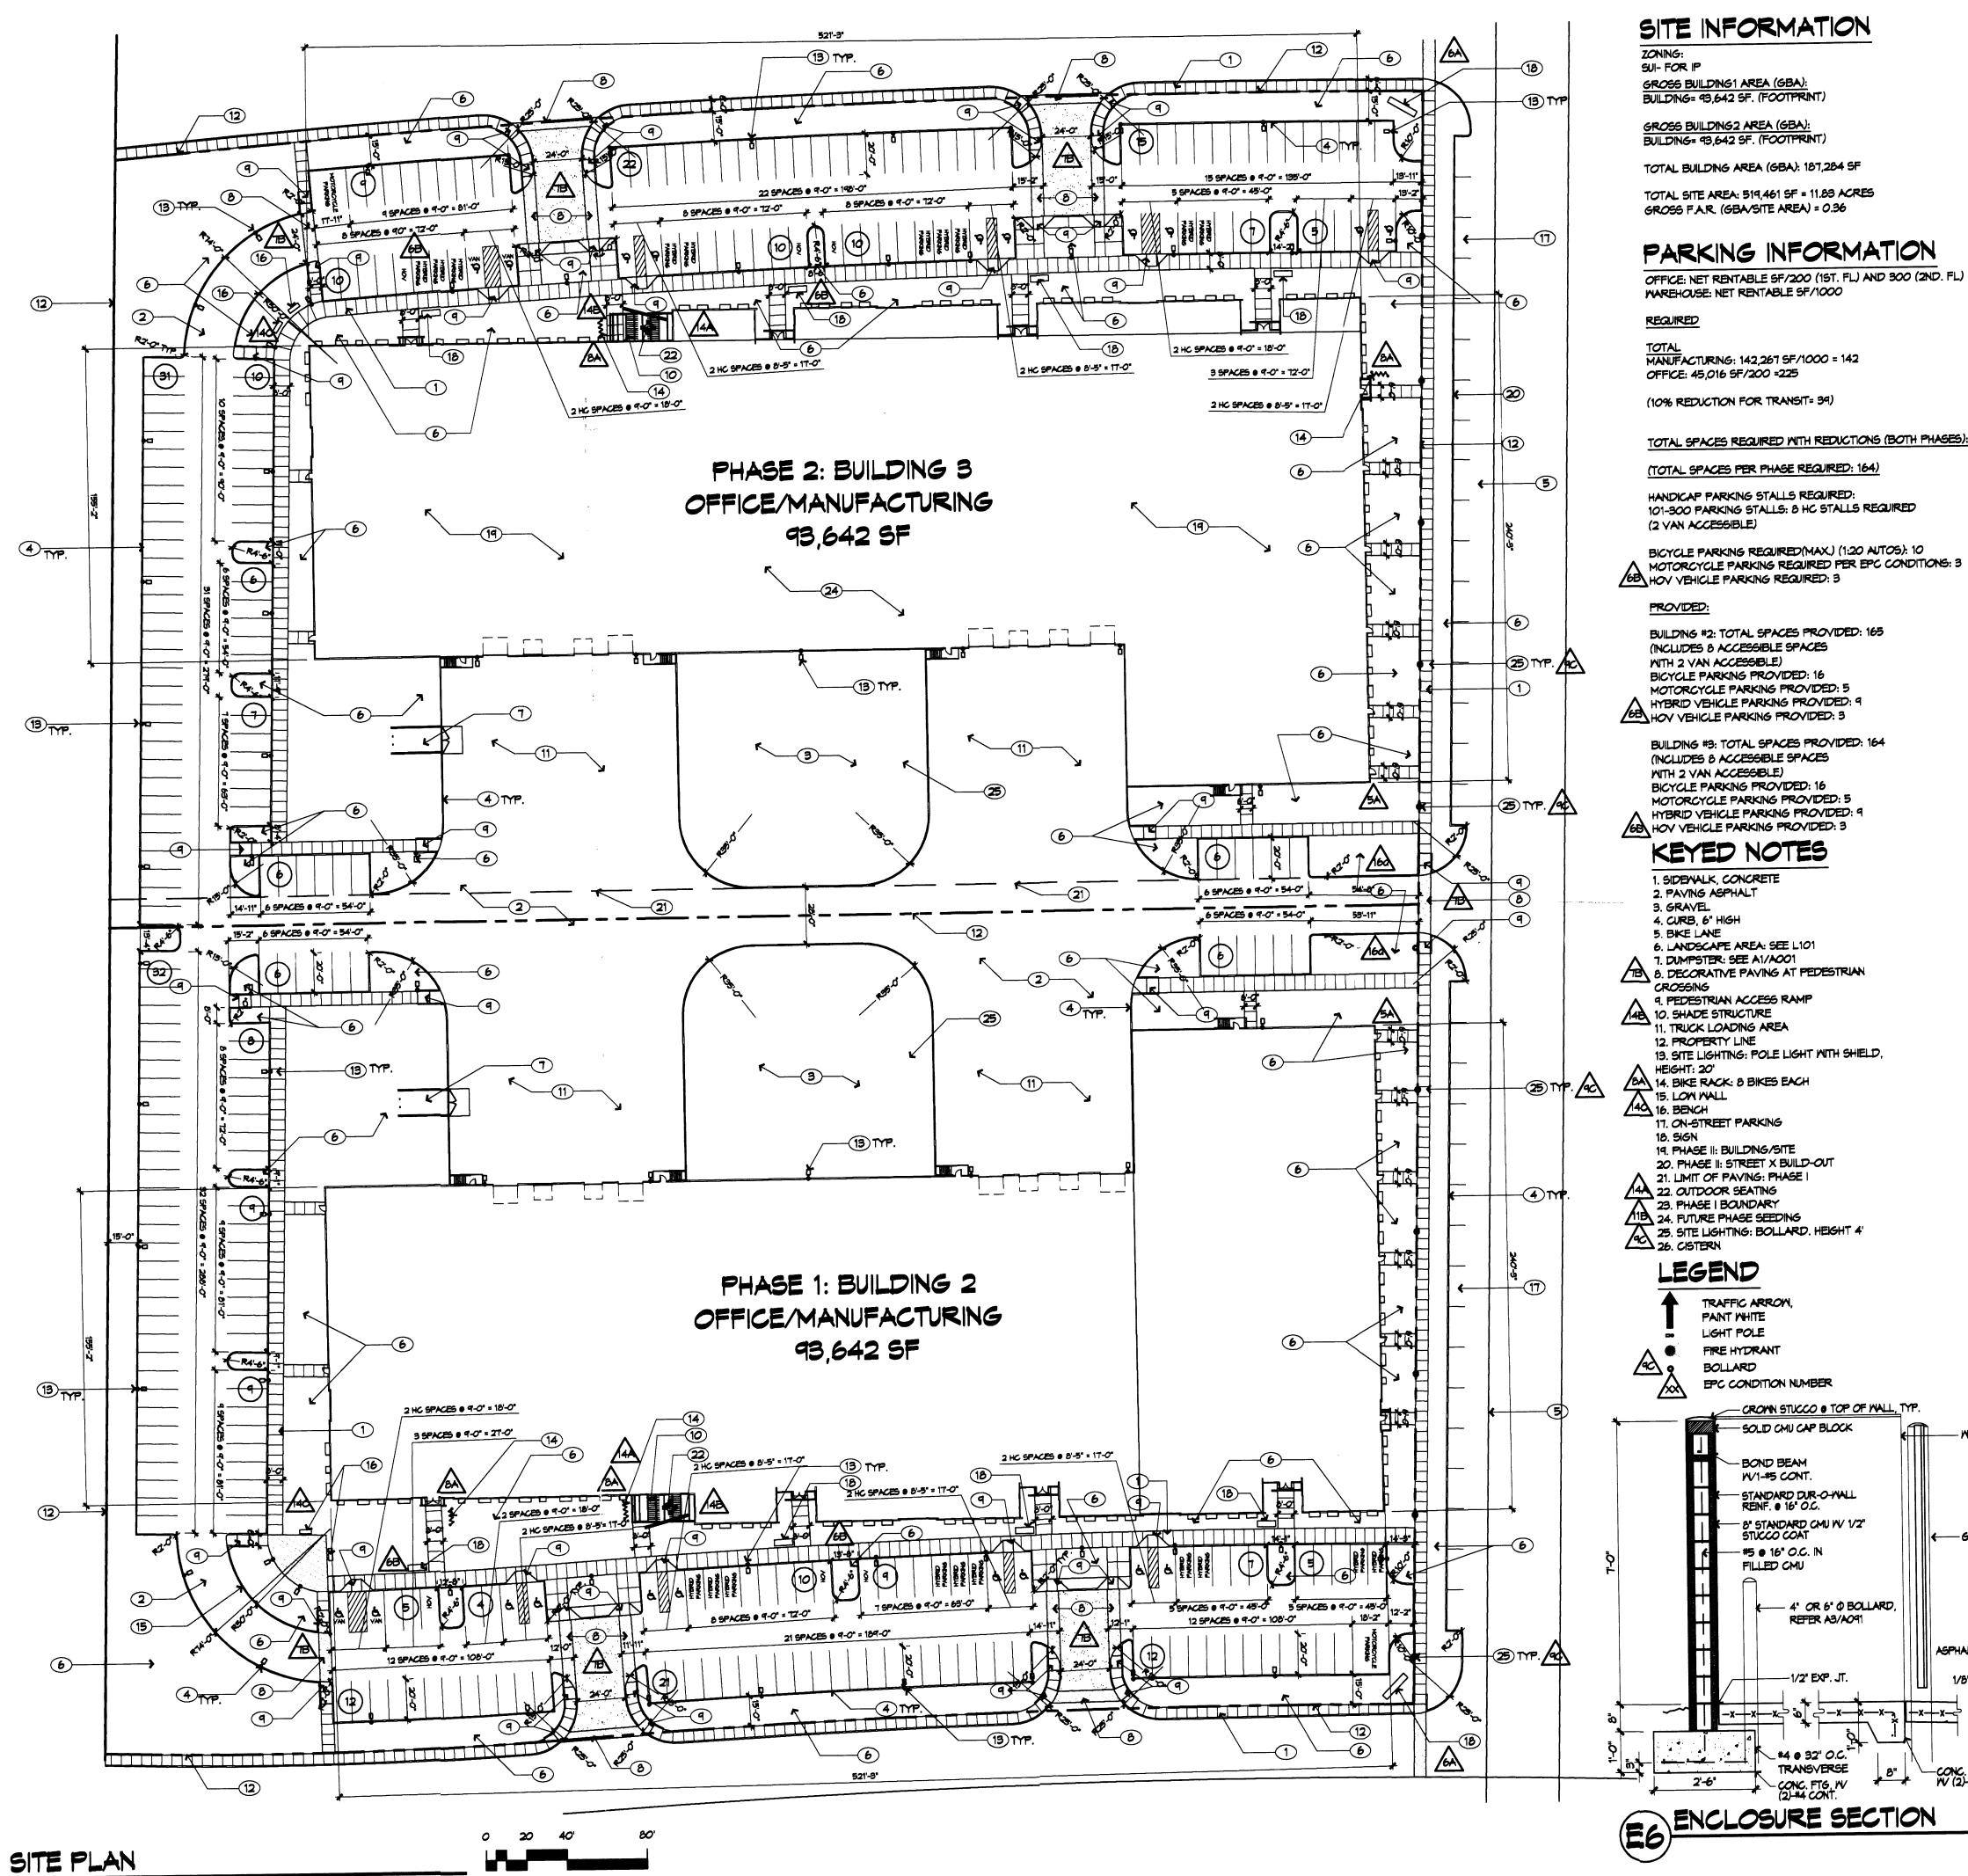

SITE INFORMATION

GROSS BUILDING1 AREA (GBA): BUILDING= 93,642 SF. (FOOTPRINT)

TOTAL SITE AREA: 519,461 SF = 11.83 ACRES

# PARKING INFORMATION

OFFICE: NET RENTABLE SF/200 (1ST. FL.) AND 300 (2ND. FL.)

TOTAL MANUFACTURING: 142,267 SF/1000 = 142 OFFICE: 45,016 SF/200 =225

(10% REDUCTION FOR TRANSIT= 39)

TOTAL SPACES REQUIRED WITH REDUCTIONS (BOTH PHASES): 328

HANDICAP PARKING STALLS REQUIRED:

BICYCLE PARKING REQUIRED (MAX.) (1:20 AUTOS): 10

BUILDING #2: TOTAL SPACES PROVIDED: 165 (INCLUDES 8 ACCESSIBLE SPACES WITH 2 VAN ACCESSIBLE) BICYCLE PARKING PROVIDED: 16 MOTORCYCLE PARKING PROVIDED: 5 HYBRID VEHICLE PARKING PROVIDED: 9 68 HOV VEHICLE PARKING PROVIDED: 3

BUILDING #3: TOTAL SPACES PROVIDED: 164 (INCLUDES 8 ACCESSIBLE SPACES WITH 2 VAN ACCESSIBLE) BICYCLE PARKING PROVIDED: 16 MOTORCYCLE PARKING PROVIDED: 5 HYBRID VEHICLE PARKING PROVIDED: 9

1. SIDENALK, CONCRETE

6. LANDSCAPE AREA: SEE L101 7. DUMPSTER: SEE A1/A001

9. PEDESTRIAN ACCESS RAMP
10. SHADE STRUCTURE
11. TRUCK LOADING AREA

13. SITE LIGHTING: POLE LIGHT WITH SHIELD,

17. ON-STREET PARKING 19. PHASE II: BUILDING/SITE 20. PHASE II: STREET X BUILD-OUT 21. LIMIT OF PAVING: PHASE

TRAFFIC ARROW, PAINT WHITE LIGHT POLE

FIRE HYDRANT EPC CONDITION NUMBER

REFER A3/A091

\_#4 @ 32" O.C. Transverse

— GATE, REFER B5/A091 — 4" OR 6" O BOLLARD, ASPHALT PAVEMENT 1/8" /FOOT SLOPE

1/2" = 1'-0"

GENERAL NOTES A. PARKING AREA SHALL BE DESIGNED

BUILT TO CURRENT DPM STANDARDS.

B. PERMISSION TO USE 40 SCALE FOR THIS SITE PLAN HAS BEEN APPROVED BY STAFF.

C. THERE ARE NO EXISTING STRUCTURES

D. CROSS LOT ACCESS WILL BE GRANTED

ALBUQUERQUES IP INDUSTRIAL PARK ZONE.

F. TRACT REFERENCES ARE TO THE TRACTS

AS CONFIGURED AND ALIGNED IN THE SITE

DEVELOPMENT PLAN. TRACT LINES ARE TO

BE ADJUSTED/FIXED WITH REQUIRED REPLAT.

G. STREET X TO HAVE TWO TRAVEL LANES

ON EACH SIDE AR ULTIMATE BUILDOUT.

H. SEE CONCEPTUAL CIVIL PLANS FOR

I. CISTERN WATER TO BE USED FOR

ON THE EAST SIDE OF UNIVERSITY

58 K. ALL GRAVEL AREA TO BE USED AS

OUTSIDE OF THE RIGHT-OF-WAY.

BOULEVARD, JUST NORTH OF STREET D.

THERE ARE NO FUTURE TRANSIT STOPS

PLANNED DIRECTLY ADJACENT TO THE

UTILITY INFORMATION.

IRRIGATION.

PROPERTY.

A WALL OR FENCE.

ADDITIONAL GRADING, DRAINAGE, AND

J. A FUTURE TRANSIT STOP MAY BE LOCATED

STORAGE AREAS SHALL BE SCREENED WITH

E. SIGNAGE SHALL COMPLY WITH THE REQUIREMENTS OF THE CITY OF

WITHIN 20 FEET OF THE SITE.

WITH REQUIRED REPLAT.

M. SIGNS: SEE BUILDING ELEVATIONS FOR DESCRIPTION OF SIGNAGE ON BUILDING. TWO TYPES OF SITE SIGNS ARE LOCATED

2 AND SOUTH SIDE BUILDING 3.

MATERIALS: PER EPC SUBMITTAL

SIZE: BASE - 3' WIDE X 15' LONG.

MATERIALS: PER EPC SUBMITTAL

LOCATED AT THE NORTH SIDE OF BUILDING

LOCATED AT THE SM CORNER AND THE NM

N. DIMENSIONS ARE TO FACE OF CURB, OR

WALL, OR EDGE OF PAVEMENT UNLESS

SIZE: BASE - 3' WIDE X 9' LONG (MAX.)

ON THE PROPERTY.

HEIGHT: 5' MAX.

HEIGHT: 15' MAX.

LIGHTING: INTERNAL OR

BACKLIT/SILHOUETTE

OTHERWISE NOTED.

LIGHTING: INTERNAL OR

BACKLIT/SILHOUETTE

/10\ TENANT SIGN A:

10 TENANT SIGN B:

architecture interiors planning engineering

7601 Jefferson NE Suite 100 Albuquerque, NM 87109 505 761-9700 fax 761-4222

dps @ dpsdesign.org

#

O. ANY DISTURBED LAND WILL BE SEEDED.

PROJECT

P. BICYCLE AMMENITIES: TENANT WILL PROVIDE BICYCLE STORAGE WITHIN THE 60 Q. ALL CURBS WILL BE DESIGNED AND BUILT ACCORDING TO THE CITY OF

ALBUQUERQUE STANDARDS. CURBS WILL ALSO BE DESIGNED TO IRRIGATE LANDSCAPE MEDIANS WHEREVER POSSIBLE TO REDUCE SURFACE RUN-OFF.

PA R. ALL LIGHTING SHALL COMPLY TO ADMINISTRATIVE AMENDMENT L. THERE ARE NO PEDESTRIAN TRAILS CURRENTLY LOCATED IN THE VICINITY. A \_Project #<u>1 004872</u> FUTURE TRAIL MAY BE LOCATED ON THE WEST SIDE OF UNIVERSITY BOULEVARD. Orientation of buildings

changed From University Blud. to internal Street X Vusel 18. APPROVED BY DATE

PROJECT NUMBER: **EPC Site Development Plan-Building Permit APPLICATION NUMBER:** 

Is an Infrastructure List Required? (x) Yes () No If yes, then a set of approved DRC plans with a work order is required for any construction within Public Right-of-Way or for construction of public

## DRB SITE DEVELOPMENT PLAN APPROVAL:

TRAFFIC ENGINEER, TRANSPORTATION DIVISION DATE UTILITIES DIVISION DATE PARKS AND RECREATION DEPARTMENT DATE CITY ENGINEER DATE SOLID WASTE MANAGEMENT DATE DRB CHAIRPERSON, PLANNING DEPARTMENT

Employment (BUILDING #2 Albuquerq REVISIONS 1 10/03/06 DRB SUBMITTAL DRAWN BY REVIEWED BY DATE PROJECT NO. DRAWING NAME SITE PLAN FOR BUILDING PERMIT

1" = 1000'-0"

SHEET NO.

SZ

MB

06002

2 OF 8

VICINITY MAP ENCLOSURE SECTION Q-16 AND Q-17

1" = 40'-0"