

### VICINITY MAP (J-14)



NO SCALE

DOC# 2007170724

12/20/2007 01:40 PM Page: 1 of 2 PLAT R:\$12.00 B: 2007C P: 0349 M. Toulouse, Bernalillo County 

COUNTY CLERK RECORDING LABEL HERE

#### DESCRIPTION

Lots numbered Nineteen (19), Twenty, (20). Twenty—one (21), Twenty—two (22), Twenty—three (23, Twenty—four (24) and Twenty—five (25) in Block numbered Two (2) of the Ives Addition, to the City of Albuquerque, New Mexico, as the same are shown and designated on the Plat of said Addition, filed in the office of the County Clerk of Bernalillo County, New Mexico, on February 7, 1923, in Plat Book C2, Folio 34.

#### FREE CONSENT

The platting of the property as described above is with the free consent and in accordance with the desires of the undersigned owners. Said owners warrant that they hold complete and indefeasible title in fee simple to the land subdivided.

10 OCT.07

lan Ford, Clerk of the Albuquerque Monthly Meeting, Owning Entity

**ACKNOWLEDGMENT** STATE OF NEW MEXICO ) COUNTY OF BERNALILLO ) ss

On this day of October, 2007, the foregoing instrument was acknowledged before me by Ian Ford, Clerk of the Albuquerque Monthly Meeting

1/19/2011

#### SUBDIVISION DATA

- 1. DRB Proj. No.
- 2. Zone Atlas Index No. J-14

Carried of Proof of the Contract of the Stage of the stage

- 3. Current Zoning S-R
- 4. Gross acreage 0.5660 Ac.
- 5. Existing number of platted lots 7 Replatted number of lots

LOG NO. 2007401853

### NOTES

- 1. Bearings shown on this plat are New Mexico State Plane Grid, Central Zone, NAD 1927. Bearings and distances in parenthesis are from existing plat.
- 2. Perimeter distances are field measurements made on the ground.
- 3. Monuments recovered and accepted or reset are noted on inscribed plat.
- No property within the area of requested final action shall at any time be subject to a deed restriction, covenant, or binding agreement prohibiting solar collectors from being installed on buildings or erected on the lots or parcels within the area of proposed plat. The foregoing requirement shall be a condition to approval of this plat or site development plan for subdivision.

PURPOSE OF PLAT

This plat has been prepared for the purposes of creating one lot from seven.

FOR BERNALILLO COUNTY TREASURER'S OFFICE USE ONLY THIS IS TO CERTIFY THAT TAXES ARE CURRENT AND PAID ON UPC# 1 014 058 227 470 23901, 1 014 058 231 480 23912 PROPERTY OWNER OF RECORD: ALBUQUERQUE MONTHLY MEETING RELIGIOUS SOCIETY, INC.

BERNALILLO COUNTY TREASURER'S OFFICE

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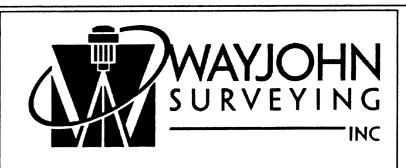
SURVEYOR'S CERTIFICATE

I. Thomas D. Johnston, licensed as a Professional Surveyor under the laws of the State of New Mexico, do hereby certify that this plat was prepared by me or under my supervision, that I am responsible for this plat, that it shows all easements of the recorded plat and made known to me by the title company, utility companies or by the owner of record, meets the minimum standards for monumentation and surveys of the Albuquerque Subdivision Ordinance, and meets the Minimum Standards for Land Surveys as adopted by the New Mexico State Board of Registration for Professional Engineers and Surveyors, effective May 1, 2007 and is true and correct to the best of my knowledge and belief.

homas D. Johnston, N.M.P.S. No. 14269

10.08.05 Date





330 LOUISIANA BLVD., N.E. ALBUQUERQUE, N.M. 87108 PHONE: (505) 255-2052 FAX: (505) 255-2887

INDEXING INFORMATION FOR COUNTY OWNER: ALBUQUERQUE MONTHLY MEETING LOCATION: SEC. 17 T.10 N., R.3 E., N.M.P.M. IVES ADDITION

SCALE: FILE NO. DRAWN: TRJ 1" = 20'SP-9-02-2005 CHECKED: TDJ DRAWING NO. SHEET 1 OF 2 5 OCT 2007 SP90205C.DWG

# PLAT OF LOT 19-A BLOCK 2 IVES ADDITION

A REPLAT OF LOTS 19, 20, 21, 22, 23, 24 & 25, BLOCK 2, IVES ADDITION

WITHIN PROJECTED SECTION 17, T.10N., R.3E., N.M.P.M. TOWN OF ALBUQUERQUE GRANT

ALBUQUERQUE, BERNALILLO COUNTY, NEW MEXICO

OCTOBER 2007


1004075

Chairperson, Planning Department

12-19-07

12/19/07

12/19/07

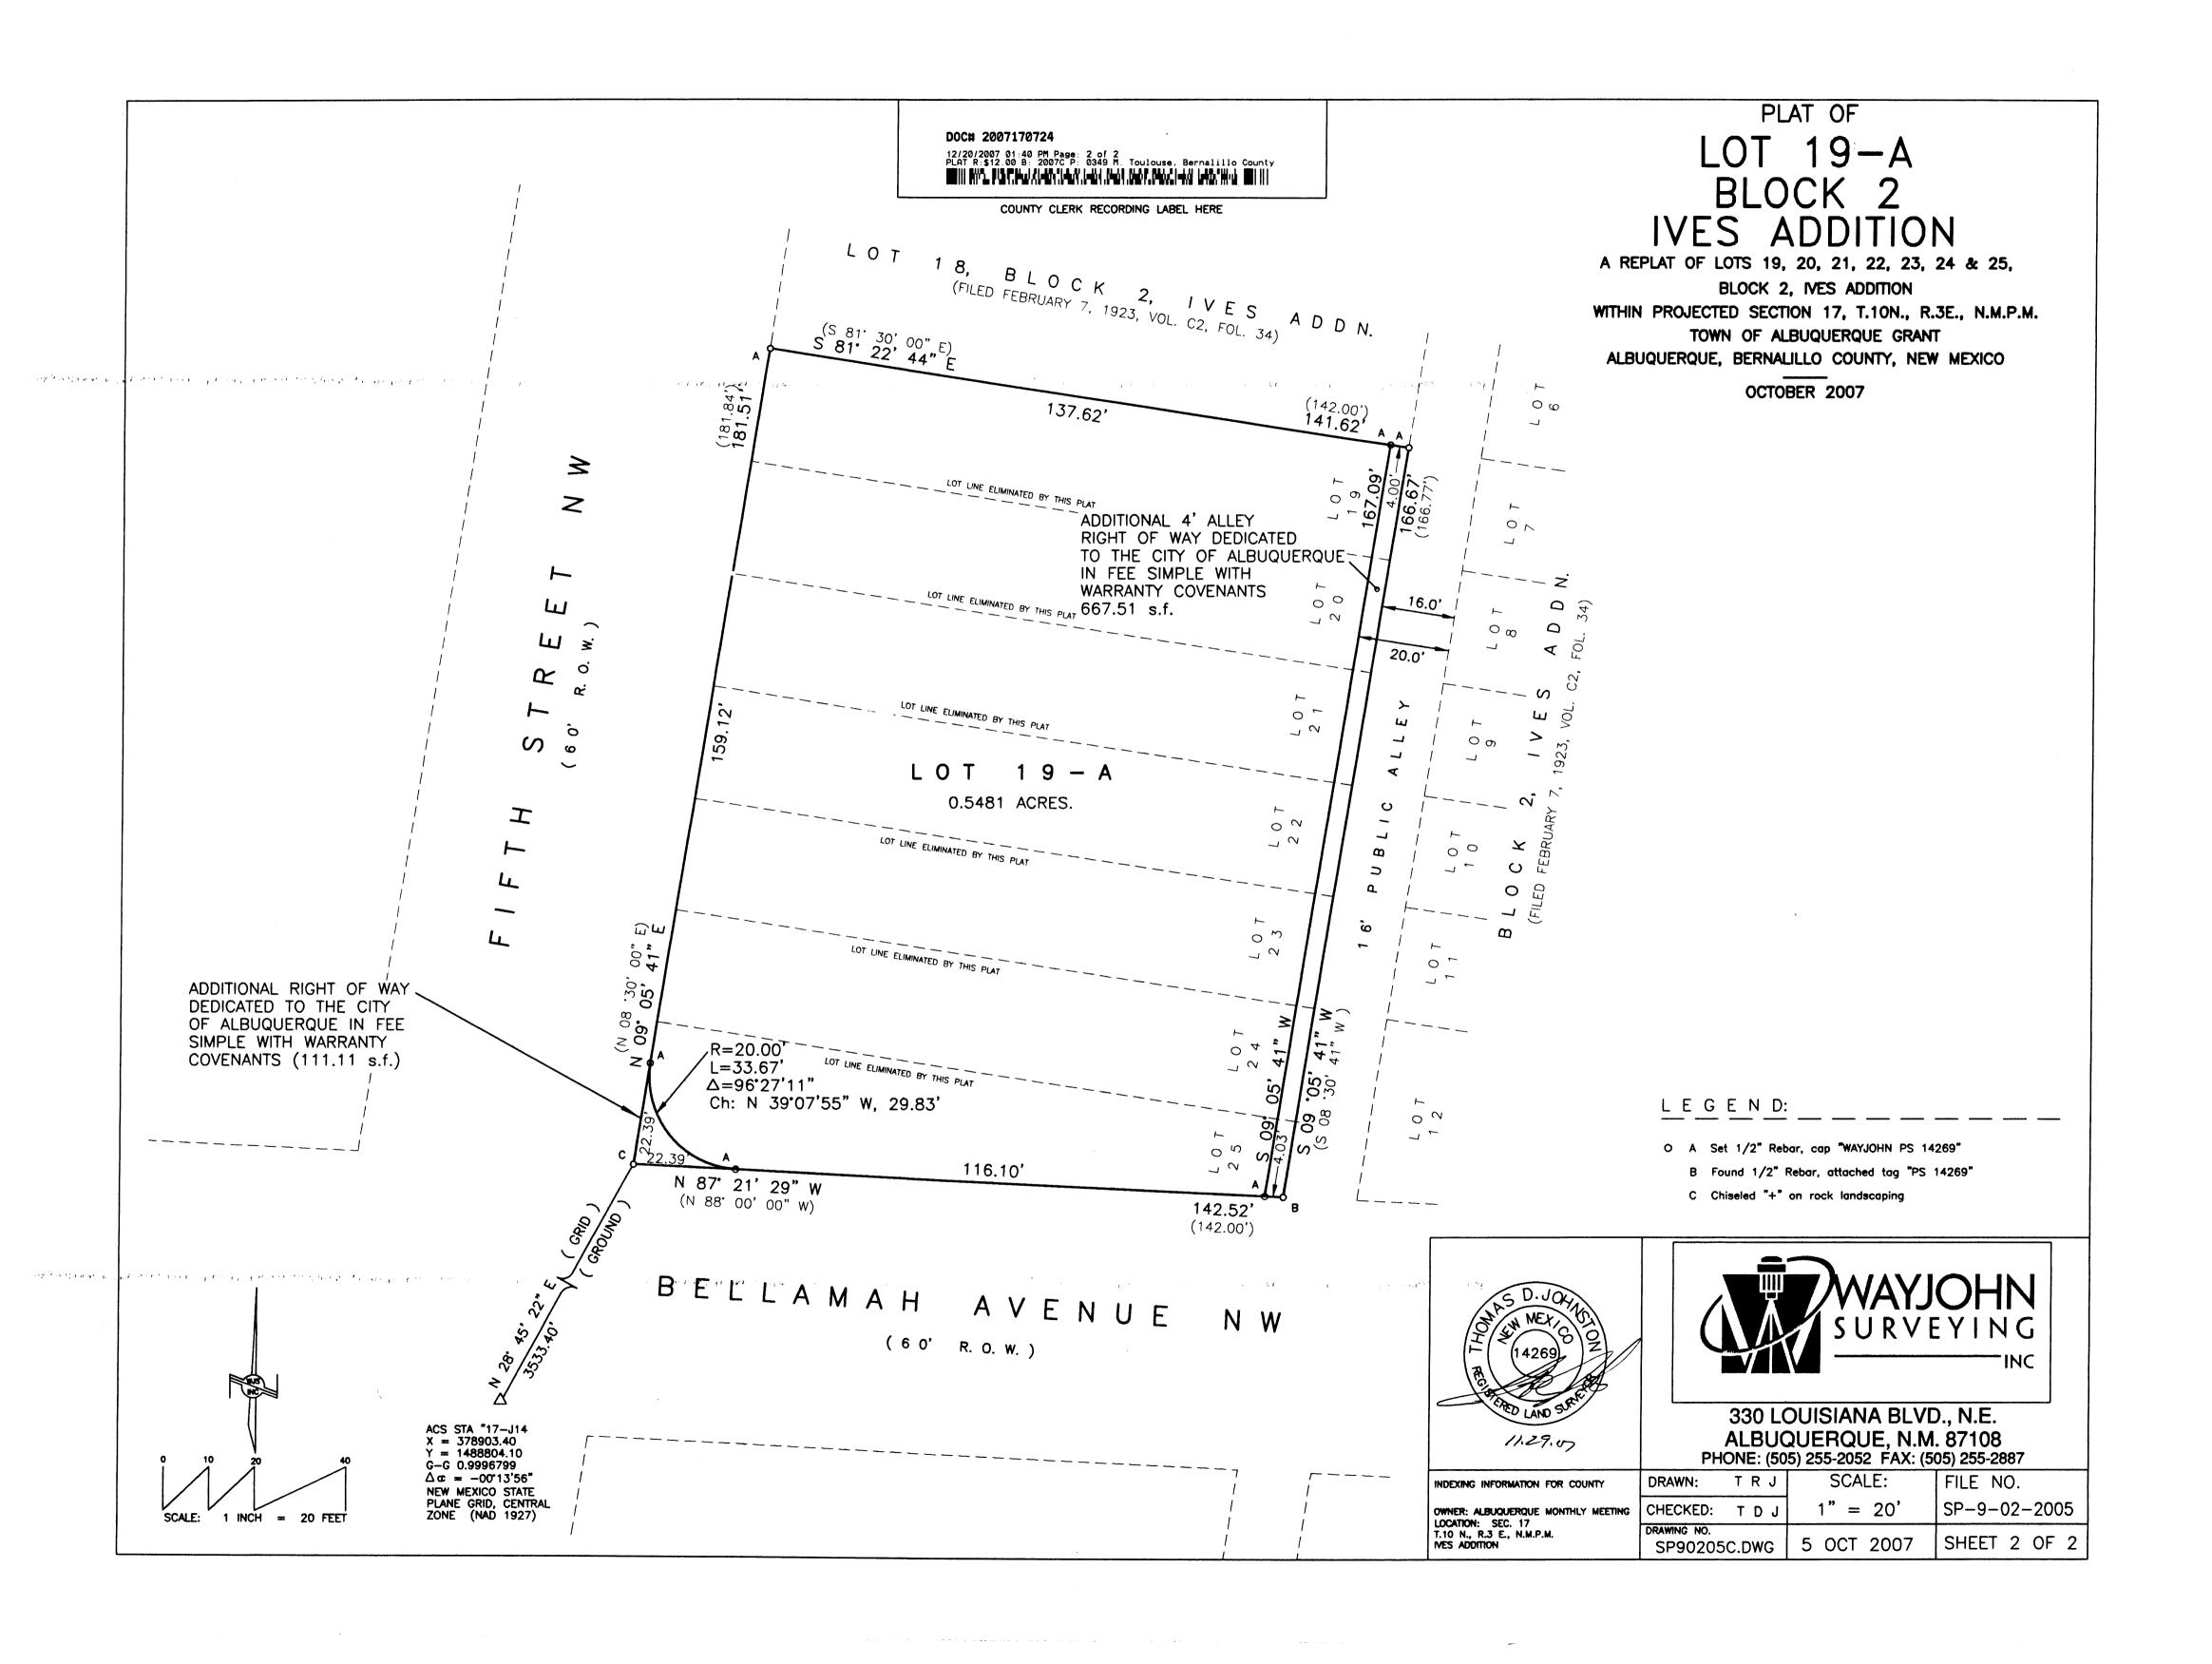

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NO SCALE

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  Replatted number of lots 1

LOG NO. 2007401853

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FOR BERNALILLO COUNTY TREASURER'S OFFICE USE ONLY
THIS IS TO CERTIFY THAT TAXES ARE CURRENT AND PAID ON
UPC# 1 014 058 227 470 23901, 1 014 058 231 480 23912
PROPERTY OWNER OF RECORD:
ALBUQUERQUE MONTHLY MEETING RELIGIOUS SOCIETY, INC.

BERNALILLO COUNTY TREASURER'S OFFICE

COUNTY CLERK RECORDING LABEL HERE

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Ian Farl

10 OCT.07

Date

lan Ford, Clerk of the Albuquerque Monthly Meeting, Owning Entity

Date

ACKNOWLEDGMENT


STATE OF NEW MEXICO )
COUNTY OF BERNALILLO ) ss

On this day of October, 2007, the foregoing instrument was acknowledged before me by Ian Ford, Clerk of the Albuquerque Monthly Meeting

My Commission expires

1/19/2011

Notary Public

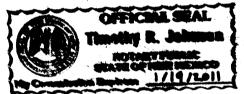

LOT 19-A
BLOCK 2

BLOCK 2 IVES ADDITION

A REPLAT OF LOTS 19, 20, 21, 22, 23, 24 & 25, BLOCK 2, IVES ADDITION

WITHIN PROJECTED SECTION 17, T.10N., R.3E., N.M.P.M.
TOWN OF ALBUQUERQUE GRANT

OCTOBER 2007 PRELIMINARY PLAT

APPROVED BY DRB

tion Number:	<u> </u>	
provals:	10-11-07	
City Surveyor	Date	
Traffic Engineering, Transportation Division	Date	
ABCWUA	Date	
Parks and Recrection Department	Date	
AMAFCA	Date	
City Engineer	Date	
DRB Chairperson, Planning Department	Date	

#### SURVEYOR'S CERTIFICATE


PROJECT NUMBER:

I, Thomas D. Johnston, licensed as a Professional Surveyor under the laws of the State of New Mexico, do hereby certify that this plat was prepared by me or under my supervision, that I am responsible for this plat, that it shows all easements of the recorded plat and made known to me by the title company, utility companies or by the owner of record, meets the minimum standards for monumentation and surveys of the Albuquerque Subdivision Ordinance, and meets the Minimum Standards for Land Surveys as adopted by the New Mexico State Board of Registration for Professional Engineers and Surveyors, effective May 1, 2007 and is true and correct to the best of my knowledge and belief.

Thomas D. Johnston, N.M.P.S. No. 14269

10.08.05

MEXICO LAND SERVED LAND SERVED

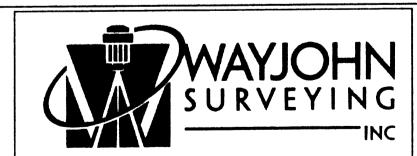

330 LOUISIANA BLVD., N.E. ALBUQUERQUE, N.M. 87108 PHONE: (505) 255-2052 FAX: (505) 255-2887

OWNER: ALBUQUERQUE MONTHLY MEETING LOCATION: SEC. 17
T.10 N., R.3 E., N.M.P.M.

IVES ADDITION

DRAWN: T R J SCALE:


CHECKED: T D J 1" = 20'


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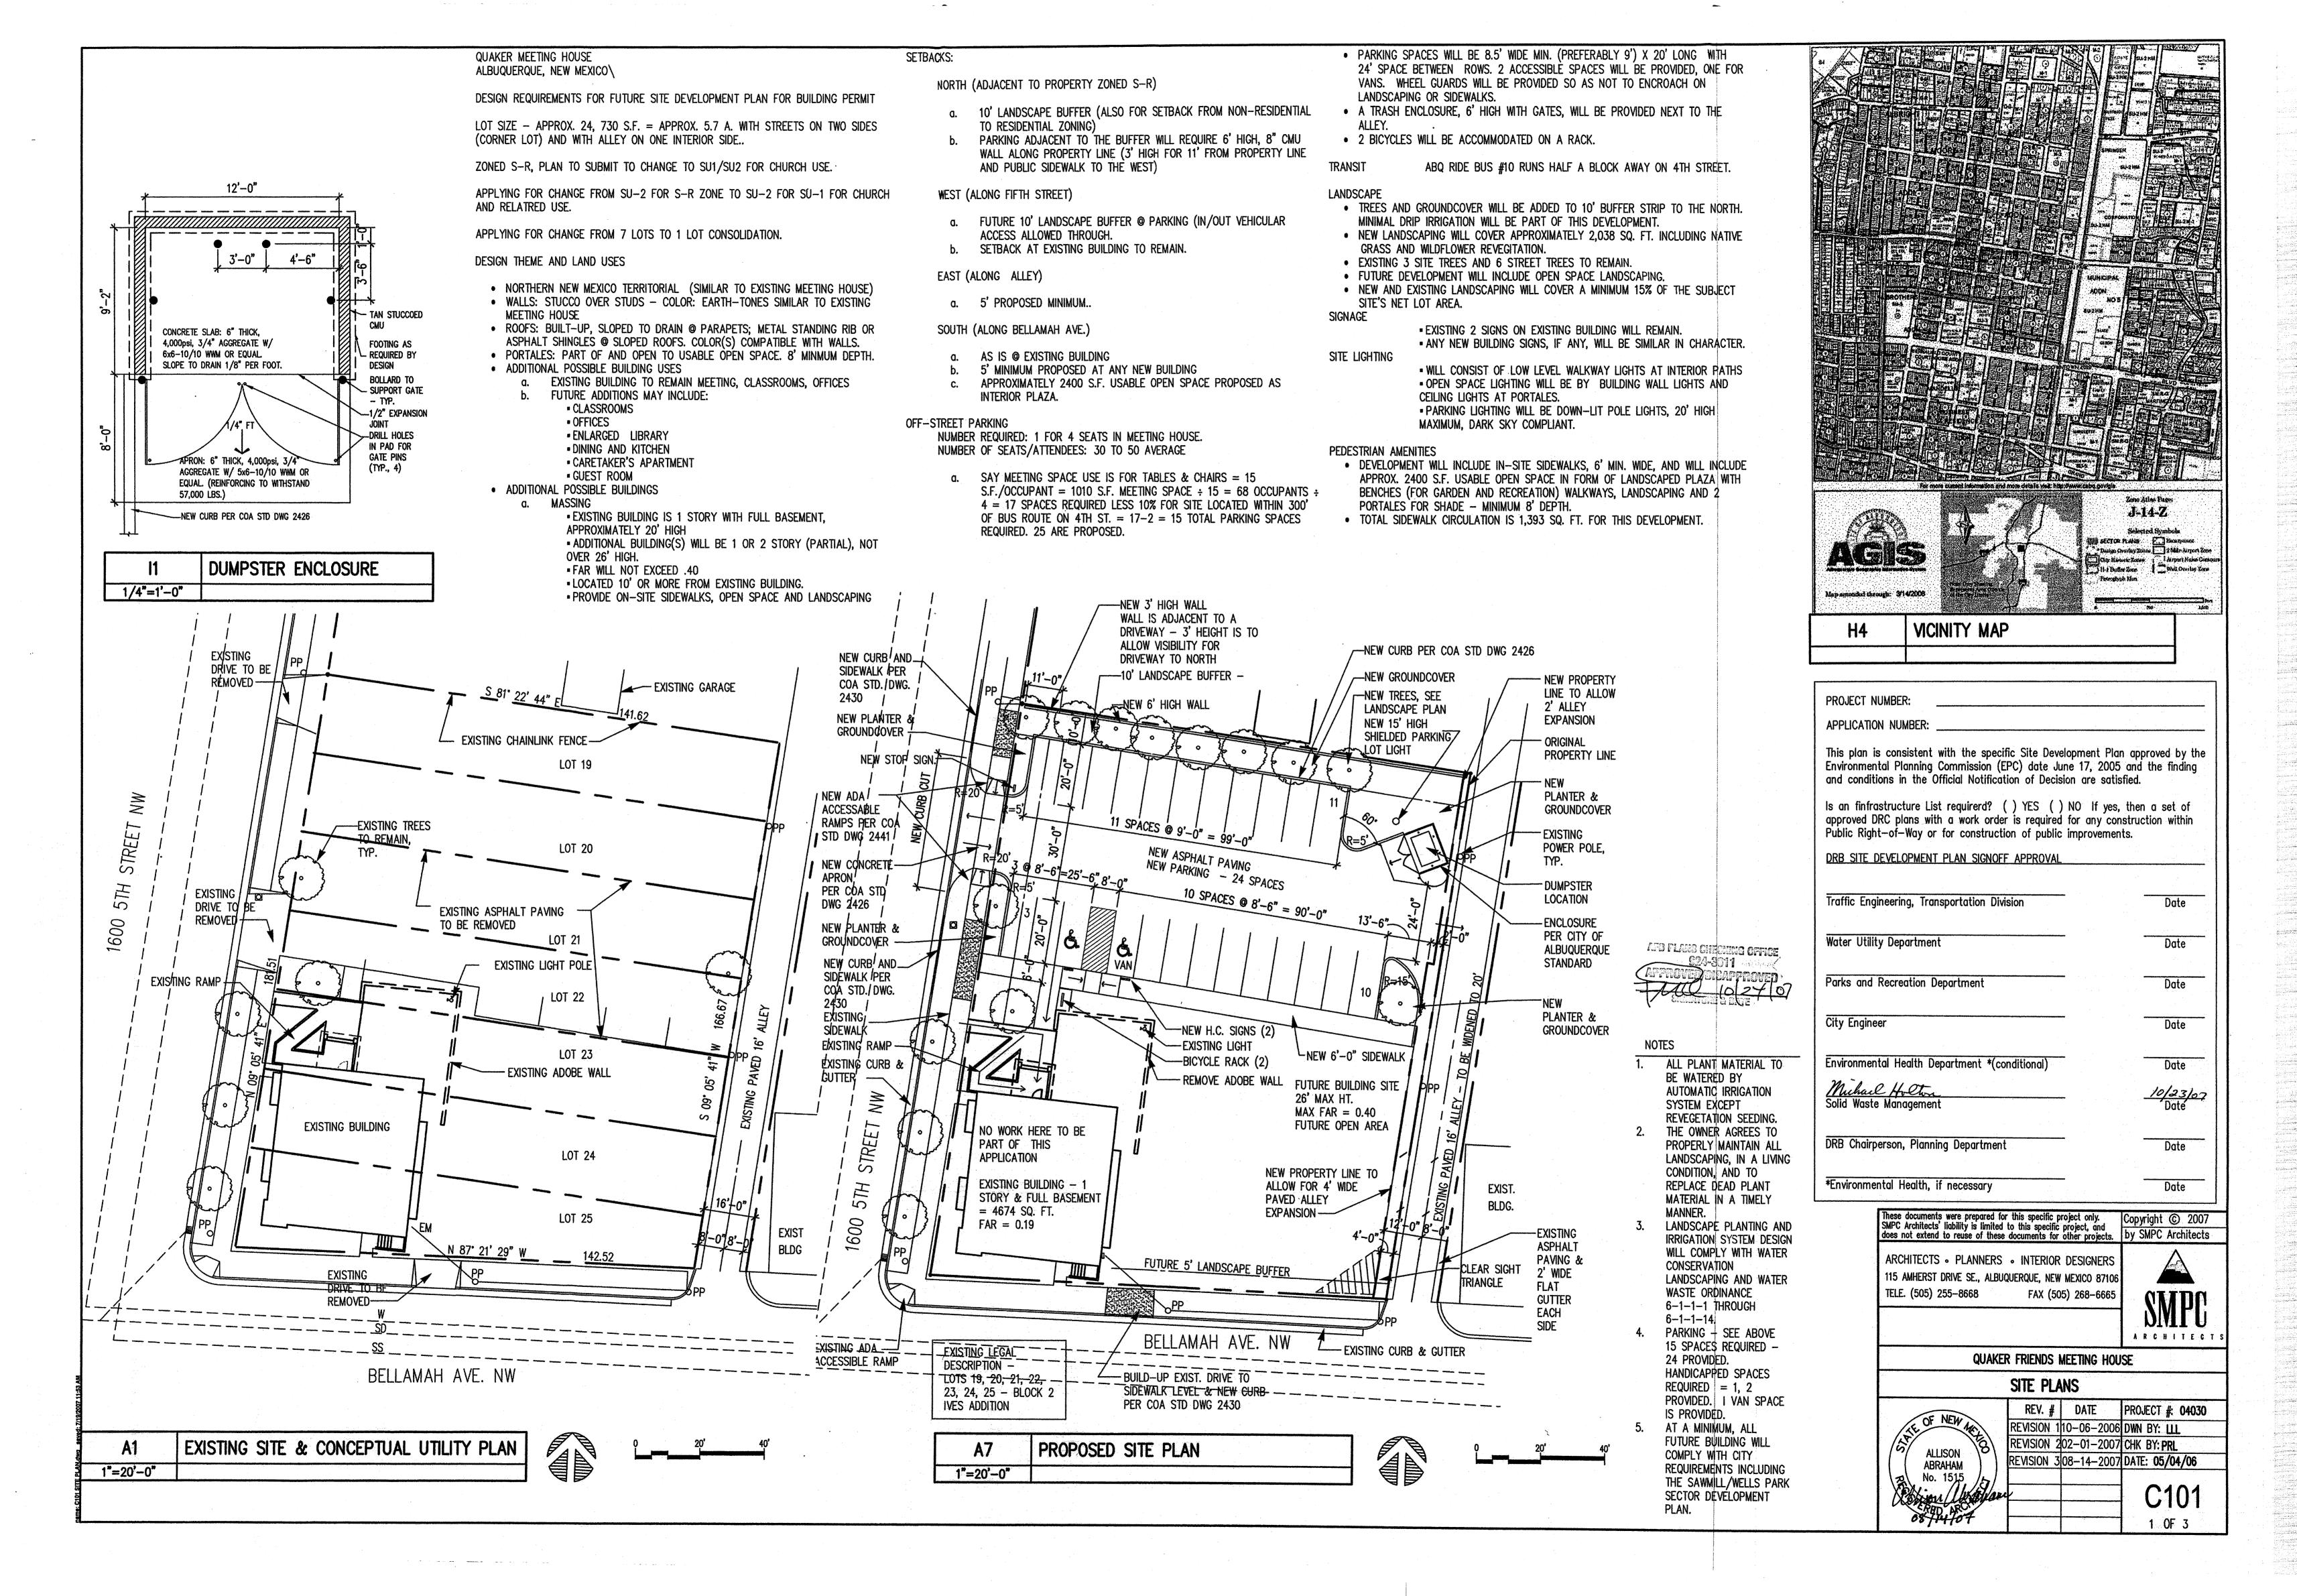
SP90205C.DWG 5 OCT 2007


SP-9-02-2005 SHEET 1 OF 2


FILE NO.



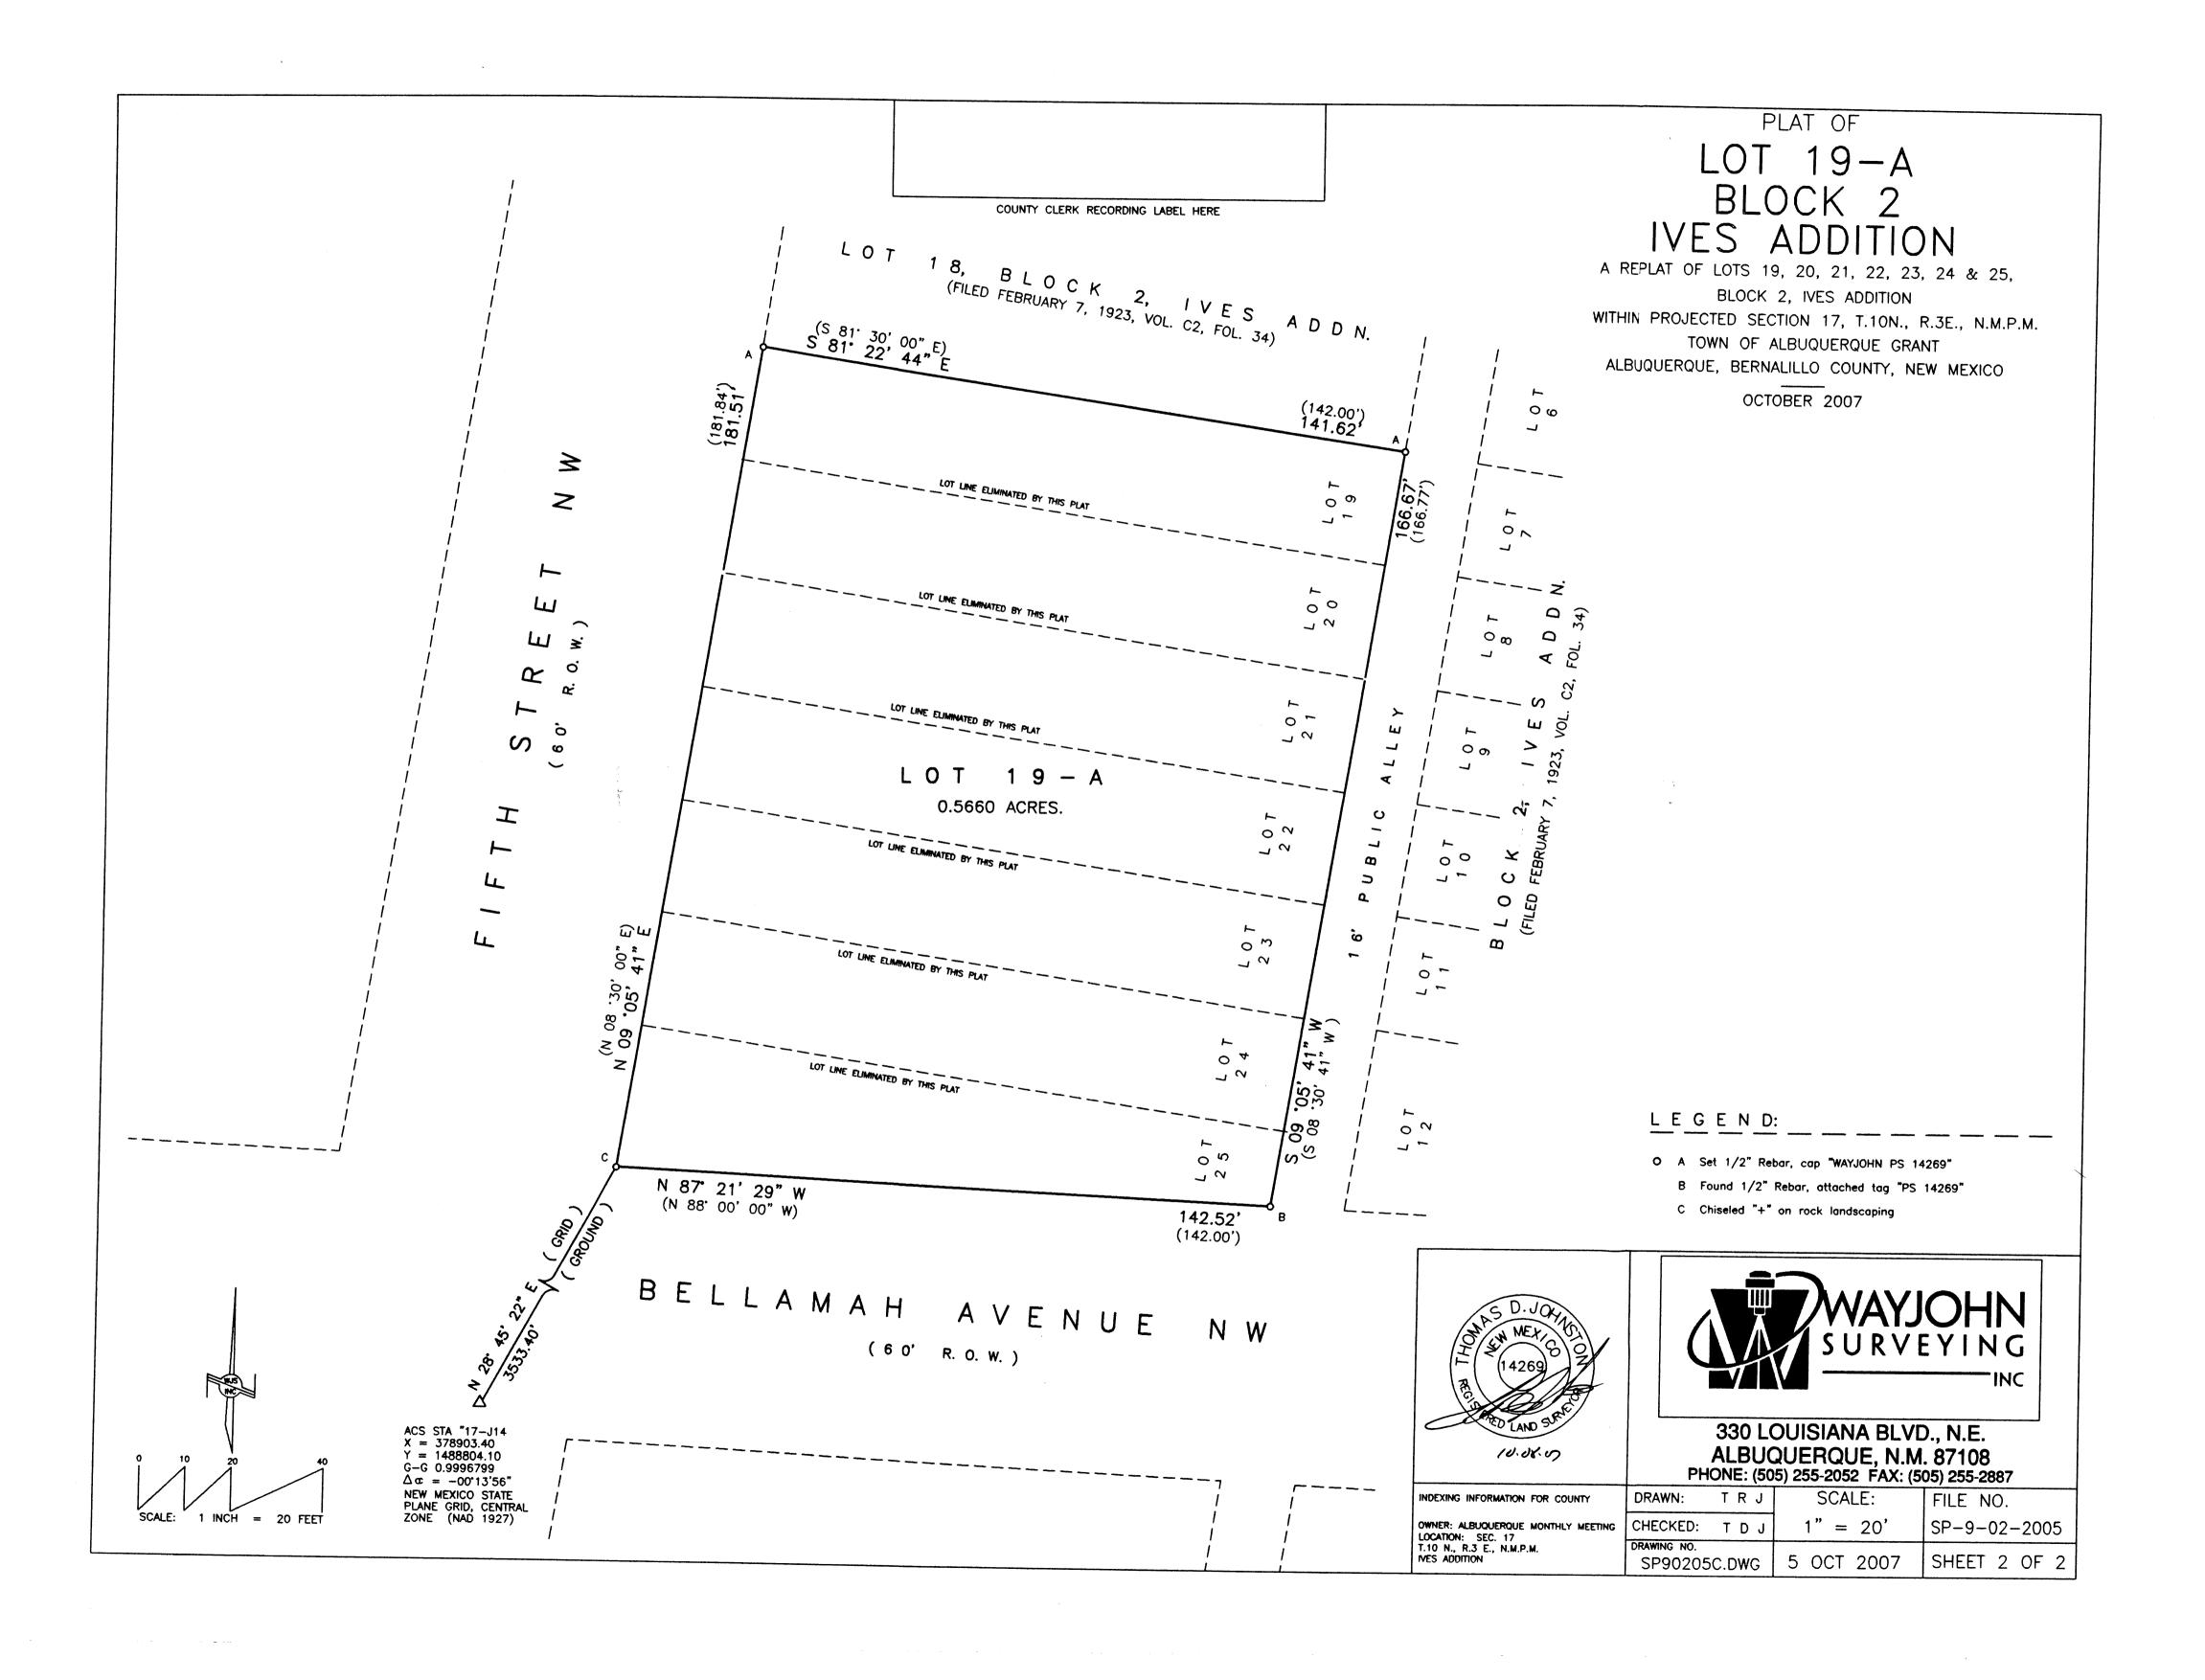

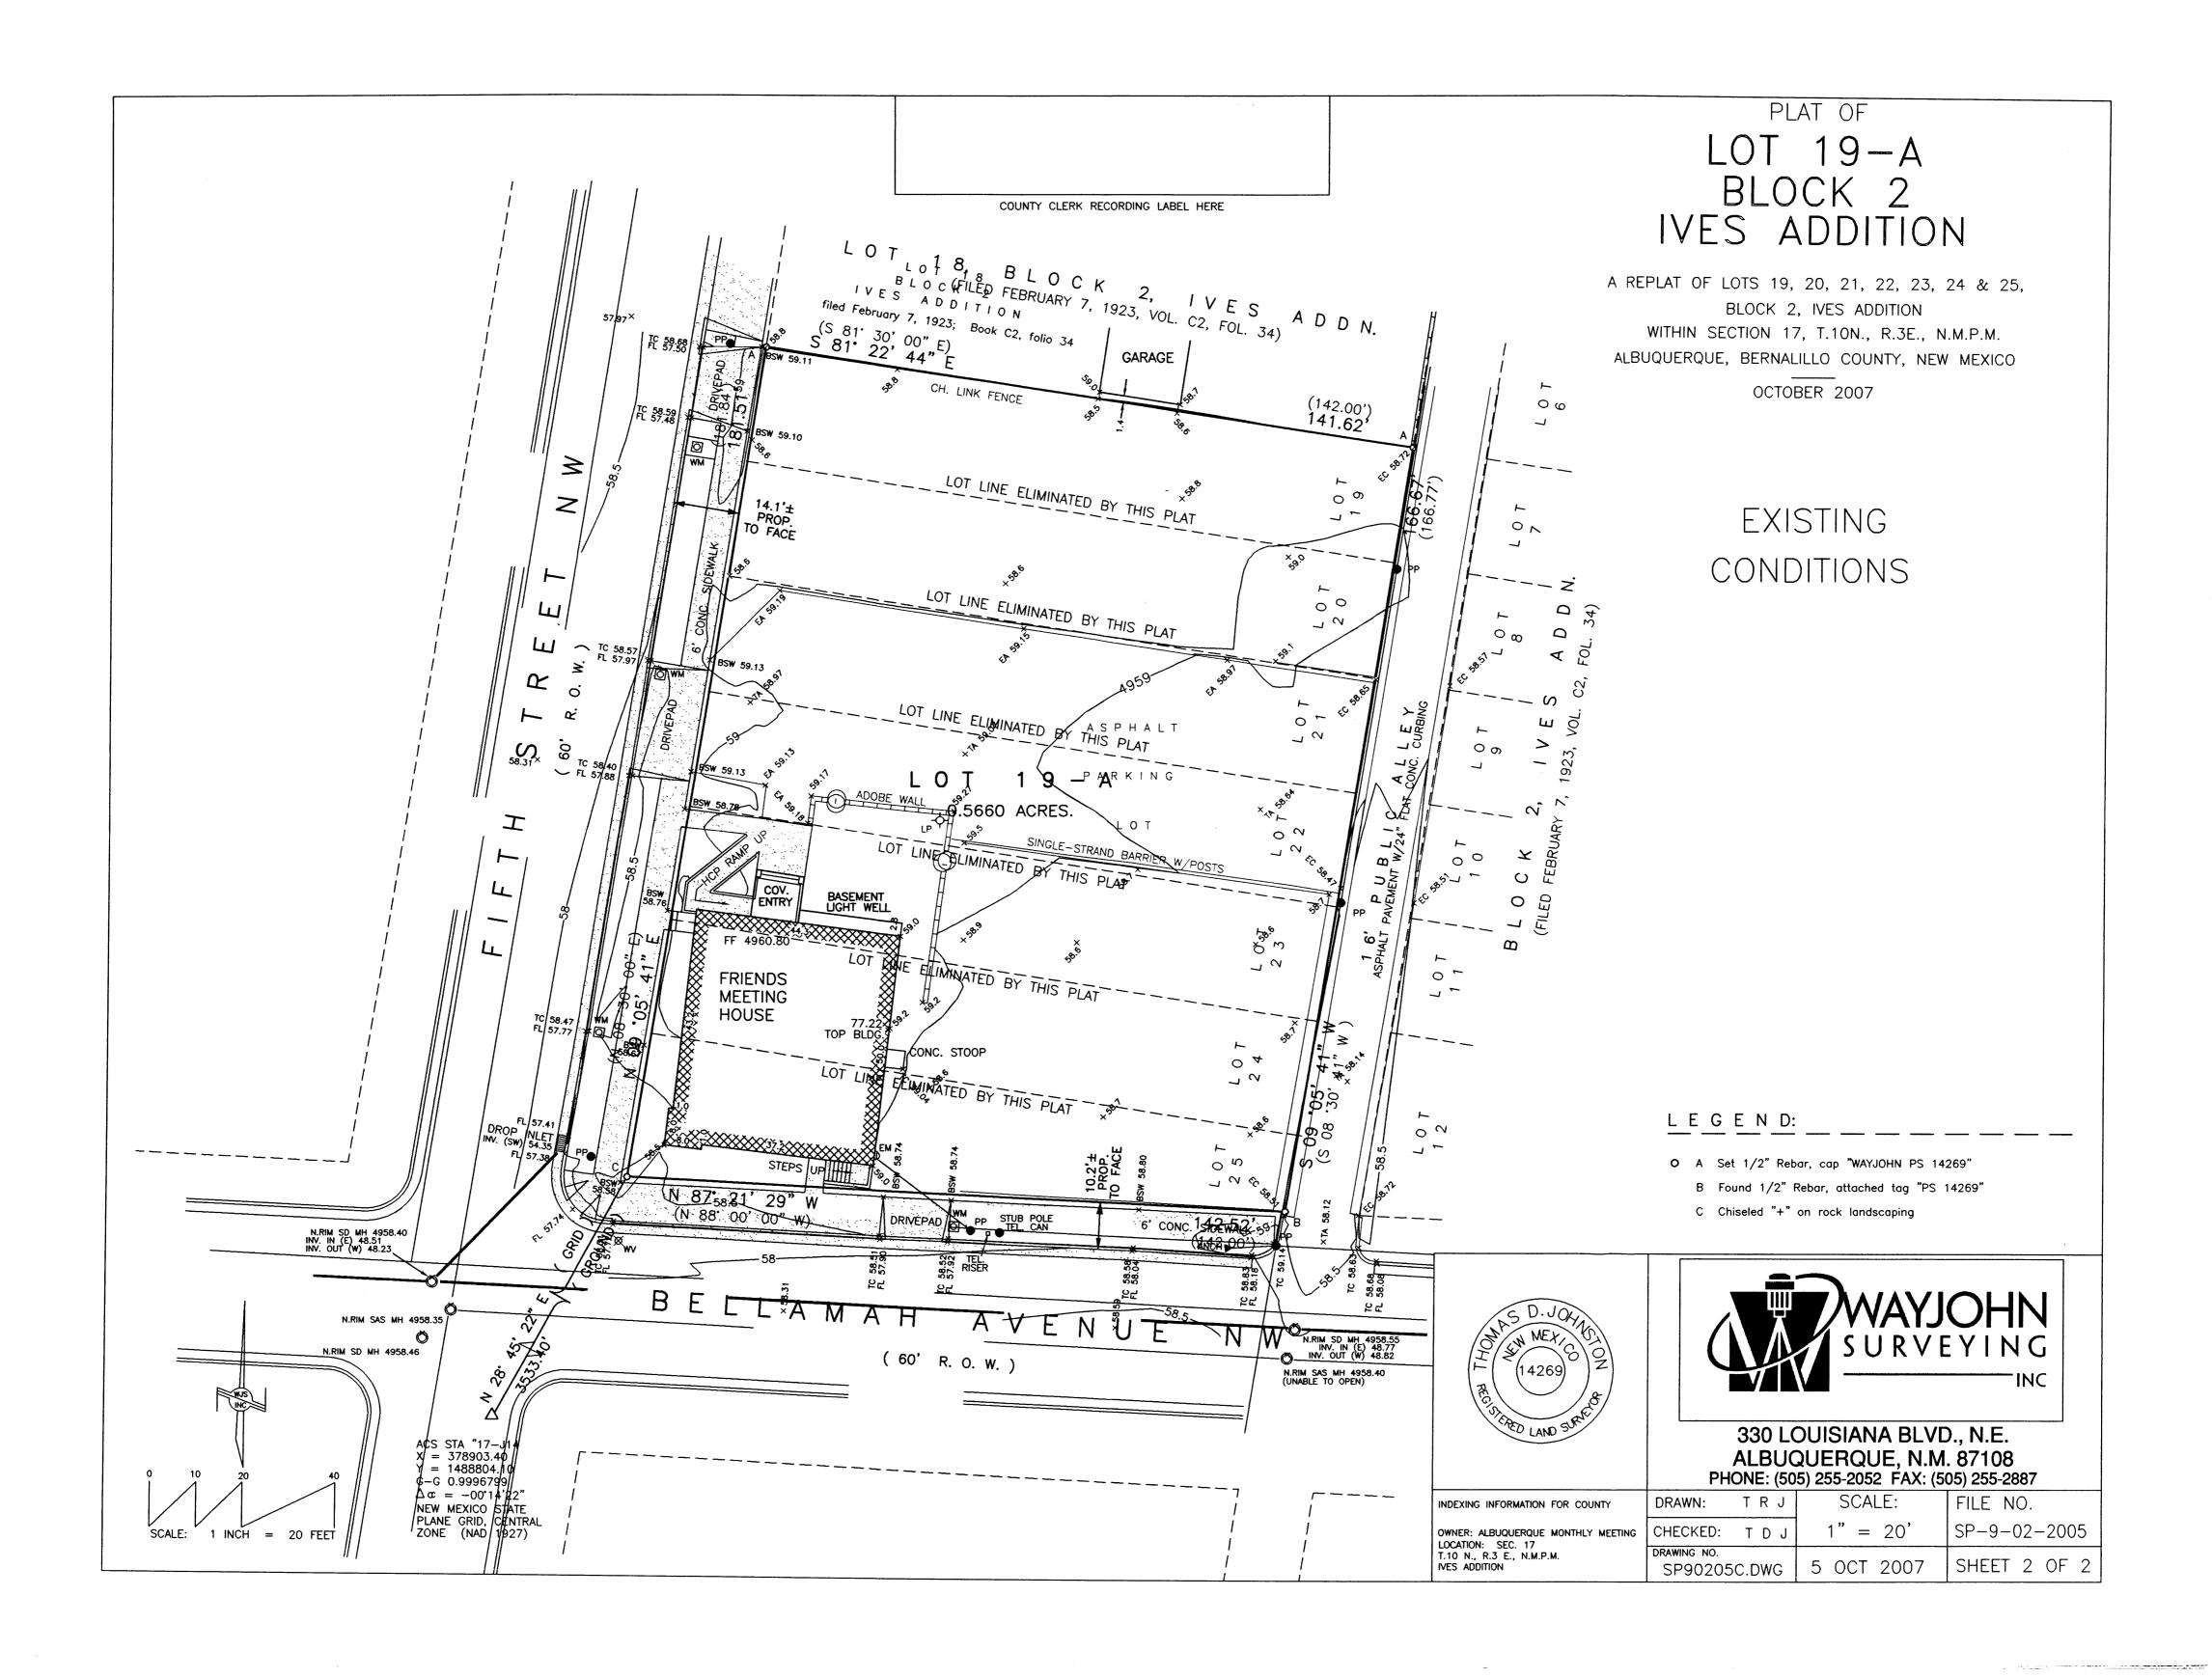

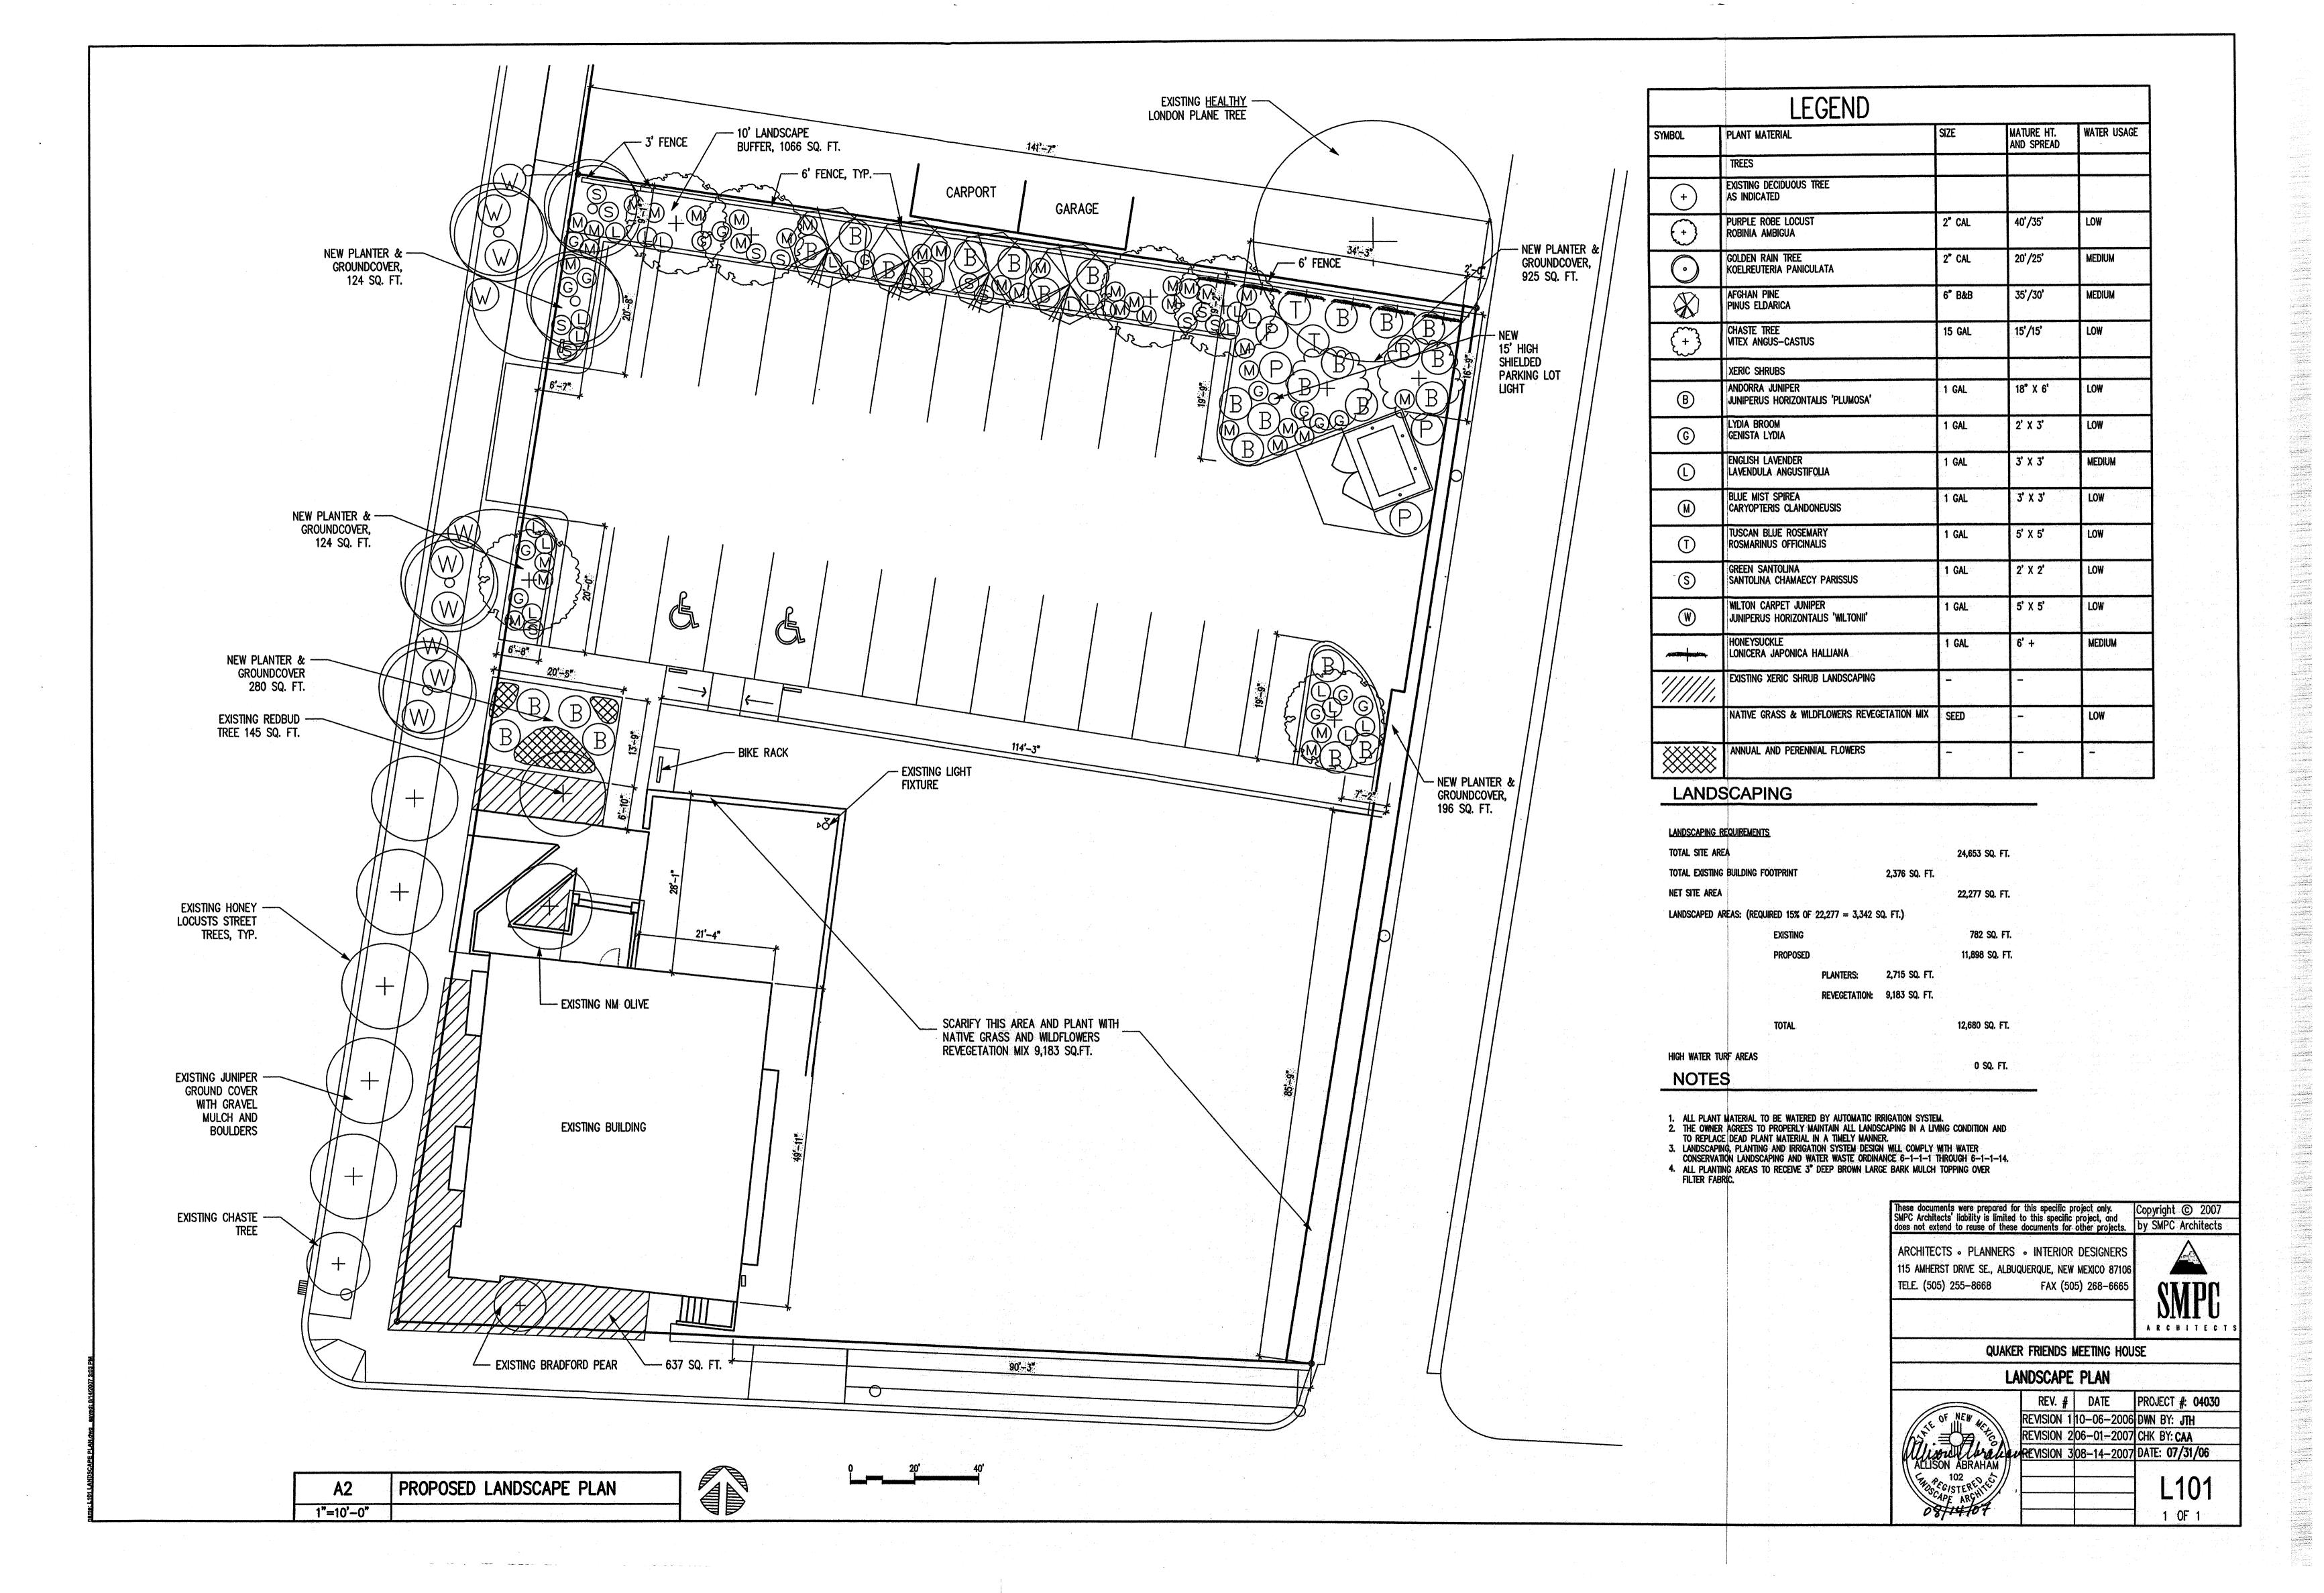


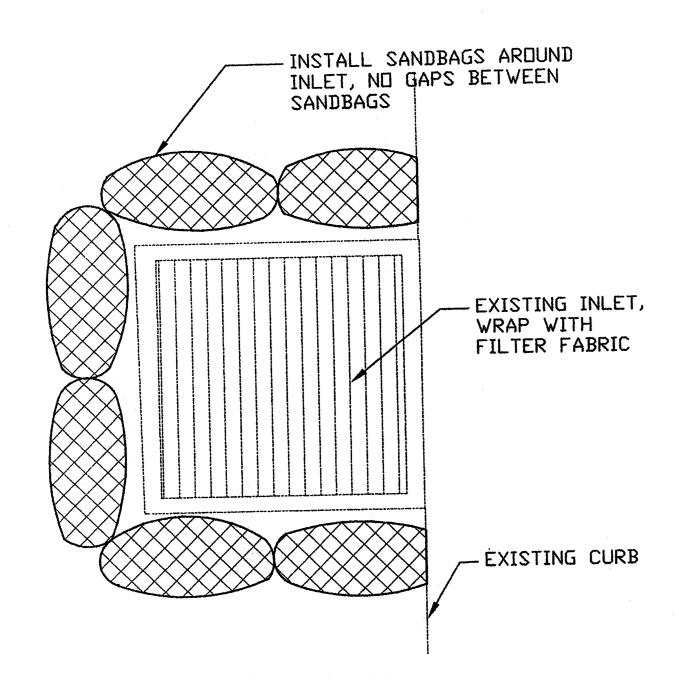

# INLET PROTECTION REQUIREMETS

# SANDBAGS:


- SANDBAGS SHALL CONSIST OF A WOVEN POLYPROPYLENE
- FABRIC SEWN TOGETHER WITH DOUBLE STITCHING.
   OVERALL SIZE OF THE SANDBAG SHALL BE AT LEAST 14 X 26 INCHES.
- THE GEOTEXTILE SHALL BE MnDOT TYPE I (PERMEABLE
- FABRICS) OR EQUIVALENT.
   NO GAPS SHALL BE PLACED BETWEEN SANDBAGS.

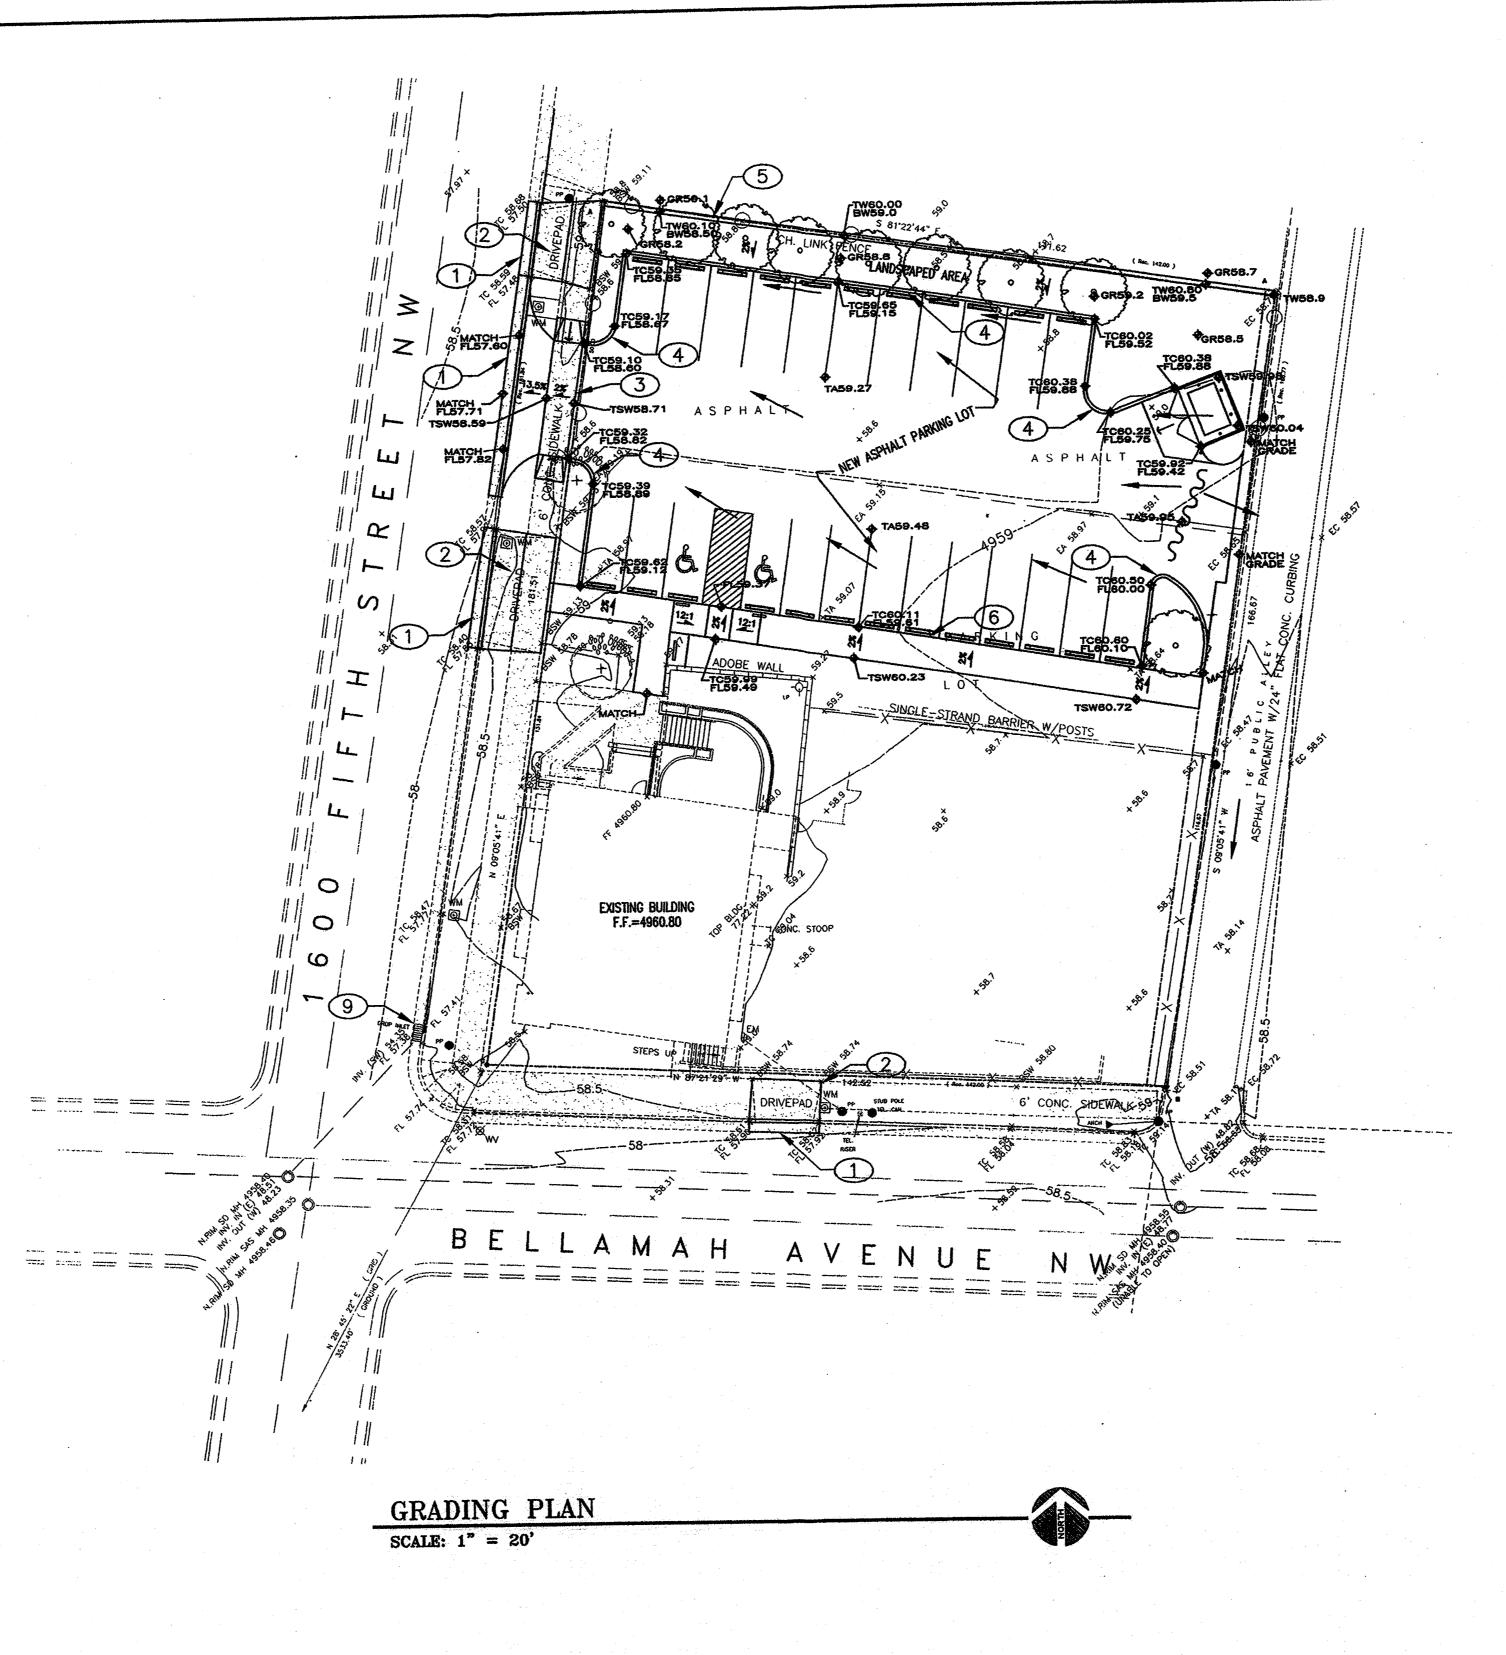



LEGEND				
5360 NE	EW CONTOUR GRADE	~~	NEW GRADE BREAK	
5362 B	KISTING CONTOUR GRADE	X 'stagk	EXISTING GRADE ELEVATION	
OI	rainage flow direction	<b>♦</b> GR56.0	NEW GRADE ELEVATION	
♦ TC62.50 NE	EW TOP OF CURB ELEVATION	♦ FL55.3	FLOWLINE GRADE ELEVATION	
♦ FL62.00 NE	W FLOWLINE OF CURB ELEVATION	<b>♦</b> TW95.1	NEW TOP OF WALL ELEVATION	
♦ TA60.11 NE	EW TOP OF ASPHALT ELEVATION	<b>♦</b> BW93.1	NEW BOTTOM OF WALL ELEVATION	
♦ TSW61.87 N	EW TOP OF SIDEWALK ELEVATION	♠ TOC93.1	1 NEW TOP OF CONCRETE ELEVATION	

# CONSTRUCTION NOTES:

- 1 APPROXIMATE LIMITS OF CURB AND GUTTER REMOVAL AND REPLACEMENT LIMITS, RECONSTRUCT PER CITY STD. DWG. 2415A WITH STANDARD CURB AND GUTTER.
- 2 REMOVE EXISTING DRIVEWAY AND CONSTRUCT 6' WIDE SIDEWALK PER CITY STD. DWG. 2430.
- REMOVE EXISTING SIDEWALK AND CONSTRUCT DRIVEWAY PER CITY STD. DWG. 2425.
- 4 CONSTRUCT HEADER CURB PER CITY STD. DWG. 2415B.
- 5 CONSTRUCT 1' HIGH TO 2' HIGH RETAINING WALL (SEE STRUCTURAL DRAWINGS).
- 6 CONSTRUCT 6' WIDE SIDEWALK PER CITY STD. DWG. 2430, WITH 10' TURNDOWN ALONG ASPALT PAVEMENT EDGE.
- 7 NOT USED.
- (8) NOT USED.
- 9 EXISTING INLET TO BE PROTECTED FROM SEDIMENT, SEE DETAIL THIS SHEET.

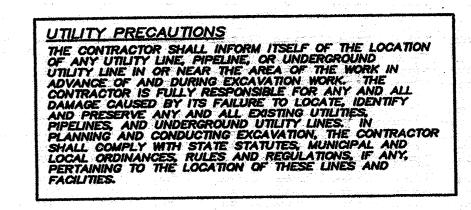

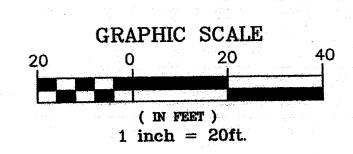

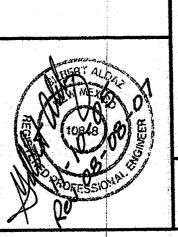

DRAINAGE AND GRADING PLAN FOR QUAKER BUILDING at 1600 FIFTH STREET NW

ALBUQUERQUE, NEW MEXICO Applied Engineering & Suveying, Inc.

ALBUQUERQUE, NEW MEXICO 87112 PH: (505)237-1456

**DRAINAGE PLAN** 

THE FOLLOWING ITEMS CONCERNING THE EXPANSION OF THE QUAKER BUILDING AT 1600 FIFTH STREET NW. ALBUQUERQUE, NEW MEXICO, GRADING AND DRAINAGE PLAN ARE CONTAINED HEREON:

1. DRAINAGE CALCULATIONS

2. VICINITY MAP (J-14)

3. FLOOD INSURANCE RATE MAP 35001C0332D

**EXISTING CONDITIONS** 

AS SHOWN BY THE VICINITY MAP, THE SITE IS LOCATED AT THE NORTHEARST CORNER OF FIFTH STREET NW AND BELLAMAH AVENUE NW AT 1600 FIFTH STREET NW, (SEE ATTACHED VICINITY MAP (J-14). THE PARCEL'S LEGAL DESCRIPTION IS LOTS 19 THROUGH 25, BLOCK NUMBER 2, IVES ADDITION IN THE CITY OF ALBUQUERQUE. THE PROPERTY IS BOUNDED ON THE SOUTH BY BELLAMAH AVENUE, TO THE EAST BY A PUBLIC ALLEY, TO THE WEST BY FIFTH STREET AND TO THE NORTH BY LOT 18. THIS SITE CONTAINS APPROXIMATELY 0.57 ACRES. LOTS 21 THROUGH 25 ARE CURRENTLY DEVELOPED WITH AN EXISTING BUILDING, ASPHALT PAVING PARKING LOT, SIDEWALKS AND LANDSCAPING. LOTS 19 AND 20 ARE CURRENTLY UNDEVELOPED WITH MINIMAL VEGETATION.

THE SITE IS CURRENTLY NOT IN A DESIGNATED 100-YEAR FLOODPLAIN; HOWEVER, BELLAMAH AVENUE AND FIFTH STREET ARE CONSIDERED IN A DESIGNATED 100-YEAR FLOODPLAIN WITH ZONE AO (DEPTH 1 FOOT).

PROPOSED CONDITIONS

AS SHOWN BY THE GRADING PLAN PREPARED FOR THIS SITE, THE INTENT IS TO CONSTRUCT A A NEW PARKING LOT, NEW SIDEWALKS AND ASSOCIATED LANDSCAPING TO MEET CITY ZONING REQUIREMENTS.

THERE IS AN EXISTING STREET DROP INLET LOCATED AT THE SOUTHWEST CORNER OF THIS SITE WHICH IS THE NORTHEAST CORNER OF THE INTERSECTION OF FIFTH STREET NW AND BELLAMAH AVENUE NW. THIS INLET CONNECTS INTO A STORMDRAIN LINE THAT IS IN BELLAMAH AVENUEW NW.

FLOWS FROM THE PARKING LOT WILL SHEETFLOW THROUGH THE PARKING LOT AND INTO FIFTH STREET. THE FLOWS FROM THIS AREA WILL DRAIN NORTH ON FIFTH STREET.

THE CALCULATIONS THAT APPEAR HEREON, ANALYZE BOTH THE EXISTING AND DEVELOPED CONDITIONS FOR THE 100-YEAR, 6-HOUR RAINFALL RUNOFF FOR PEAK FLOWS AND STORM DURATION FOR VOLUME REQUIREMENTS. THE PROCEDURE FOR 40 ACRE AND SMALLER BASINS AS SET FORTH IN THE REVISION OF SECTION 22.7 HYDROLOGY OF THE DEVELOPMENT PROCESS MANUAL, VOLUME 2, DESIGN CRITERIA, DATED JANUARY 1993. THIS D.P.M. PROCEDURE IS USED FOR ANALYZING ONSITE FLOWS.

DOWNSTREAM CAPACITY

BASED ON A REVIEW OF THE EXISTING DEVELOPMENT IT DOES NOT APPEAR THAT THE INCREASED FLOWS DUE TO THE PROPOSED RECONSTRUCTION OF THE EXISTING PARKING LOT SHOULD NOT SIGNIFICANTLY INCREASE THE OFFSITE FLOWS TO DOWNSTREAM PROPERTIES SINCE THIS IS AN INFILL SITE.

**EROSION CONTROL** 

THE CONTRACTOR WILL BE REQUIRED TO MINIMIZE SEDIMENT INTO THE PUBLIC ROADWAYS OR ALLEYS. CONTRACT WILL BE REQUIRED TO PROTECT THE EXISTING INLET WITH SEDIMENT CONTROL MEASURES IN ORDER TO MINIMIZE SEDIMENT FROM ENTERING THIS INLET.

OFFSITE FLOWS

BASED ON A FIELD VISIT OF THE SITE AND REVIEW OF THE TOPOGRAPHIC SURVEY IT APPEARS THAT NO OFFSITE FLOWS ENTER THIS PROPERTY.

### DRAINAGE CALCULATIONS

1. PRECIPITATION ZONE = 2

2. DESIGN STORM = DEPTH (INCHES) AT 100-YEAR STORM

6-HOUR = 2.35 INCHES 24-HOUR = 2.75 INCHES 10 DAY = 3.95 INCHES

3. PEAK DISCHARGE (CFS/ACRE) FIR 100-YEAR, ZONE 2, TABLE A-9:

Q = 1.56 CFS/ACRE SOIL UNCOMPACTED "A" Q = 2.28 CFS/ACRE LANDSCAPED "B" Q = 3.14 CFS/AC COMPACTED SOIL "C"

Q = 4.70 CFS/ACRE IMPERVIOUS AREA "D" FOR WATERSHEDS LESS THAN OR EQUAL TO 40 ACRES

4. EXCESS PRECIPITATION, E (INCHES), 6 HOUR STORM, ZONE 2, TABLE A-8:

E = 0.53 INCHES SOIL UNCOMPACTED "A"

E = 0.78 INCHES LANDSCAPED "B" E = 1.13 INCHES COMPACTED SOIL "C"

E = 2.12 INCHES IMPERVIOUS AREA 'D"

5. EXISTING CONDITIONS ONSITE

**EXISTING TOTAL AREA OF SITE = 0.57ACRES** EXISTING BUILDING SITE AREA = 2,260SF = 0.05ACRES EXISTING SIDEWALKS AND PAVING AREA = 486SF + 6.540SF

= 7.026SF = 0.16ACRES

TREATMENT "D" AREA = 0.05 + 0.16ACRES = 0.21ACRES REMAINING AREA IS COMPACTED BY HUMAN ACTIVITY = 0.57ACRES - 0.21 = 0.36ACRES

TREATMENT "C" AREA = 0.36ACRES

TREATMENT 0.36 0.21

 $Q(EXISTING-6HR) = (3.14 \times 0.36) + (4.70 \times 0.21)$ = 2.12CFS (6HR) EXISTING ONSITE FLOW  $V(EXISTING-6HR) = ((1.13 \times 0.36) + (2.12 \times 0.21))/12)$ = 0.07AC-FT = 3,093CF EXISTING ONSITE VOLUME 6. PROPOSED CONDITIONS ONSITE:

PROPOSED NEW SIDEWALKS AND PARKING LOT AREA = 1,885SF - 129SF + 7,923SF + 130SF = 9,809SF = 0.23ACRES

TOTAL IMPERVIOUS AREA PROPOSED WITH EXISTING BUILDING & SIDEWALKS = 0.23AC + 0.06 = 0.29ACRES

TREATMENT "D" AREA = 0.29ACRES TREATMENT "B" AREA = 0.05ACRES TREATMENT "C" AREA = 0.23ACRES


AREA(ACRES)

0.05 0.23

Q(PROPOSED-6HR) =  $(2.28 \times 0.05) + (3.14 \times 0.23) + (4.74 \times 0.29)$ = 2.20CFS (6HR) PROPOSED ONSITE FLOW V(PROPOSED-6HR) = ((0.78 X 0.05) + (1.13X0.23) + (2.1: X 0.29))/ 12) = 0.08AC-FT = 3.317CF PROPOSED ONSITE VCLUME


Q(INCREASE FROM THIS DEVELOPMINT) = 2.20CFS - 2.12CFS = 0.08CFS INCREASE NEGLIGIELE

V(INCREASE FROM THIS DEVELOPMENT) = 3,317CF - 3,093CF = 224CF INCREASE NEGLIGIBLE

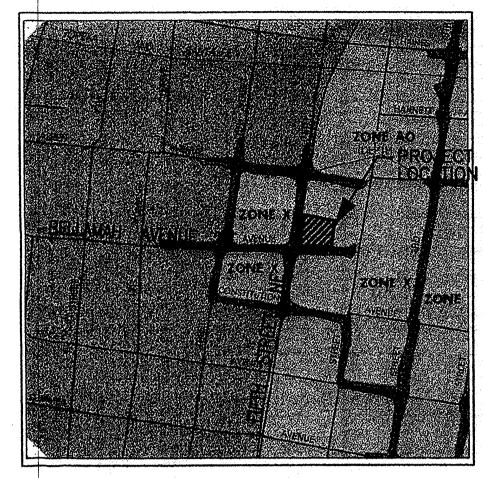


FIRM MAP 35001C0332D

SCALE: N.T.S.

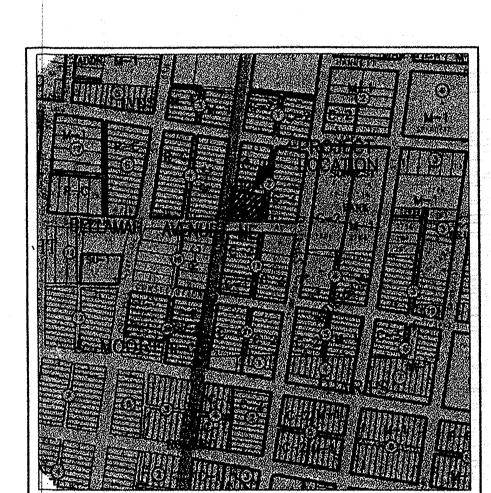

VICINITY MAP J-14

SCALE: N.T.S.

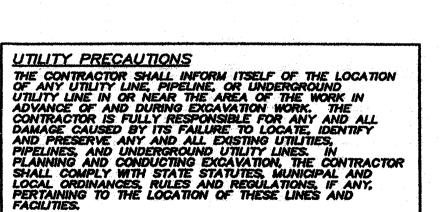

DRAINAGE CALCULATIONS AND MAPS QUAKER BUILDING

ALBUQUERQUE, NEW MEXICO

Applied Engineering & Suveying, Inc. 1605 BLAIR DRIVE NE ALBUQUERQUE, NEW MEXICO 87112 PH: (505)237-1456 SHEET NUMBER:

DATE/REVISIONS: