PLAT OF LOTS 16-A & 17-A, BLOCK 1 UNIVERSITY HEIGHTS COUNTY CLERK RECORDING LABEL HERE ALBUQUERQUE, BERNALILLO COUNTY, NEW MEXICO SECTION 22, T. 10 N., R. 3 E., NMPM DECEMBER 2006 EAST CENTRAL AVENUE 100' R.O.W. **EXISTING CONDITIONS** PRELIMINARY PLAT
APPROVED BY DRB
ON 5 9 07 LOT 24 ACS STA "8-K15" X = 388189.18 Y = 1494992.51 G-G .99966757" G-G .99966/86 \( \triangle \tilde{\triangle} \) \( \tilde{\triangle} \) \( \triangle \triangle \triangle \triangle \triangle \triangle \) \( \triangle \triangle \triangle \triangle \triangle \) \( \triangle \triangle \triangle \triangle \triangle \triangle \) \( \triangle \triangle \triangle \triangle \triangle \triangle \) \( \triangle \triangle \triangle \triangle \triangle \triangle \triangle \) \( \triangle \triangle \triangle \triangle \triangle \triangle \) \( \triangle \triangl COMM. BLDG. COMMERCIAL BUILDING ACS STA "5-K16A" X = 390249.98 Y = 1484954.25 G-G .99966644 \( \Delta \tilde{\tiiiity}}}}}}}} \tilde{\tilde{\tilde{\tilde{\ttilde{\tilde{\tilde{\ N 7720'27" E ( GRID )
WIRT 1080.69 ( GROUND ) N 72-26'07" W ( GRID )
907.49 ( GROUND ) LOT 22 BHOCK 1 UNIVERSITY HEIGHTS (filed February 7, 1916; Vbl. D, focomm.) ELEV. 5171.38 (SLD 1929) (EAST 142.00) S 89'29'46" 5 142.00 NEW MEXICO STATE PLANE GRID COORDINATES, CENTRAL ZONE NAD 1927 Set Nail & disk, "P\$ 14269" 4.00 Set Nail & disk, "PS 14269" LINE ELIMINATED LOT 21
av THAS PLAT LOT 20 12.5' PL TO FACE CURB 1 INCH = 50 FEET **℃** ¥ **a** o o, □ **∝** ~ 2 BLOCK 1 SITY HEIGHT 7, 1916; Vol. D, folio 27) 20.0' PL TO FACE CURB >  $\alpha$ 工 Set Noil & disk.

PS 14269 Exist.

BLDG.

BL LOT 2 UNIVERS ( filed February ∵Sel Nail & disk, ⊙"PS 14269" 16—A EXIST. 7100.00 s.f. BLDG. 0.1630 Ac. N 89°29'46" ₩——144,00 Set Nail & disk "PS-14269" Set Nail & disk ( WEST 142.00 ) LOT 15 BLOCK 1 UNIVERSITY HELTS H 5 (filed February 7, 1916; Vot. D, falio 27) (14269) 330 LOUISIANA BLVD., N.E. ALBUQUERQUE, N.M. 87108 PHONE: (505) 255-2052 FAX: (505) 255-2887 INDEXING INFORMATION FOR COUNTY CLERK DRAWN: FILE NO. SCALE: OWNER: HARVARD MALL PARTNERS 1" = 50'SP-12-01-2006 LOCATION: SECTION 22
T. 10 N., R. 3 E., N.M.P.M.
SUBDIVISION: UNIVERSITY HEIGHTS CHECKED: T D J DRAWING NO. 14 DEC 2006 SHEET 2 OF 2 SP120106.DWG

PLAT OF LOTS 16-A & 17-A, BLOCK 1 UNIVERSITY HEIGHTS COUNTY CLERK RECORDING LABEL HERE ALBUQUERQUE, BERNALILLO COUNTY, NEW MEXICO SECTION 22, T. 10 N., R. 3 E., NMPM DECEMBER 2006 EAST CENTRAL AVENUE 100' R.O.W. LOT 24 ACS STA "8-K15"

X = 388189.18

Y = 1494992.51

G-G .99966786

△ Œ -00'12'53"

ELEV. 5154.047 (SLD 1929)

NEW MEXICO STATE PLANE


GRID COORDINATES, CENTRAL ZONE

NAD 1927 ACS STA "5-K16A" X = 390249.98 Y = 1484954.25 G-G .99966644 Δ Φ -00'12'39" ELEV. 5171.38 (SLD 1929) N 77 20'27" E ( GRID ) LOT 22 BLOCK 1 UNIVERSITY HEIGHTS (filed February 7, 1915; Vol. D, follo 27) (EAST 142.00) S 89°29'46" E 142.00 NEW MEXICO STATE PLANE
GRID COORDINATES, CENTRAL ZONE
NAD 1927 Set Nail & disk, "PS 14269" 4.00 13 Set Nail & disk, "PS 14269" LOT 21

THE PLAN PLAT LOT 20 17—A 34500.00 s.f. 0.7920 Ac. LOT 20

S PLAT LOT 19

S 89'29'46" E 142.00 SCALE: 1 INCH = 50 FEET 20' PUBLIC WATERLINE EASEMENT (Note 50) **05** 10 LOT 18 SITY HEIGHT > œ I Set Noil & diek. 4.00 138.00 Set Nail & disk, N N N S 89'29'46" E 142.00
8 PUBLIC PEDESTRIAN EASEMENT (Note 5b) 16-A 7100.00 s.f. 0.1630 Ac. N 89°29'46" W Set Noil & diek, 142.00 ( WEST 142.00 ) LOT 15 BLOCK 1 UNIVERSITY HEIGHTS (filed February 7, 1916; Vol. D, folio 27) 330 LOUISIANA BLVD., N.E. ALBUQUERQUE, N.M. 87108 1.17.07 PHONE: (505) 255-2052 FAX: (505) 255-2887 INDEXING INFORMATION FOR COUNTY CLERK DRAWN: SCALE: FILE NO. EWK OWNER: HARVARD MALL PARTNERS 1" = 50'SP-12-01-2006 CHECKED: T D J LOCATION: SECTION 22 T. 10 N., R. 3 E., N.M.P.M. SUBDIVISION: UNIVERSITY HEIGHTS DRAWING NO. 14 DEC 2006 SHEET 2 OF 2 SP120106.DWG

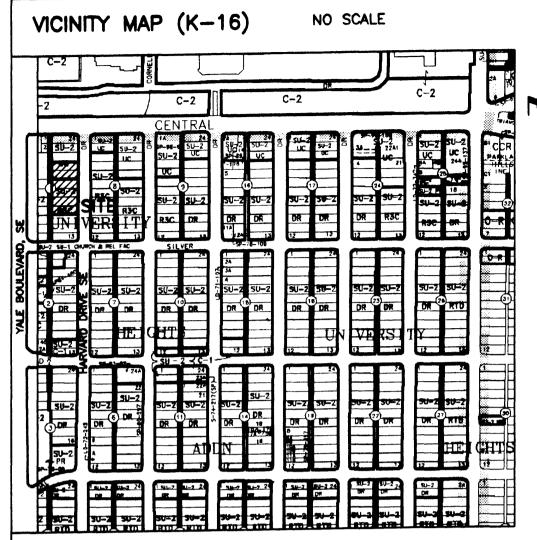

#### SUBDIVISION DATA

- 1. DRB Proj. No. 1004927
- 2. Zone Atlas Index No. K-16
- 3. Current Zoning SU2 (UC & R3C)
- 4. Gross acreage 0.9780 Acre
- 5. Number of proposed Lots: 2
- 6. No. of existing lots: 6
- 7. Miles of full width streets created: NONE
- , whiles of full width stroots creates.
- 8. Date of Survey: December, 2006 9. TALOS LOG NO.: 2006511533

### PURPOSE OF PLAT:

The purpose of this plat is to replat six existing lots into two lots, grant easements and dedicate additional right—of way for public alley.

#### NOTE

- 1. Bearings are Grid Bearings, Central Zone, NAD 1927, based upon ACS MONUMENTS "8-K15" and "5-K16A"
- 2. All distances are ground.
- 3. Monuments recovered and accepted or set are noted on plat.
- 4. Record bearings in parenthesis. Record bearings from the following source:
- a. Plat of UNIVERSITY HEIGHTS, filed February 7, 1916; Volume D, folio 27, records of Bernalillo County, New Mexico.
- 5. a) Twenty foot (20') Public Waterline Easement is hereby granted with the filing of this plat.
  - b) Eight foot (8') Public Pedestrian Easement is hereby granted with the filling of this plat.
- 6. Right-of-way dedicated to the City of Albuquerque in fee simple with warrany covenants.

# FOR BERNALILLO COUNTY TREASURER'S OFFICE USE ONLY THIS IS TO CERTIFY THAT TAXES ARE CURRENT AND PAID ON UPC# PROPERTY OWNER OF RECORD: BERNALILLO COUNTY TREASURER'S OFFICE

COUNTY CLERK RECORDING LABEL HERE

#### DESCRIPTION

Lots numbered Sixteen (16), Seventeen (17), Eighteen (18), Nineteen (19), Twenty (20) and Twenty—one (21) in Block Numbered One (1) of UNIVERSITY HEIGHTS, an Addition to the City of Albuquerque, New Mexico as the same are shown and designated on the Map of said Addition filed in the office of the County Clerk of Bernalillo County, New Mexico on February 7, 1916, being more particularly described as follows:

Beginning at the Northwest corner of Lot 21, said corner being a point on the Easterly line of a Sixteen—foot (16') Public Alley, from which point ACS Station "8—K15" (X = 388189.18; Y = 1484992.51, New Mexico State Plane Grid Coordinates, Central Zone, NAD 1927) bears

New Mexico State Plane Grid Coordinates, Central 2016, NAD 1927) bears

N 72°26'07" W, a ground distance of 907.49 feet, and running from said beginning point thence,

S 89°29'46" E, a distance of 142.00 feet to the Northeast corner of the herein described land, being a point on the West right—of—way line of Harvard Drive, SE;

thence, following said line, S 00'30'14" W, a distance of 300.00 feet to the Southeast corner of the herein described land; thence, N 89'29'46" W, a distance of 142.00 feet to the Southwest corner of the herein described land, being a point on the Easterly line of the aforementioned 16' Public Alley;

thence, following said line, N 00'30'14" E, a distance of 300.00 feet to the Northwest corner and the place of beginning, containing 0.9780 acre, more or less.

#### FREE CONSENT AND DEDICATION:

The platting of the property as described above, dedication of additional right—of—way to the City of Albuquerque in fee simple with warranty covenants and granting of all public easements is with the free consent and in accordance with the desires of the undersigned owner. Said owner warrants that he holds complete and indefeasible title in fee simple to the land subdivided.

		Azarbe
Jay	Remb, mana	ng partner, Harvard Mall Partners

ACKNOWLEDGMENT

STATE OF NEW MEXICO )
COUNTY OF BERNALILLO )

On this day of \_\_\_\_\_\_, 2006, the foregoing instrument was acknowledged before me by Jay Rembe, general partner, Harvard Mail Partners, a New Mexico limited liability partnership, on behalf of said partnership.

My Commission expires

2-20-67

Notary Public

PLAT OF

# LOTS 16-A & 17-A, BLOCK 1 UNIVERSITY HEIGHTS

ALBUQUERQUE, BERNALILLO COUNTY, NEW MEXICO

SECTION 22, T. 10 N., R. 3 E., NMPM

DECEMBER 2006

PROJECT NUMBER: 1004927	
Application Number:	
Utility Approvals:	
PNM Electric Services	Date
PNM Gas Services	Date
Qwest Telecommunications	Date
Comcast Cable	Date
City Approvale:	1-18-07
City Surveyor	Date
Real Property Division	Date
Environmental Health Department	Date
Traffic Engineering, Transportation Division	Date
Water Utility Department	Date
Parks and Recreation Department	Date
AMAFCA	Date
City Engineer	Date
DRB Chairperson, Planning Department	Date


#### SURVEYOR'S CERTIFICATE

I, Thomas D. Johnston, licensed as a Professional Surveyor under the laws of the State of New Mexico, do hereby certify that this plat was prepared by me or under my supervision, that I am responsible for this plat, that it shows all easements of the recorded plat and made known to me by the title company, utility companies or by the owner of record, meets the minimum standards for monumentation and surveys of the Albuquerque Subdivision Ordinance, and meets the Minimum Standards for Land Surveys as adopted by the New Mexico State Board of Registration for Professional Engineers and Surveyors, effective October 1, 2000 and is true and correct to the best of my knowledge and helief.

Thomas D. Johnston, N.M.P.S. No. 14269

12.18.V6



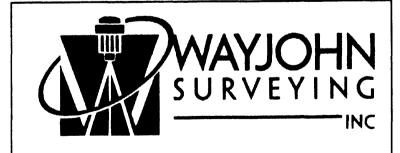


330 LOUISIANA BLVD., N.E. ALBUQUERQUE, N.M. 87108 PHONE: (505) 255-2052 FAX: (505) 255-2887

INDEXING INFORMATION FOR COUNTY CLERK OWNER: HARVARD MALL PARTNERS LOCATION: SECTION 22 T. 10 N., R. 3 E., N.M.P.M.. SUBDIVISION: UNIVERSITY HEIGHTS

 DRAWN:
 E W K
 SCALE:
 FILE NO.

 CHECKED:
 T D J
 N/A
 SP-12-01-2006

 DRAWING NO.
 SP120106.DWG
 14 DEC 2006
 SHEET 1 OF 2

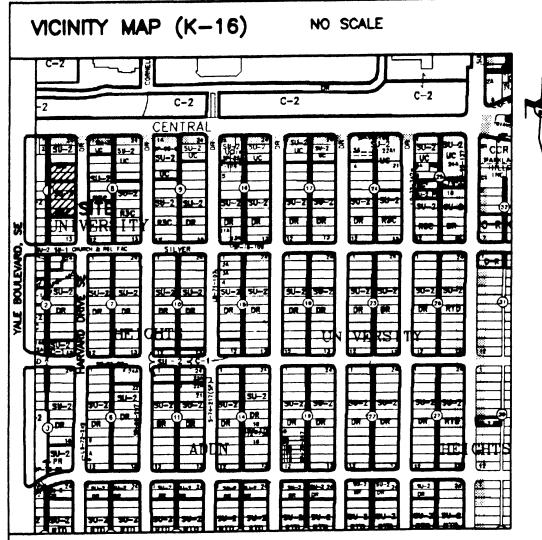

#### SUBDIVISION DATA

- 1. DRB Proj. No. 1004927
- 2. Zone Atlas Index No. K-16
- 3. Current Zoning SU2 (UC & R3C)
- 4. Gross acreage 0.9780 Acre
- 5. Number of proposed Lots: 2
- 6. No. of existing lots: 6
- 7. Miles of full width streets created: NONE
- 8. Date of Survey: December, 2006
- 9. TALOS LOG NO.: 2006511533

#### PURPOSE OF PLAT:

The purpose of this plat is to replat six existing lots into two lots, grant easements and dedicate additional right—of way for public alley.

#### NOTE

- 1. Bourings are Grid Searings, Control Zone, 1999 1927, based upon ACS MONUMENTS "8-K15" and "5-K16A"
- 2. All distances are ground
- 3. Monuments recovered and accepted or set are noted on plat.
- 4. Record bearings in percentages. Record bearings from the following source:

  a. Plat of UNIVERSITY HEIGHTS, filed February 7, 1916;

  Volume D, folio 27, records of Bernallio County, New Mexico.
- 5. a) Twenty foot (20°) Public Waterline Easement is hereby granted with the filling of this plat.
- b) Eight foot (8') Public Pedestrian Eccement is hereby granted with the filling of this plat, TO 96 MAINTAINED BY THE SHARE OF LOT IS A
- 6. Right—of—way dedicated to the City of Albuquerque in fee simple with warrany covenants.
- 7. FINE FOOT (6') PUBLIC WATER LINE AND PUBLIC SEMERLINE EASEMENT GRANTED TO THE CITY OF ALGUE USRAVE BY THIS PLAT.
- 8. THE PROPERTY ON THIS PLAT IS SUBJECT TO A PRE-DEVELOPMENT FACILITIES FEE ACREEMENT WITH ALBUQUEROUS PUBLIC SCHOOLS RECORDED AT BOOK AI36, PAGE 2979, AS DOCUMENT Nº 200763104, ON APRIL 30, 2007.

FOR BERNALLLO COUNTY TREMBUREY'S OFFICE USE ONLY
THIS IS TO CERTIFY THAT TAXES ARE CURRENT AND PAID ON
UPC#
1010057 0272073240L
PROPERTY OWNER OF RECORD:
PROPERTY OWNER ON RECORD: HOLLY CONTINUES
BERNALLLO COUNTY TREASURER'S CEFICE
Gusta Trusto 7110107

### DOC# 2007098549

07/10/2007 09:24 AM Page: 1 of 2 PLAT R:\$12.00 B. 2007C P: 0179 M Toulouse, Bernalillo County

COUNTY CLERK RECORDING LABEL HERE

#### **DESCRIPTION**

Lots numbered Sixteen (16), Seventeen (17), Eighteen (18), Nineteen (19), Twenty (20) and Twenty—one (21) in Block Numbered One (1) of UNIVERSITY HEIGHTS, an Addition to the City of Albuquerque, New Mexico as the same are shown and designated on the Map of said Addition filed in the office of the County Clerk of Bernaliilo County, New Mexico on February 7, 1916, being more particularly described as follows:

Beginning at the Northwest corner of Lot 21, said corner being a point on the Easterly line of a Sixteen-fact (16') Public Alley, from which point ACS Station "8—K15" (X = 388189.18; Y = 1484992.51, New Mexico State Plane Grid Ceerdinates, Central Zone, NAD 1927) bears N 72'26'07" W, a ground distance of 907.49 feet, and running from said beginning point thence, S 89'29'46" E, a distance of 142.00 feet to the Northeast corner of the herein described land, being a point on the West right—of—way line of Hervard Drive, SE; thence, following said line, S 00'30'14" W, a distance of 300.00 feet to the Southeast corner of the herein

thence, N 86°29'46" W, a distance of 142.00 feet to the Southwest corner of the herein described land, being a point on the Easterly line of the aforementioned 16' Public Alley; thence, following said line, N 00'30'14" E, a distance of 300.00 feet to the Northwest corner and the piece of beginning, containing 0.9780 acre, more or less.

#### FREE CONSENT AND DEDICATION:

The platting of the property as described above, dedication of additional right—of—way to the City of Albuquecque in fee simple with warranty sevenants and granting of all public essements is with the free consent and in accordance with the desires of the undersigned owner. Said owner warrant that he holds complete and indefeesible title in fee simple to the land subdivided.

Jay Remts, managing partner, Harvard Mall Partners

#### ACKNOWLEDGMENT

COUNTY OF BERNALILLO ) se COUNTY OF BERNALIL

My Commission expires

Notary Public

PLAT OF

# LOTS 16-A & 17-A, BLOCK 1 UNIVERSITY HEIGHTS

ALBUQUERQUE, BERNALILLO COUNTY, NEW MEXICO

SECTION 22, T. 10 N., R. 3 E., NMPM

DECEMBER 2006

PROJECT NUMBER: 1004927	
Application Number: 07-DRE-00555	
Utility Approvals:	
Land 91. Mark	7-07-07
PNM Electric Services	Date
- Land B. Mest	7-07-07
PNN Gas Services	, Date
Mellettelle,	7307
Qwest Telecommunications,	Date
John Bulan	7.3.07
Conficaet Cable	Date
City Adacovole:	
JAD Jan	1-18-07
City Surveyor	Date
N/A	
Real Property Division	Date
N/A	
Environmental Health Department	Date
Isle by	5-9-07
Traffic Engineering, Transportation Division	Date
William O. Balch	7-5-07
Water Utility Department	Date
Christine Sandoral	5/9/07
Portie and Recreation Department	/ Date
Bradle of Brushon	5/9/07
AMAFCA	Date
Birth & Birth	5/9/07
City Brighter	
andrew Sarcia	7/5/07
DRS Chairperson, Planning Department	Dute


#### SURVEYOR'S CERTIFICATE

Mexico, do hereby certify that this plat was prepared by me or under my supervision, that I am responsible for this plat, that it shows all easements of the recorded plat and made known to me by the title company, utility compenies or by the owner of record, mests the minimum standards for menumentation and surveys of the Albuquerque Subdivision Ordinance, and made the Minimum Standards for Land Surveys as adopted by the New Mexico State Search of Registration for Professional Engineers and Surveyors, effective October 1, 2000 and is true and correct to the best of my knowledge and belief.

Thomas D. Johnston, N.M.P.S. No. 14209

12.18.Vb



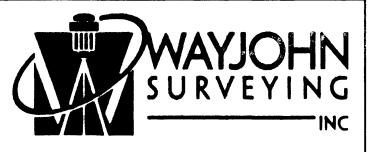

330 LOUISIANA BLVD., N.E. ALBUQUERQUE, N.M. 87108 PHONE: (505) 255-2052 FAX: (505) 255-2887

INDESING INFORMATION FOR COUNTY CLERK OWNER:
HARMAND MALL PARTNERS
LOCATION: SECTION 22
T. 10 N., R. 3 E., N.M.P.M.,
SUBDIMISION: UNIVERSITY HEIGHTS

THE PROPERTY OF THE PROP

DRAWN: E W K SCALE: FILE NO.

CHECKED: T D J N/A SP-12-01-2006

DRAWN: B W K SCALE: FILE NO.

SP120106.DWG 14 DEC 2006 SHEET 1 OF 2

DOC# 2007098549

07/10/2007 09:24 AM Page: 2 of 2 PLAT R:\$12.00 B: 2007C P: 0179 M. Toulouse, Bernalillo County

COUNTY CLERK RECORDING LABEL HERE


PLAT OF


# LOTS 16-A & 17-A, BLOCK 1 UNIVERSITY HEIGHTS

ALBUQUERQUE, BERNALILLO COUNTY, NEW MEXICO

SECTION 22, T. 10 N., R. 3 E., NMPM

DECEMBER 2006

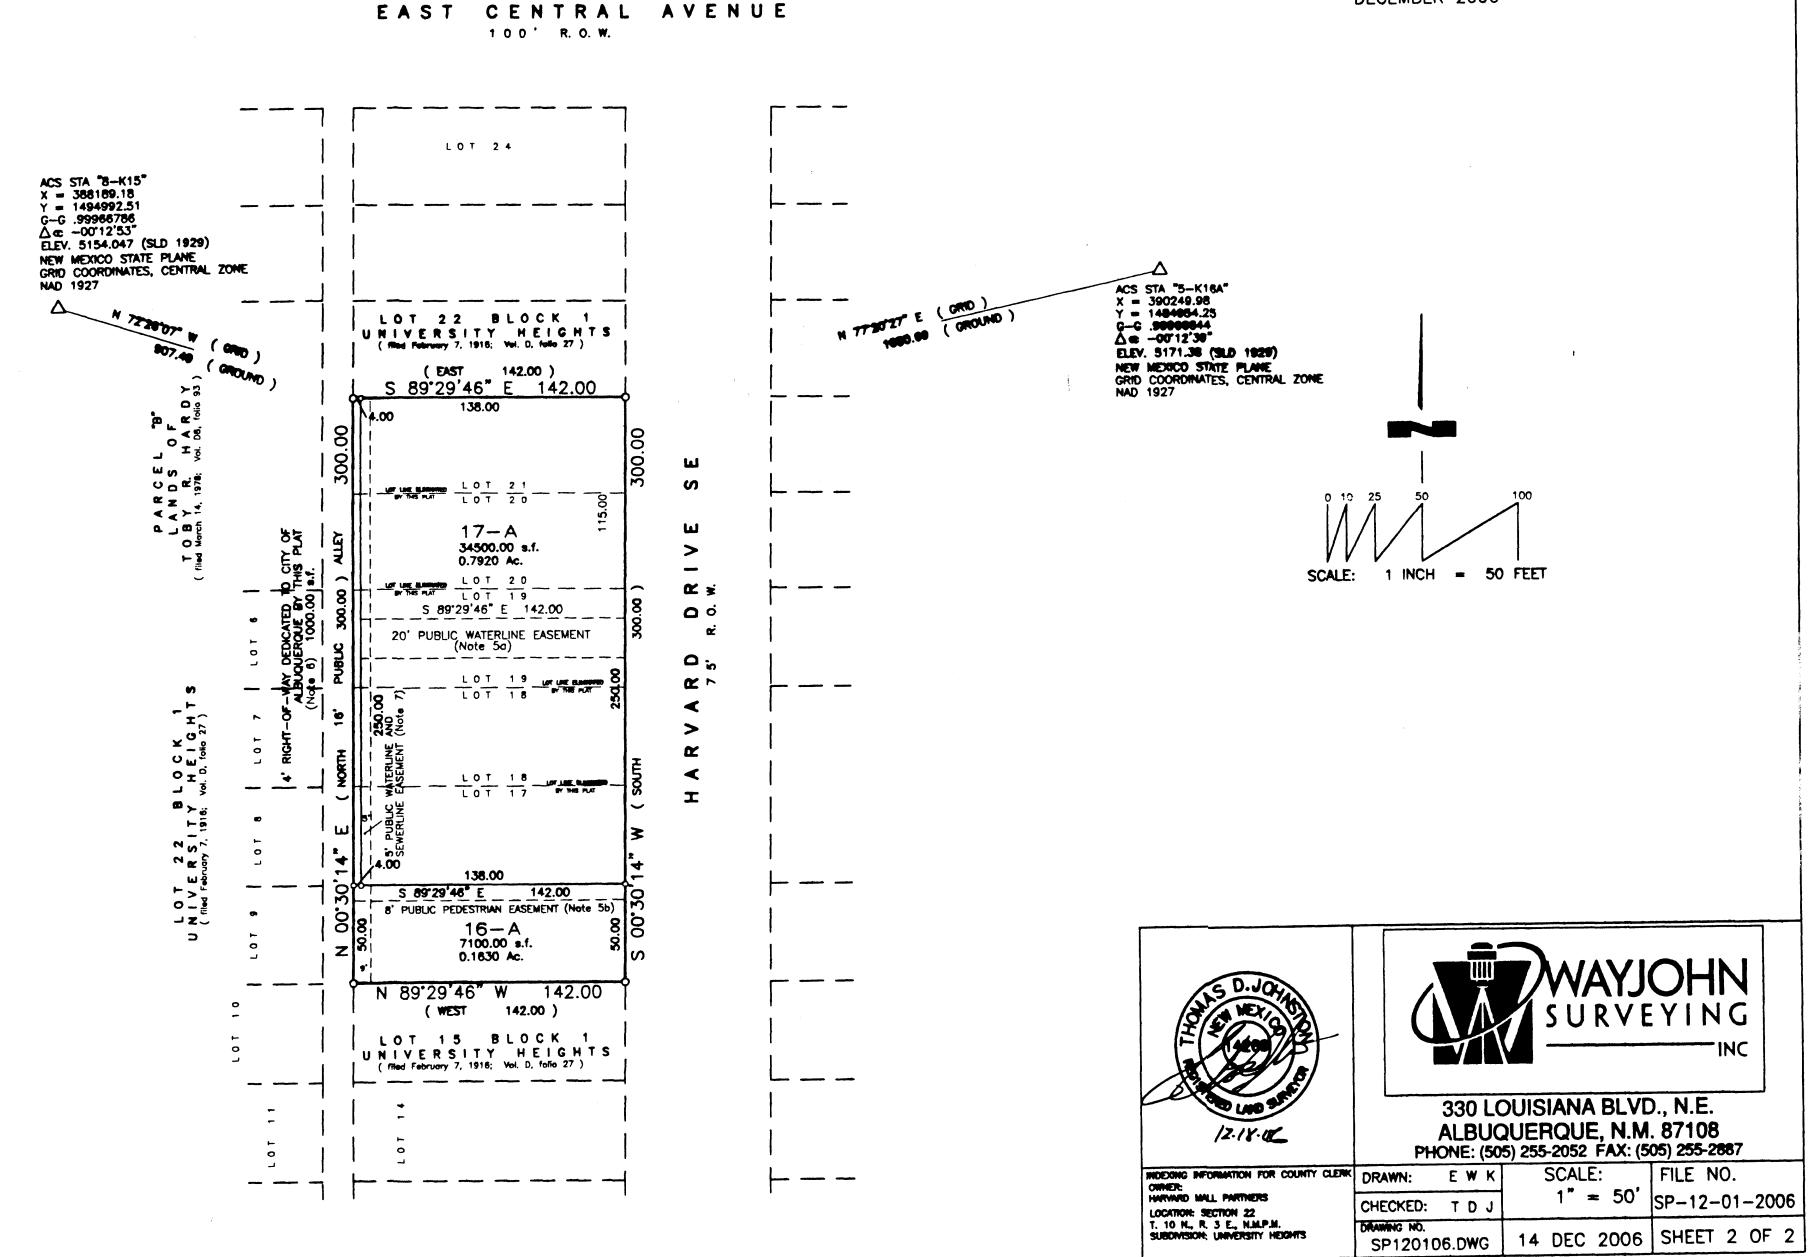

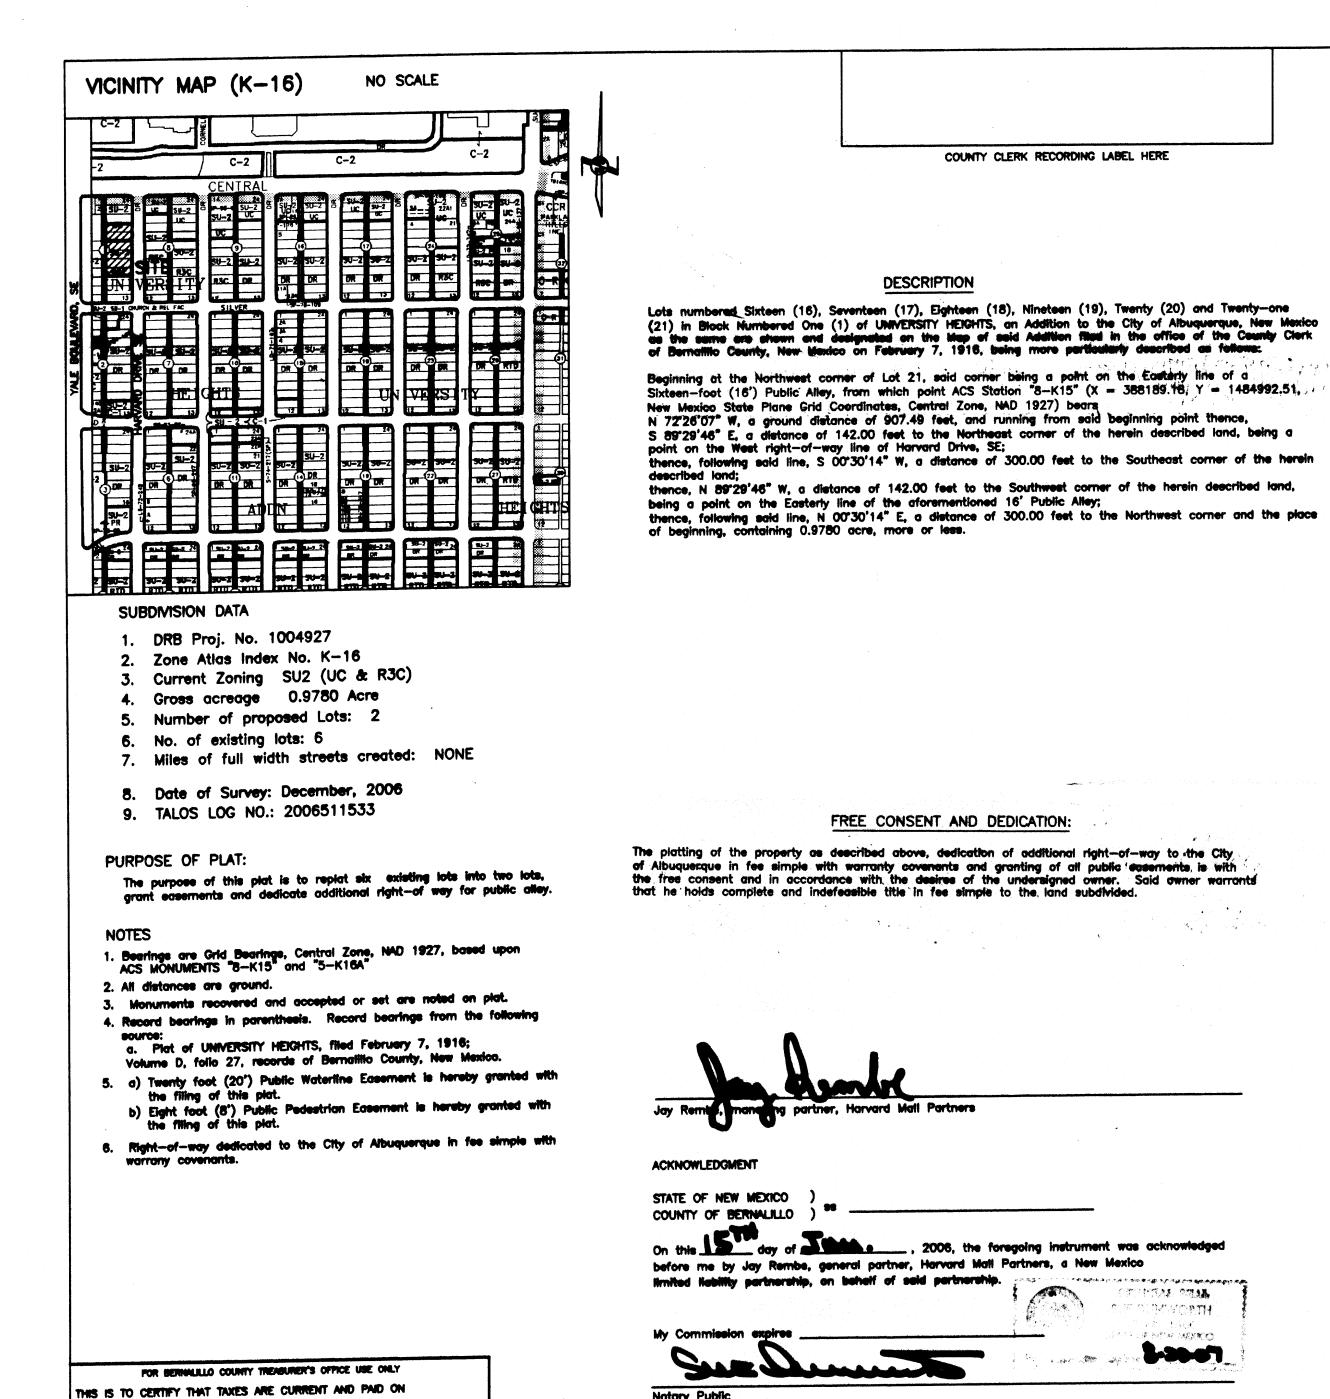

UPC

PROPERTY OWNER OF RECORD:

BERNALILLO COUNTY TREASURER'S OFFICE

# PLAT OF


# LOTS 16-A & 17-A, BLOCK 1 UNIVERSITY HEIGHTS


ALBUQUERQUE, BERNALILLO COUNTY, NEW MEXICO

SECTION 22, T. 10 N., R. 3 E., NMPM

DECEMBER 2006

PROJECT NUMBER: 1004927	
Application Number:	
PNM Electric Services	Date
PNM Gas Services	Date
Qwest Telecommunications	Date
Corncast Cable	Date
City Surveyor	1-18-07 Date
Real Property Division	Date
Environmental Health Department	Date
Traffic Engineering, Transportation Division	Date
Water Utility Department	Date
Parks and Recreation Department	Date
AMAFCA	Date
City Engineer	Date
DRB Chairperson, Planning Department	Date
I, Thomae D. Johneton, licensed as a Professional Surveyor under the laws Mexico, do hereby certify that this plat was prepared by me or under my a responsible for this plat, that it shows all easements of the recorded plat one by the title company, utility companies or by the owner of record, meastandards for monumentation and surveys of the Albuquerque Subdivision Or the Minimum Standards for Land Surveyors, effective October 1, 2000 and is to the best of my knowledge and belief.  Thomas D. Johnston, N.M.P.S. No. 14269	supervision, that I am and made known to to the minimum vinance, and meets
E D.JO	JOHN

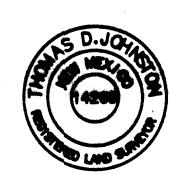

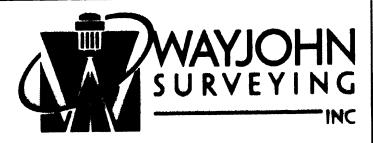

330 LOUISIANA BLVD., N.E. ALBUQUERQUE, N.M. 87108 PHONE: (505) 255-2052 FAX: (505) 255-2887

INDIDING INFORMATION FOR COUNTY CLERK DRAWN: OWNER: HARWARD MALL, PARTNERS LOCATION: SECTION 22 T. 10 N., R. 3 E., N.M.P.M., SUBDIVISION: UNIVERSITY HEIGHTS

SCALE: FILE NO. EWK N/A ISP-12-01-2006 CHECKED: T D J 14 DEC 2006 SHEET 1 OF 2 SP120106.DWG

PLAT OF LOTS 16-A & 17-A, BLOCK 1 UNIVERSITY HEIGHTS COUNTY CLERK RECORDING LABEL HERE ALBUQUERQUE, BERNALILLO COUNTY, NEW MEXICO SECTION 22, T. 10 N., R. 3 E., NMPM DECEMBER 2006 EAST CENTRAL AVENUE 100' R.O.W. LOT 24 ACS STA "8-K15"

X = 388189.18

Y = 1494992.51

G-G .99966786

\$\Delta \tilde{\ ACS STA "5-K16A"

X = 390249.98

Y = 1484954.25

G-G .99966644

△ Œ -00'12'39"

ELEV. 5171.38 (SLD 1929)

NEW MEXICO STATE PLANE

GRID COORDINATES, CENTRAL ZONE

NAD 1927 N 77'20'27" E/ ( GROUND ) LOT 22 BLOCK 1 UNIVERSITY HEIGHTS (filled February 7, 1918; Vol. D, follo 27) ( EAST 142.00 ) S 89°29'46" E 142.00 Set Nail & disk, "PS 14269" 4.00 13 Set Neil & disk, "PS 14269" S BY THE PLAT LOT 21 17-A 34500.00 s.f. 0.7920 Ac. 1 INCH = 50 FEET LOT 19 S 89°29'46" E 142.00 20' PUBLIC WATERLINE EASEMENT (Note 5a) œ < I PS 14269" 138.00 Set Noil & diek, O"PS 14269" S 89'29'46" E 142.00
8 PUBLIC PEDESTRIAN EASEMENT (Note 5b) 16-A 7100.00 s.f. 0.1630 Ac. "PS 14269" N 89°29'46" W 142.00 Set Nail & diek, ( WEST 142.00 ) LOT 15 BLOCK 1 UNIVERSITY HEIGHTS (filed February 7, 1916; Vol. D, folio 27) 330 LOUISIANA BLVD., N.E. ALBUQUERQUE, N.M. 87108 1.17.07 PHONE: (505) 255-2052 FAX: (505) 255-2887 INODONG INFORMATION FOR COUNTY CLERK DRAWN: FILE NO. SCALE: EWK OWNER: HARVARD MALL PARTNERS  $1" = 50' |_{SP-12-01-2006}$ CHECKED: T D J LOCATION: SECTION 22 T. 10 N., R. 3 E., N.M.P.M., SUBDIVISION: UNIVERSITY HEIGHTS DINAMING NO. 14 DEC 2006 SHEET 2 OF 2 SP120106.DWG

# Bricklight Courtyards-DRB Submittal

```
Parks = Central University
  34700 Non = 135-33 + 3024 Extrag = 11791
             31676 1 = $ 12,353,64
 Superty = Esses, de Regidentis 3024 th = 834.63 of
                34700 $ New = 9577, 20 magrilutes1
               7910.5$ Old Commercial = 3599,28
New 9577. 20 + 3276.00 = 12757.20
Old 834,63 +3599,28 = 4433,91
   12753,20 - 4433,9 = ($8319,29
```

Total \$ 20,672,93

12353.64 + 8319.29 = 20192.93

# PROJECT DATA

```
LEGAL DESCRIPTION:
LOTS 6,7,8,9,10,16,17,18,19,20,21, BLOCK 1, UNIVERSITY HEIGHTS
```

### ACREAGE: LOT 7 = .16 ACRES LOT 9 = .16 ACRESLOT 10 = .16 ACRES LOT 16 = .16 ACRESLOT 17 = .16 ACRES LOT 18 = .16 ACRES LOT 19 = .16 ACRES LOT 20 = .16 ACRES

### PROPOSED BUILDING AREAS: BUILDING A:

```
1,200 SF. RESIDENTIAL
                             2,050 SF. RESIDENTIAL
4,450 SF.
BUILDING B:
                             3.800 SF. RESIDENTIAL
                            5.600 SF. RESIDENTIAL
                             4,700 SF. RESIDENTIAL
BUILDING C:
                            2,400 SF. RETAIL
                             3,800 SF. RESIDENTIAL
                             5.600 SF. RESIDENTIAL
                              4,700 SF. RESIDENTIAL
BUILDING D:
                             1,200 SF. RETAIL
```

# 1,200 SF. RESIDENTIAL 2,050 SF. RESIDENTIAL TOTAL DEVELOPMENT: 44,300 SF. (INCLUDING

### PARKING CALCULATIONS: PARKING REQUIRED:

101 111

7,200 SF. RETAIL 1 PER 300 SF, PER UC ZONE 7,200/300 = 24 SPACES REQUIRED

34,700 SF. RESIDENTIAL UNITS 1 PER 600 SF, PER R3C ZONE 33,400/600 = 56 SPACES REQUIRED

80 TOTAL SPACES REQUIRED LESS 10% REDUCTION AS PROJECT IS WITHIN 300' OF TRANSIT ROUTE = 72 SPACES REQUIRED

# 26 SPACES ARE PROVIDED OFF OF ALLEY. LOTS 17,18,19,20.

46 SPACES PROVIDED AND DESIGNATED IN ADJACENT PARKING LOT. LOTS 6,7,8,9,10.

# 72 TOTAL SPACES PROVIDED

4 HC ACCESSIBLE SPACES AND 3 MOTORCYCLE SPACES REQUIRED PER C.O.A. REQUIREMENTS.

4 HC ACCESSIBLE SPACES PROVIDED OFF OF ALLEY. 7 MOTORCYCLE SPACES PROVIDED IN ADJACENT LOT.

# BICYCLE PARKING CALCULATIONS:

BICYCLE PARKING REQUIRED: = 4 SPACES REQUIRED

# BICYCLE PARKING PROVIDED:

= 18 SPACES PROVIDED (3 RACK) = 24 SPACES PROVIDED (4 RACKS) = 42 SPACES PROVIDED

#### OPEN SPACE CALCULATIONS: 200 SF. PER EFFICIENCY OR 1 BEDROOM PER SU-1 ZONING REGULATIONS.

46 RESIDENTIAL UNITS x 200 = 9200 SF. OPEN SPACE

= 2160 SF. 11060 SF. OPEN SPACE PROVIDED

# SHEET LIST

```
SITE DEVELOPMENT PLAN FOR BUILDING PERMIT
CONCEPTUAL LANDSCAPE PLAN
NOTES AND DRAINAGE INFORMATION
EXISTING GRADING AND DRAINAGE PLAN
GRADING AND DRAINAGE PLAN
SITE UTILITY PLAN
 OVERALL EXTERIOR ELEVATIONS
 ENLARGED EXTERIOR ELEVATIONS
```

# REQUESTED ZONING

```
ZONE CHANGE FROM SU-2/UC AND SU-2/R-3-C TO SU-2/SU-1 FOR A MIXED USE PROJECT
INCLUDING A 46 DWELLING UNIT COURTYARD DEVELOPMENT AND 7,200 SQUARE FEET FOR
COMMERCIAL USE, AND A SECTOR PLAN AMENDMENT TO THE ZONING MAP FROM UC AND R3C TO
SU-1 FOR MIXED USE.
```

### PERMISSIVE COMMERCIAL USES INCLUDE:

MULTIPLE-FAMILY DWELLINGS, NOT TO EXCEED A TOTAL OF 46 DWELLING UNITS. CHURCH OR OTHER PLACE OF WORSHIP, INCLUDING INCEDENTAL RECREATIONAL AND EDUCATIONAL FACILITIES.

OFFICE MACHINES AND EQUIPMENT SALES AND REPAIR. RETAIL SALES OF THE FOLLOWING GOODS, PLUS INCIDENTAL RETALING OF RELATED GOODS AND INCIDENTAL SERVICE OR REPAIR: (a) ARTS AND CRAFTS OBJECTS, SUPPLIES, PLUS THEIR

INCIDENTAL CREATION PROVIDED THERE IS LITTLE OR NO REPRODUCTION OF SUBSTANTIALLY IDENTICAL (b) BOOKS, MAGAZINES, NEWSPAPERS, STATIONERY, PROVIDED THAT NO SUCH MATERIAL IS ADVERTISED TO

BE FORBIDDEN TO BE SOLD TO MINORS. CLOTHING, SHOES, DRY GOODS. COSMETICS, NOTIONS, HOBBY SUPPLIES. DRUGS, MEDICAL SUPPLIES. FLOWERS AND PLANTS, INCLUDING MINOR AND

INCIDENTAL OUTDOOR SALES. RESTAURANTS, WITH OR WITHOUT BEER AND WINE THERE SHALL BE NO DRIVE-IN RESTAURANT OR

DRIVE-UP WINDOW; AND, THE RETAILING OF ALCOHOLIC DRINKS, INCLUDING BEER AND WINE, FOR ON OR OFF PREMISE CONSUMPTION. WITHIN 500 FEET OF A COMMUNITY RESIDENTIAL PROGRAM OR HOSPITAL FOR TREATMENT OF SUBSTANCE ABUSERS, IS PROHIBITED.

FURNITURE, HOUSEHOLD FURNISHINGS, AND APPLIANCES. JEWELRY. BICYCLE SALES. REPAIR IS ALLOWED AS AN ACCESSORY USE TO SALES PROVIDED ALL REPAIR ACTIVITIES, INCLUDING TEMPORARY STORAGE, ARE DONE WITHIN A COMPLETELY ENCLOSED BUILDING. (k) GAMES, INCLUDING COMPUTER AND VIDEO GAMES. (RETAIL SALES


ONLY, NO ARCADES). MUSICAL INSTRUMENTS AND SUPPLIES. PHOTOGRAPH EQUIPMENT. SPORTING GOODS.

WALK-UP AUTOMATIC TELLER MACHINES (ATM'S). BARBER, BEAUTY. DRY CLEANING STATION (NO PROCESSING), SELF SERVICE LAUNDRY.

HEALTH GYMNASIUMS. INSTRUCTION IN MUSIC, DANCE, FINE ARTS, CRAFTS, MODELING. PET GROOMING.

PHOTOGRAPHY, PHOTOCOPY, EXCEPT ADULT PHOTO STUDIO. REPAIR OF SHOES, HOUSEHOLD EQUIPMENT. TAILORING, DRESSMAKING.

THERE ARE NO CONDITIONAL COMMERCIAL USES PERMITTED WITH THIS REQUEST.

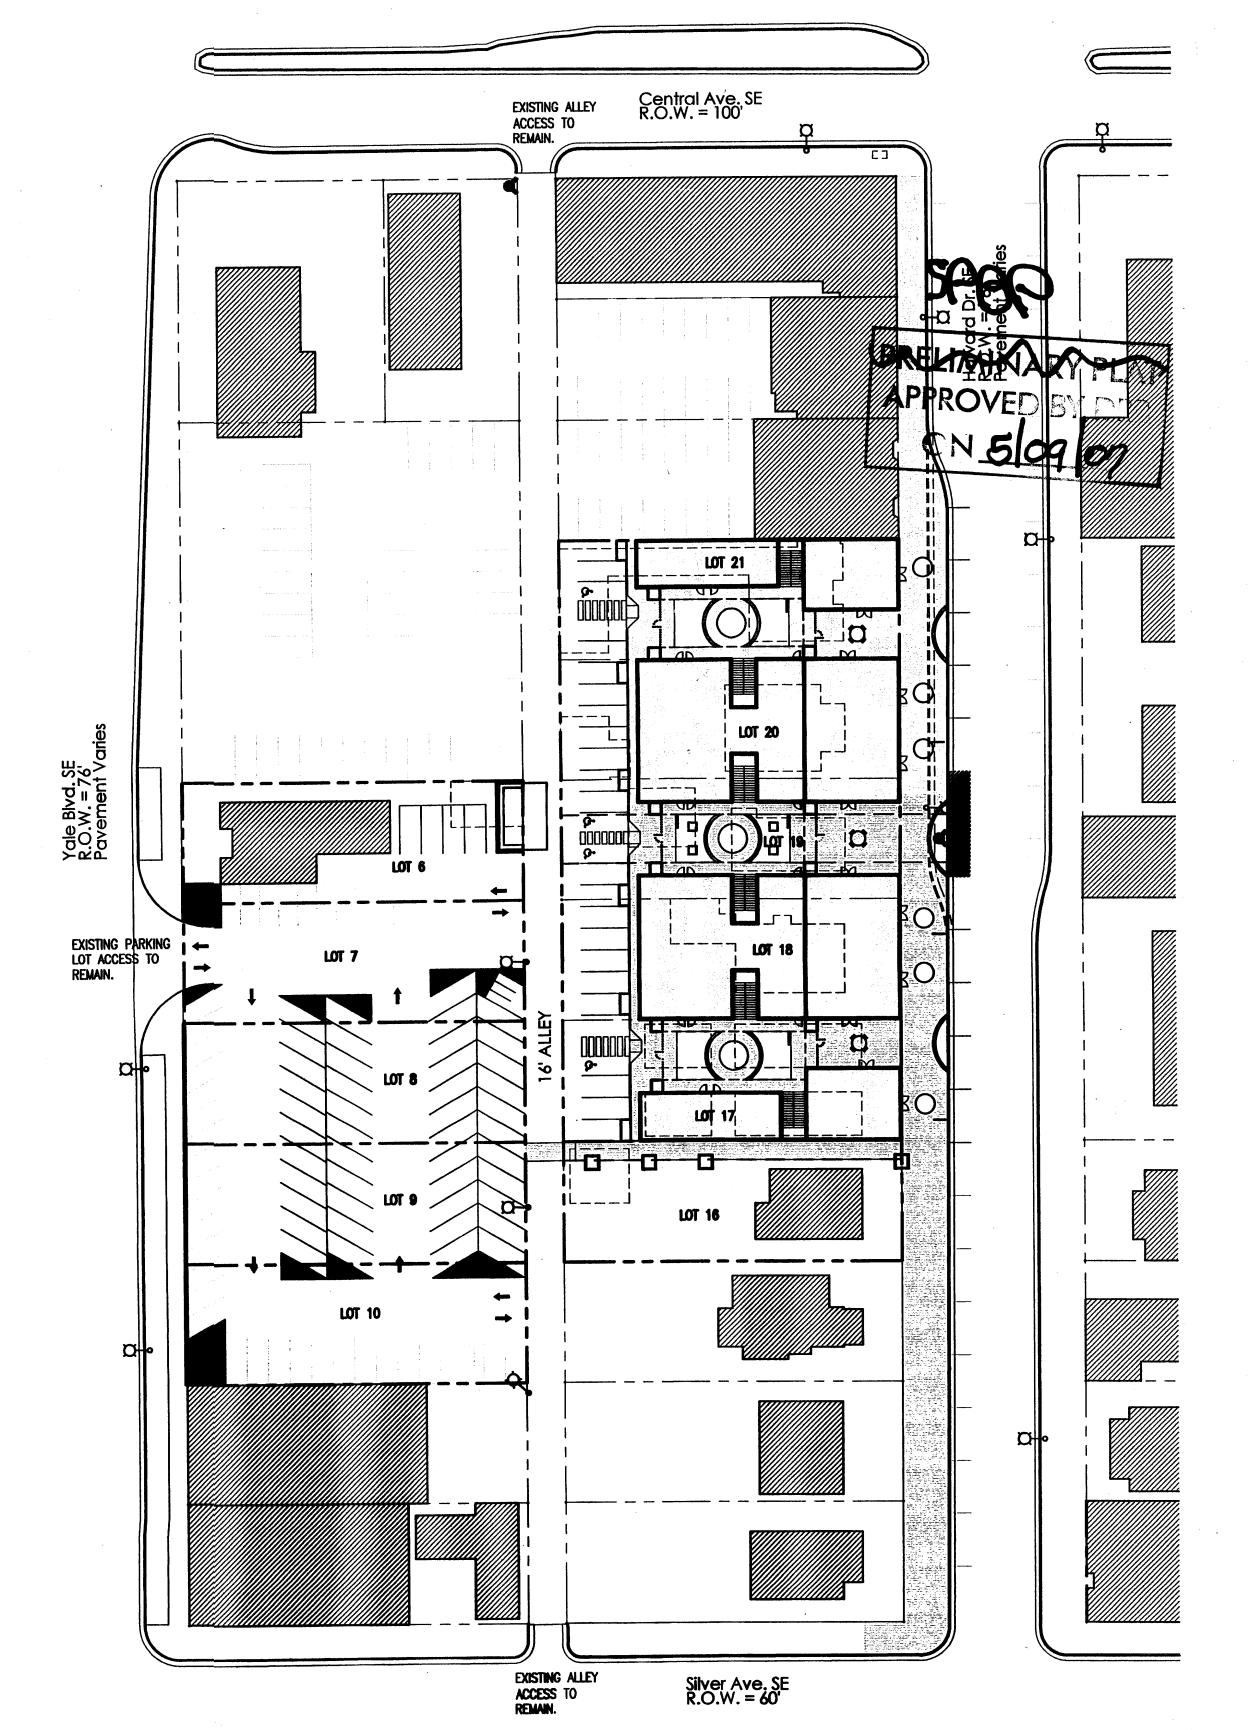


\ Overall Site Plan for Building Permit


Mullen Heller Architecture P.C. 1015 Tijeras Avenue NW


Suite 220 Albuquerque 87102 505 268 4144[p] 505 268 4244 [f]

Bricklight

Lots 6-10,17-2

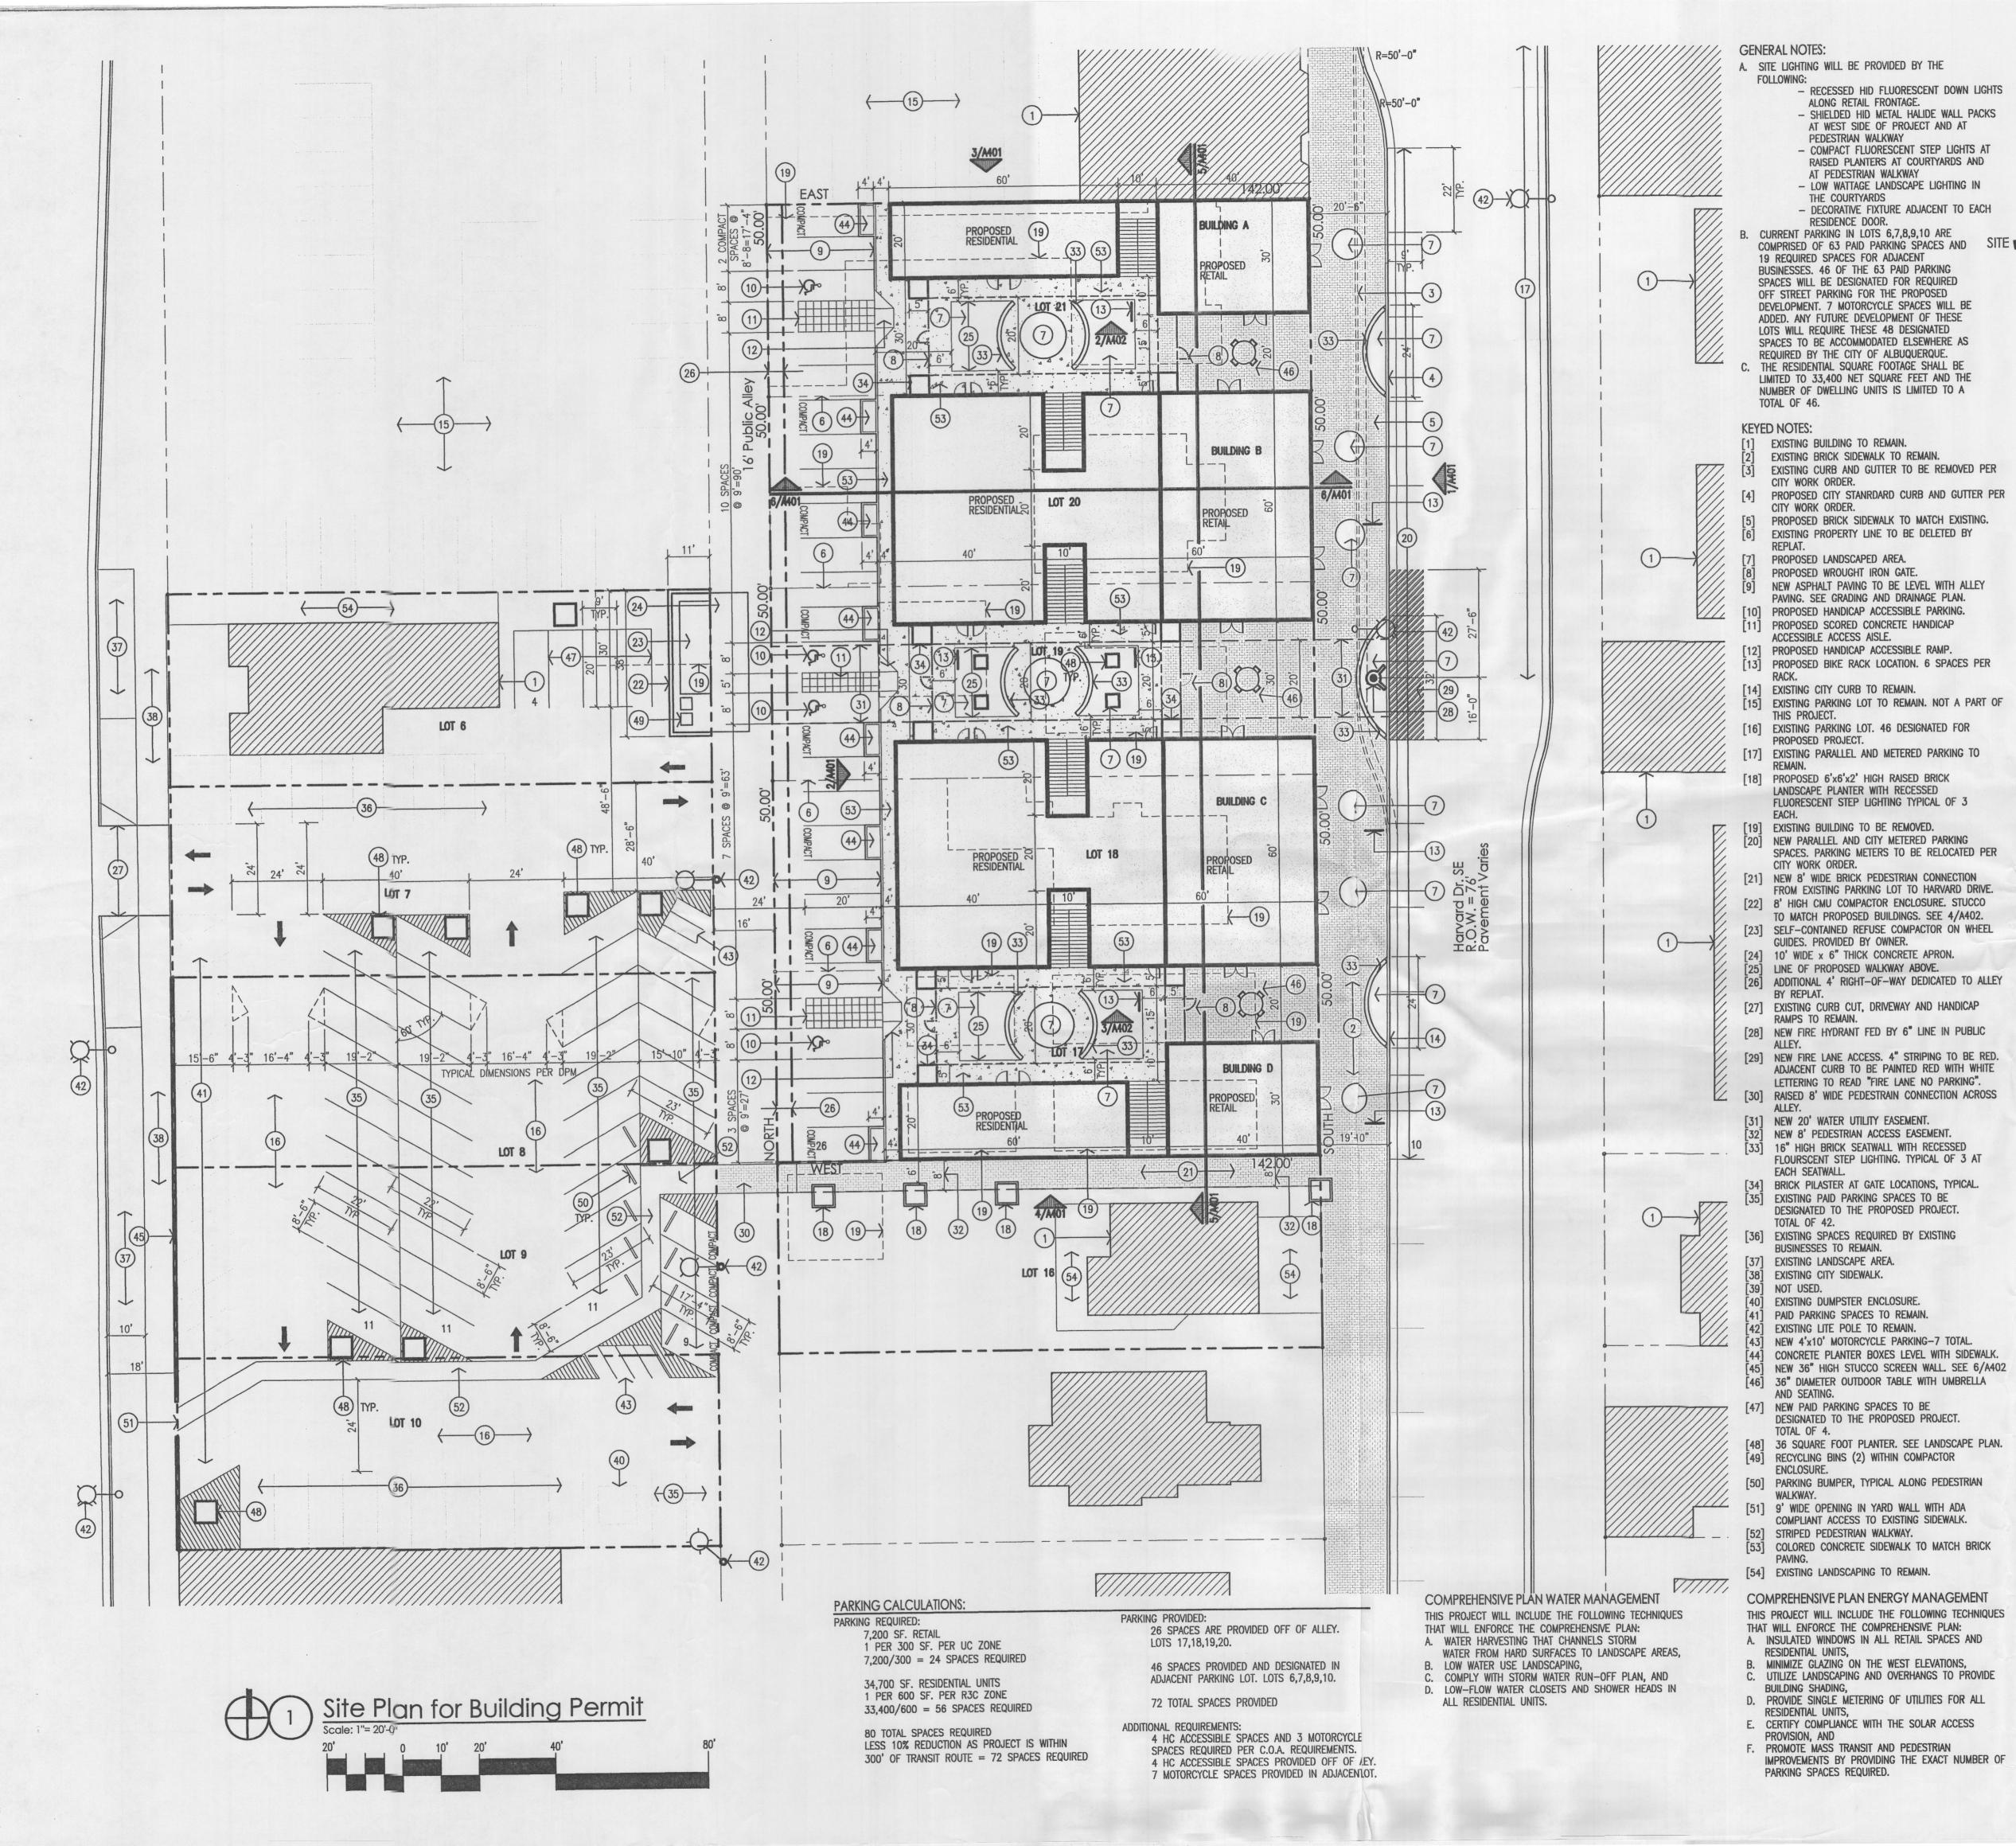

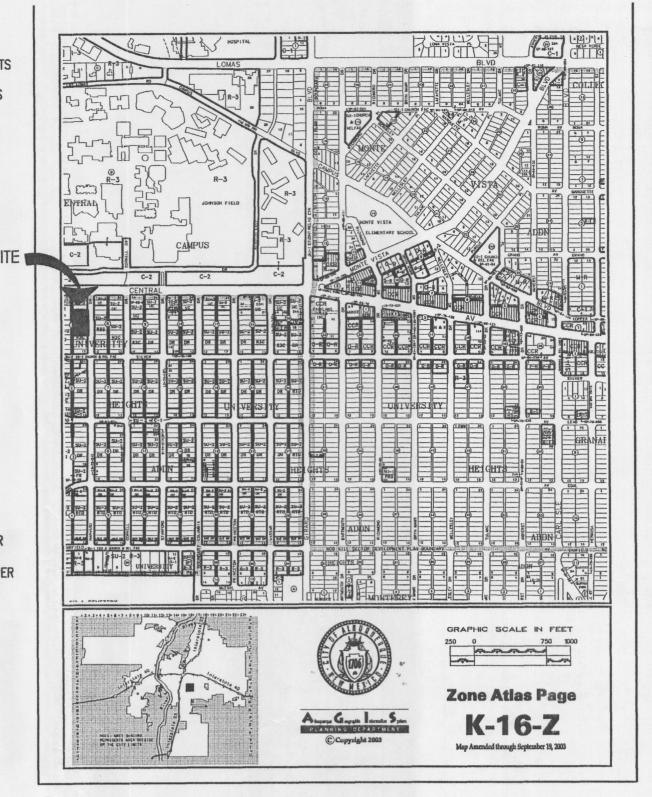

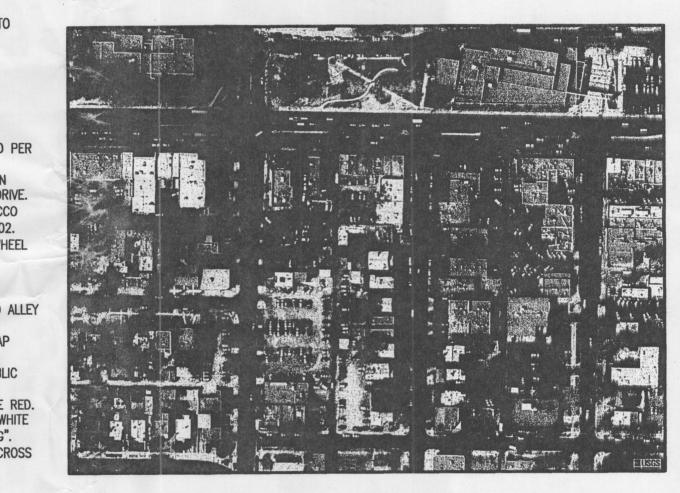

Aerial Photograph

PROJECT NUMBER: 1004927 APPLICATION N	UMBER:
THIS PLAN IS CONSISTANT WITH THE SPECIFIC SITE DEVELO THE ENVIRONMENTAL PLANNING COMMISSION (EPC) DATED: AND THE FINDINGS AND CONDITIONS IN THE OFFICIAL NOTIFICATION SATISFIED.	AUGUST 17, 2006
IS AN INFRASTRUCTURE LIST REQUIRED? (X) YES ( ) NO APPROVED DRC PLANS WITH A WORK ORDER IS REQUIRED WITHIN PUBLIC RIGHT-OF-WAY OR FOR CONSTRUCTION OF	IF YES, THEN A SET OF FOR ANY CONSTRUCTION PUBLIC IMPROVEMENTS.
DRB SITE DEVELOPMENT PLAN SIGNOFF APPROVAL:	
TRAFFIC ENGINEER, TRANSPORTATION DIVISION	Date
UTILITIES DEVELOPMENT	Date
PARKS AND RECREATION DEPARTMENT	Date
CITY ENGINEER	Date
*ENVIRONMENTAL HEALTH DEPARTMENT (CONDITIONAL)	Date
SOLID WASTE MANAGEMENT	Date
DRB CHAIRPERSON, PLANNING DEPARTMENT	Date

Building Block 1,

≥<br/>
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Mullen Heller

Architecture P.C.

1015 Tijeras Avenue NW

Albuquerque 87102

Suite 220

505 268 4144[p]

505 268 4244 [f]



# LANDSCAPE PALETTE

Symbol	Botanical Name / Common Name	Mature Size Water Use
	Trees Existing Trees to Remain	
8	Chitalpa tashkentensis Chitalpa	30' x 30' Medium
$\odot$	Zelkova serrātā Zelkova	50' x 40' Medium+
$\odot$	Koelreuteria paniculata Golden Raintree	20' x 20' Medium
$\otimes$	Lageretroemia indica Crape Myrtle	15' x 15' Medium+
	Robinia x ambigua Purple Robe Locust	25' x 25' Medium
$\Diamond$	<u>Shrubs/Groundcovers</u> Buddiela davidii 'Nanhoensis' Butterfly Bush	48" x 48" Medium
€	Caryopteris clandonensis Blue Mist	36' x 36' Medium
$\otimes$	Cytisus x 'Lena' Lena's Broom	36" x 36" Medium
8	Lavandula angustifolia English Lavender	24° × 24° Medium
•	Potentilla fruticosa Shrubby Cinquefoil	36" x 36" Medium +
	Rosmarinus officinalis Prostrate Rosemary	24° × 48° Low +
*	Ornamental Grasses Nassella tennuissima Threadgrass	24" x 24" Low +

# LANDSCAPE CALCULATIONS

Total Site Area: (129	acres) 56,286 SF
Building Area:	20,384 SF
Net Area:	35,902 8F
Required Landscape Area (15% of Net Area):	5,386 8F
Provided Landscape Area:	•6,198 SF
* includes existing landscaping on Lots 6 and 16	á

### includes existing landscaping on Lots 6 and 16 LANDSCAPE NOTES

Due to the current site plan proposal, all existing trees on site shall be removed.

Based on the City Zoning Code (trees per dwelling unit), 27 trees are required for this site. We have provided 26 trees, including 4 in pots in the utility easement between the 2 center buildings. We have provided 9 pots within the parking lot to provide for tree requirements within the parking lot. Four existing trees along Yale satisfy the street tree requirement for Yale.

PLANT MATERIAL

The plant material selected for this project is in keeping with the existing plant material used throughout the Harvard corridor. The palette includes material that is considered High or Medium + in terms of water use. These species are used sparingly and are intended to blend with the surrounding landscape. It is our intent to provide structural soil in paved areas surrounding the trees along Harvard. This will provide a larger area of planting medium to aid the long-term health of those trees.

MULCHES
All strub planting areas shall be top dressed with 3° layer of pecan shells.

IRRIGATION SYSTEM
Irrigation system standards outlined in the Water Conservation Landscaping and Water
Waste Ordinance shall be strictly adhered to. A fully automated drip irrigation system will
be used to irrigate tree, shrub and groundcover planting areas.

MAINTENANCE RESPONSIBILITY

Maintenance of the landscaping and irrigation system, including those areas within the public ROW, shall be the responsibility of the property owner.

STATEMENT OF WATER WASTE

Using the "planting restriction" approach within the Water Conservation Landscaping and Water Waste Ordinance, the Landscape Plan for the Harvard Redevelopment shall limit the provision of high water use turf to a maximum of 20 percent of the required landscape area. The current landscape plan does not contain any high water use turf.

Mullen Heller Architecture P.C. 1015 Tijeras Avenue NW Suite 220 Albuquerque 87102 505 268 4144[p] 505 268 4244 [f]

Courtyards
lock 1, University Hei

Bricklight (Lots 17—21, Blo Albuquerque, New

sheet-

CONSENSUS PLAINNING, INC.
Planning / Landscape Architecture
302 Eighth Street NW
Albuquerque, NM 87102
(505) 764-9801 Fax 842-5495
e-mail: cp@consensusplanning.com

# GENERAL CONSTRUCTION NOTES

### GENERAL

CONTRACTOR IS RESPONSIBLE FOR OBTAINING ALL REQUIRED CONSTRUCTION PERMITS, INCLUDING A TOP SOIL DISTURBANCE PERMIT, PRIOR TO START OF CONSTRUCTION.

ALL WORK ON THIS PROJECT SHALL BE PERFORMED IN ACCORDANCE WITH APPLICABLE FEDERAL, STATE, AND LOCAL LAWS, ORDINANCES, AND REGULATIONS CONCERNING CONSTRUCTION SAFETY AND HEALTH.

REFERENCES MADE TO STANDARD SPECIFICATIONS AND STANDARD DRAWINGS REFER TO THE CITY OF ALBUQUERQUE STANDARD SPECIFICATIONS FOR PUBLIC WORKS CONSTRUCTION, 1986 EDITION WITH ALL UPDATES.

THE CONTRACTOR SHALL NOT INSTALL ITEMS AS SHOWN ON THESE PLANS WHEN IT IS OBVIOUS THAT FIELD CONDITIONS ARE DIFFERENT THAN SHOWN IN THE PLANS. SUCH CONDITIONS SHALL BE BROUGHT TO THE ATTENTION OF THE ENGINEER IN A TIMELY MANNER. IN THE EVENT THE CONTRACTOR DOES NOT NOTIFY THE ENGINEER IN A TIMELY MANNER, THE CONTRACTOR ASSUMES FULL RESPONSIBILITY AND EXPENSE FOR ANY REVISIONS NECESSARY, INCLUDING ENGINEERING DESIGN FEES.

EXISTING SITE IMPROVEMENTS WHICH ARE DAMAGED OR DISPLACED BY THE CONTRACTOR SHALL BE REMOVED AND REPLACED BY THE CONTRACTOR AT THE CONTRACTOR'S EXPENSE. REPAIRS SHALL BE APPROVED BY THE OWNER PRIOR TO CONSTRUCTION OF THE REPAIRS. REPAIRS SHALL BE ACCEPTED BY THE OWNER PRIOR TO FINAL

EXISTING FENCING THAT IS NOT DESIGNATED FOR REMOVAL SHALL NOT BE DISTURBED. ANY FENCING THAT IS DISTURBED OR ALTERED BY THE CONTRACTOR SHALL BE RESTORED TO ITS ORIGINAL CONDITION AT THE CONTRACTORS EXPENSE. IF THE CONTRACTOR DESIRES TO REMOVE FENCING TO ACCOMMODATE CONSTRUCTION ACTIVITIES, THE CONTRACTOR SHALL OBTAIN THE OWNER'S WRITTEN PERMISSION BEFORE THE FENCE IS REMOVED. CONTRACTOR SHALL RESTORE THE FENCE TO ITS ORIGINAL CONDITION AT THE EARLIEST OPPORTUNITY. WHILE ANY FENCING IS REMOVED, THE CONTRACTOR SHALL BE SOLELY RESPONSIBLE FOR SECURITY OF THE SITE UNTIL THE FENCE IS RESTORED.

### WORK WITHIN ADJACENT RIGHT-OF-WAY

PRIOR TO BEGINNING ANY CONSTRUCTION ACTIVITIES WITHIN ADJACENT RIGHT-OF-WAYS OR WITHIN PROPERTY NOT OWNED BY THE OWNER OF THE PROJECT SITE, THE CONTRACTOR SHALL ASSURE THAT ALL PERMITS AND PERMISSIONS REQUIRED HAVE BEEN OBTAINED IN WRITING.

# SURVEY MONUMENTS, PROPERTY CORNERS, BENCHMARKS

THE CONTRACTOR SHALL NOTIFY THE OWNER AT LEAST SEVEN DAYS BEFORE BEGINNING ANY CONSTRUCTION ACTIVITY THAT COULD DAMAGE OR DISPLACE SURVEY MONUMENTS, PROPERTY CORNERS, OR PROJECT BENCHMARKS SO THESE ITEMS MAY BE RELOCATED.

ANY SURVEY MONUMENTS, PROPERTY CORNERS, OR BENCHMARKS THAT ARE NOT IDENTIFIED FOR RELOCATION ARE THE RESPONSIBILITY OF THE CONTRACTOR TO PRESERVE AND PROTECT, RELOCATION OR REPLACEMENT OF THESE ITEMS SHALL BE DONE BY THE OWNER'S SURVEYOR AT THE EXPENSE OF THE CONTRACTOR.

#### DIMENSION

- ALL DIMENSIONS TO CURBS ARE TO THE FLOWLINE UNLESS OTHERWISE NOTED.
- ALL STATIONING IS TO THE CENTERLINE OF THE RIGHT-OF-WAY UNLESS OTHERWISE NOTED.
- ALL SLOPES AND GRADES ARE IN PERCENT UNLESS OTHERWISE NOTED.

CURB ELEVATIONS ARE SHOWN AT THE FLOW LINE UNLESS OTHERWISE NOTED. SEE THE DETAIL SHEET TO DETERMINE THE CURB HEIGHT ABOVE FLOW LINE.

### SOILS

UNLESS OTHERWISE SPECIFIED, SUBGRADE, ENGINEERED FILL, AND STRUCTURAL FILL SHALL BE COMPACTED TO THE FOLLOWING SPECIFICATIONS OF THE ASTM D-1557 MAXIMUM DRY DENSITY.

MATERIAL/LOCATION	PERCENT COMPACT
STRUCTURAL FILL IN THE BUILDING AREA	95%
SUBBASE FOR SLAB SUPPORT	95%
MISCELLANEOUS BACKFILL BELOW STRUCTURAL	L_
FILL OR ROADWAY PAVEMENT	95%
MISCELLANEOUS BACKFILL BELOW UNPAVED,	
NON-BUILDING AREAS	90%
ROADWAY PAVEMENT SUBGRADE	95%
SIDEWALK SUBGRADE	90%
CURB AND GUTTER SUBGRADE	95%
COND WIND GOLLEN SOPPOWER	

# PAVEMENT

WHEN ABUTTING NEW PAVEMENT TO EXISTING PAVEMENT, CUT EXISTING PAVEMENT EDGE TO A NEAT, STRAIGHT LINE AS NECESSARY TO REMOVE ANY BROKEN OR CRACKED PAVEMENT AND MATCH NEW PAVEMENT ELEVATION TO EXISTING.

ALL UTILITIES AND UTILITY SERVICE LINES SHALL BE INSTALLED AND APPROVED PRIOR TO PAVING.

ALL WATER VALVE BOXES AND ELECTRICAL, TELEPHONE, TELEVISION, AND SEWER MANHOLES IN THE CONSTRUCTION AREA SHALL BE ADJUSTED TO FINISHED GRADE BEFORE PAVING.

WHEN SIDEWALK OR CURB AND GUTTER IS REMOVED, IT SHALL BE REMOVED TO EXISTING CONSTRUCTION JOINTS. CUTTING OR BREAKING SHALL NOT BE ALLOWED.

### UTILITIES

IF ANY UTILITY LINES, PIPELINES, OR UNDERGROUND UTILITY LINES ARE SHOWN ON THESE DRAWINGS, THEY ARE SHOWN IN AN APPROXIMATE LOCATION ONLY BASED ON THE INFORMATION PROVIDED TO THE ENGINEER BY OTHERS. THIS INFORMATION MAY BE INACCURATE OR INCOMPLETE. ADDITIONALLY, UNDERGROUND LINES MAY EXIST THAT ARE NOT SHOWN. THE CONTRACTOR SHALL VERIFY THE LOCATION OF ANY UTILITY LINE, PIPELINE, OR UNDERGROUND UTILITY LINE IN OR NEAR THE AREA OF THE WORK IN ACCORDANCE WITH CHAPTER 62, ARTICLE 14-1, THROUGH 14-8, NMSA 1978.

THE CONTRACTOR SHALL CONTACT THE STATEWIDE UTILITY LOCATOR SERVICE AT 1-800-321-2537 AT LEAST TWO WORKING DAYS BEFORE BEGINNING CONSTRUCTION. AFTER THE UTILITIES ARE SPOTTED, THE CONTRACTOR SHALL EXPOSE ALL PERTINENT UTILITIES TO VERIFY THEIR VERTICAL AND HORIZONTAL LOCATION. IF A CONFLICT EXISTS BETWEEN EXISTING UTILITIES AND PROPOSED CONSTRUCTION, THE CONTRACTOR SHALL NOTIFY THE ENGINEER SO THAT THE CONFLICT CAN BE RESOLVED WITH MINIMAL DELAY.

THE CONTRACTOR SHALL EXERCISE DUE CARE TO AVOID DISTURBING ANY EXISTING UTILITIES, ABOVE OR BELOW GROUND. UTILITIES THAT ARE DAMAGED BY CARELESS CONSTRUCTION SHALL BE REPAIRED OR REPLACED AT THE CONTRACTOR'S EXPENSE.

EXISTING VALVES SHALL ONLY BE OPERATED BY THE UTILITY COMPANY. CONTRACTOR SHALL NOTIFY THE UTILITY A MINIMUM OF TWO WORKING DAYS BEFORE ANY VALVE, NEW OR EXISTING, NEEDS TO BE OPERATED.

THE CONTRACTOR SHALL COORDINATE ANY REQUIRED UTILITY INTERRUPTIONS WITH THE OWNER AND AFFECTED UTILITY COMPANY A MINIMUM OF THREE WORKING DAYS BEFORE THE INTERRUPTION.

THE CONTRACTOR SHALL MAINTAIN A RECORD DRAWING SET OF PLANS AND PROMPTLY LOCATE ALL UTILITIES, EXITING OR NEW, IN THEIR CORRECT LOCATION, HORIZONTAL AND VERTICAL. THIS RECORD SET OF DRAWINGS SHALL BE MAINTAINED ON THE PROJECT SITE AND SHALL BE AVAILABLE TO THE OWNER AND ENGINEER AT ANY TIME DURING CONSTRUCTION.

# EROSION CONTROL. ENVIRONMENTAL PROTECTION. AND STORM WATER POLLUTION PREVENTION PLAN

THE CONTRACTOR SHALL CONFORM TO ALL CITY, COUNTY, STATE, AND FEDERAL DUST AND EROSION CONTROL REGULATIONS. THE CONTRACTOR SHALL OBTAIN AND PREPARE ANY DUST CONTROL OR EROSION CONTROL PERMITS REQUIRED FROM THE REGULATORY AGENCIES.

THE CONTRACTOR SHALL PROMPTLY REMOVE ANY MATERIAL EXCAVATED WITH THE PUBLIC RIGHT-OF-WAY OR ADJACENT PROPERTY TO KEEP IT FROM WASHING OFF THE PROJECT SITE.

THE CONTRACTOR SHALL ENSURE THAT NO SOIL ERODES FROM THE SITE ONTO ADJACENT PROPERTY BY CONSTRUCTION OF TEMPORARY EROSION CONTROL BERMS OR INSTALLING SILT FENCES AT THE PROPERTY LINES AND WETTING THE SOIL TO PREVENT IT FROM BLOWING.

WATERING, AS REQUIRED FOR CONSTRUCTION DUST CONTROL, SHALL BE CONSIDERED INCIDENTAL TO CONSTRUCTION AND NO MEASUREMENT OR PAYMENT SHALL BE MADE. CONSTRUCTION AREAS SHALL BE WATERED FOR DUST CONTROL IN COMPLIANCE WITH GOVERNMENT ORDINANCES. THE CONTRACTOR SHALL BE RESPONSIBLE FOR LOCATING AND SUPPLYING WATER AS REQUIRED.

ANY AREAS DISTURBED BY CONSTRUCTION AND NOT COVERED BY LANDSCAPING OR IMPERVIOUS SURFACES SHALL BE REVEGETATED WITH RECLAMATION SEEDING.

THE CONTRACTOR SHALL PROPERLY HANDLE AND DISPOSE OF ALL ASPHALT REMOVED ON THE PROJECT BY HAULING IT TO AN APPROVED DISPOSAL SITE IN ACCORDANCE WITH THE REQUIREMENTS OF THE NEW MEXICO SOLID WASTE ACT.

ALL WASTE PRODUCTS FROM THE CONSTRUCTION SITE, INCLUDING ITEMS DESIGNED FOR REMOVAL, CONSTRUCTION WASTE, CONSTRUCTION EQUIPMENT WASTE PRODUCTS (OIL, GAS, TIRES, ETC.), GARBAGE, GRUBBING, EXCESS CUT MATERIAL, VEGETATIVE DEBRIS, ETC.. SHALL BE APPROPRIATELY DISPOSED OF OFFSET AT NO ADDITIONAL COST TO THE OWNER. IT SHALL BE THE CONTRACTOR'S RESPONSIBILITY TO OBTAIN ANY PERMITS REQUIRED FOR HAUL OR DISPOSAL OF WASTE PRODUCTS, IT SHALL BE THE CONTRACTOR'S RESPONSIBILITY TO ENSURE THAT THE WASTE DISPOSAL SITE COMPLIES WITH GOVERNMENT REGULATIONS REGARDING THE ENVIRONMENT, ENDANGERED SPECIES, AND ARCHAEOLOGICAL RESOURCES.

THE CONTRACTOR SHALL BE RESPONSIBLE FOR THE CLEANUP AND REPORTING OF SPILLS OF HAZARDOUS MATERIALS ASSOCIATED WITH THE CONSTRUCTION SITE. HAZARDOUS MATERIALS INCLUDE GASOLINE, DIESEL FUEL, MOTOR OIL, SOLVENTS, CHEMICALS, PAINT, ETC. WHICH MAY BE A THREAT TO THE ENVIRONMENT. THE CONTRACTOR SHALL REPORT THE DISCOVERY OF PAST OR PRESENT SPILLS TO THE NEW MEXICO EMERGENCY RESPONSE AT 1-800-219-6157.

THE CONTRACTOR SHALL COMPLY WITH ALL APPLICABLE REGULATIONS CONCERNING SURFACE AND UNDERGROUND WATER. CONTACT WITH SURFACE WATER BY CONSTRUCTION EQUIPMENT AND PERSONNEL SHALL BE MINIMIZED. EQUIPMENT MAINTENANCE AND REFUELING OPERATIONS SHALL BE PERFORMED IN AN ENVIRONMENTALLY SAFE MANNER IN COMPLIANCE WITH GOVERNMENT REGULATIONS.

THE CONTRACTOR SHALL COMPLY WITH ALL APPLICABLE REGULATIONS CONCERNING CONSTRUCTION NOISE AND HOURS OF OPERATION.

# ACCESSIBLE FACILITIES

ALL SURFACES ALONG ACCESSIBLE ROUTES AND FOR HANDICAP RAMPS SHALL BE STABLE FIRM, SLIDE RESISTANT AND SHALL COMPLY WITH UNIFORM FEDERAL ACCESSIBILITY STANDARDS, PARAGRAPH 4.5.

LONGITUDINAL SLOPES ALONG ACCESSIBLE ROUTE SIDEWALKS, EXCEPT AT HANDICAP RAMPS, SHALL NOT BE STEEPER THAN 1: 20. CROSS SLOPES ALONG ACCESSIBLE ROUTE SIDEWALKS EXCEPT AT HANDICAP RAMPS, SHALL NOT BE STEEPER THAN 1: 48. SLOPES IN ACCESSIBLE PARKING SPACES, ACCESS AISLES, AND PASSENGER LOADING ZONES SHALL NOT BE STEEPER THAN 1: 48 IN ALL DIRECTIONS.


THE SITE SHALL COMPLY WITH ANSI A117.1-1992, "ACCESSIBLE AND USABLE BUILDINGS AND FACILITIES".

# TRAFFIC CONTROL

THE CONTRACTOR SHALL PROVIDE ALL REQUIRED TRAFFIC CONTROL PLANS. ALL SIGNS, BARRICADES, CHANNELIZATION DEVICES, SIGN FRAMES AND ERECTION OF SUCH DEVICES SHALL CONFORM TO THE REQUIREMENTS OF "MANUAL OF UNIFORM TRAFFIC CONTROL DEVICES FOR STREETS AND HIGHWAYS" LATEST EDITION. PRIOR TO CONSTRUCTION, TRAFFIC CONTROL PLANS SHALL BE APPROVED BY THE GOVERNING AUTHORITY.

# ABBREVIATIONS

AD = AREA DRAIN	DTL = DETAIL	GV = GATE VALVE	RCP = REINFORCED CONCRETE PIPE	TCC =
AIP = ABANDONED IN PLACE	DWG = DRAWING	HI PT = HIGH POINT	R/W = RIGHT-OF-WAY	TG = TOP OF GRATE
BLDG = BUILDING	E = ELECTRIC LINE	INV = INVERT ELEVATION	SAS = SANITARY SEWER	TS = TOP OF SIDEWALK
BM = BENCHMARK	ELEC. = ELECTRIC	LF = LINEAL FEET	SD = STORM DRAIN	TW = TOP OF WALL
CATV = CABLE TELEVISION LINE	ELEV = ELEVATION	MH = MANHOLE	STA = STATION	TYP = TYPICAL
CMP = CORRUGATED METAL PIPE	EX = EXISTING	NG = NATURAL GROUND	STD = STANDARD	TB = TELEPHONE BOX
CO = CLEANOUT	FF = FINISHED FLOOR ELEVATION	OE = OVERHEAD ELECTRIC LINE	SW = SIDEWALK	UE =
COA = CITY OF ALBUQUERQUE	FG = FINISHED GRADE	PCC = PORTLAND CEMENT CONCRETE	T = TELEPHONE	UT =
CONC = CONCRETE	FH = FIRE HYDRANT	PP = POWER POLE	TA = TOP OF ASPHALT PAVEMENT	W = WATER
CL = CENTERLINE	FL = FLOW LINE	PROP = PROPOSED	TAC = TOP OF ASPHALT CURB	WM = WATER METER
DIA = DIAMETER	GM = GAS METER	PVC = POLYVINYL CHLORIDE PIPE	TC = TOP OF CONCRETE SLAB (PAVEMENT)	WV WATER VALVE

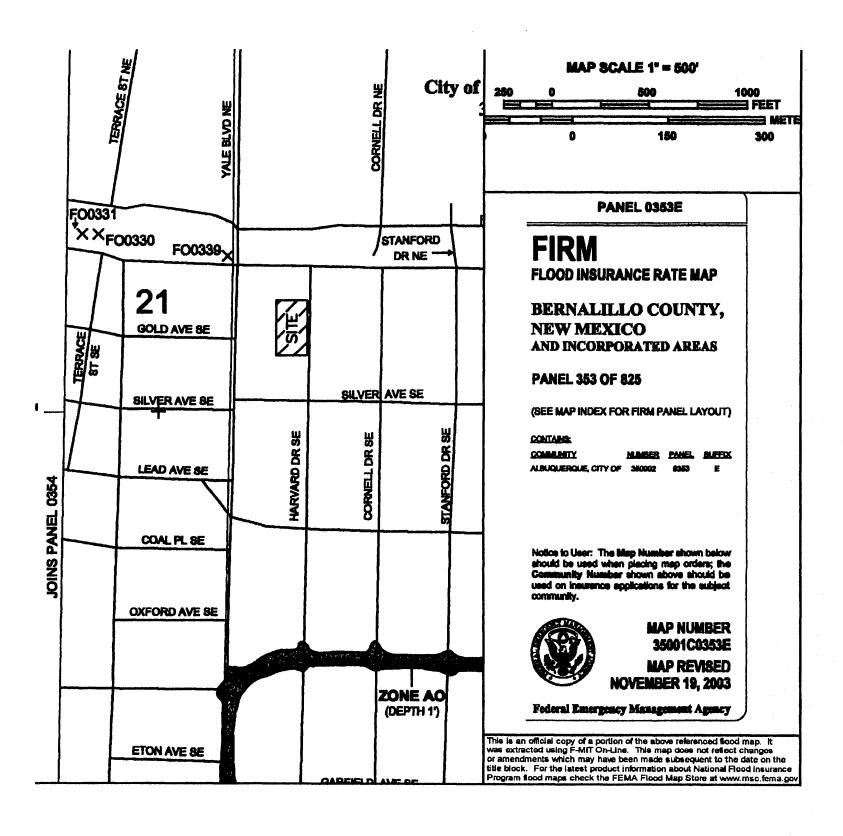

#### 100-YEAR HYDROLOGIC CALCULATIONS

		L	AND TRI	EATMEN	T	WEIGHTED					
BASIN	AREA	Α	В	С	D	E	V (6-hr)	V (6-hr)	V(10 day)	V(10 day)	Q
#	(acre)	(%)	(%)	(%)	(%)	(in)	(acre-ft)	(cu-ft)	(acre-ft)	(cu-ft)	(cfs)
EXISTING CONDITIONS											
SITE	0.8150	0.00	5.00	5.00	90.00	2.00	0.14	5,927	0.23	10,187	3.67
					PROPOS	SED CONDITI	ONS		_	<del></del>	
SITE	0.8150	0.00	5.00	5.00	90.00	2.00	0.14	5,927	0.23	10,187	3.67
EXCESS	PRECIP.	0.53	0.78	1.13	2.12	E (in)					
	CHARGE	1.56	2.28	3.14	4.7	QPI (cfs)					
· · · · · · · · · · · · · · · · · · ·	······································		<del></del>	<del></del>	<del> </del>	······································			ZONE =	2	
WEIGHTE	DE(in) = (8)	Ea)(%A) -	ь (Ев)(%B	) + (Ec)(%	6C) + (Ев	)(%D)			Р <sub>6-ня</sub> (in.) =	2.35	
V <sub>6-HR</sub> (acre-	-ft) = (WEIG	HTED E	)(AREA)/	12					P <sub>24-HR</sub> (in.) =	2.75	
V10DAY (acre	e-ft) = V <sub>6-ня</sub>	+ (AD)(P1	0DAY - P6-H	a)/12					P10DAY (in.) =	3.95	
Q (cfs) = (6	Qpa)(Aa) + (6	Q <sub>PB</sub> )(A <sub>B</sub> ) -	+ (Qpc)(Ad	c) + (Q <sub>PD</sub> )	(A <sub>D</sub> )						

# DRAINAGE INFORMATION

# LOCATION & DESCRIPTION

THE PROPOSED SITE IS 0.815 ACRES LOCATED ON THE WEST SIDE OF HARVARD DRIVE AND SOUTH OF CENTRAL AVENUE AS SEEN ON THE VICINITY MAP ON SHEET COO1. THE LOT IS DEVELOPED WITH DEVELOPED LOTS NORTH AND SOUTH OF IT. IT IS BOUNDED BY HARVARD DRIVE TO THE EAST AND AN ALLEY TO THE WEST.

# FLOOOPLAIN STATUS

THIS PROJECT, AS SHOWN ON FEMA'S FLOOD INSURANCE RATE MAP 35001C0353 E, DATED NOVEMBER 19, 2003 IS NOT WITHIN ANY DESIGNATED 100-YEAR FLOODPLAIN. A PORTION OF THIS PANEL WITH THE SITE DESIGNATED ON IT IS INCLUDED ON THIS SHEET.

# METHODOLOGY

THE HYDROLOGY FOR THIS PROJECT WAS ANALYZED USING THE QUICK CALCULATION METHOD AS DOCUMENTED IN THE JUNE 1997 RELEASE OF THE CITY OF ALBUQUERQUE DEVELOPMENT PROCESS MANUAL, SECTION 22.2.

# EXISTING DRAINAGE

THE SITE IS DEVELOPED AS DESCRIBED ABOVE IN "LOCATION AND DESCRIPTION." THE EXISTING BUILDINGS HAVE PITCHED ROOFS DRAINING NORTH AND SOUTH. THE GROUND IS COVERED WITH BRICK PAVERS WITH A HIGH POINT AT APPROXIMATELY THE EAST PROPERTY LINE DRAINING THESE LOTS WEST TO THE ALLEY AT APPROXIMATELY A 0.75% GRADE. THE BRICK PAVERS WITHIN THE HARVARD RIGHT—OF—WAY DRAIN TO THE STREET. THE SITE IS 90% IMPERVIOUS. THE ALLEY WHICH DRAINS THIS SITE HAS APPROXIMATELY A 2" INVERTED CROWN CENTERED WITHIN THE 16' WIDTH AND SLOPES FROM NORTH TO SOUTH AT APPROXIMATELY A 0.45% GRADE. DUE TO EXISTING DEVELOPMENT, ALL RUNOFF IS DIRECTED TO EITHER HARVARD STREET OR THE ALLEY. THEREFORE, THERE IS NO OFFSITE RUNOFF ENTERING THIS SITE.

# DEVELOPED CONDITION

THESE FIVE LOTS WILL BE REPLATTED INTO A SINGLE LOT WITH FOUR NEW STRUCTURES. SIMILAR TO EXISTING CONDITIONS, THE FOUR BUILDINGS WILL DRAIN INTO THE THREE LANDSCAPED AREAS BETWEEN THE BUILDINGS. THESE LANDSCAPED AREAS WILL BE GRADED TO DRAIN WEST TO THE ALLEY. THIS DEVELOPMENT WILL ALSO BE 90% IMPERVIOUS. THEREFORE, NO CHANGES WILL BE MADE TO THE EXISTING RUNOFF FROM THIS SITE. THE HARVARD RIGHT—OF—WAY WILL REMAIN AS IT IS WITH BRICK PAVERS. A SMALL AREA OF THE STREET WILL BE NARROWED TO MATCH THE STREET SECTION TO THE SOUTH BUT DRAINAGE WILL NOT BE ALTERED.

LARRY READ & ASSOCIATES
Civil Engineers

2430 Midtown Place, NE Suite C Albuquerque, New Mexico 87107 (505) 345-0620 Fax (505) 237-8422 Tev date by revision

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Mullen Heller

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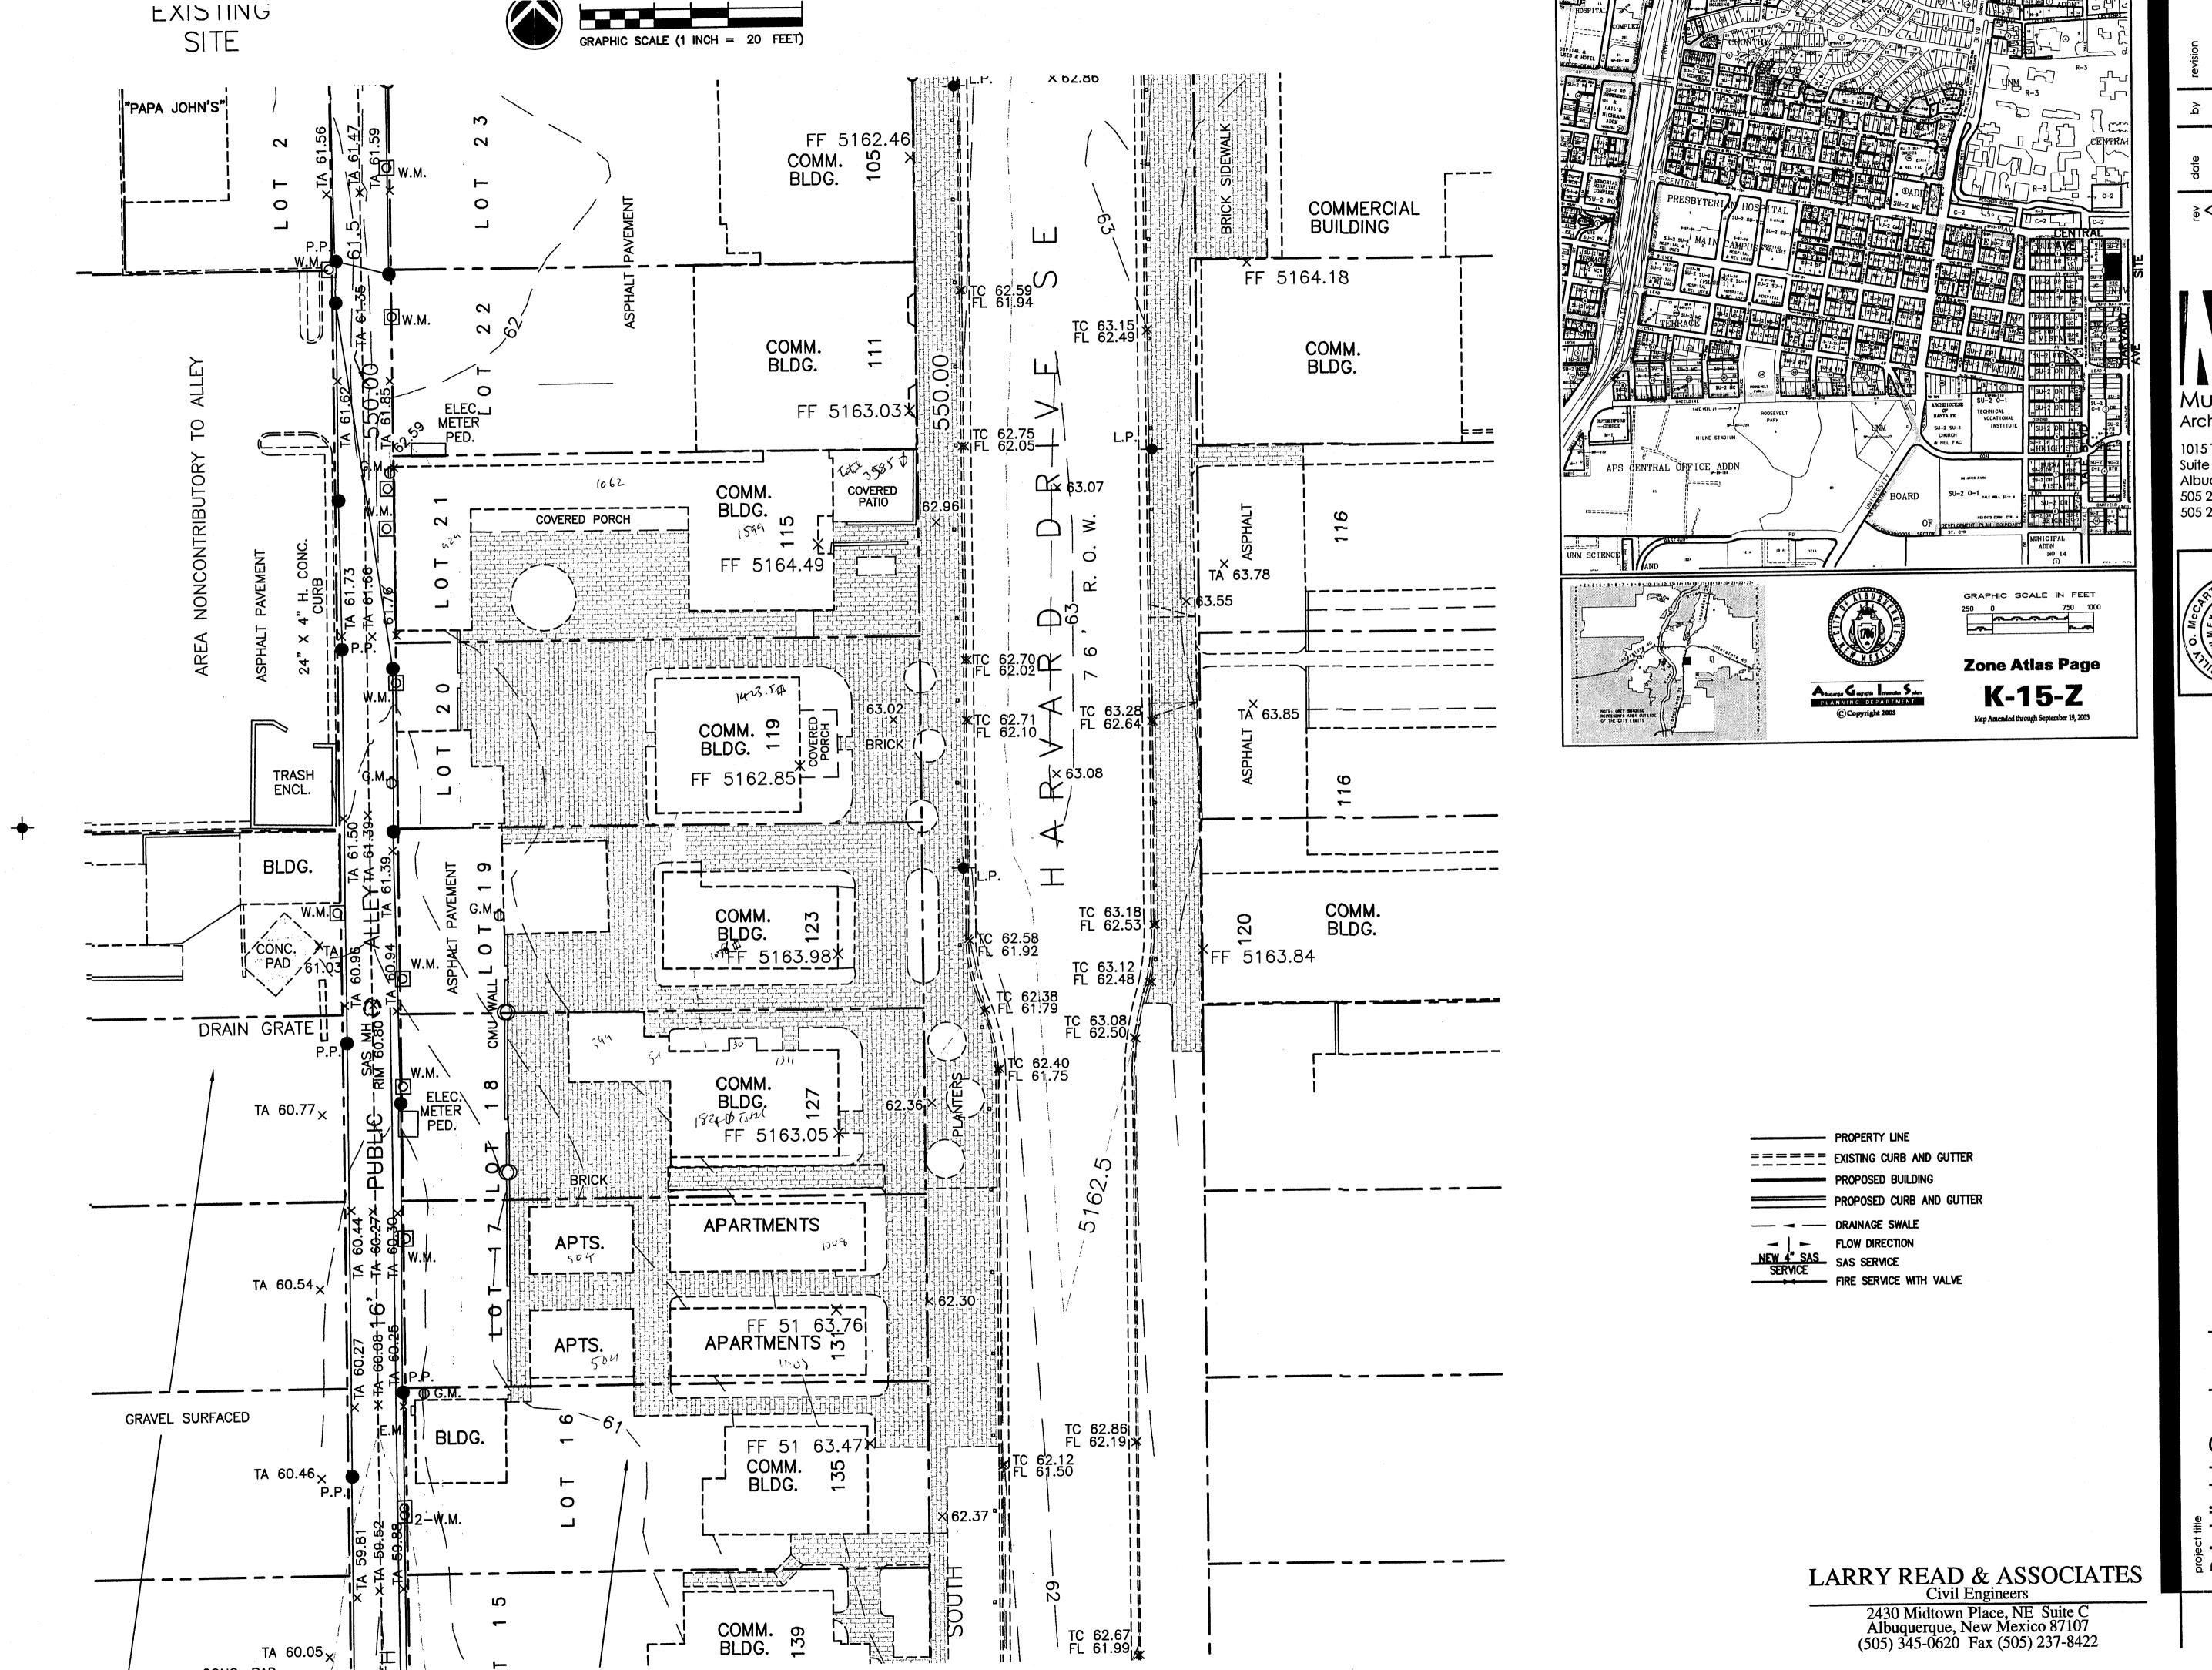


job number 06-01
drawn by BOM
project manager JDH
date 11/14/06

-21, Block 1, University Heights
ew Mexico

Briect BriC Lots

C00



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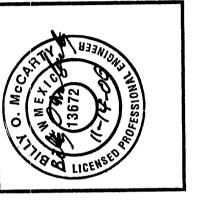
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Mullen Heller

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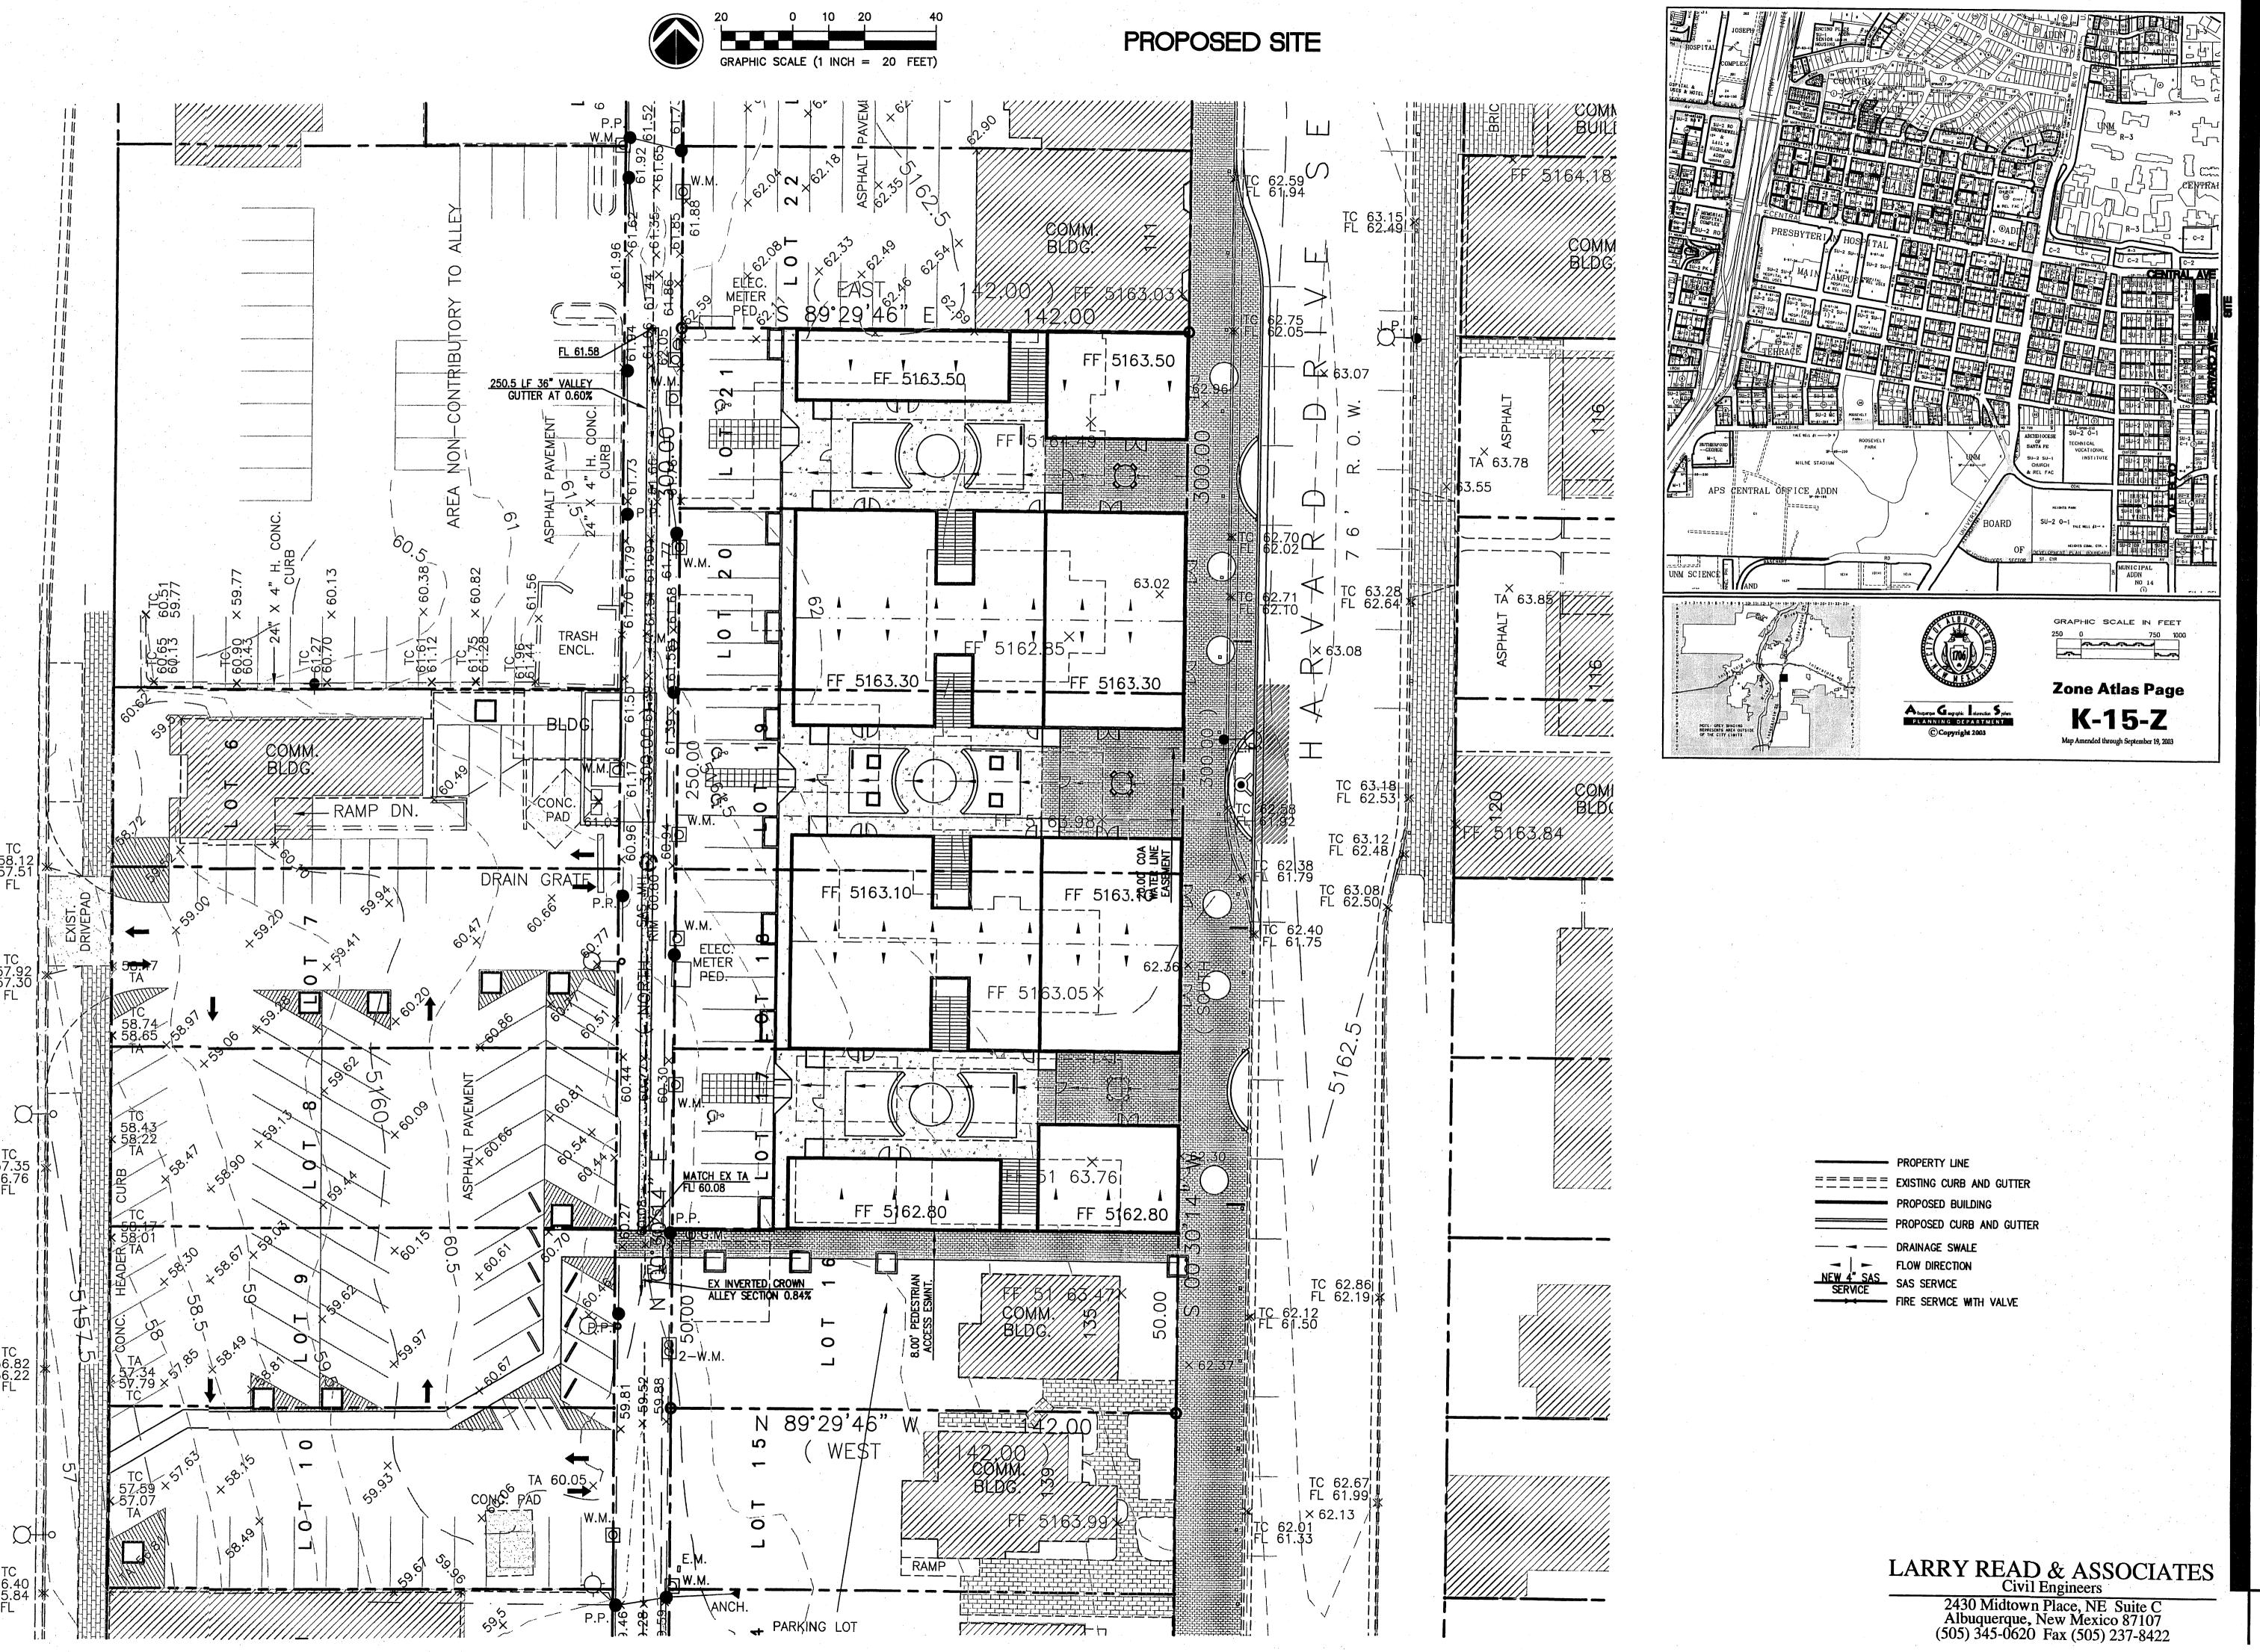


job number 06-01
drawn by BOM
project manager JDH
date 11/14/06

ards , University Heights

Bricklight Courtyards
Lots 6-10, 17-21, Block 1, University
Albuquerque, New Mexico
sheet title
Grading and Drainage

sheet-




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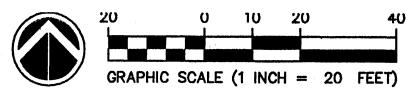



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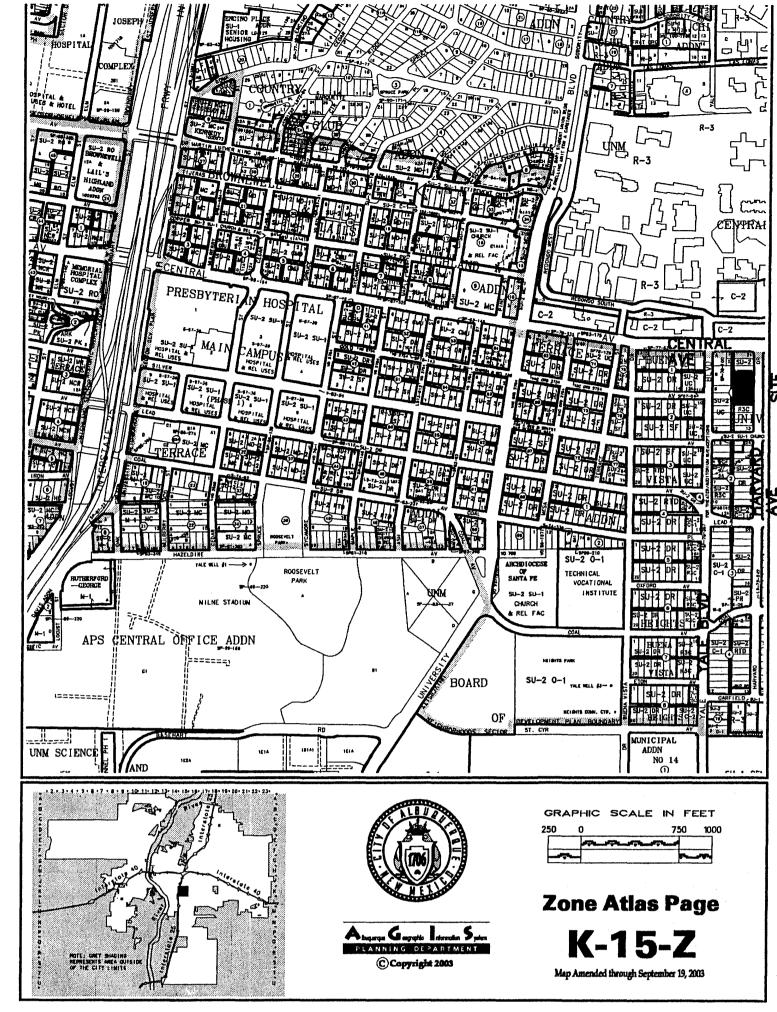
OUTYOLOS Block 1, University Heights exico

Bricklight Courtyons Lots 6–10, 17–21, Block 1, Albuquerque, New Mexico

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----- PROPERTY LINE ---- DRAINAGE SWALE FLOW DIRECTION NEW 4" SAS SERVICE FIRE SERVICE WITH VALVE


LARRY READ & ASSOCIATES

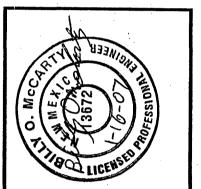Civil Engineers

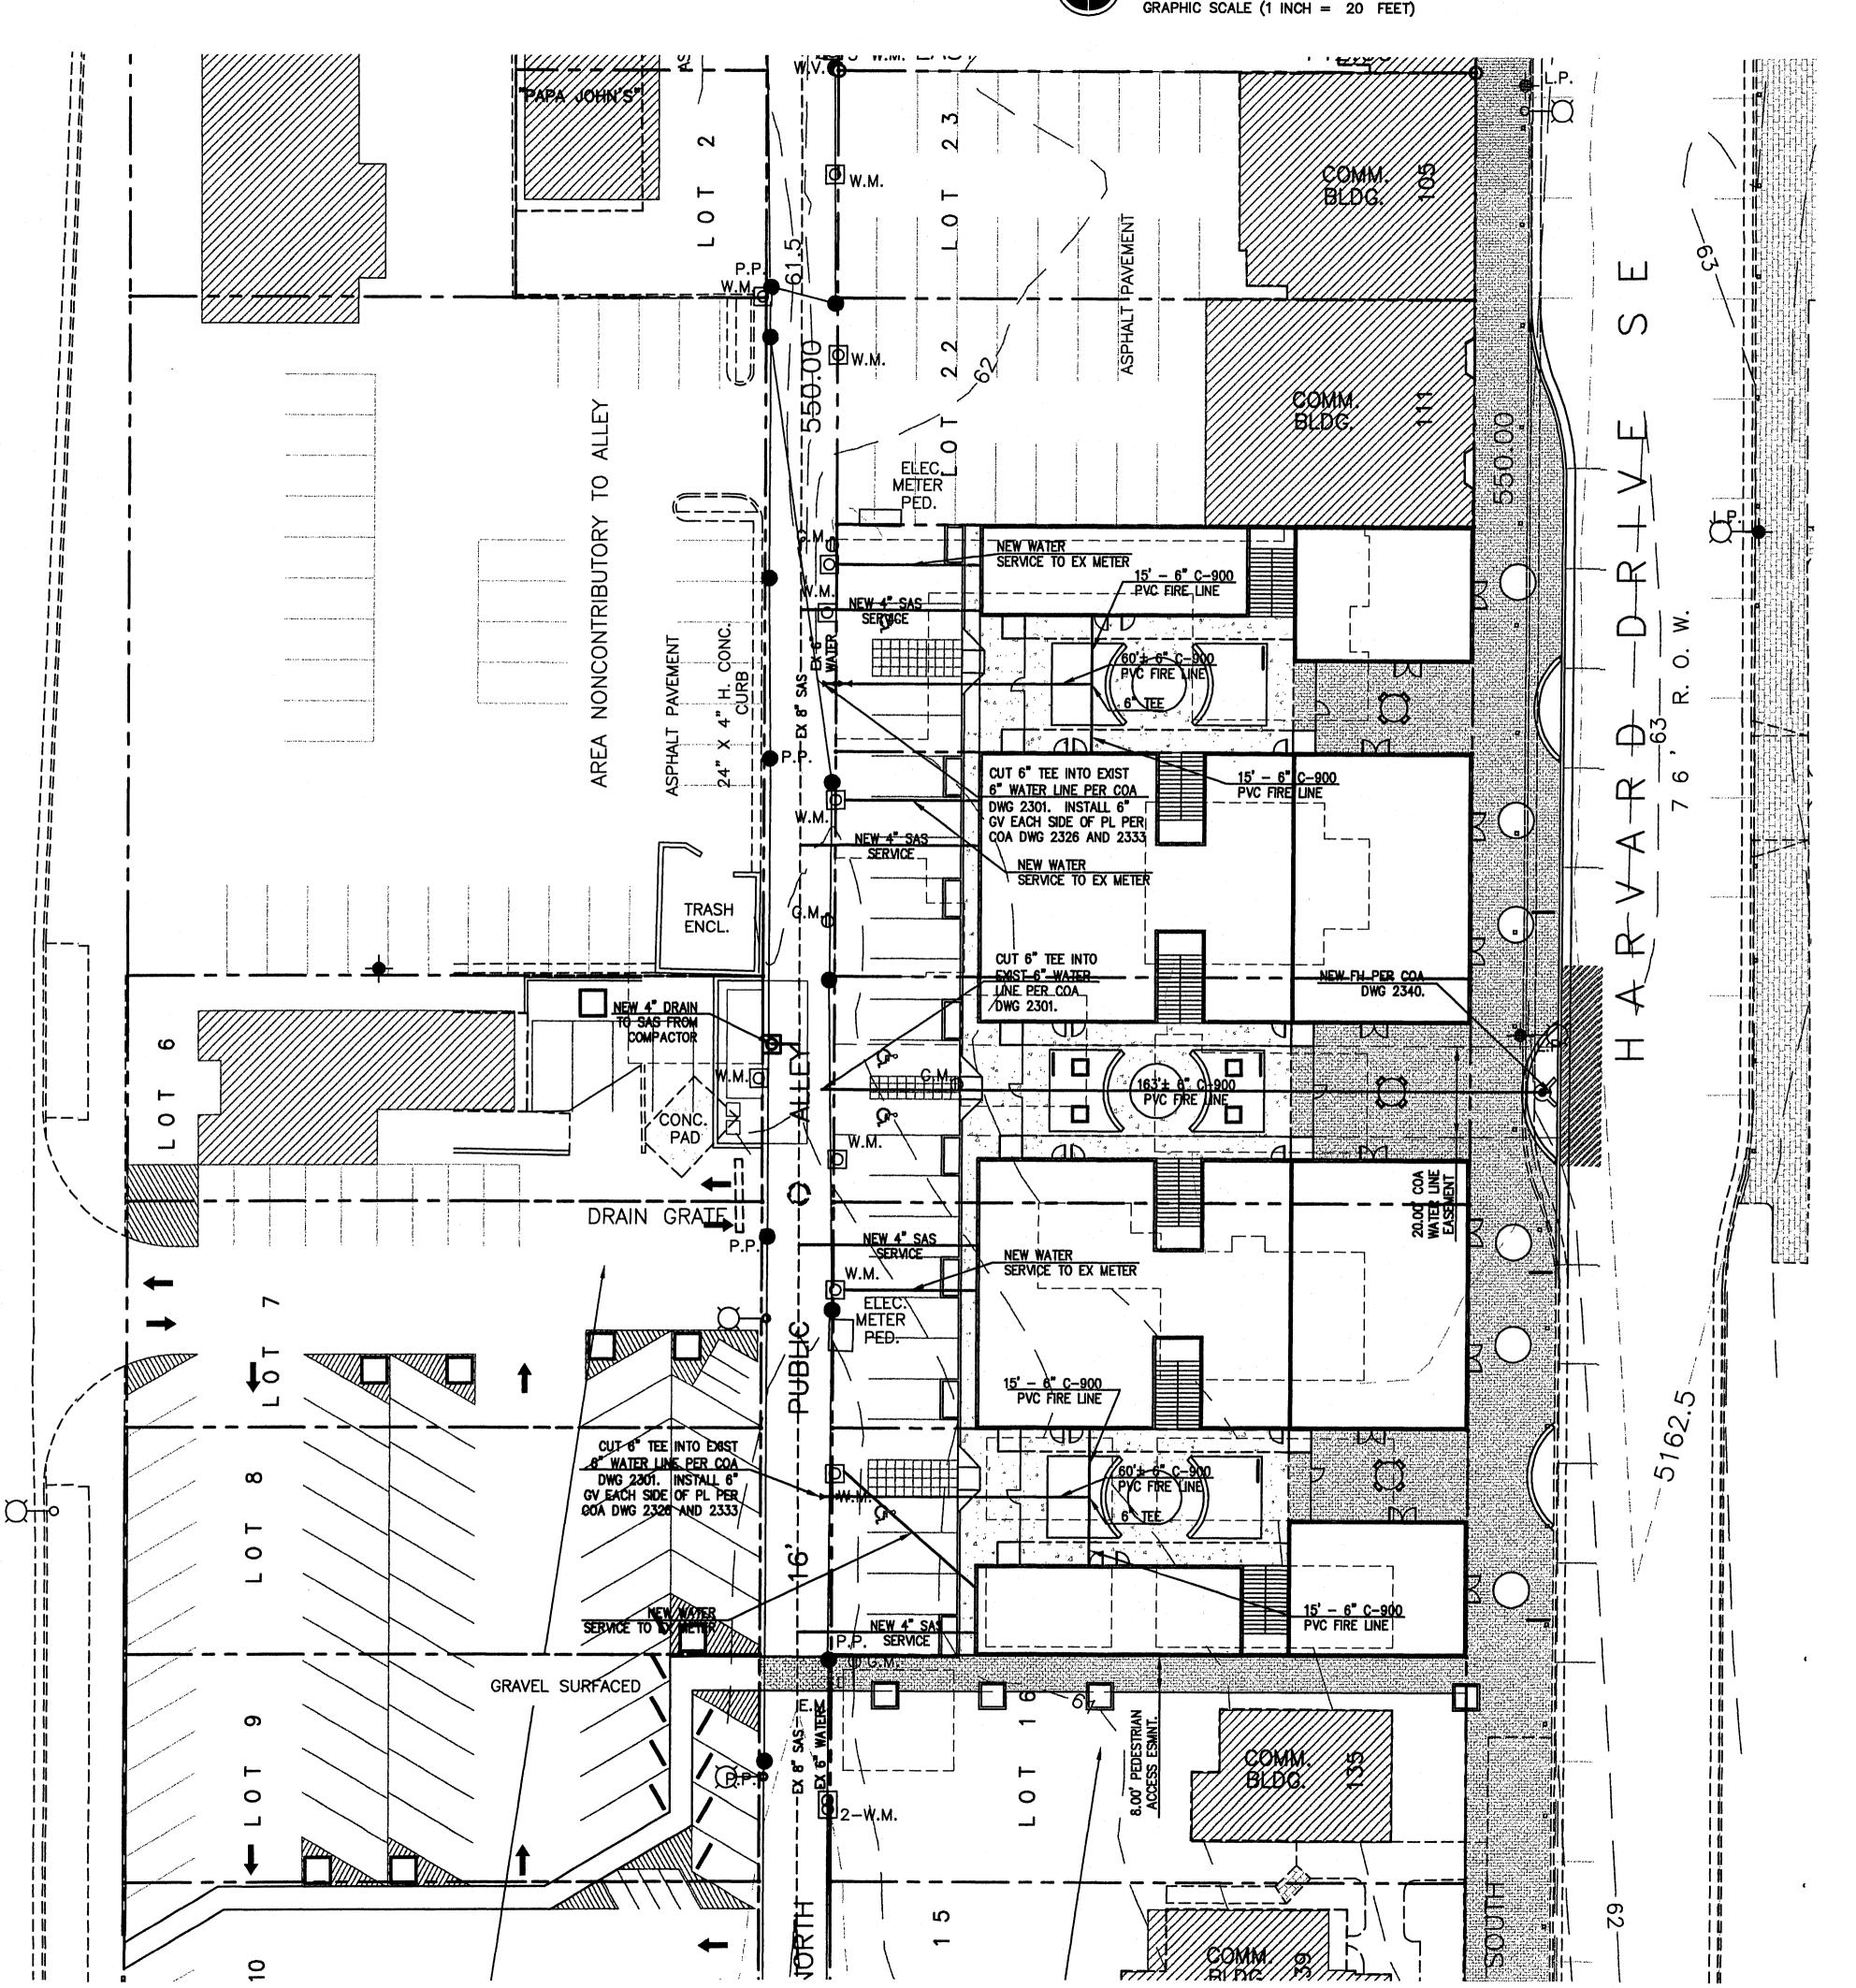2430 Midtown Place, NE Suite C
Albuquerque, New Mexico 87107
(505) 345-0620 Fax (505) 237-8422


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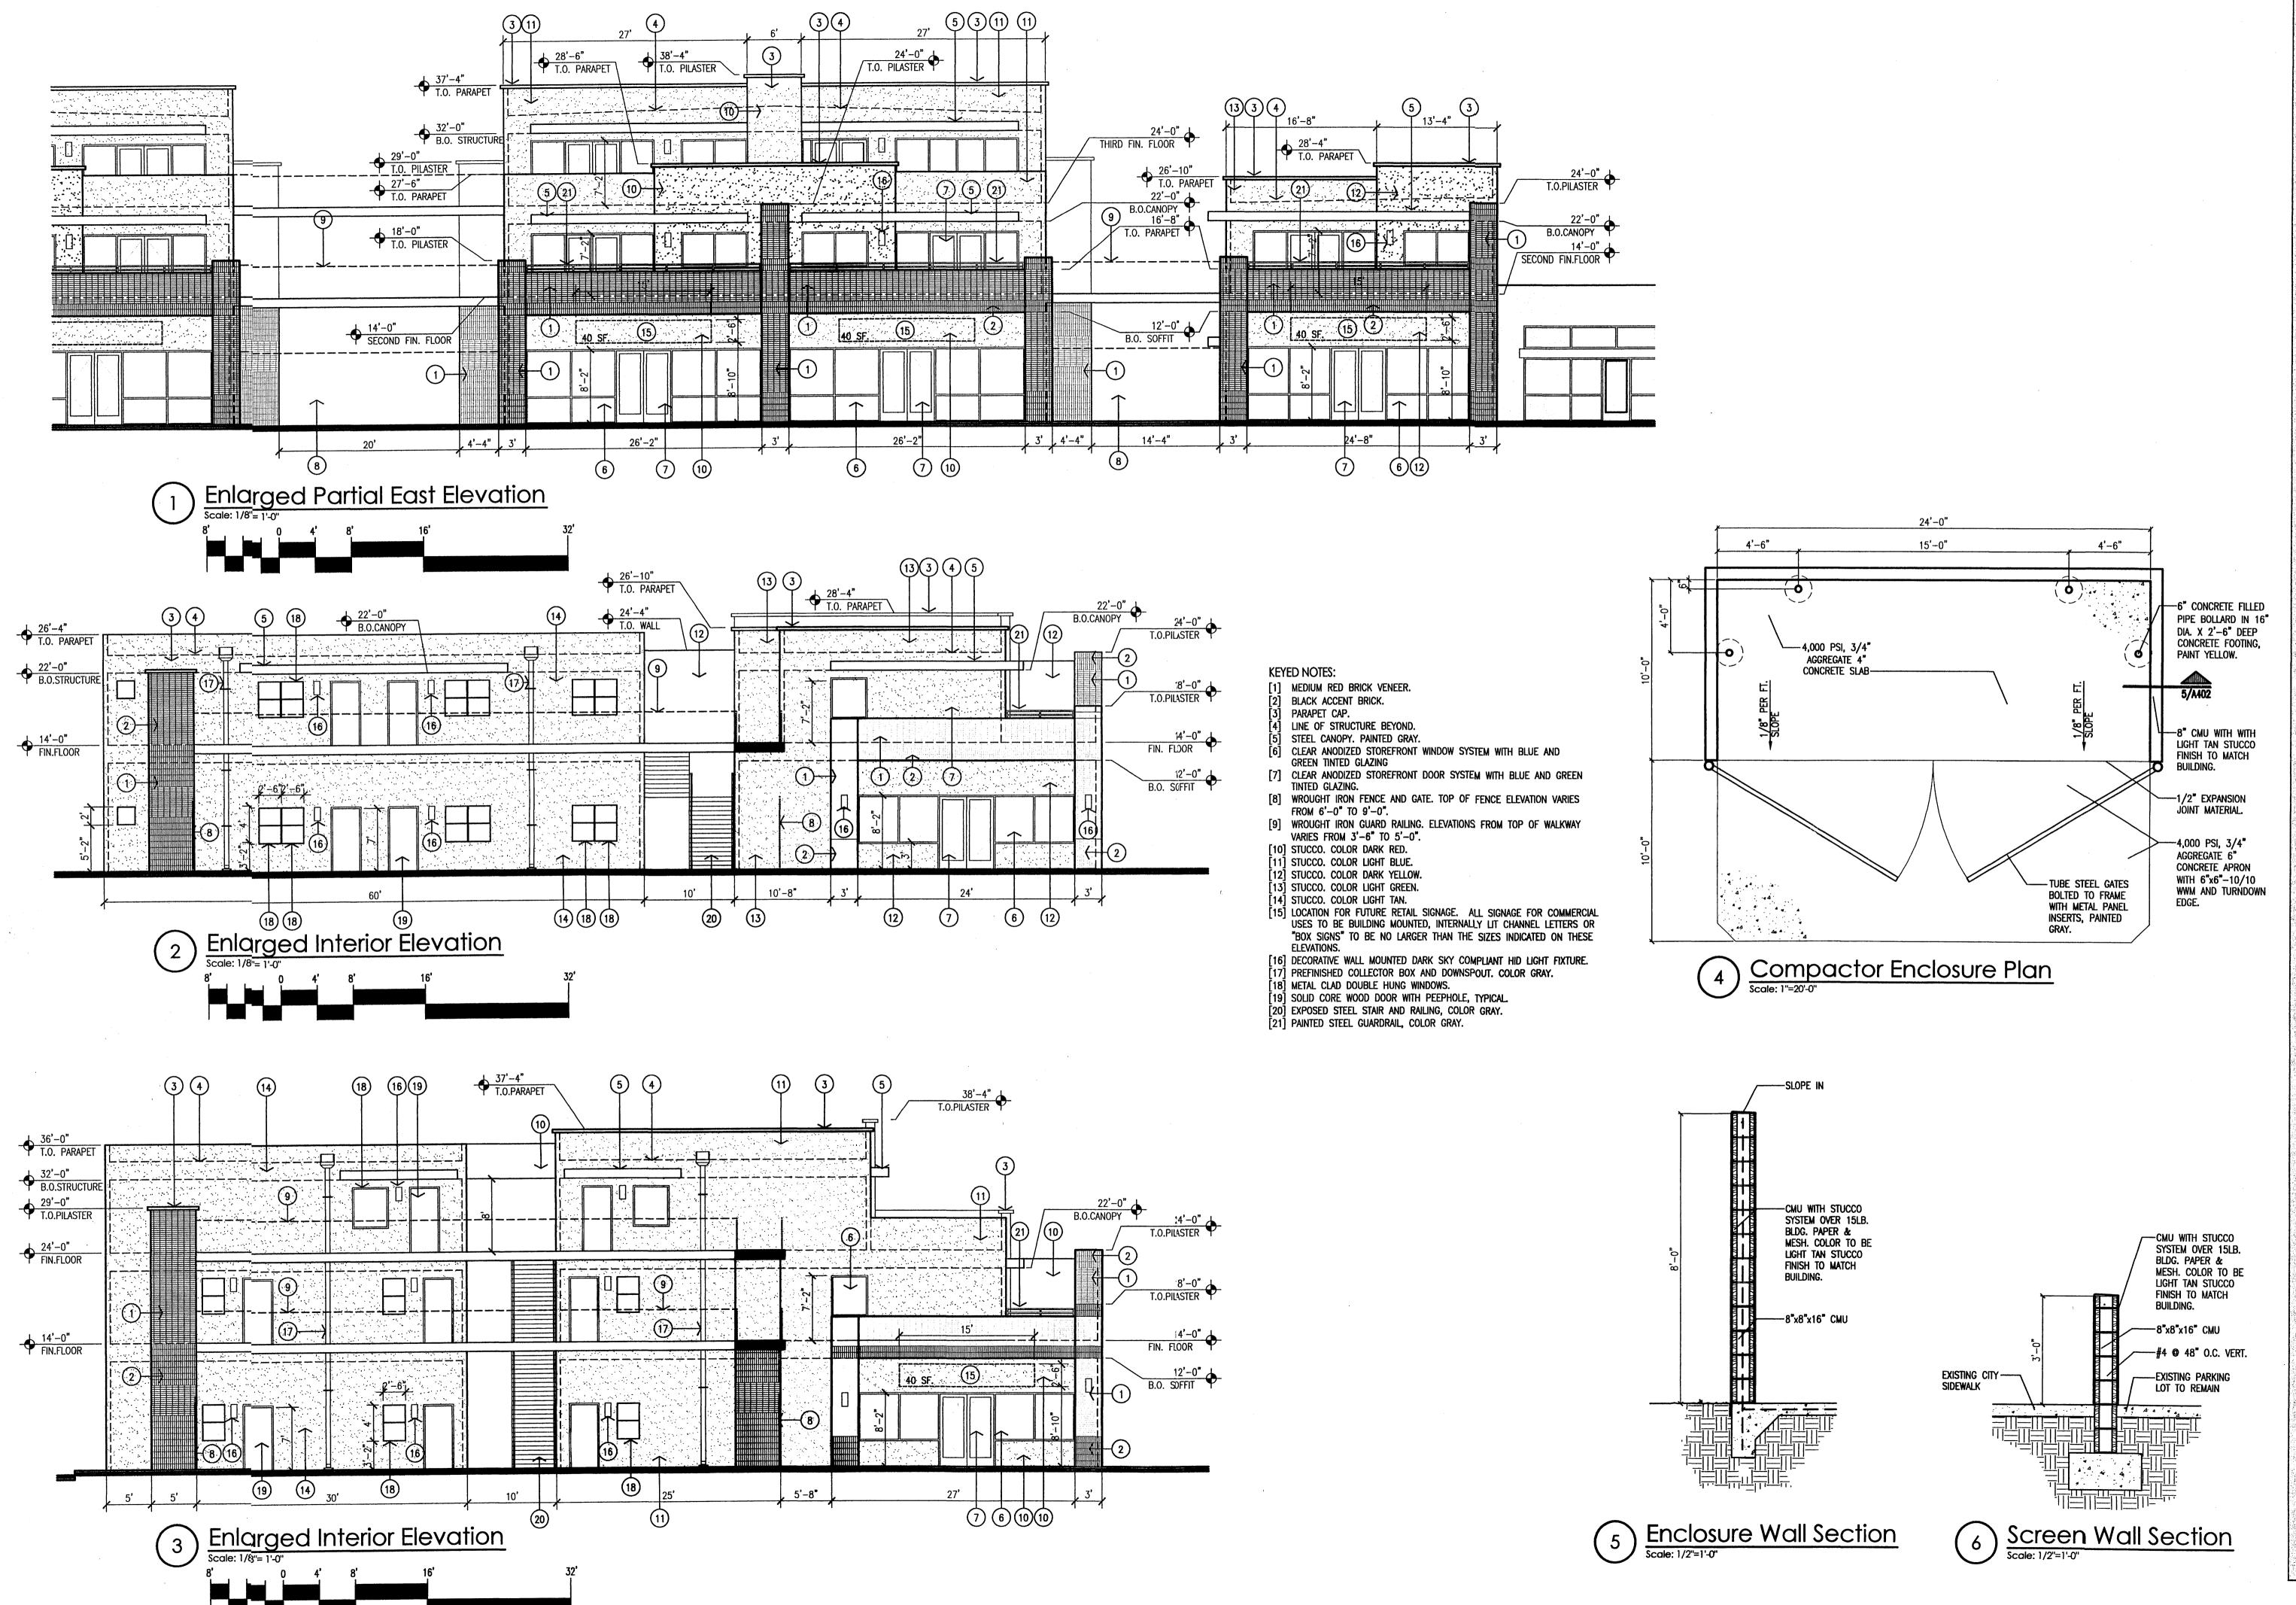


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Albuquerque 87102
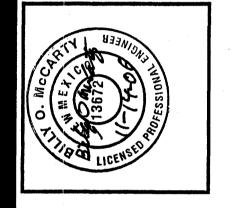
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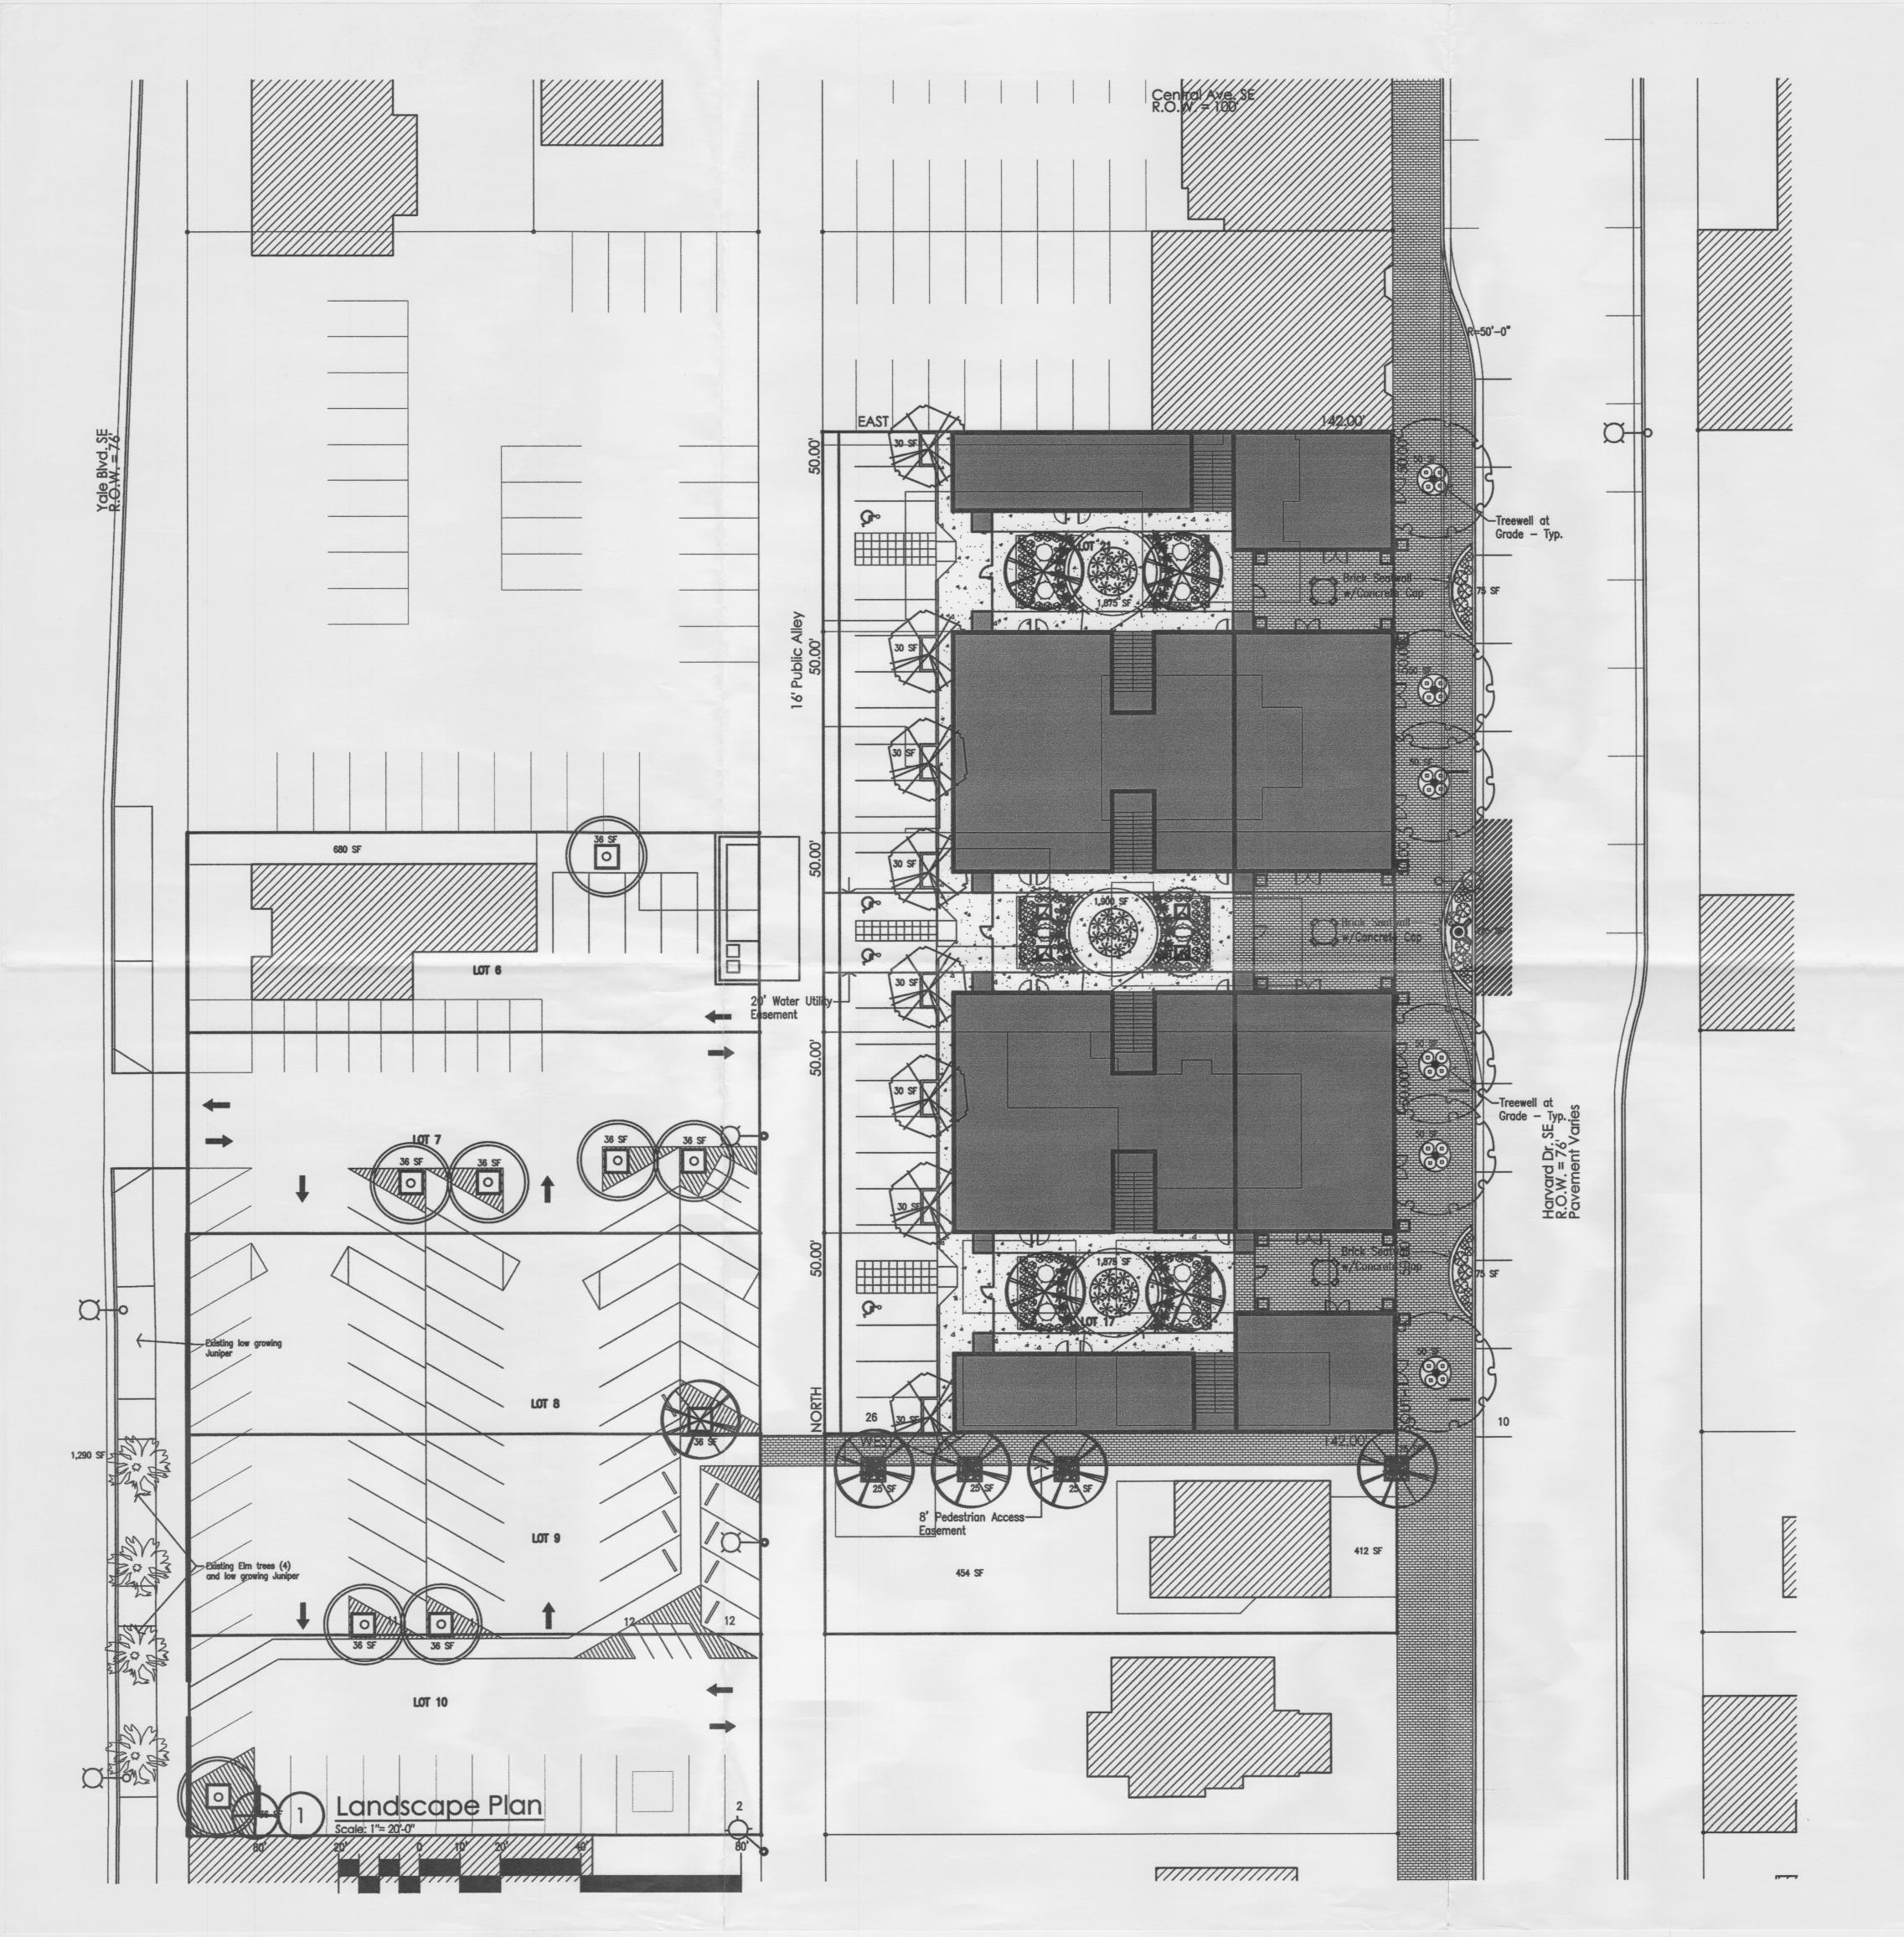


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Bricklight Courtyards
Lots 6–10,17–21, Block 1, University Heights
Albuquerque, New Mexico
sheet title
Enlarged Exterior Elevations

A402

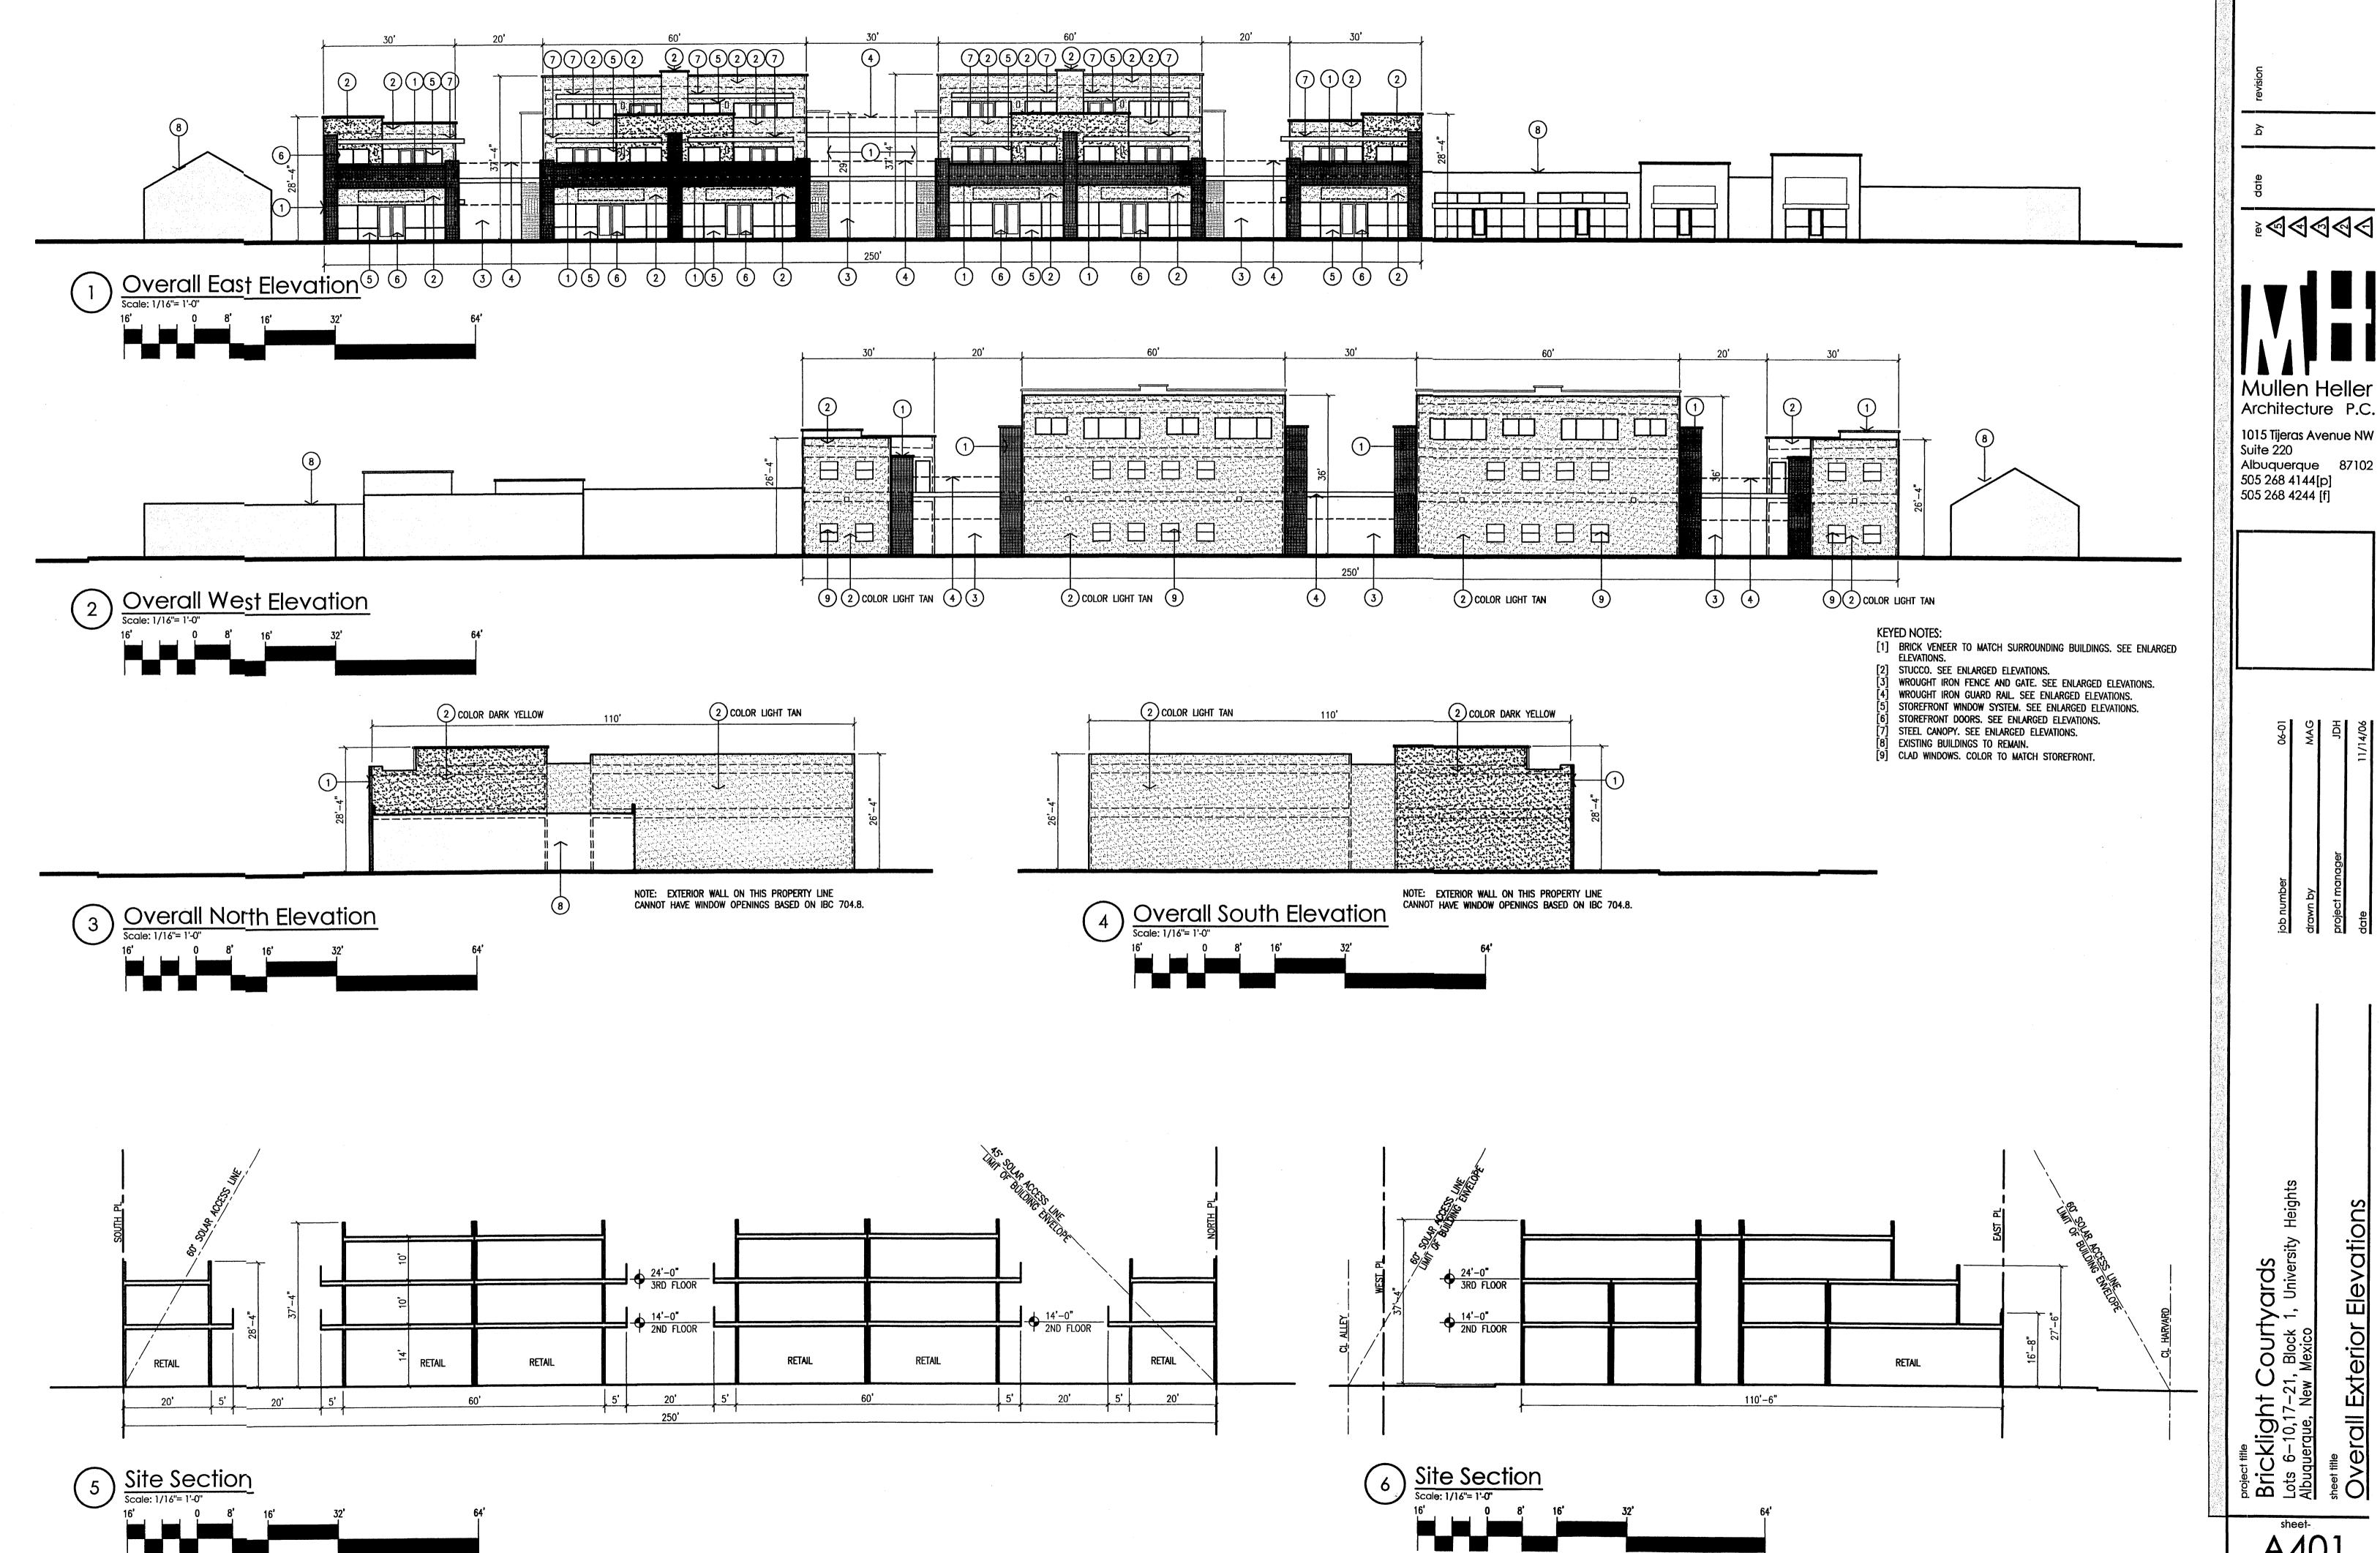

# LANDSCAPE PALETTE

THIM	JOUANT PALETTE	
Symbol	Botanical Name / Common Name	Mature Size Water Use
	Trees Existing Trees to Remain	
8	Chitalpa tashkentensis Chitalpa	30' x 30' Medium
$\odot$	Zelková serrata Zelková	50' x 40' Medium+
0	Koeireuteria paniculata Golden Raintres	20' x 20' Medium
8	Lagerstroemia indica Crape Myrtle	15' x 15' Medium+
8	Robinia x ambigua Purple Robe Locust	25' x 25' Medium
0	Shrubs/Groundcovers Buddleia davidii "Nanhoensis" Butterfly Bush	48" x 48" Medium
	Caryopteris clandonensis Blue Mist	36" x 36" Medium
$\otimes$	Cytisus x 'Lena' Lena's Broom	36" x 36" Medium
8	Lavandula angustifolia English Lavender	24° × 24° Medium
0	Potentilla fruticosa Shrubby Cinquefoil	36" x 36" Medium +
*	Rosmarinus officinalis Prostrate Rosemary	24° x 48° Low +
*	Omamental Grasses Nassella termuissima Threadgrass	24" × 24" Low +

# LANDSCAPE CALCULATIONS

Total Site Area: (1.76 a	cres) 76,666	SF
Building Area:	20,384	SF
Net Area:	56,282	SF
Required Landscape Area (15% of Net Area):	8,442	SF
Provided Landscape Area:	•9,853	SF
<ul> <li>includes existing landscaping on Lots 6 and 16, courtyard areas.</li> </ul>	and the (3) er	nclose

# LANDSCAPE NOTES

Due to the current site plan proposal, all existing trees on site shall be removed.

TREE REQUIREMENTS

Based on the City Zoning Code (trees per dwelling unit), 27 trees are required for this site. We have provided 26 trees, including 4 in pots in the utility easement between the 2 center buildings. We have provided 3 pots within the parking lot to provide for tree requirements within the parking lot. Four existing trees along Yale satisfy the street tree requirement for Yale.

PLANT MATERIAL

The plant material selected for this project is in keeping with the existing plant material used throughout the Harvard corridor. The palette includes material that is considered High or Medium + in terms of water use. These species are used sparingly and are intended to blend with the surrounding landscape. It is our intent to provide structural soil in paved areas surrounding the trees along Harvard. This will provide a larger area of planting medium to aid the long-term health of those trees.

MULCHES
All shrub planting areas shall be top dressed with 3" layer of pecan shells.

IRRIGATION SYSTEM
Irrigation system standards outlined in the Water Conservation Landscaping and Water
Waste Ordinance shall be strictly adhered to. A fully automated drip irrigation system will
be used to irrigate tree, shrub and groundcover planting areas.

# MAINTENANCE RESPONSIBILITY

Maintenance of the landscaping and irrigation system, including those areas within the public ROW, shall be the responsibility of the property owner.

STATEMENT OF WATER WASTE
Using the "planting restriction" approach within the Water Conservation Landscaping and
Water Waste Ordinance, the Landscape Plan for the Harvard Redevelopment shall limit the
provision of high water use turf to a maximum of 20 percent of the required landscape
area. The current landscape plan does not contain any high water use turf.



CONSENSUS PLANNING, INC.

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Courtyards

Bricklight
Lots 17-21, Blo
Albuquerque, Nev

# Bricklight Courtyards-DRB Submittal

# PROJECT DATA

```
LEGAL DESCRIPTION:
LOTS 6,7,8,9,10,16,17,18,19,20,21, BLOCK 1, UNIVERSITY HEIGHTS
ACREAGE:
LOT 6 = .16 \text{ ACRES}
LOT 7 = .16 \text{ ACRES}
LOT 8 = .16 \text{ ACRES}
LOT 9 = .16 ACRES
LOT 10 = .16 ACRES
LOT 16 = .16 \text{ ACRES}
LOT 17 = .16 ACRES
LOT 18 = .16 \text{ ACRES}
LOT 19 = .16 \text{ ACRES}
LOT 20 = .16 ACRES
\begin{array}{rcl} LOT & 21 & = & .16 & ACRES \\ \hline TOTAL & = & 1.76 & ACRES \end{array}
PROPOSED BUILDING AREAS:
BUILDING A:
                            1,200 SF. RESIDENTIAL
                             2,050 SF. RESIDENTIAL
BUILDING B:
                            3.800 SF. RESIDENTIAL
                            5.600 SF. RESIDENTIAL
                            4,700 SF. RESIDENTIAL
16,500 SF.
BUILDING C:
                             3,800 SF. RESIDENTIAL
      SECOND FLOOR:
                            5,600 SF. RESIDENTIAL
                           4,700 SF. RESIDENTIAL
BUILDING D:
                             1.200 SF. RESIDENTIAL
                             2,050 SF. RESIDENTIAL
       TOTAL DEVELOPMENT: 44,300 SF. (INCLUDING
 PARKING CALCULATIONS:
 PARKING REQUIRED:
       7,200 SF. RETAIL
       1 PER 300 SF. PER UC ZONE
       7,200/300 = 24 SPACES REQUIRED
       34,700 SF. RESIDENTIAL UNITS
       1 PER 600 SF. PER R3C ZONE
       33,400/600 = 56 SPACES REQUIRED
       80 TOTAL SPACES REQUIRED
       LESS 10% REDUCTION AS PROJECT IS WITHIN 300' OF
       TRANSIT ROUTE = 72 SPACES REQUIRED
  PARKING PROVIDED:
       26 SPACES ARE PROVIDED OFF OF ALLEY.
       LOTS 17,18,19,20.
       46 SPACES PROVIDED AND DESIGNATED IN
       ADJACENT PARKING LOT. LOTS 6,7,8,9,10.
       72 TOTAL SPACES PROVIDED
  ADDITIONAL REQUIREMENTS:
       4 HC ACCESSIBLE SPACES AND 3 MOTORCYCLE
       SPACES REQUIRED PER C.O.A. REQUIREMENTS.
       4 HC ACCESSIBLE SPACES PROVIDED OFF OF ALLEY.
       7 MOTORCYCLE SPACES PROVIDED IN ADJACENT LOT.
  BICYCLE PARKING CALCULATIONS:
  BICYCLE PARKING REQUIRED:
       RETAIL = 4 SPACES REQUIRED
       RESIDENTIAL = 23 SPACES REQUIRED
TOTAL = 28 SPACES REQUIRED
  BICYCLE PARKING PROVIDED:
                   = 6 SPACES PROVIDED (1 RACK)
       RESIDENTIAL = 36 SPACES PROVIDED (6 RACKS)
                     = 42 SPACES PROVIDED
  OPEN SPACE CALCULATIONS:
  200 SF. PER EFFICIENCY OR 1 BEDROOM
  PER SU-1 ZONING REGULATIONS.
  46 RESIDENTIAL UNITS x 200 = 9200 SF. OPEN SPACE
  COURTYARDS = 8900 SF.
```

= 2160 SF. 11060 SF. OPEN SPACE PROVIDED

# SHEET LIST

```
G101 TITLE SHEET

A001 SITE DEVELOPMENT PLAN FOR BUILDING PERMIT

L101 CONCEPTUAL LANDSCAPE PLAN

C001 GRADING AND DRAINAGE PLAN

A401 OVERALL EXTERIOR ELEVATIONS

A402 ENLARGED EXTERIOR ELEVATIONS


C002 SITE UTILITY PLAN
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# REQUESTED ZONING

```
ZONE CHANGE FROM SU-2/UC AND SU-2/R-3-C TO SU-2/SU-1 FOR A MIXED USE PROJECT
INCLUDING A 46 DWELLING UNIT COURTYARD DEVELOPMENT AND 7,200 SQUARE FEET FOR
COMMERCIAL USE, AND A SECTOR PLAN AMENDMENT TO THE ZONING MAP FROM UC AND R3C TO
PERMISSIVE COMMERCIAL USES INCLUDE:
               MULTIPLE-FAMILY DWELLINGS, NOT TO EXCEED A TOTAL OF 46 DWELLING UNITS.
               CHURCH OR OTHER PLACE OF WORSHIP, INCLUDING INCIDENTAL RECREATIONAL
               AND EDUCATIONAL FACILITIES.
              OFFICE MACHINES AND EQUIPMENT SALES AND REPAIR.
               RETAIL SALES OF THE FOLLOWING GOODS, PLUS INCIDENTAL RETAILING OF RELATED
               GOODS AND INCIDENTAL SERVICE OR REPAIR:
                      (a) ARTS AND CRAFTS OBJECTS, SUPPLIES, PLUS THEIR
                           INCIDENTAL CREATION PROVIDED THERE IS LITTLE OR
                           NO REPRODUCTION OF SUBSTANTIALLY IDENTICAL
                     (b) BOOKS, MAGAZINES, NEWSPAPERS, STATIONERY,
                            PROVIDED THAT NO SUCH MATERIAL IS ADVERTISED TO
                           BE FORBIDDEN TO BE SOLD TO MINORS.
                          CLOTHING, SHOES, DRY GOODS.
                          COSMETICS, LOTIONS, HOBBY SUPPLIES.
                          DRUGS, MEDICAL SUPPLIES.
                          FLOWERS AND PLANTS, INCLUDING MINOR AND
                            INCIDENTAL OUTDOOR SALES.
                          RESTAURANTS, WITH OR WITHOUT BEER AND WINE
                                 1) THERE SHALL BE NO DRIVE-IN RESTAURANT OR
                                      DRIVE-UP WINDOW; AND,
                                    THE RETAILING OF ALCOHOLIC DRINKS, FOR ON OR OFF
                                      PREMISE CONSUMPTION, WITHIN 500 FEET OF A
                                      COMMUNITY RESIDENTIAL PROGRAM OR HOSPITAL FOR
                                      TREATMENT OF SUBSTANCE ABUSERS, IS PROHIBITED.
                          FURNITURE, HOUSEHOLD FURNISHINGS, AND APPLIANCES.
                           JEWELRY.
                           BICYCLE SALES. REPAIR IS ALLOWED AS AN ACCESSORY USE TO
                           SALES PROVIDED ALL REPAIR ACTIVITIES, INCLUDING TEMPORARY
                            STORAGE, ARE DONE WITHIN A COMPLETELY ENCLOSED BUILDING.
                          GAMES, INCLUDING COMPUTER AND VIDEO GAMES. (RETAIL SALES
                            ONLY, NO ARCADES).
                          MUSICAL INSTRUMENTS AND SUPPLIES.
                         PHOTOGRAPH EQUIPMENT.
                           SPORTING GOODS.
                           WALK-UP AUTOMATIC TELLER MACHINES (ATM'S).
                            BARBER, BEAUTY.
                           DRY CLEANING STATION (NO PROCESSING), SELF SERVICE LAUNDRY.
                           HEALTH GYMNASIUMS.
                           INSTRUCTION IN MUSIC, DANCE, FINE ARTS, CRAFTS, MODELING.
                           INTERIOR DECORATING.
                           PET GROOMING.
                           PHOTOGRAPHY, PHOTOCOPY, EXCEPT ADULT PHOTO STUDIO.
                           REPAIR OF SHOES, HOUSEHOLD EQUIPMENT.
                            TAILORING, DRESSMAKING.
```

PARKING LOT.

THERE ARE NO CONDITIONAL COMMERCIAL USES PERMITTED WITH THIS REQUEST.

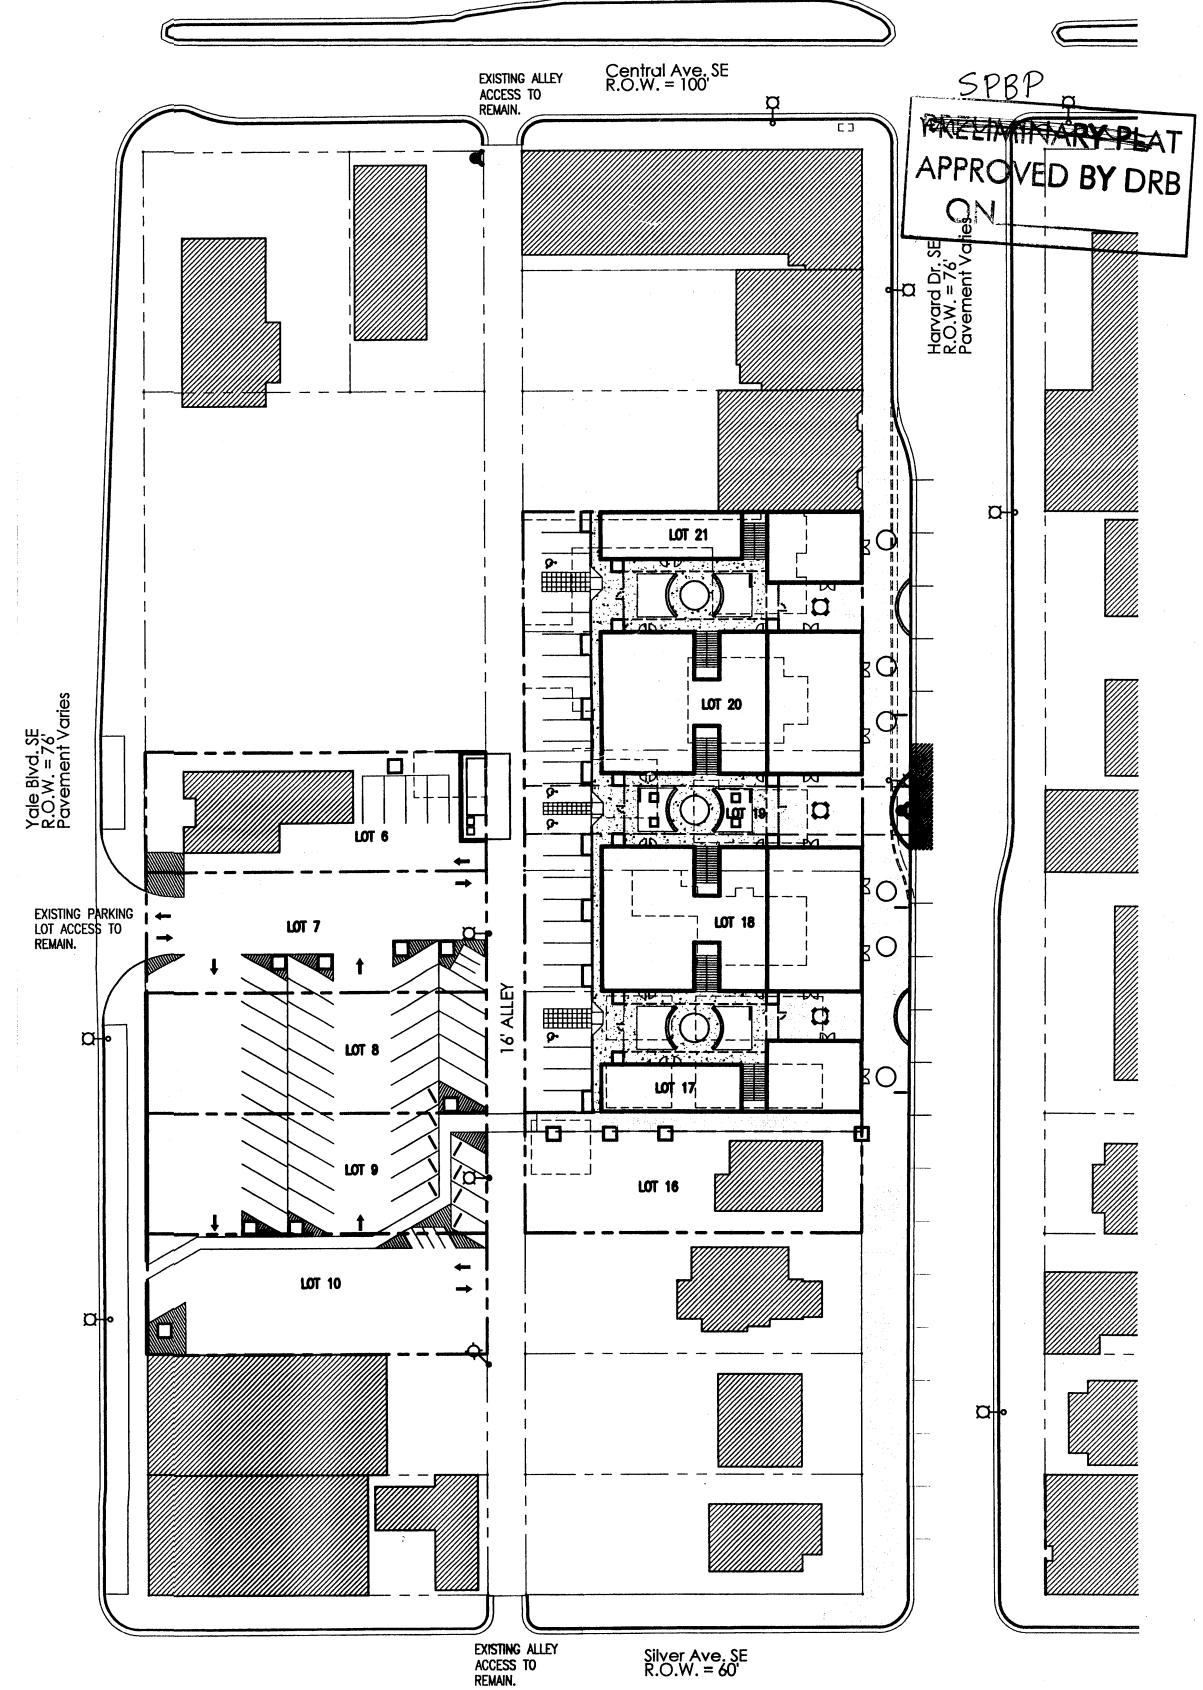

Overall Site Plan for Building Permit

by revision

Mullen Heller

Mullen Heller Architecture P.C.


1015 Tijeras Avenue NW Suite 220 Albuquerque 87102 505 268 4144[p] 505 268 4244 [f]

> MAG r Douglas Heller, AIA 11/14/06

University Heights

ricklight Courtyards ots 6–10,17–21, Block 1, Univers buquerque, New Mexico

G101

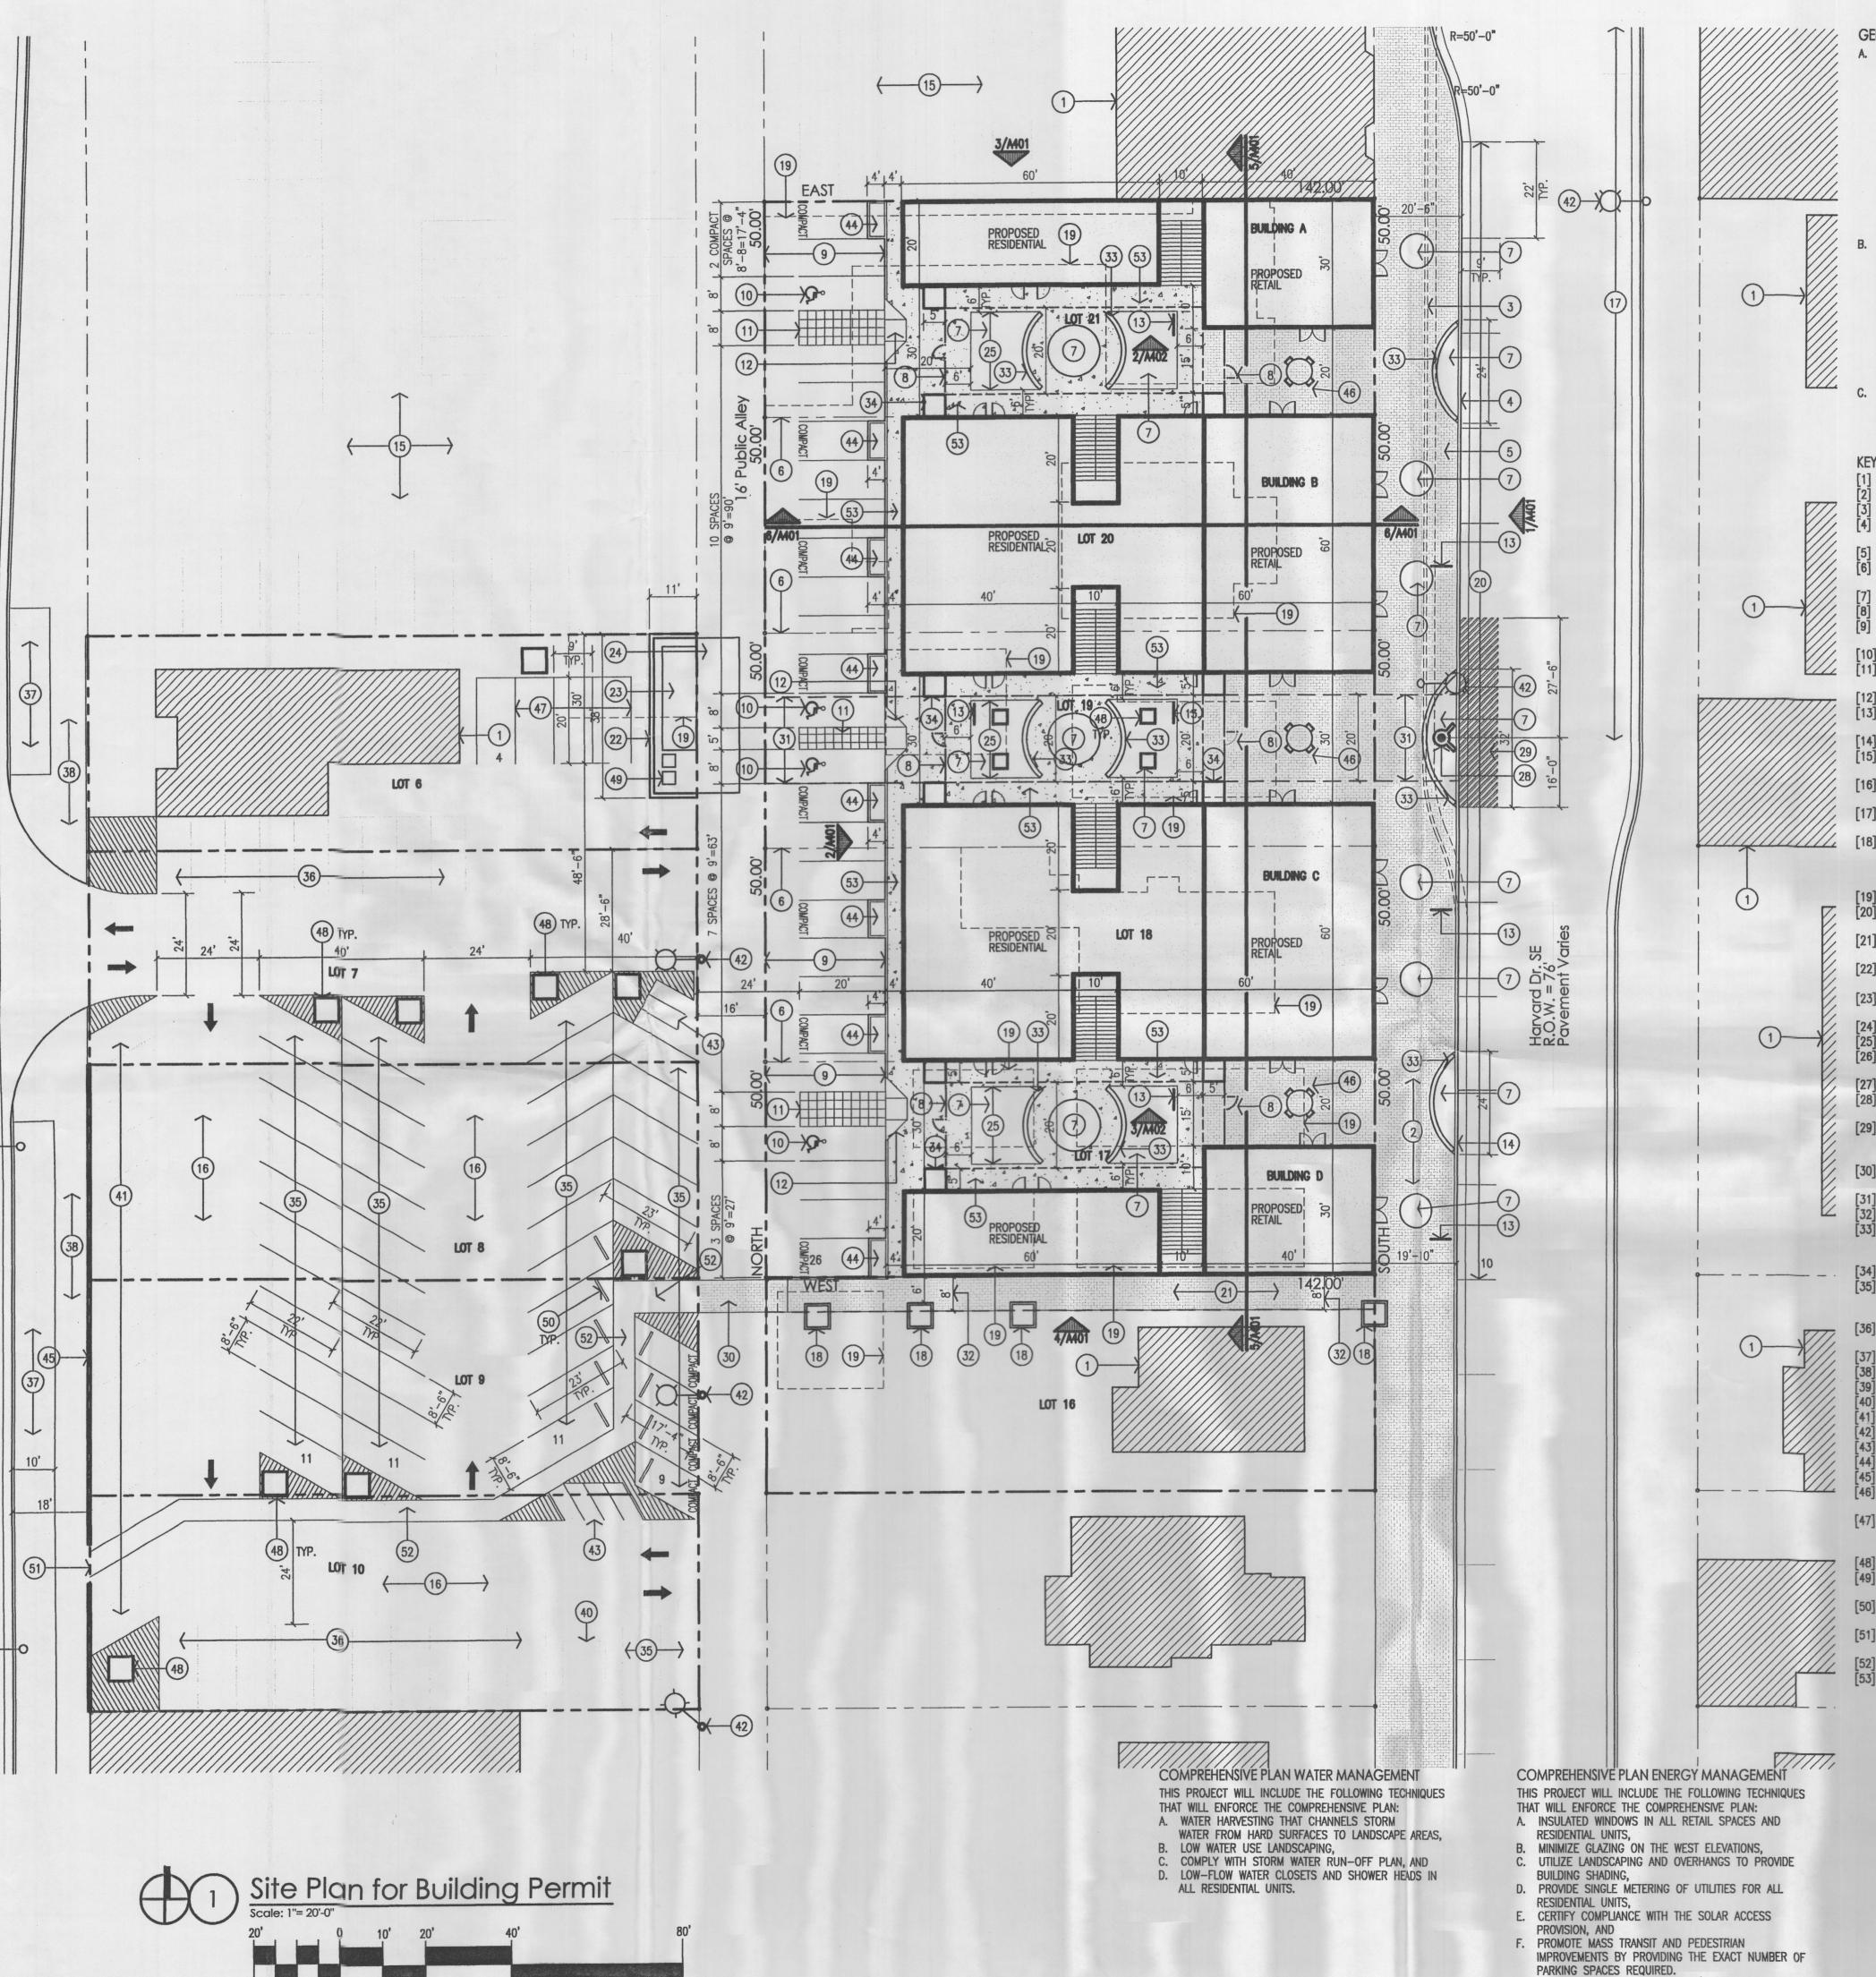

**GENERAL NOTES:** A. SITE LIGHTING WILL BE PROVIDED BY THE FOLLOWING: - RECESSED HID FLUORESCENT DOWN LIGHTS ALONG RETAIL FRONTAGE. - SHIELDED HID METAL HALIDE WALL PACKS AT WEST SIDE OF PROJECT AND AT

PEDESTRIAN WALKWAY - COMPACT FLUORESCENT STEP LIGHTS AT RAISED PLANTERS AT COURTYARDS AND AT PEDESTRIAN WALKWAY - LOW WATTAGE LANDSCAPE LIGHTING IN THE COURTYARDS

- DECORATIVE FIXTURE ADJACENT TO EACH RESIDENCE DOOR.

B. CURRENT PARKING IN LOTS 6,7,8,9,10 ARE COMPRISED OF 63 PAID PARKING SPACES AND 19 REQUIRED SPACES FOR ADJACENT BUSINESSES. 46 OF THE 63 PAID PARKING SPACES WILL BE DESIGNATED FOR REQUIRED OFF STREET PARKING FOR THE PROPOSED DEVELOPMENT. 7 MOTORCYCLE SPACES WILL BE ADDED. ANY FUTURE DEVELOPMENT OF THESE LOTS WILL REQUIRE THESE 48 DESIGNATED SPACES TO BE ACCOMMODATED ELSEWHERE AS REQUIRED BY THE CITY OF ALBUQUERQUE. C. THE RESIDENTIAL SQUARE FOOTAGE SHALL BE LIMITED TO 33,400 NET SQUARE FEET AND THE NUMBER OF DWELLING UNITS IS LIMITED TO A TOTAL OF 46.

# **KEYED NOTES:**

EXISTING BUILDING TO REMAIN. EXISTING BRICK SIDEWALK TO REMAIN. EXISTING CURB AND GUTTER TO BE REMOVED. PROPOSED CURB AND GUTTER PER CITY OF ALBUQUERQUE 2430.

PROPOSED BRICK SIDEWALK TO MATCH EXISTING. EXISTING PROPERTY LINE TO BE DELETED BY

PROPOSED LANDSCAPED AREA. PROPOSED WROUGHT IRON GATE.

NEW ASPHALT PAVING TO BE LEVEL WITH ALLEY PAVING. SEE GRADING AND DRAINAGE PLAN.

PROPOSED HANDICAP ACCESSIBLE PARKING. PROPOSED SCORED CONCRETE HANDICAP ACCESSIBLE ACCESS AISLE. PROPOSED HANDICAP ACCESSIBLE RAMP. PROPOSED BIKE RACK LOCATION. 6 SPACES PER

[14] EXISTING CITY CURB TO REMAIN. EXISTING PARKING LOT TO REMAIN. NOT A PART OF

THIS PROJECT. [16] EXISTING PARKING LOT. 48 DESIGNATED FOR PROPOSED PROJECT.

[17] EXISTING PARALLEL AND METERED PARKING TO [18] PROPOSED 6'x6'x2' HIGH RAISED BRICK LANDSCAPE PLANTER WITH RECESSED

EXISTING BUILDING TO BE REMOVED. NEW PARALLEL AND CITY METERED PARKING

FLUORESCENT STEP LIGHTING TYPICAL OF 3

[21] NEW 8' WIDE BRICK PEDESTRIAN CONNECTION FROM EXISTING PARKING LOT TO HARVARD DRIVE.

[22] 8' HIGH CMU COMPACTOR ENCLOSURE. STUCCO TO MATCH PROPOSED BUILDINGS. SEE 4/A402. [23] SELF-CONTAINED REFUSE COMPACTOR ON WHEEL

GUIDES. PROVIDED BY OWNER. [24] 10' WIDE x 6" THICK CONCRETE APRON. [25] LINE OF PROPOSED WALKWAY ABOVE.
[26] EXISTING FIRE HYDRANT FED BY 6" LINE IN PUBLIC

[27] EXISTING BUS STOP.

[28] NEW FIRE HYDRANT FED BY 6" LINE IN PUBLIC

[29] NEW FIRE LANE ACCESS. 4" STRIPING TO BE RED. ADJACENT CURB TO BE PAINTED RED WITH WHITE LETTERING TO READ "FIRE LANE NO PARKING". [30] RAISED 8' WIDE PEDESTRIAN CONNECTION ACROSS

[31] NEW 20' WATER UTILITY EASEMENT. NEW 8' PEDESTRIAN ACCESS EASEMENT. [33] 16" HIGH BRICK SEATWALL WITH RECESSED FLUORESCENT STEP LIGHTING. TYPICAL OF 3 AT EACH SEATWALL. [34] BRICK PILASTER AT GATE LOCATIONS, TYPICAL [35] EXISTING PAID PARKING SPACES TO BE

DESIGNATED TO THE PROPOSED PROJECT. TOTAL OF 45. [36] EXISTING SPACES REQUIRED BY EXISTING

BUSINESSES TO REMAIN. EXISTING LANDSCAPE AREA. EXISTING CITY SIDEWALK.

NEW MOTORCYCLE SPACES. EXISTING DUMPSTER ENCLOSURE.

PAID PARKING SPACES TO REMAIN. EXISTING LITE POLE TO REMAIN. NEW 4'x10' MOTORCYCLE PARKING-7 TOTAL. CONCRETE PLANTER BOXES LEVEL WITH SIDEWALK.


NEW 36" HIGH STUCCO SCREEN WALL. SEE 6/A402 36" DIAMETER OUTDOOR TABLE WITH UMBRELLA AND SEATING. [47] NEW PAID PARKING SPACES TO BE

DESIGNATED TO THE PROPOSED PROJECT. TOTAL OF 4. [48] 36 SQUARE FOOT PLANTER. SEE LANDSCAPE PLAN.


[49] RECYCLING BINS (2) WITHIN COMPACTOR ENCLOSURE. [50] PARKING BUMPER, TYPICAL ALONG PEDESTRIAN

WALKWAY. [51] 9' WIDE OPENING IN YARD WALL WITH ADA COMPLIANT ACCESS TO EXISTING SIDEWALK.

[52] STRIPED PEDESTRIAN WALKWAY. COLORED CONCRETE SIDEWALK TO MATCH BRICK

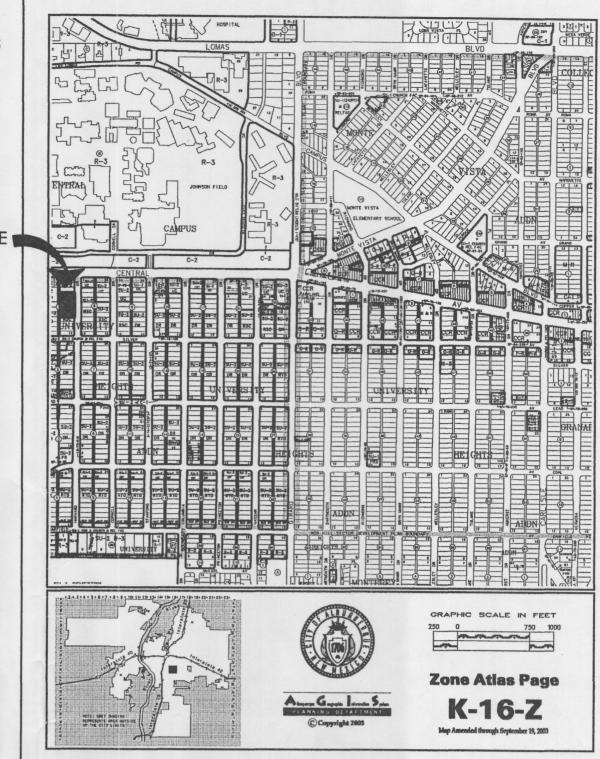

2) Vicinity Map

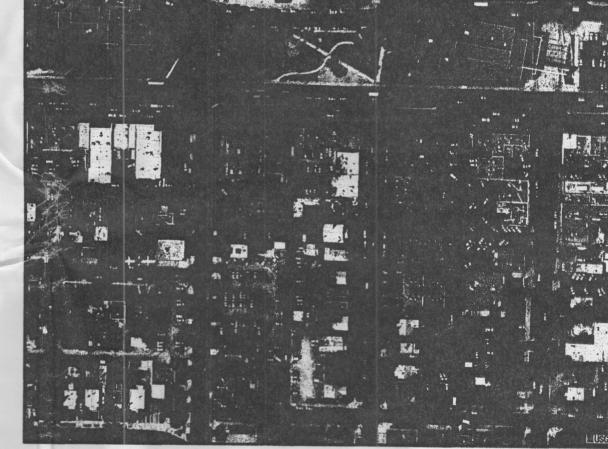

(3) Aerial Photograph

PROJECT NUMBER: 1004927 APPLICATION NU	MBER:
THIS PLAN IS CONSISTENT WITH THE SPECIFIC SITE DEVELOP THE ENVIRONMENTAL PLANNING COMMISSION (EPC) DATED:_ AND THE FINDINGS AND CONDITIONS IN THE OFFICIAL NOTIFI SATISFIED.	AUGUST 17, 2006
IS AN INFRASTRUCTURE LIST REQUIRED? (X) YES ( ) NO APPROVED DRC PLANS WITH A WORK ORDER IS REQUIRED F WITHIN PUBLIC RIGHT-OF-WAY OR FOR CONSTRUCTION OF F	IF YES, THEN A SET OF FOR ANY CONSTRUCTION PUBLIC IMPROVEMENTS.
DRB SITE DEVELOPMENT PLAN SIGNOFF APPROVAL:	
TRAFFIC ENGINEER, TRANSPORTATION DIVISION	Date
UTILITIES DEVELOPMENT	Date
PARKS AND RECREATION DEPARTMENT	Date
CITY ENGINEER	Date
	Date
*ENVIRONMENTAL HEALTH DEPARTMENT (CONDITIONAL)	
*ENVIRONMENTAL HEALTH DEPARTMENT (CONDITIONAL)  Michael Holton  SOLID WASTE MANAGEMENT	11/14/0

Bricklight
Lots 6-10,17-2
Albuquerque, Nev

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# LANDSCAPE PALETTE

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<u> </u>	Potentilla fruticosa Shrubby Cinquefoil	36" x 36" Medium +
***	Rosmarinus officinalis Prostrate Rosemary	24" x 48" Low +
*	Ornamental Grasses Nassella temuissima Threadgrass	24" × 24" Low +

# LANDSCAPE CALCULATIONS

Total Site Area:	(129 acres) 56,286	SI
Building Area:	17200	SI
Net Area:	39,086	S
Required Landscape Area (15% of Net Area):	5,863	SI
Provided Landscape Area:	4,652	SI

# LANDSCAPE NOTES

Due to the current site plan proposal, all existing trees on site shall be removed.

TREE REQUIREMENTS

Based on the City Zoning Code (trees per dwelling unit), 27 trees are required for this site. We have provided 26 trees, including 4 in pots in the utility easement between the 2 center buildings. We have provided 9 pots within the parking lot to provide for tree requirements within the parking lot. Four existing trees along Yale satisfy the street tree requirement for Yale.

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Courtyards
4 1, University Heights
Mexico

CONSENSUS PLANNING, INC.


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(505) 764-9801 Fax 842-5495

e-mail: cp@consensusplanning.com



by revision

\*4444

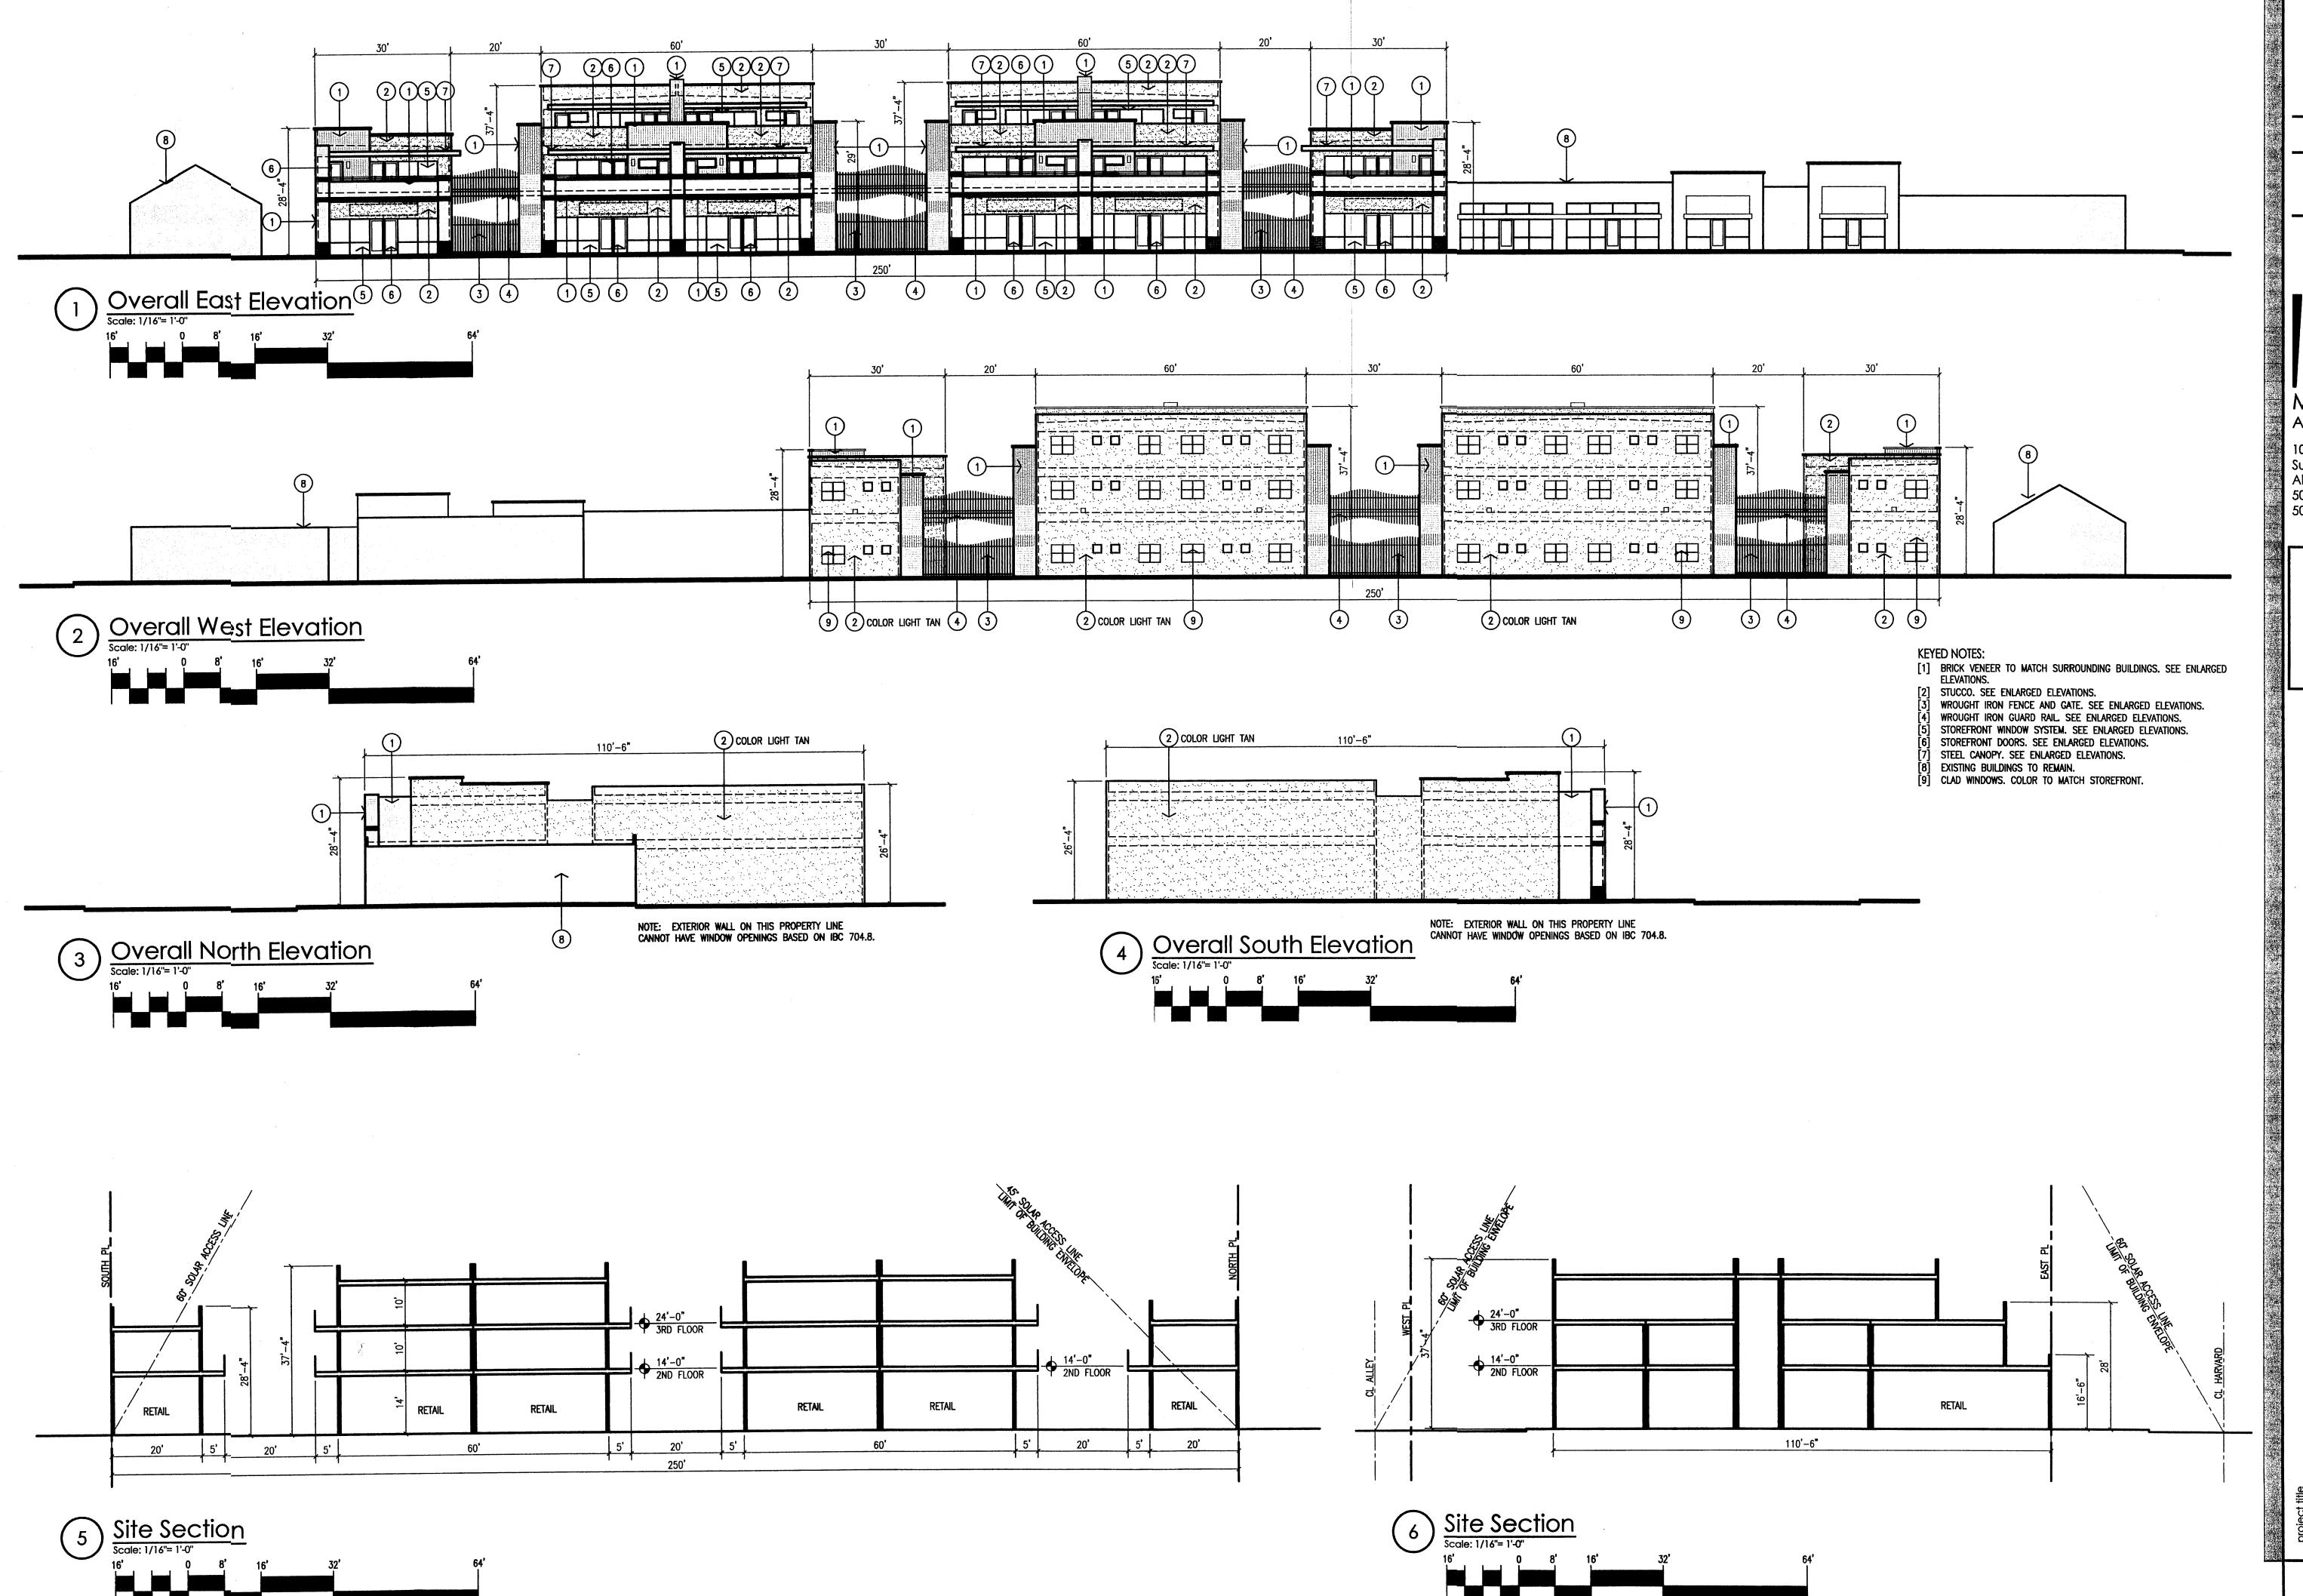Mullen Heller

Mullen Heller
Architecture P.C.

1015 Tijeras Avenue NW Suite 220 Albuquerque 87102 505 268 4144[p] 505 268 4244 [f]

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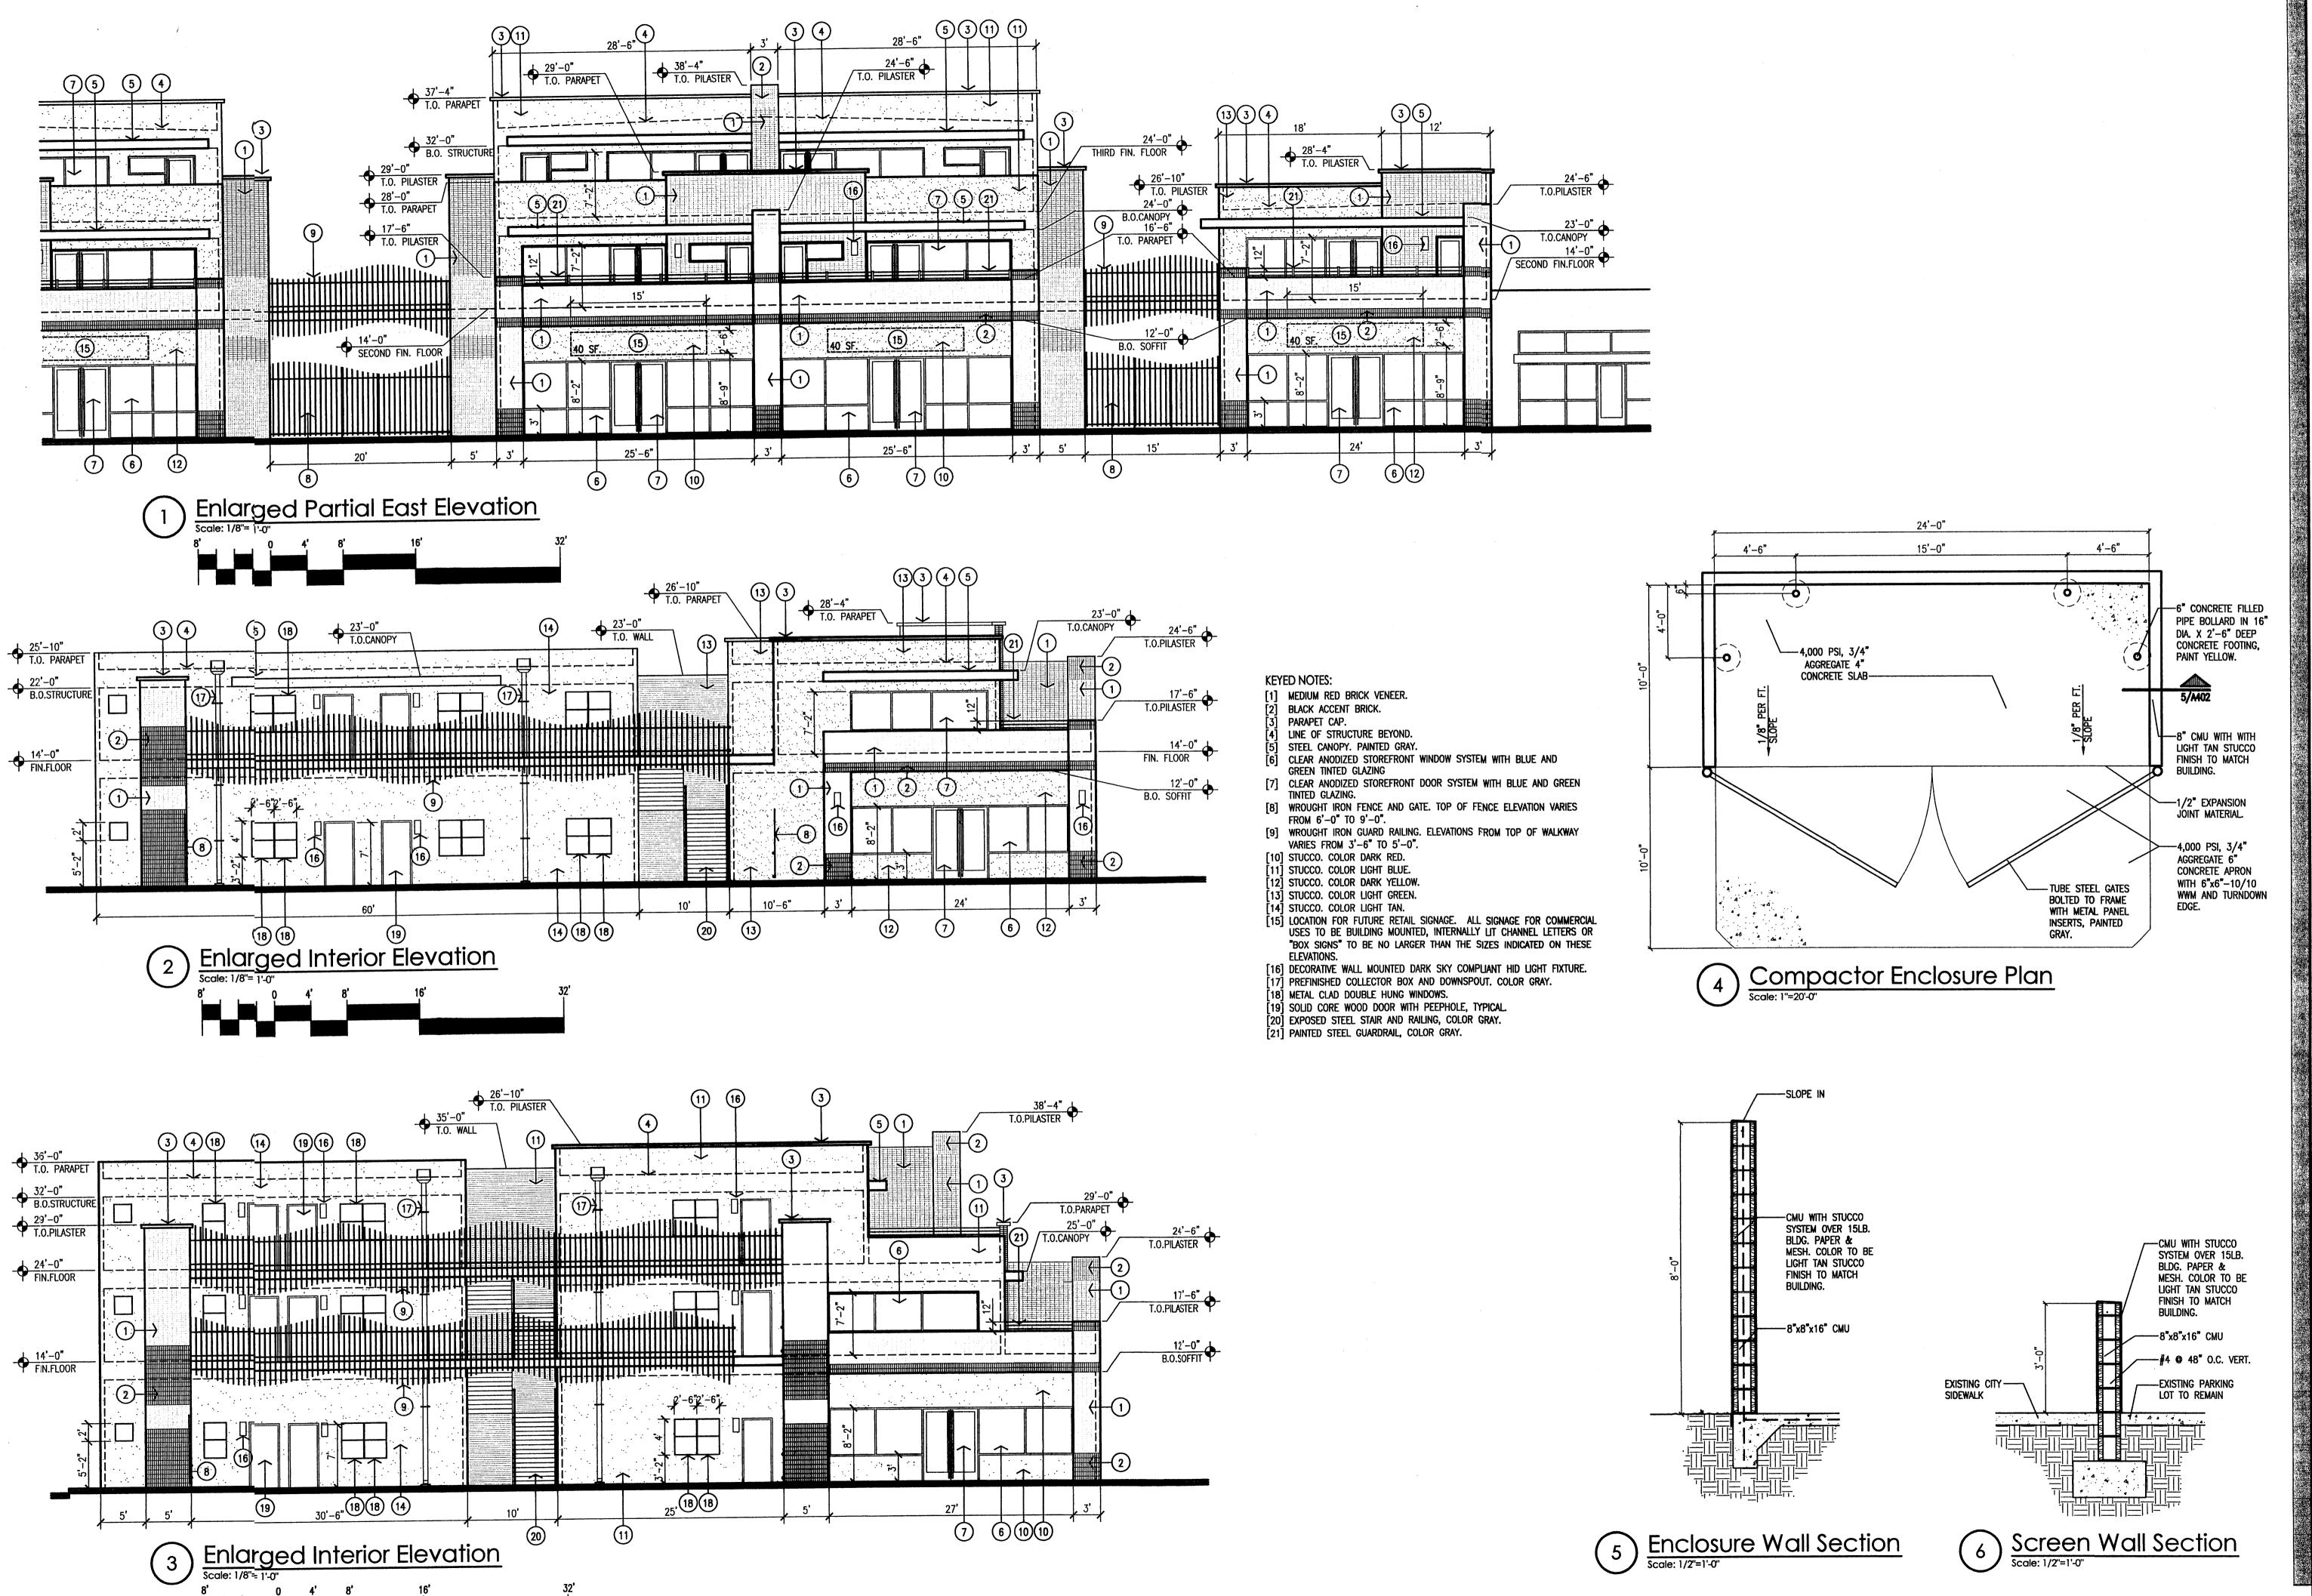
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University Heights
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Bricklight Courtyards
Lots 6-10,17-21, Block 1, Universalbuquerque, New Mexico

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Mullen Heller Architecture P.C. 1015 Tijeras Avenue NW Suite 220 Albuquerque 87102 505 268 4144[p] 505 268 4244 [f] Yards 1, Univers Bricklight
Lots 6-10,17-2
Albuquerque, Nev

A402

# GENERAL CONSTRUCTION NOTES

### GENERAL

- 18 1 - Call

CONTRACTOR IS RESPONSIBLE FOR OBTAINING ALL REQUIRED CONSTRUCTION PERMITS, INCLUDING A TOP SOIL DISTURBANCE PERMIT, PRIOR TO START OF CONSTRUCTION.

ALL WORK ON THIS PROJECT SHALL BE PERFORMED IN ACCORDANCE WITH APPLICABLE FEDERAL, STATE, AND LOCAL LAWS, ORDINANCES, AND REGULATIONS CONCERNING CONSTRUCTION SAFETY AND HEALTH.

REFERENCES MADE TO STANDARD SPECIFICATIONS AND STANDARD DRAWINGS REFER TO THE CITY OF ALBUQUERQUE STANDARD SPECIFICATIONS FOR PUBLIC WORK'S CONSTRUCTION, 1986 EDITION WITH ALL UPDATES.

THE CONTRACTOR SHALL NOT INSTALL ITEMS AS SHOWN ON THESE PLANS WHEN IT IS OBVIOUS THAT FIELD CONDITIONS ARE DIFFERENT THAN SHOWN IN THE PLANS. SUCH CONDITIONS SHALL BE BROUGHT TO THE ATTENTION OF THE ENGINEER IN A TIMELY MANNER. IN THE EVENT THE CONTRACTOR DOES NOT NOTIFY THE ENGINEER IN A TIMELY MANNER, THE CONTRACTOR ASSUMES FULL RESPONSIBILITY AND EXPENSE FOR ANY REVISIONS NECESSARY, INCLUDING ENGINEERING DESIGN FEES.

EXISTING SITE IMPROVEMENTS WHICH ARE DAMAGED OR DISPLACED BY THE CONTRACTOR SHALL BE REMOVED AND REPLACED BY THE CONTRACTOR AT THE CONTRACTOR'S EXPENSE. REPAIRS SHALL BE APPROVED BY THE OWNER PRIOR TO CONSTRUCTION OF THE REPAIRS. REPAIRS SHALL BE ACCEPTED BY THE OWNER PRIOR TO FINAL

EXISTING FENCING THAT IS NOT DESIGNATED FOR REMOVAL SHALL NOT BE DISTURBED. ANY FENCING THAT IS DISTURBED OR ALTERED BY THE CONTRACTOR SHALL BE RESTORED TO ITS ORIGINAL CONDITION AT THE CONTRACTORS EXPENSE. IF THE CONTRACTOR DESIRES TO REMOVE FENCING TO ACCOMMODATE CONSTRUCTION ACTIVITIES, THE CONTRACTOR SHALL OBTAIN THE OWNER'S WRITTEN PERMISSION BEFORE THE FENCE IS REMOVED. CONTRACTOR SHALL RESTORE THE FENCE TO ITS ORIGINAL CONDITION AT THE EARL'EST OPPORTUNITY. WHILE ANY FENCING IS REMOVED, THE CONTRACTOR SHALL BE SOLELY RESPONSIBLE FOR SECURITY OF THE SITE UNTIL THE FENCE IS RESTORED.

### WORK WITHIN ADJACENT RIGHT-OF-WAY

PRIOR TO BEGINNING ANY CONSTRUCTION ACTIVITIES WITHIN ADJACENT RIGHT-OF-WAYS OR WITHIN PROPERTY NOT OWNED BY THE OWNER OF THE PROJECT SITE, THE CONTRACTOR SHALL ASSURE THAT ALL PERMITS AND PERMISSIONS REQUIRED HAVE BEEN OBTAINED IN WRITING.

# SURVEY MORUMENTS, PROPERTY CORNERS, BENCHMARKS

THE CONTRACTOR SHALL NOTIFY THE OWNER AT LEAST SEVEN DAYS BEFORE BEGINNING ANY CONSTRUCTION ACTIVITY THAT COULD DAMAGE OR DISPLACE SURVEY MONUMENTS, PROPERTY CORNERS, OR PROJECT BENCHMARKS SO THESE ITEMS MAY BE RELOCATED.

ANY SURVEY MONUMENTS, PROPERTY CORNERS, OR BENCHMARKS THAT ARE NOT IDENTIFIED FOR RELOCATION ARE THE RESPONSIBILITY OF THE CONTRACTOR TO PRESERVE AND PROTECT, RELOCATION OR REPLACEMENT OF THESE ITEMS SHALL BE DONE BY THE OWNER'S SURVEYOR AT THE EXPENSE OF THE CONTRACTOR.

### DIMENSIONS

ALL DIMENSIONS TO CURBS ARE TO THE FLOWLINE UNLESS OTHERWISE NOTED.

ALL STATIONING IS TO THE CENTERLINE OF THE RIGHT-OF-WAY UNLESS OTHERWISE NOTED.

ALL SLOPES AND GRADES ARE IN PERCENT UNLESS OTHERWISE NOTED.

CURB ELEVATIONS ARE SHOWN AT THE FLOW LINE UNLESS OTHERWISE NOTED. SEE THE DETAIL SHEET TO DETERMINE THE CURB HEIGHT ABOVE FLOW LINE.

#### SOILS

UNLESS OTHERWISE SPECIFIED, SUBGRADE, ENGINEERED FILL, AND STRUCTURAL FILL SHALL BE COMPACTED TO THE FOLLOWING SPECIFICATIONS OF THE ASTM D-1557 MAXIMUM DRY DENSITY.

MATERIAL/LOCATION	PERCENT COMPACT
STRUCTURAL FILL IN THE BUILDING AREA	95%
SUBBASE FOR SLAB SUPPORT	95%
MISCELLANEOUS BACKFILL BELOW STRUCTURAL FILL OR ROADWAY PAVEMENT	95%
MISCELLANEOUS BACKFILL BELOW UNPAVED,	
NON-BUILDING AREAS	90%
ROADWAY PAVEMENT SUBGRADE	95%
SIDEWALK SUBGRADE	90%
CURB AND GUTTER SUBGRADE	95%

# PAVEMENT

WHEN ABUTTING NEW PAVEMENT TO EXISTING PAVEMENT, CUT EXISTING PAVEMENT EDGE TO A NEAT, STRAIGHT LINE AS NECESSARY TO REMOVE ANY BROKEN OR CRACKED PAVEMENT AND MATCH NEW PAVEMENT ELEVATION TO EXISTING.

ALL UTILITIES AND UTILITY SERVICE LINES SHALL BE INSTALLED AND APPROVED PRIOR TO PAVING.

ALL WATER VALVE BOXES AND ELECTRICAL, TELEPHONE, TELEVISION, AND SEWER MANHOLES IN THE CONSTRUCTION AREA SHALL BE ADJUSTED TO FINISHED GRADE BEFORE PAVING.

WHEN SIDEWALK OR CURB AND GUTTER IS REMOVED, IT SHALL BE REMOVED TO EXISTING CONSTRUCTION JOINTS. CUTTING OR BREAKING SHALL NOT BE ALLOWED.

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IF ANY UTILITY LINES, PIPELINES, OR UNDERGROUND UTILITY LINES ARE SHOWN ON THESE DRAWINGS, THEY ARE SHOWN IN AN APPROXIMATE LOCATION ONLY BASED ON THE INFORMATION PROVIDED TO THE ENGINEER BY OTHERS. THIS INFORMATION MAY BE INACCURATE OR INCOMPLETE. ADDITIONALLY, UNDERGROUND LINES MAY EXIST THAT ARE NOT SHOWN. THE CONTRACTOR SHALL VERIFY THE LOCATION OF ANY UTILITY LINE, PIPELINE, OR UNDERGROUND UTILITY LINE IN OR NEAR THE AREA OF THE WORK IN ACCORDANCE WITH CHAPTER 62, ARTICLE 14-1. THROUGH 14-8, NMSA 1978.

THE CONTRACTOR SHALL CONTACT THE STATEWIDE UTILITY LOCATOR SERVICE AT 1-800-321-2537 AT LEAST TWO WORKING DAYS BEFORE BEGINNING CONSTRUCTION. AFTER THE UTILITIES ARE SPOTTED, THE CONTRACTOR SHALL EXPOSE ALL PERTINENT UTILITIES TO VERIFY THEIR VERTICAL AND HORIZONTAL LOCATION. IF A CONFLICT EXISTS BETWEEN EXISTING UTILITIES AND PROPOSED CONSTRUCTION, THE CONTRACTOR SHALL NOTIFY THE ENGINEER SO THAT THE CONFLICT CAN BE RESOLVED WITH MINIMAL DELAY.

THE CONTRACTOR SHALL EXERCISE DUE CARE TO AVOID DISTURBING ANY EXISTING UTILITIES, ABOVE OR BELOW GROUND. UTILITIES THAT ARE DAMAGED BY CARELESS CONSTRUCTION SHALL BE REPAIRED OR REPLACED AT THE CONTRACTOR'S EXPENSE.

EXISTING VALVES SHALL ONLY BE OPERATED BY THE UTILITY COMPANY. CONTRACTOR SHALL NOTIFY THE UTILITY A MINIMUM OF TWO WORKING DAYS BEFORE ANY VALVE, NEW OR EXISTING, NEEDS TO BE OPERATED.

THE CONTRACTOR SHALL COORDINATE ANY REQUIRED UTILITY INTERRUPTIONS WITH THE OWNER AND AFFECTED UTILITY COMPANY A MINIMUM OF THREE WORKING DAYS BEFORE THE INTERRUPTION.

THE CONTRACTOR SHALL MAINTAIN A RECORD DRAWING SET OF PLANS AND PROMPTLY LOCATE ALL UTILITIES, EXITING OR NEW, IN THEIR CORRECT LOCATION, HORIZONTAL AND VERTICAL. THIS RECORD SET OF DRAWINGS SHALL BE MAINTAINED ON THE PROJECT SITE AND SHALL BE AVAILABLE TO THE OWNER AND ENGINEER AT ANY TIME DURING CONSTRUCTION.

### EROSION CONTROL, ENVIRONMENTAL PROTECTION, AND STORM WATER POLLUTION PREVENTION PLAN

THE CONTRACTOR SHALL CONFORM TO ALL CITY, COUNTY, STATE, AND FEDERAL DUST AND EROSION CONTROL REGULATIONS. THE CONTRACTOR SHALL OBTAIN AND PREPARE ANY DUST CONTROL OR EROSION CONTROL PERMITS REQUIRED FROM THE REGULATORY AGENCIES.

THE CONTRACTOR SHALL PROMPTLY REMOVE ANY MATERIAL EXCAVATED WITH THE PUBLIC RIGHT-OF-WAY OR ADJACENT PROPERTY TO KEEP IT FROM WASHING OFF THE PROJECT SITE.

THE CONTRACTOR SHALL ENSURE THAT NO SOIL ERODES FROM THE SITE ONTO ADJACENT PROPERTY BY CONSTRUCTION OF TEMPORARY EROSION CONTROL BERMS OR INSTALLING SILT FENCES AT THE PROPERTY LINES AND WETTING THE SOIL TO PREVENT IT FROM BLOWING.

WATERING, AS REQUIRED FOR CONSTRUCTION DUST CONTROL, SHALL BE CONSIDERED INCIDENTAL TO CONSTRUCTION AND NO MEASUREMENT OR PAYMENT SHALL BE MADE. CONSTRUCTION AREAS SHALL BE WATERED FOR DUST CONTROL IN COMPLIANCE WITH GOVERNMENT ORDINANCES. THE CONTRACTOR SHALL BE RESPONSIBLE FOR LOCATING AND SUPPLYING WATER AS REQUIRED.

ANY AREAS DISTURBED BY CONSTRUCTION AND NOT COVERED BY LANDSCAPING OR IMPERVIOUS SURFACES SHALL BE REVEGETATED WITH RECLAMATION SEEDING.

THE CONTRACTOR SHALL PROPERLY HANDLE AND DISPOSE OF ALL ASPHALT REMOVED ON THE PROJECT BY HAULING IT TO AN APPROVED DISPOSAL SITE IN ACCORDANCE WITH THE REQUIREMENTS OF THE NEW MEXICO SOLID WASTE ACT

ALL WASTE PRODUCTS FROM THE CONSTRUCTION SITE, INCLUDING ITEMS DESIGNED FOR REMOVAL, CONSTRUCTION WASTE, CONSTRUCTION EQUIPMENT WASTE PRODUCTS (OIL, GAS, TIRES, ETC.), GARBAGE, GRUBBING, EXCESS CUT MATERIAL, VEGETATIVE DEBRIS, ETC.. SHALL BE APPROPRIATELY DISPOSED OF OFFSET AT NO ADDITIONAL COST TO THE OWNER. IT SHALL BE THE CONTRACTOR'S RESPONSIBILITY TO OBTAIN ANY PERMITS REQUIRED FOR HAUL OR DISPOSAL OF WASTE PRODUCTS, IT SHALL BE THE CONTRACTOR'S RESPONSIBILITY TO ENSURE THAT THE WASTE DISPOSAL SITE COMPLIES WITH GOVERNMENT REGULATIONS REGARDING THE ENVIRONMENT, ENDANGERED SPECIES, AND ARCHAEOLOGICAL RESOURCES.

THE CONTRACTOR SHALL BE RESPONSIBLE FOR THE CLEANUP AND REPORTING OF SPILLS OF HAZARDOUS MATERIALS ASSOCIATED WITH THE CONSTRUCTION SITE. HAZARDOUS MATERIALS INCLUDE GASOLINE, DIESEL FUEL, MOTOR OIL, SOLVENTS, CHEMICALS, PAINT, ETC. WHICH MAY BE A THREAT TO THE ENVIRONMENT. THE CONTRACTOR SHALL REPORT THE DISCOVERY OF PAST OR PRESENT SPILLS TO THE NEW MEXICO EMERGENCY RESPONSE AT 1-800-219-6157.

THE CONTRACTOR SHALL COMPLY WITH ALL APPLICABLE REGULATIONS CONCERNING SURFACE AND UNDERGROUND WATER. CONTACT WITH SURFACE WATER BY CONSTRUCTION EQUIPMENT AND PERSONNEL SHALL BE MINIMIZED. EQUIPMENT MAINTENANCE AND REFUELING OPERATIONS SHALL BE PERFORMED IN AN ENVIRONMENTALLY SAFE MANNER IN COMPLIANCE WITH GOVERNMENT REGULATIONS.

THE CONTRACTOR SHALL COMPLY WITH ALL APPLICABLE REGULATIONS CONCERNING CONSTRUCTION NOISE AND HOURS OF OPERATION.

# ACCESSIBLE FACILITIES

ALL SURFACES ALONG ACCESSIBLE ROUTES AND FOR HANDICAP RAMPS SHALL BE STABLE FIRM, SLIDE RESISTANT AND SHALL COMPLY WITH UNIFORM FEDERAL ACCESSIBILITY STANDARDS, PARAGRAPH 4.5.

LONGITUDINAL SLOPES ALONG ACCESSIBLE ROUTE SIDEWALKS, EXCEPT AT HANDICAP RAMPS, SHALL NOT BE STEEPER THAN 1: 20. CROSS SLOPES ALONG ACCESSIBLE ROUTE SIDEWALKS EXCEPT AT HANDICAP RAMPS, SHALL NOT BE STEEPER THAN 1: 48. SLOPES IN ACCESSIBLE PARKING SPACES, ACCESS AISLES, AND PASSENGER LOADING ZONES SHALL NOT BE STEEPER THAN 1: 48 IN ALL DIRECTIONS.


THE SITE SHALL COMPLY WITH ANSI A117.1-1992, "ACCESSIBLE AND USABLE BUILDINGS AND FACILITIES".

# TRAFFIC CONTROL

THE CONTRACTOR SHALL PROVIDE ALL REQUIRED TRAFFIC CONTROL PLANS. ALL SIGNS, BARRICADES, CHANNELIZATION DEVICES, SIGN FRAMES AND ERECTION OF SUCH DEVICES SHALL CONFORM TO THE REQUIREMENTS OF "MANUAL OF UNIFORM TRAFFIC CONTROL DEVICES FOR STREETS AND HIGHWAYS" LATEST EDITION. PRIOR TO CONSTRUCTION. TRAFFIC CONTROL PLANS SHALL BE APPROVED BY THE GOVERNING AUTHORITY.

# ABBREVIATIONS

AD = AREA DRAIN	DTL = DETAIL	GV = GATE VALVE	RCP = REINFORCED CONCRETE PIPE	TCC =
AIP = /BANDONED IN PLACE	DWG = DRAWING	HI PT = HIGH POINT	R/W = RIGHT-OF-WAY	TG = TOP OF GRATE
BLDG = EUILDING	E = ELECTRIC LINE	INV = INVERT ELEVATION	SAS = SANITARY SEWER	TS = TOP OF SIDEWALK
BM = EENCHMARK	ELEC. = ELECTRIC	LF = LINEAL FEET	SD = STORM DRAIN	TW = TOP OF WALL
CATV = CABLE TELEVISION LINE	ELEV = ELEVATION	MH = MANHOLE	STA = STATION	TYP = TYPICAL
CMP = CORRUGATED METAL PIPE	EX = EXISTING	NG = NATURAL GROUND	STD = STANDARD	TB = TELEPHONE BOX
CO = CLEANOUT	FF = FINISHED FLOOR ELEVATION	OE = OVERHEAD ELECTRIC LINE	SW = SIDEWALK	UE =
COA = CITY OF ALBUQUERQUE	FG = FINISHED GRADE	PCC = PORTLAND CEMENT CONCRETE	T = TELEPHONE	UT =
CONC = CONCRETE	FH = FIRE HYDRANT	PP = POWER POLE	TA = TOP OF ASPHALT PAVEMENT	W = WATER
CL = CENTERLINE	FL = FLOW LINE	PROP = PROPOSED	TAC = TOP OF ASPHALT CURB	WM = WATER METER
DIA = DIAMETER	GM = GAS METER	PVC = POLYVINYL CHLORIDE PIPE	TC = TOP OF CONCRETE SLAB (PAVEMENT)	WV WATER VALVE

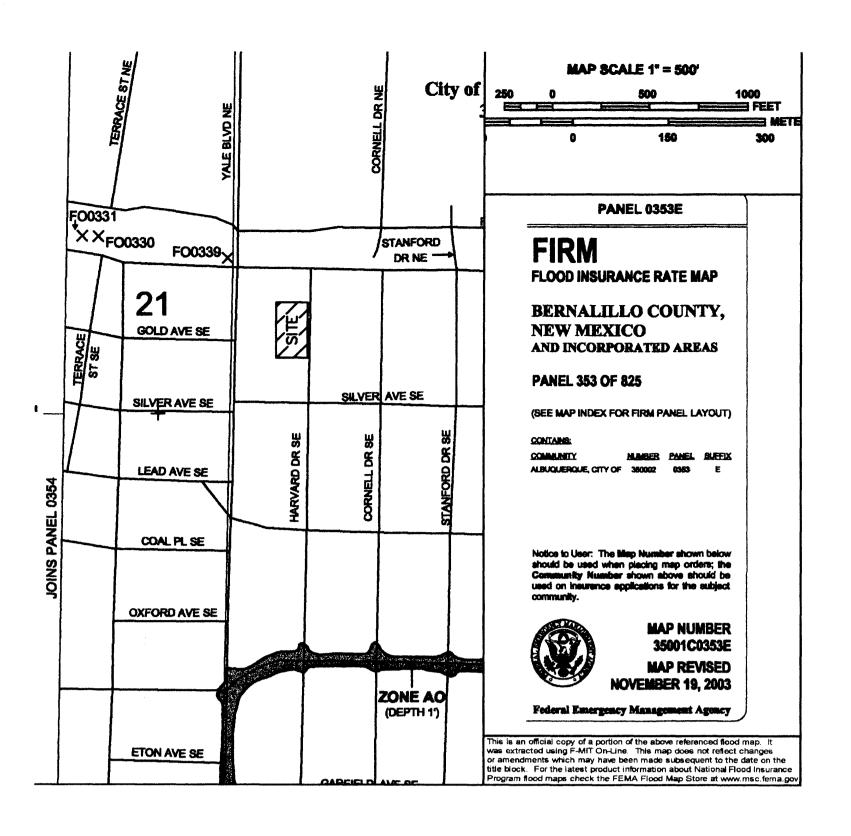

#### 100-YEAR HYDROLOGIC CALCULATIONS

		L	AND TR	EATMEN	T	WEIGHTED					
BASIN	AREA	Α	В	С	D	E	V (6-hr)	V (6-hr)	V(10 day)	V(10 day)	Q
#	(acre)	(%)	(%)	(%)	(%)	(in)	(acre-ft)	(cu-ft)	(acre-ft)	(cu-ft)	(cfs)
					EXISTI	NG CONDITIO	NS				
SITE	0.8150	0.00	5.00	5.00	90.00	2.00	0.14	5,927	0.23	10,187	3.67
					PROPOS	ED CONDITI	ONS		***************************************	• • • • • • • • • • • • • • • • • • •	
SITE	0.8150	0.00	5.00	5.00	90.00	2.00	0.14	5,927	0.23	10,187	3.67
	PRECIP.	0.53 1.56	0.78 2.28	1.13 3.14	2.12	E <sub>i</sub> (in)					
PEAR DIS	CHANGE	1.30	2.20	3.14	4.7	QPi (cfs)			ZONE =	2	
WEIGHTED E (in) = $(E_A)(\%A) + (E_B)(\%B) + (E_C)(\%C) + (E_D)(\%D)$									P <sub>6-HR</sub> (in.) =	2.35	
V <sub>6-HR</sub> (acre-ft) = (WEIGHTED E)(AREA)/12								$P_{24-HR}$ (in.) = 2.75			
V10DAY (acre	$V_{10DAY} (acre-ft) = V_{6-HR} + (A_D)(P_{10DAY} - P_{6-HR})/12$								P10DAY (in.) =	3.95	
$Q (cfs) = (Q_{PA})(A_A) + (Q_{PB})(A_B) + (Q_{PC})(A_C) + (Q_{PD})(A_D)$											

# DRAINAGE INFORMATION

# LOCATION & DESCRIPTION

THE PROPOSED SITE IS 0.815 ACRES LOCATED ON THE WEST SIDE OF HARVARD DRIVE AND SOUTH OF CENTRAL AVENUE AS SEEN ON THE VICINITY MAP ON SHEET COO1. THE LOT IS DEVELOPED WITH DEVELOPED LOTS NORTH AND SOUTH OF IT. IT IS BOUNDED BY HARVARD DRIVE TO THE EAST AND AN ALLEY TO THE WEST.

# FLOODPLAIN STATUS

THIS PROJECT, AS SHOWN ON FEMA'S FLOOD INSURANCE RATE MAP 35001C0353 E, DATED NOVEMBER 19, 2003 IS NOT WITHIN ANY DESIGNATED 100—YEAR FLOODPLAIN. A PORTION OF THIS PANEL WITH THE SITE DESIGNATED ON IT IS INCLUDED ON THIS SHEET.

# METHODOLOGY

THE HYDROLOGY FOR THIS PROJECT WAS ANALYZED USING THE QUICK CALCULATION METHOD AS DOCUMENTED IN THE JUNE 1997 RELEASE OF THE CITY OF ALBUQUERQUE DEVELOPMENT PROCESS MANUAL, SECTION 22.2.

# EXISTING DRAINAGE

THE SITE IS DEVELOPED AS DESCRIBED ABOVE IN "LOCATION AND DESCRIPTION." THE EXISTING BUILDINGS HAVE PITCHED ROOFS DRAINING NORTH AND SOUTH. THE GROUND IS COVERED WITH BRICK PAVERS WITH A HIGH POINT AT APPROXIMATELY THE EAST PROPERTY LINE DRAINING THESE LOTS WEST TO THE ALLEY AT APPROXIMATELY A 0.75% GRADE. THE BRICK PAVERS WITHIN THE HARVARD RIGHT-OF-WAY DRAIN TO THE STREET. THE SITE IS 90% IMPERVIOUS. THE ALLEY WHICH DRAINS THIS SITE HAS APPROXIMATELY A 2" INVERTED CROWN CENTERED WITHIN THE 16' WIDTH AND SLOPES FROM NORTH TO SOUTH AT APPROXIMATELY A 0.45% GRADE. DUE TO EXISTING DEVELOPMENT, ALL RUNOFF IS DIRECTED TO EITHER HARVARD STREET OR THE ALLEY. THEREFORE, THERE IS NO OFFSITE RUNOFF ENTERING THIS SITE.

# DEVELOPED CONDITION

THESE FIVE LOTS WILL BE REPLATTED INTO A SINGLE LOT WITH FOUR NEW STRUCTURES. SIMILAR TO EXISTING CONDITIONS, THE FOUR BUILDINGS WILL DRAIN INTO THE THREE LANDSCAPED AREAS BETWEEN THE BUILDINGS. THESE LANDSCAPED AREAS WILL BE GRADED TO DRAIN WEST TO THE ALLEY. THIS DEVELOPMENT WILL ALSO BE 90% IMPERVIOUS. THEREFORE, NO CHANGES WILL BE MADE TO THE EXISTING RUNOFF FROM THIS SITE. THE HARVARD RIGHT-OF-WAY WILL REMAIN AS IT IS WITH BRICK PAVERS. A SMALL AREA OF THE STREET WILL BE NARROWED TO MATCH THE STREET SECTION TO THE SOUTH BUT DRAINAGE WILL NOT BE ALTERED.

LARRY READ & ASSOCIATES
Civil Engineers

2430 Midtown Place, NE Suite C Albuquerque, New Mexico 87107 (505) 345-0620 Fax (505) 237-8422 by revision

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Mullen Heller Architecture P.C

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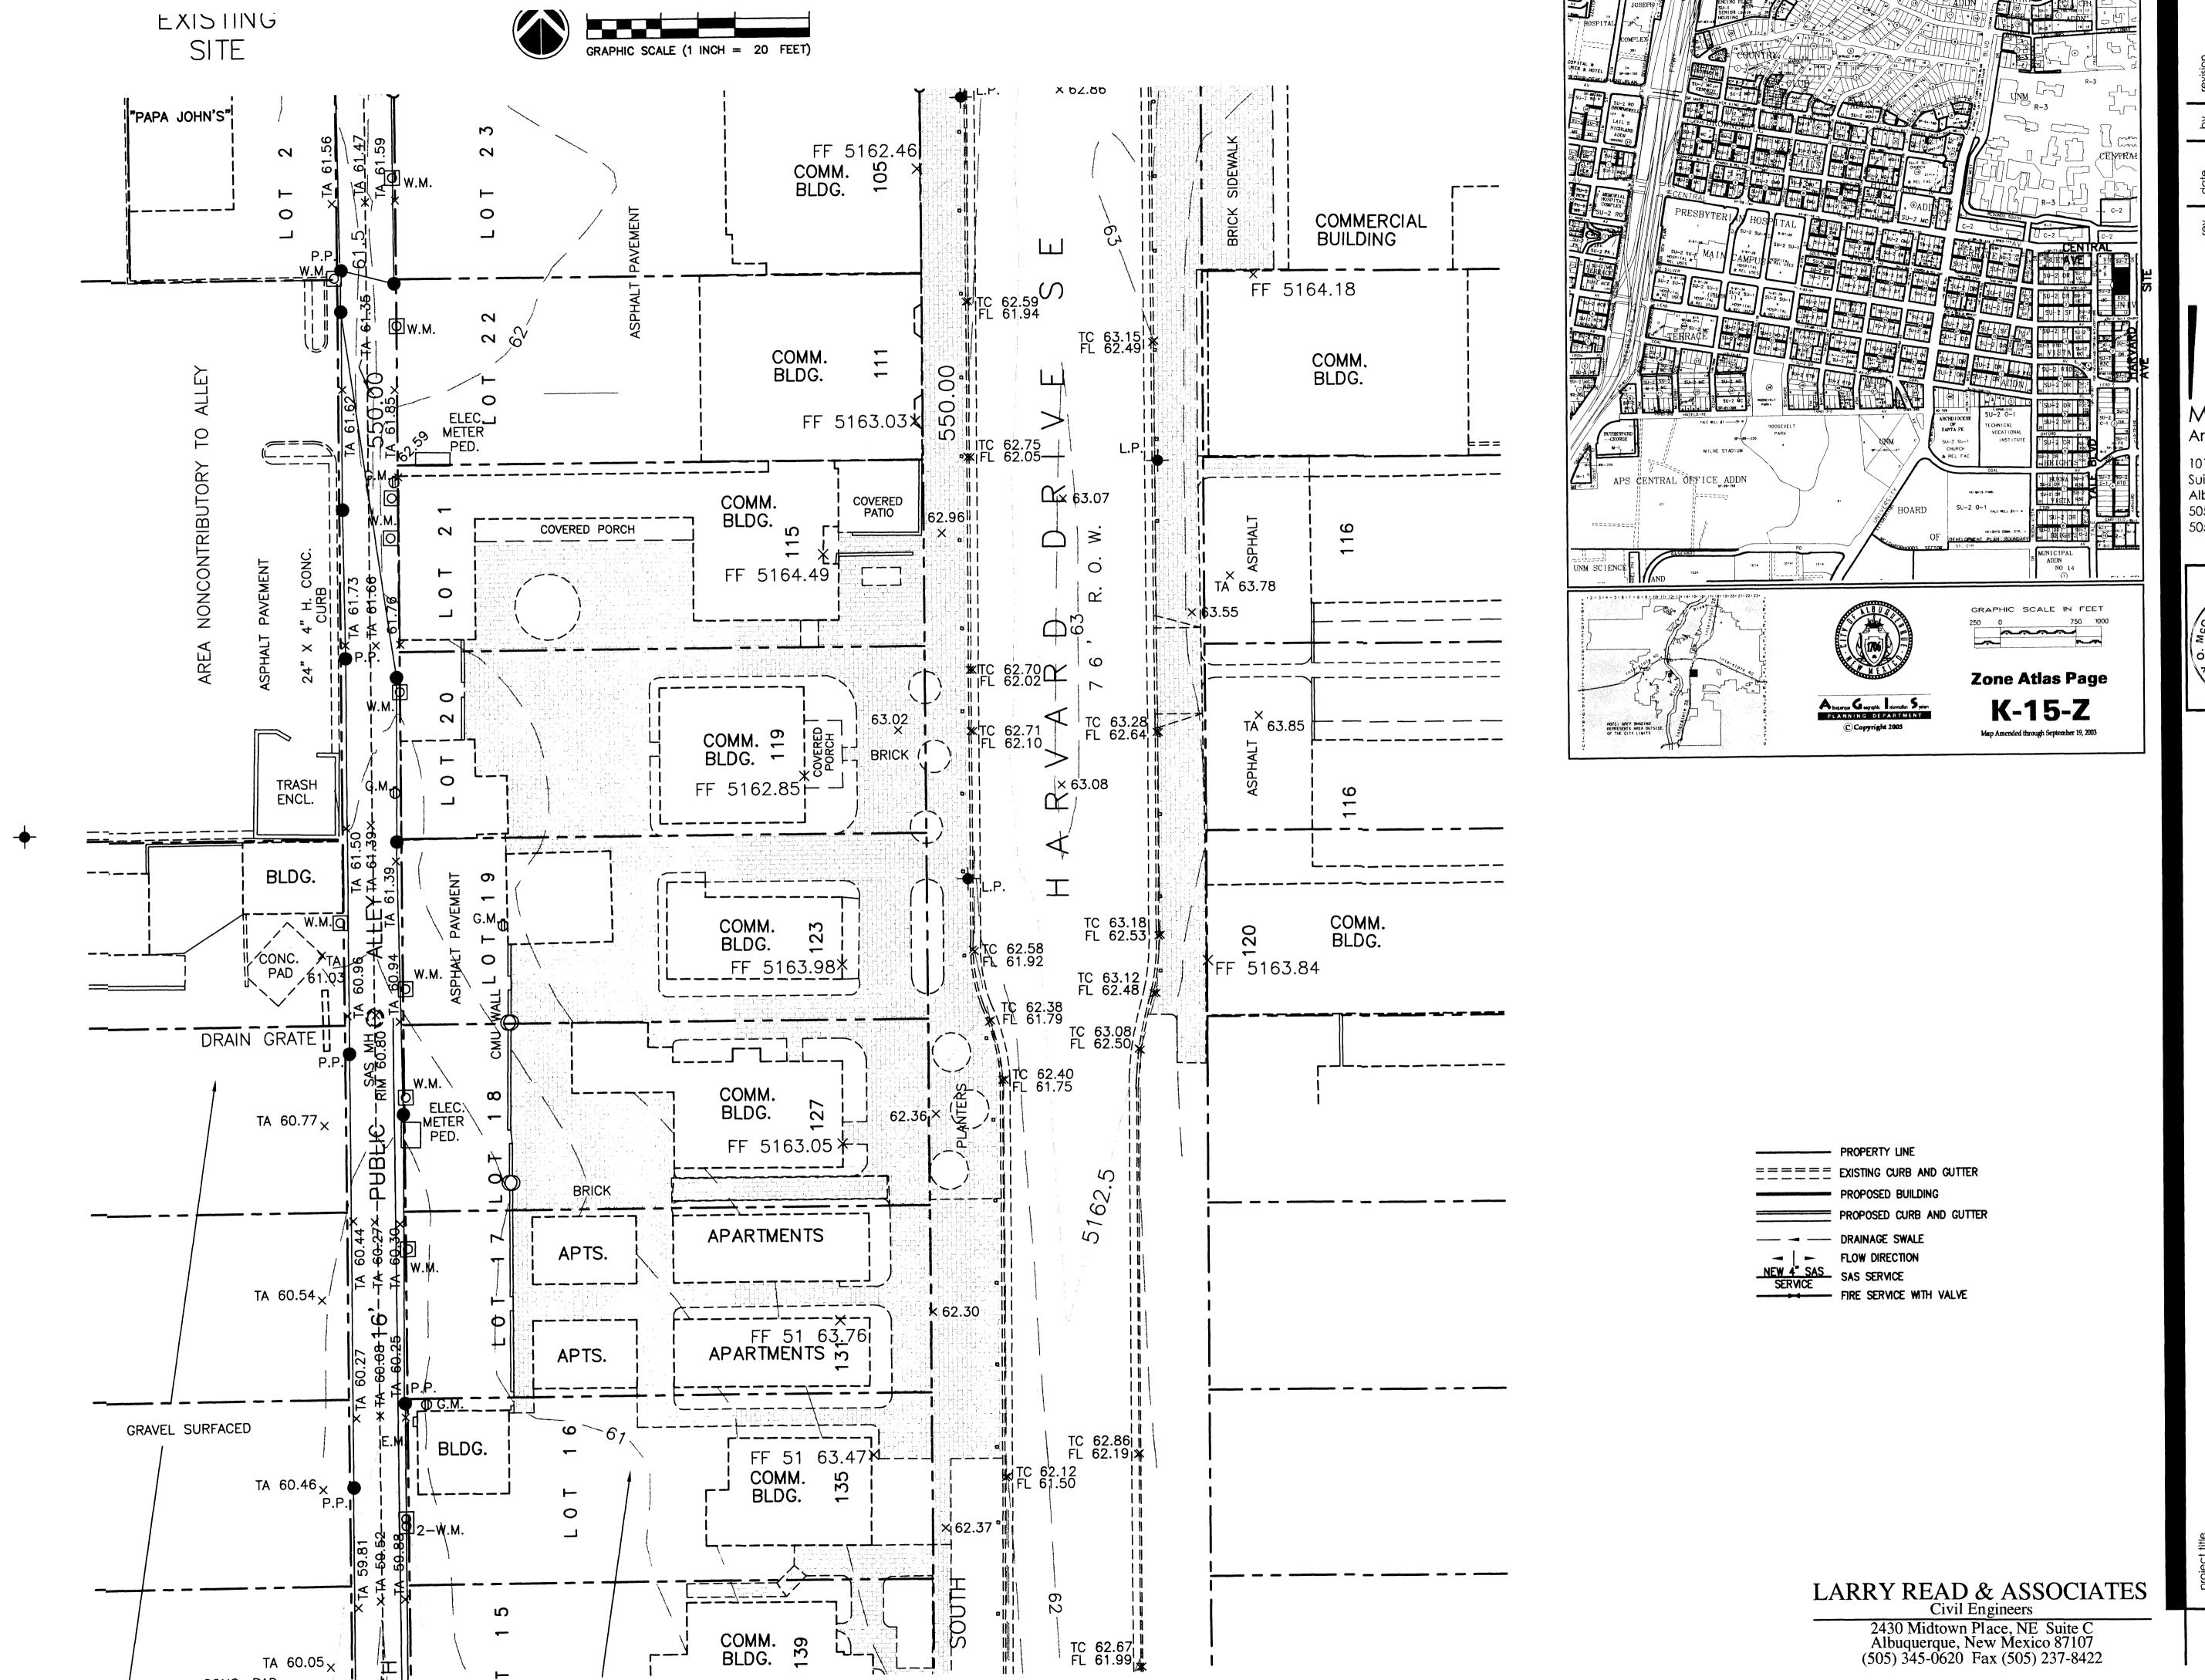


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drawn by BOM
project manager JDH
date 11/14/06

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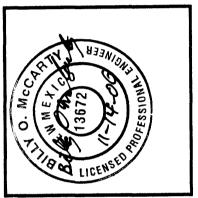


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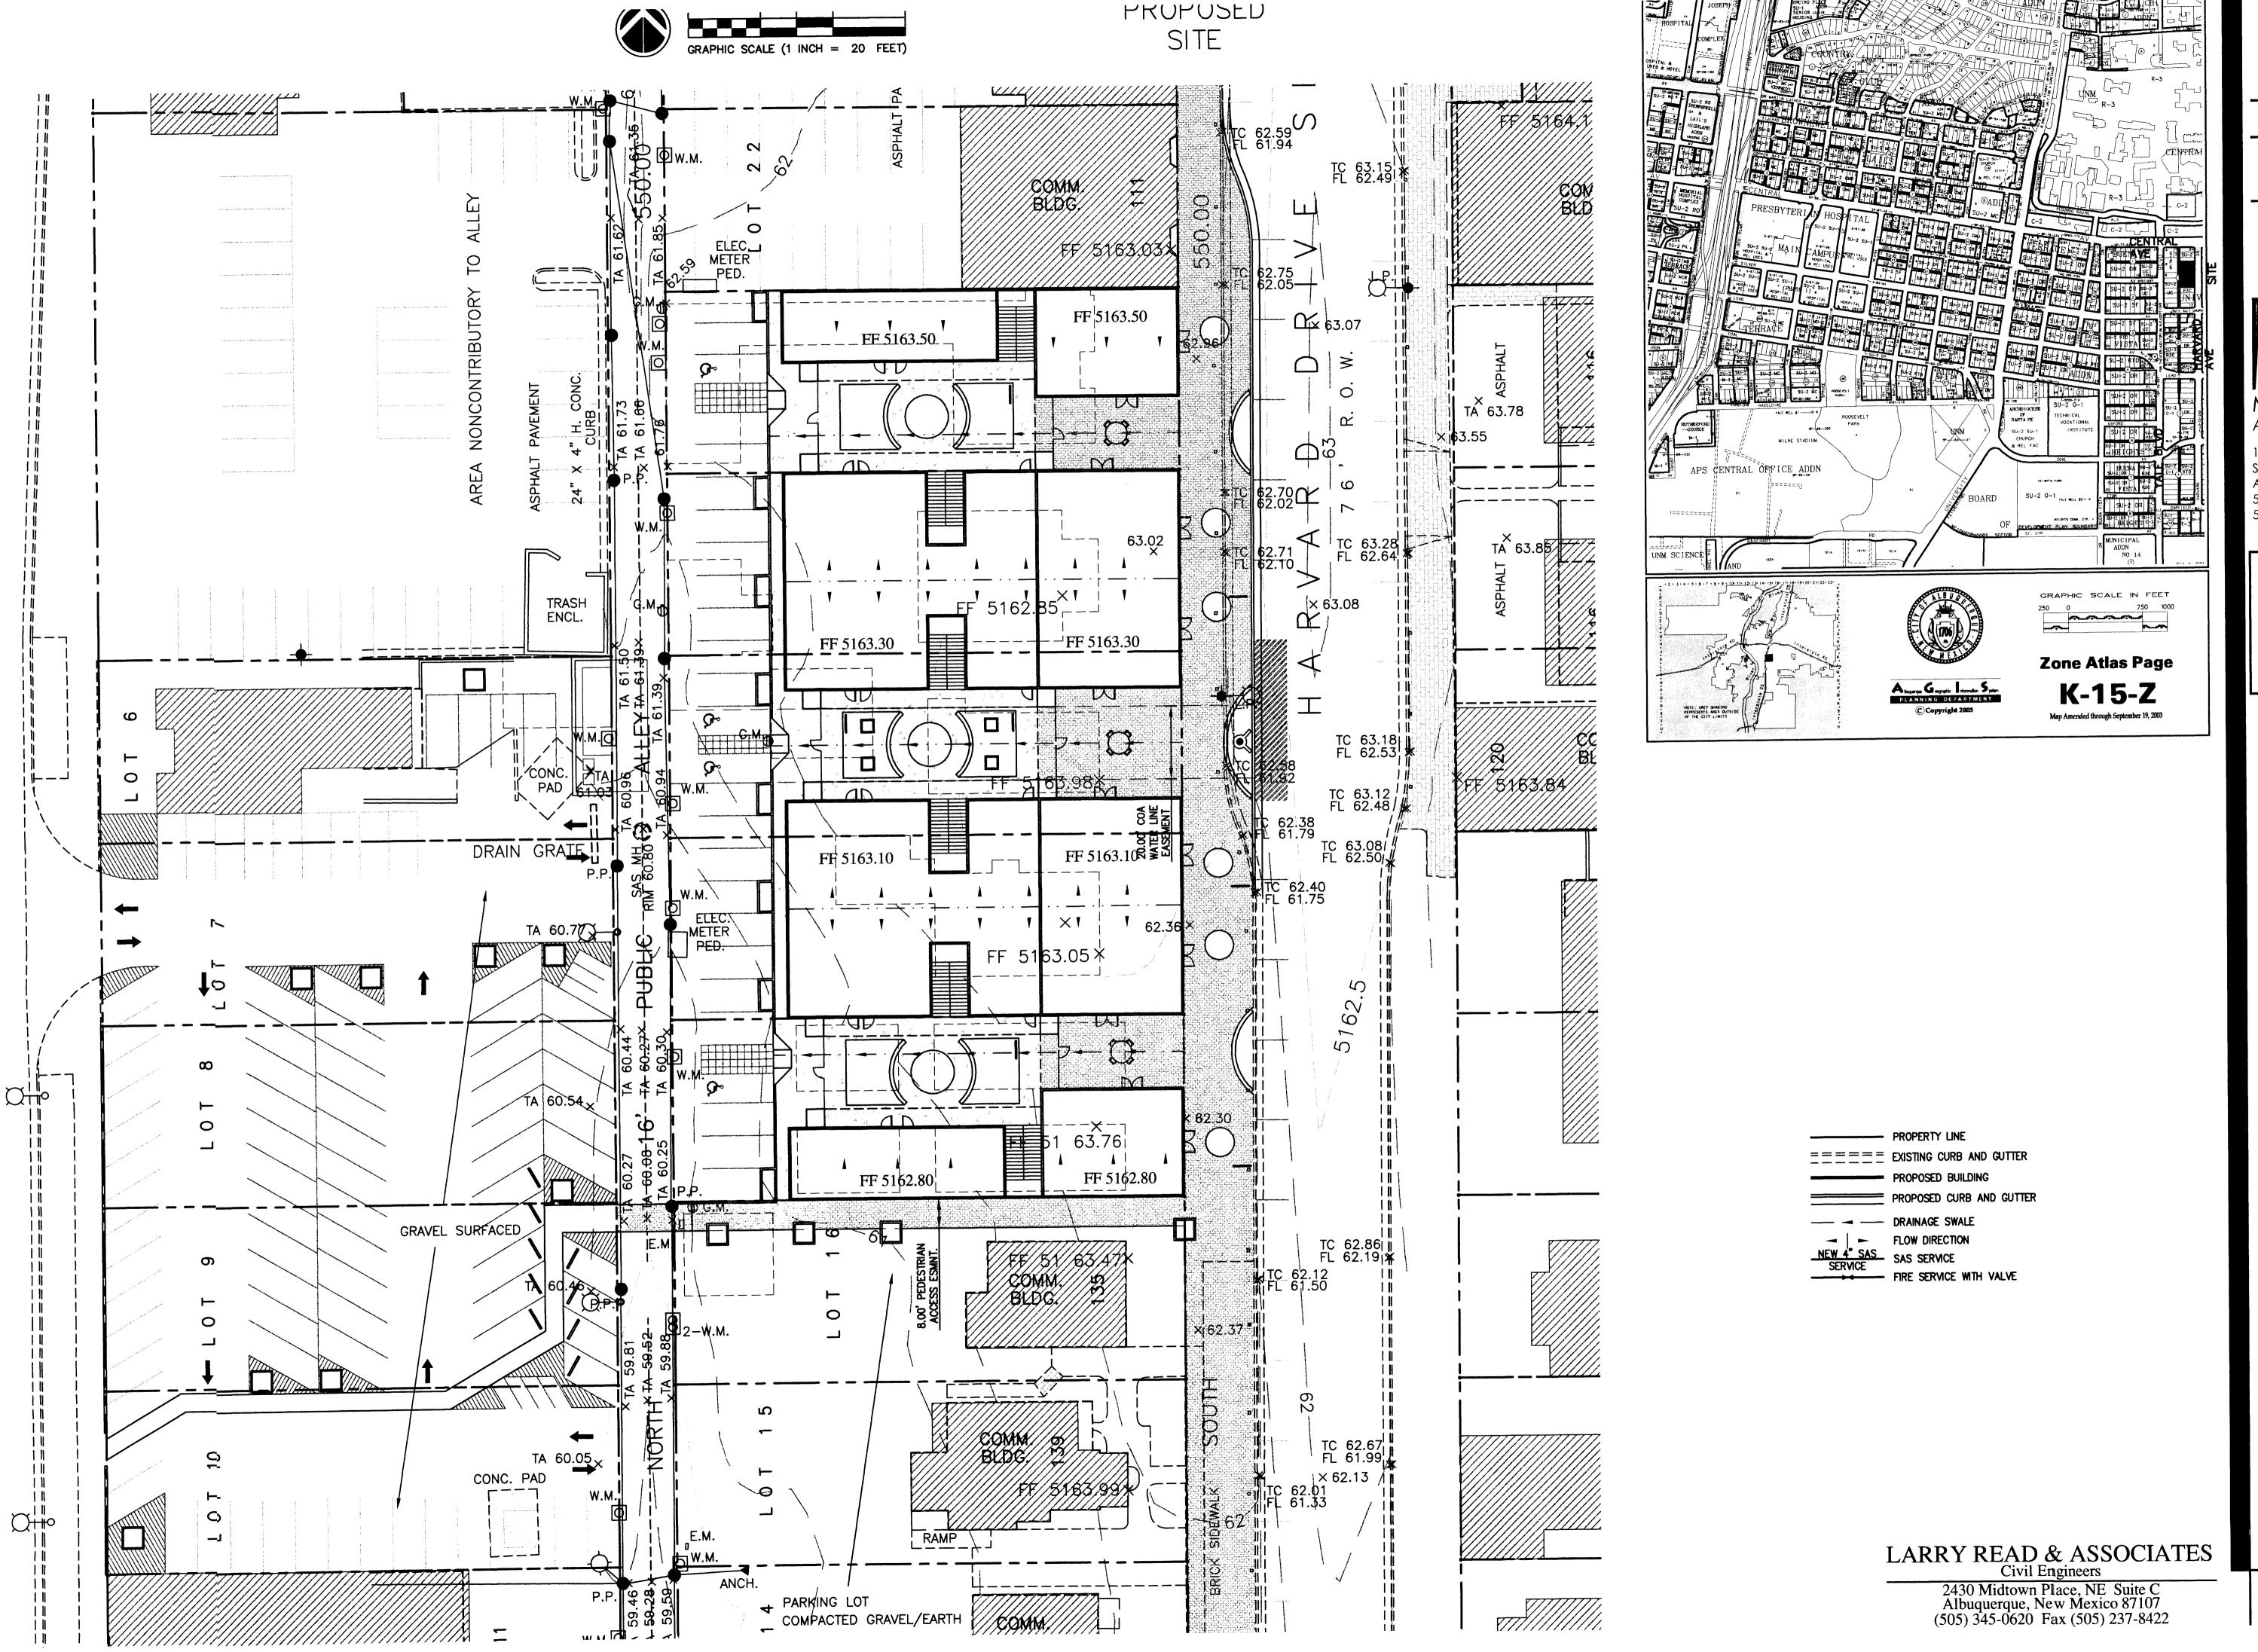


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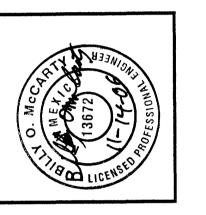
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Bricklight Courtyards
Lots 6–10, 17–21, Block 1, University Heig
Albuquerque, New Mexico

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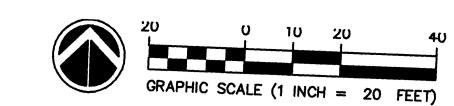



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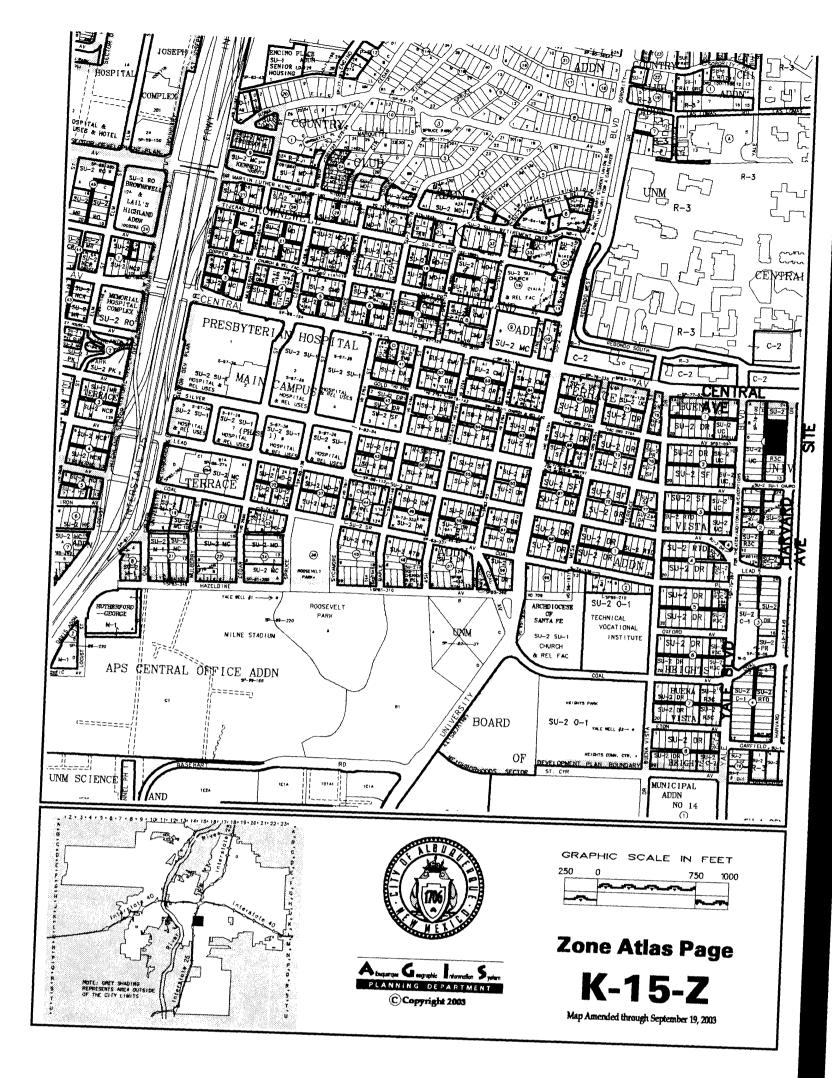


Bricklight Lots 6-10, 17-Albuquerque, Ne

C003





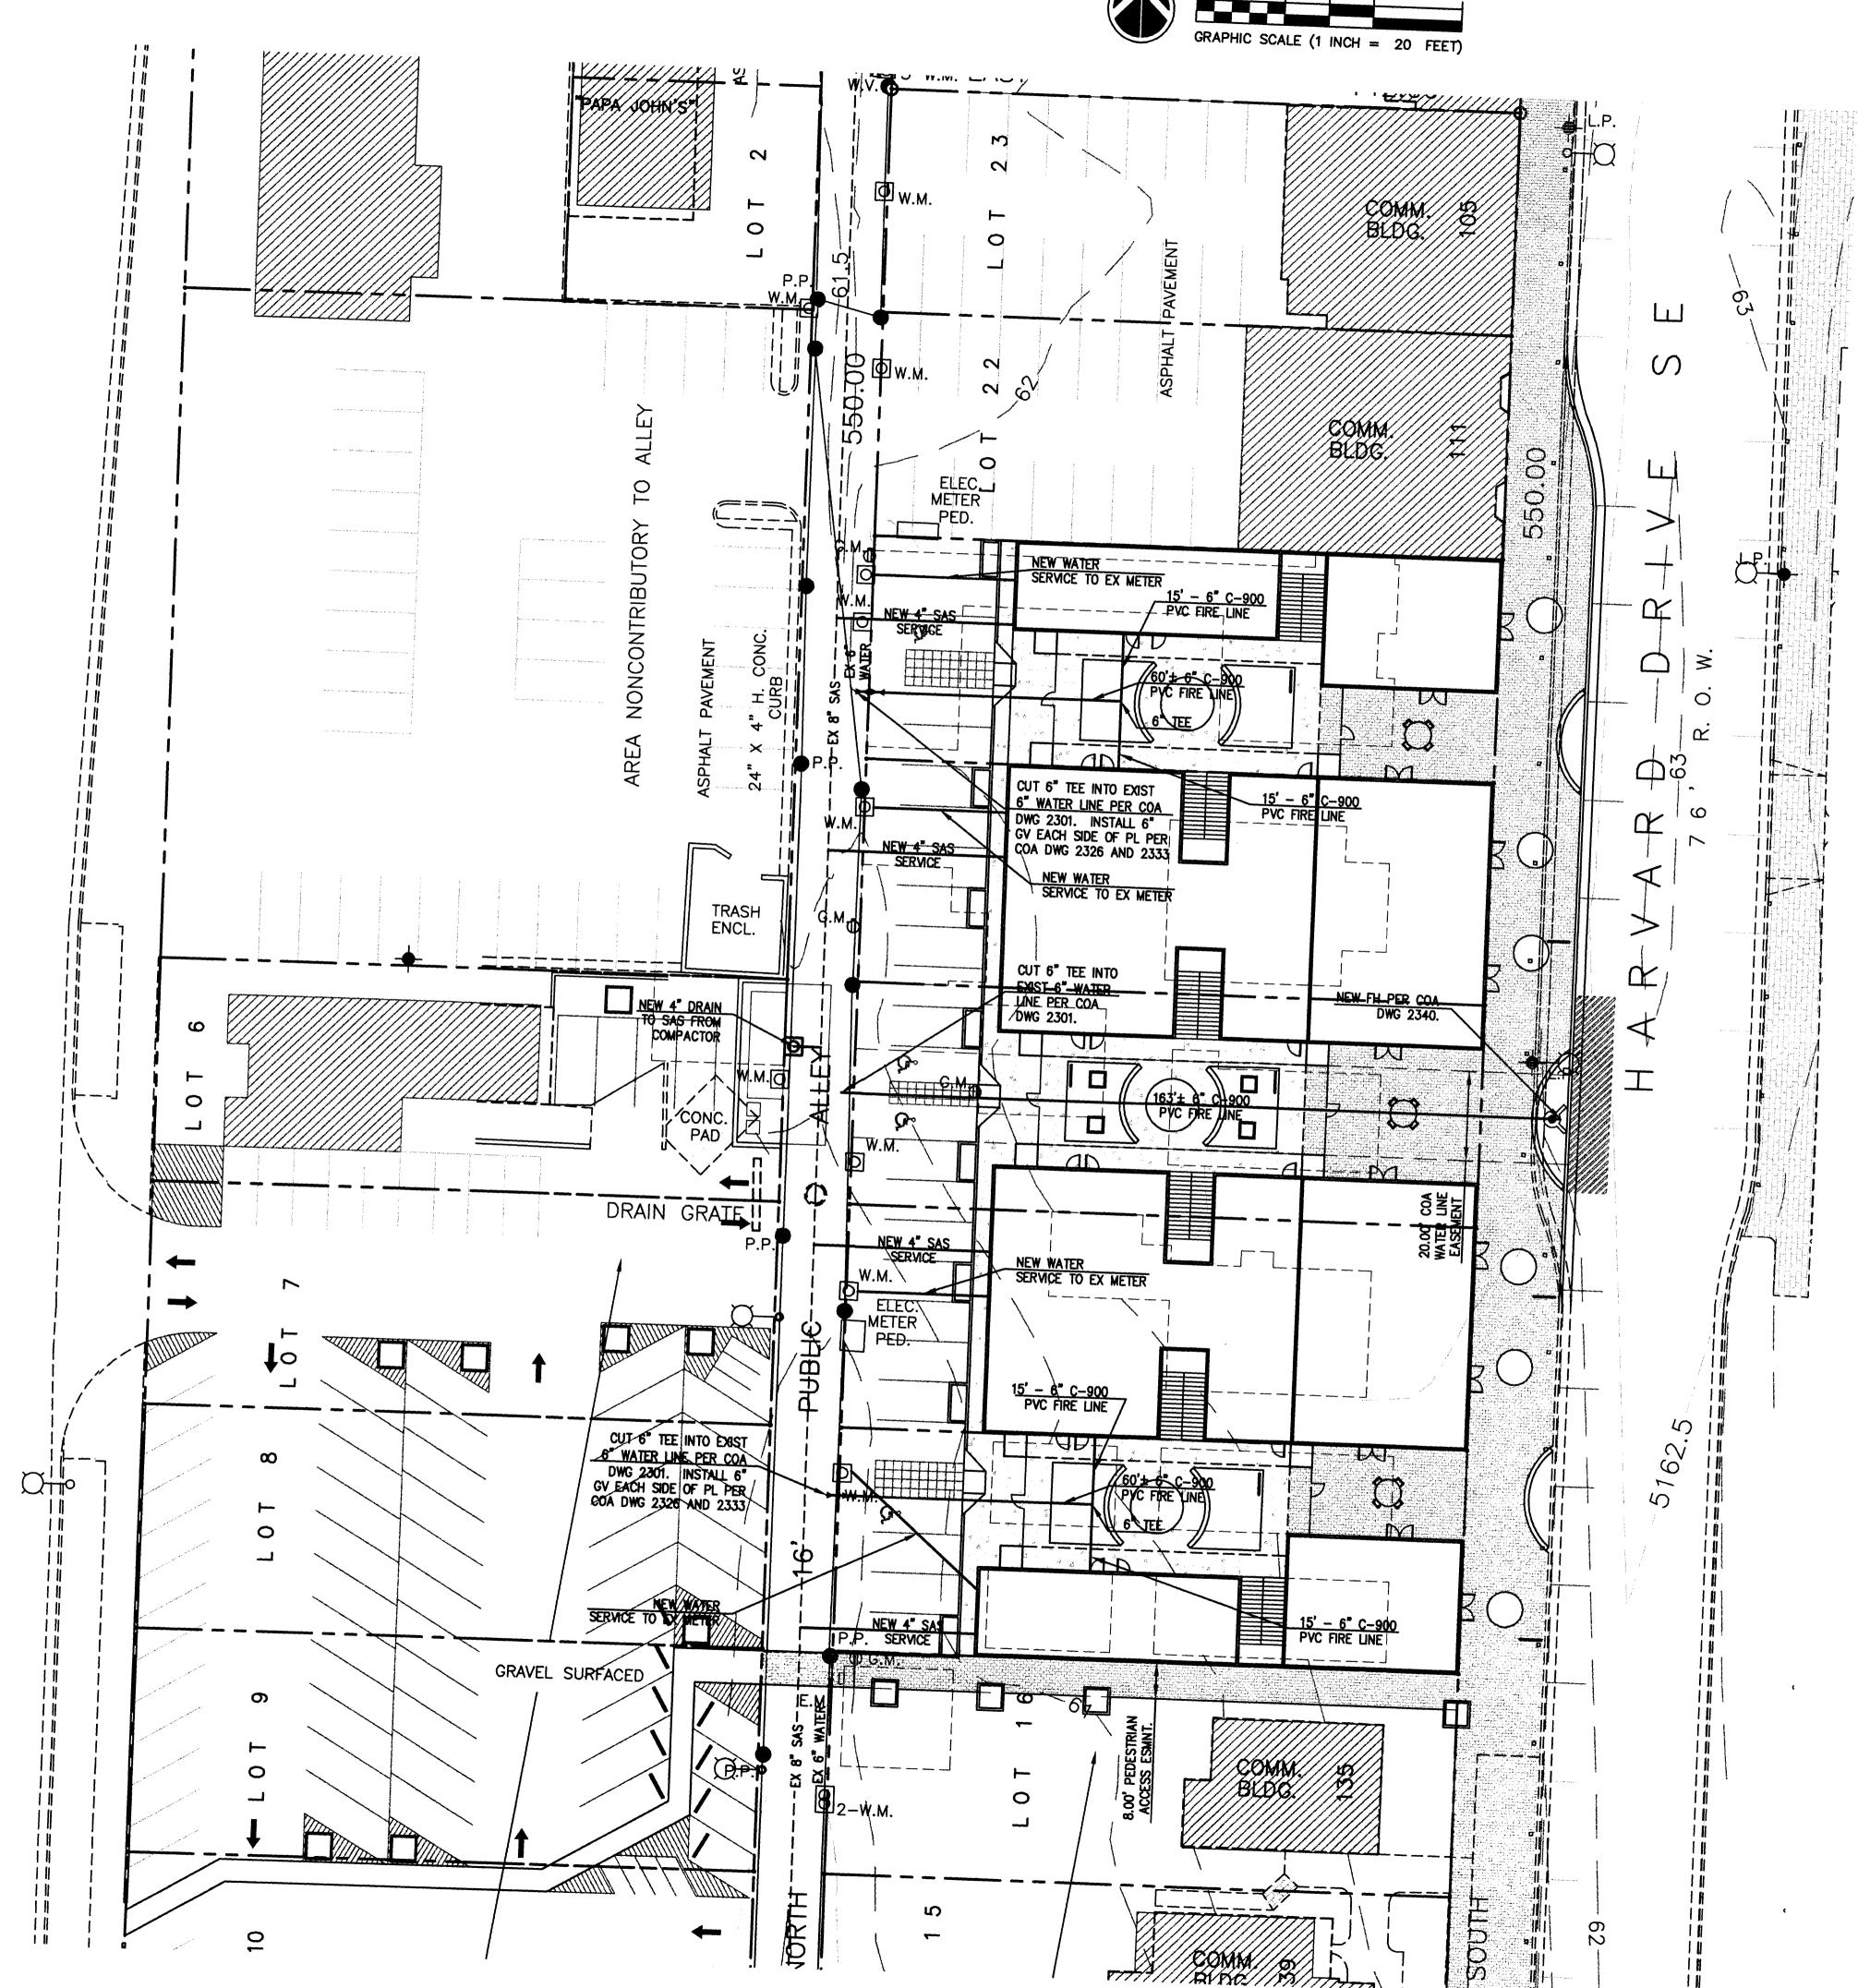

PROPERTY LINE ===== EXISTING CURB AND GUTTER PROPOSED BUILDING PROPOSED CURB AND GUTTER --- DRAINAGE SWALE FLOW DIRECTION NEW 4" SAS SERVICE

FIRE SERVICE WITH VALVE

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