

THIS IS TO CERTIFY THAT TAXES ARE CURRENT AND PAID ON UPC#	۷D
PROPERTY OWNER OF RECORD:	
BERNALILLO COUNTY TREASURER'S OFFICE:	

PUBLIC UTILITY EASEMENT APPROVALS

QWEST COMMUNICATIONS	DATE
PUBLIC SERVICE CO. OF NEW MEXICO	DATE
NEW MEXICO GAS CO.	DATE
COMCAST CABLE	DATE

PUBLIC UTILITY EASEMENTS SHOWN ON THIS PLAN ARE GRANTED FOR COMMON AND JOINT USE OF:

1. PUBLIC SERVICE COMPANY OF NEW MEXICO ELECTRIC SERVICES FOR THE INSTALLATION, MAINTENANCE AND SERVICE OF OVERHEAD AND UNDERGROUND ELECTRICAL LINES, TRANSFORMERS, POLES, AND OTHER EQUIPMENT, FIXTURES, STRUCTURES AND RELATED FACILITIES REASONABLY NECESSARY TO PROVIDE ELECTRICAL SERVICE.

- 2. NEW MEXICO GAS COMPANY FOR THE INSTALLATION, MAINTENANCE AND SERVICE OF NATURAL GAS LINES, VALVES AND OTHER EQUIPMENT AND FACILITIES REASONABLY NECESSARY TO PROVIDE NATURAL GAS SERVICE.
- 3. QWEST COMMUNICATIONS FOR THE INSTALLATION, MAINTENANCE AND SERVICE OF ALL BURIED AND AERIAL COMMUNICATION LINES AND OTHER RELATED EQUIPMENT AND FACILITIES REASONABLY NECESSARY TO PROVIDE COMMUNICATION SERVICES, INCLUDING BUT NOT LIMITED TO, ABOVE GROUND PEDESTALS AND CLOSURES.
- 4. COMCAST CABLE FOR THE INSTALLATION, MAINTENANCE AND SERVICE OF SUCH LINES, CABLE AND OTHER EQUIPMENT AND FACILITIES REASONABLY NECESSARY TO PROVIDE CABLE TV SERVICE.

INCLUDED IS THE RIGHT TO BUILD, REBUILD, CONSTRUCT, RECONSTRUCT, LOCATE, RELOCATE, CHANGE, REMOVE, MODIFY, RENEW, OPERATE AND MAINTAIN FACILITIES FOR THE PURPOSES DESCRIBED ABOVE, TOGETHER WITH FREE ACCESS, TO, FROM AND OVER SAID EASEMENTS, INCLUDING SUFFICIENT WORKING AREA SPACE FOR ELECTRIC TRANSFORMERS, WITH THE RIGHT TO TRIM AND REMOVE TREES, SHRUBS OR BUSHES WHICH INTERFERE WITH PURPOSES SET FORTH HEREIN. NO BUILDING, SIGN, POOL (ABOVE GROUND OR SUBSURFACE), HOT TUB, CONCRETE OR WOOD DECKING OR OTHER STRUCTURE SHALL BE ERECTED OR CONSTRUCTED ON SAID EASEMENTS, NOR SHALL ANY WELL BE DRILLED OR OPERATED THEREON. PROPERTY OWNERS SHALL BE SOLELY RESPONSIBLE FOR CORRECTING ANY VIOLATION OF THE NATIONAL ELECTRIC OR SAFETY CODE CAUSED BY CONSTRUCTION OF POOLS, DECKING, OR ANY STRUCTURES ADJACENT TO, OR WITHIN, OR NEAR EASEMENTS SHOWN ON THIS PLAT.

LEGAL DESCRIPTION

A PARCEL OF LAND SITUATED IN SECTION 1, T11N, R2E, N.M.P.M., CITY OF ALBUQUERQUE, BERNALILLO COUNTY, NEW MEXICO; SAID PARCEL BEING THE SAME AS TRACT A-1-A, B-1-A, B-1-B & C-1-A OF BLACK ARROYO DAM, FILED IN THE OFFICE OF THE COUNTY CLERK OF BERNALILLO COUNTY, NEW MEXICO ON JULY 16, 2007 IN BK. 2007C. PG. 190 AND MORE PARTICULARLY DESCRIBED USING NEW MEXICO STATE PLANE BEARINGS (CENTRAL ZONE) AND HORIZONTAL GROUND DISTANCES AS FOLLOWS:

BEGINNING AT THE NORTHWEST CORNER OF THE PARCEL HEREIN DESCRIBED, FROM WHENCE THE MONUMENT ACS 1-E11 BEARS N44.58.42. A DISTANCE OF 1387.61 FEET; THENCE,

S89°49'54"E, 461.71 feet along the south right—of—way of Westside Blvd. NW to a point; thence,

Southeasterly, 7.61 feet along the arc of a curve right, said curve having a radius of 25.00 feet and a long chord bearing S20°02'36"E a distance of 6.98 feet; thence,

S89'49'54"E, 430.25 feet to a point; thence,

Southeasterly, 39.79 feet along the arc of a curve right, said curve having a radius of 25.00 feet and a long chord bearing S44*47'23"E a distance of 35.72 feet and transitioning from the south right—of—way of Westside Blvd. NW to the west right—of—way of Golf Course Rd. NW; thence,

S00°15'59"W, 161.47 feet to a point; thence

Southeasterly, 316.27 feet along the arc of a curve left, said curve having a radius of 696.46 feet and a long chord bearing S12*42'26"E a distance of 313.55 feet; thence,

Southeasterly, 316.27 feet along the arc of a curve left, said curve having a radius of 696.46 feet and a long chord bearing S12*42'26"E a distance of 313.55 feet; thence.

Southwesterly, 42.24 feet along the arc of a curve right, said curve having a radius of 25.00 feet and a long chord bearing S22*36'06"W a distance of 35.72; thence.

S18°59'54"E, 56.00 feet to a point; thence

Southeasterly, 41.18 feet along the arc of a curve right, said curve having a radius of 25.00 feet and a long chord bearing S61*48'42"E a distance of 36.68 feet; thence,

Southeasterly, 194.09 feet along the arc of a curve right, said curve having a radius of 747.37 feet and a long chord bearing S07*19'54"E a distance of 193.54 feet; thence,

S00°18'44"W, 192.09 feet to a point; thence

S01°24'18"E, 137.86 feet to a point; thence departing from the west right—of—way of Golf Course Rd. NW,

N89'03'34"W, 110.48 feet to a point; thence

N51°39'41"W, 125.84 feet to a point; thence

N31°48'38"E, 101.07 feet to a point; thence

N58*05'54"W, 78.01 feet to a point; thence

N29°53'57"E, 71.20 feet to a point; thence

N46°38'43"W, 554.44 feet to a point; thence

N42°49'25"W, 678.39 FEET TO A POINT, SAID POINT BEING THE POINT OF BEGINNING.

SAID PARCEL CONTAINS 11.9554 ACRES MORE OF LESS.

SURVEYOR'S CERTIFICATION

I, JEAN J. BORDENAVE, A REGISTERED PROFESSIONAL ENGINEER AND LAND SURVEYOR UNDER THE LAWS OF THE STATE OF NEW MEXICO, DO HEREBY CERTIFY THAT THIS PLAT WAS PREPARED BY ME OR UNDER MY SUPERVISION: MEETS THE MINIMUM REQUIREMENTS OF MONUMENTATION AND SURVEYS OF THE ALBUQUERQUE SUBDIVISION ORDINANCE; SHOWS EASEMENTS OF RECORD AND/OR INDICATED IN TITLE COMMITMENT NO. FT000120470, DATED FEBRUARY 19, 2007, ISSUED BY FIDELITY NATIONAL TITLE CO. AND OR MADE KNOWN TO ME BY THE OWNERS; AND THAT IT IS TRUE AND CORRECT TO THE BEST OF MY KNOWLEDGE AND BELIEF.

JEAN J. BORDENAVE, NMPE&LS NO. 5110

PLAT OF

TRACTS A-I-A-I, B-I-A-I & B-I-A-2 BLACK ARROYO DAM

ALBUQUERQUE, NEW MEXICO AUGUST, 2013

APPROVALS

PROJECT NO: 1004976 APPLICATION NO:13DRB-

CITY OF ALBUQUERQUE SURVEYOR

PARKS AND RECREATION DEPARTMENT

DATE

AMAFCA

CITY ENGINEER

DATE

ABCWUA

DATE

TRAFFIC ENGINEERING, TRANSPORTATION DIVISION

DATE

DRB CHAIRPERSON, PLANNING DEPARTMENT

DATE

DISCLOSURE STATEMENT

THE PURPOSE OF THIS PLAT IS TO: REDEFINE THE INTERNAL LOT LINES BETWEEN TRACTS, REDEFINE THE AMAFCA ACCESS, PRIVATE DRAINAGE AND PUBLIC UTILITY EASEMENT TO CONFORM TO THE AS—BUILT INFRASTRUCTURE AND GRANT PUBLIC UTILITY EASEMENTS FOR GAS, POWER AND COMMUNICATIONS.

FREE CONSENT AND DEDICATION

THE SUBDIVISION OF THE LAND DESCRIBED ON THIS PLAT IS WITH THE FREE CONSENT OF AND IN ACCORDANCE WITH THE DESIRE OF THE UNDERSIGNED OWNERS OF THE LAND. THE OWNERS DO HEREBY:

WARRANT THAT THEY HOLD AMONG THEM COMPLETE AND INDEFEASIBLE TITLE TO THE LAND SUBDIVIDED,

GRANT SPECIFIC SURFACE AND SUBSURFACE POWER, GAS, WATER, SEWER AND COMMUNICATION EASEMENTS AS DELINEATED ON THIS PLAT;

ACKNOWLEDGE EXISTING EASEMENTS AS SHOWN ON THIS PLAT:

STATE THAT THIS SUBDIVISION LIES WITHIN THE SUBDIVISION REGULATION JURISDICTION OF THE CITY OF ALBUQUERQUE, NEW MEXICO.

IN ADDITION THE OWNER OF TRACTS D AND E DOES HEREBY DEDICATE PUBLIC RIGHTS-OF-WAY, SHOWN HEREON, IN FEE SIMPLE WITH WARRANTY COVENANTS TO THE CITY OF ALBUQUERQUE.


TRACTS D & E (CALABACILLAS GROUP, A NEW MEXICO GENERAL PARTNERSHIP)


DONALD. D. HARVILLE, GENERAL PARTNER	
STATE OF NEW MEXICO) SS COUNTY OF BERNALILLO) THIS INSTRUMENT WAS ACKNOWLEDGED BEFORE ME	/
NOTARY PUBLIC:	, GENERAL PARTNER.



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EXIO



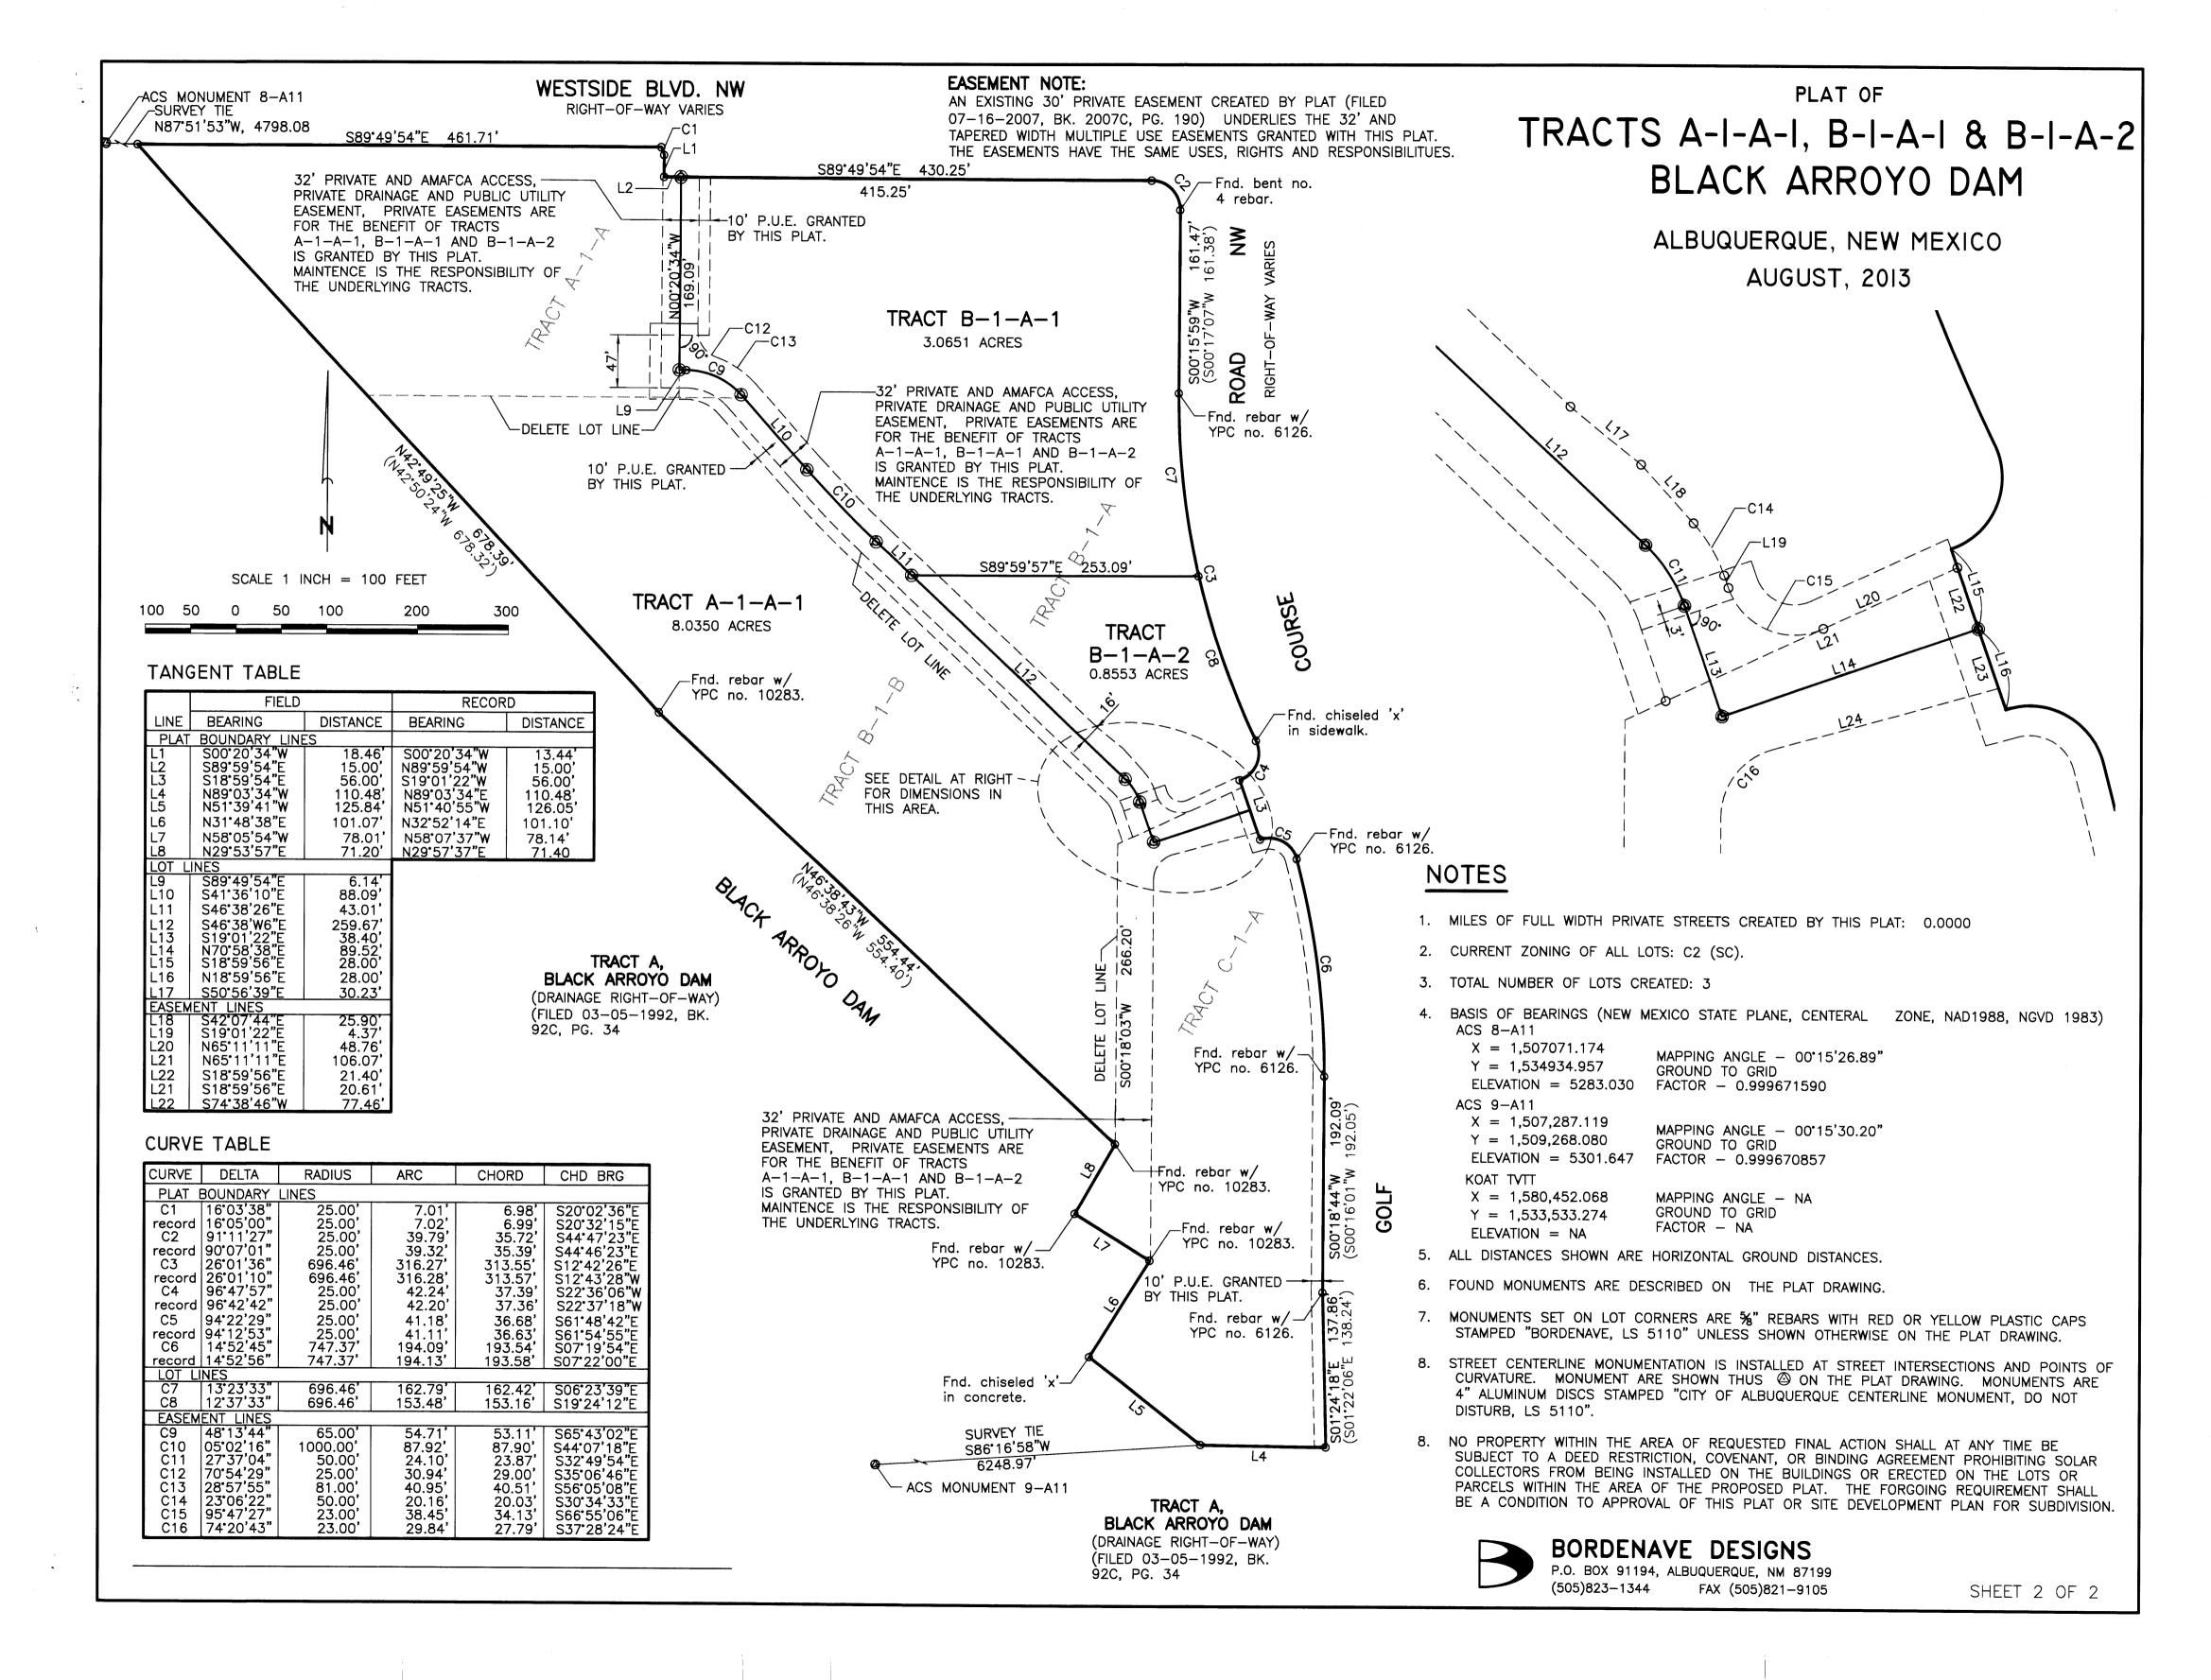

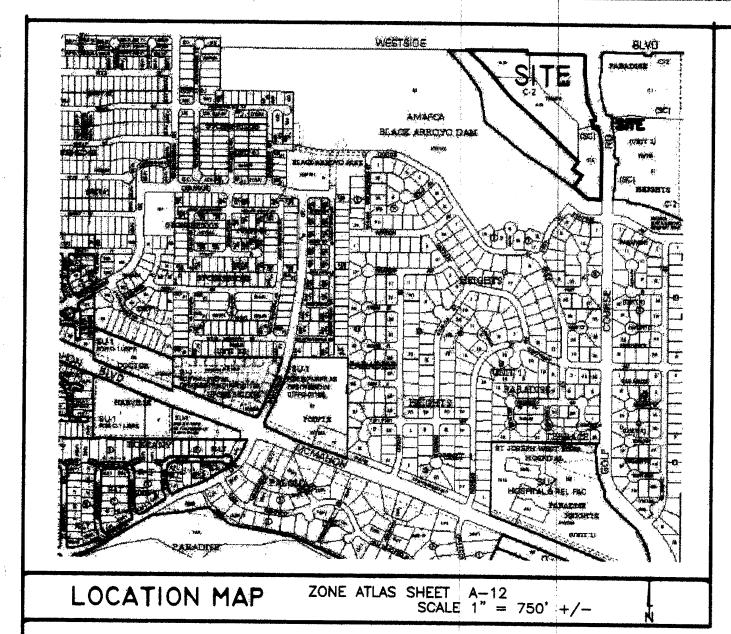THIS IS TO CERTIFY THAT TAXES ARE CURRENT AND See Parcels listed PAID ON UPC#____ PROPERTY OWNER OF RECORD:

Calabacillas Group

BERNALILLO COUNTY TREASURER'S OFFICE: F/15/13

PUBLIC UTILITY EASEMENT APPROVALS

An-	8/14/13
QWEST COMMUNICATIONS /d/b/a CENTURYLINK	DATE 8-/4-13
PUBLIC SERVICE CO. OF NEW MEXICO	DATE 8//3/20/3
NEW MEXICO GAS CO.	2/14/13
COMCAST CABLE	DATE

PUBLIC UTILITY EASEMENTS shown on this plat are grated for the common and joint use of: PUBLIC SERVICE COMPANY OF NEW MEXICO ((PNM), a New Mexico corporation, (PNM Electric) for installation, maintenance, and service of overhead and underground electrical lines, transformers, and other equipment and related facilities reasonably necessary to provide electrical services

NEW MEXICO GAS COMPANY for installation, maintenance, and service of natural gas lines, valves and other equipment and facilities reasonably necessary to provide natural gas Services

QWEST for the installation, maintenance, and service of such lines, cable and other related equipment and facilities reasonably necessary to provide communication services. CABLE TV for the installation, maintenance, and service of such lines, cable an other related equipment and facilities reasonably necessary to profide Cable services.

included is the right to build, rebuild, construct, reconstruct, locate, relocate, change, remove, replace, modify, renew, operate and maintain facilities for purposes described above together with free access to, from, and over said easements, with the right and privilege of going upon, over and across adjoining lands of Grantor for the purposes set forth herein and with the right to utilize the right of way and easement to extend services to customers of Grantee, including sufficient working area space for electric transformers, with the right and privilege to trim and remove trees, shrubs or bushes which interfere with purposes set forth herein. No building, sign, pool (aboveground or subsurface), hot tub, concrete or wood pool decking, or other structure shall be erected or constructed on said easements, nor shall any well be drilled or operated thereon. Property owners shall be solely responsible for correcting any violations of National Electrical Safety Code by construction of pools, decking. or any structures adjacent to or near easements shown on this plat.

Easements for electric transformer/switchgears, as installed, shall extend ten (10) feet in front of the transformer/swithchgear doors and five (5) feet on each side.

In approving this plat, Public Service Company of New Mexico (PNM) and New Mexico Gas Company (NMGC) did not conduct a Title Search of the properties shown hereon. Consequently, PNM and NMGC do not waive or release andy easement or easement rights which may have been granted by prior plat, replat or other document and which are not shown on this plat.

LEGAL DESCRIPTION

A PARCEL OF LAND SITUATED IN PROJECTED SECTION 1, T11N, R2E, N.M.P.M., TOWN OF ALAMEDA GRANT, CITY OF ALBUQUERQUE, BERNALILLO COUNTY, NEW MEXICO; SAID PARCEL BEING THE SAME AS TRACT A-1-A, B-1-A, B-1-B & C-1-A OF BLACK ARROYO DAM, FILED IN THE OFFICE OF THE COUNTY CLERK OF BERNALILLO COUNTY, NEW MEXICO ON JULY 16, 2007 IN BK. 2007C. PG. 190 AND MORE PARTICULARLY DESCRIBED LISING NEW MEXICO STATE BLANE PERFINOSE AND MORE PARTICULARLY DESCRIBED USING NEW MEXICO STATE PLANE BEARINGS (CENTRAL ZONE) AND HORIZONTAL GROUND DISTANCES AS FOLLOWS:

BEGINNING AT THE NORTHWEST CORNER OF THE PARCEL HEREIN DESCRIBED, FROM WHENCE THE MONUMENT ACS 1-E11 BEARS N87'50'09"W A DISTANCE OF 4799.34 FEET: THENCE.

S89'49'54"E, 461.71 feet along the south right-of-way of Westside Blvd. NW to

Southeasterly, 7.01 feet along the arc of a curve right, said curve having a radius of 25.00 feet and a long chord bearing \$20.02.36"E a distance of 6.98

S00'20'34"W, 18.46 feet to a point; thence.

S89'49'54"E, 430.25 feet to a point; thence,

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JEAN J. BORDENAVE, NMPE&LS NO. 8110

DOC# 2013091099 08/15/2013 09:17 AM Page: 1 of 2 htyPLAT R:\$25.00 B: 2013C P: 0096 M. Toulous Olivere, Bernalillo Cou

PLAT OF

TRACTS A-I-A-I, B-I-A-I & B-I-A-2 BLACK ARROYO DAM

ALBUQUERQUE, NEW MEXICO AUGUST, 2013

APPROVALS

PROJECT NO: 1004976 APPLICATION NO:13DRB-70650 8-14-13 DATE 8-14-13 PARKS AND RECREATION DEPARTMENT DATE m.mayu 8-14-13 DATE 8-14-13 08/14/13 DATE 08-14-13 TRAFFIC ENGINEERING, TRANSPORTATION DIVISION DATE 8-14-13 DRB CHAIRPERSON, PLANNING DEPARTMENT DATE

DISCLOSURE STATEMENT

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CALABACILLAS GROUP, A NEW MEXICO GENERAL PARTNERSHIP

Donald Harville DONALD. D. HARVILLE, GENERAL PARTNER

STATE OF NEW MEXICO) SS COUNTY OF BERNALILLO) SS THIS INSTRUMENT WAS ACKNOWLEDGED BEFORE ME ON

08 //3 / /3 BY DONALD D. HARVILLE , GENERAL PARTNER.

NOTARY PUBLIC:



BORDENAVE DESIGNS


P.O. BOX 91194, ALBUQUERQUE, NM 87199 (505)823-1344 FAX (505)821-9105


SHEET 1 OF 2

831 - 3349

Maria Losto OCU- 4650



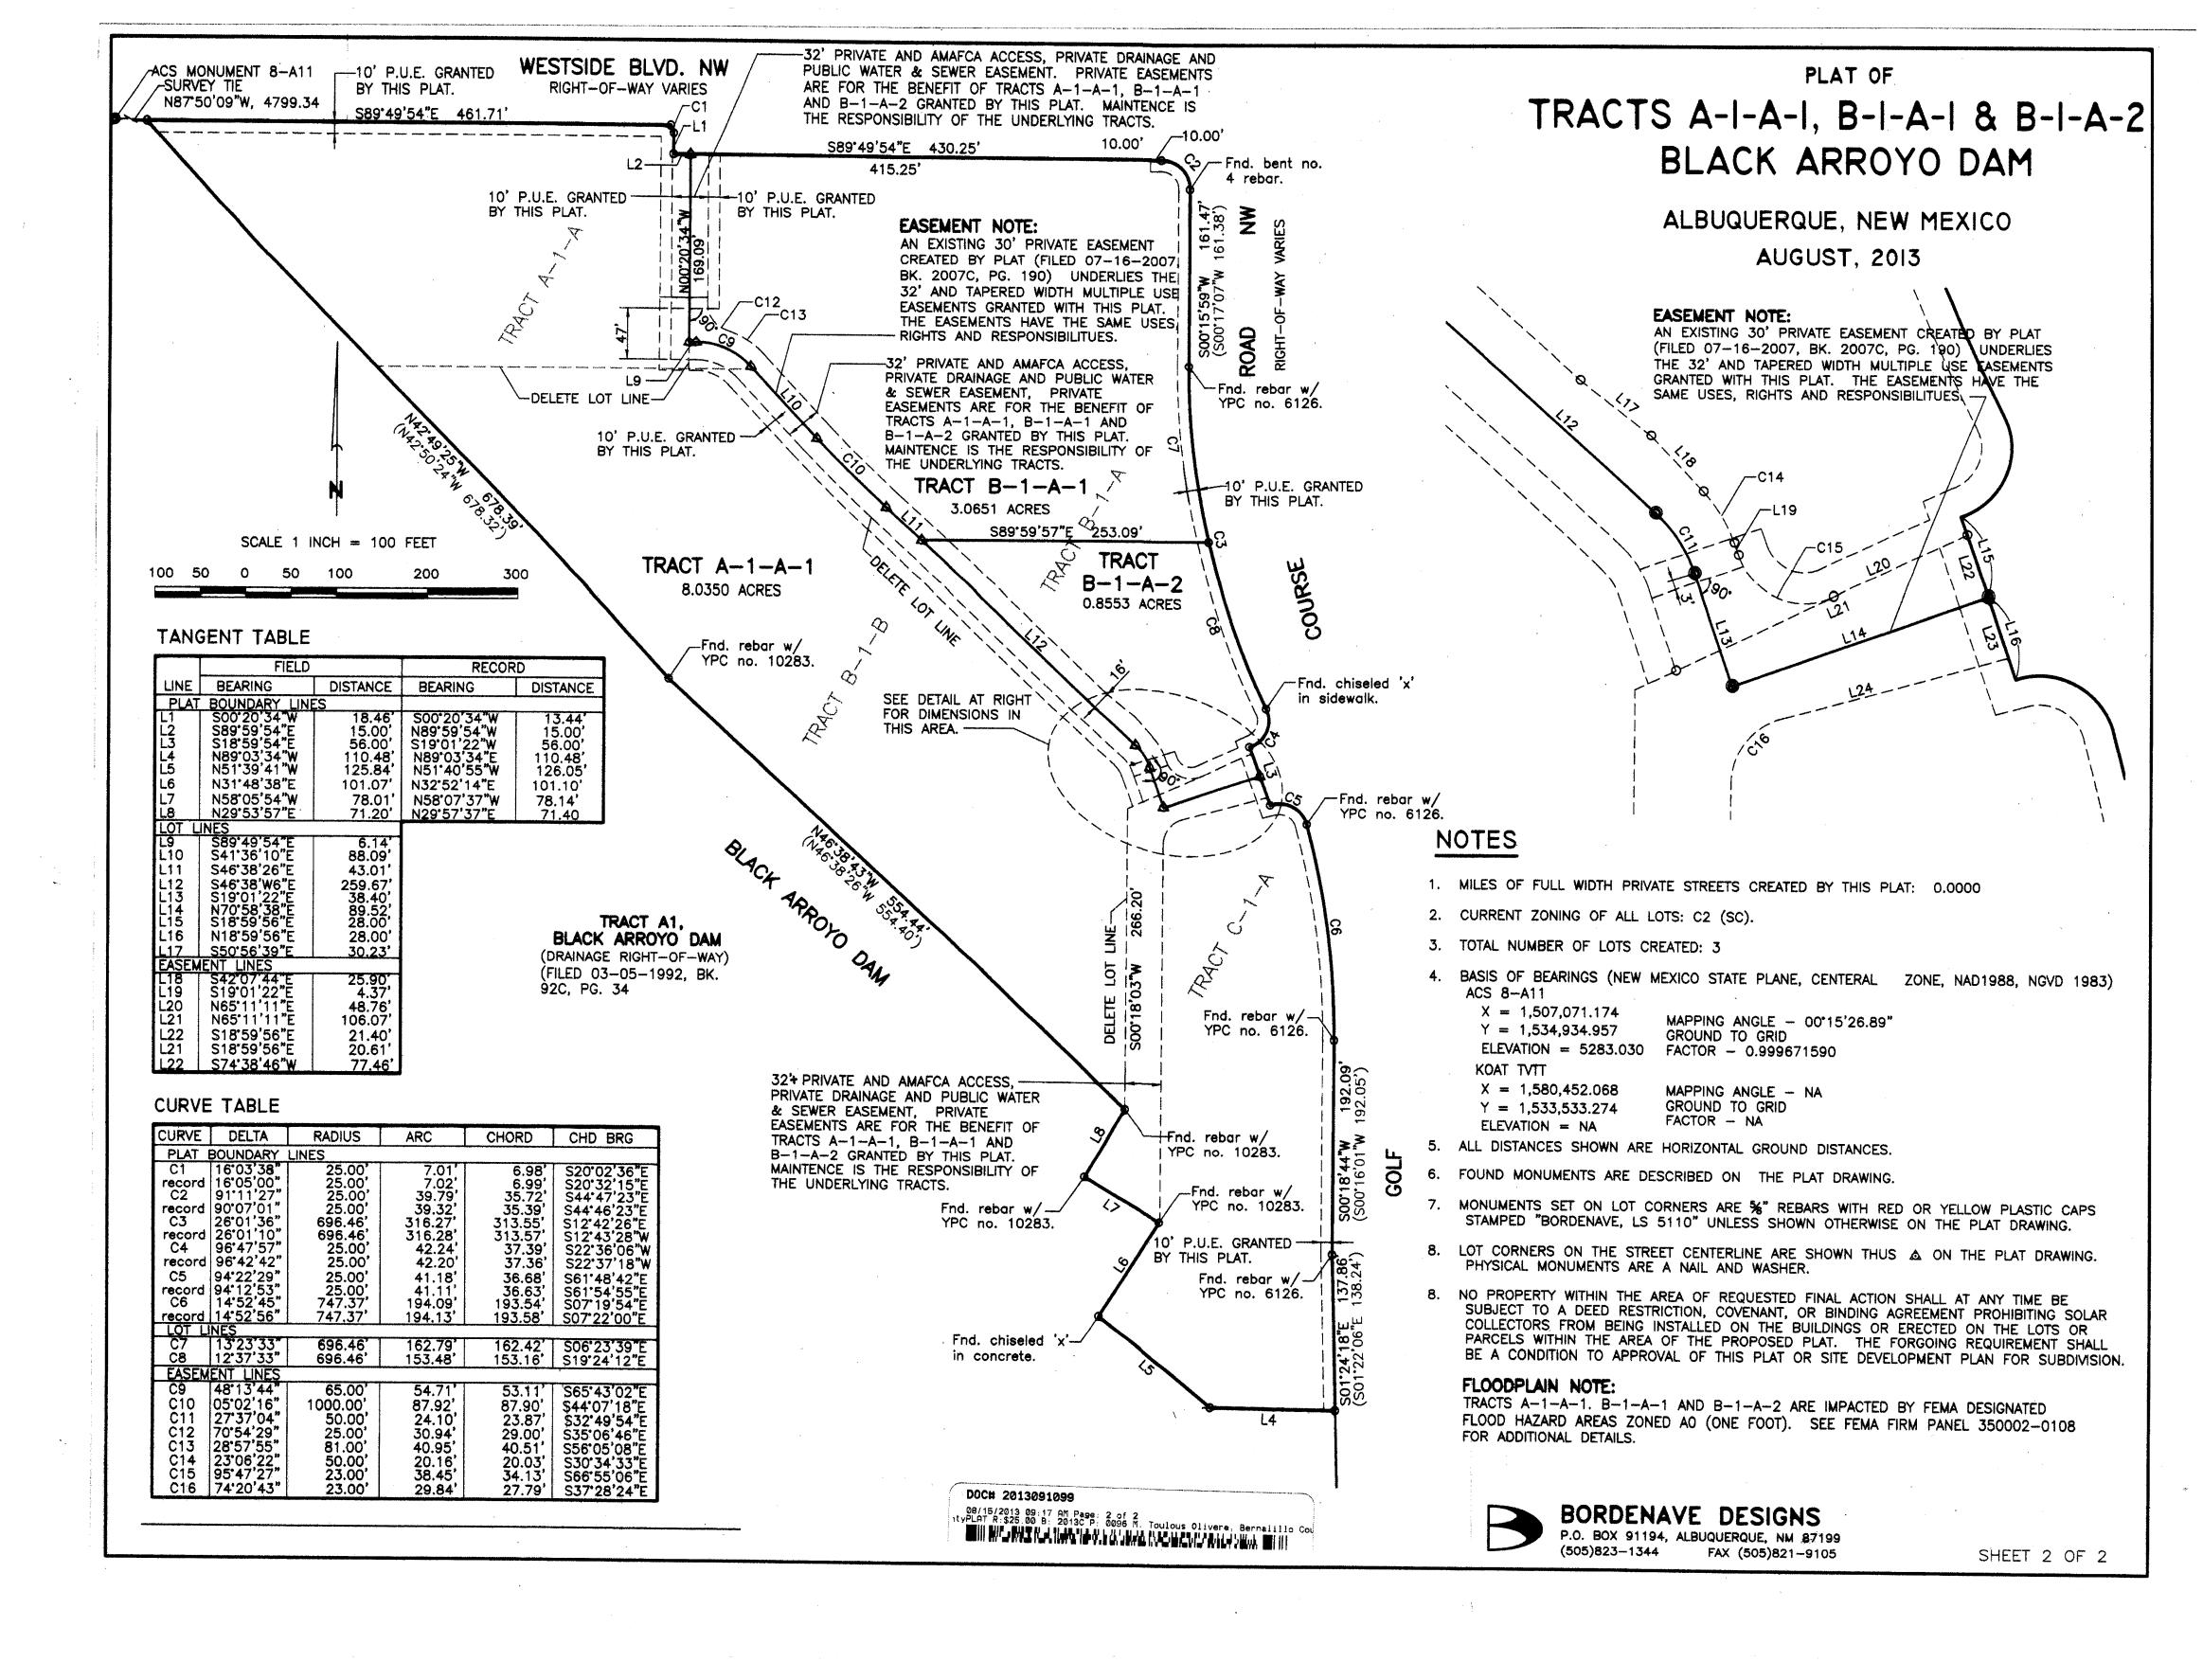

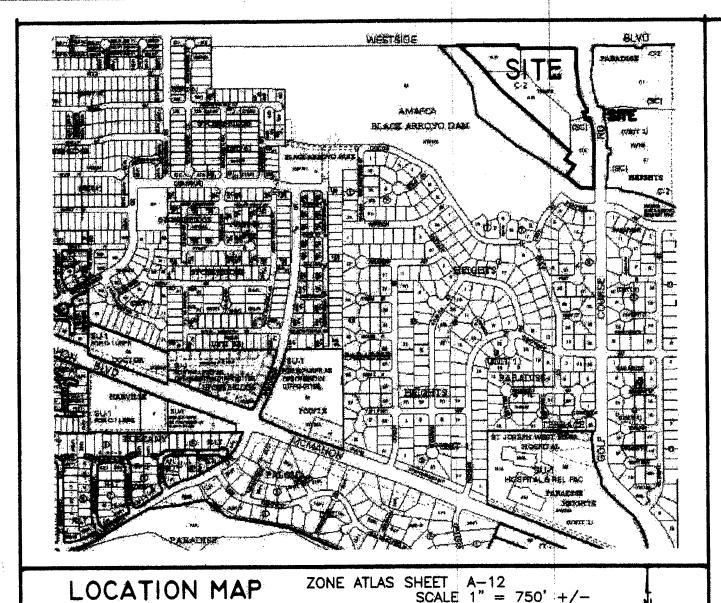

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PUBLIC UTILITY EASEMENT APPROVALS

An-	8/14/13
WEST COMMUNICATIONS /d/b/a CENTURYLII	NK DATE 8-14-13
PUBLIC SERVICE CO. OF NEW MEXICO	DATE 8//3/20/3
NEW MEXICAS CO.	7/11/23
OMCAST CABLE	DATE

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NEW MEXICO GAS COMPANY for installation, maintenance, and service of natural gas lines, valves and other equipment and facilities reasonably necessary to provide natural gas services.

QWEST for the installation, maintenance, and service of such lines, cable and other related equipment and facilities reasonably necessary to provide communication services. CABLE TV for the installation, maintenance, and service of such lines, cable an other related equipment and facilities reasonably necessary to profide Cable services.

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SURVEYOR'S CERTIFICATION

I, JEAN J. BORDENAVE, A REGISTERED PROFESSIONAL ENGINEER AND LAND SURVEYOR UNDER THE LAWS OF THE STATE OF NEW MEXICO, DO HEREBY CERTIFY THAT THIS PLAT WAS PREPARED BY ME OR UNDER MY SUPERVISION: MEETS THE MINIMUM REQUIREMENTS OF MONUMENTATION AND SURVEYS OF THE ALBUQUERQUE SUBDIVISION ORDINANCE; SHOWS EASEMENTS OF RECORD AND/OR INDICATED IN TITLE COMMITMENT NO. FT000120470, DATED FEBRUARY 19, 2007, ISSUED BY FIDELITY NATIONAL TITLE CO. AND OR MADE KNOWN TO ME BY THE OWNERS: AND THAT IT IS TRUE AND CORRECT TO THE BEST OF MY KNOWLEDGE AND BELIEF.

JEAN J. BORDENAVE, NMPE&LS NO. \$110

DOC# 2013091099

08/15/2013 09:17 AM Page: 1 of 2 htyPLAT R:\$25.00 B: 2013C P: 0096 M. Toulous Olivera, Bernalillo Cov

PLAT OF

TRACTS A-I-A-I, B-I-A-I & B-I-A-2 BLACK ARROYO DAM

ALBUQUERQUE, NEW MEXICO AUGUST, 2013

APPROVALS

PROJECT NO: 1004976 APPLICATION NO:13DRB-70650 8-14-13 OF ALBUQUERQUE SUI Carol S. Dumont DATE ALBUQUERQUE SURVEYOR 8-14-13 PARKS AND RECREATION DEPARTMENT DATE Lyn M. mayer 8-14-13 DATE AMAFCA 8-14-13 CITY ENGINEER, 00/14/13 DATE 08-14-13 DATE TRAFFIZ ENGINEERING, TRANSPORTATION DIVISION 8-14-13 DRB CHAIRPERSON, PLANNING DEPARTMENT DATE

DISCLOSURE STATEMENT

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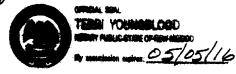
CALABACILLAS GROUP, A NEW MEXICO GENERAL PARTNERSHIP

DONALD, D. HARVILLE, GENERAL PARTNER

STATE OF NEW MEXICO) SS COUNTY OF BERNALILLO) STATE OF NEW MEXICO) STATE OF NEW MEXIC DONALD D. HARVILLE

08 //3 / /3 BY GENERAL PARTNER.

NOTARY PUBLIC:







BORDENAVE DESIGNS

P.O. BOX 91194, ALBUQUERQUE, NM 87199 (505)823-1344 FAX (505)821-9105

SHEET 1 OF 2

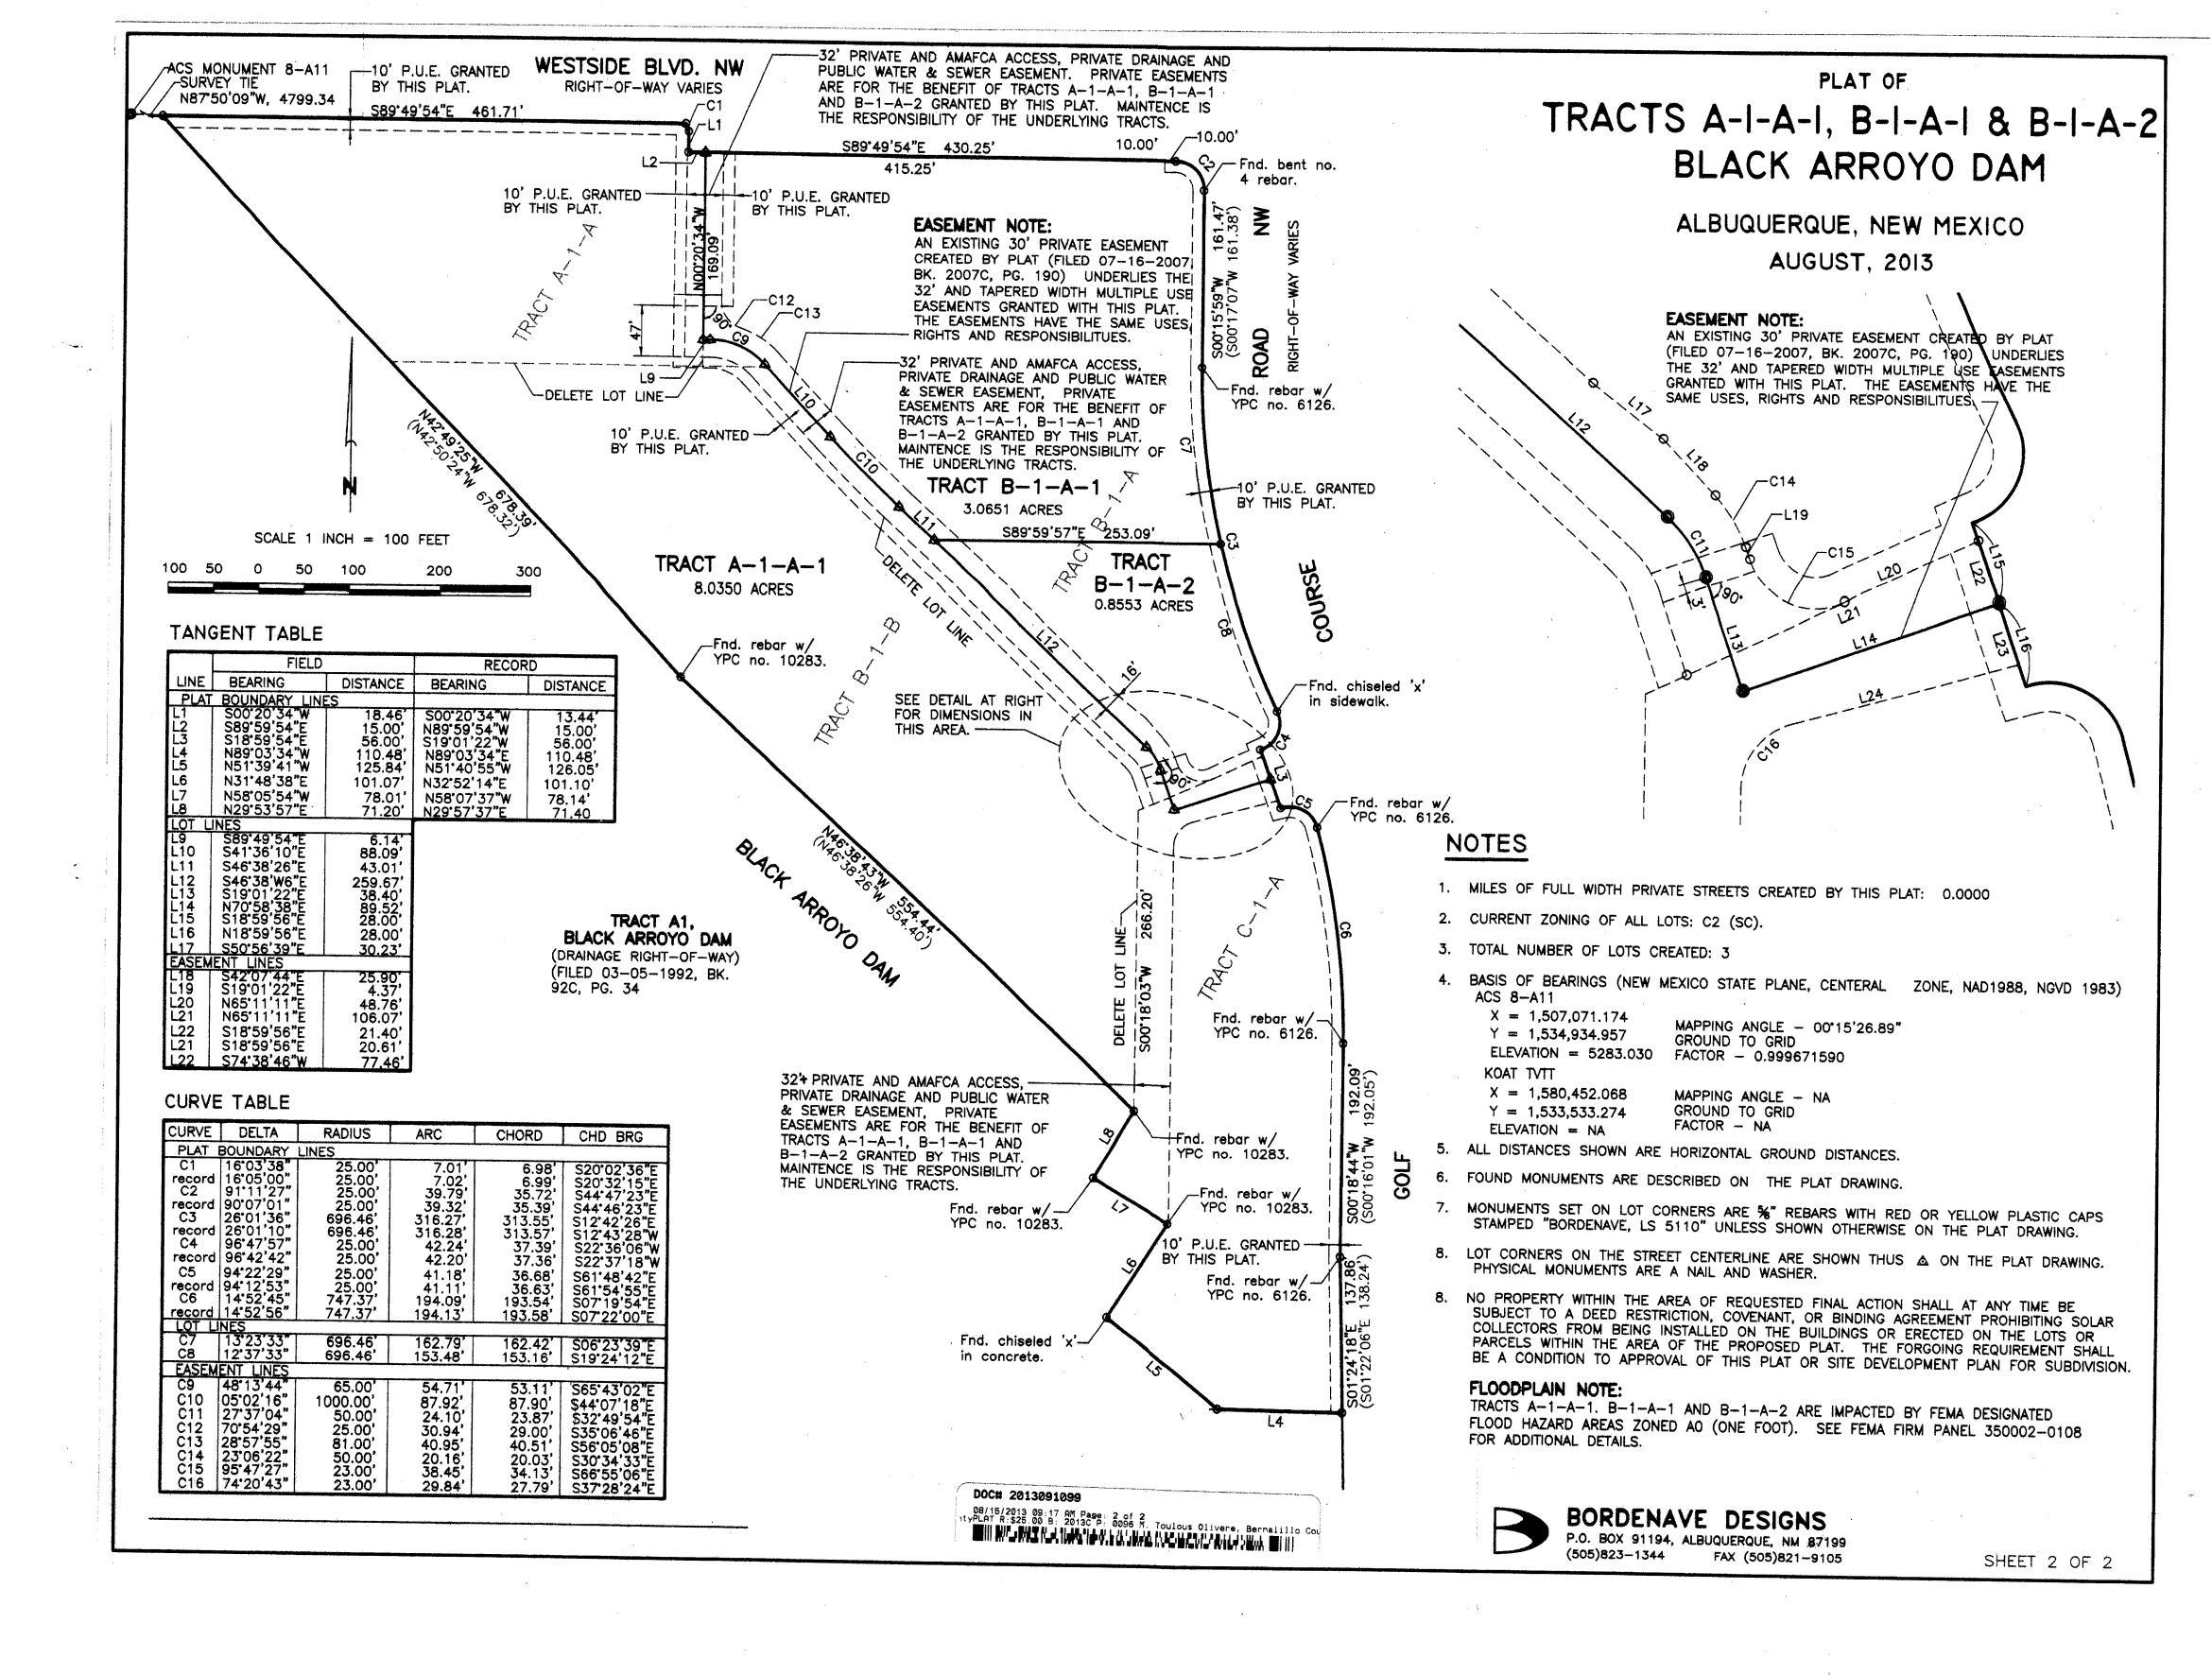

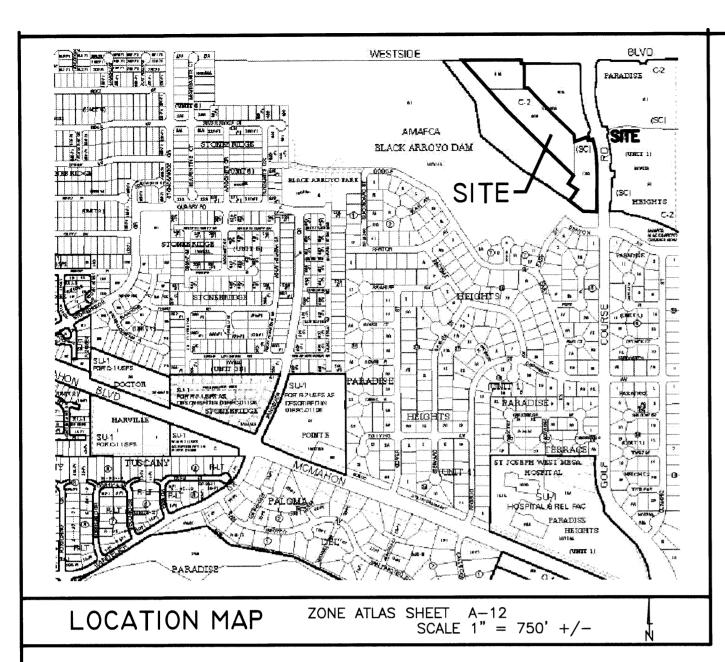

THIS IS TO CERTIFY THAT TAXES ARE CURRENT AND PAID ON UPC#_______PROPERTY OWNER OF RECORD:

BERNALILLO COUNTY TREASURER'S OFFICE:

PUBLIC UTILITY EASEMENT APPROVALS

QWEST COMMUNICATIONS /d/b/a CENTURYLINK	DATE
PUBLIC SERVICE CO. OF NEW MEXICO	DATE
NEW MEXICO GAS CO.	DATE
COMCAST CABLE	DATE

PUBLIC UTILITY EASEMENTS shown on this plat are grated for the common and joint use of: PUBLIC SERVICE COMPANY OF NEW MEXICO ((PNM), a New Mexico corporation, (PNM Electric) for installation, maintenance, and service of overhead and underground electrical lines, transformers, and other equipment and related facilities reasonably necessary to provide electrical services

NEW MEXICO GAS COMPANY for installation, maintenance, and service of natural gas lines, valves and other equipment and facilities reasonably necessary to provide natural gas services.

QWEST for the installation, maintenance, and service of such lines, cable and other related equipment and facilities reasonably necessary to provide communication services. CABLE TV for the installation, maintenance, and service of such lines, cable an other

related equipment and facilities reasonably necessary to profide Cable services. Included is the right to build, rebuild, construct, reconstruct, locate, relocate, change, remove, replace, modify, renew, operate and maintain facilities for purposes described above together with free access to, from, and over said easements, with the right and privilege of going upon, over and across adjoining lands of Grantor for the purposes set forth herein and with the right to utilize the right of way and easement to extend services to customers of Grantee, including sufficient working area space for electric transformers, with the right and privilege to trim and remove trees, shrubs or bushes which interfere with purposes set forth herein. No building, sign, pool (aboveground or subsurface), hot tub, concrete or wood pool decking, or other structure shall be erected or constructed on said easements, nor shall any well be drilled or operated thereon. Property owners shall be solely responsible for correcting any violations of National Electrical Safety Code by construction of pools, decking, or any structures adjacent to or near easements shown on this plat.

Easements for electric transformer/switchgears, as installed, shall extend ten (10) feet in front of the transformer/swithchgear doors and five (5) feet on each side.

Disclaimer

In approving this plat, Public Service Company of New Mexico (PNM) and New Mexico Gas Company (NMGC) did not conduct a Title Search of the properties shown hereon. Consequently, PNM and NMGC do not waive or release andy easement or easement rights which may have been granted by prior plat, replat or other document and which are not shown on this plat.

LEGAL DESCRIPTION

A PARCEL OF LAND SITUATED IN PROJECTED SECTION 1, T11N, R2E, N.M.P.M., TOWN OF ALAMEDA GRANT, CITY OF ALBUQUERQUE, BERNALILLO COUNTY, NEW MEXICO; SAID PARCEL BEING THE SAME AS TRACT A-1-A-1 OF BLACK ARROYO DAM, FILED IN THE OFFICE OF THE COUNTY CLERK OF BERNALILLO COUNTY, NEW MEXICO ON AUGUST 15, 2013 IN BK. 2013C. PG. 96 AND MORE PARTICULARLY DESCRIBED USING NEW MEXICO STATE PLANE BEARINGS (CENTRAL ZONE) AND HORIZONTAL GROUND DISTANCES AS FOLLOWS:

BEGINNING AT THE NORTHWEST CORNER OF THE PARCEL HEREIN DESCRIBED, FROM WHENCE THE MONUMENT ACS 1-E11 BEARS N87'50'09"W A DISTANCE OF 4799.34 FEET: THENCE.

S89'49'54"E, 461.71 feet along the south right—of—way of Westside Blvd. NW to a point; thence,

Southeasterly, 7.01 feet along the arc of a curve right, said curve having a radius of 25.00 feet and a long chord bearing S20°02'36"E a distance of 6.98 feet: thence.

S00°20'34"W, 18.46 feet to a point; thence,

S89'49'54"E, 15.00 feet to a point; thence departing from the south right—of—way of Westside Blvd. NW,

S00°20'34"E, 169.09 feet to a point; thence,

S89°59'54"E, 6.14 feet to a point; thence

Southeasterly, 54.71 feet along the arc of a curve right, said curve having a radius of 65.00 feet and a long chord bearing S65*43'02"E a distance of 53.11 feet; thence.

S41°36'10"E. 88.09 feet to a point; thence

Southeasterly, 87.92 feet along the arc of a curve left, said curve having a radius of 1000.00 feet and a long chord bearing S44°07'18"E a distance of 87.90 feet; thence.

S46°28'36"E, 302.67 feet to a point; thence

Southeasterly, 24.10 feet along the arc of a curve right, said curve having a radius of 50.00 feet and a long chord bearing S32*49'54"E a distance of 23.87 feet; thence,

S19°01'22"E, 38.40 feet to a point; thence,

N70°58'38"E, 89.50 feet to a point, said point being on the westerly right—of—way of Golf Course Rd. NW; thence,

S18*59'56"E, 26.62 feet to a point; thence

N70°58'38"E, 9.53 feet to a point; thence

Southeasterly, 41.05 feet along the arc of a curve right, said curve having a radius of 25.00 feet and a long chord bearing S61*58'51"E a distance of 36.59 feet; thence,

Southeasterly, 200.90 feet along the arc of a curve right, said curve having a radius of 757.00 feet and a long chord bearing S07°20'09"E a distance of 200.31 feet; thence,

S00°16'01"W, 136.15 feet to a point; thence

S00°58'26"E, 191.73 feet to a point; thence departing from the west right—of—way of Golf Course Rd. NW,

N89°03'34"W, 120.19 feet to a point; thence

N51°39'41"W, 125.84 feet to a point; thence

N31°48'38"E, 101.07 feet to a point; thence

N58°05'54"W, 78.01 feet to a point; thence

N29°53'57"E, 71.20 feet to a point; thence

N46°38'43"W, 554.44 feet to a point; thence

N42°49'25"W, 678.39 FEET TO A POINT, SAID POINT BEING THE POINT OF BEGINNING.

SAID PARCEL CONTAINS 8.2836 ACRES MORE OF LESS.

DISCLOSURE STATEMENT

THE PURPOSE OF THIS PLAT IS TO: VACATE PUBLIC RIGHT-OF-WAY ON GOLF COURSE ROAD, DEDICATE RIGHT-OF-WAY ON WESTSIDE BLVD., VACATE A 10' P.U.E. AND GRANT A NEW 10' P.U.E. ALONG THE PROPOSED GOLF COURSE ROAD VACATION AND DELETE THE FLOODPLAIN NOTE OF THE PRECEDING PLAT.

PLAT OF

TRACT A-I-A-I-A BLACK ARROYO DAM

ALBUQUERQUE, NEW MEXICO APRIL, 2014

<u>APPROVALS</u>	
PROJECT NO: 1004976 APPLICATION NO:	
The second secon	
CITY OF ALBUQUERQUE SURVEYOR	DATE
PARKS AND RECREATION DEPARTMENT	DATE
AMAFCA	DATE
CITY ENGINEER	DATE
ABCWUA	DATE
TRAFFIC ENGINEERING, TRANSPORTATION DIVISION	DATE
DRB CHAIRPERSON, PLANNING DEPARTMENT	DATE

SURVEYOR'S CERTIFICATION

I, JEAN J. BORDENAVE, A REGISTERED PROFESSIONAL ENGINEER AND LAND SURVEYOR UNDER THE LAWS OF THE STATE OF NEW MEXICO, DO HEREBY CERTIFY THAT THIS PLAT WAS PREPARED BY ME OR UNDER MY SUPERVISION:
MEETS THE MINIMUM REQUIREMENTS OF MONUMENTATION AND SURVEYS OF THE ALBUQUERQUE SUBDIVISION ORDINANCE; SHOWS EASEMENTS OF RECORD AND/OR INDICATED IN TITLE COMMITMENT NO. FT000120470, DATED FEBRUARY 19, 2007, ISSUED BY FIDELITY NATIONAL TITLE CO. AND OR MADE KNOWN TO ME BY THE OWNERS; AND THAT IT IS TRUE AND CORRECT TO THE BEST OF MY KNOWLEDGE AND BELIEF.

JEAN J. BORDENAVE, NMPE&LS NO. 5110

FREE CONSENT AND DEDICATION

THE SUBDIVISION OF THE LAND DESCRIBED ON THIS PLAT IS WITH THE FREE CONSENT OF AND IN ACCORDANCE WITH THE DESIRE OF THE UNDERSIGNED OWNERS OF THE LAND. THE OWNERS DO HEREBY:

WARRANT THAT THEY HOLD AMONG THEM COMPLETE AND INDEFEASIBLE TITLE TO THE LAND SUBDIVIDED,

GRANT SPECIFIC SURFACE AND SUBSURFACE POWER, GAS, WATER, SEWER AND COMMUNICATION EASEMENTS AS DELINEATED ON THIS PLAT;

ACKNOWLEDGE EXISTING EASEMENTS AS SHOWN ON THIS PLAT;

STATE THAT THIS SUBDIVISION LIES WITHIN THE SUBDIVISION REGULATION JURISDICTION OF THE CITY OF ALBUQUERQUE, NEW MEXICO.


IN ADDITION THE OWNER OF TRACTS D AND E DOES HEREBY DEDICATE PUBLIC RIGHTS-OF-WAY, SHOWN HEREON, IN FEE SIMPLE WITH WARRANTY COVENANTS TO THE CITY OF ALBUQUERQUE.

CALABACILLAS GROUP, A NEW MEXICO GENERAL PARTNERSHIP

DONALD. D. HARVILLE, GENERAL PARTNER	
STATE OF NEW MEXICO) SS COUNTY OF BERNALILLO) THIS INSTRUMENT WAS ACKNOWLEDGED BEFORE ME ON/	_BY
NOTARY PUBLIC:	




SHEET 1 OF 2

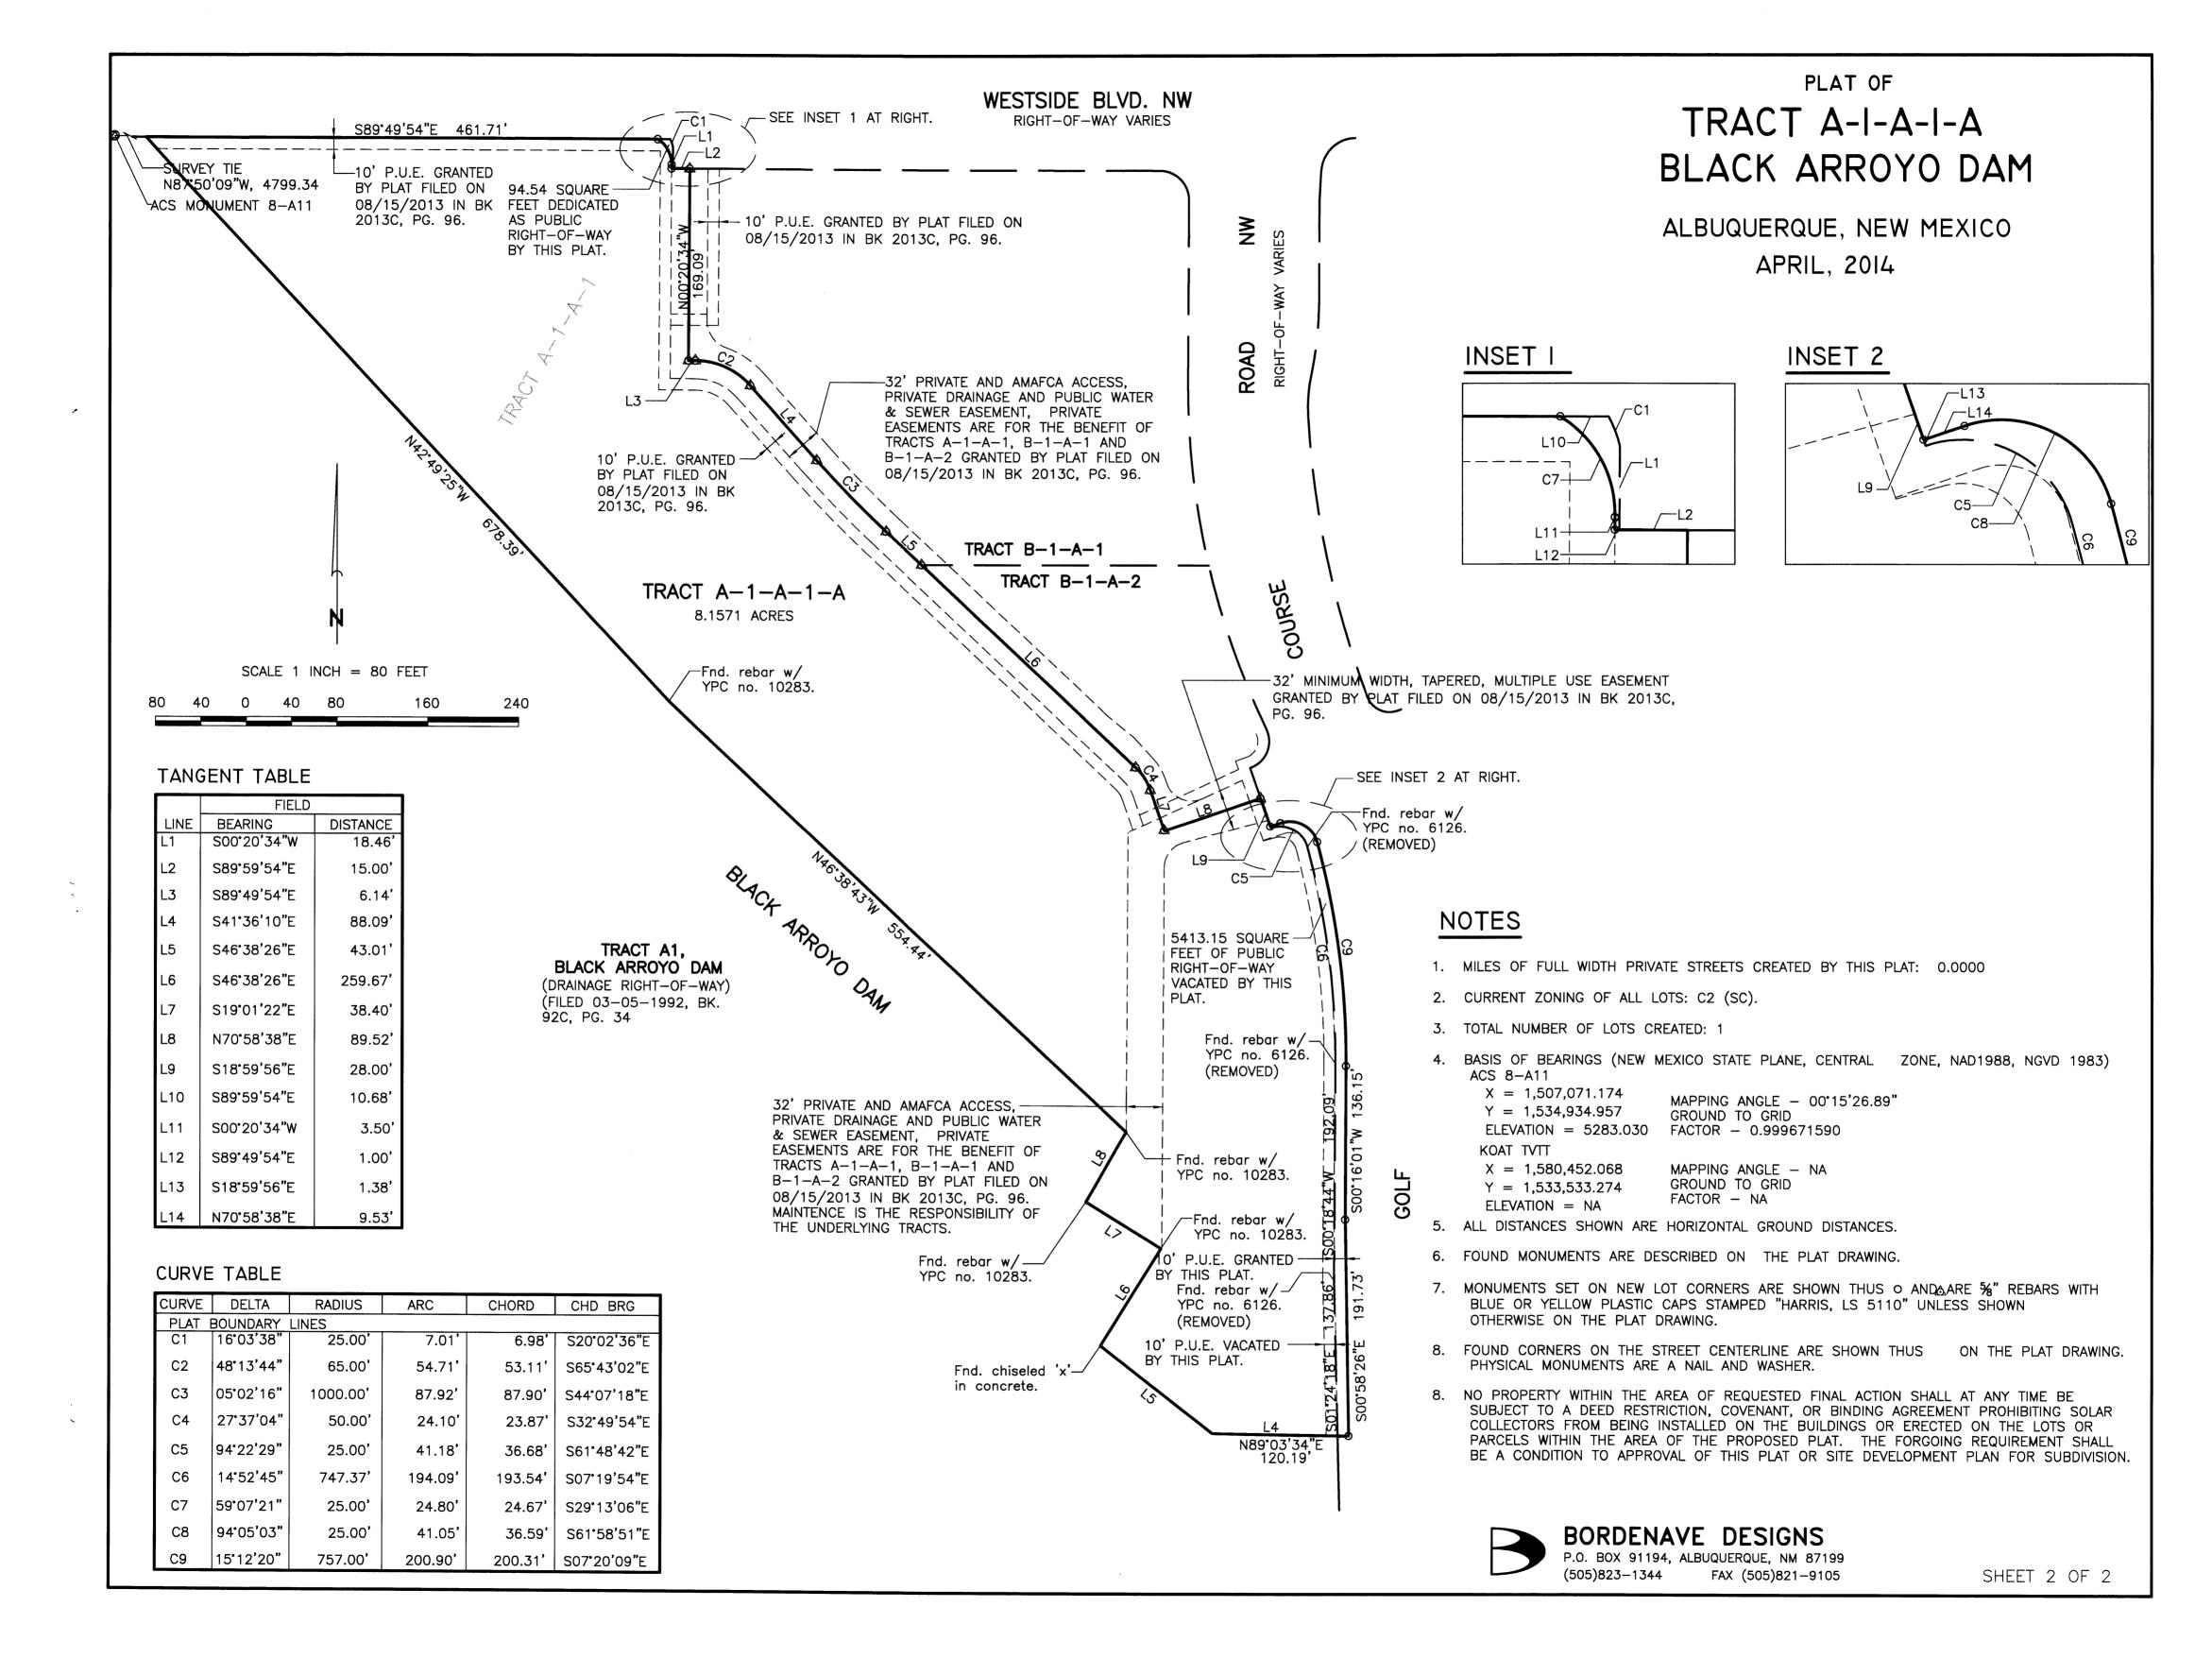

EXISTING INFRASTRUCTURE

TRACT A-I-A-I BLACK ARROYO DAM


ALBUQUERQUE, NEW MEXICO APRIL, 2014

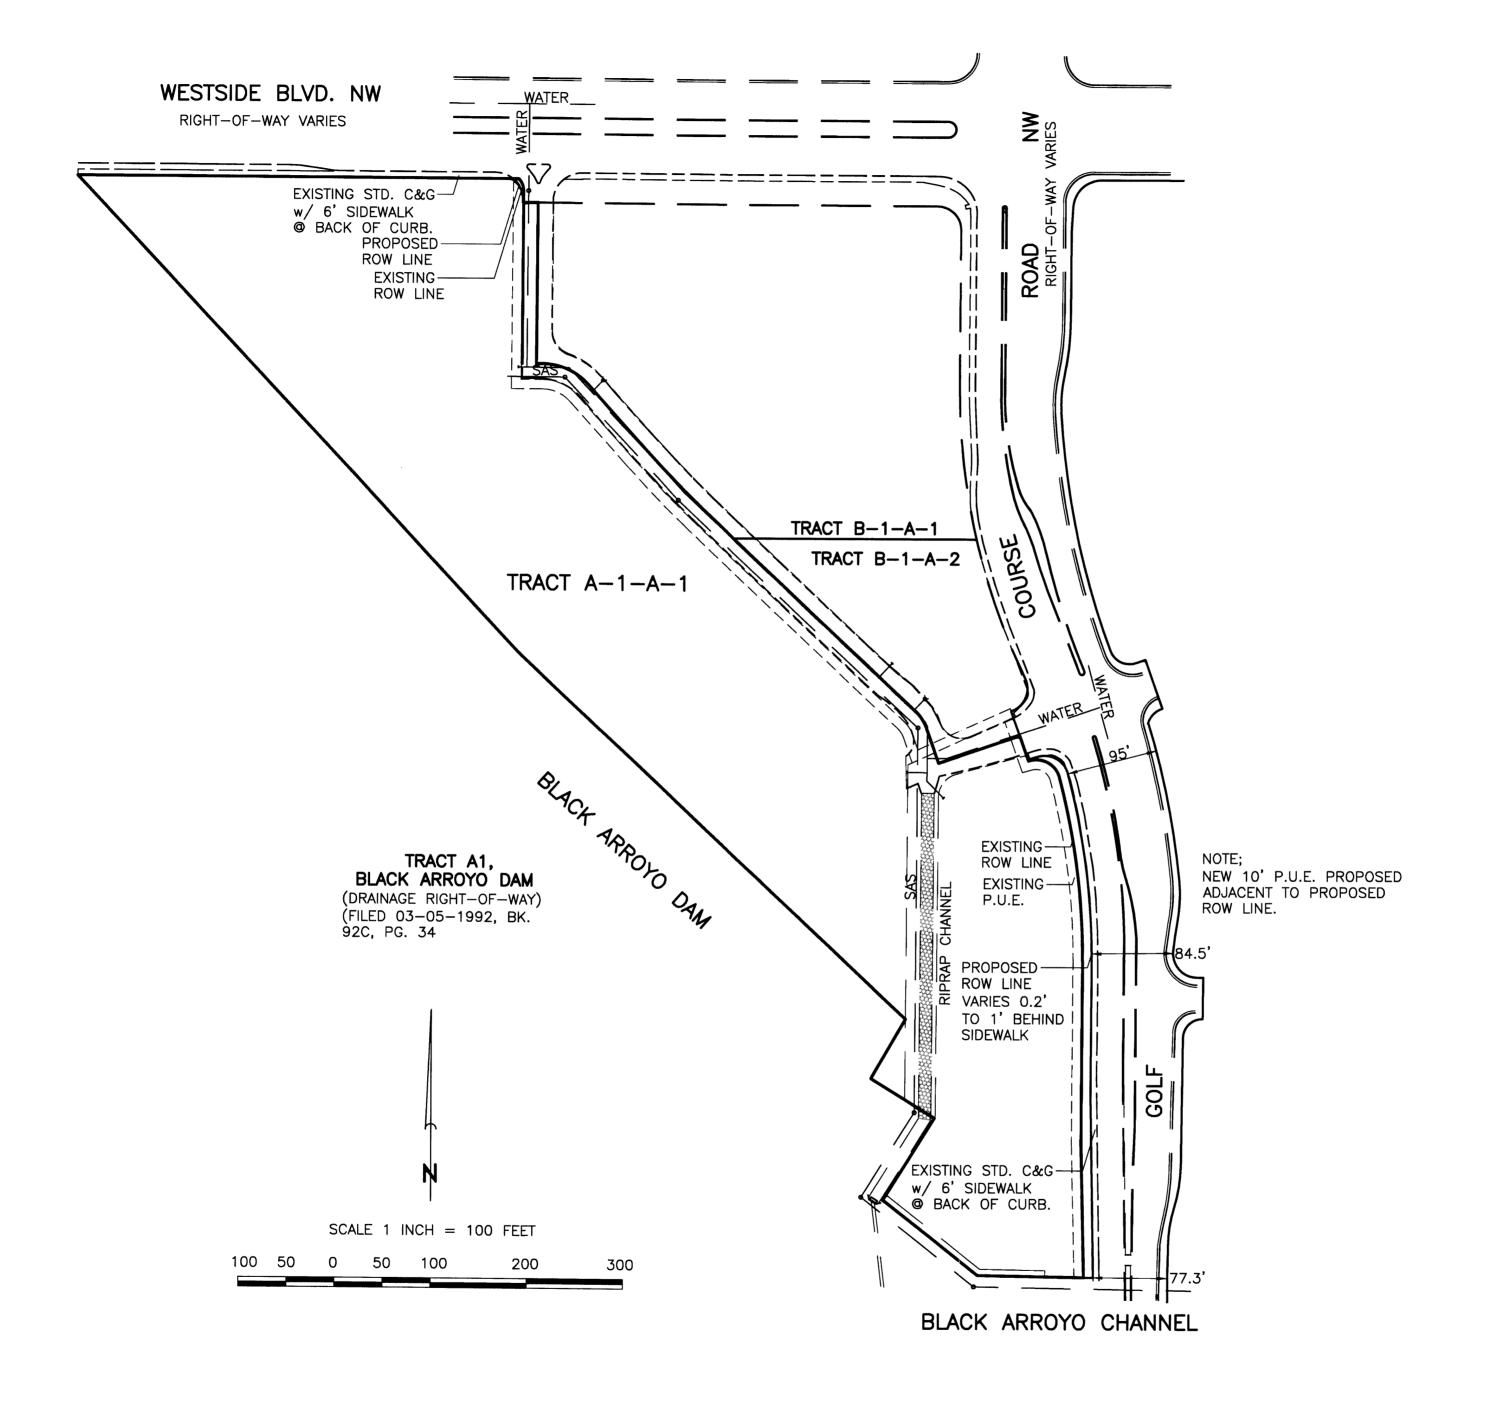

EXISTING INFRASTRUCTURE

TRACT A-I-A-I BLACK ARROYO DAM

ALBUQUERQUE, NEW MEXICO APRIL, 2014

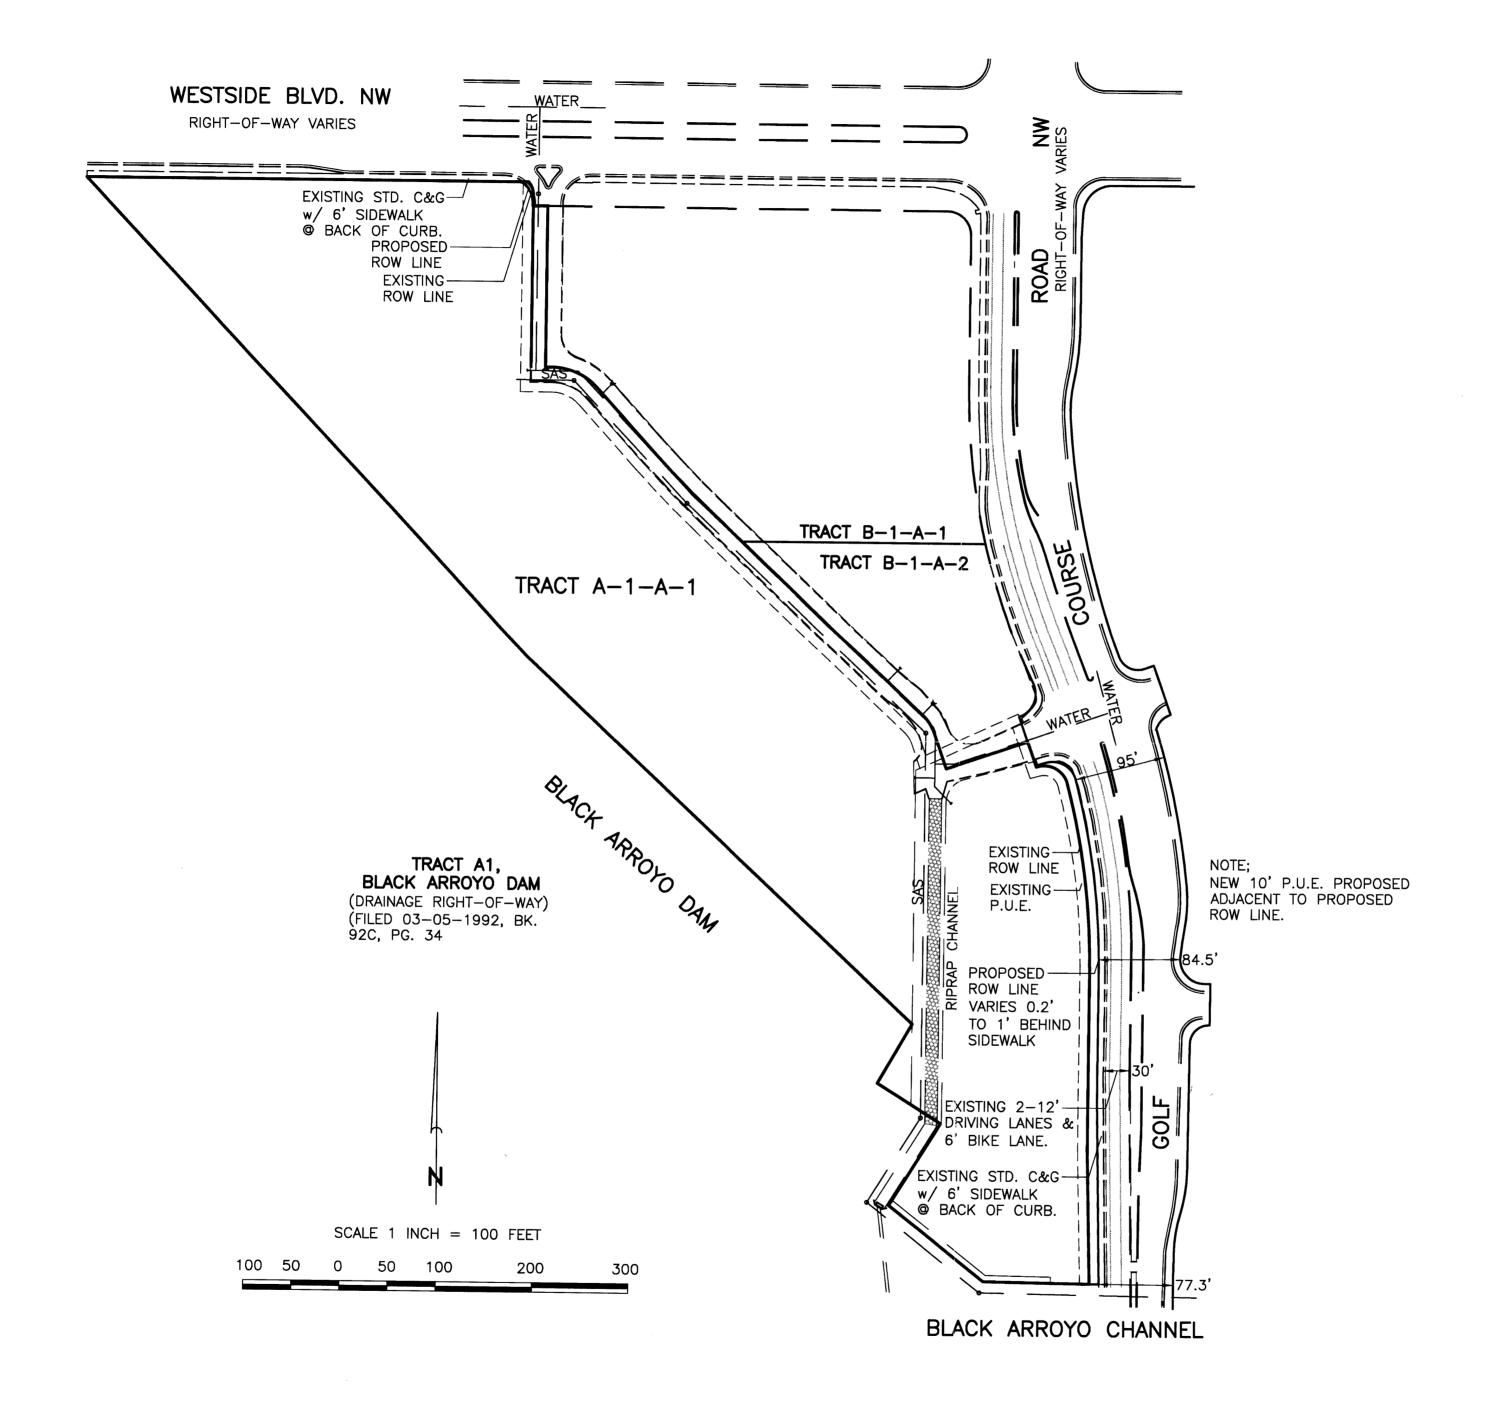

WESTSIDE BLVD. NW NW VARIES RIGHT-OF-WAY VARIÉS EXISTING STD. C&G— w/ 6' SIDEWALK BACK OF CURB. PROPOSED— ROW LINE EXISTING — ROW LINE TRACT B-1-A-1 TRACT B-1-A-2 TRACT A-1-A-1 EXISTING — ROW LINE TRACT A1, BLACK ARROYO DAM (DRAINAGE RIGHT-OF-WAY) (FILED 03-05-1992, BK. 92C, PG. 34 NEW 10' P.U.E. PROPOSED ADJACENT TO PROPOSED ROW LINE. EXISTING-P.U.E. PROPOSED— ROW LINE VARIES 0.2' TO 1' BEHIND SIDEWALK EXISTING 2-12'-DRIVING LANES & 6' BIKE LANE. EXISTING STD. C&G-w/ 6' SIDEWALK @ BACK OF CURB. SCALE 1 INCH = 100 FEET

300


BLACK ARROYO CHANNEL

100 50 0 50 100

EXISTING INFRASTRUCTURE

TRACT A-I-A-I BLACK ARROYO DAM

ALBUQUERQUE, NEW MEXICO APRIL, 2014

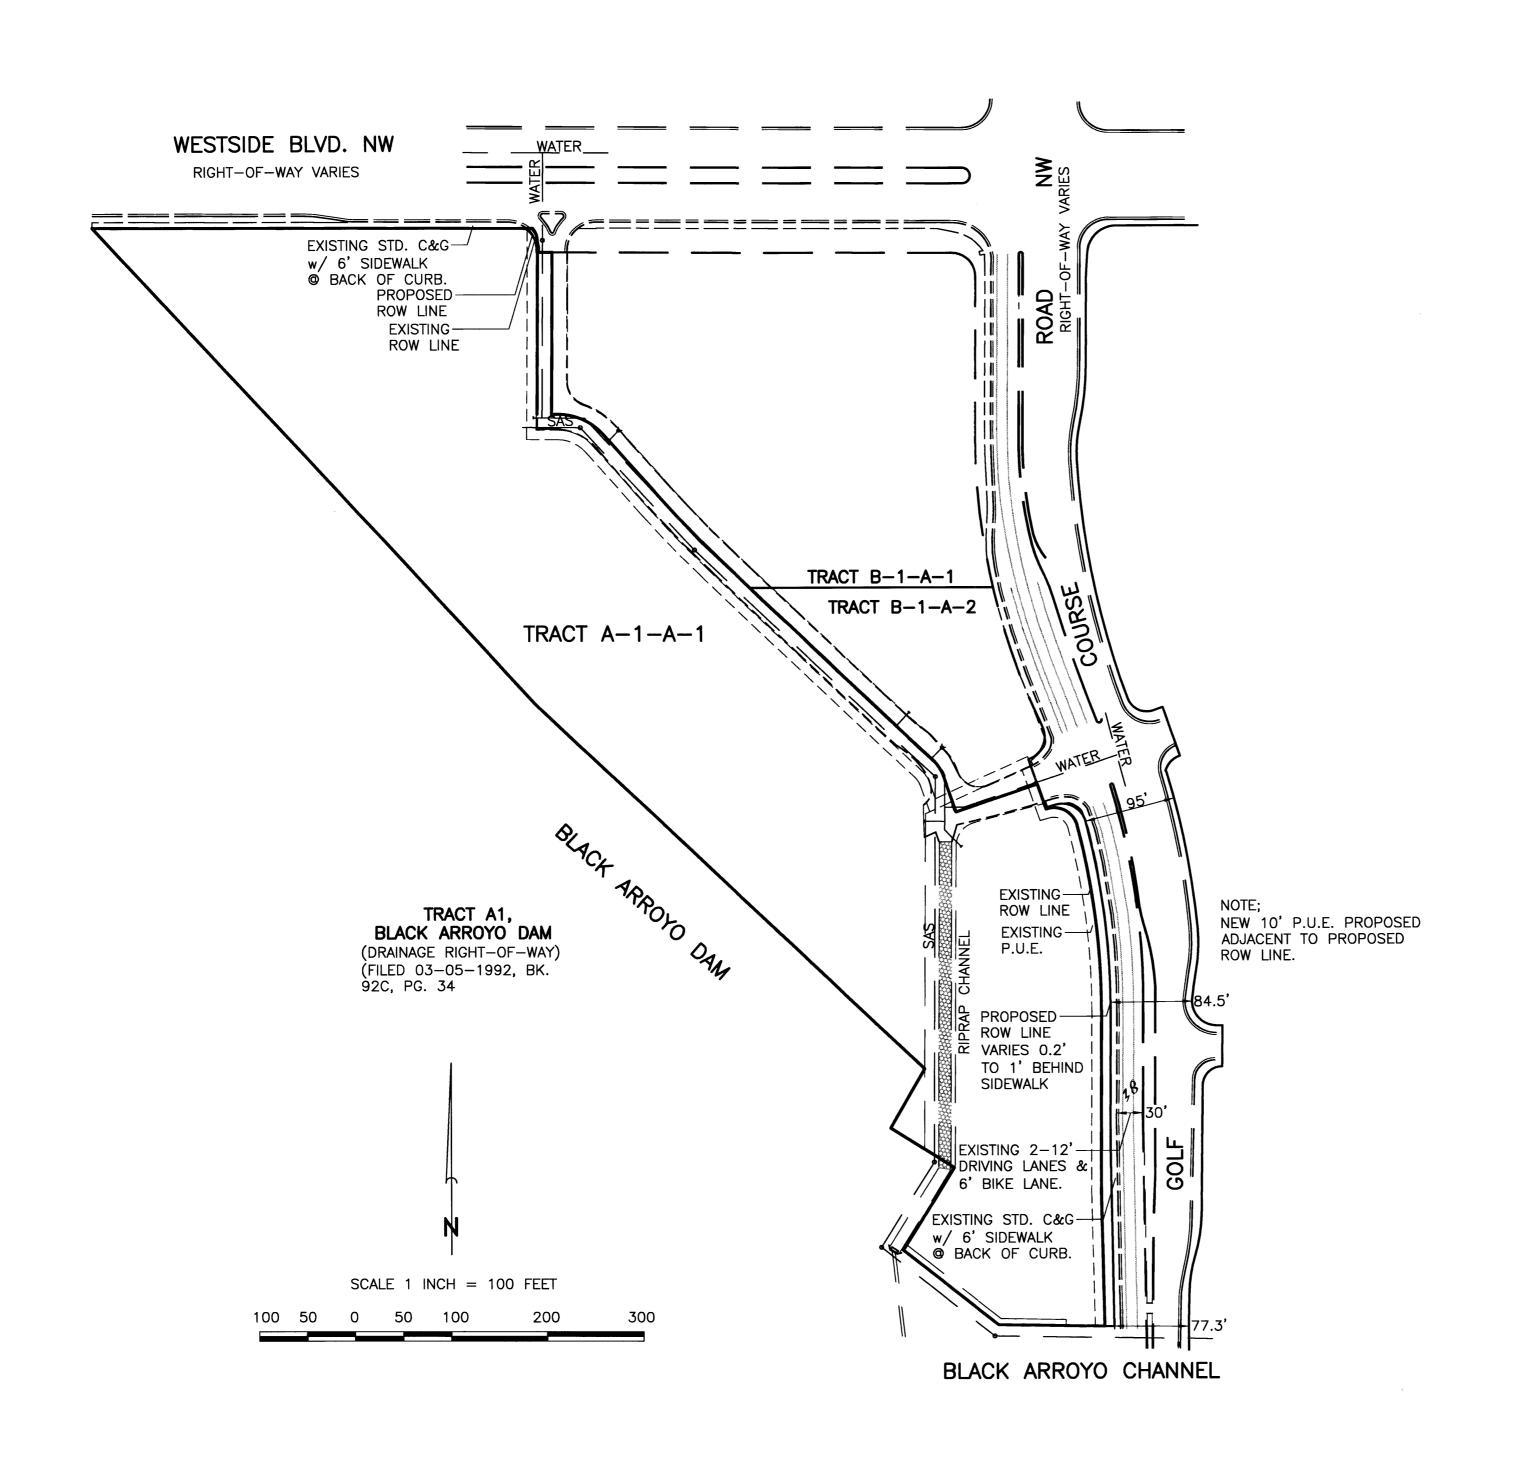


EXISTING INFRASTRUCTURE TRACT A-I-A-I BLACK ARROYO DAM


ALBUQUERQUE, NEW MEXICO **APRIL**, 2014

PROJECT #: 1004976


DATE: (0-41-14

APP#: 14-70185 (SUV)

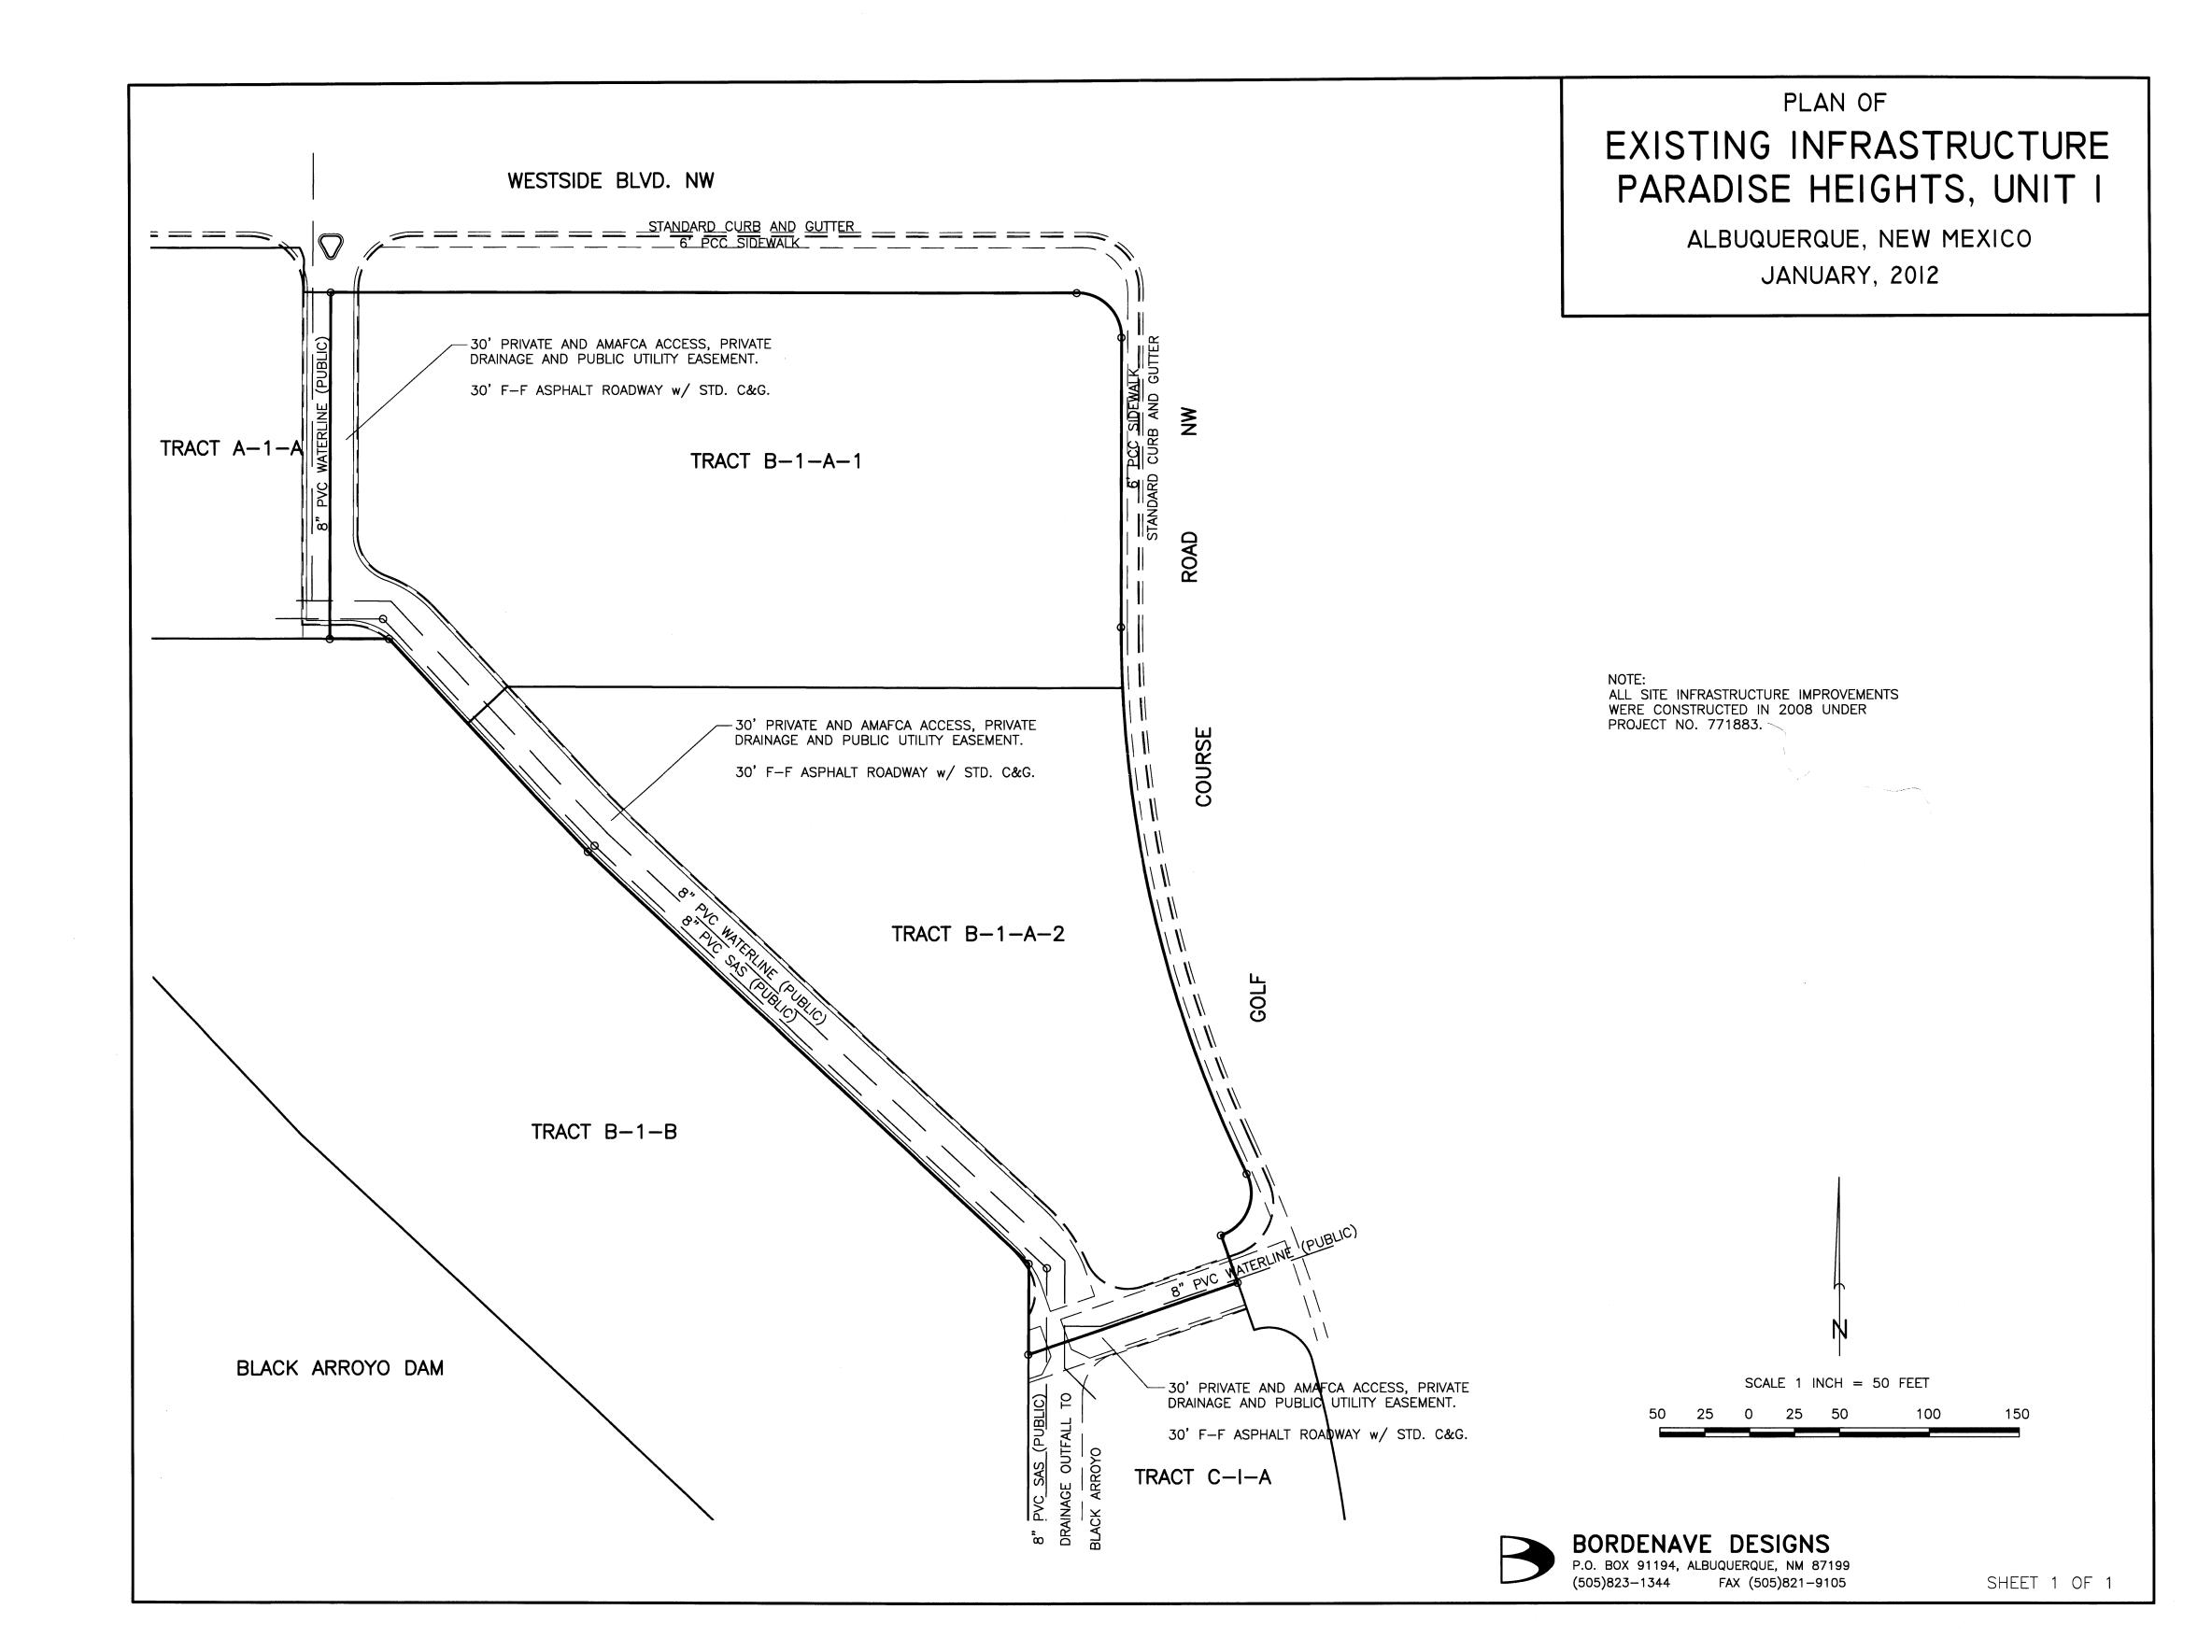

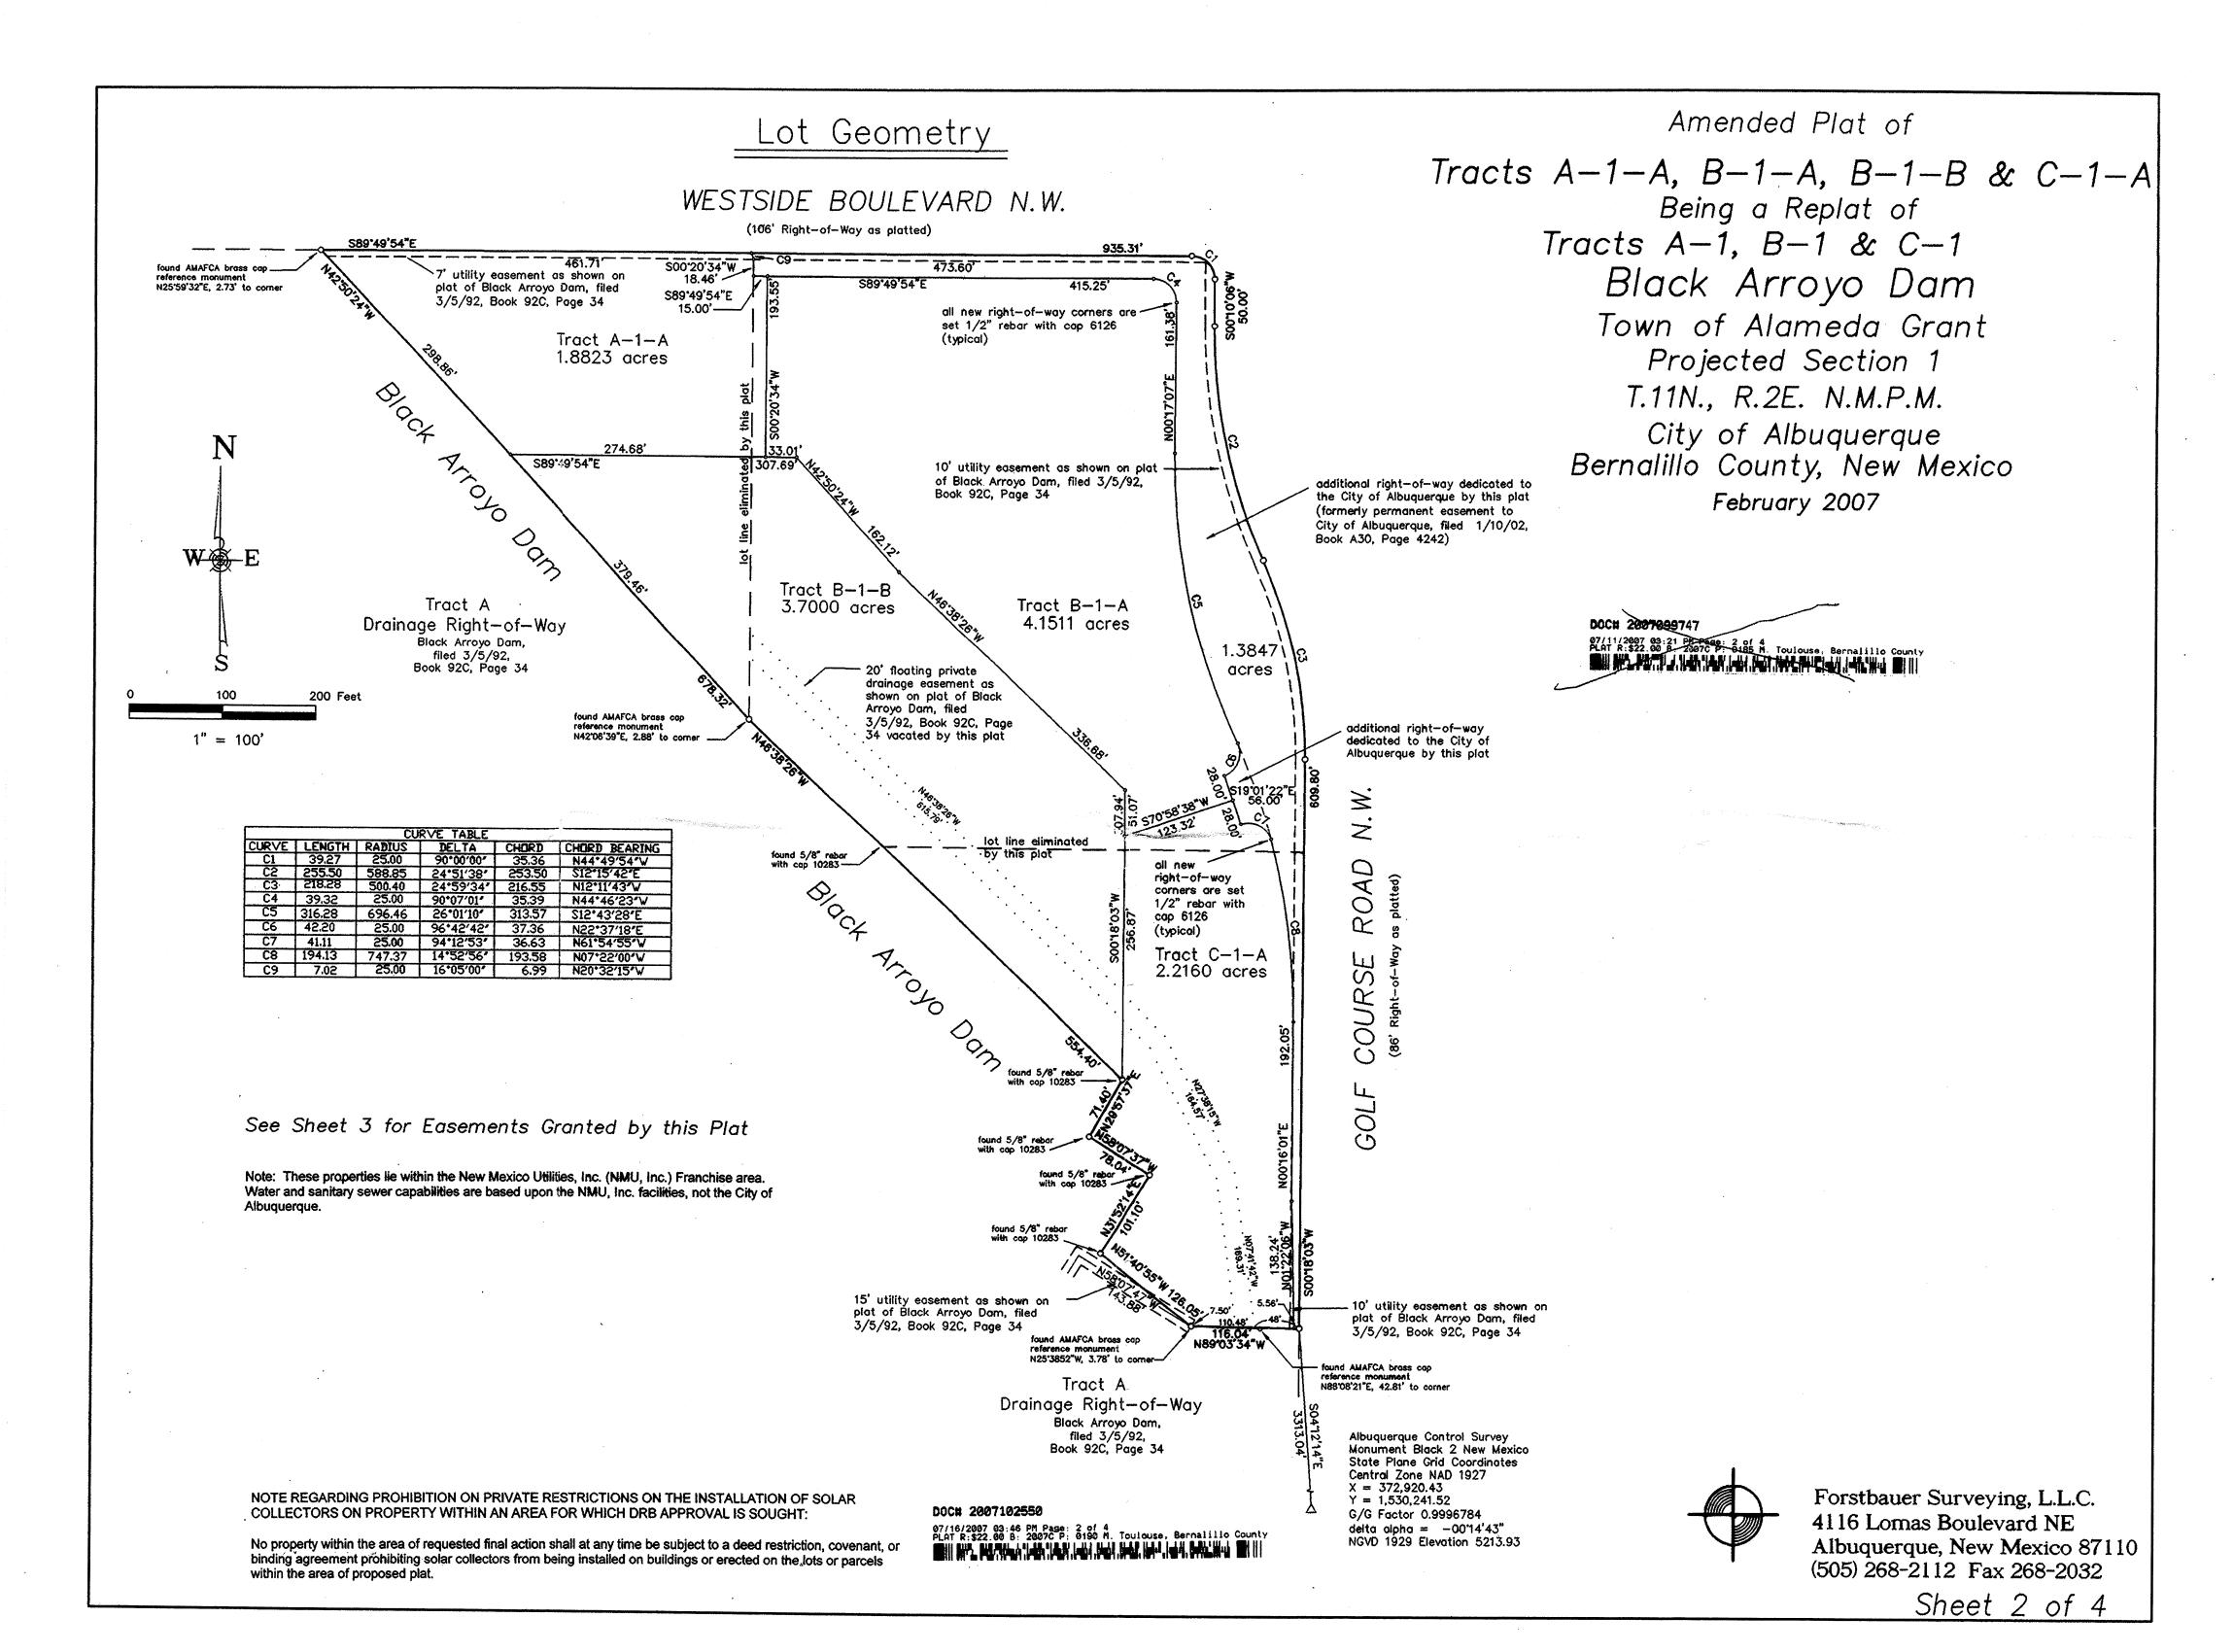

SKETCH PLAT OF TRACTS B-I-A-I & B-I-A-2 WESTSIDE BLVD. NW BLACK ARROYO DAM ALBUQUERQUE, NEW MEXICO -LENGTH = 39.27' RADIUS = 25.00' DELTA = 90'00'00" CHORD = 35.36' CHD BRG = S44'49'54"E JANUARY, 2013 S89°49'54"E 415.25' VICINITY MAP A-12 TRACT A-1-A TRACT B-1-A-1 AMAFCA BLACK ARROYO DAM 2.2035 ACRES ROAD -S47°09'36"W, 30.00' N89'49'54"W, 33.01' S89'49'54"W 342.54 30' PRIVATE AND AMAFCA ACCESS, PRIVATE DRAINAGE AND PUBLIC UTILITY EASEMENT, PRIVATE EASEMENTS ARE FOR THE BENEFIT OF TRACTS A-1-A, B-1-A,B-1-B AND C-1-A. MAINTENCE IS THE RESPONSIBILITY -LENGTH = 316.28' RADIUS = 696.46' DELTA = 26'01'10" CHORD = 313.57' CHD BRG = S12'43'28"E OF THE UNDERLYING TRACTS. PER DOCUMENT NO. 2007102550. TYPICAL. PURPOSE OF PLAT TRACT B-1-A-2 1.9477 ACRES THE PURPOSE OF THE PLAT IS TO SUBDIVIDE TRACT B-1-A INTO TWO TRACTS B-1-A-1 AND B-1-A-2. GOLF TRACT B-1-B -LENGTH = 42.20' RADIUS = 25.00' DELTA = 96'42'42" CHORD = 37.36' CHD BRG = S22'37'18"E -S19'01'22"E, 28.00' BLACK ARROYO DAM SCALE 1 INCH = 50 FEET 25 0 25 50 100 150 TRACT C-I-A BORDENAVE DESIGNS P.O. BOX 91194, ALBUQUERQUE, NM 87199 (505)823-1344 FAX (505)821-9105 SHEET 1 OF 1

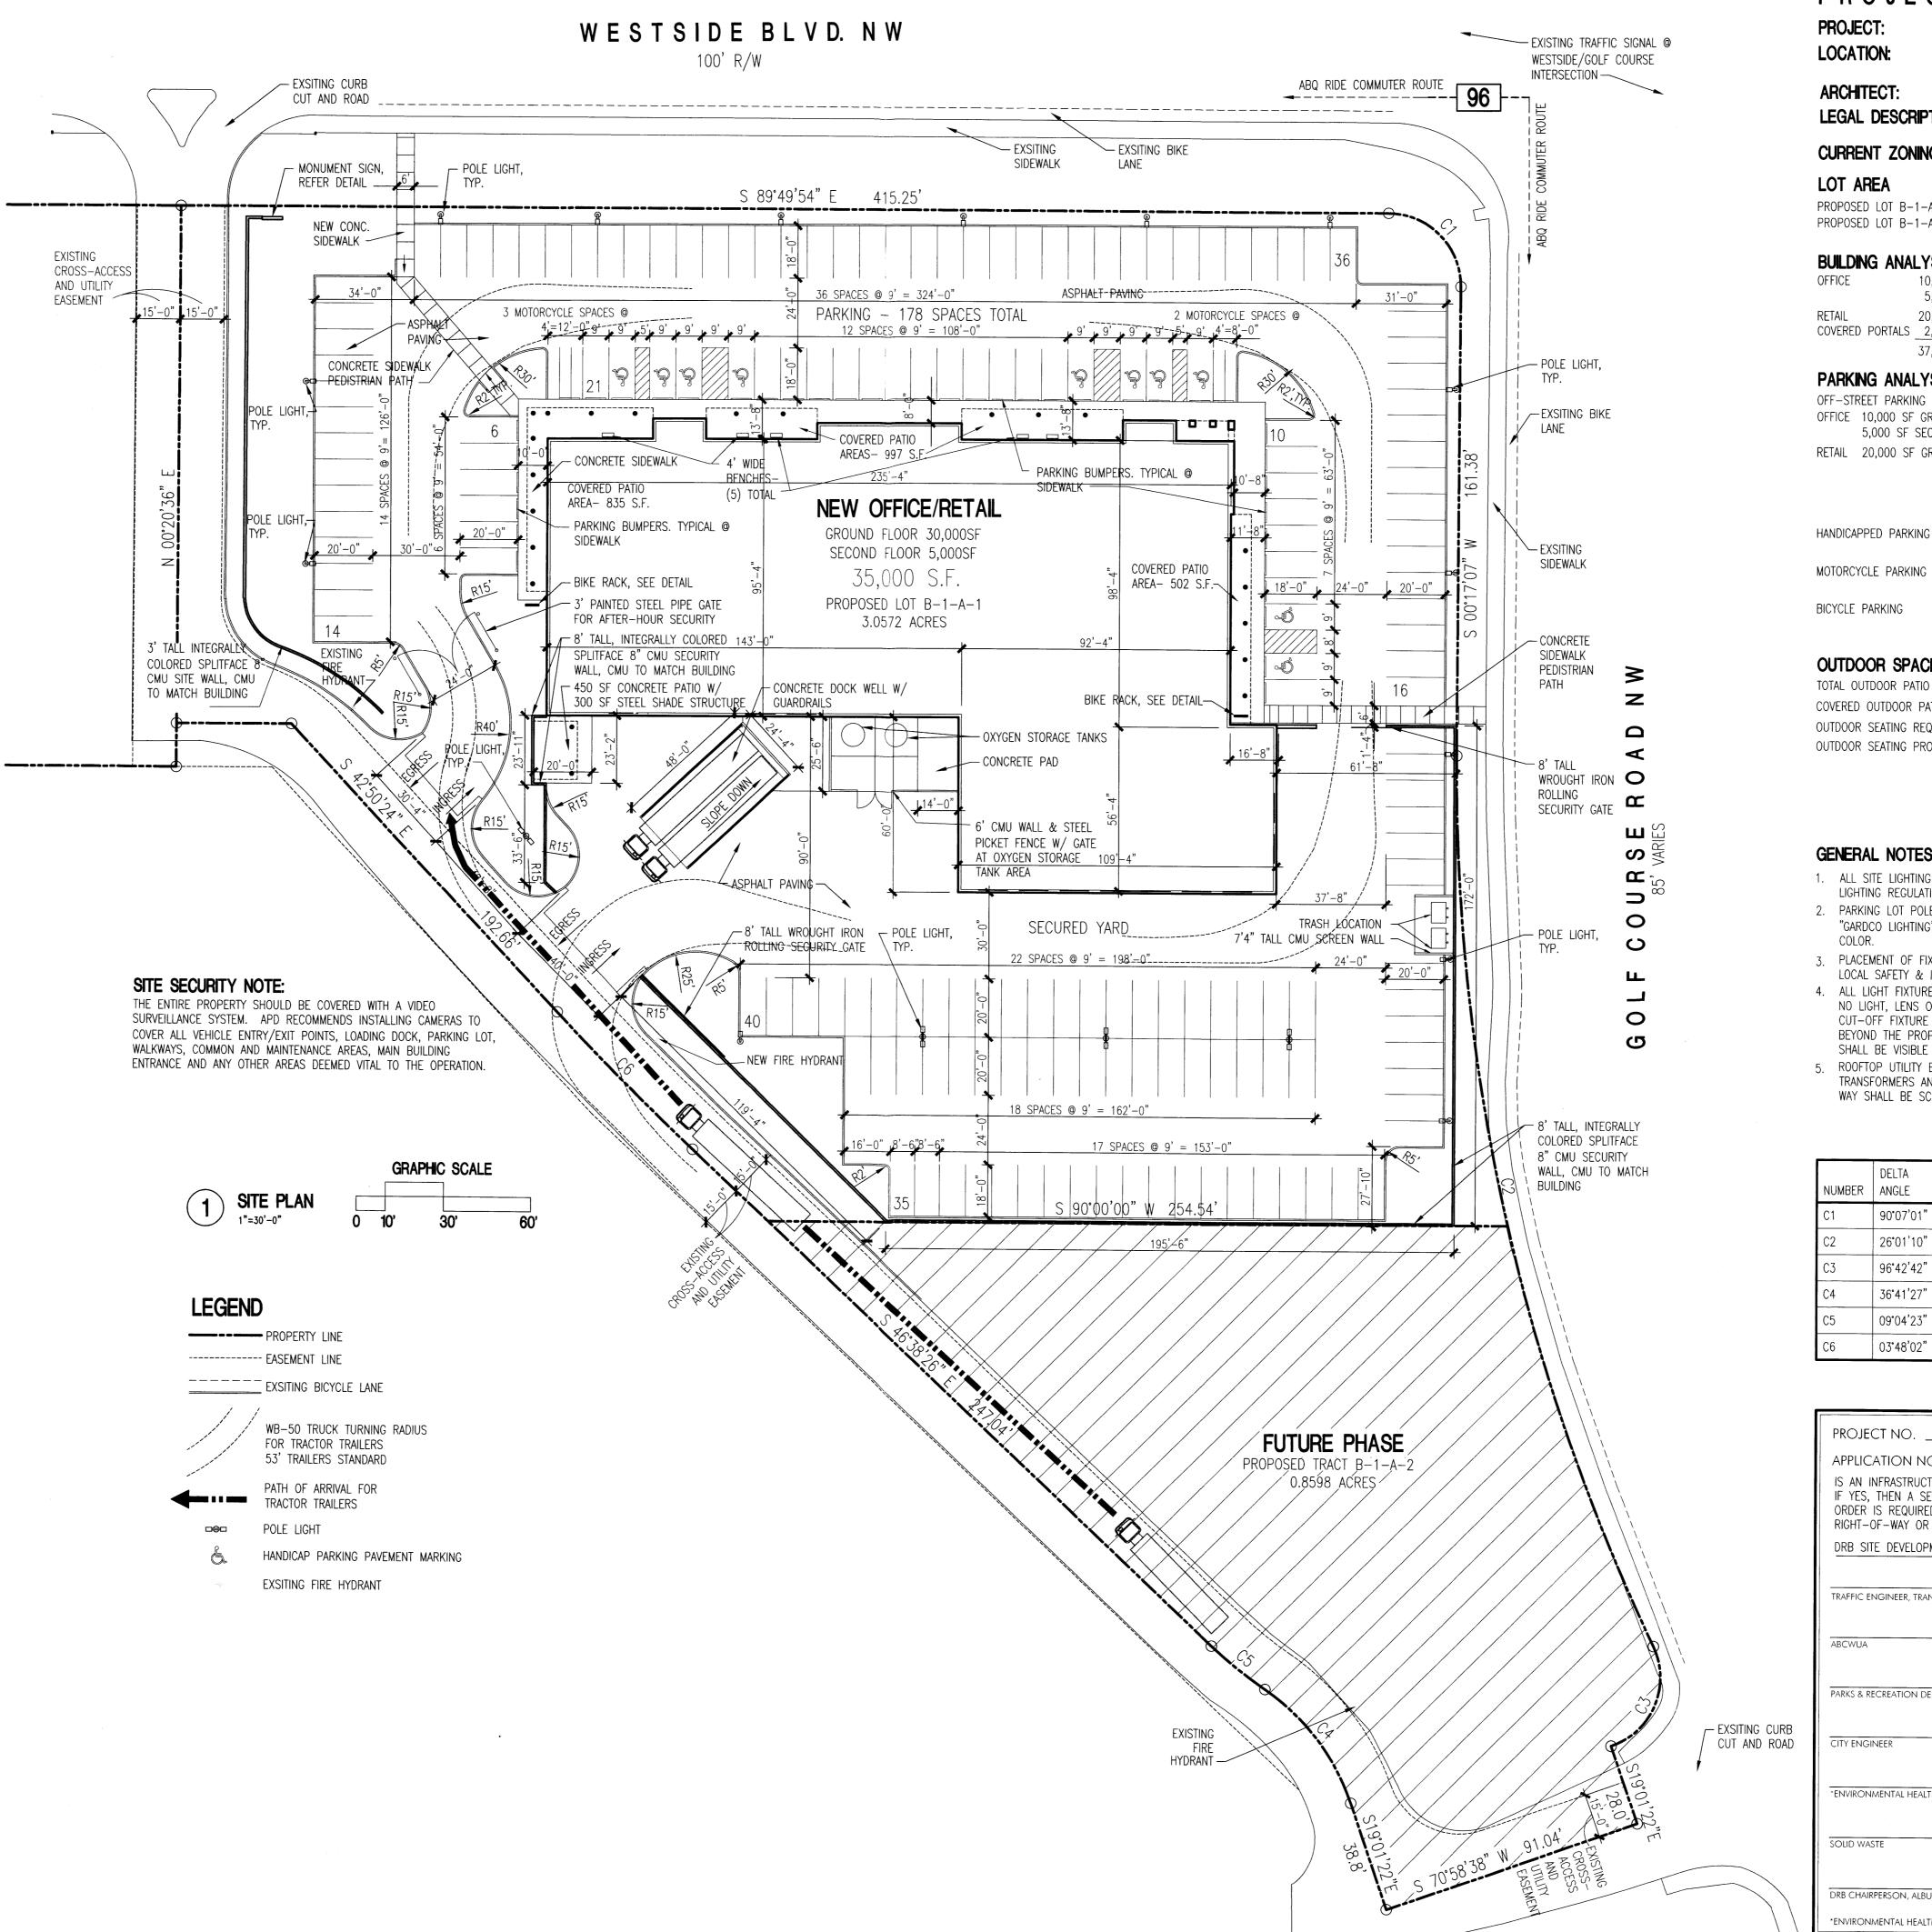

PROJECT INFORMATION

NEW OFFICE/RETAIL 10851 GOLF COURSE ROAD NW ALBUQUERQUE, NEW MEXICO TATE FISHBURN ARCHITECT LEGAL DESCRIPTION: LOT B-1-A Β BLACK ARROYO DAM CURRENT ZONING CLASSIFICATION: C-2(SC)S PROPOSED LOT B-1-A-1 3.0572 ACRES PROPOSED LOT B-1-A-2 0.8598 ACRES 3.917 ACRES BUILDING ANALYSIS 10,000 SF GROUND FLOOR шО 5,000 SF SECOND FLOOR 20,000 SF GROUND FLOOR COVERED PORTALS 2,145 SF GROUND FLOOR \simeq 37,145 GSF \vdash ARCHITECT SEAL

PARKING ANALYSIS

OFF-STREET PARKING OFFICE 10,000 SF GROUND FLOOR 1:200 = 50 SPACES5,000 SF SECOND FLOOR 1:300 = 17 SPACESRETAIL 20,000 SF GROUND FLOOR 1:200 FOR 15,000SF = 75 SPACES 1:250 FOR 5,000SF = 20 SPACES

REQUIRED 162 SPACES PROVIDED 178 SPACES

PROVIDED 10 SPACES

REQUIRED 8 SPACES PROVIDED 10 SPACES MOTORCYCLE PARKING REQUIRED 5 SPACES PROVIDED 5 SPACES 1:20 REQUIRED 9 SPACES BICYCLE PARKING

OUTDOOR SPACE ANALYSIS

TOTAL OUTDOOR PATIO AREA-5,063 S.F. COVERED OUTDOOR PATIO AREA-2,634 S.F. (52%) OUTDOOR SEATING REQUIRED- 1 SEAT PER 25 LFT= 236 / 25 = 9.44 OUTDOOR SEATING PROVIDED-(5) 48' BENCHES FOR 10 SEATS TOTAL

PROJECT

ENGINEER SEAL

GENERAL NOTES

- 1. ALL SITE LIGHTING SHALL BE CONSITENT WITH SECTION 14-16-9. AREA LIGHTING REGULATIONS & THE NIGHT SKY ORDINANCE.
- 2. PARKING LOT POLE MOUNTED LIGHTING SHALL BE 15'-0" HIGH "GARDCO LIGHTING" GLOW TOP MAG 18-1 OR EQUAL IN EARTHTONE
- 3. PLACEMENT OF FIXTURES & STANDARDS SHALL CONFORM TO STATE & LOCAL SAFETY & ILLUM. REQUIREMENTS.
- 4. ALL LIGHT FIXTURES SHALL BE FULLY SHIFLDED HORIZONTAL LAMPS W/ NO LIGHT, LENS OR BULB PROTRUDING BELOW THE BOTTOM OF THE CUT-OFF FIXTURE IN ORDER THAT NO FUGITIVE LIGHT SHALL ESCAPE BEYOND THE PROPERTY LINE AND NO SITE LIGHTING LIGHT SOURCE SHALL BE VISIBLE FROM THE SITE PERIMETER.
- 5. ROOFTOP UTILITY EQUIPMENT, MECHANICAL EQUIPMENT AND TRANSFORMERS AND TELEPHONE BOXES VIEWED FROM THE RIGHT OF WAY SHALL BE SCREENED.

CURVE TARLE

CORVE TABLE					
NUMBER	DELTA ANGLE	CHORD DIRECTION	RADIUS	ARC LENGTH	CHORD LENGTH
C1	90°07'01"	N 44°46'23" W	25.00	39.32	35.39
C2	26°01'10"	S 12°43'28" E	696.46	316.28	313.57
C3	96°42'42"	N 22°37'18" E	25.00	42.20	37.36
C4	36°41'27"	N 37°22'05" W	77.91	49.89	49.04
C5	09°04'23"	S 51°10'37" E	150.04	23.76	23.73
C6	03°48'02"	S 44°44'25" E	1000.37	66.36	66.34

PROJECT NO. APPLICATION NO. IS AN INFRASTRUCTURE LIST REQUIRED? () YES () NO IF YES, THEN A SET OF APPROVED DRC PLANS WITH A WORK ORDER IS REQUIRED FOR ANY CONSTRUCTION WITHIN PUBLIC RIGHT-OF-WAY OR FOR CONSTRUCTION OF PUBLIC IMPROVEMENTS. DRB SITE DEVELOPMENT PLAN FOR BUILDING PERMIT: TRAFFIC ENGINEER, TRANSPORTATION DIVISION ABCWUA PARKS & RECREATION DEPARTMENT CITY ENGINEER *ENVIRONMENTAL HEALTH DEPARTMENT (CONDITIONAL) SOLID WASTE DRB CHAIRPERSON, ALBUQUERQUE PLANNING DEPARTMENT *ENVIRONMENTAL HEALTH, IF NECESSARY

FICE/I OURS W ME PMENT F S OFFICE SLF COUP E, NEW N OLF SITE DEVE HME SPECIAI WESTSIDE & ALBUQUERC


REVISIONS



DRAWING NAME

SITE DEVELOPMENT PLAN FOR BUILDING **PERMIT**

SHEET NUMBER

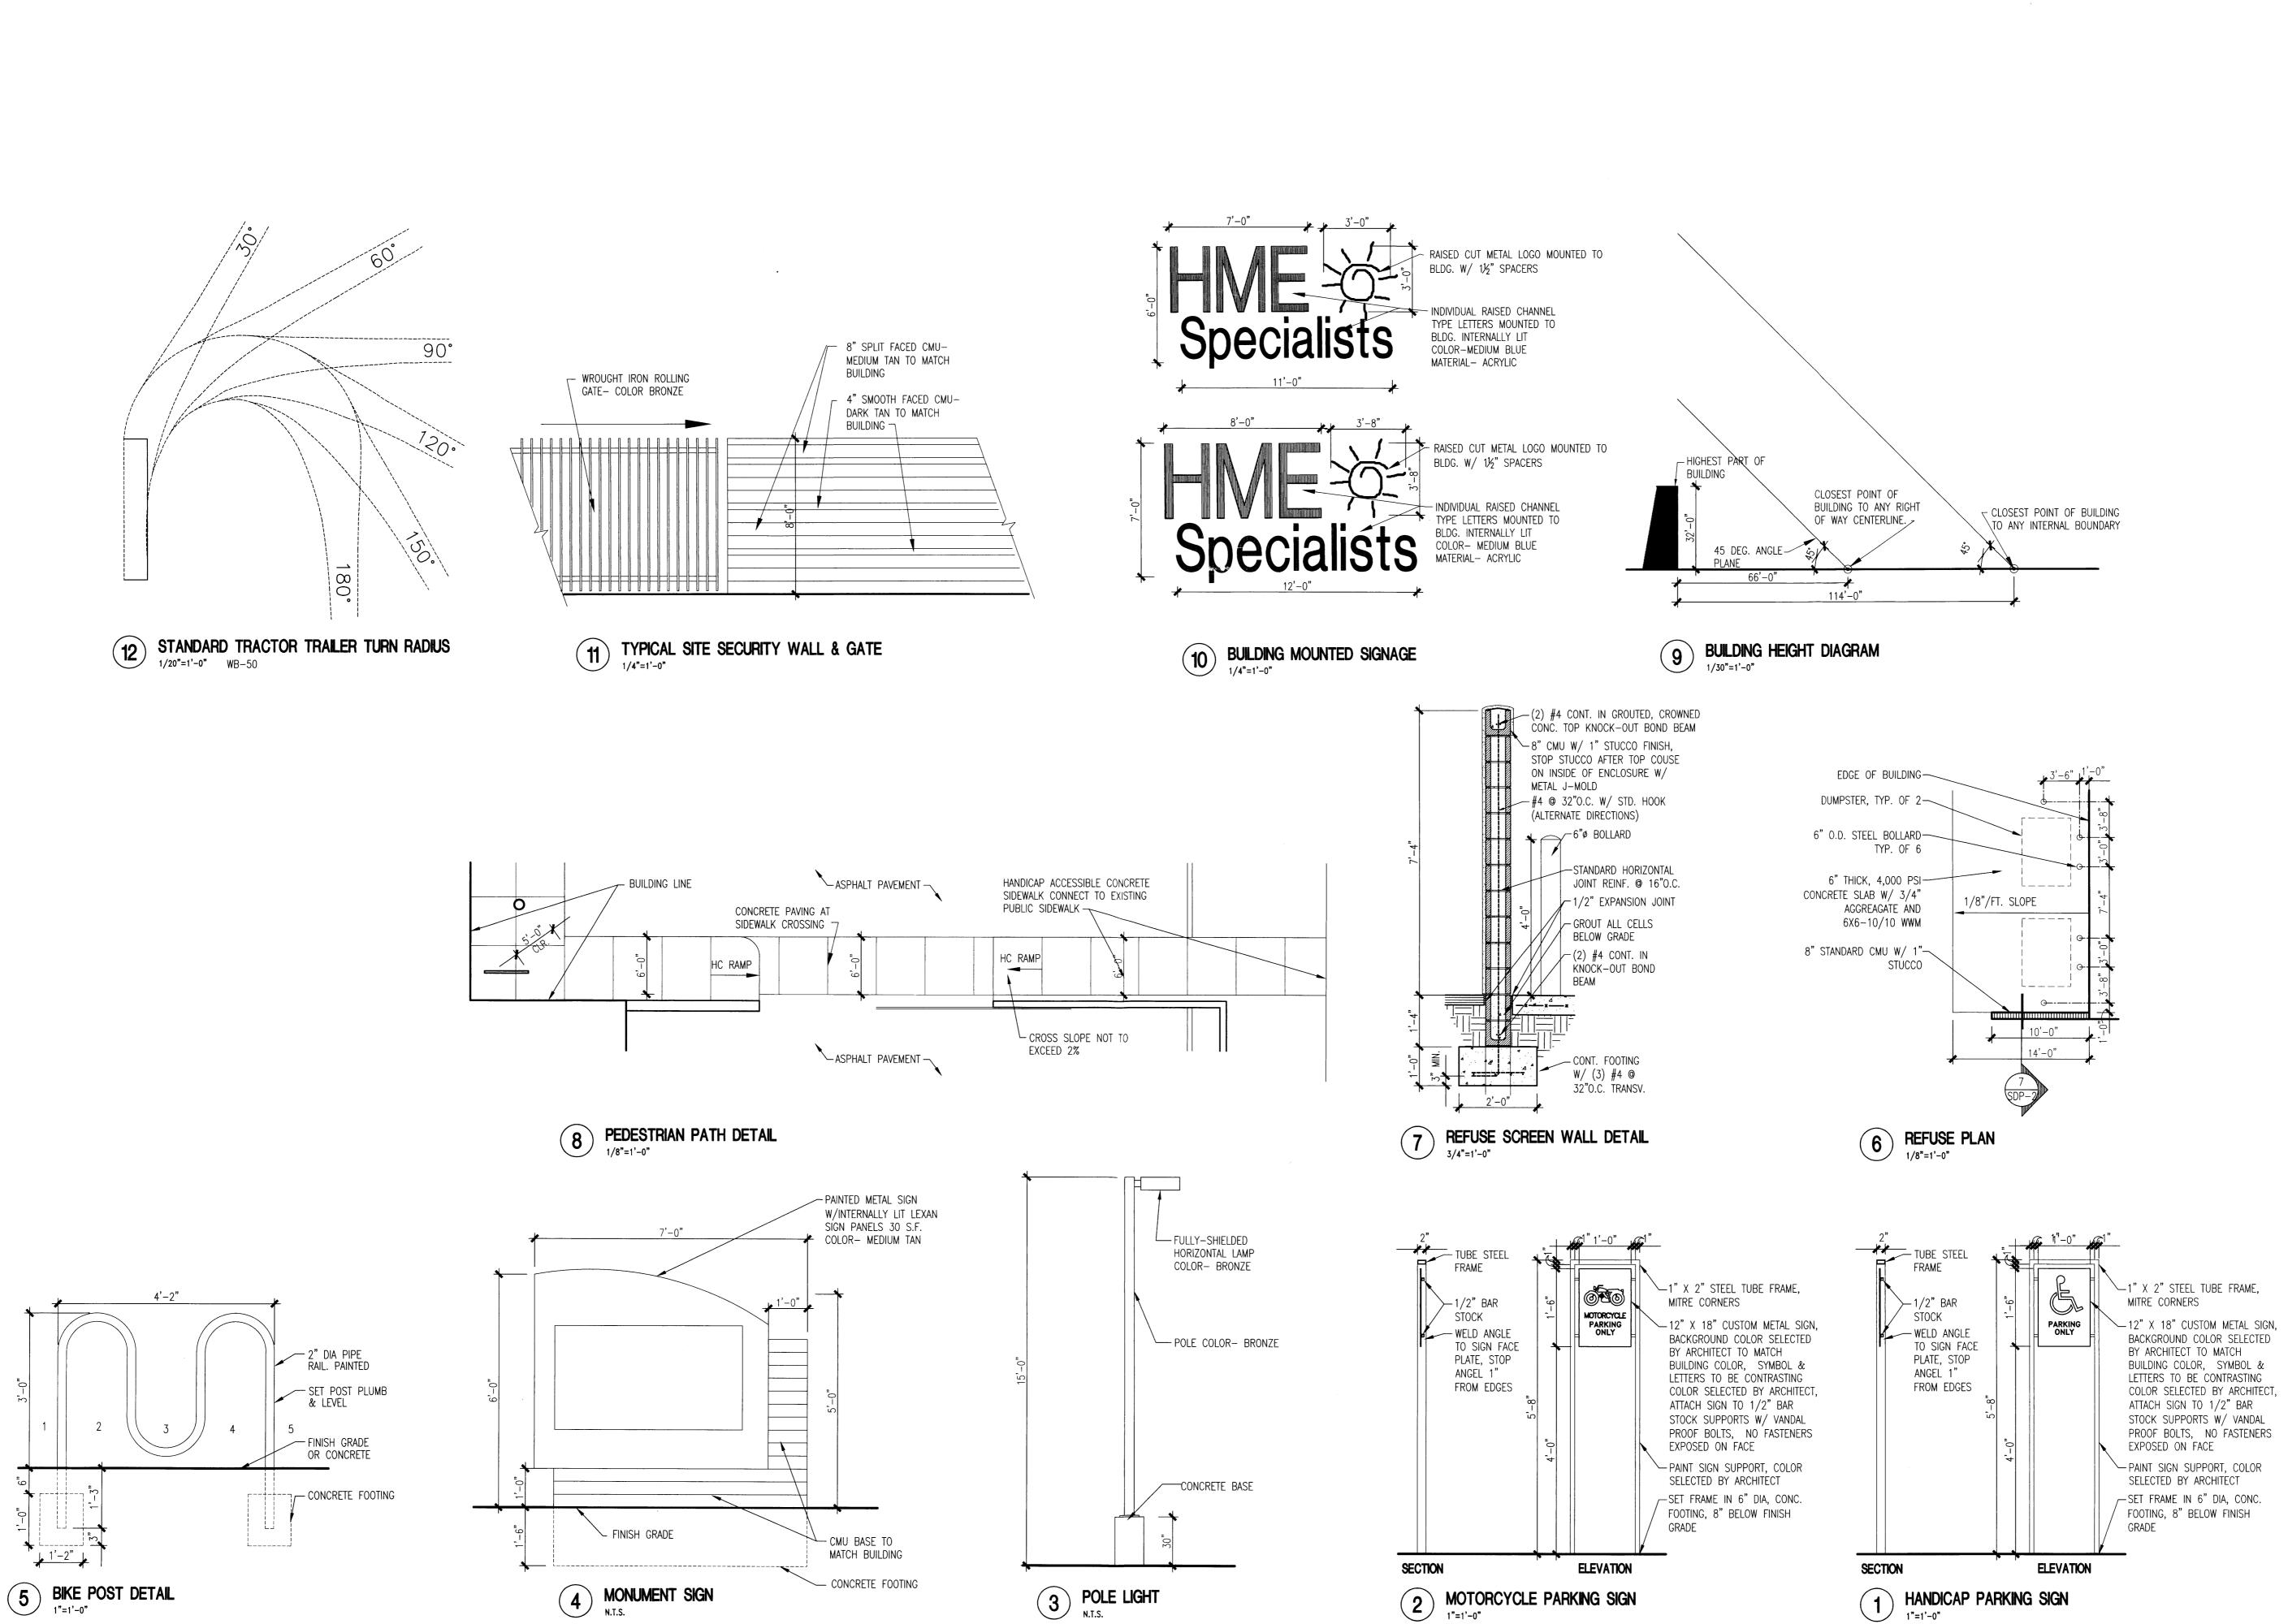

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 $Z \vdash$ α \supset В \perp S L I шО ARCHITECT SEAL

ENGINEER SEAL

PROJECT

SITE DEVELOPMENT PLA HME SPECIALISTS OFFICE/R WESTSIDE & GOLF COURSE ALBUQUERQUE, NEW MEX

REVISIONS

APRIL 24, 2013

SCALE

as noted


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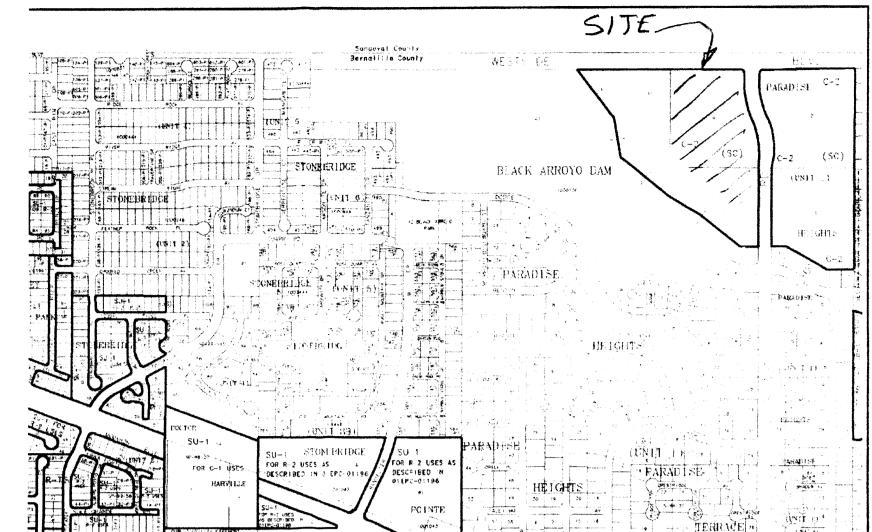
SITE DEVELOPMENT PLAN FOR BUILDING

PERMIT DETAILS


SHEET NUMBER

SDP-2



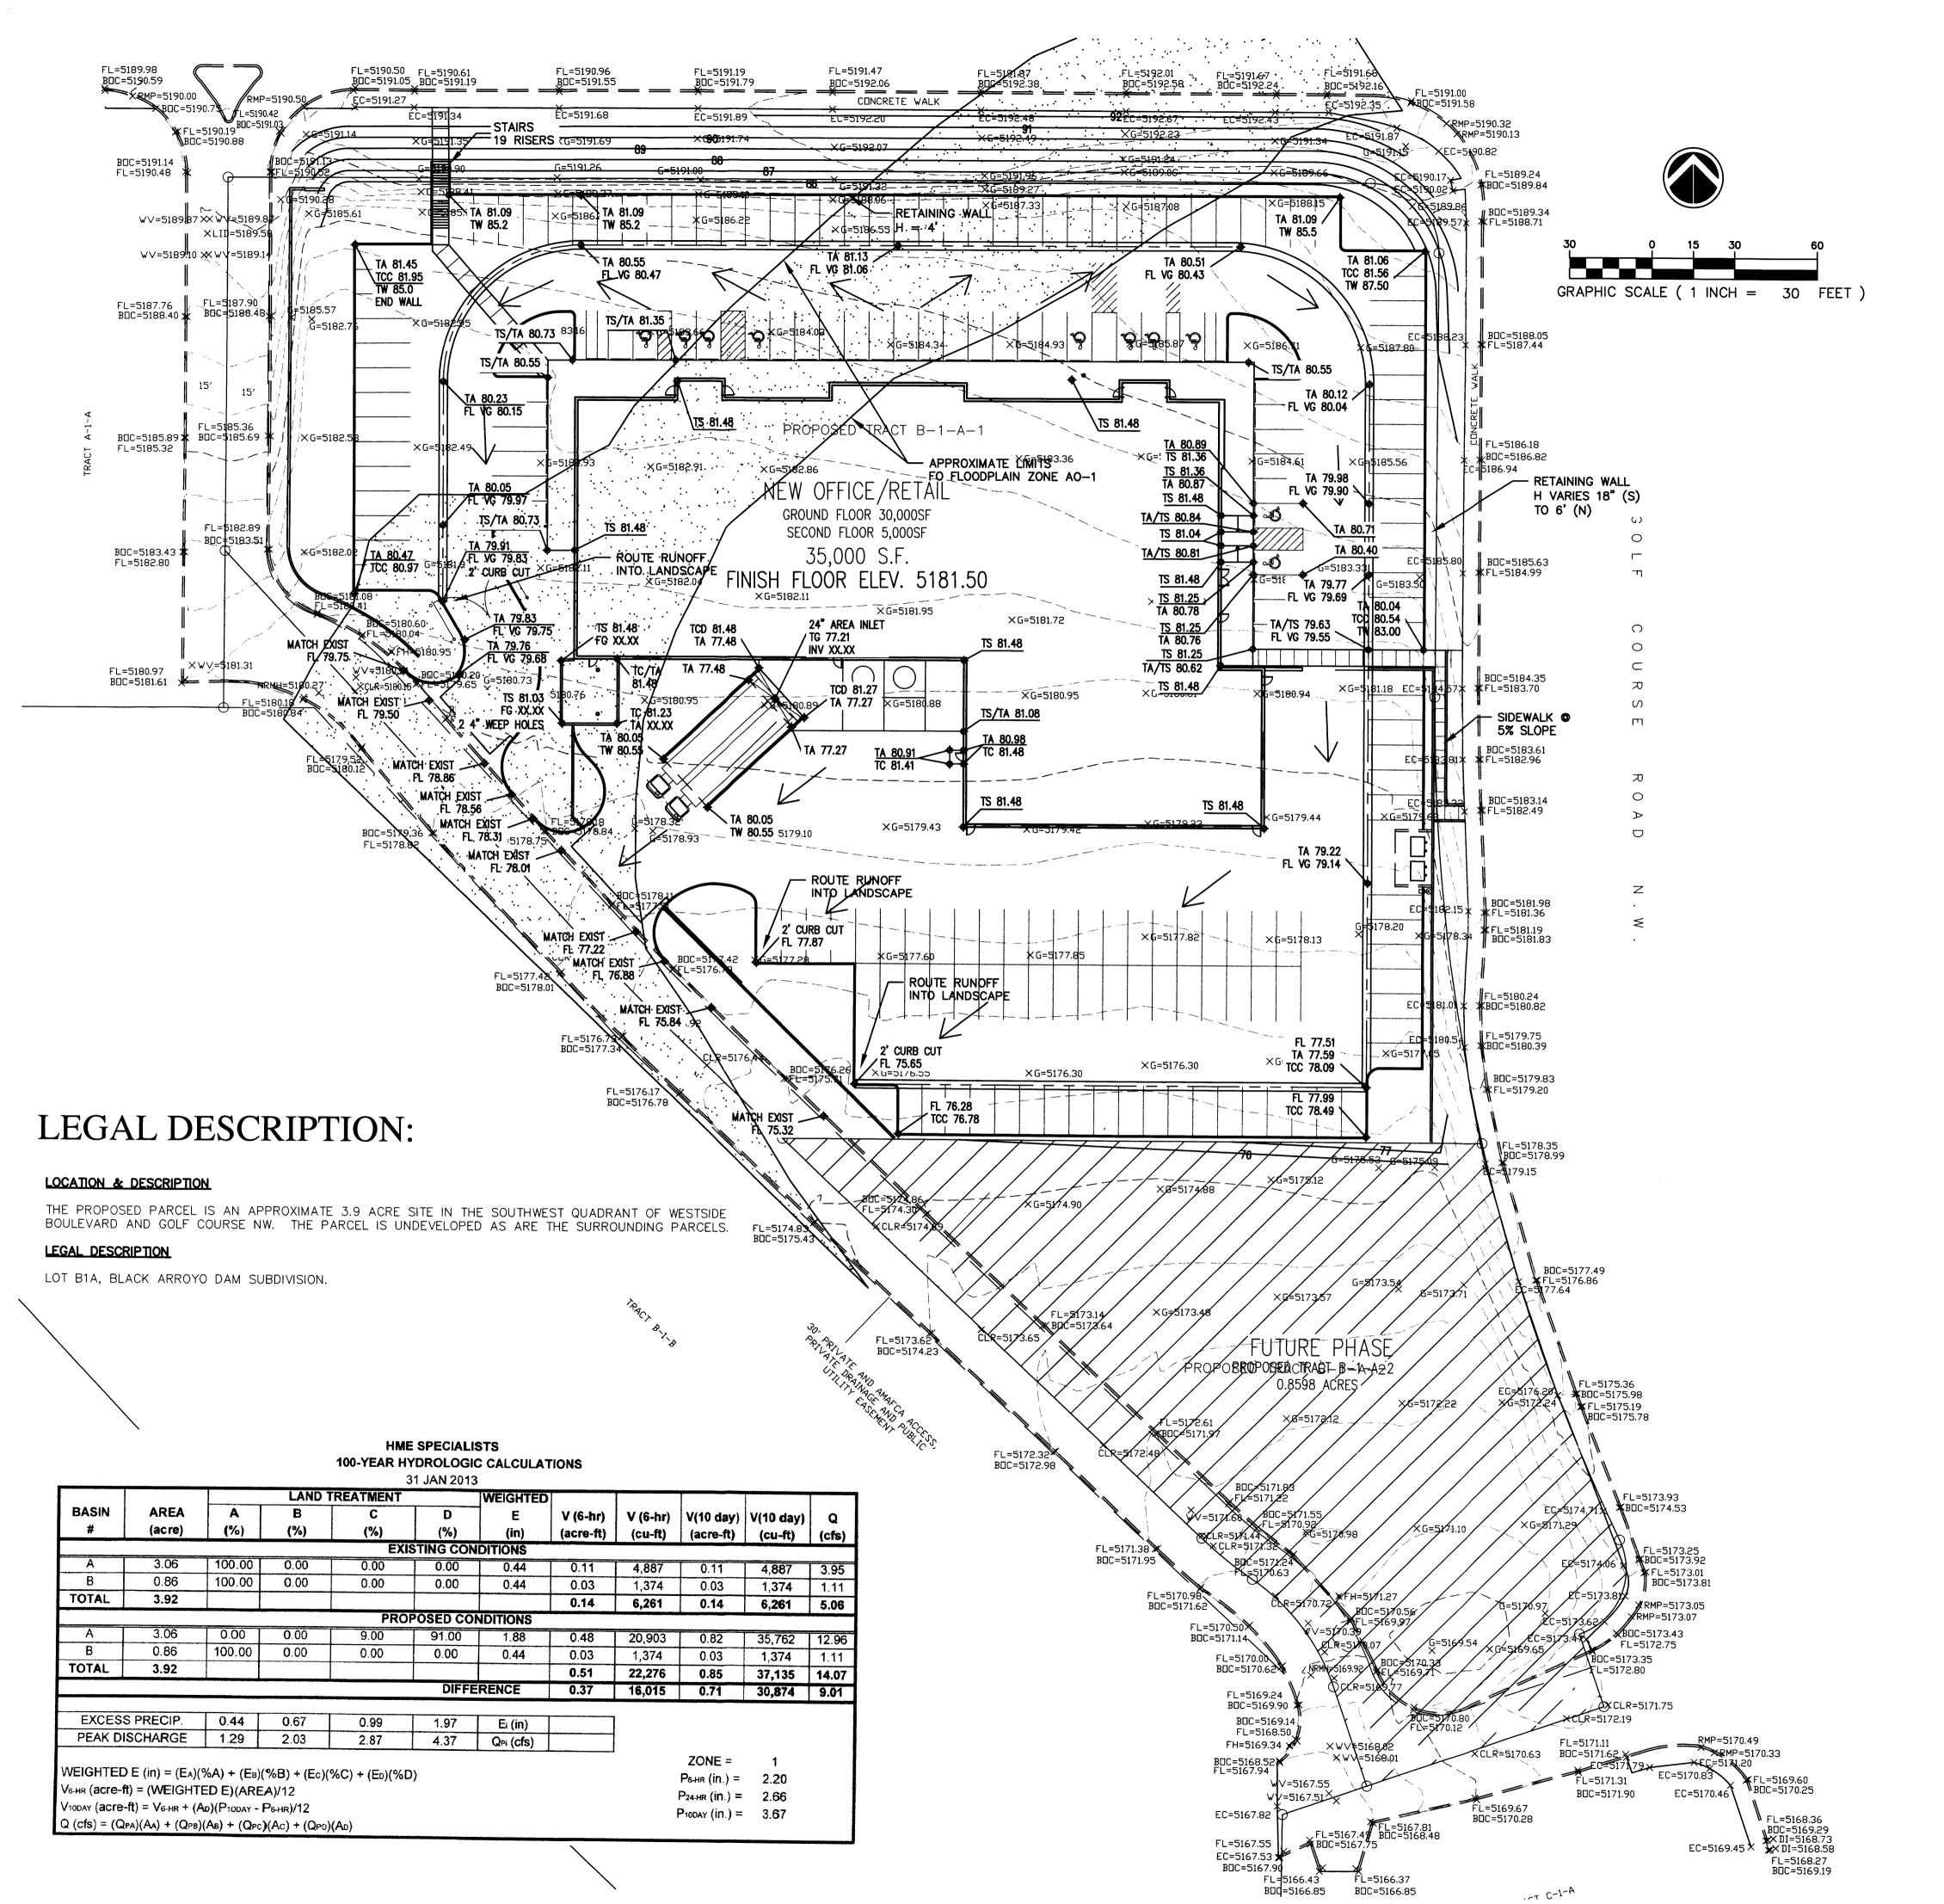

VICINITY MAP ZONE ATLAS PAGE A-12

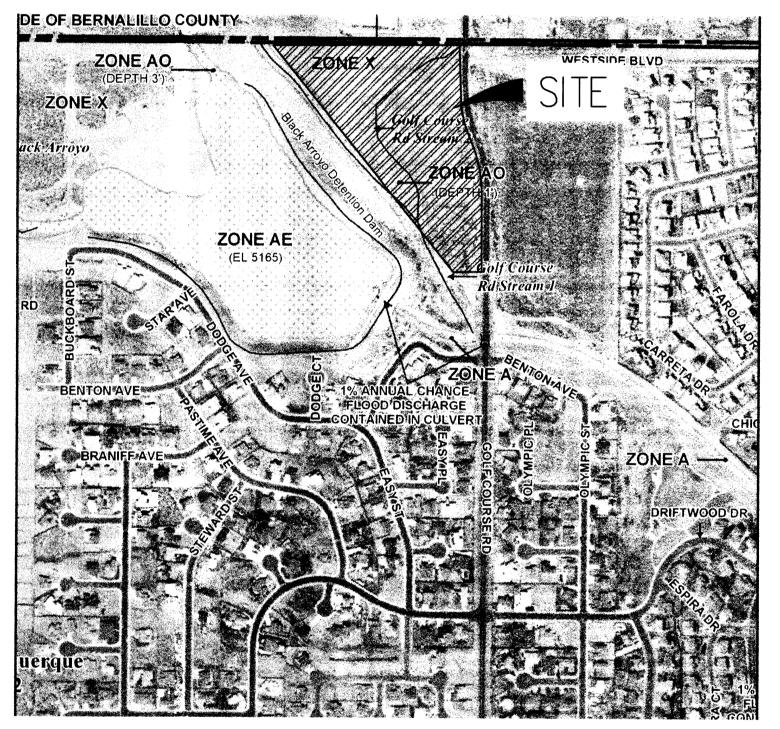

FIRM MAP PANEL 35001C0108G EFFECIVE DATE SEPT 26, 2008

DRAINAGE REPORT

HYDROLOGY

THE HYDROLOGY FOR THIS PROJECT WAS ANALYZED USING THE QUICK CALCULATIONS OF THE JUNE 1997 RELEASE OF THE CITY OF ALBUQUERQUE DEVELOPMENT PROCESS MANUAL, SECTION 22.2.

PRECIPITATION


THE 100-YR, 6-HR STORM EVENT WAS USED AS THE DESIGN STORM FOR THIS ANALYSIS. THE SITE LIES WITHIN THE ZONE 1 PRECIPITATION AREA FOR THE CITY OF ALBUQUERQUE, AS IDENTIFIED IN THE CITY OF ALBUQUERQUE DEVELOPMENT PROCESS MANUAL, SECTION 22.2. THEREFORE, TABLES WITHIN THIS SECTION WERE USED TO ESTABLISH THE EXCESS PRECIPITATION AND PEAK DISCHARGE.

EXISTING DRAINAGE

THE SITE AS IT CURRENTLY EXISTS HAS A RELATIVELY UNIFORM NORTH TO SOUTH SLOPE OF APPROXIMATELY 3.3%. RUNOFF MODE IS SHALLOW SHEET FLOW. PER THE EXISTING FLOOD RATE INSURANCE MAP, THE IS AN AO-1 FLOOD PLAIN ON SITE FROM THE NORTHEAST CORNER TOWARD THE SOUTHWEST THEN SOUTH PARALLELING THE WEST PROPERTY LINE OF THIS PARCEL. THIS DISCUSSION ACKNOWLEDGES THE FLOODPLAIN IS NOTED ON THE MAP BUT ALSO REALIZES A LETTER OF MAP REVISION (LOMR) HAS BEEN SUBMITTED TO REVISE THE MAP BASED ON STORMWATER CONTROL FACILITIES RECENTLY CONSTRUCTED UPSTREAM OF THIS PARCEL. STORMWATER GENERATED FROM THIS SITE DISCHARGES ON THE SOUTH END OF THE SITE TO THE LOWER END OF THE BLACK ARROYO DAM

DEVELOPED CONDITION

THE PROPOSED GRADING FOR THIS PROJECT GENERALLY CONTINUES THE PATTERN OF THE EXISTING STORMWATER RUNOFF EXCEPT THAT THE RUNOFF FROM THE NORTHERN PORTION OF THE SITE IS ROUTED AROUND THE BUILDING IN THE PAVED PARKING LOT. ONCE SOUTH OF THE BUILDING THE RUNOFF TAKES TWO PATHS. THE RUNOFF FROM THE WESTERN PORTION OF THE SITE FLOWS WEST THROUGH THE NORTHERN DRIVEPAD TO THE NEW PRIVATE ROAD THAT CONVEYS THE RUNOFF SOUTH TO THE SOUTHERN END OF THE BLACK ARROYO DAM. RUNOFF FROM THE EASTERN PORTION OF THE SITE SHEET FLOW SOUTH, ON THE PROPOSED PARKING LOT PAVEMENT, WHERE IT ULTIMATELY DISCHARGES FROM THE SITE INTO THE NEW PRIVATE ROAD DISCUSSED ABOVE. IN ORDER TO REDUCE THE RETAINING WALL HEIGHT ALONG THE NORTH PROPERTY LINE, THIS PLAN PROPOSES SLOPING FROM 10' BEYOND THE FACE OF THE CURB (STANDARD DISTANCE) TO THE RETAINING WALL FACE AT A SLOPE OF 4:1. THIS SLOP WILL BE LANDSCAPED. THE 10' FROM THE FACE OF CURB TO THE GRADE BREAK LINE (10') SLOPE TO THE CURB AS THE STANDARD 2%. IT IS THE INTENT OF THIS GRADING PLAN TO DEPRESS LANDSCAPE AREAS ALONG THE WEST SIDE OF THE SITE AND ROUTE THE RUNOFF FROM THE PAVED AREAS THROUGH THOSE LANDSCAPE AREAS AS A WATER HARVESTING MEASURE...

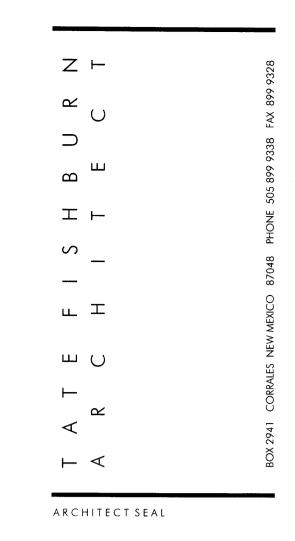

ENGINEER SEAL

PROJECT

SITE DEVELOPMENT PLAN HME SPECIALISTS OFFICE/RETAII WESTSIDE & GOLF COURSE, NW ALBUQUERQUE, NEW MEXICO

REVISIONS

ATE MAY 7 2013

MAY 7, 2013

NORTH S C A L


1"=30'-0"

DRAWING NAME

CONCPTUAL GRADING PLAN

SHEET NUMBER

C0.1

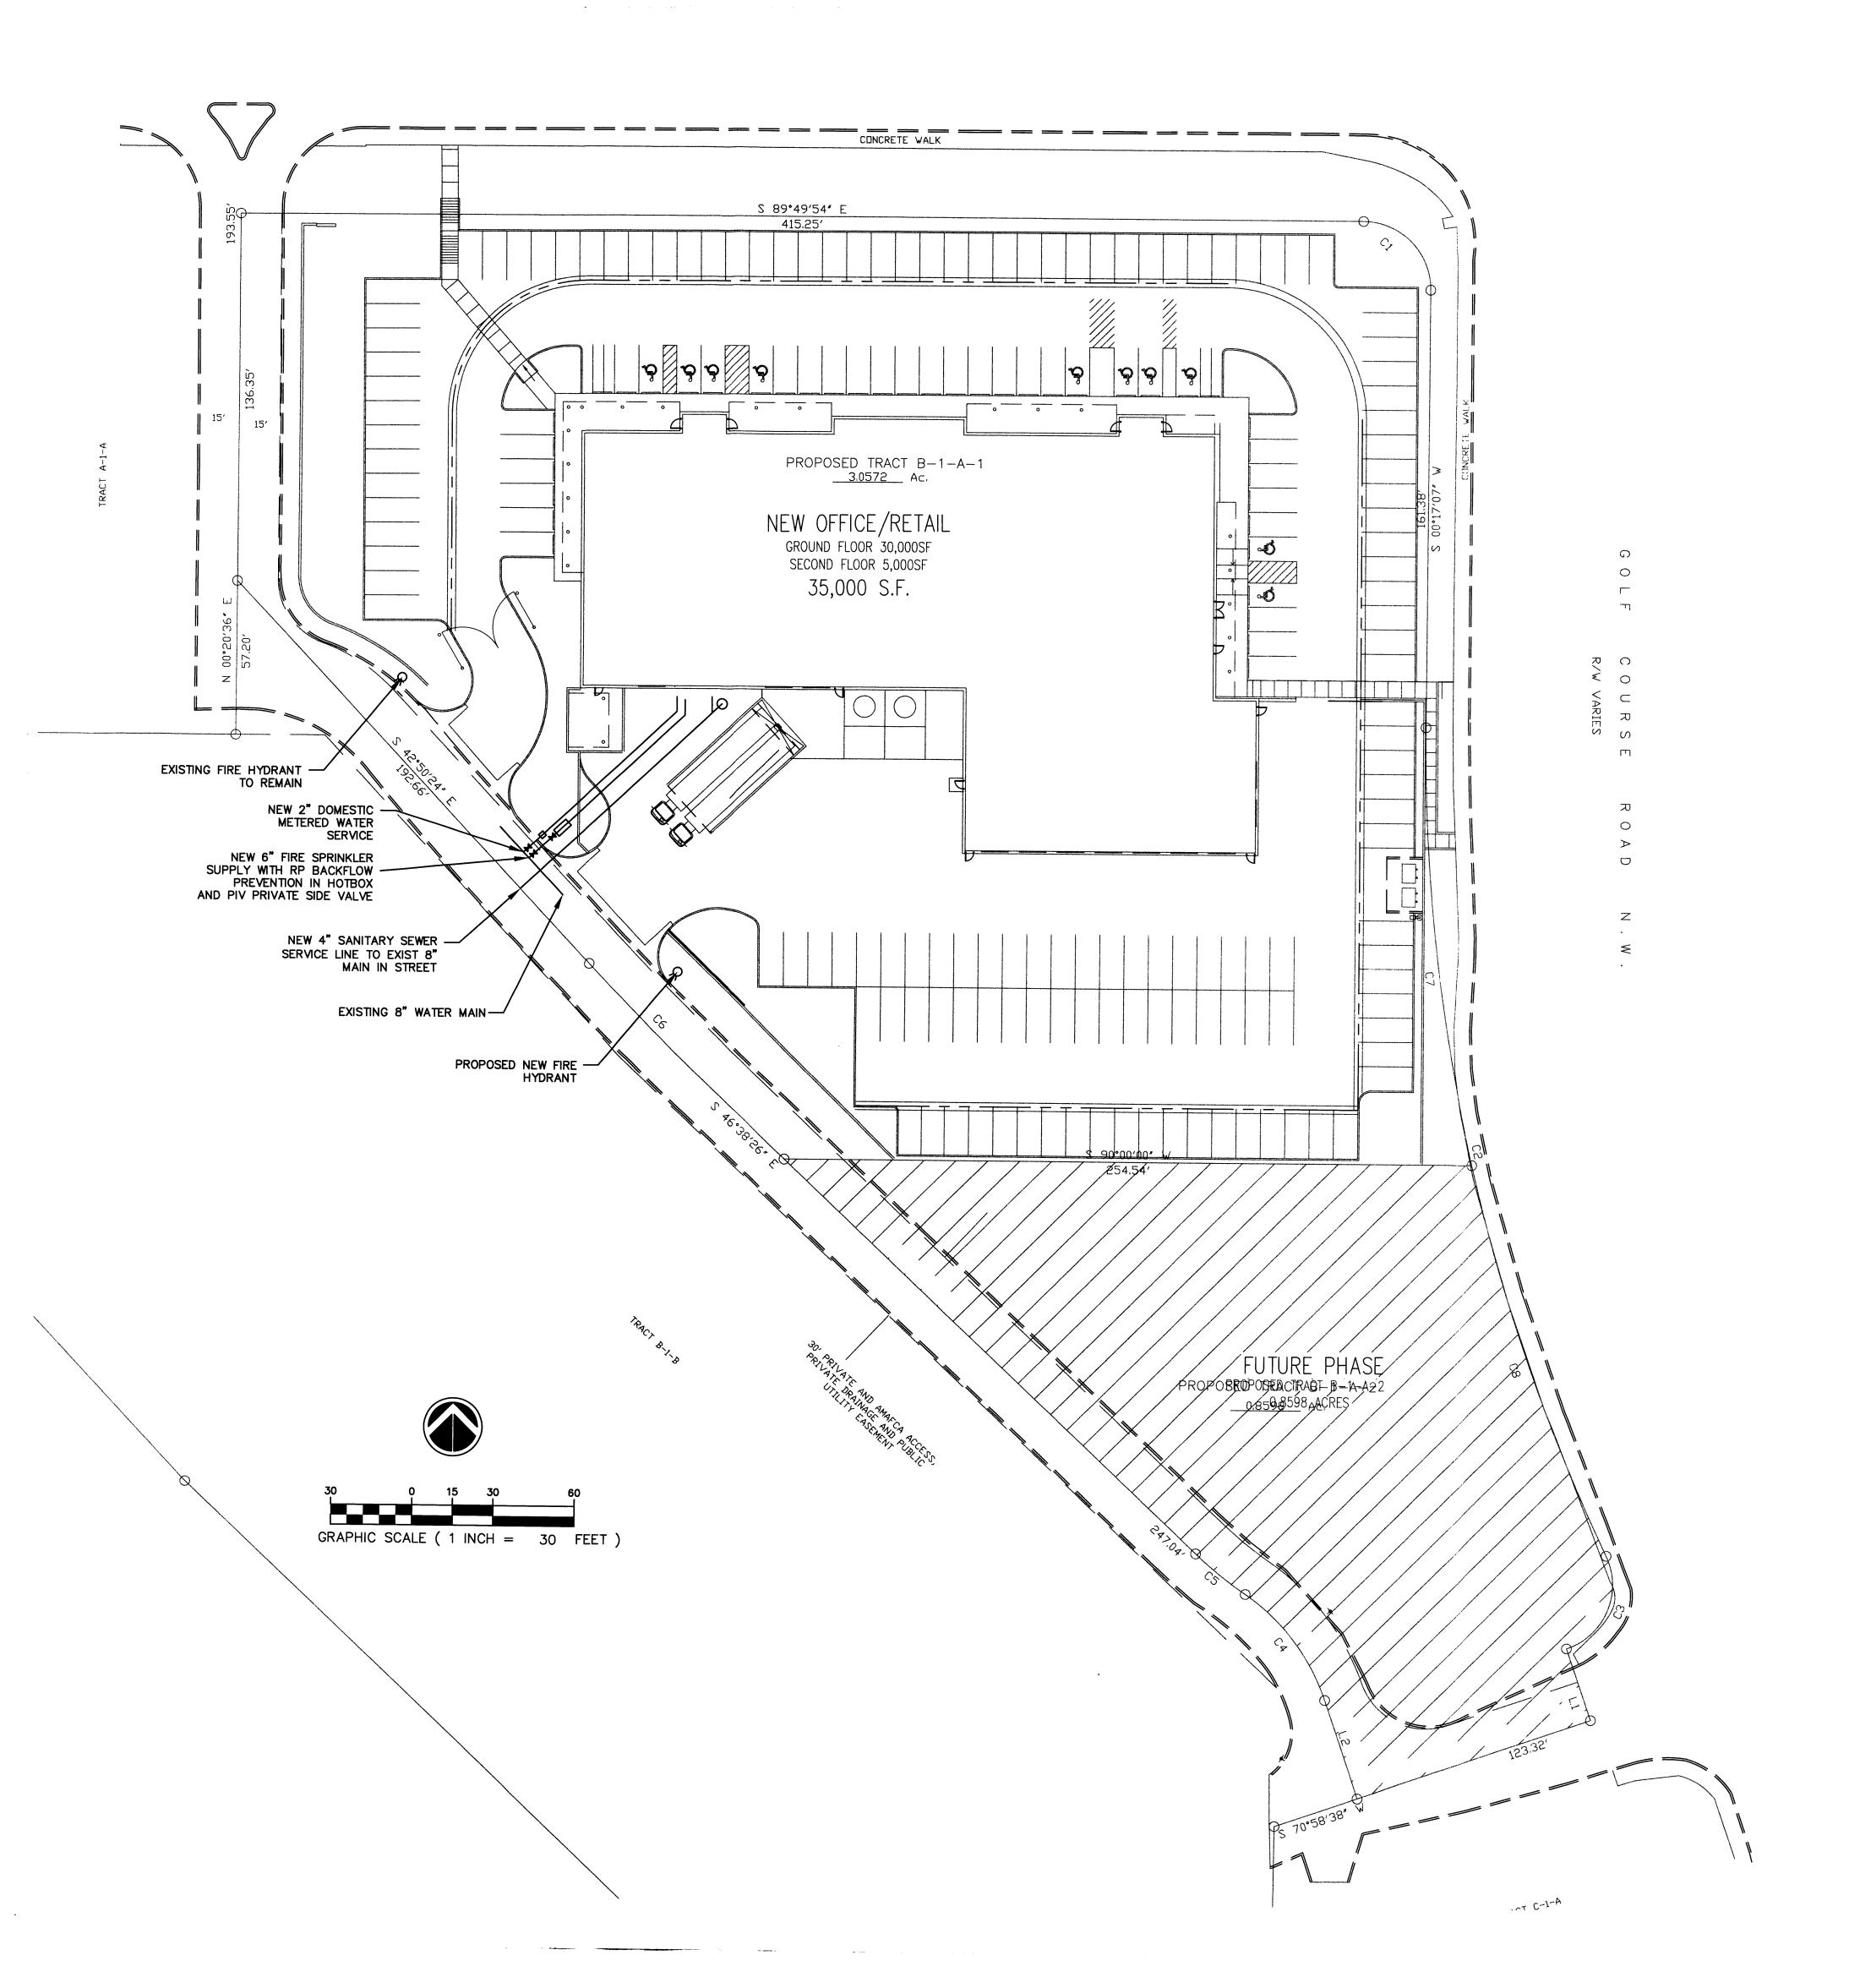

PUBLIC SERVICE COMPANY CONDITIONS

SCREENING SHOULD BE INSTALLED TO ALLOW FOR ACCESS TO UTILITY FACILITIES. ALL SCREENING AND VEGITATION SURROUNDING GROUND MOUNTED TRANSFORMERS AND UTILITY PADS ARE TO ALLOW 10-FEET OF CLEARANCE IN FRONT OF THE EQUIPMENT DOOR AND 5 TO 6-FEET OF CLEARANCE ON THE REMAINING THREE SIDES FOR SAFE OPERATION, MAINTENANCE AND REPAIR PURPOSES. PLEASE REFER TO THE PNM ELECTRIC SERVICE GUIDE AT WWW. PNM.CON FOR SPECIFICATIONS.

TATEFISHBURNN

ARCHITECT SEAL

ENGINEER SEAL

PROJECT

HME SPECIALISTS OFFICE/RETAIL
WESTSIDE & GOLF COURSE, NW
ALBUQUERQUE, NEW MEXICO

REVISIONS

MAY 7, 2013




DRAWING NAME

CONCPTUAL WATER/SEWR PLAN

SHEET NUMBE

C0.2

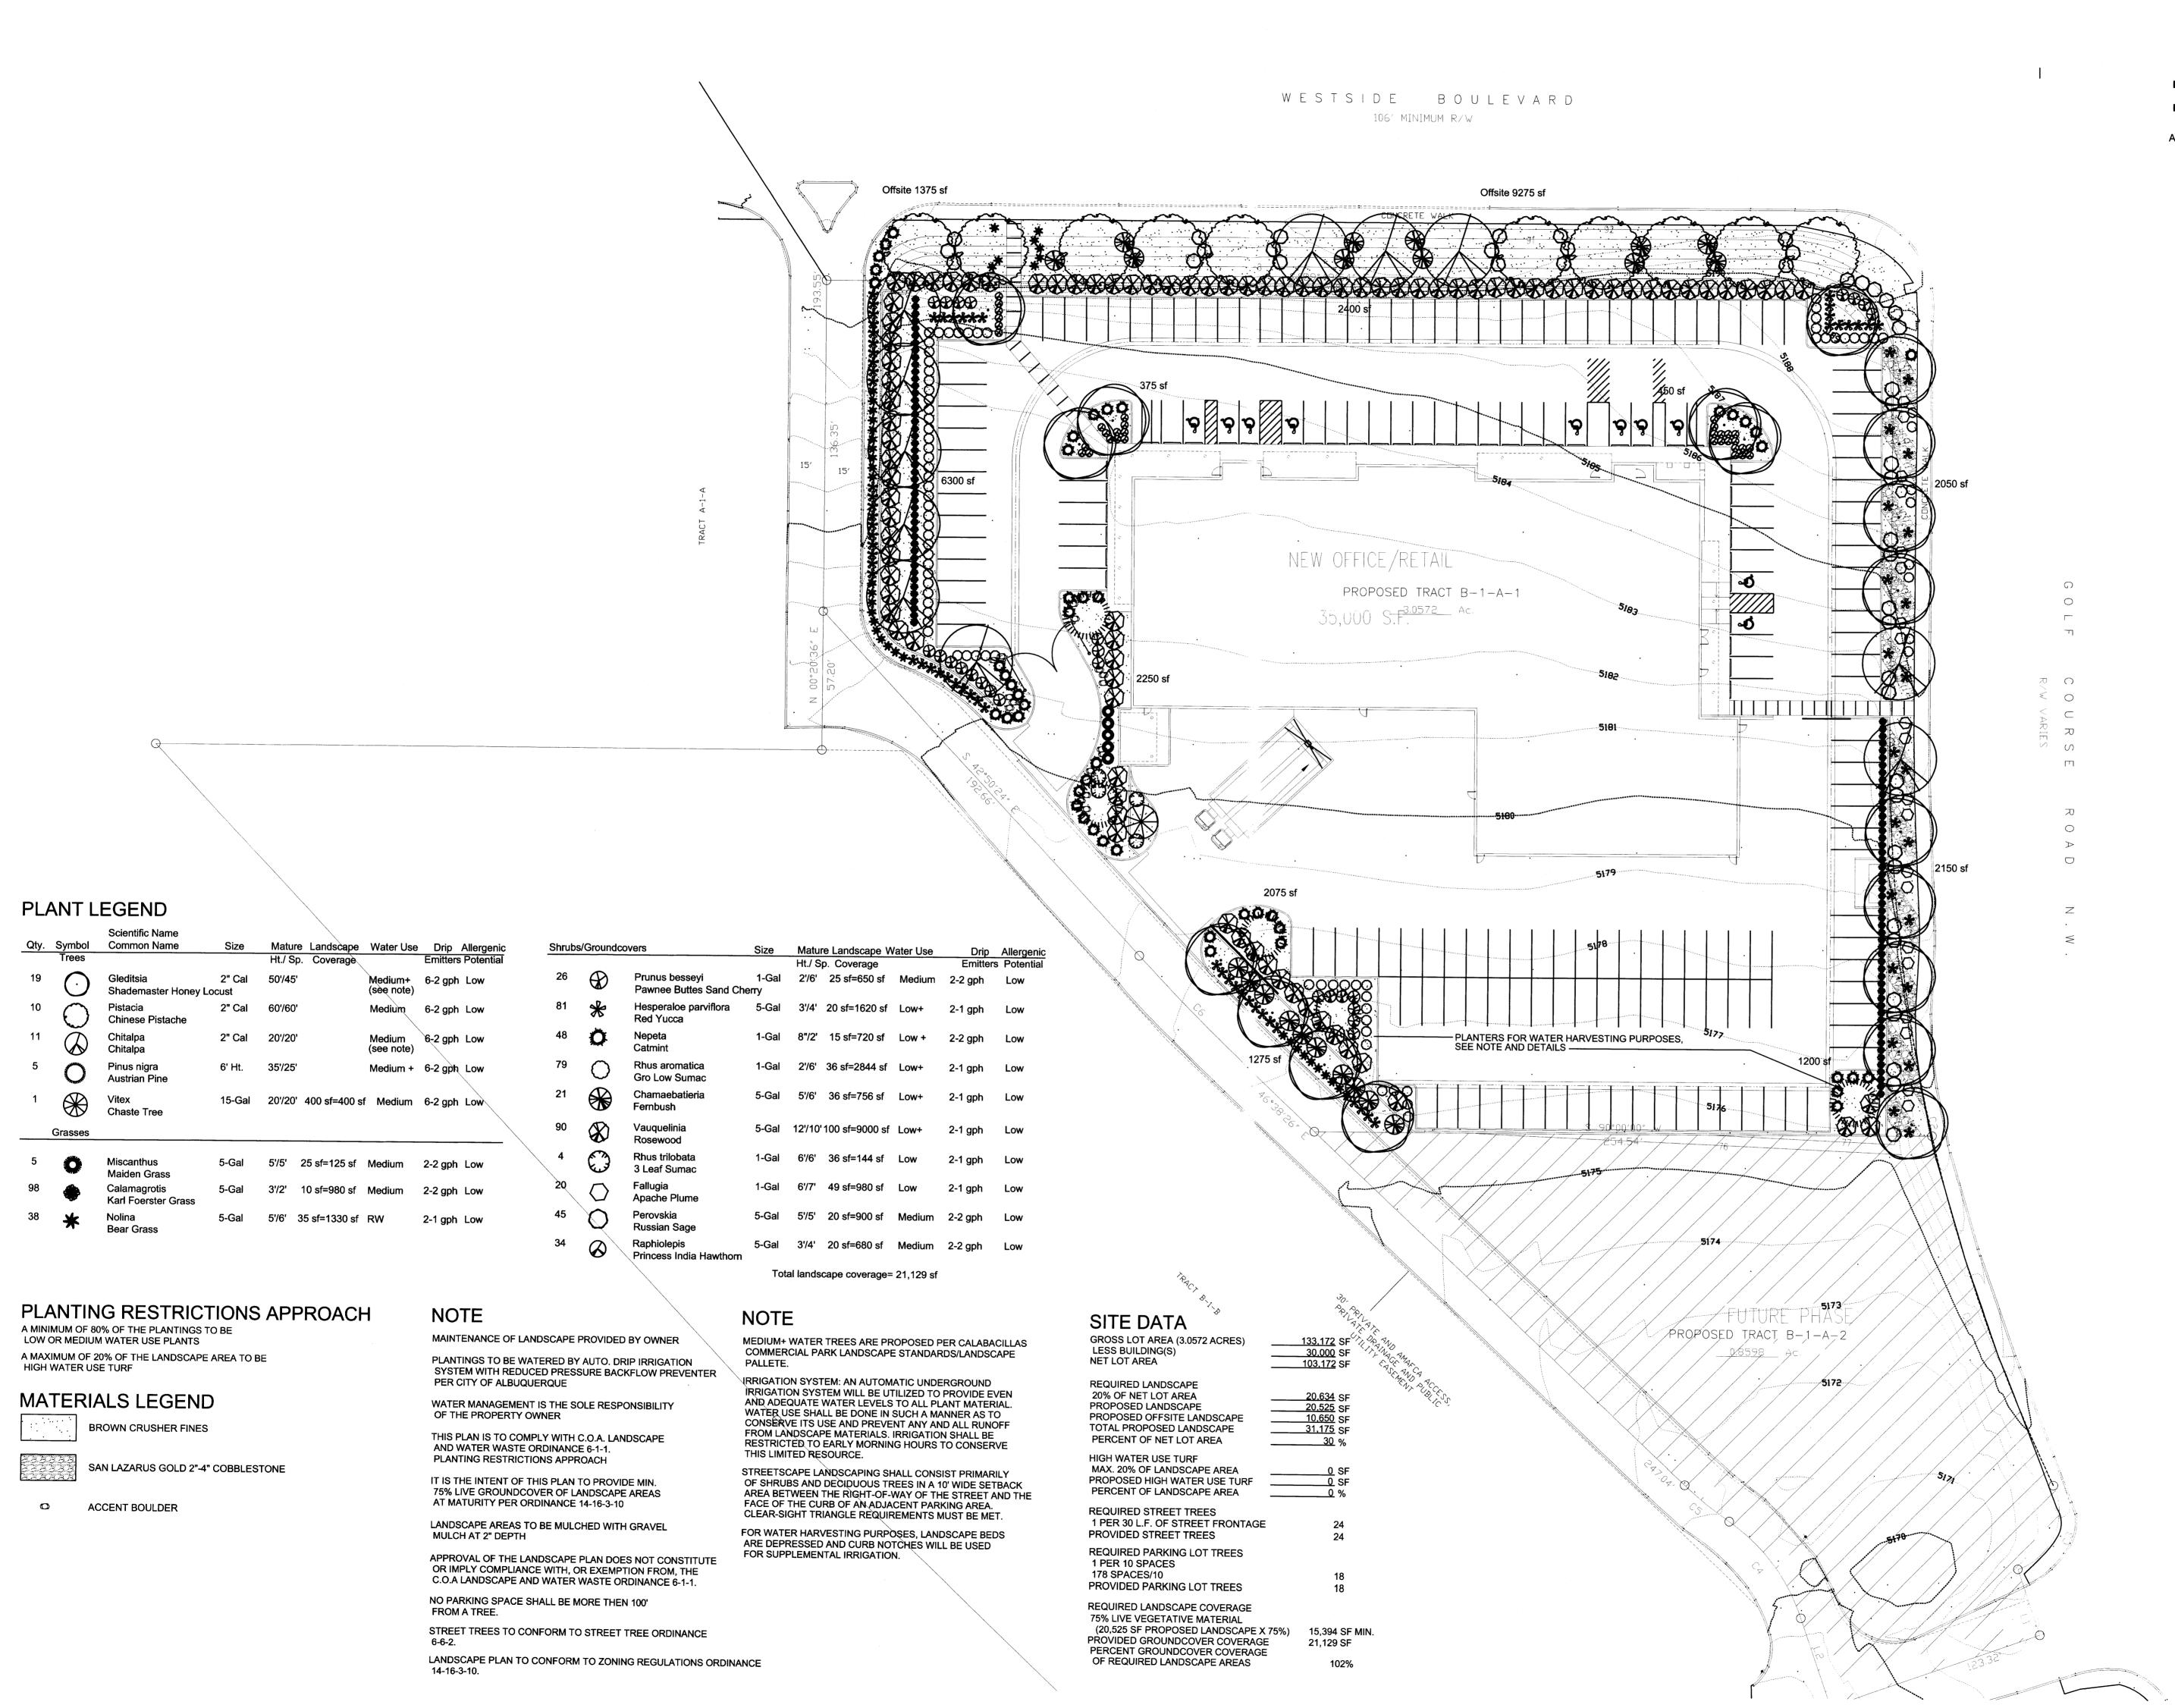



A P C H I T E C T S E A L

ENGINEER SEAL

HME SPECIALISTS OFFICE/RETAILS WESTSIDE & GOLF COURSE, NW.

4/24/13 4/17/13 4/11/13 2/27/13


REVISIONS




DEAWING NAME

ADSCAPE PLAN

SHEET NUMBER

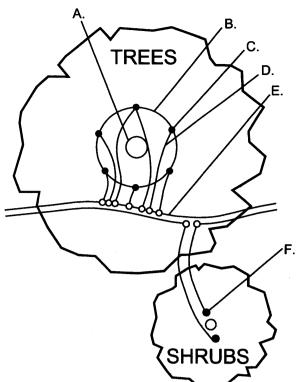


- TREE TRUNK/ ROOT CROWN
- F. EMITTER PLACED WITHIN 6" OF PLANT STEM
- NOTE: PLACE EMITTER ABOVE PLANT ON SLOPE

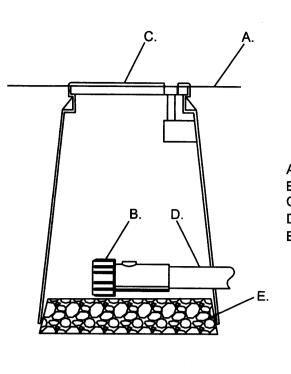


- FINISH GRADE END FLUSH CAP
- 6" ROUND BOX WITH LOCKING LID
- PE DRIP LINE E. 2" DEPTH ¾" GRAVEL


END FLUSH CAP DETAIL

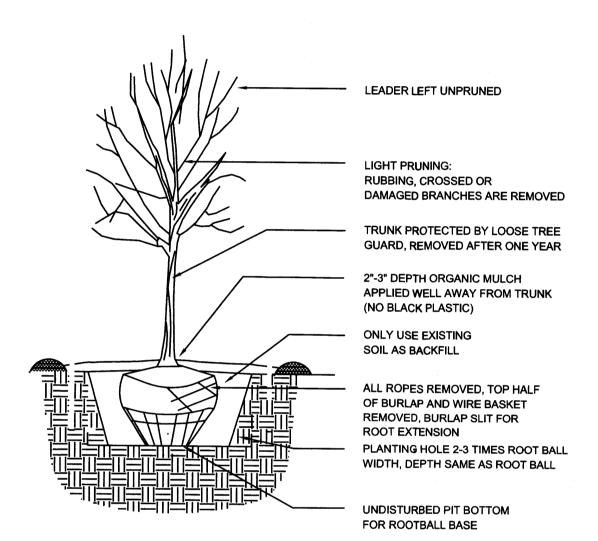


TREE PLANTING DETAIL

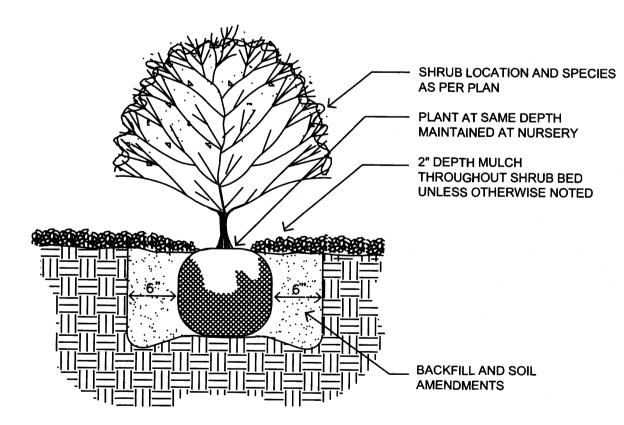


SHRUB PLANTING DETAIL

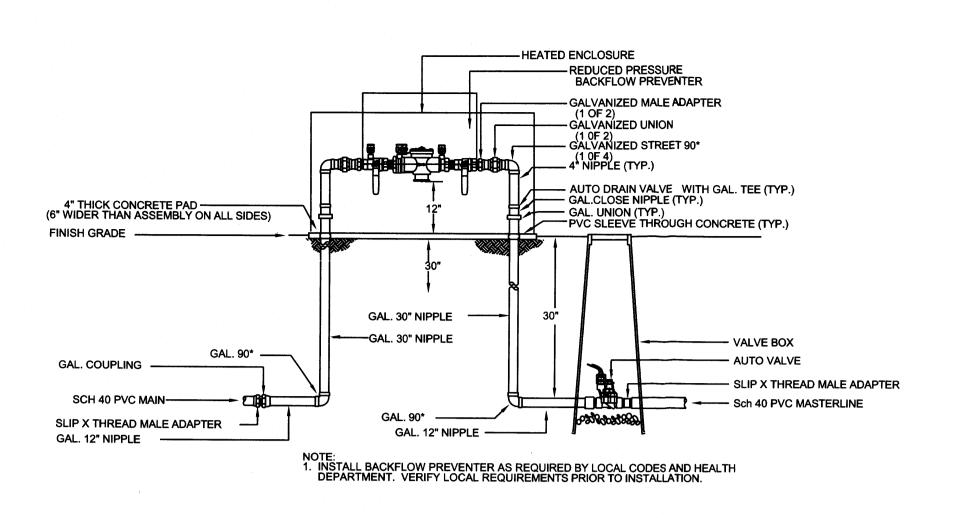

RP BACKFLOW/MASTER VALVE DETAIL

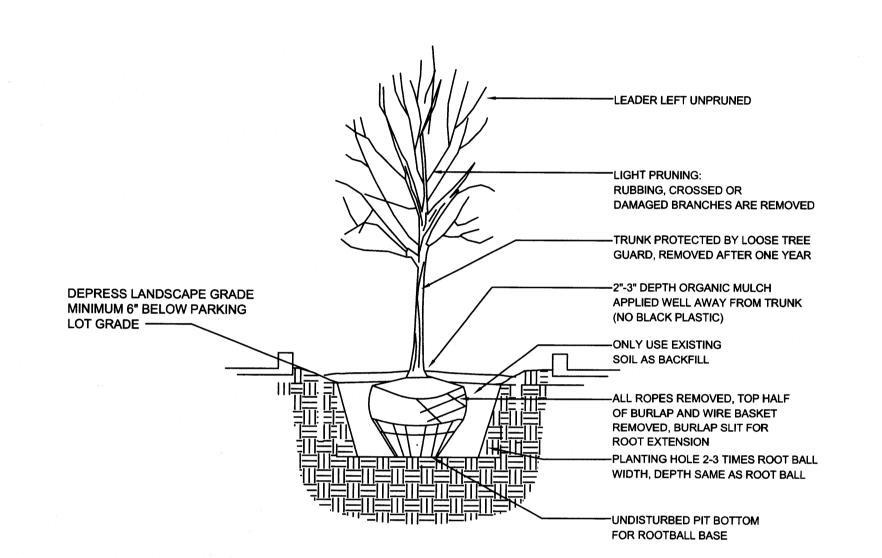

TREE PLANTING DETAIL/WATER HARVESTING

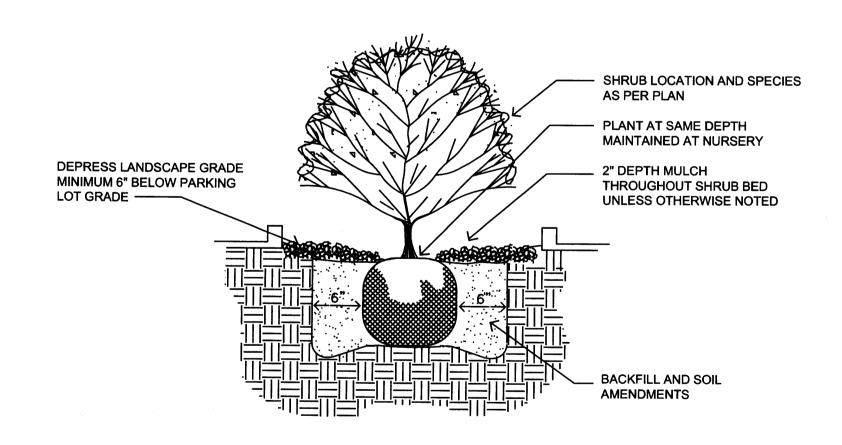

SHRUB PLANTING DETAIL/WATER HARVESTING

ENGINEER SEAL

ARCHITECT SEAL

LANDSCAPE CONTRACTORS
P.O. BOX 10597
Albuquerque, NM 87184
505.898.9615
505.898.2105 (fax)
design@hulc.com
www.headsuplandscape.com

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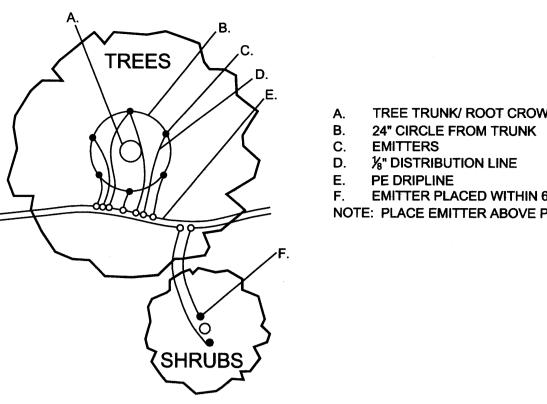
DATEJANUARY 31, 2013




DRAWING NAME

DETAIL SHEET

SHEET NUMBER



EMITTER PLACEMENT DETAIL

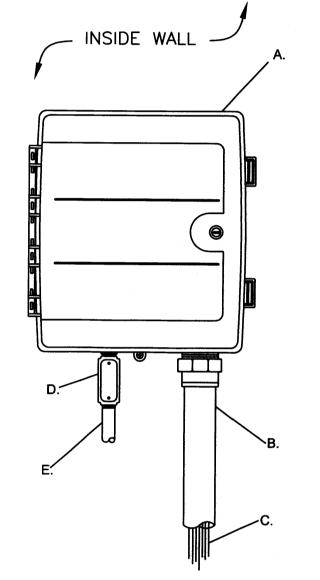


- A. WALL MOUNT CONTROLLER 2" PVC SCH 40 CONDUIT AND FITTINGS
- WIRES TO REMOTE CONTROL VALVES JUNCTION BOX
- 1" PVC SCH 40 CONDUIT AND FITTINGS
- TO POWER SUPPLY


A. BROOKS PRODUCTS INC. 1419-18


BODY (ABS) VALVE BOX W/ BOLT DOWN

CONTROLLER DETAIL

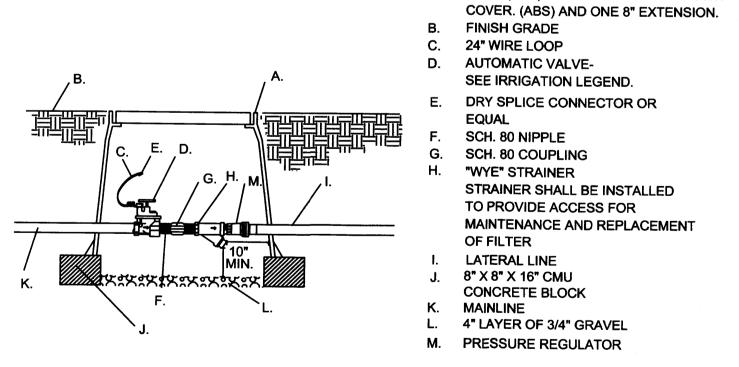

DRIP VALVE DETAIL

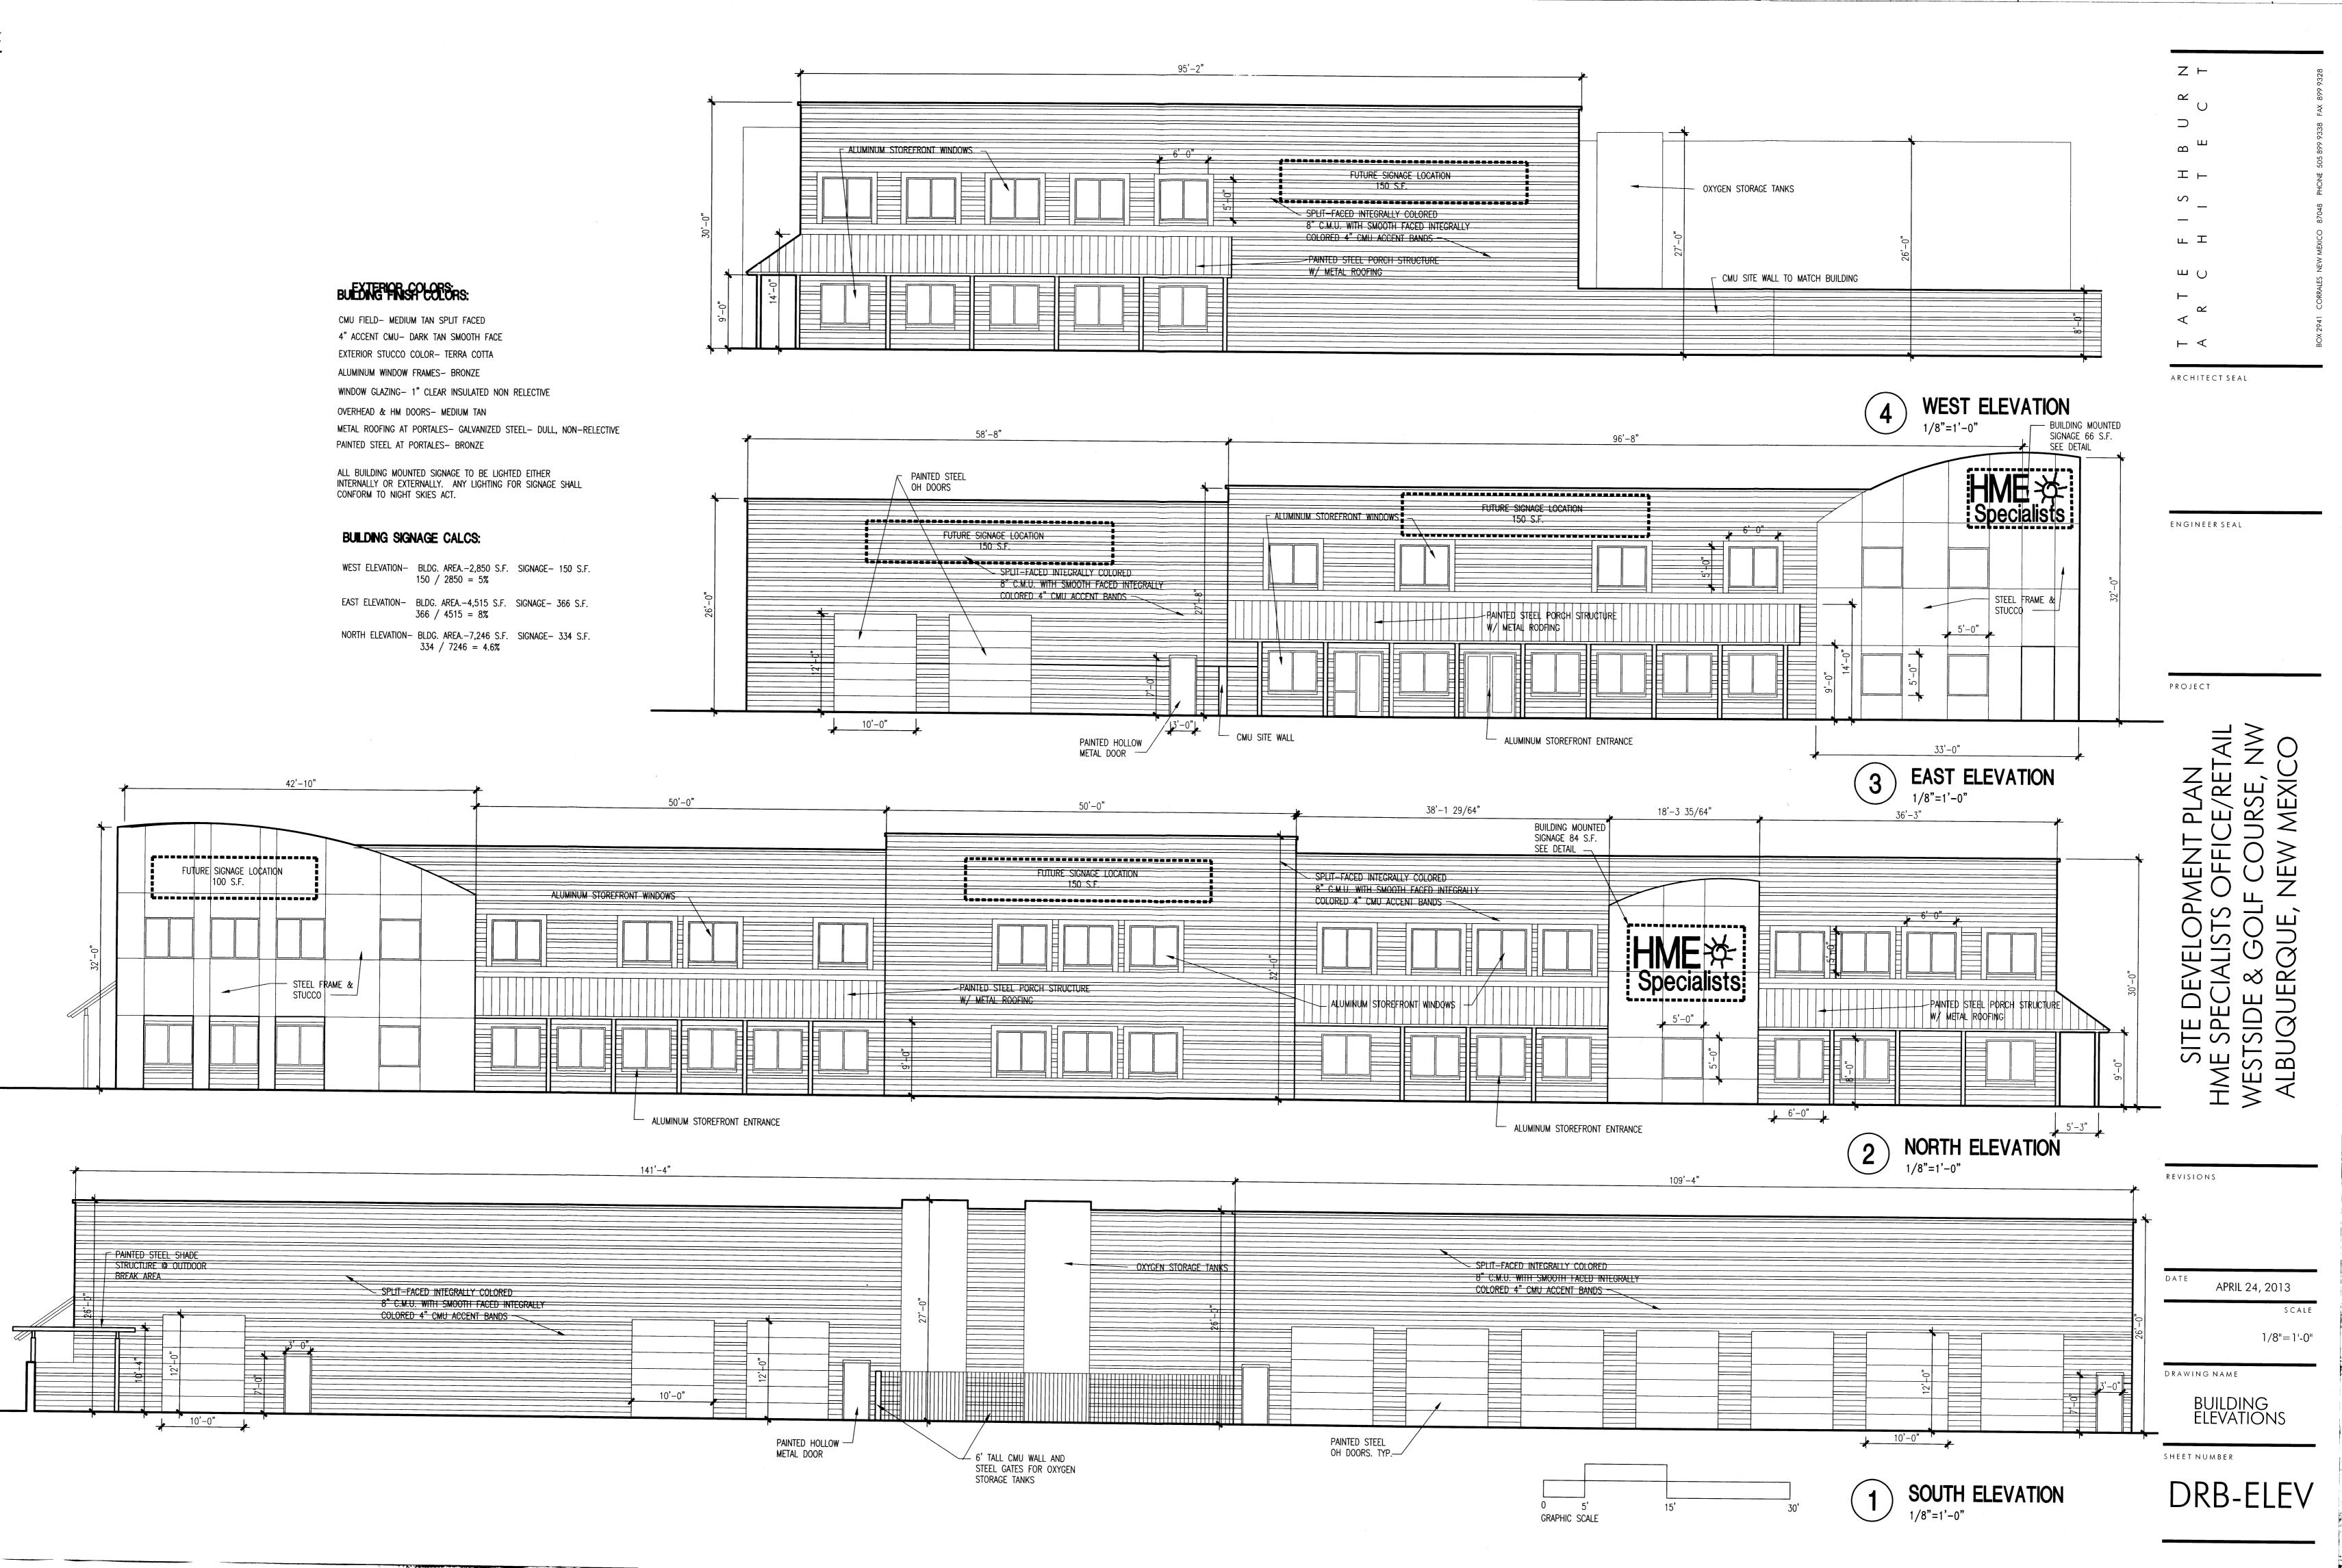

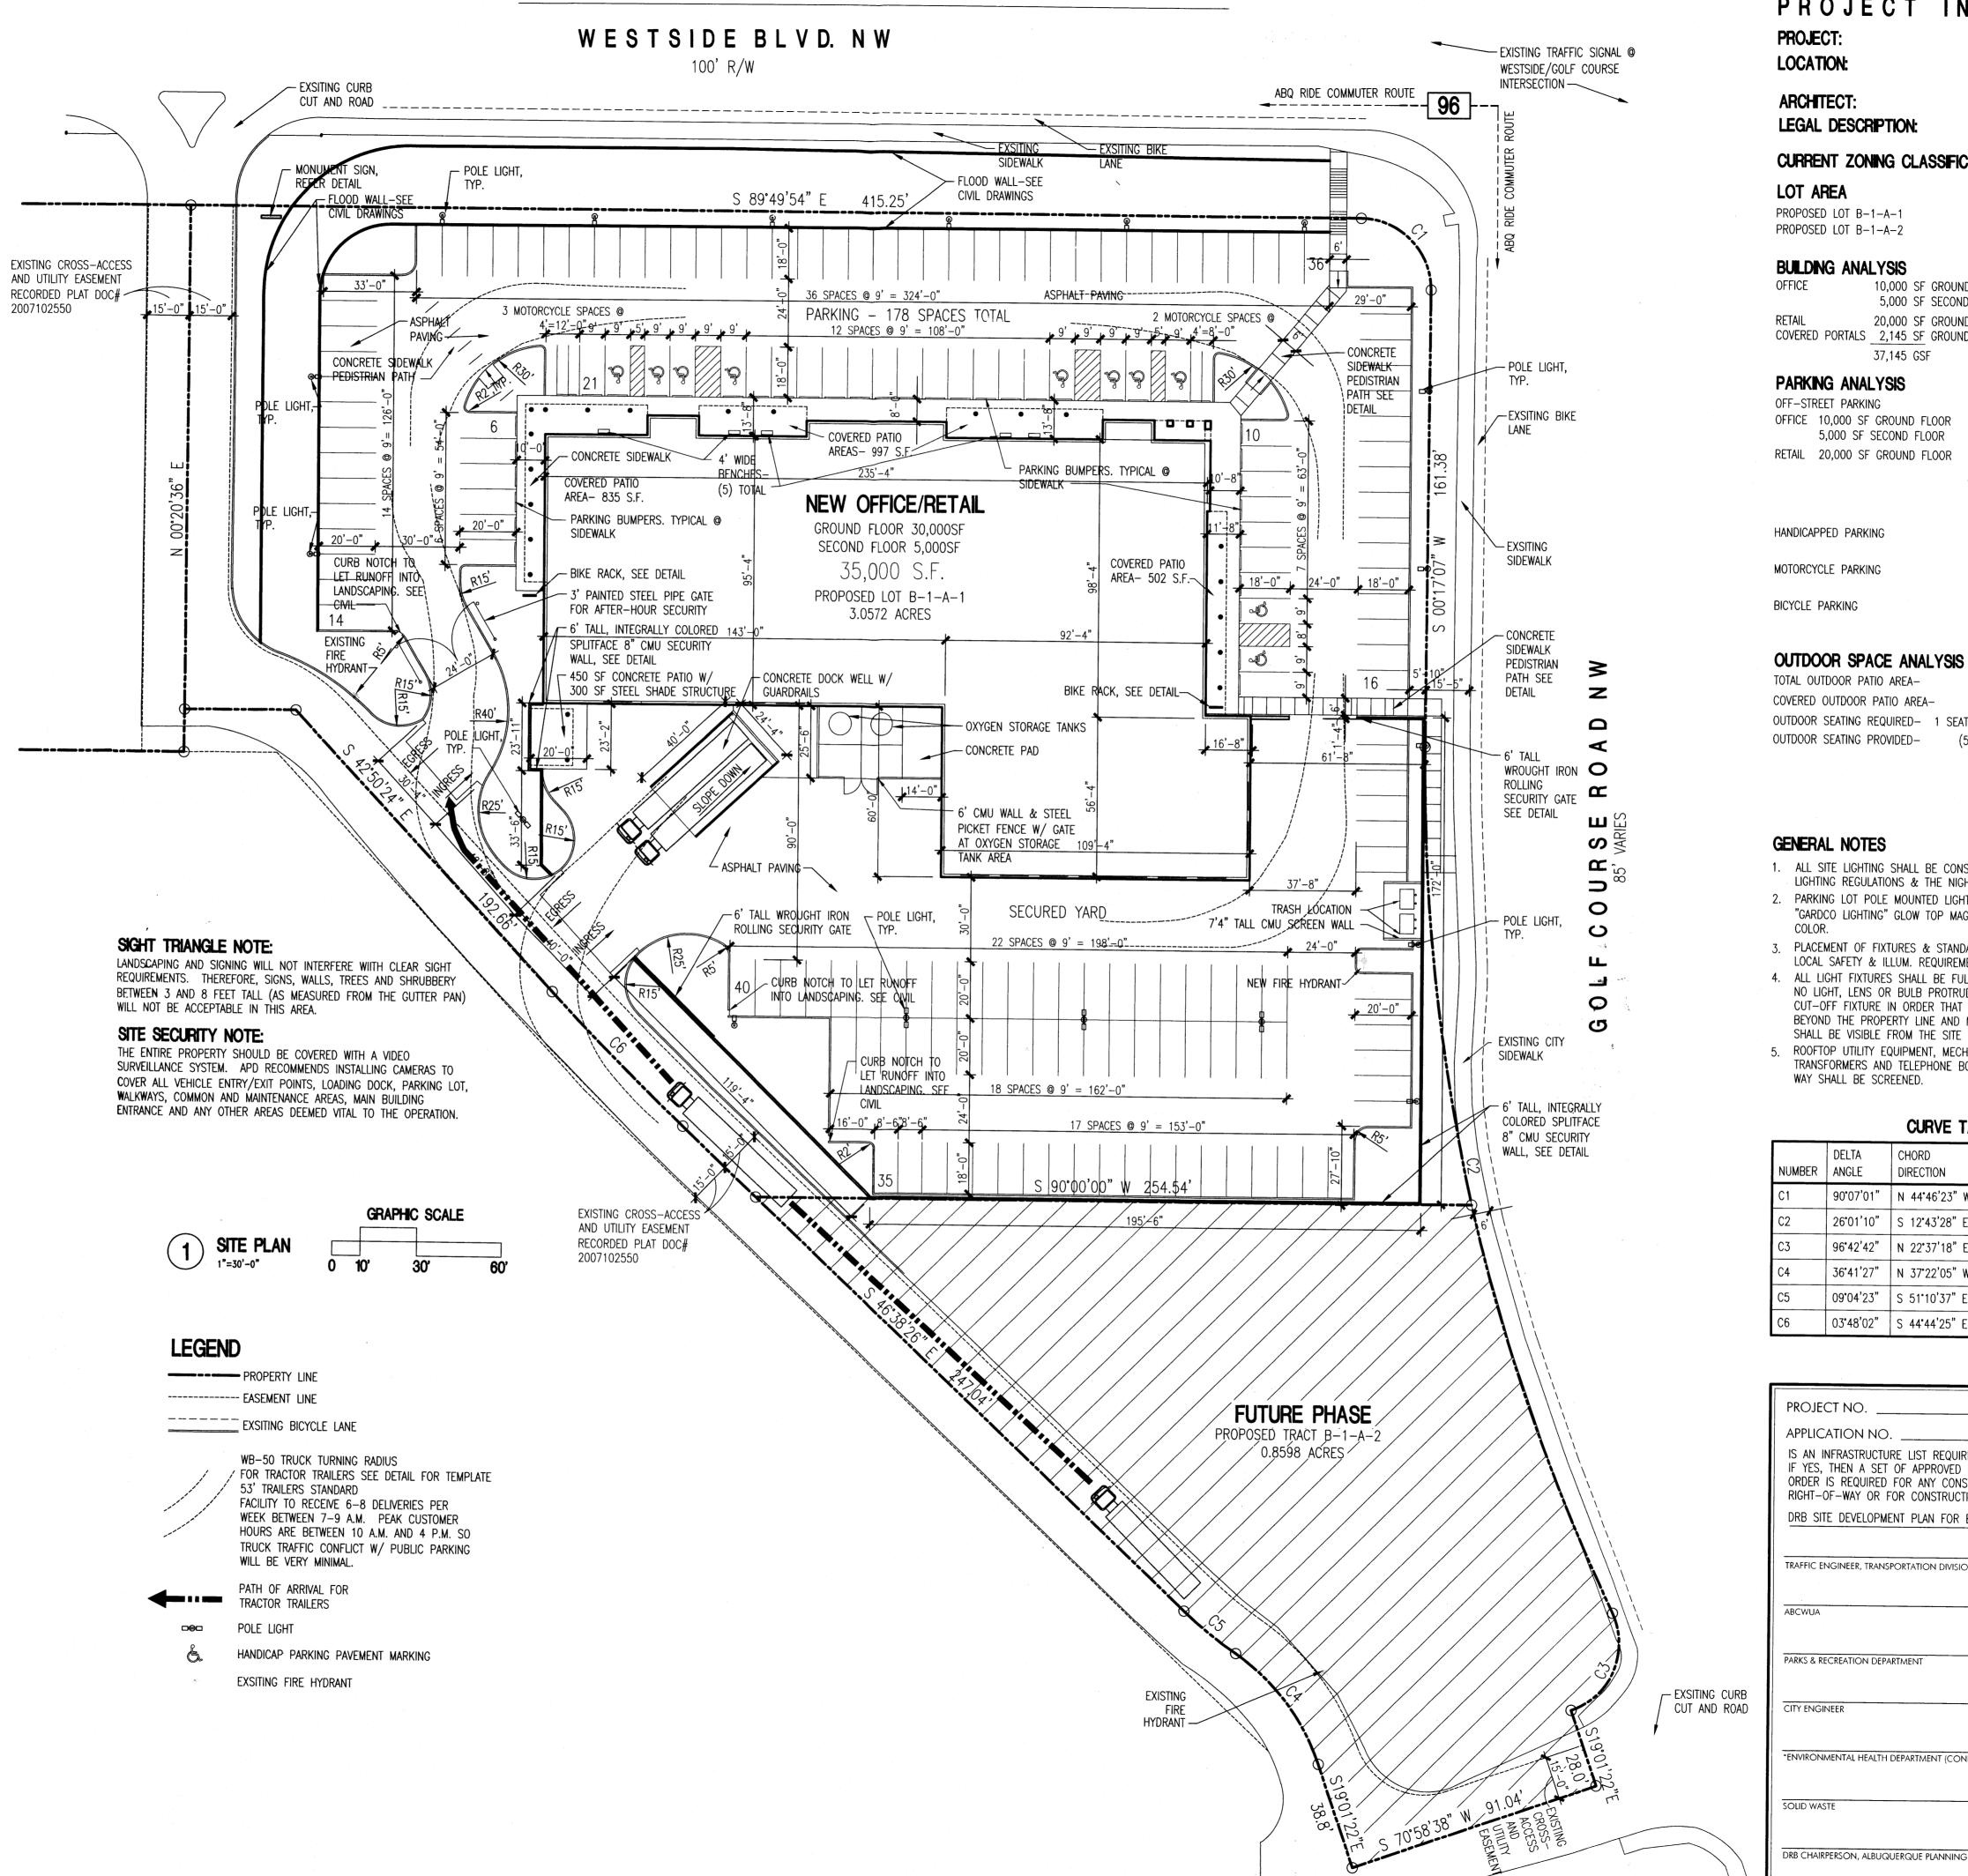

PROJECT INFORMATION

NEW OFFICE/RETAIL 10851 GOLF COURSE ROAD NW ALBUQUERQUE, NEW MEXICO TATE FISHBURN ARCHITECT LEGAL DESCRIPTION: LOT B-1-A BLACK ARROYO DAM CURRENT ZONING CLASSIFICATION: C-2(SC) PROPOSED LOT B-1-A-1 3.0572 ACRES PROPOSED LOT B-1-A-2 0.8598 ACRES 3.917 ACRES BUILDING ANALYSIS 10,000 SF GROUND FLOOR 5,000 SF SECOND FLOOR 20,000 SF GROUND FLOOR COVERED PORTALS 2,145 SF GROUND FLOOR 37,145 GSF

PARKING ANALYSIS OFF-STREET PARKING

1:200 = 50 SPACES5,000 SF SECOND FLOOR 1:300 = 17 SPACESRETAIL 20,000 SF GROUND FLOOR 1:200 FOR 15,000SF = 75 SPACES 1:250 FOR 5,000SF = 20 SPACES REQUIRED 162 SPACES PROVIDED 178 SPACES HANDICAPPED PARKING REQUIRED 8 SPACES PROVIDED 10 SPACES

TOTAL OUTDOOR PATIO AREA-5,063 S.F. COVERED OUTDOOR PATIO AREA-2,634 S.F. (52%) OUTDOOR SEATING REQUIRED- 1 SEAT PER 25 LFT= 236 / 25 = 9.44 OUTDOOR SEATING PROVIDED-(5) 48' BENCHES FOR 10 SEATS TOTAL

GENERAL NOTES

- 1. ALL SITE LIGHTING SHALL BE CONSITENT WITH SECTION 14-16-9, AREA LIGHTING REGULATIONS & THE NIGHT SKY ORDINANCE.
- 2. PARKING LOT POLE MOUNTED LIGHTING SHALL BE 15'-0" HIGH "GARDCO LIGHTING" GLOW TOP MAG 18-1 OR EQUAL IN EARTHTONE
- 3. PLACEMENT OF FIXTURES & STANDARDS SHALL CONFORM TO STATE & LOCAL SAFETY & ILLUM. REQUIREMENTS.
- 4. ALL LIGHT FIXTURES SHALL BE FULLY SHIELDED HORIZONTAL LAMPS W/ NO LIGHT, LENS OR BULB PROTRUDING BELOW THE BOTTOM OF THE CUT-OFF FIXTURE IN ORDER THAT NO FUGITIVE LIGHT SHALL ESCAPE BEYOND THE PROPERTY LINE AND NO SITE LIGHTING LIGHT SOURCE SHALL BE VISIBLE FROM THE SITE PERIMETER.
- 5. ROOFTOP UTILITY EQUIPMENT, MECHANICAL EQUIPMENT AND TRANSFORMERS AND TELEPHONE BOXES VIEWED FROM THE RIGHT OF WAY SHALL BE SCREENED.

CURVE TABLE

OUTVE TYDEE					
NUMBER	DELTA ANGLE	CHORD DIRECTION	RADIUS	ARC LENGTH	CHORD LENGTH
C1	90°07'01"	N 44°46'23" W	25.00	39.32	35.39
C2	26°01'10"	S 12°43'28" E	696.46	316.28	313.57
C3	96*42'42"	N 22°37'18" E	25.00	42.20	37.36
C4	36°41'27"	N 37°22'05" W	77.91	49.89	49.04
C5	09*04'23"	S 51°10'37" E	150.04	23.76	23.73
C6	03*48'02"	S 44°44'25" E	1000.37	66.36	66.34

PROJECT NO.	
APPLICATION NO.	
IS AN INFRASTRUCTURE LIST REQUIRED? () YES (IF YES, THEN A SET OF APPROVED DRC PLANS WITH ORDER IS REQUIRED FOR ANY CONSTRUCTION WITHIN RIGHT-OF-WAY OR FOR CONSTRUCTION OF PUBLIC IN	A WORK PUBLIC
DRB SITE DEVELOPMENT PLAN FOR BUILDING PERMIT:	
	-
TRAFFIC ENGINEER, TRANSPORTATION DIVISION	DAT
ABCWUA	DAT
PARKS & RECREATION DEPARTMENT	DAT
CITY ENGINEER	DATI
*ENVIRONMENTAL HEALTH DEPARTMENT (CONDITIONAL)	DATE
SOLID WASTE	DATE
DRB CHAIRPERSON, ALBUQUERQUE PLANNING DEPARTMENT	DATE

a m шΟ

ARCHITECT SEAL

1:20 REQUIRED 9 SPACES ENGINEERSEAL

REQUIRED 5 SPACES

PROVIDED 5 SPACES

PROVIDED 10 SPACES

PROJECT

SITE DEVELOPMENT PLAN HME SPECIALISTS OFFICE/RI WESTSIDE & GOLF COURSE ALBUQUERQUE, NEW MEXI Δ


REVISIONS

JUNE 7, 2013

1"=30'-0"

DRAWING NAME

SITE DEVELOPMENT PLAN FOR BUILDING PERMIT SHEET NUMBER

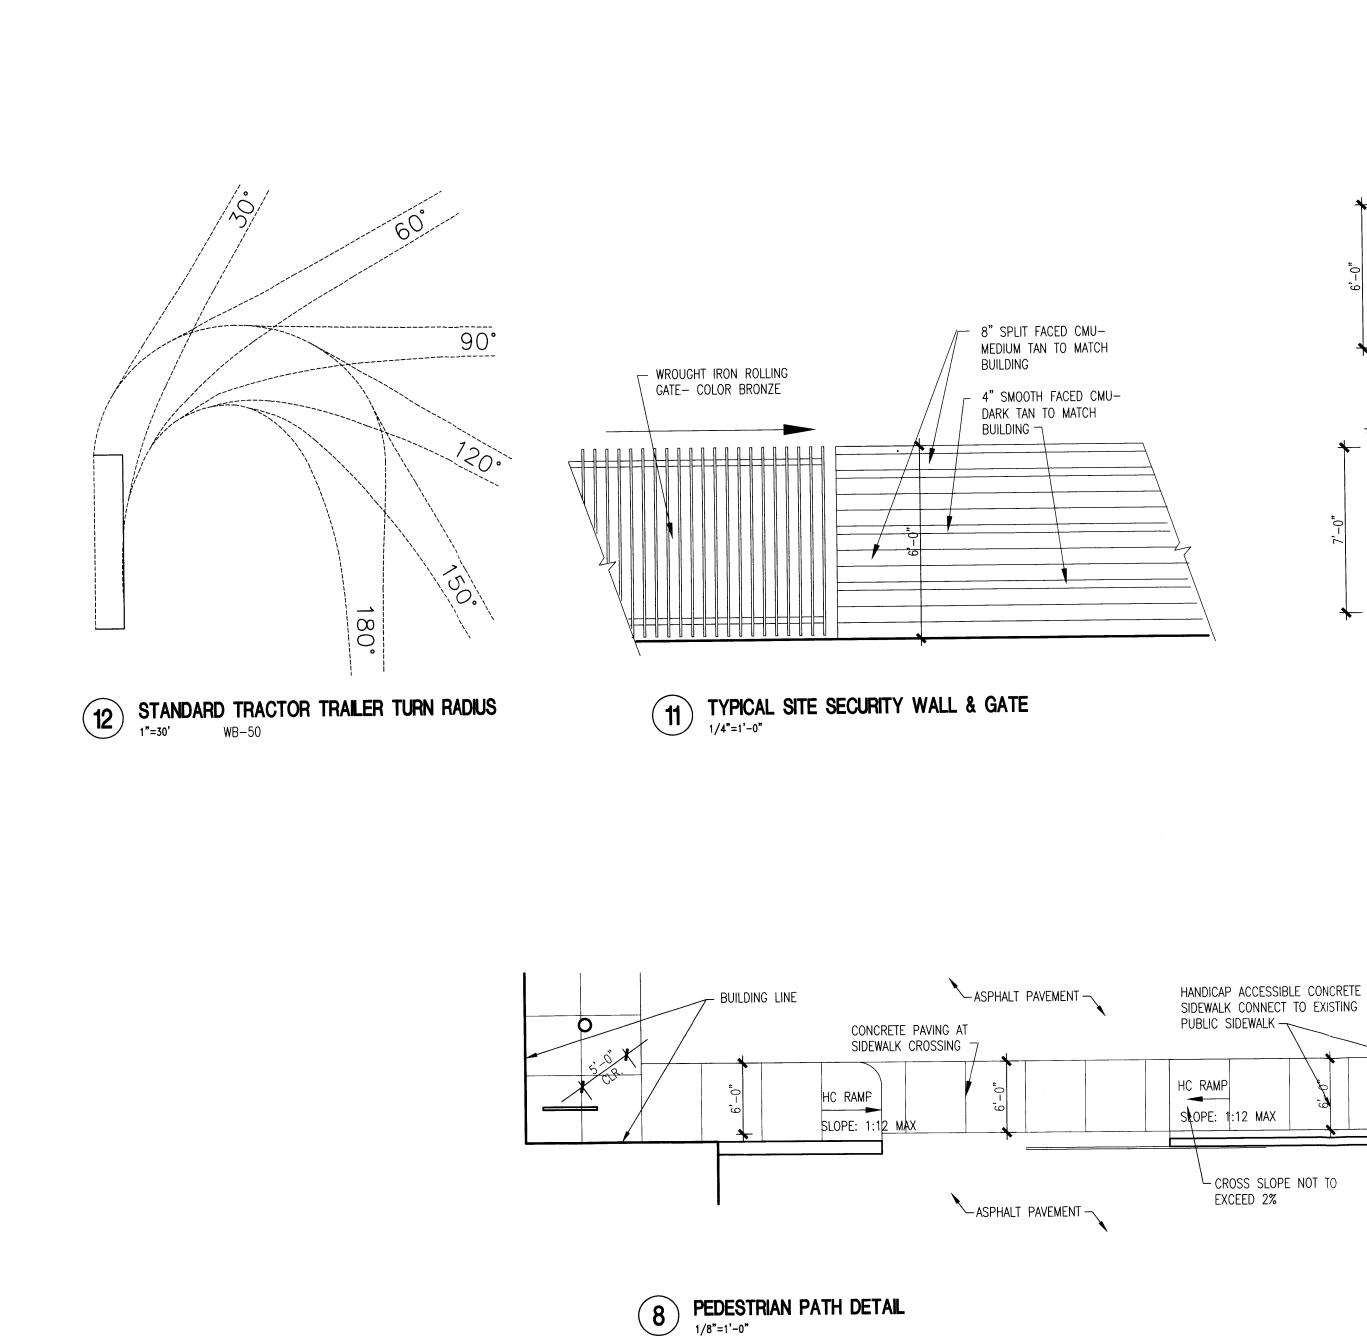

TYPICAL AT BOTH LOCATIONS

➤ FINISH GRADE

4 MONUMENT SIGN
N.T.S.

PAINTED METAL SIGN
W/INTERNALLY LIT LEXAN
SIGN PANELS 30 S.F.
COLOR- MEDIUM TAN

- CMU BASE TO

MEDIUM TAN

- CONCRETE FOOTING

MATCH BUILDING COLOR-

FULLY—SHIELDED
HORIZONTAL LAMP
COLOR— BRONZE

POLE COLOR- BRONZE

CONCRETE BASE

3 POLE LIGHT

المعارض والمراج والمعادي العرائية والأعطاط بيدار البينية والروازي

and the second s

4'-2"

5 BIKE POST DETAIL


- 2" DIA PIPE RAIL. PAINTED


— FINISH GRADE


OR CONCRETE


CONCRETE FOOTING

- SET POST PLUMB & LEVEL

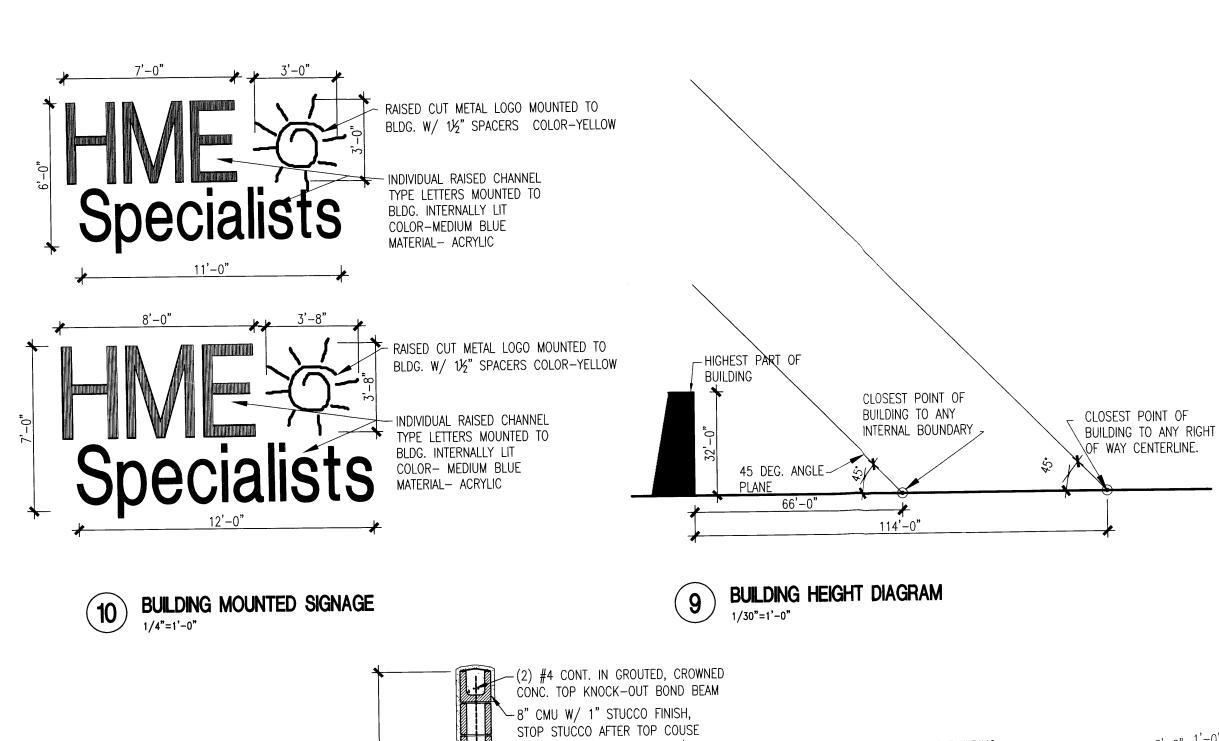

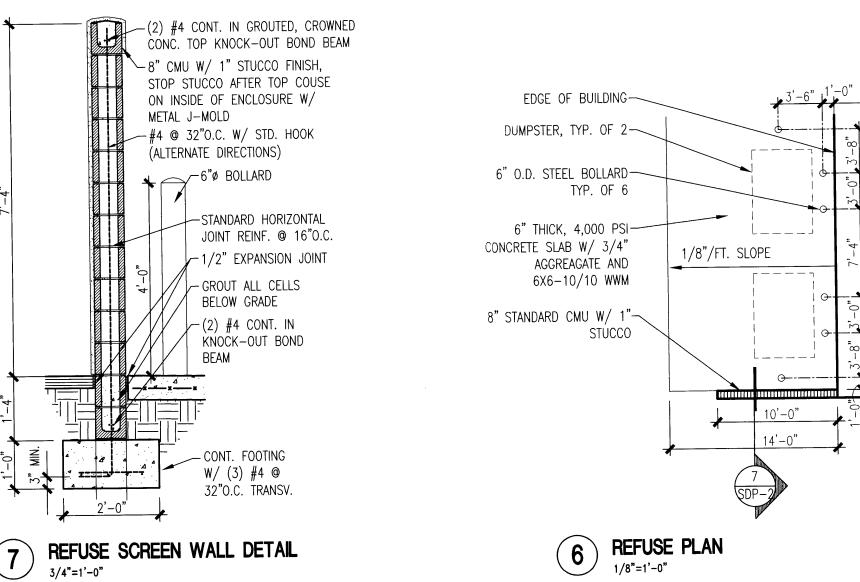

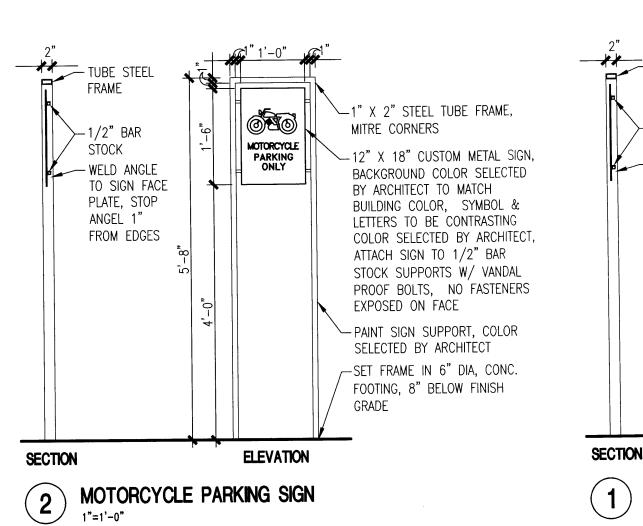

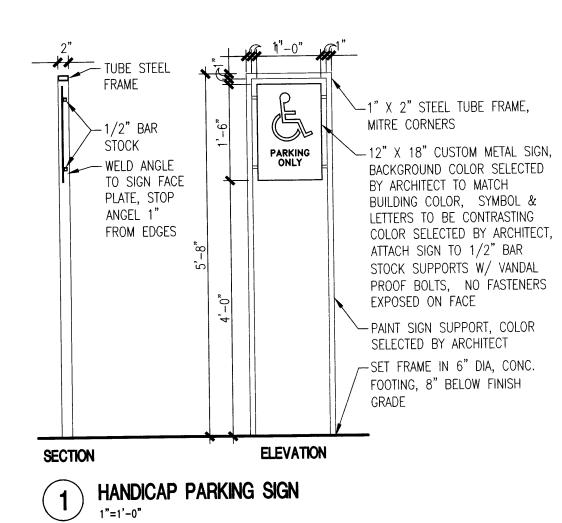

SITE DEVELOPMENT PLAN HME SPECIALISTS OFFICE/RETAIL WESTSIDE & GOLF COURSE, NW ALBUQUERQUE, NEW MEXICO

REVISIONS

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ARCHITECT SEAL

ENGINEER SEAL

PROJECT


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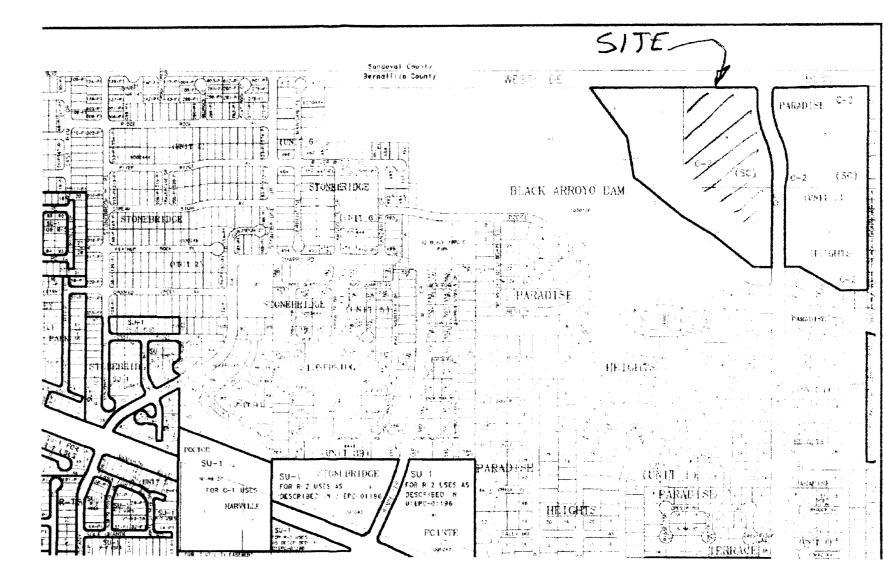
scale AS NOTED

SITE DEVELOPMENT
PLAN FOR BUILDING
PERMIT DETAILS


SHEET NUMBER

SDP-2



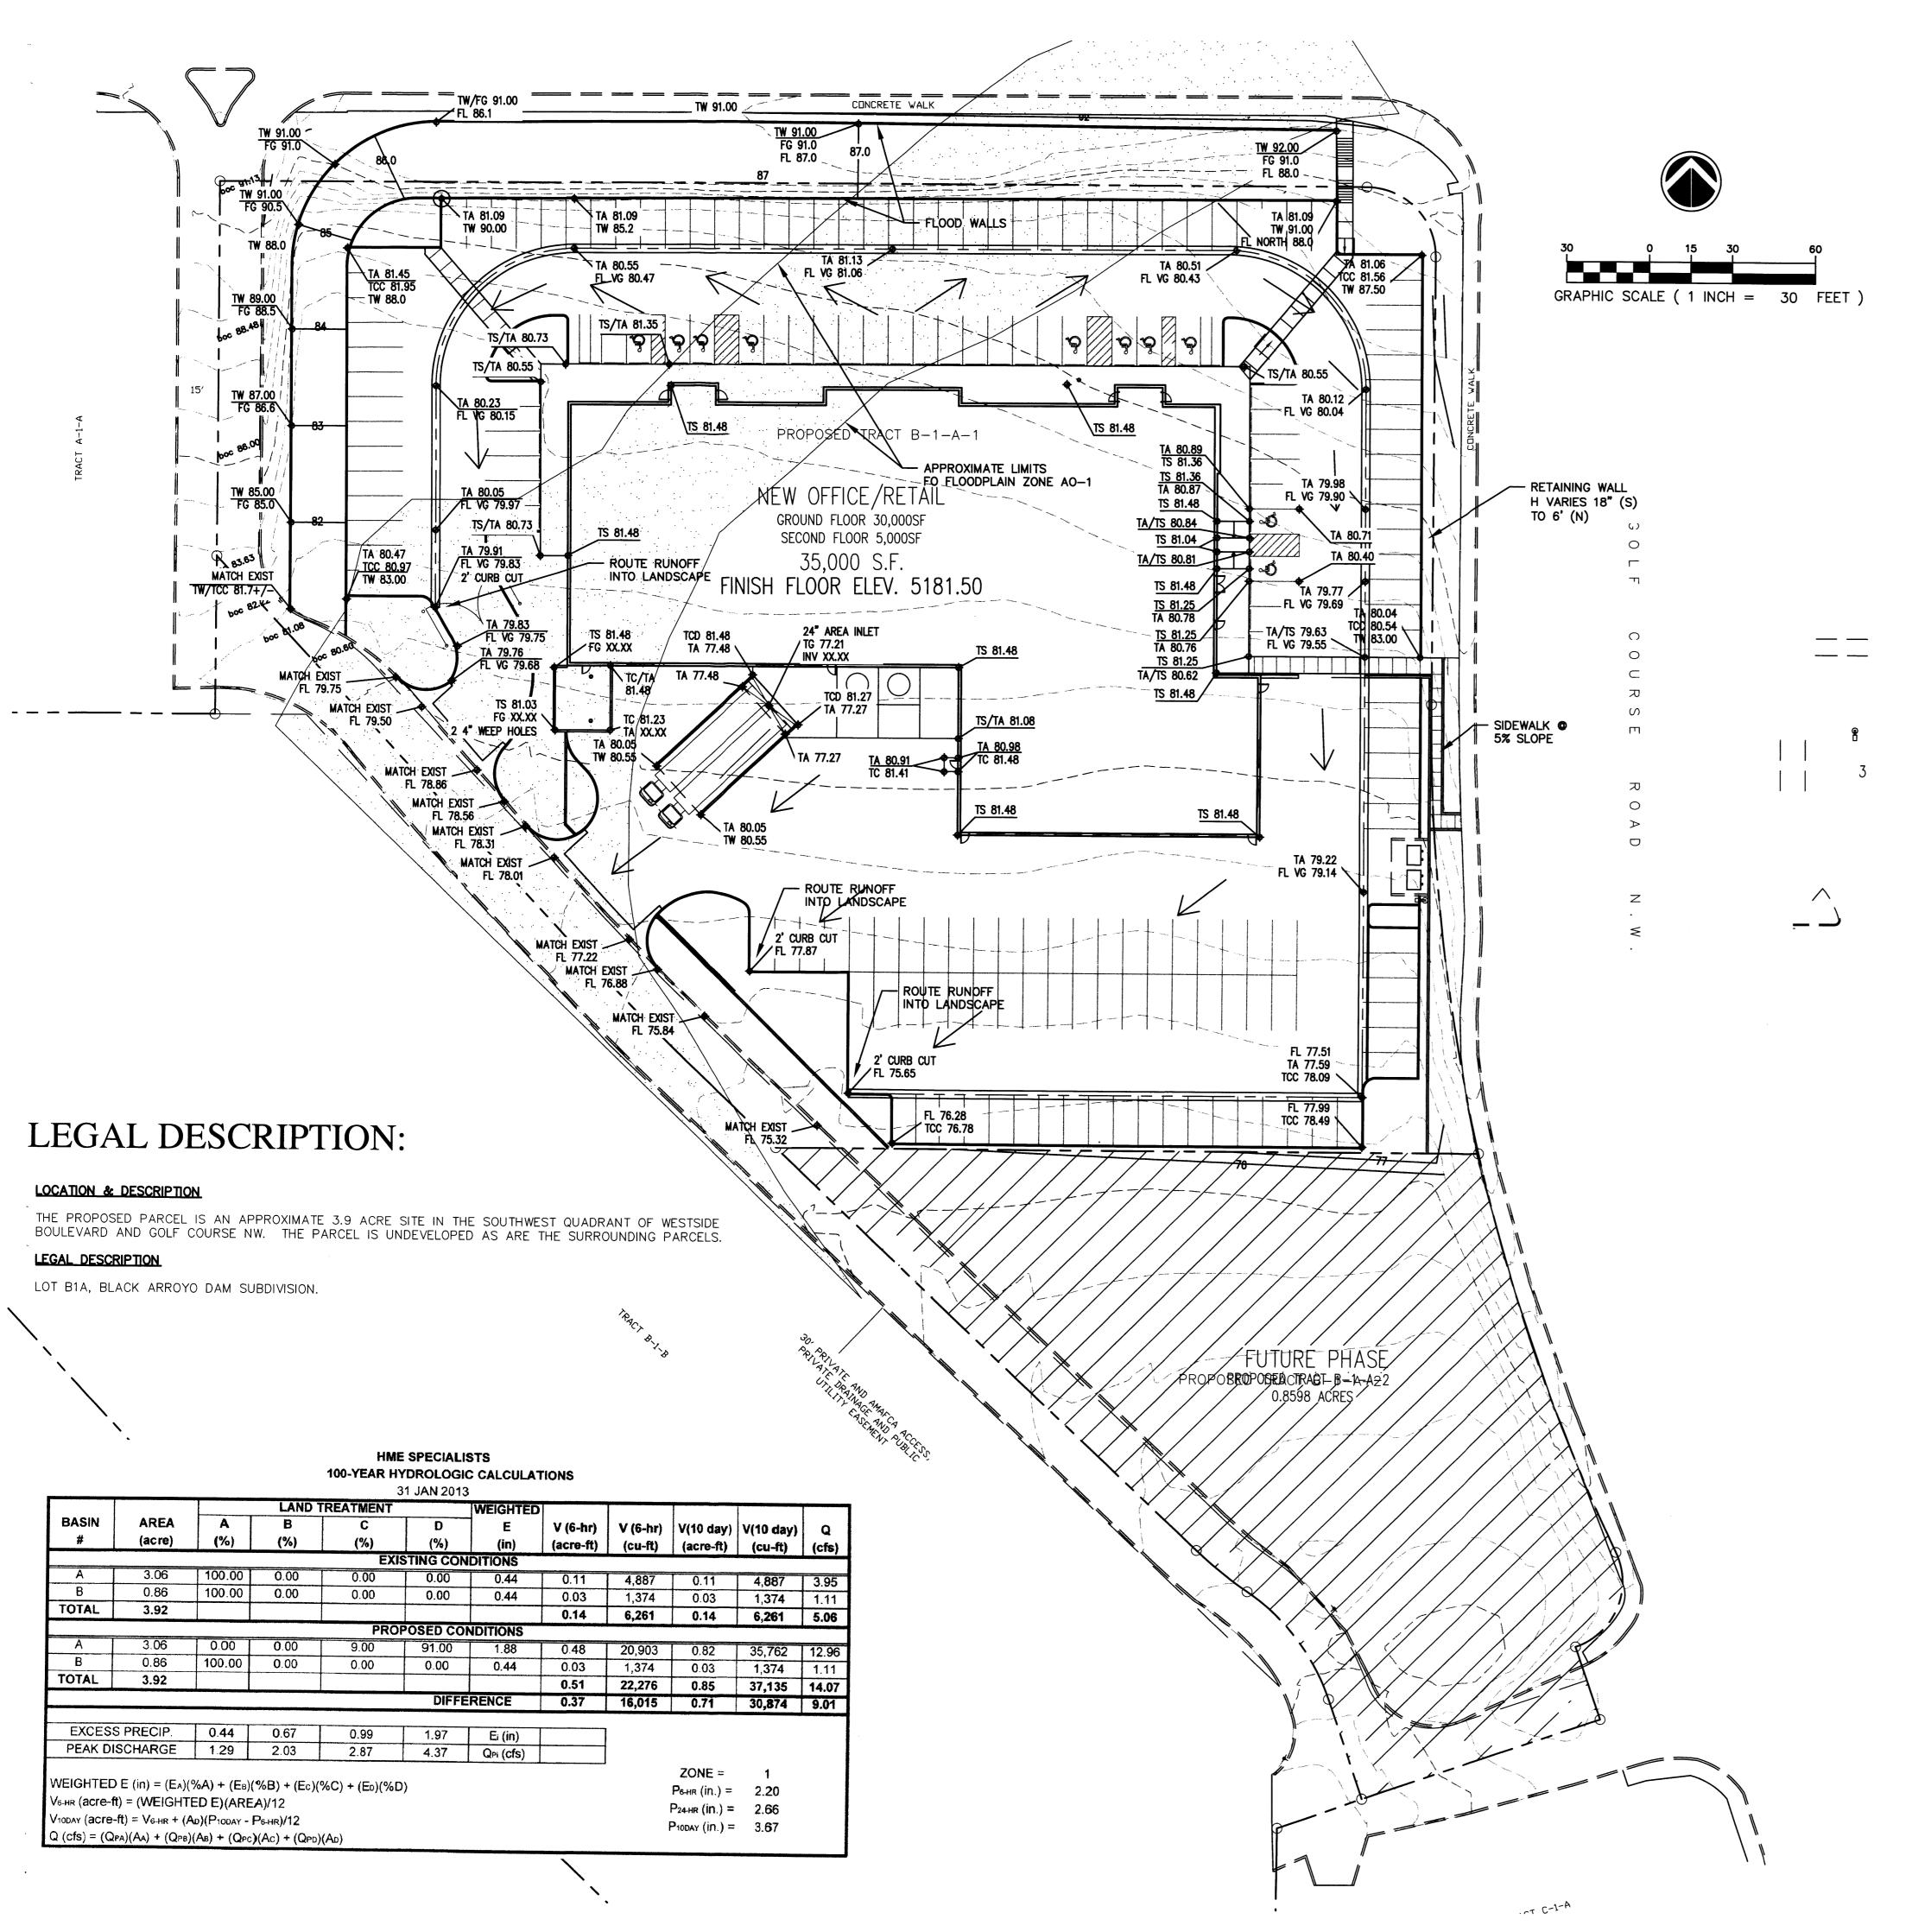

VICINITY MAP ZONE ATLAS PAGE A-12

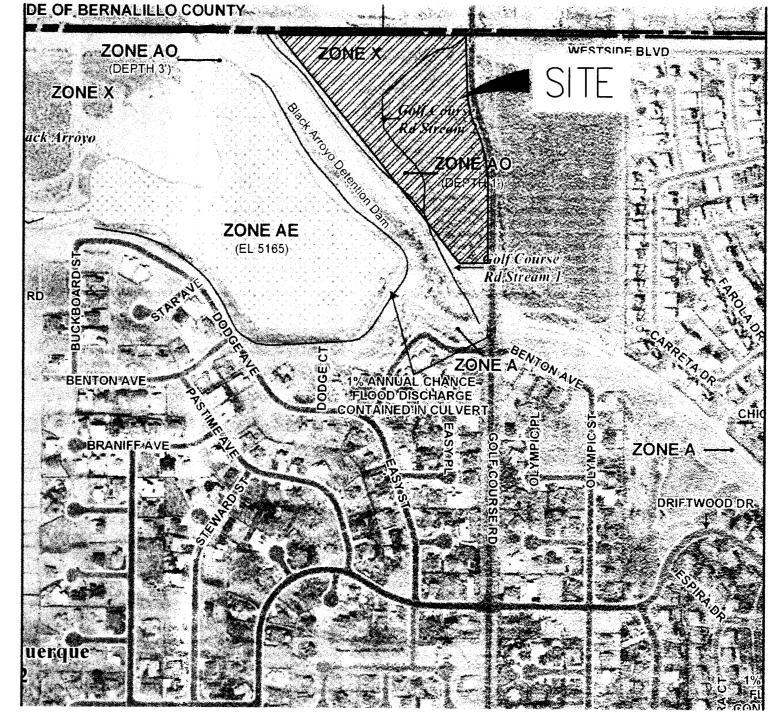

FIRM MAP PANEL 35001C0108G EFFECIVE DATE SEPT 26, 2008

DRAINAGE REPORT

HYDROLOGY

THE HYDROLOGY FOR THIS PROJECT WAS ANALYZED USING THE QUICK CALCULATIONS OF THE JUNE 1997 RELEASE OF THE CITY OF ALBUQUERQUE DEVELOPMENT PROCESS MANUAL, SECTION 22.2.

PRECIPITATION

THE 100-YR, 6-HR STORM EVENT WAS USED AS THE DESIGN STORM FOR THIS ANALYSIS. THE SITE LIES WITHIN THE ZONE 1 PRECIPITATION AREA FOR THE CITY OF ALBUQUERQUE, AS IDENTIFIED IN THE CITY OF ALBUQUERQUE DEVELOPMENT PROCESS MANUAL, SECTION 22.2. THEREFORE, TABLES WITHIN THIS SECTION WERE USED TO ESTABLISH THE EXCESS PRECIPITATION AND PEAK DISCHARGE.

EXISTING DRAINAGE

THE SITE AS IT CURRENTLY EXISTS HAS A RELATIVELY UNIFORM NORTH TO SOUTH SLOPE OF APPROXIMATELY 3.3%. RUNOFF MODE IS SHALLOW SHEET FLOW. PER THE EXISTING FLOOD RATE INSURANCE MAP, THE IS AN AO-1 FLOOD PLAIN ON SITE FROM THE NORTHEAST CORNER TOWARD THE SOUTHWEST THEN SOUTH PARALLELING THE WEST PROPERTY LINE OF THIS PARCEL. THIS DISCUSSION ACKNOWLEDGES THE FLOODPLAIN IS NOTED ON THE MAP BUT ALSO REALIZES A LETTER OF MAP REVISION (LOMR) HAS BEEN SUBMITTED TO REVISE THE MAP BASED ON STORMWATER CONTROL FACILITIES RECENTLY CONSTRUCTED UPSTREAM OF THIS PARCEL. STORMWATER GENERATED FROM THIS SITE DISCHARGES ON THE SOUTH END OF THE SITE TO THE LOWER END OF THE BLACK ARROYO DAM.

DEVELOPED CONDITION


THE PROPOSED GRADING FOR THIS PROJECT GENERALLY CONTINUES THE PATTERN OF THE EXISTING STORMWATER RUNOFF EXCEPT THAT THE RUNOFF FROM THE NORTHERN PORTION OF THE SITE IS ROUTED AROUND THE BUILDING IN THE PAVED PARKING LOT. ONCE SOUTH OF THE BUILDING THE RUNOFF TAKES TWO PATHS. THE RUNOFF FROM THE WESTERN PORTION OF THE SITE FLOWS WEST THROUGH THE NORTHERN DRIVEPAD TO THE NEW PRIVATE ROAD THAT CONVEYS THE RUNOFF SOUTH TO THE SOUTHERN END OF THE BLACK ARROYO DAM. RUNOFF FROM THE EASTERN PORTION OF THE SITE SHEET FLOW SOUTH, ON THE PROPOSED PARKING LOT PAVEMENT, WHERE IT ULTIMATELY DISCHARGES FROM THE SITE INTO THE NEW PRIVATE ROAD DISCUSSED ABOVE. IN ORDER TO REDUCE THE RETAINING WALL HEIGHT ALONG THE NORTH PROPERTY LINE, THIS PLAN PROPOSES SLOPING FROM 10' BEYOND THE FACE OF THE CURB (STANDARD DISTANCE) TO THE RETAINING WALL FACE AT A SLOPE OF 4:1. THIS SLOP WILL BE LANDSCAPED. THE 10' FROM THE FACE OF CURB TO THE GRADE BREAK LINE (10') SLOPE TO THE CURB AS THE STANDARD 2%. IT IS THE INTENT OF THIS GRADING PLAN TO DEPRESS LANDSCAPE AREAS ALONG THE WEST SIDE OF THE SITE AND ROUTE THE RUNOFF FROM THE PAVED AREAS THROUGH THOSE LANDSCAPE AREAS AS A WATER HARVESTING MEASURE..

ENGINEER SEAL

SILE DEVELOPMENT PLAN AME SPECIALISTS OFFICE/RETAIL NESTSIDE & GOLF COURSE, NW ALBLIQLIFROLF NFW MFXICO

REVISIONS

MAY 7, 2013

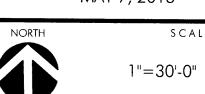


RAWING NAME

CONCPTUAL GRADING PLAN

SHEET NUMBER

C0.1

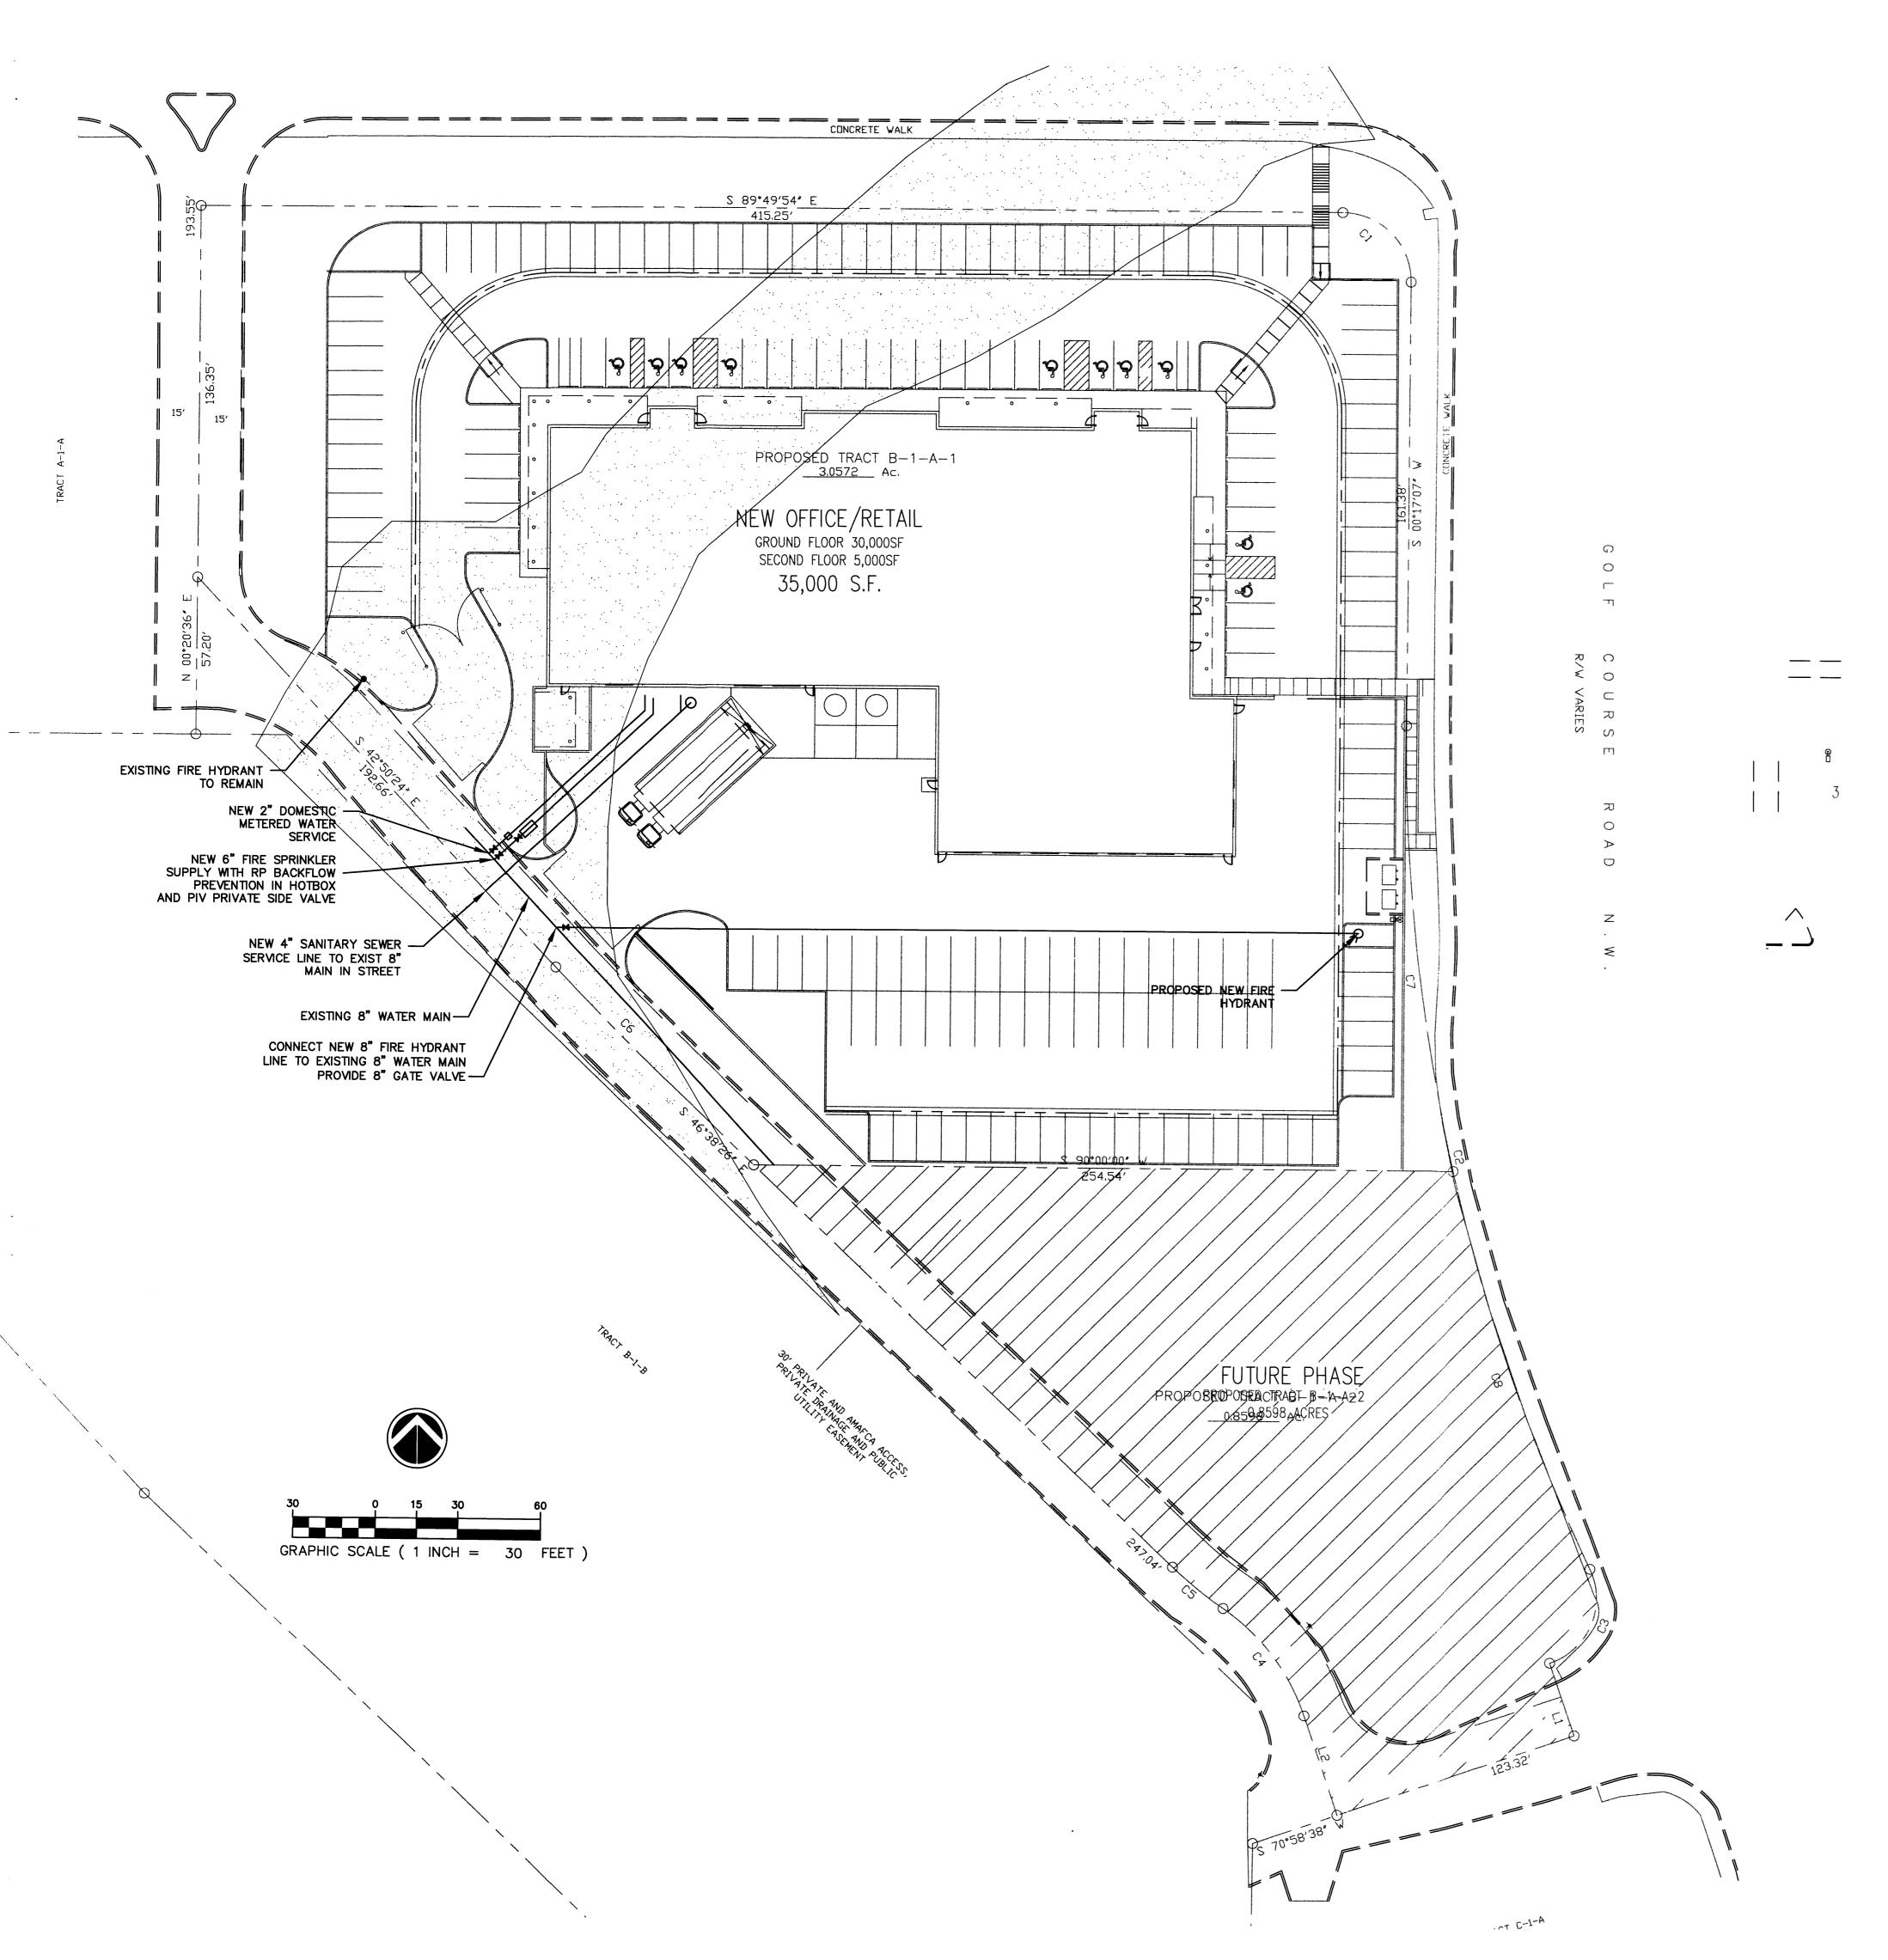

and a graph of the second control of

PUBLIC SERVICE COMPANY CONDITIONS

SCREENING SHOULD BE INSTALLED TO ALLOW FOR ACCESS TO UTILITY FACILITIES. ALL SCREENING AND VEGITATION SURROUNDING GROUND MOUNTED TRANSFORMERS AND UTILITY PADS ARE TO ALLOW 10-FEET OF CLEARANCE IN FRONT OF THE EQUIPMENT DOOR AND 5 TO 6-FEET OF CLEARANCE ON THE REMAINING THREE SIDES FOR SAFE OPERATION, MAINTENANCE AND REPAIR PURPOSES. PLEASE REFER TO THE PNM ELECTRIC SERVICE GUIDE AT WWW. PNM.CON FOR SPECIFICATIONS.

TATEFISHBURNN

ARCHITECT SEAL

ENGINEER SEAL

PROJECT

SITE DEVELOPMENT PLAN
HME SPECIALISTS OFFICE/RETAIL
WESTSIDE & GOLF COURSE, NW

REVISIONS

JUNE 7, 2013

NORTH S C A




1"=30'-0"

DRAWING NAME

CONCPTUAL WATER/SEWR PLAN

SHEET NUMBER

C0.2

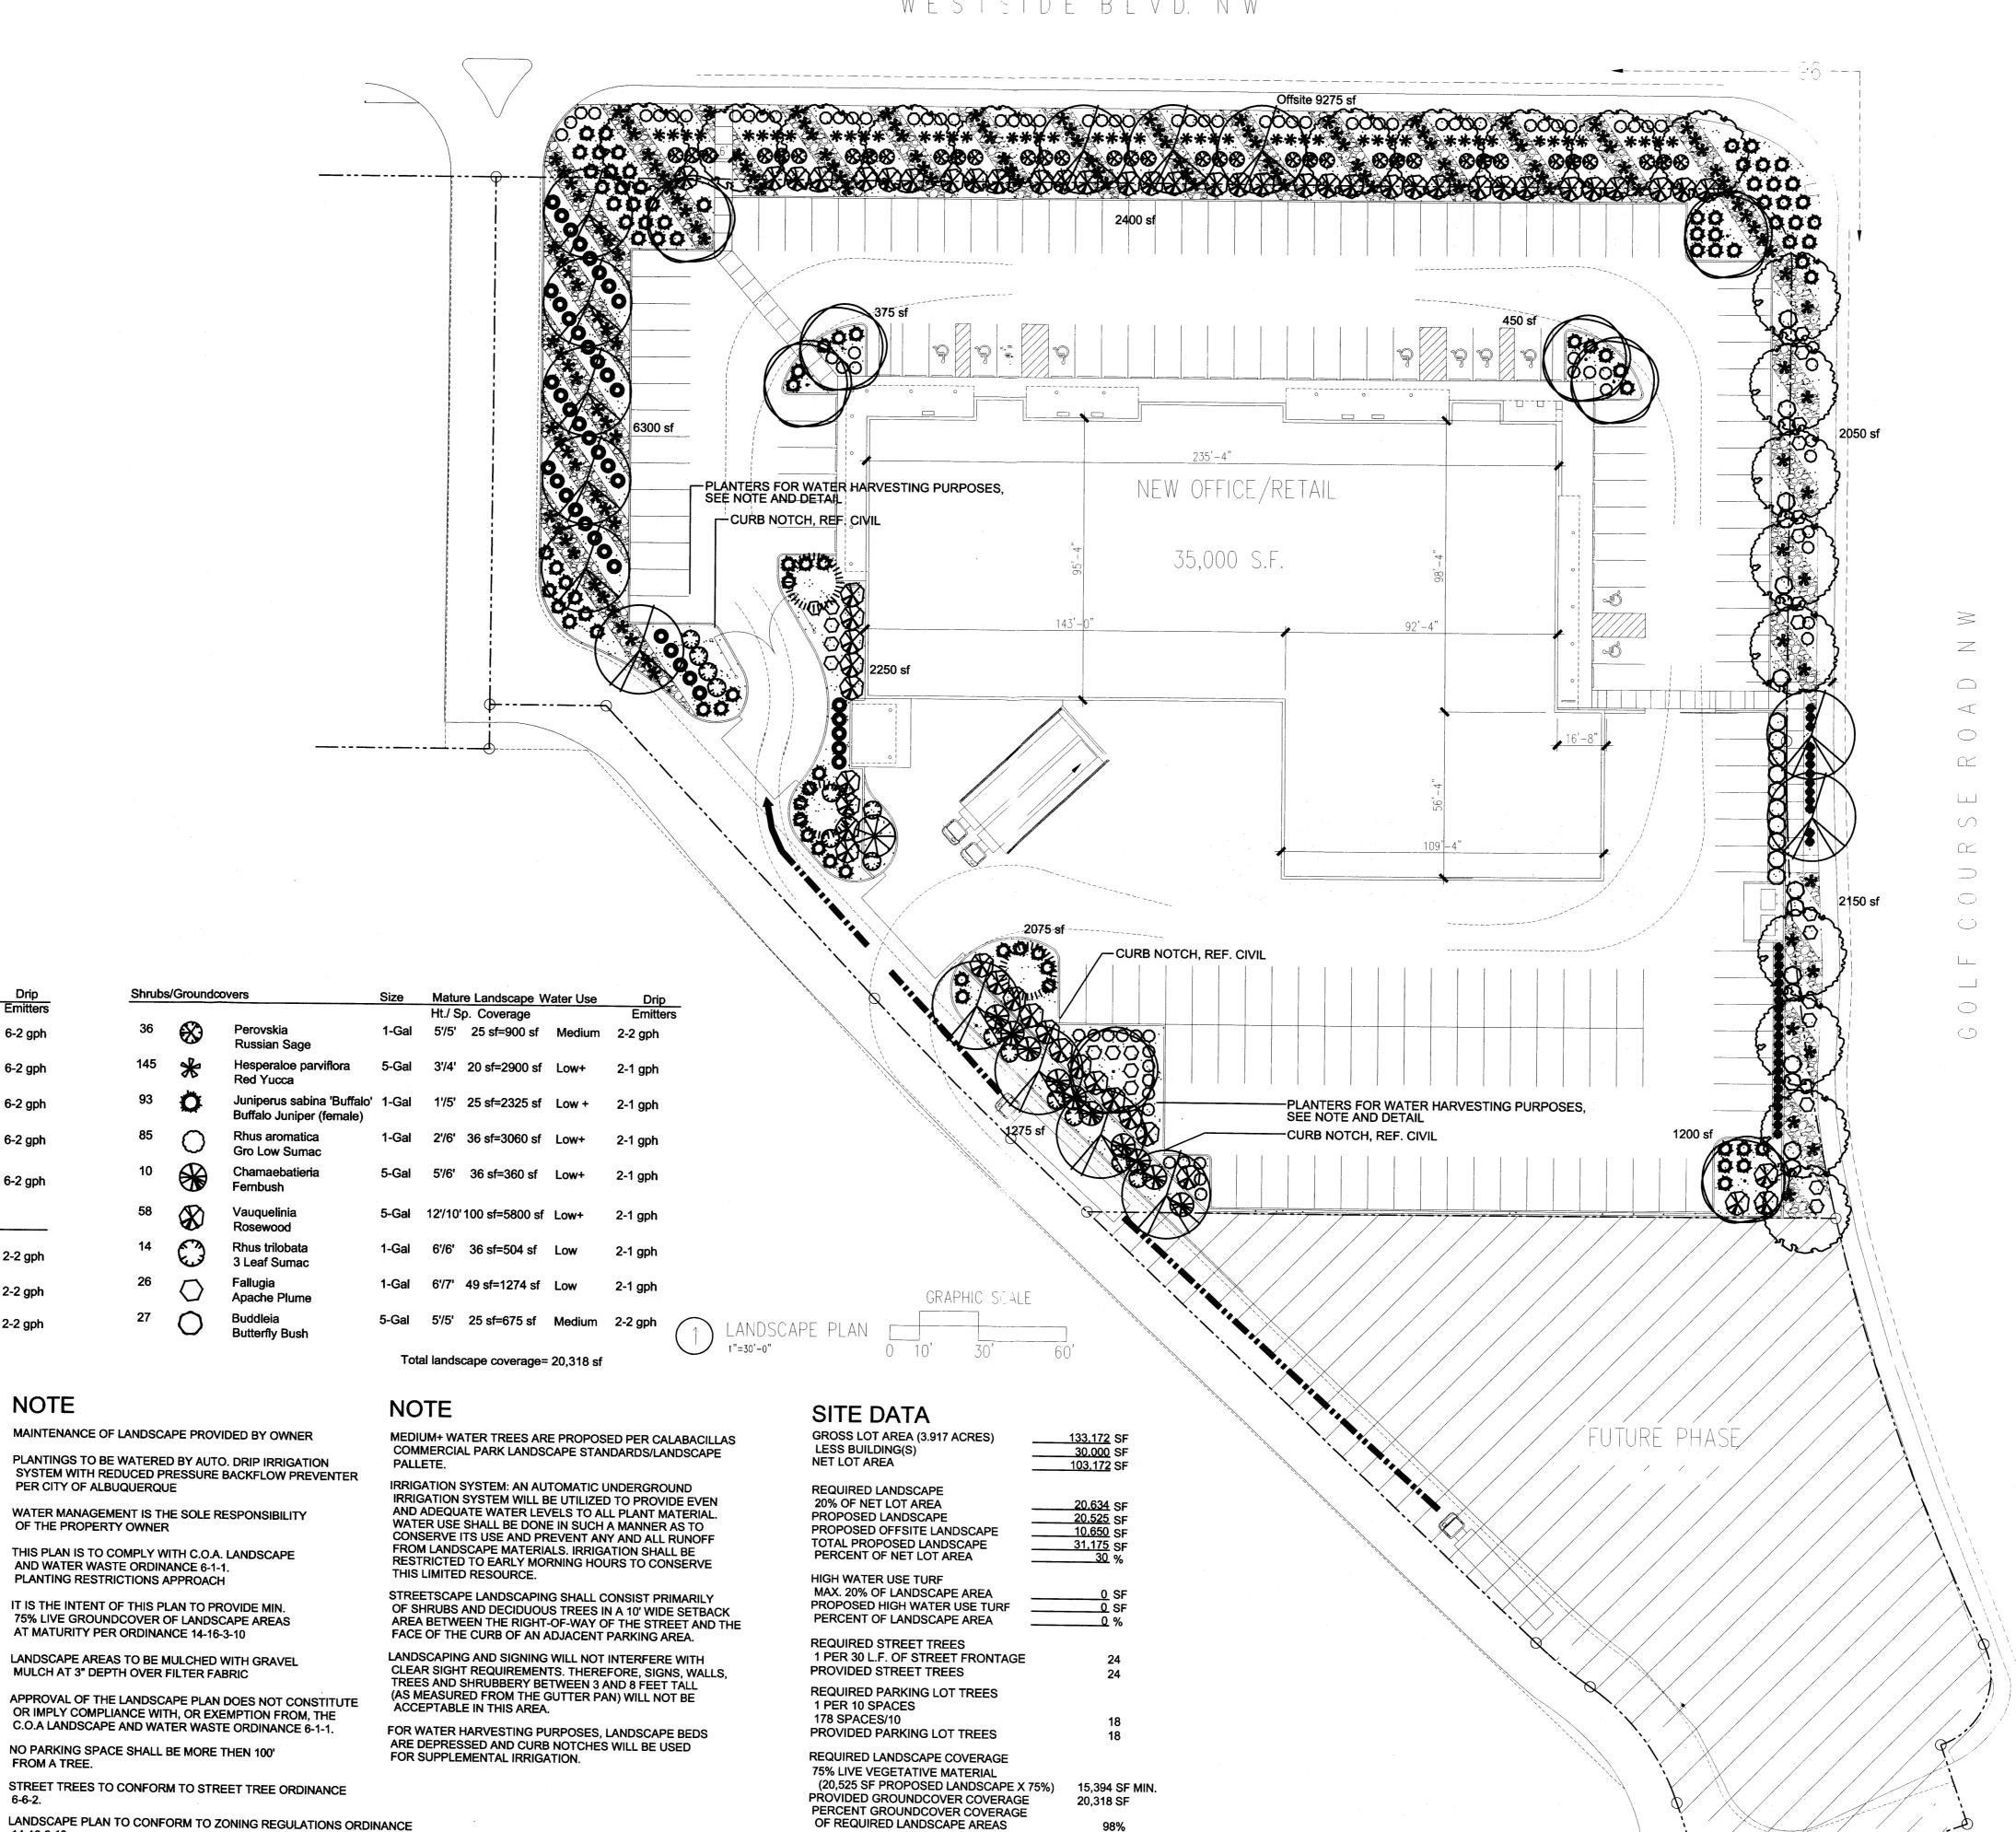

PLANT LEGEND

Scientific Name

Common Name

Chinese Pistache

Fraxinus velutina

Arizona Ash

Pinus nigra

Vitex

Grasses

Austrian Pine

Chaste Tree

Maiden Grass

Muhlenbergia

Calamagrotis

A MINIMUM OF 80% OF THE PLANTINGS TO BE

A MAXIMUM OF 20% OF THE LANDSCAPE AREA TO BE

BROWN CRUSHER FINES

LOW OR MEDIUM WATER USE PLANTS

MATERIALS LEGEND

HIGH WATER USE TURF

Regal Mist Grass

Karl Foerster Grass

PLANTING RESTRICTIONS APPROACH

SAN LAZARUS GOLD 2"-4" COBBLESTONE

Size Mature Landscape Water Use

15-Gal 20'/20' 400 sf=400 sf Medium 6-2 gph

5'/5' 25 sf=1050 sf Medium

Medium + 6-2 gph

NOTE

FROM A TREE.

PER CITY OF ALBUQUERQUE

OF THE PROPERTY OWNER

THIS PLAN IS TO COMPLY WITH C.O.A. LANDSCAPE

IT IS THE INTENT OF THIS PLAN TO PROVIDE MIN.

75% LIVE GROUNDCOVER OF LANDSCAPE AREAS

LANDSCAPE AREAS TO BE MULCHED WITH GRAVEL

AND WATER WASTE ORDINANCE 6-1-1.

PLANTING RESTRICTIONS APPROACH

AT MATURITY PER ORDINANCE 14-16-3-10

MULCH AT 3" DEPTH OVER FILTER FABRIC

NO PARKING SPACE SHALL BE MORE THEN 100'

(see note)

15 sf=720 sf Medium 2-2 gph

Shrubs/Groundcovers

Fernbush

Vauquelinia

Fallugia

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Albuquerque, NM 87184
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505.898.2105 (fax)
design@hulc.com
www.headsuplandscape.com

ARCHITECT SEAL

ENGINEER SEAL

REVISIONS

5/29/13 5/22/13 4/24/13 4/17/13 4/11/13 2/27/13


DAT JANUARY 31, 2013




DRAWING NAME

SHEET NUMBER

LANDSCAPE PLAN

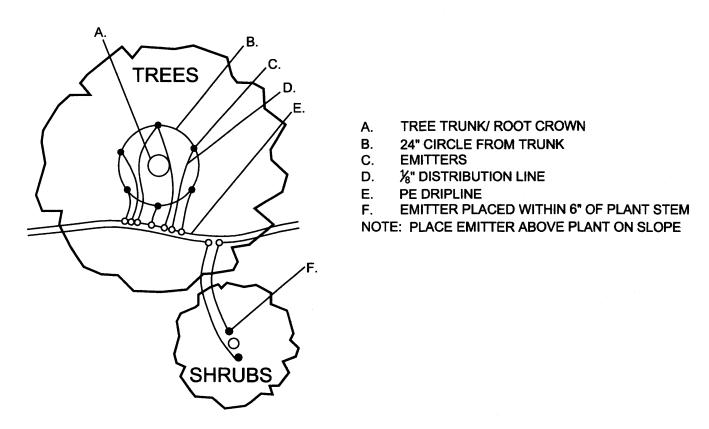

EMITTER PLACEMENT DETAIL

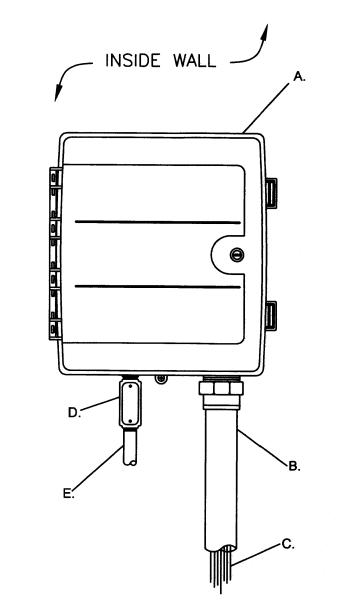


- A. WALL MOUNT CONTROLLER


 B 2" PVC SCH 40 CONDUIT AND FITTIN
- B. 2" PVC SCH 40 CONDUIT AND FITTINGSC. WIRES TO REMOTE CONTROL VALVES
- D. JUNCTION BOXE. 1" PVC SCH 40 CONDUIT AND FITTINGS TO POWER SUPPLY

A. BROOKS PRODUCTS INC. 1419-18


CONTROLLER DETAIL

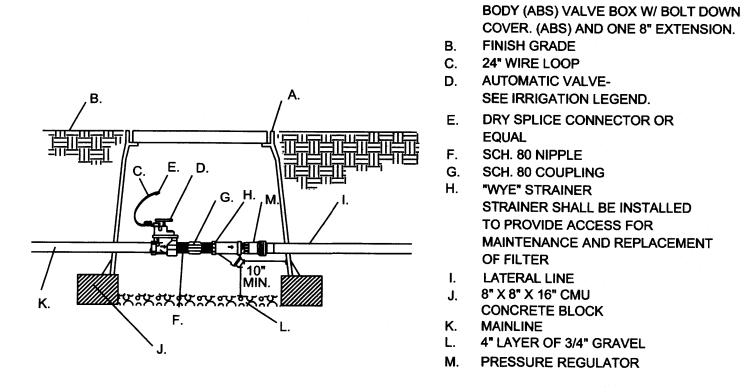


DRIP VALVE DETAIL

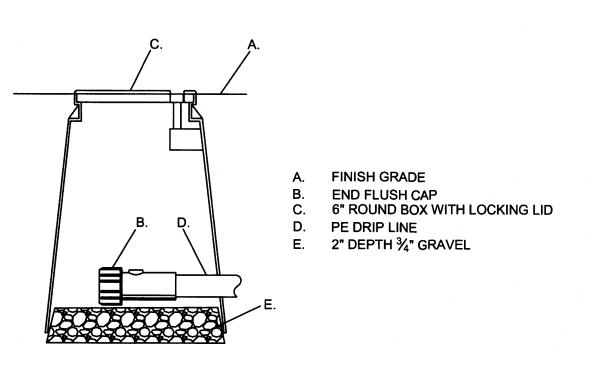


END FLUSH CAP DETAIL

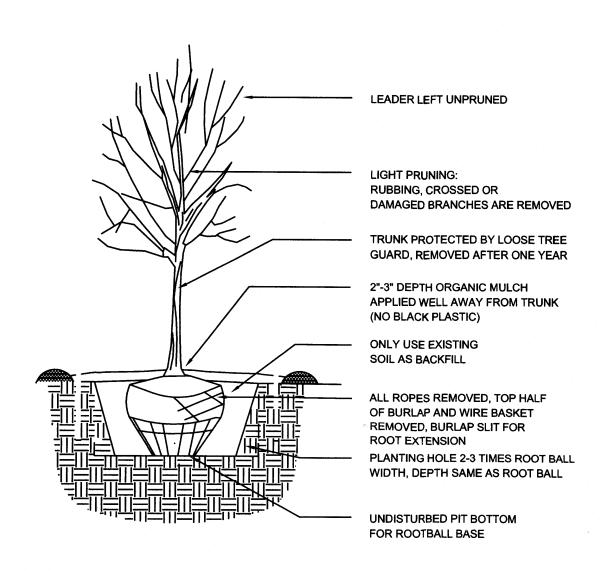


TREE PLANTING DETAIL

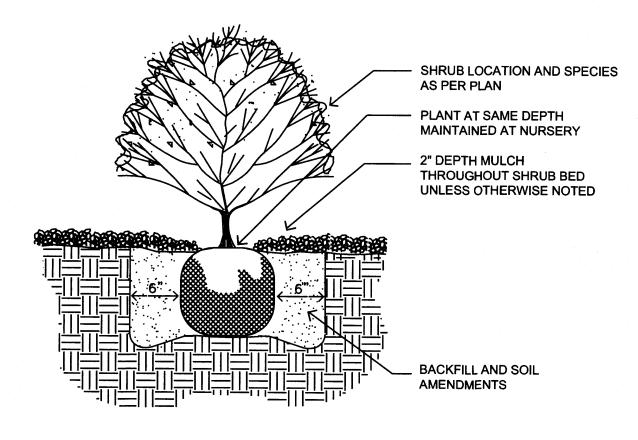


SHRUB PLANTING DETAIL

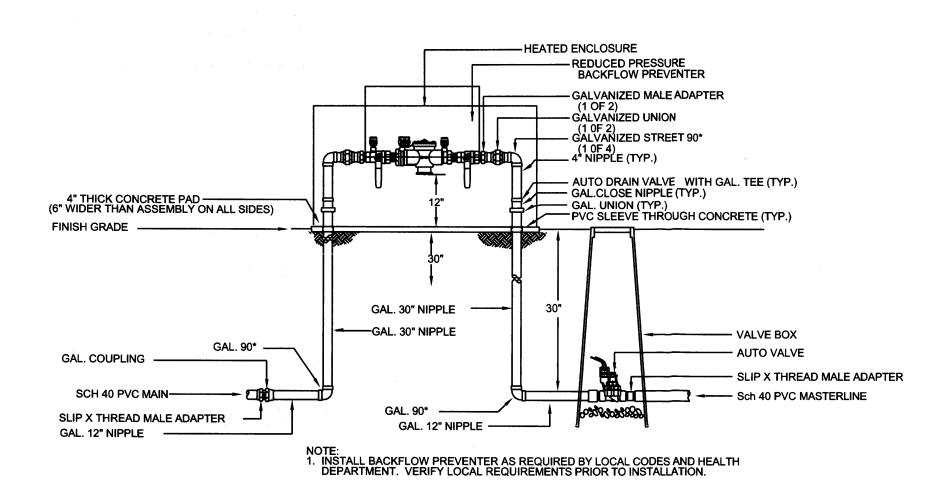

RP BACKFLOW/MASTER VALVE DETAIL

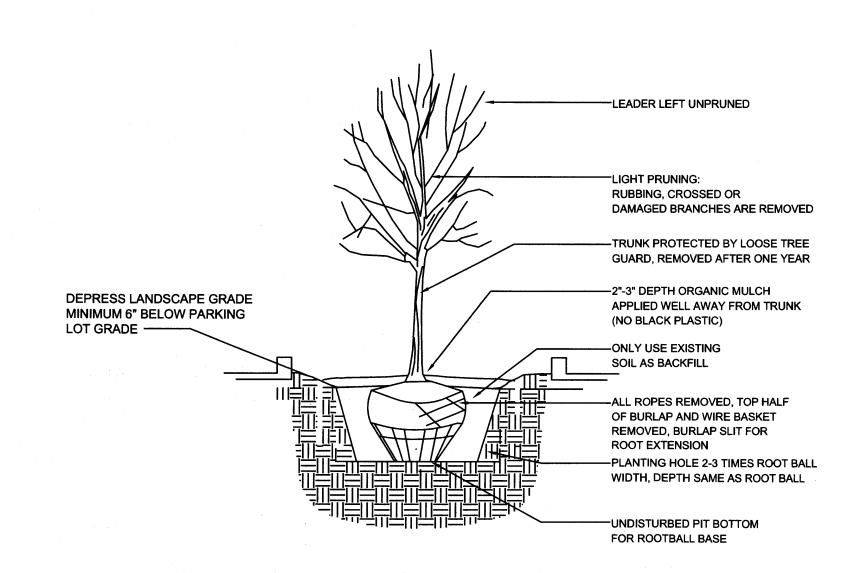

TREE PLANTING DETAIL/WATER HARVESTING

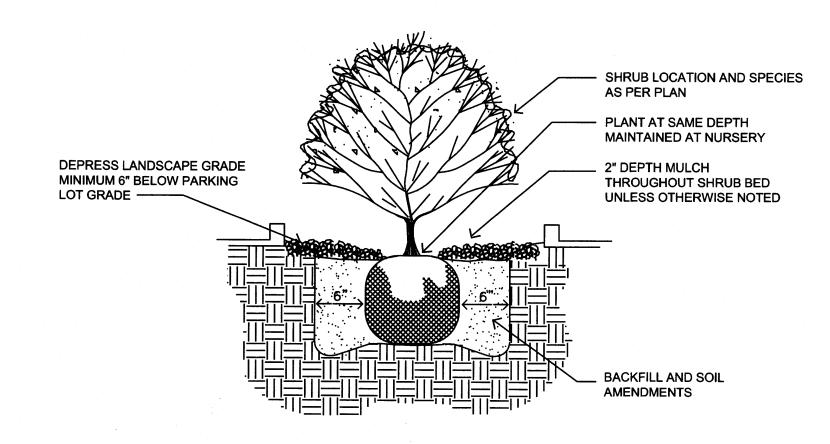

SHRUB PLANTING DETAIL/WATER HARVESTING



ENGINEER SEAL

SITE DEVELOPMENT PLAN SELME SPECIALISTS OFFICE/RETAILS WESTSIDE & GOLF COURSE, NW ALBUQUERQUE, NEW MEXICO

4/11/13 2/27/13

datejanuary 31, 2013


REVISIONS




DRAWING NAME

DETAIL SHEET

SHEET NUMBER

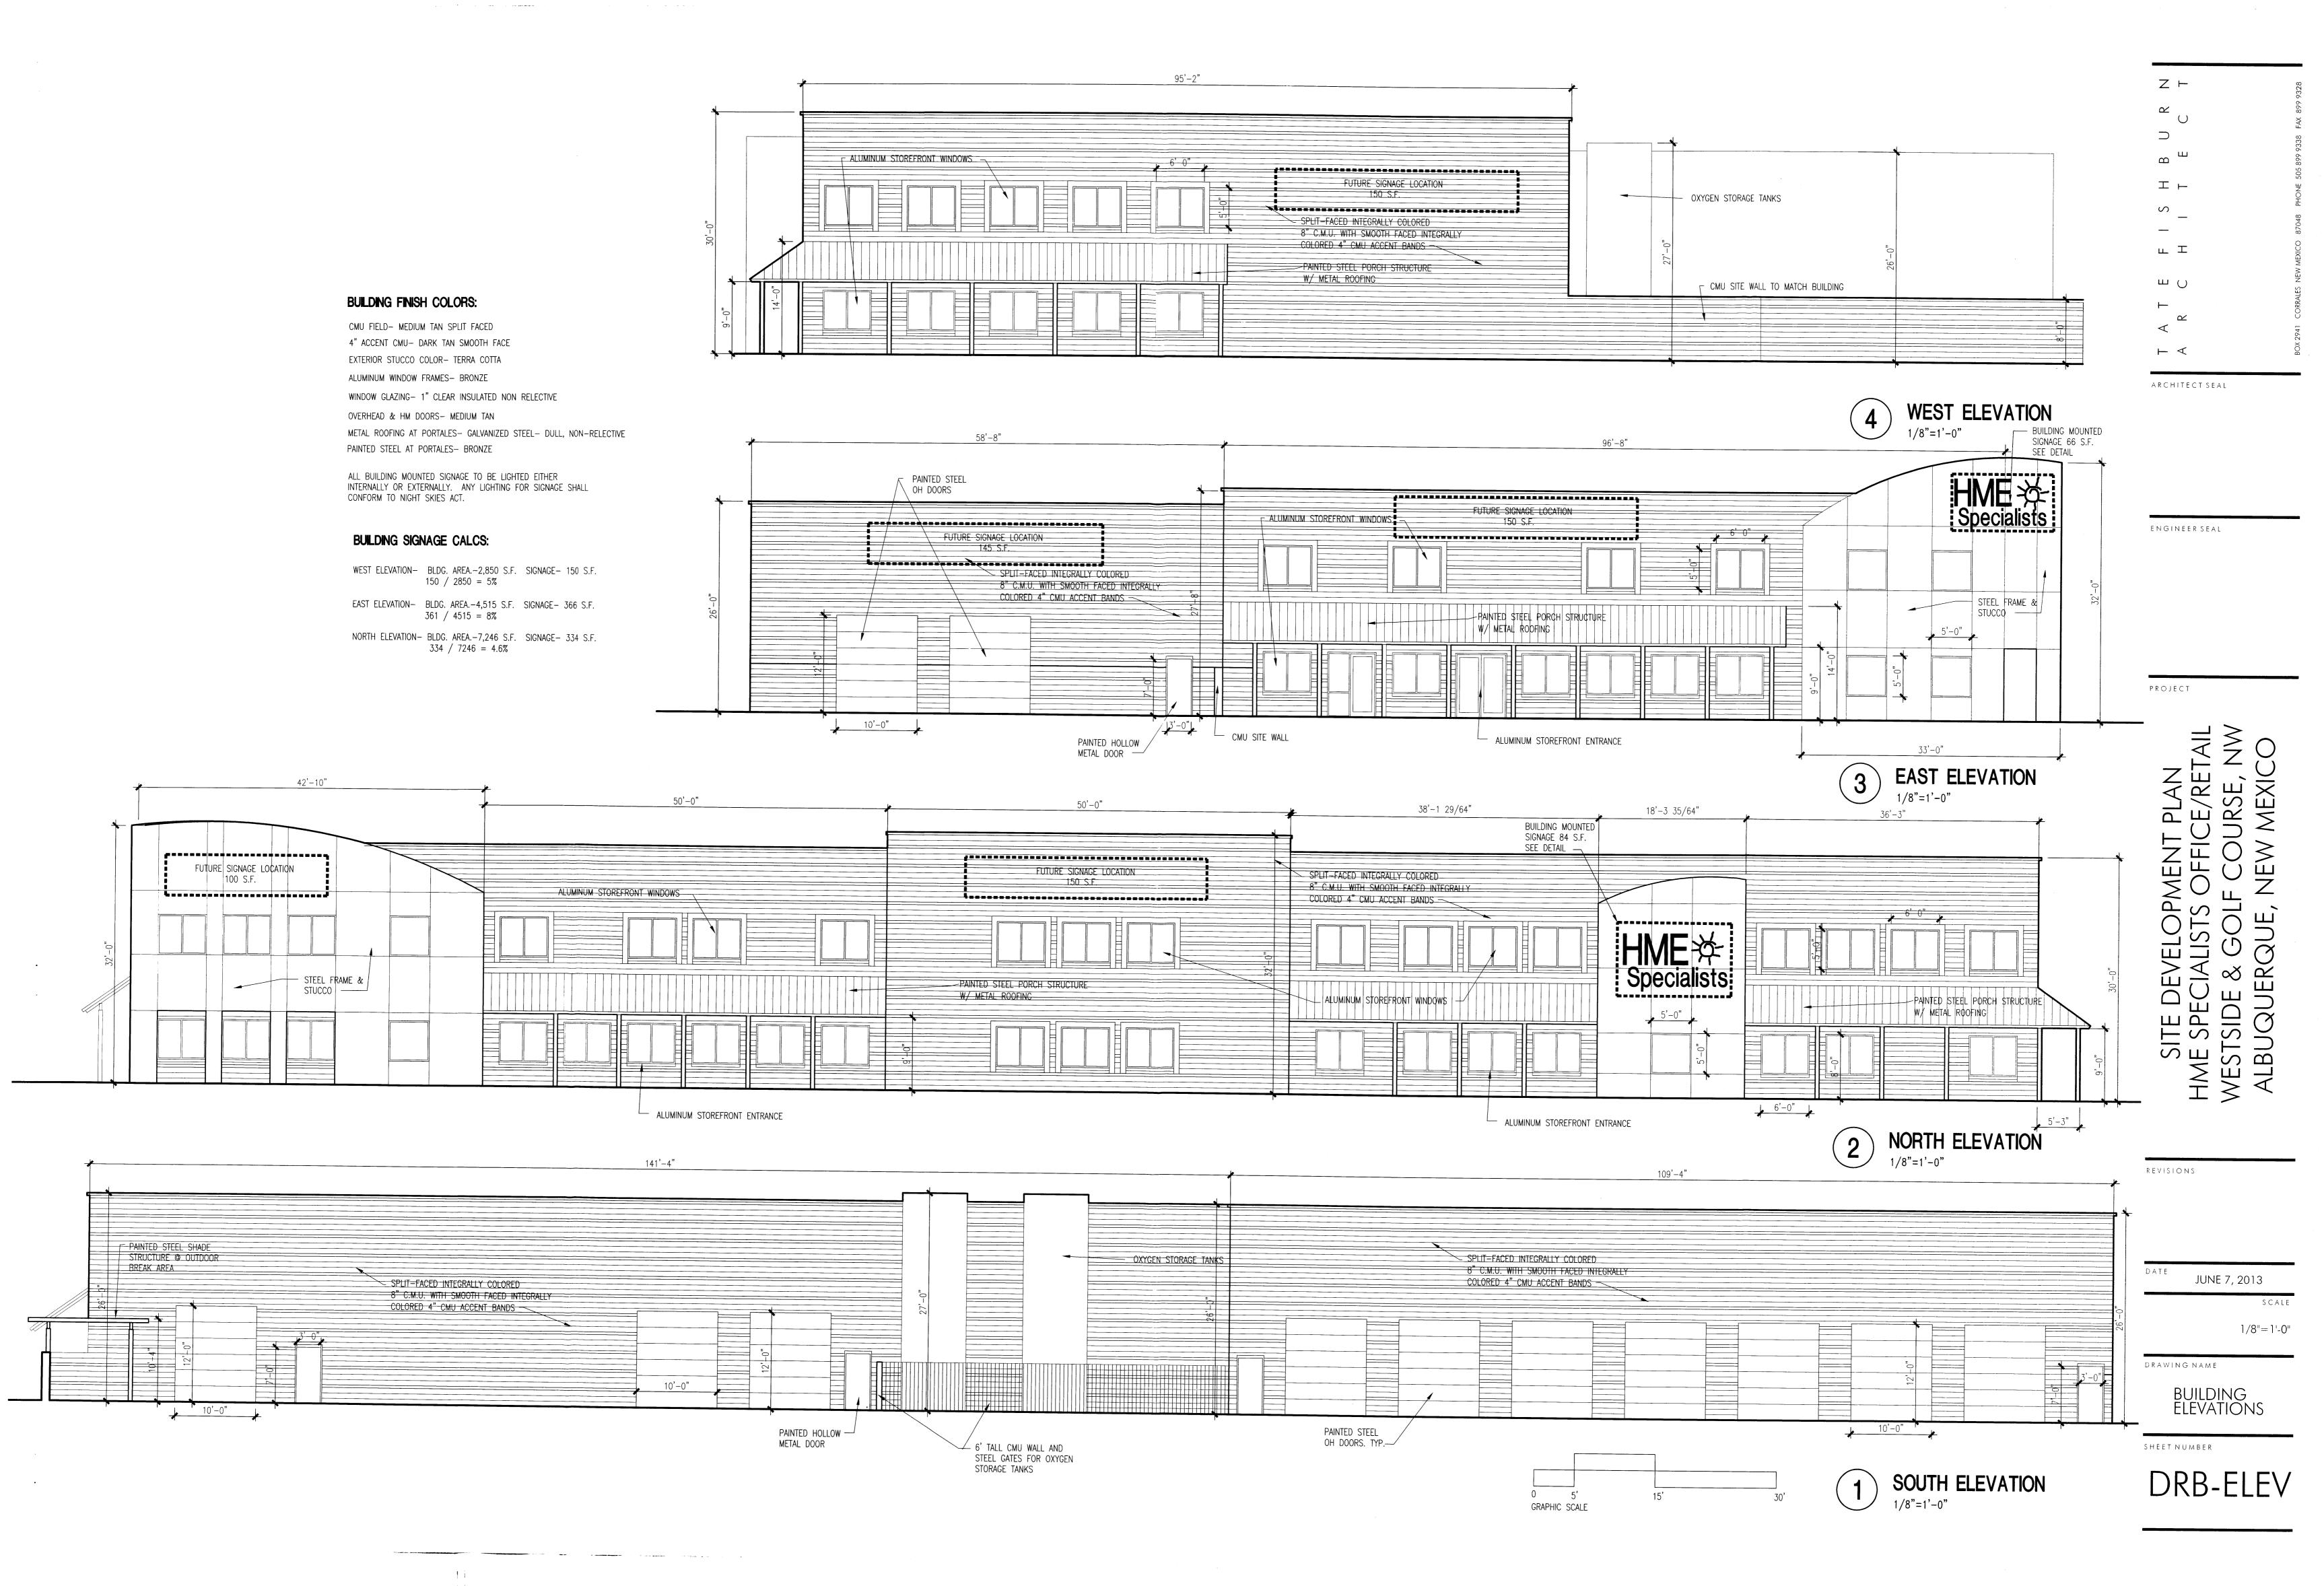

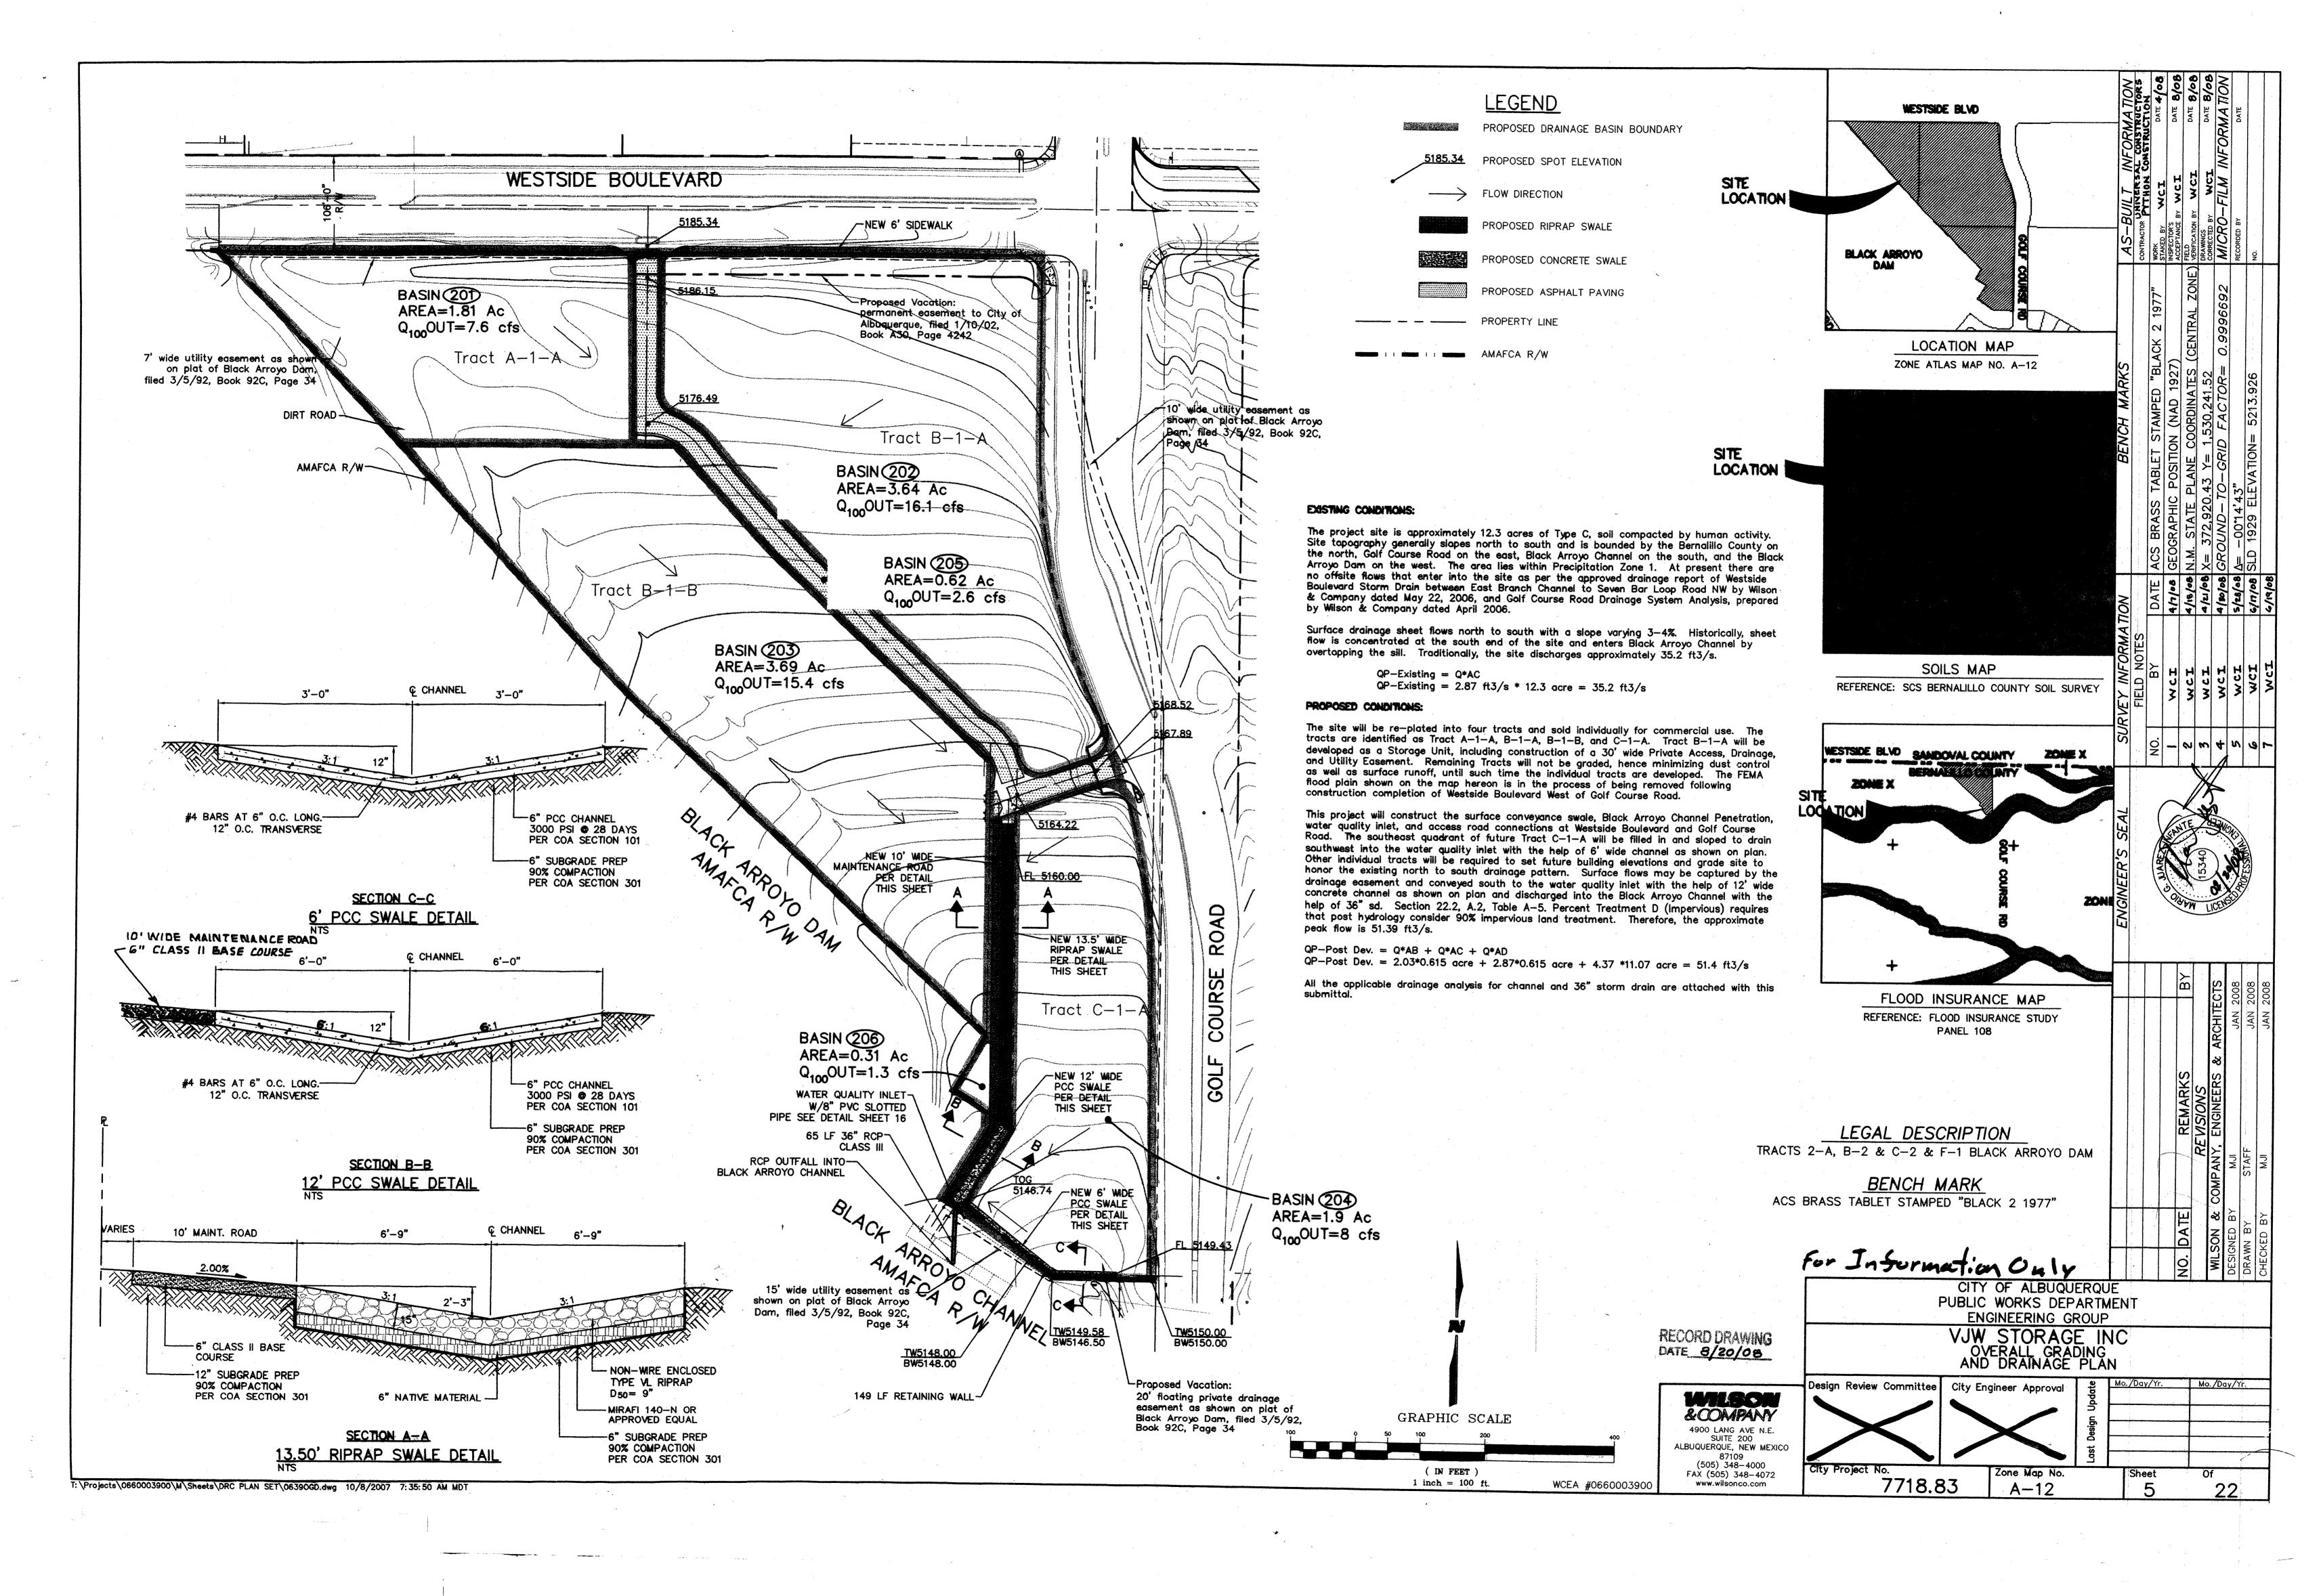

GENERAL SITE INFORMATION

SITE INFORMATION

The existing Site Development Plan indicates an area of 12.5 acres. Additional right—of—way has since been dedicated to the City of Albuquerque for street construction. The remaining site has a total area of 11.95 acres divided into three lots; separated by the internal private access road. The site will be further subdivided as needed to meet requirements of individual developers.

PROPOSED USE

The site is zoned C-2 (SC). It is intended that the site develop as a mix of a commercial uses including, retail, restaurants, financial, medical, office, etc.

INGRESS AND EGRESS

Vehicular access within the site is provided by a private access road. Each lot will have direct access to this road. The access road is connected to Westside Blvd. on the north and to Golf Course Rd. on the east side of the subdivision.

Pedestrian access is along the private access road and along the city streets named above.

Public transit (cross town commuter route) access is available at nearby park and ride sites on weekdays. Local service is not

Bicycle access is provided by a six foot wide bike lane on Golf Course Rd. and to the east on Westside Blvd.

Cross access easements will provide access and parking between adjacent tracts. Pedestrian connections will be provided between parking isles, public sidewalks, buildings and adjacent tracts.

LOT SIZE

All lots will have a minimum area of one acre and a least mean dimension of one hundred eighty feet. See least mean dimension calculation example below.

BUILDING SETBACKS

See sheet 2 of 2 "ARCHITECTURAL STANDARDS" and City of Albuquerque Comprehensive Zoning Ordinance for control.

MAXIMUM FAR

A maximum floor area ratio (FAR) will be 0.30 for all tracts.

LANDSCAPING

10' UNDERGROUND — & ABOVEGROUND

PUBLIC UTILITY EASEMENT.

AMAFCA - BLACK

ARROYO


CHANNEL

The landscape design standards shown on sheet 2 place an emphasis on native and/or naturalized plant species, landscape criteria, and landscape buffers. Subsequent landscape plans will be detailed and will be consistent with city standards regarding pollen control and water conservation.

LEAST MEAN DIMENSION CALCULATION

 $\begin{array}{r} (143.10 + 74.17) (62.64/2) = 6805 \\ (74.17 + 110.30) (61.59/2) = 5681 \\ (110.30 + 44.32) (41.69/2) = 1159 \\ (44.32 + 98.32) (87.47/2) = 6238 \\ (98.32 + 0) (78.87) = 3877 \\ \hline 23760/330.26 = 71.94 \\ \end{array}$

LEAST MEAN DIMENSION = 110.45 + 71.94 = 182.39'

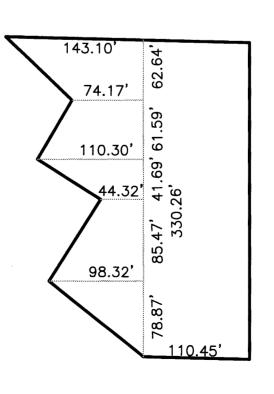


AMENDED

SITE PLAN FOR SUBDIVISION CALABACILLAS COMMERCIAL PARK

ALBUQUERQUE, NEW MEXICO JULY, 2013

VICINITY MAP A-12

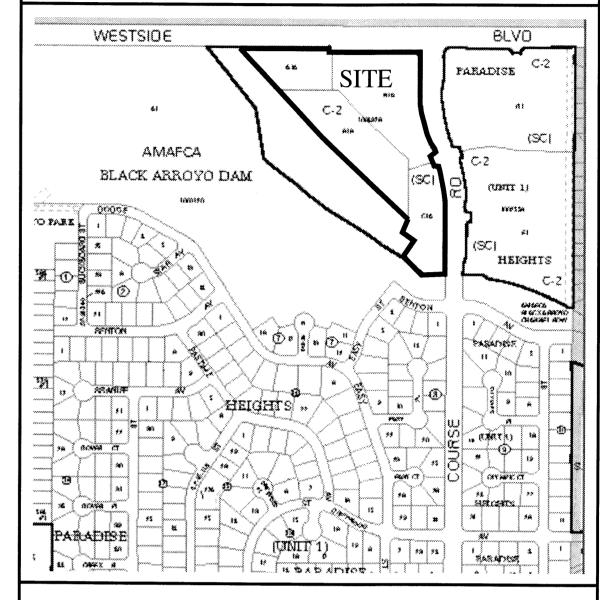

APPROVALS

 PROJECT NO:
 1004976

 APPLICATION NO:
 13EPC-40090

THIS PLAN IS CONSISTENT WITH THE SPECIFIC SITE DEVELOPMENT PLAN APPROVED BY THE ENVIRONMENTAL PLANNING COMMISSION (EPC) DATED______ AND THE FINDINGS AND CONDITIONS IN THE OFFICIAL NOTICE OF DECISION.

IS AN INFRASTRUCTURE LIST REQUIRED? ()YES () NO IF YES, THEN A SET OF APPROVED DRC PLANS WITH A WORK ORDER IS REQUIRED OF ANY CONSTRUCTION OF PUBLIC INPROVEMENTS.M

PARKS AND RECREATION DEPARTMENT	DATE
A.M.A.F.C.A.	DATE
CITY ENGINEER	DATE
A.B.C.W.U.A.	DATE
TRAFFIC ENGINEERING AND TRANSPORTATION DIVISION	DATE
DRB CHAIRPERSON, PLANNING DEPARTMENT	DATE





SHEET I OF 2

GENERAL

Future development will ensure consistency with these standards and the City of Albuquerque Zoning Code. The purpose of these design standards is to provide a framework to assist the architects, landscape architects, engineers and surveyors in understanding the vision and development goals for the property. The primary goal for this property is to achieve a vibrant variety of commercial uses.

The design standards should be used to facilitate the design of buildings and amenities which respect to the natural conditions of the site, maintain and highlight the views of the Sandia and Manzano mountains and take advantage of the open area created by the Black Arroyo Dam on the west boundary of the site. Innovative techniques such as water harvesting and use of 'green' building design are strongly encouraged.

These standards address the issues of architecture, screening, lighting, landscape, setbacks, pedestrian amenities, and parking lots that will create the visual image desire for Black Arroyo Dam.

Subsequent site plans for building permits shall be consistent with the City of Albuquerque zoning code as well as the design standards established by this Site Plan for Subdivision and shall be approved by the Environmental Planning Commission (EPC). minor amendments to this Site Plan for Subdivision shall be approved administratively by the Planning Director in accordance with the Comprehensive City Zoning Code, Section 14–16–2–22 (a)(6) Special Use Zone and major amendments shall be approved by the Environmental Planning Commission (EPC).

ARCHITECTURAL STANDARDS

- 1. The site affords dramatic views of the Sandia and Manzano mountains. Site design will take advantage of this asset. Patios and plazas will be be designed to have views of the mountains to the greatest extent possible.
- 2. The style for all buildings is broadly defined as 'Southwestern, Neo-Pueblo', 'Rio Grande Valley Adobe style', 'New Mexico Colonial style', 'Territorial style', etc. or a 'Southwestern Contemporary style', as it relates to the historical architectural styles. Unmodified, non-southwestern 'Franchise' architecture is prohibited.
- 3. Building design shall be architecturally integrated within the site and context of the commercial development with southwestern architecture per the "West Side Strategic Plan".
- 4. Building configuration, to the extent possible, should be in a plaza—like design or other similar arrangements to avoid strip—type development. On this regard, restaurants are encouraged to provide outdoor dining.
- 5. The primary building mass will be an earth—tone color (earth—tone is considered to be colors found in soils common to the southwest) regardless of materials. Colors other than the earth—tone palette, shall be used only for accents, decorative elements and for the emphasis of certain design elements.
- 6. Exterior building materials should generally be non—reflective and cementatious in visual quality. No more than three major materials, excluding frames, trim, canopies, etc., will be combined on any given building elevation.
- 7.Glass will have a surface reflectance no greater than 20% of incident light and wood or non—reflective metal trim will be colored in conformance withe general coloration of the structure.
- 8. All canopies and out—buildings will be integrated into the main building architecture.
- 9. Colored CMU walls will be permitted only if broken by horizontal bands of CMU of a different texture and color. Barbed wire, concertina wire, chain link fencing and unfinished cmu are prohibited.

SCREENING

- 1. Service areas, such as loading docks, janitorial and mechanical rooms and other service entrances and refuse collection facilities will not be located in or adjacent to the building faces most proximate to the boundaries of residential areas
- 2. Rooftop equipment, such as mechanical, electrical, communication and solar equipment, etc., will be hidden by parapet and/or screen walls to obscure them from public view.
- 3. Ground based equipment, such as mechanical, electrical, communication and solar equipment, etc., will be hidden by screen walls. Walls will be at least 6" higher than the object(s) being screened and consistent with the main building architectural style.
- 4. Screening will be designed to allow for access to utility facilities. All screening and landscaping surrounding ground—mounted transformers and utility pads are to allow ten (10) feet of clearance in front of the equipment door and six (6) feet of clearance on the remaining sides for safe operation, maintenance and repair purposes. Please refer to the PNM Electric service Guide and www.pnm.com for specifications.

SETBACKS

1. Minimum building setbacks from the face of the building to the property line will be 30 feet from the public street right—of—way line and private access easement line and 15 feet from all other property lines.

LANDSCAPE STANDARDS

The development of an overall landscape concept will establish a framework that unifies the property and is complementary to the high desert landscape of the west side. The landscape design should emphasize native and naturalized plant species. all landscaped areas need to coordinated and responsive to existing environmental conditions and local building policies. These guidelines are to be used as a supplement to the city requirements in the 'Water Conservation Landscaping and Water Waste Ordinance', the 'Street Tree Ordinance' and landscape regulation included in the 'City of Albuquerque Comprehensive City Zoning Code'.

- 1. The total landscape area for each lot must exceed 15% of the total lot area less the building footprint area.
- 2. landscape plans will list water usage and allergenic potential for all plant material proposed.
- 3. An automatic underground irrigation system will be utilized to provide even and adequate water levels to all plant material. Water use will be done in such a manner as to conserve water use and prevent irrigation runoff.
- 4. Landscape maintenance is the responsibility of the property owner.
- 5. Parking lot landscaping will primarily consist of deciduous trees. The distance between planting islands will no exceed 85 feet.
- 6. Street—scape landscaping will primarily consist of a combination of shrubs and deciduous trees in a 10 foot wide area between the street right—of—way line and the face of the curb of an adjacent parking area. tree location will meet the requirements of the street tree ordinance. Note that clear sight triangle requirements must be met.
- 7. Residential buffer materials shall primarily consist of deciduous trees in combination with conifers to provide year round partial screening.
- 8. Non-living ground cover will be limited to 15% of the reauired landscaped area.
- 9. Suggested trees for this site: desert willow, chinese pistache, arizona sycamore, canadian choke cherry, honey locust, purple robe locust. Varieties of juniper, crab apple, sycamore and bradford pear will not be used.
- 10. Suggested shrubs are apache plume, rosemary, russian sage, big sage, lavender, three leaf sumac, mountain mahogany, autumn sage and fernbush. Boxwood and privet will not be used.
- 11. Suggested ornamental grasses are threadgrass, blue gramma and blue fescue. Sod will not be used.
- 12. Landscaped areas shall be depressed a minimum of two inches below adjacent confining elements.

SIGNAGE STANDARDS

These signage standards were developed to regulate the size, location, type and quality of sign elements within the Black Arroyo Dam site. The goal is to provide a signage program that is of high quality, maintains a consistent style, creates a sense of arrival and complements the visual nature of the property.

- 1. All signs shall be in compliance with Section 14-16-3-5, General Sign Regulation of the Comprehensive City Zoning Code.
- 2. The support structures for the monument and project signs will be compatible with the building architecture.
- 3. No sign on a building facade facing a residential area will be illuminated.
- 4. A project sign is permitted at each entrance to the project from an arterial street. The project signs will be freestanding 'monument type' signs. The top of the sign will no be more than 6 feet above the adjacent finish grade and the face will have a maximum area of 36 square feet.
- 5. Each building site is limited to one monument sign. The monument will be a 'monument type' freestanding sign. The top of the sign will be no more that 4 feet above the adjacent finish grade and the face will have a maximum area of 20 square feet.
- 6. Each parcel is limited to one building mounted sign per tenant or business. The sign will not exceed 8% of the area of the facade to which it is attached.
- 7. Pole mounted signs and signs supported with wires are prohibited.

PARKING & PEDESTRIAN STANDARDS

In order to support the goals for the property regarding pedestrian accessibility, careful attention should be paid to the parking design. An effort should be made by site designers to lessen the impact of parking facilities on the land and preserve views. In order to ease the visual impact of parking areas, parking facilities should be broken up into smaller areas.

- 1. Handicapped parking spaces will be provided adjacent to building entries.
- 2. Provided parking shall not exceed the required parking by more than 10%.
- 3. Buildings and on—site circulation should be located to minimize pedestrian/vehicle conflicts.
- 4. Pedestrian access will be provided to link buildings and public sidewalks as well as from lot to lot.
- 5. Parking areas will be designed to include a pedestrian pathway (textured, colored concrete) to buildings.
- 6. Where parking is adjacent to public streets, landscaping for screening purposed will be required. The screen will be composed of shrubs trimmed to a height of 4 feet.
- 7. Blanket cross access and parking easements will be granted on all lots.
- 8. All tracts will provide pedestrian connections to abutting tracts.
- 9. A pedestrian pathway with a minimum width of six feet will be provided along the western and southern side of the internal roadway.

LIGHTING STANDARDS

In order to enhance the safety, security and visual aesthetics, careful consideration must be given to both daytime and nighttime appearance of the lighting design and fixtures. The primary design objective of the site lighting system will be to maximize public safety while not affecting adjacent properties, buildings or roadways with unnecessary glare or reflection.

- 1. All lighting shall comply with section 14-16-3-9, area lighting regulations of the comprehensive city zoning code. Placement of fixtures and standards will conform to state and local safety and illumination standards.
- 2. Lighting shall conform to 'dark sky' standards.
- 3. All lighting will be fully shielded.
- 4. Parking lot lighting shall be provided by 15'-0" high light poles in an earth—tone color.
- 5. Lighting height will be measured from adjacent finish grade to the top of the fixture.
- 6. High pressure sodium lighting and up—lighting are prohibited.

BUSINESS INFO BUSINESS INFO CALABACILLAS COMMERCIAL PARK BUSINESS NAMES PROJECT SIGN 2-SIDED SIGN W/ 20 S.F FACE EACH SIDE SO S.F. EACH SIDE SO S.F. EACH SIDE


CLEAR SIGHT TRIANGLE

1. Landscaping and signage will no interfere with clear sight requirements. Signs, walls, trees, and shrubbery between 3 and 8 feet tall (as measured from the gutter pan will not be acceptable in the clear sight triangle.

AMENDED

SITE PLAN FOR SUBDIVISION
CALABACILLAS
COMMERCIAL PARK
ALBUQUERQUE, NEW MEXICO

JULY, 2013

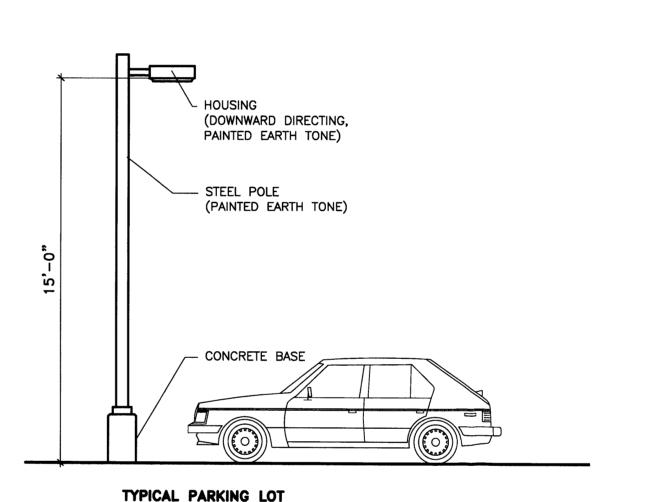



BORDENAVE DESIGNS

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SHEET 2 OF 2

UTILITY MAP

SITE UTILITY INFORMATION

1. WATER, SANITARY SEWER, STORM DRAIN, POWER, GAS AND COMMUNICATIONS ARE AVAILABLE TO THE SUBDIVISION ALONG THE INTERNAL ACCESS ROAD. NO OFFSITE CONSTRUCTION IS REQUIRED.

2. COORDINATION OF UTILITY SERVICES MAY BE MADE THROUGH THE FOLLOWING:

WATER AND SANITARY SEWER — ABCWUA
POWER — PUBLIC SERVICE CO. OF NEW MEXICO
GAS — NEW MEXICO GAS CO.
TELEPHONE — CENTURY LINK
CABLE — COMCAST

SITE UTILITIES FOR CALABACILLAS COMMERCIAL PARK

ALBUQUERQUE, NEW MEXICO JULY, 2013

VICINITY MAP A-12

