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DRAWN BY

DATE

REVIEWED BY

PROJECT NO.

SHEET NO.

DRAWING NAME

GRADING AND

DRAINAGE PLAN

ew

Innovation querdue, Nev

1501 Innovati Albuquerque,

BO


09/06/05

05028

- 6. INSTALL GUTTER SECTION PER DETAIL 3 THIS SHEET.

### **GRADING NOTES**

- 2. THE COST FOR REQUIRED CONSTRUCTION DUST AND EROSION CONTROL MEASURES SHALL BE INCIDENTAL
- 3. ALL WORK RELATIVE TO FOUNDATION CONSTRUCTION, SITE PREPARATION, AND PAVEMENT INSTALLATION, AS SHOWN ON THIS PLAN, SHALL BE CONSTRUCTED IN ACCORDANCE WITH THE "GEOTECHNICAL INVESTIGATION," AS PROVIDED BY THE ARCHITECT OR OWNER. ALL OTHER WORK SHALL, UNLESS OTHERWISE STATED OR PROVIDED FOR HEREON, BE CONSTRUCTED IN ACCORDANCE WITH THE PROJECT, (FIRST PRIORITY) SPECIFICATIONS, AND/OR THE CITY OF ALBUQUERQUE (COA) STANDARD SPECIFICATIONS FOR PUBLIC WORKS (SECOND PRIORITY).
- 4. EARTH SLOPES SHALL NOT EXCEED 3 HORIZONTAL TO 1 VERTICAL UNLESS SHOWN OTHERWISE.
- OF THE PROPERTY BOUNDARIES EXCEPT AS REQUIRED BY THIS PLAN.
- 6. THE CONTRACTOR IS TO ENSURE THAT NO SOIL ERODES FROM THE SITE ONTO ADJACENT PROPERTY OR PUBLIC RIGHT-OF-WAY. THIS SHOULD BE ACHIEVED BY CONSTRUCTING TEMPORARY BERMS AT THE PROPERTY LINES PER DETAIL ON SHEET C203 AND WETTING THE SOIL TO PROTECT IT FROM WIND EROSION.
- A BORROW SITE CONTAINING ACCEPTABLE FILL MATERIAL SHALL BE OBTAINED BY THE CONTRACTOR IN COMPLIANCE WITH APPLICABLE ENVIRONMENTAL REGULATIONS AND APPROVED BY THE OBSERVER. ALL COSTS INCURRED IN OBTAINING A DISPOSAL OR BORROW SITE AND HAUL TO OR FROM SHALL BE CONSIDERED INCIDENTAL TO THE PROJECT AND NO SEPARATE MEASUREMENT OR PAYMENT SHALL BE MADE.
- BE ADJUSTED FOR MEDIANS AND ISLANDS.
- BEGINNING CONSTRUCTION.

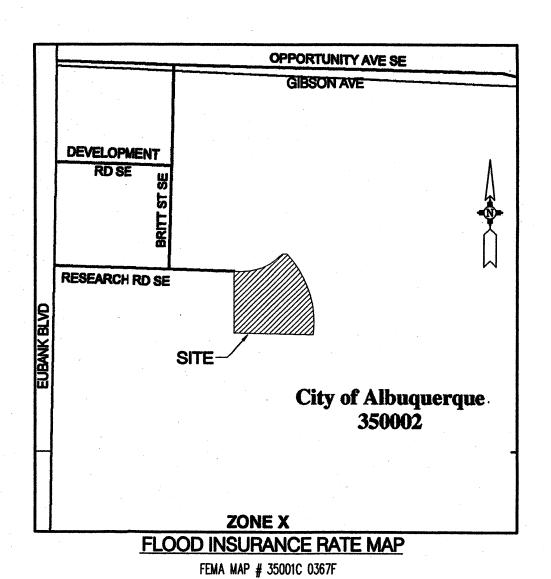

LEGAL DESCRIPTION

PARTNERSH

PARTNERSHIP

**LOCATION MAP** ZONE ATLAS INDEX MAP No. M-21-Z

RIBBON CHANNEL TYPICAL SECTION

2 VALLEY GUTTER TYPICAL SECTION

3 GUTTER DETAIL AT PLANTER

- HEADER CURB

PARK

### **BENCHMARK**

ACS ALUMINUM CAP STAMPED "6-L21, 1986" INTERSECTION OF CENTRAL AVE. & ELIZABETH ST.

ELEV=5503.35 NAVD 8

### GRADING & DRAINAGE KEYED NOTES

- 1. INSTALL 18" SIDEWALK CULVERT PER COA STD DWG 2236.
- 2. INSTALL CONCRETE RIBBON CHANNEL PER DETAIL 1 THIS SHEET.
- 3. MATCH EXISTING PAVEMENT.
- 5. INSTALL 4" DRAIN PIPE.
- 1. EXCEPT AS PROVIDED HEREIN, GRADING SHALL BE PERFORMED AT THE ELEVATIONS AND IN ACCORDANCE WITH THE DETAILS SHOWN ON THIS PLAN.
- TO THE PROJECT COST.

- 5. IT IS THE INTENT OF THESE PLANS THAT THIS CONTRACTOR SHALL NOT PERFORM ANY WORK OUTSIDE
- 7. A DISPOSAL SITE FOR ANY & ALL EXCESS EXCAVATION MATERIAL, AND UNSUITABLE MATERIAL AND/OR
- 8. PAVING AND ROADWAY GRADES SHALL BE +/- 0.1' FROM PLAN ELEVATIONS. PAD ELEVATION SHALL BE +/- 0.05' FROM BUILDING PLAN ELEVATION.
- 9. ALL PROPOSED CONTOURS REFLECT TOP OF PAVEMENT ELEVATIONS IN THE PARKING AREA AND MUST
- 10. VERIFY ALL ELEVATIONS SHOWN ON PLAN FROM BASIS OF ELEVATION CONTROL STATION PRIOR TO

## **Bohannan A Huston**

Courtyard I 7500 Jefferson St. NE Albuquerque, NM 87109-4335 ENGINEERING . SPATIAL DATA . ADVANCED TECHNOLOGIES

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				Proposed	~ <del>~~~~~~~~~~~~~~~~~~~~~~~~~~~~~~~~~~~~</del>	s Basin Da	ta Table	•	·•	
	s table is bas						2//22			
Basin	Area	Area	_	Treatme	T		Q(100)	Q(100)	V(100)	V(100)
ID	(SQ. FT)	(AC.)	Α	В	C	D	(cfs/ac.)	(CFS)	(inches)	(CF)
Existing	Conditions	}								
1	46920	1.08	0.0%	10.0%	10.0%	80.0%	4.62	4.98	2.11	8246
2	45440	1.04	0.0%	10.0%	10.0%	80.0%	4.62	4.82	2.11	7986
TOTAL	92360	2.12		•		•	4.62	9.80	4.22	32465
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TOTAL	92360	2.12	•	-	•	•	4.66	9.88	4.27	32876

FF = 97.40

1.04 ACRE

5495

FL95.00

## DRAINAGE MANAGEMENT PLAN

SCALE: 1"=40'

1596.55 FI96.90

The purpose of this submittal is to present a final grading and drainage plan for a one-story buildings and corresponding parking lots on the corner of Innovation Parkway and Research Road. This submittal is made in order to support building permit approval.

PARKING LO CURB & GUTTER

### II. SITE LOCATION AND EXISTING CONDITIONS

The project site is located on the southwest corner of Innovation Parkway and Research Road. The site is located within zone atlas map # M-21-Z, and hydrologic zone 3. A previous phase of this project has been built just north of the site. The Grading and Drainage Plan approved October 21. 2003 (M21/D7C) details the existing and proposed conditions for the full build out of this project. The approved master drainage plan for Sandia Science and Technology Park allows a discharge of 1.57cfs per acre. The full site (Phase I and Phase II) is 4.79 acres which results in maximum allowable runoff of 7.52cfs.

During Phase I, the site was divided into two basins. Due to the design requirements outlined by the Sandia Science and Technology Park, two ponds were constructed on site to mitigate flows before entering the storm drain in Research Road. Basin 1 drains into Pond D. Pond D's outflow is controlled with a 12" storm drain pipe. Pond D and Basin 2 will then drain into Pond A. Pond A uses a 12" storm drain to control flow into the existing 18" storm drain that ultimately drains into the 36" storm drain along Research Road. The discharge is regulated by the 12" diameter pipe. This flow was analyzed via AHYMO to be 7.25cfs which is less then the maximum allowable flow of 7.52cfs.

### III. PROPOSED HYDROLOGIC CONDITIONS

In accordance with Phase I, Basins 1 and 2 will be formed along with two new detention ponds. Drainage from this site will be conveyed by surface flow across the site through these two detention ponds. There was a slight increase in impervious area in Basin 2 which resulted in an increase in runoff of less than 1% (0.08cfs increase). This increase will be insignificant as the analysis allowed for 0.27cfs.

### V. CONCLUSION

The final phase and previously constructed ponds ensure the outflow for the 100yr storm event does not surpass the 7.52cfs allowable flow required by the SS&TP. The improvements proposed with this final grading and drainage plan are capable of safely passing the 100 year storm and meet city requirements. With this submittal, we are seeking city hydrology approval for building permit.

### **GENERAL NOTES**


- 1. ALL WORK DETAILED ON THESE PLANS AND PERFORMED UNDER THIS CONTRACT SHALL BE CONSTRUCTED IN ACCORDANCE WITH THE PROJECT SPECIFICATIONS AND THE PROJECT GEOTECHNICAL REPORT. WHERE APPLICABLE, CITY OF ALBUQUERQUE PUBLIC WORKS STANDARDS SHALL APPLY.
- 2. THE CONTRACTOR SHALL ABIDE BY ALL LOCAL, STATE, AND FEDERAL LAWS, RULES AND REGULATIONS WHICH APPLY TO THE CONSTRUCTION OF THESE IMPROVEMENTS, INCLUDING EPA REQUIREMENTS WITH RESPECT TO STORM WATER DISCHARGE.
- 3. PRIOR TO CONSTRUCTION, THE CONTRACTOR SHALL FIELD VERIFY THE HORIZONTAL AND VERTICAL LOCATIONS OF ALL POTENTIAL OBSTRUCTIONS INCLUDING ALL UNDERGROUND UTILITIES. SHOULD A CONFLICT EXIST, THE CONTRACTOR SHALL NOTIFY THE CONSTRUCTION OBSERVER OR ENGINEER SO THAT THE CONFLICT CAN BE RESOLVED WITH A MINIMUM AMOUNT OF DELAY.
- 4. TWO (2) WORKING DAYS PRIOR TO ANY EXCAVATION, THE CONTRACTOR SHALL CONTACT LINE LOCATING SERVICE FOR LOCATION OF EXISTING UTILITIES.
- 5. ALL ELECTRICAL, TELEPHONE, CABLE TV, GAS AND OTHER UTILITY LINES, CABLES, AND APPURTENANCES ENCOUNTERED DURING CONSTRUCTION THAT REQUIRE RELOCATION, SHALL BE COORDINATED WITH THAT UTILITY. THE CONTRACTOR SHALL BE RESPONSIBLE FOR COORDINATION OF ALL NECESSARY UTILITY ADJUSTMENTS. NO ADDITIONAL COMPENSATION WILL BE ALLOWED FOR DELAYS OR INCONVENIENCES CAUSED BY UTILITY COMPANY WORK CREWS. THE CONTRACTOR MAY BE REQUIRED TO RESCHEDULE HIS ACTIVITIES TO ALLOW UTILITY CREWS TO PERFORM THEIR REQUIRED WORK.
- 6. THE CONTRACTOR IS RESPONSIBLE FOR PROTECTING ALL EXISTING UTILITY LINES WITHIN THE CONSTRUCTION AREA. ANY DAMAGE TO EXISTING FACILITIES CAUSED BY CONSTRUCTION ACTIVITY SHALL BE REPAIRED OR REPLACED AT THE CONTRACTOR'S EXPENSE AND APPROVED BY THE CONSTRUCTION OBSERVER.
- 7. CONSTRUCTION ACTIVITY SHALL BE LIMITED TO THE PROPERTY AND/OR PROJECT LIMITS. ANY DAMAGE TO ADJACENT PROPERTIES RESULTING FROM THE CONSTRUCTION PROCESS SHALL BE REPAIRED OR REPLACED AT THE CONTRACTOR'S EXPENSE.
- 8. OVERNIGHT PARKING OF CONSTRUCTION EQUIPMENT SHALL NOT OBSTRUCT DRIVEWAYS OR DESIGNATED TRAFFIC LANES. THE CONTRACTOR SHALL NOT STORE ANY EQUIPMENT OR MATERIAL WITHIN THE PUBLIC RIGHT-OF-WAY.
- 9. THE CONTRACTOR SHALL OBTAIN ALL THE NECESSARY PERMITS FOR THE PROJECT PRIOR TO COMMENCING CONSTRUCTION (I.E., BARRICADING, TOPSOIL DISTURBANCE, EXCAVATION PERMITS, EPA STORM WATER PERMITS, ETC.).
- 10. ALL PROPERTY CORNERS DESTROYED DURING CONSTRUCTION SHALL BE REPLACED AT THE CONTRACTOR'S EXPENSE. ALL PROPERTY CORNERS MUST BE RESET BY A REGISTERED LAND SURVEYOR.
- 11. THE CONTRACTOR SHALL PREPARE A CONSTRUCTION TRAFFIC CONTROL AND SIGNING PLAN AND OBTAIN APPROVAL OF SUCH PLAN FROM THE CITY OF ALBUQUERQUE, TRAFFIC ENGINEERING DEPARTMENT, PRIOR TO BEGINNING ANY CONSTRUCTION WORK ON OR ADJACENT TO EXISTING STREETS.
- 12. ALL BARRICADES AND CONSTRUCTION SIGNING SHALL CONFORM TO APPLICABLE SECTIONS OF THE "MANUAL ON UNIFORM TRAFFIC CONTROL DEVICES" (MUTCD), US DEPARTMENT OF TRANSPORTATION, LATEST EDITION.
- 13. THE CONTRACTOR SHALL MAINTAIN ALL CONSTRUCTION BARRICADES AND SIGNING AT ALL TIMES. THE CONTRACTOR SHALL VERIFY THE PROPER LOCATION OF ALL BARRICADING AT THE END AND BEGINNING OF EACH DAY.
- 14. THE CONTRACTOR SHALL TAKE ALL STEPS NECESSARY TO CONFORM WITH EPA REQUIREMENTS, INCLUDING COMPLIANCE WITH NPDES PHASE 2 REQUIREMENTS.

## **BENCHMARK**

ACS ALUMINUM CAP STAMPED "6-L21, 1986" INTERSECTION OF CENTRAL AVE. & ELIZABETH ST. ELEV=5503.35 NAVD 88

6801 Jefferson NE Suite 100 Albuquerque, NM 87109

505 761-9700 fax 761-4222 dps@dpsabq.com

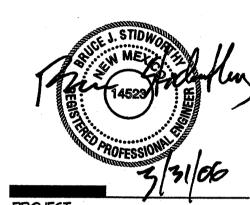


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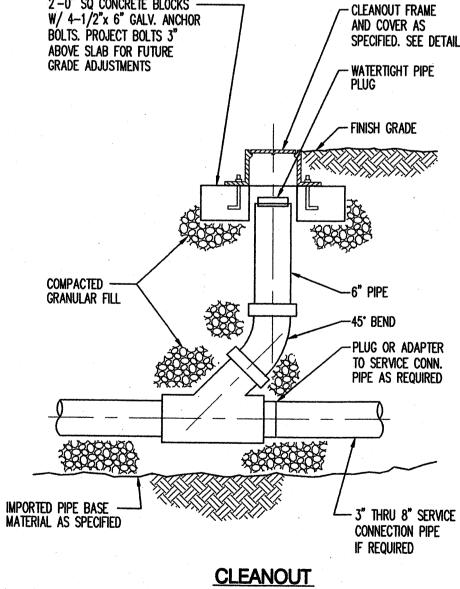
1501 Innovilbuduerqu

# 4-5/8" Ø HOLES --REQ' D @ EQUAL

## **CLEANOUT**

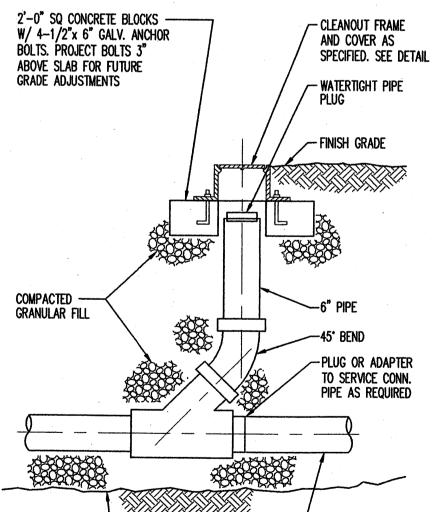

### FRAME & COVER N.T.S.



### ○ UTILITY KEYED NOTES

UTILITY NOTES

EXCEPT AT BUILDING CONNECTION.

SIDEWALK, AS APPLICABLE.

ALL NECESSARY FITTINGS.

APPROVED FOR FIRE SERVICE.

1. THIS CONTRACTOR SHALL BE RESPONSIBLE FOR THE COMPLETE INSTALLATION OF ALL

TRENCHING, BACKFILL, SUPPORTS, CLEANOUT PADS, SERVICE STOPS AND BOXES, SERVICE

COORDINATION SHALL BE REMOVED AND CORRECTLY INSTALLED AT THE CONTRACTOR'S

2. MINIMUM DEPTHS OF COVER SHALL BE: 48" FOR WATERLINES AND 48" FOR SEWER,

3. ALL WORK DETAILED ON THESE PLANS TO BE PERFORMED UNDER CONTRACT SHALL,

4. UTILITY LINES SHALL BE INSTALLED PRIOR TO PAVEMENT, CURB AND GUTTER, AND/OR

5. ROUGH GRADING OF SITE (±0.5') SHALL BE COMPLETED PRIOR TO INSTALLATION OF

6. CONTRACTOR WILL BE RESPONSIBLE FOR CONNECTIONS TO BUILDING DRAIN LINES AND

8. FIRE LINES SHALL USE PIPE MATERIALS UNDERWRITERS LABORATORIES LISTED AND

9. CONTRACTOR SHALL BE RESPONSIBLE FOR ALL WATER METER, FIRE LINE, AND SEWER HOOKUP FEES FOR INSTALLATIONS. OWNER SHALL BE RESPONSIBLE FOR UTILITY

10. CONTRACTOR SHALL VERIFY INVERTS AND LOCATIONS OF EXISTING WATER/SAS LINES PRIOR TO BEGINNING WORK. ALL CONFLICTS SHALL BE BROUGHT TO ATTENTION OF THE

7. ALL VALVES SHALL BE ANCHORED PER COA STANDARD DWG. 2333.

EXPANSION CHARGES, PRORATA AND OTHER SPECIAL ASSESSMENTS.

EXCEPT AS OTHERWISE STATED OR PROVIDED OF HEREON, BE CONSTRUCTED IN ACCORDANCE WITH THE IAPMO UNIFORM PLUMBING CODE, LATEST EDITION.

WORK RELATED TO MECHANICAL UTILITIES AS SHOWN ON THIS PLAN INCLUDING:

LINES, TESTING, CLEANING, AND STERILIZING. ANY WORK NOT ACCEPTED BY THE ARCHITECT OR ENGINEER DUE TO IMPROPER WORKMANSHIP OR LACK OF PROPER

- A. EXISTING WATER SERVICE LINE.
- B. INSTALL NEW 1 1/2" WATER METER & METER BOX.
- C. STUB TO WITHIN 5' OF BUILDING, SEE PLUMBING PLANS FOR CONTINUATION.

ENGINEER AND RESOLVED PRIOR TO BEGINNING WORK.

- D. TIE NEW 6" FIRE LINE TO EXISTING 6" STUB OUT.
- E. TIE NEW 6" SAS TO EXISTING SAS STUB OUT.
- F. EXISTING SAS SERVICE LINE, NOT USED.
- G. CONSTRUCT CLEANOUT PER DETAIL THIS SHEET.

## Bohannan 🛦 Huston 🗉

Courtyard i 7500 Jefferson St. NE Albuquerque, NM 87109-4335 ENGINEERING & SPATIAL DATA & ADVANCED TECHNOLOGIES DRAWN BY REVIEWED BY BJS


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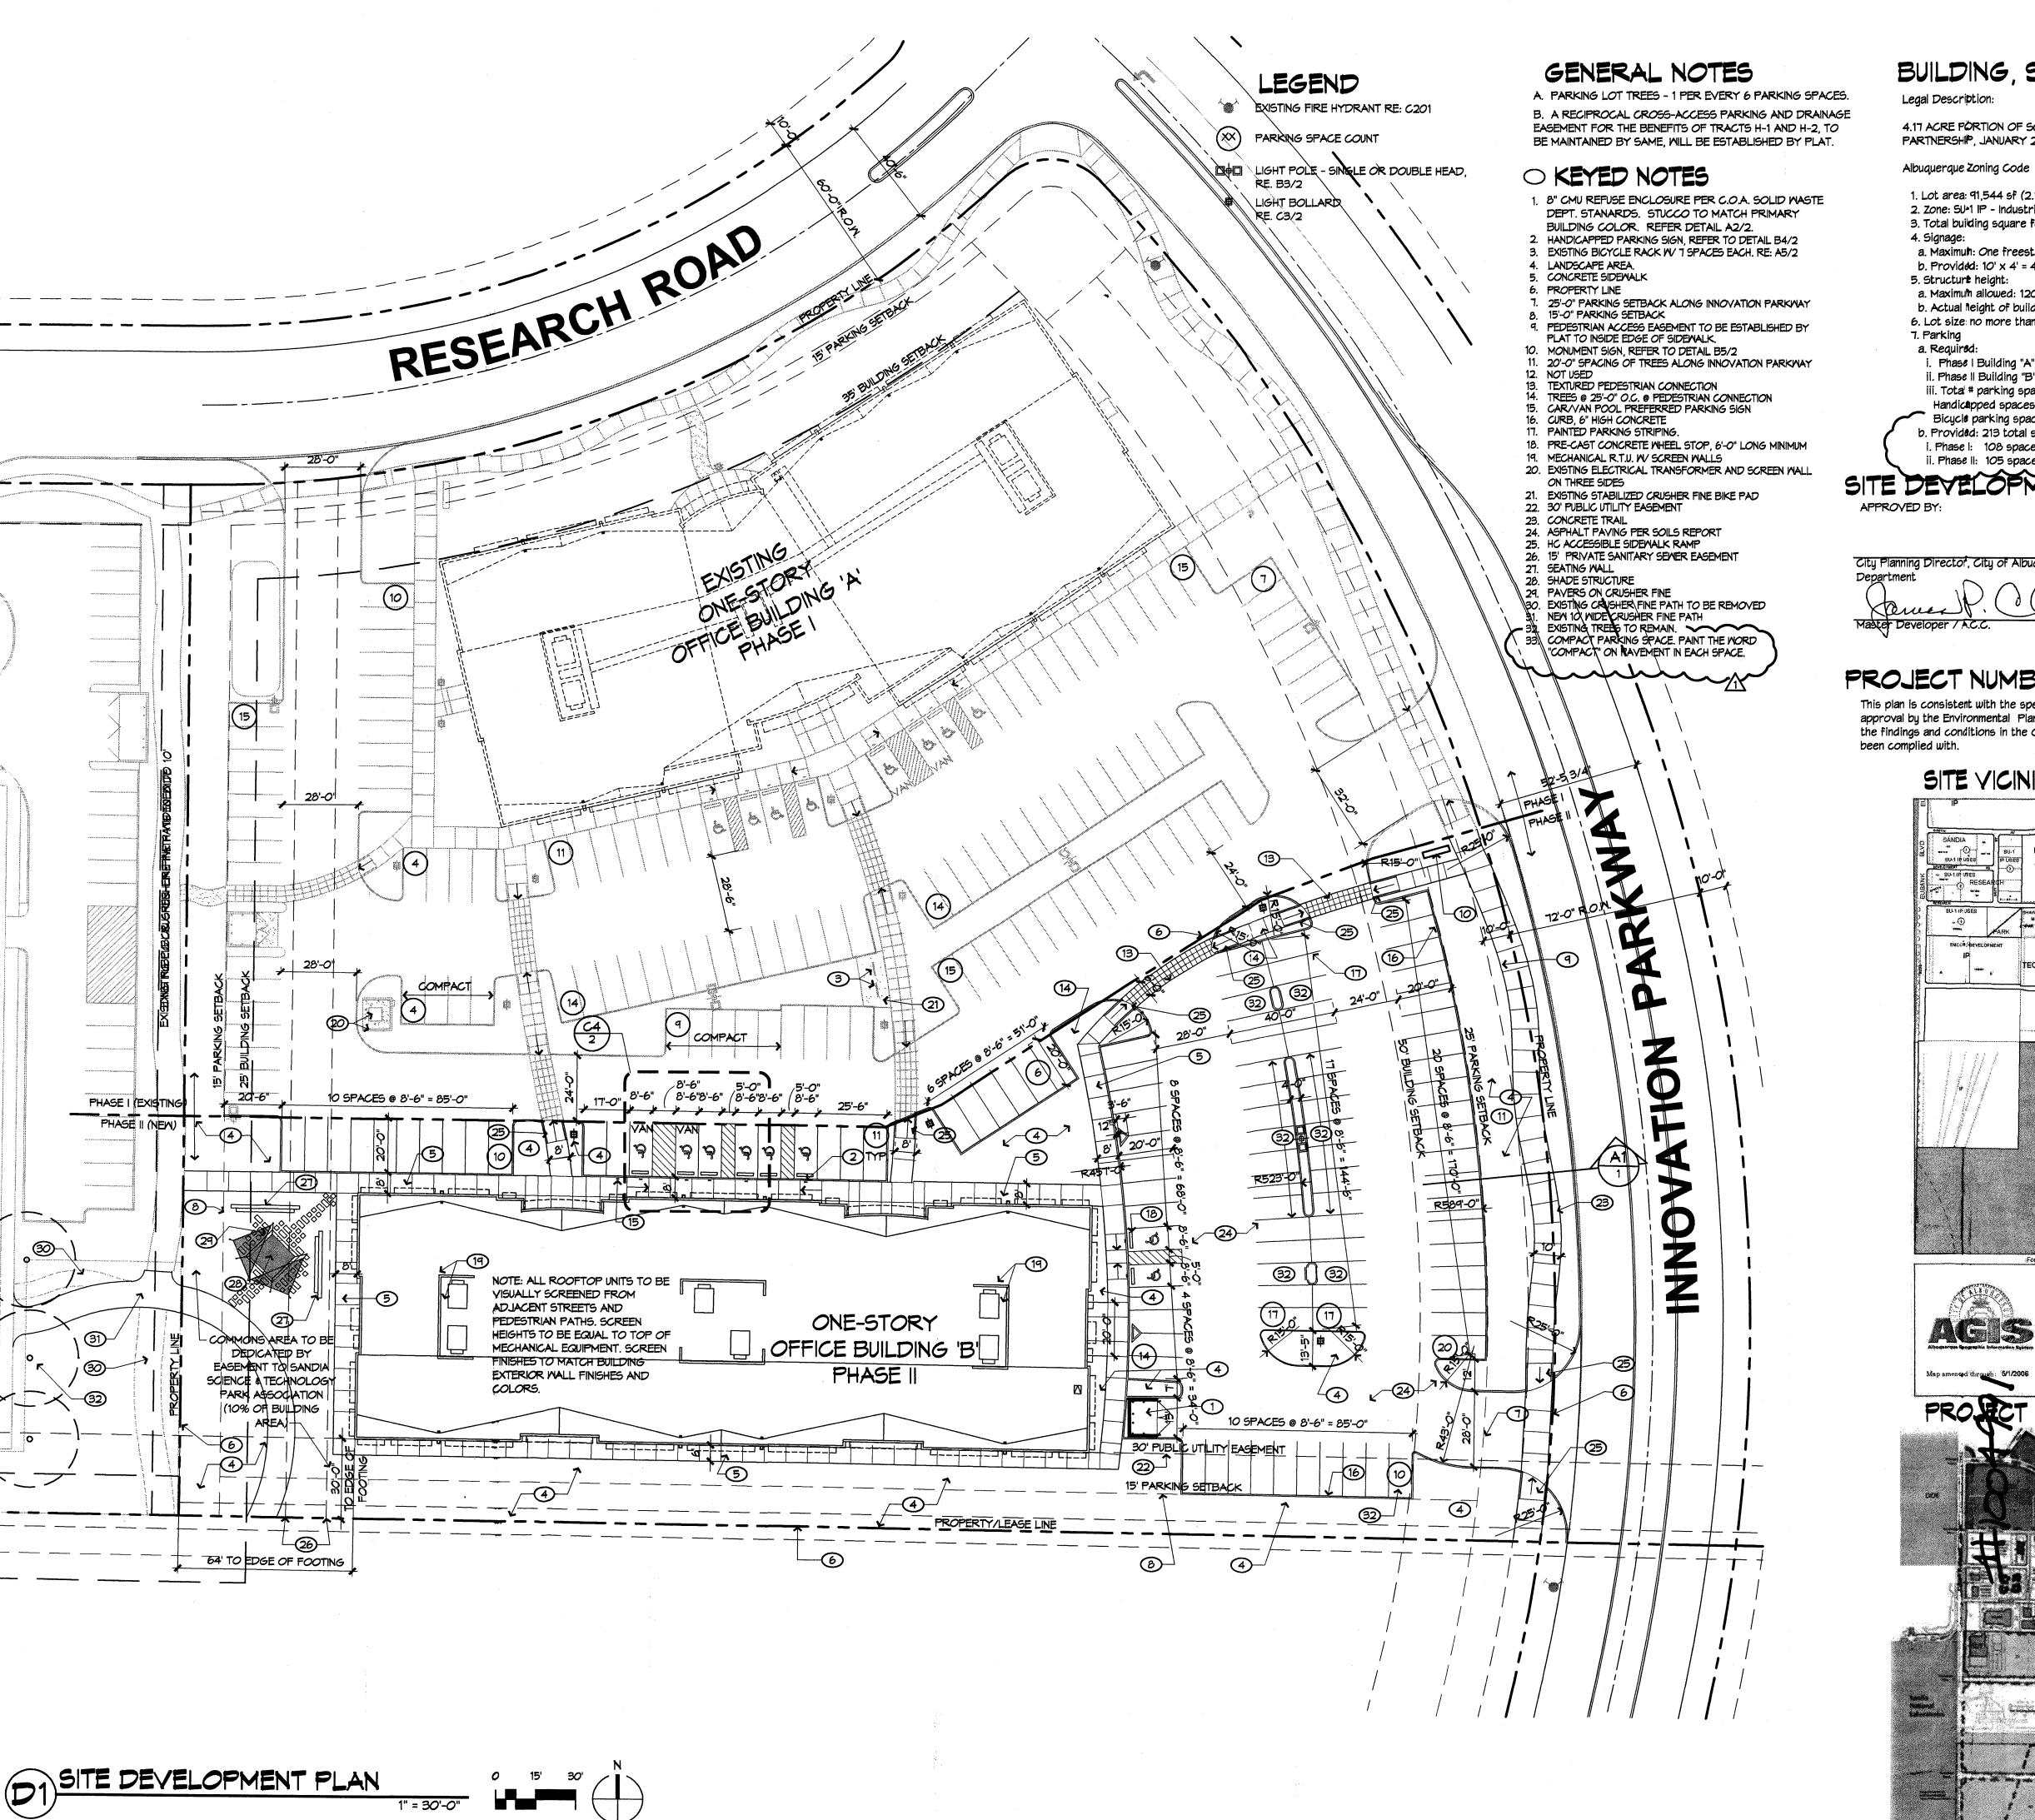
DATE 09/23/05 PROJECT NO. 05028 DRAWING NAME

UTILITY PLAN

SHEET NO.

P: \050333\cdp\general\050333up01.dwg, 24x36 March 31, 2006 — 2:19pm



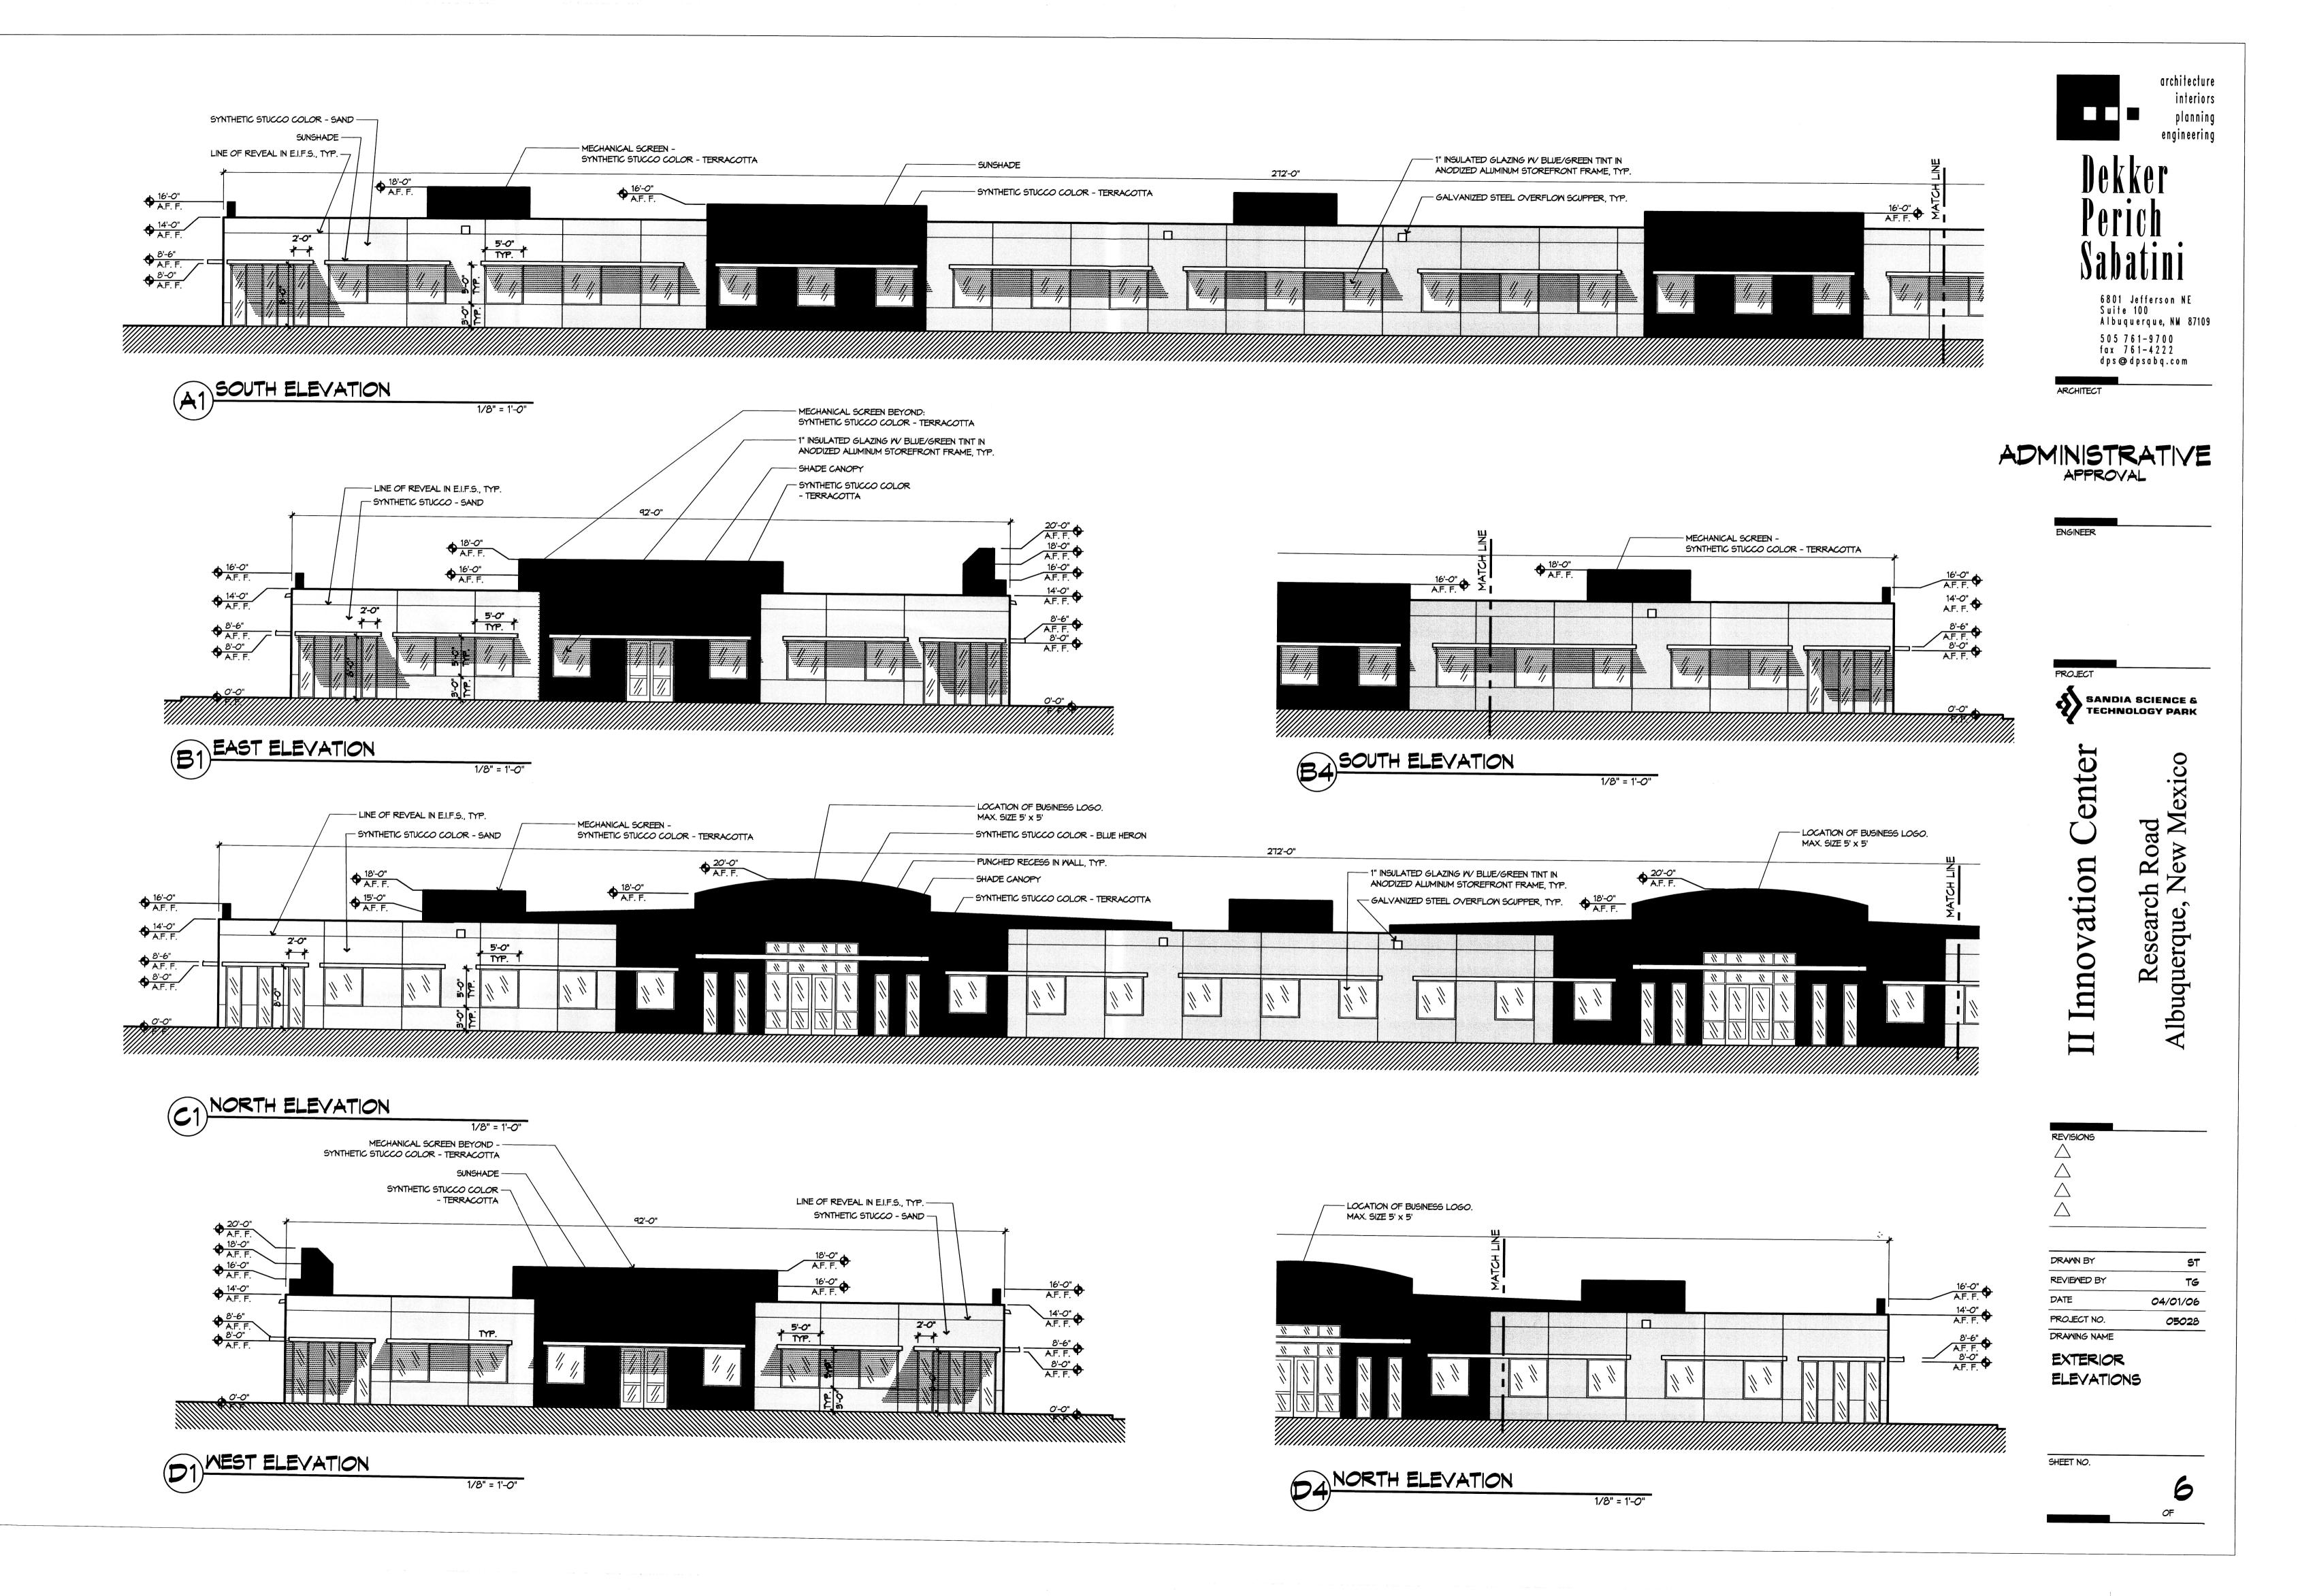

### BUILDING, SITE & PARKING DATA

### Legal Description:

4.17 ACRE PORTION OF SOUTHWEST CORNER OF TRACT A, LANDS OF SHAW, MITCHELL MALLORY PARTNERSHIP, JANUARY 22, 1999, VOLUME 99C, FOLIO 14

1. Lot area: 91,544 sf (2.1 acres.) 2. Zone: SU-1 IP - Industrial Park

3. Total building square footage: 24,628 SF

4. Signage: a. Maximum: One freestanding (monumental) sign, 50 sf/face

b. Provided: 10' x 4' = 40 sf/face

5. Structurt height: a. Maximum allowed: 120' or less than 45° from property line

b. Actual Neight of building: 20' (outside of 45°) 6. Lot size no more than 50% buildings (24,628 / 91,544 = 27% < 50%) = .27 F.A.R.

a. Required:

i. Phase | Building "A": 25,475 x 85% = 21,654 sf net leasable area, / 200 = 108 spaces ii. Phase II Building "B": 24,628 x 85% = 20,934 sf net leasable area, / 200 = 105 spaces

iii. Total # parking spaces required = 213

Handicapped spaces required: 16, provided: 16 (Phases | & ||)

Bicycle parking spaces required: 213 / 20 = 11, provided: 14 b. Provided: 213 total spaces (incl. 16 H.C. & 20 compact)

i. Phase I: 108 spaces provided ii. Phase II: 105 spaces provided

8/16/06 Date

ADMINISTRATIVE

ARCHITECT

architecture

interiors

planning

engineering

6801 Jefferson NE

Albuquerque, NM 87109

Suite 100

505 761-9700

fax 761-4222

SANDIA SCIENCE & TECHNOLOGY PARK

Albuquerque


dps@dpsabq.com


ENGINEER


### PROJECT NUMBER:


This plan is consistent with the specific site development plan for subdivision approval by the Environmental Planning Commission on March 22, 2001 and that the findings and conditions in the Official Notice; Notification of Decision have been complied with.

### SITE VICINITY MAP

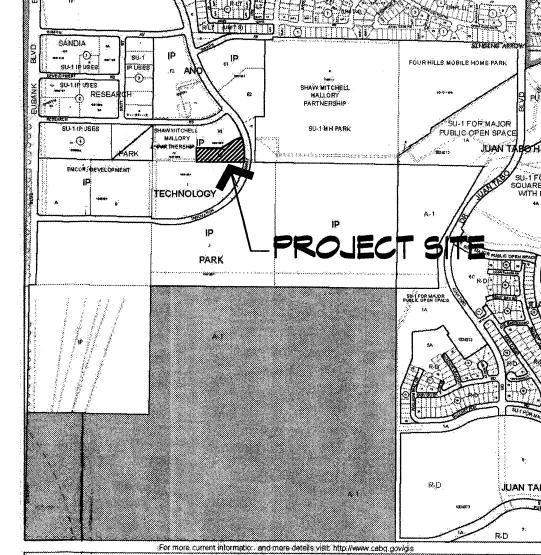

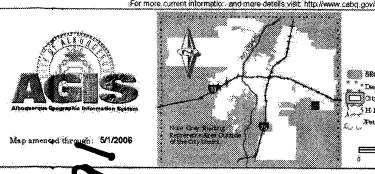

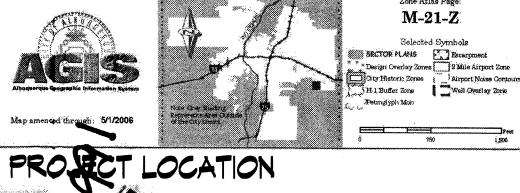

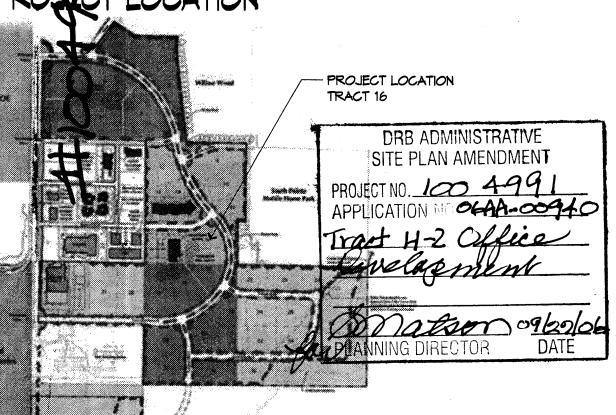


SANDIA SCIENCE 6

8-11-06 COA comments

DRAWN BY REVIEWED BY DATE 04/01/06 PROJECT NO.


BUILDING PERMIT

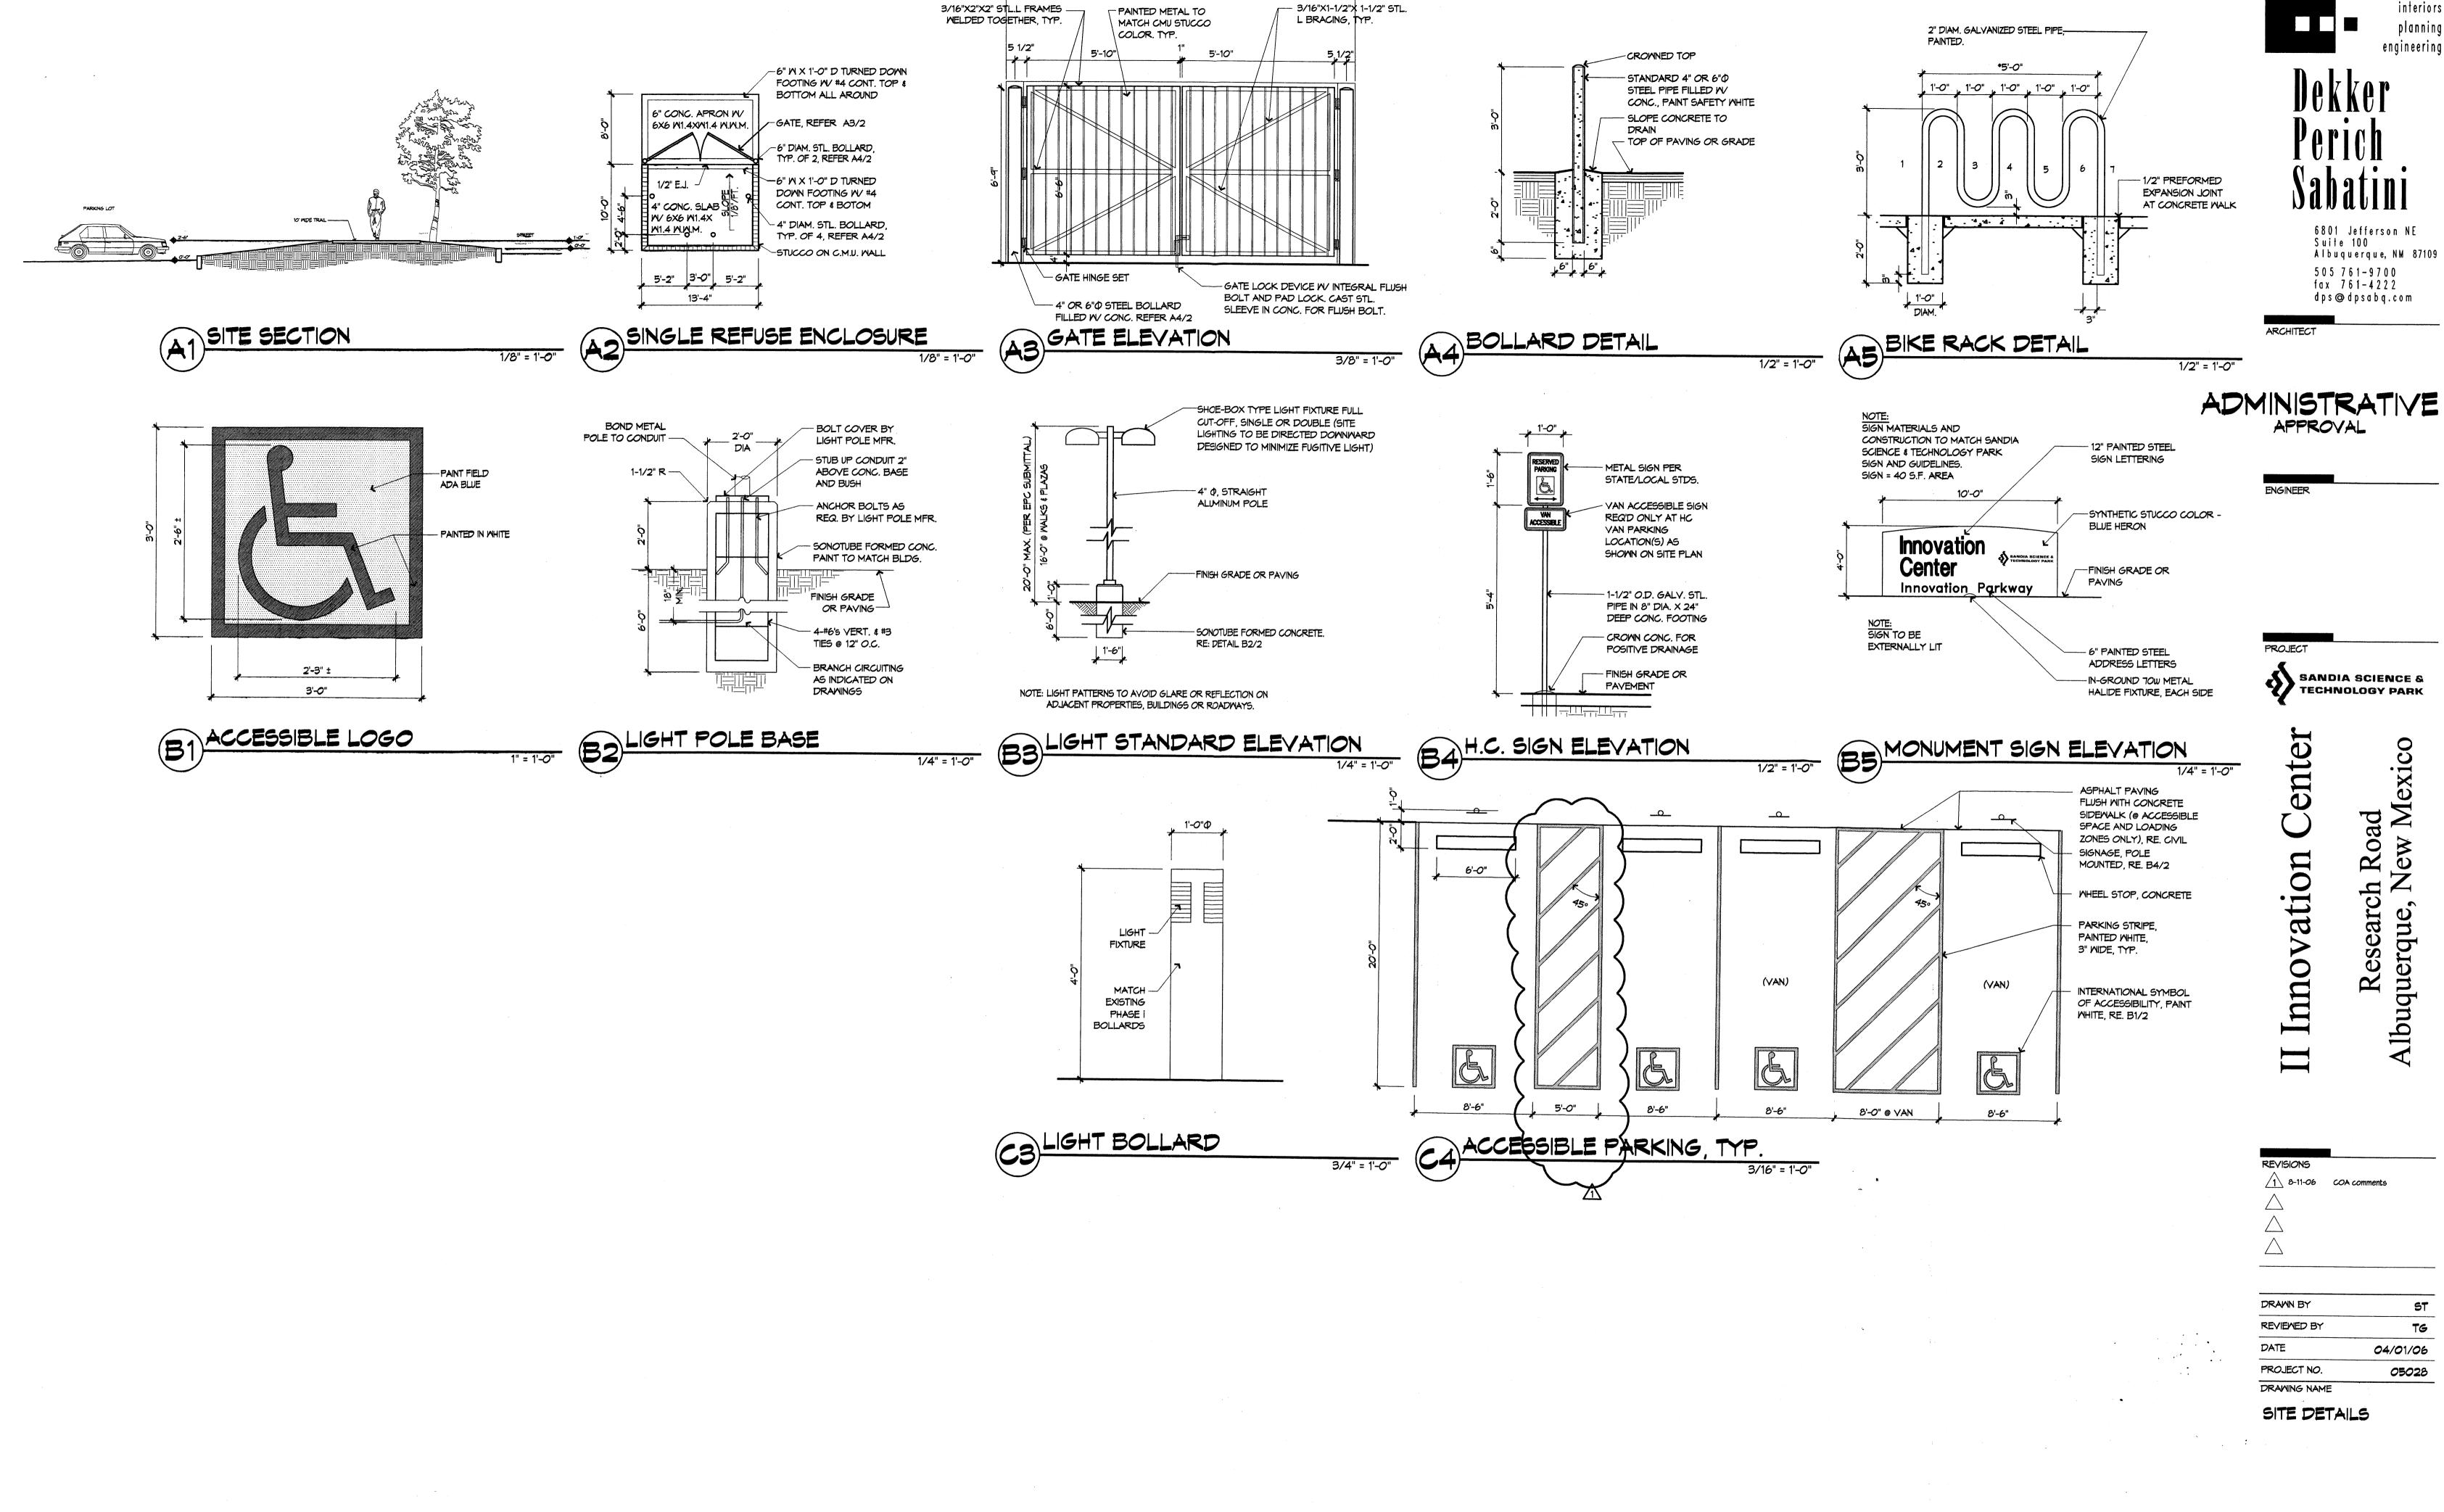

13'-4"

architecture interiors planning engineering

Albuquerque, NM 87109

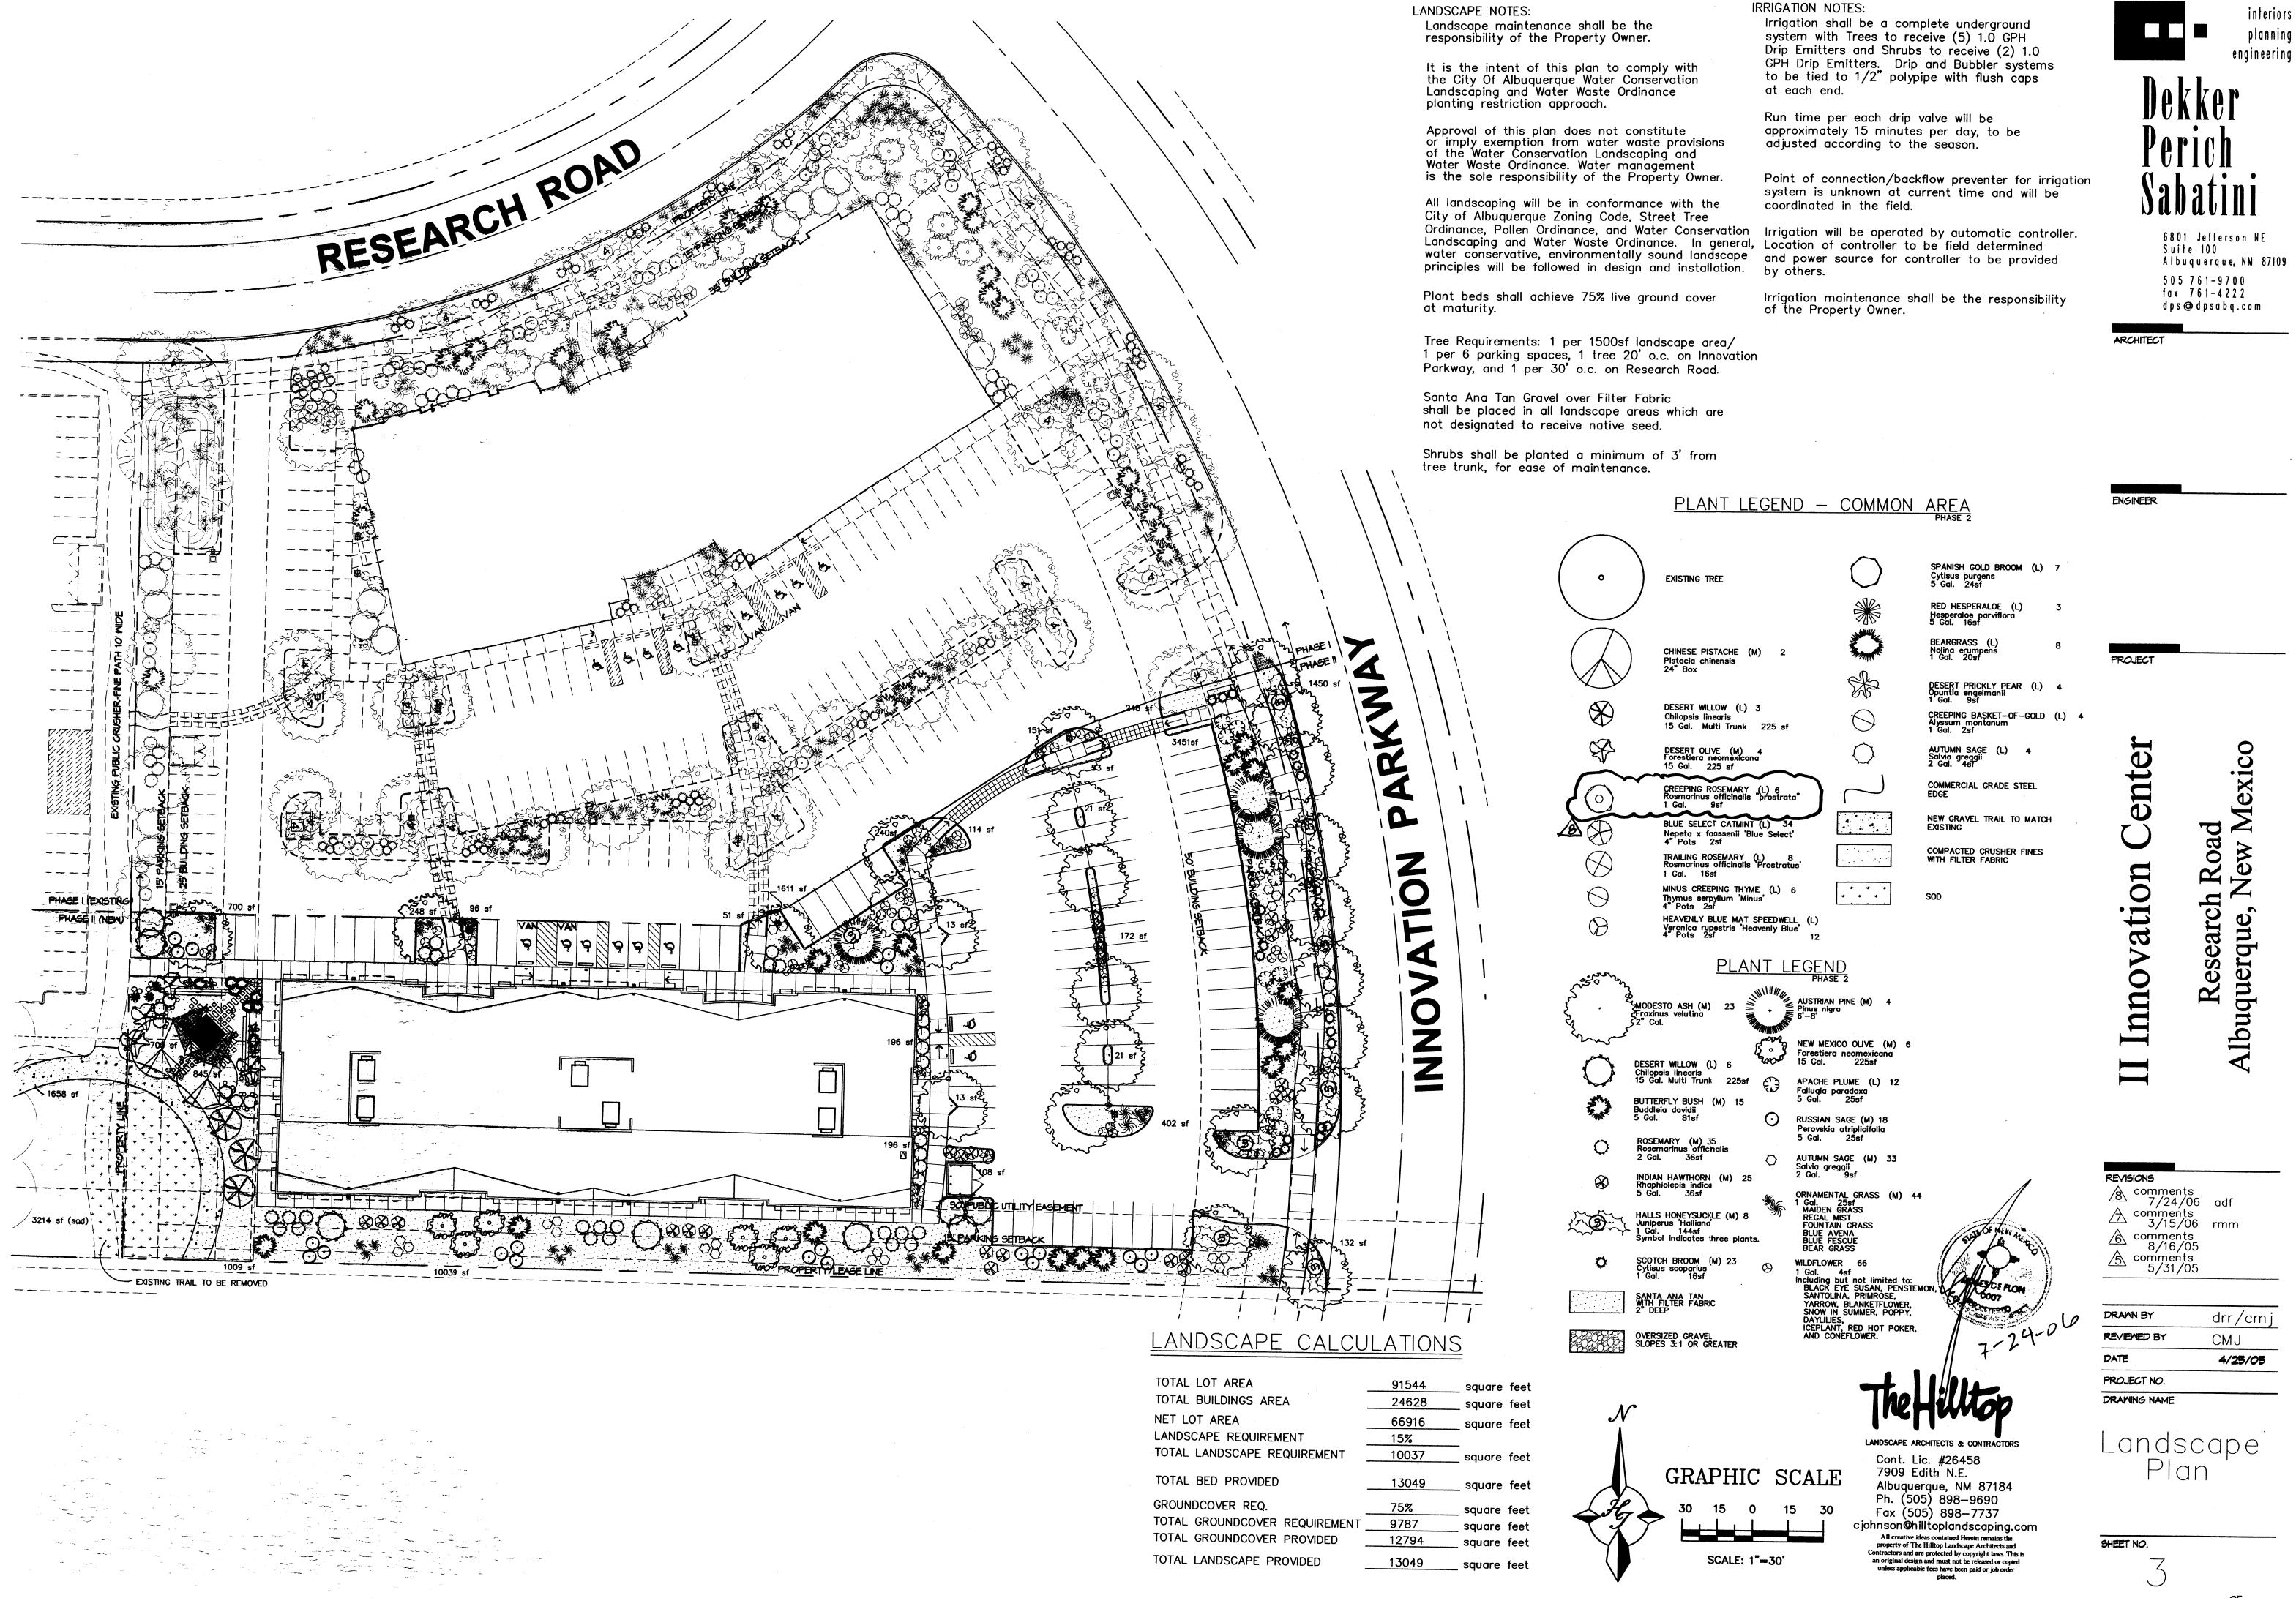

**建物设置的**类似的特殊的人。

interiors planning

OPPORTUNITY AVE SE

City of Albuquerque 350002

FLOOD INSURANCE RATE MAP FEMA MAP # 35001C 0367F

**LEGAL DESCRIPTION** 

ACS ALUMINUM CAP STAMPED "6-L21, 1986" INTERSECTION OF CENTRAL AVE. & ELIZABETH ST.

Tract H, Sandia Science and Technology Park

**BENCHMARK** 

ELEV=5503.35 NAVD 88

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**GRADING NOTES** 

TO THE PROJECT COST.


(SECOND PRIORITY).

WITH THE DETAILS SHOWN ON THIS PLAN.

2. INSTALL CONCRETE RIBBON CHANNEL PER DETAIL 1 THIS SHEET.

DEVELOPMENT

RESEARCH RD SE

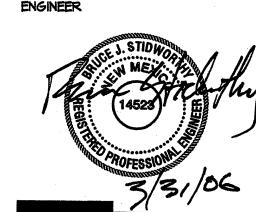

# n P ew vation Innovation querque, Nev 1501 Innovati Albuquerque, ]

REVISIONS

DRAWN BY	B0
REVIEWED BY	BJS
DATE	09/06/05
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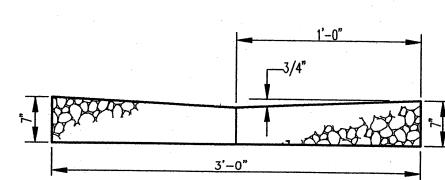
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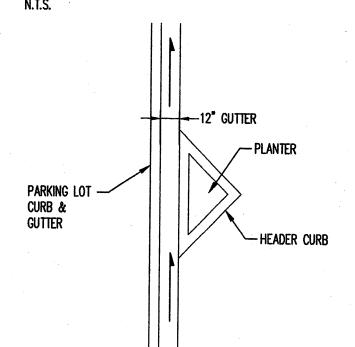
SHEET NO.

PARTNERSH

**LOCATION MAP** 

RIBBON CHANNEL TYPICAL SECTION





				Inno	vation P	ark Phas	se II			
				Proposed	Condition	s Basin Da	ata Table			······································
~ Thi	s table is bas	ed on the l	OPM Section	n 22.2, Zone:	3	-	***			***************************************
Basin	Area	Area	Land Treatment Percentages			Q(100)	Q(100)	V(100)	V(100)	
ID	(SQ. FT)	(AC.)	A	В	C	D	(cfs/ac.)	(CFS)	(inches)	(CF)
<b>Existing</b>	Conditions	3	:						1	
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1.08 ACRE

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II. SITE LOCATION AND EXISTING CONDITIONS


The project site is located on the southwest corner of Innovation Parkway and Research Road. The site is located within zone atlas map # M-21-Z, and Technology Park allows a discharge of 1.57cfs per acre. The full site (Phase I and Phase II) is 4.79 acres which results in maximum allowable runoff of 7.52cfs.


## Bohannan A Huston

Courtyard i 7500 Jefferson St. NE Albuquerque, NM 87109-4335 ENGINEERING . SPATIAL DATA . ADVANCED TECHNOLOGIES

SCALE: 1"=40'

ZONE ATLAS INDEX MAP No. M-21-Z

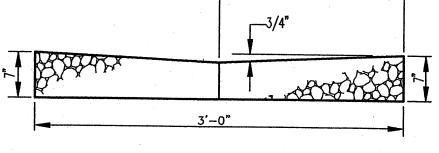

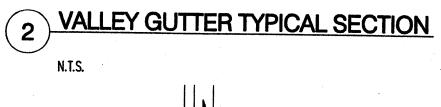

3 GUTTER DETAIL AT PLANTER

DRAWN BY	
REVIEWED BY	
DATE	09/6

DRAWING NAME

95.70 4.28 15.97.20 T5.97.38

FL95.00

1 FL95.10 95.80

and the first the father with the contract

### **GENERAL NOTES**

- 1. ALL WORK DETAILED ON THESE PLANS AND PERFORMED UNDER THIS CONTRACT SHALL BE CONSTRUCTED IN ACCORDANCE WITH THE PROJECT SPECIFICATIONS AND THE PROJECT GEOTECHNICAL REPORT. WHERE APPLICABLE, CITY OF ALBUQUERQUE PUBLIC WORKS STANDARDS SHALL APPLY.
- 2. THE CONTRACTOR SHALL ABIDE BY ALL LOCAL, STATE, AND FEDERAL LAWS, RULES AND REGULATIONS WHICH APPLY TO THE CONSTRUCTION OF THESE IMPROVEMENTS, INCLUDING EPA REQUIREMENTS WITH RESPECT TO STORM WATER DISCHARGE.
- 3. PRIOR TO CONSTRUCTION, THE CONTRACTOR SHALL FIELD VERIFY THE HORIZONTAL AND VERTICAL LOCATIONS OF ALL POTENTIAL OBSTRUCTIONS INCLUDING ALL UNDERGROUND UTILITIES. SHOULD A CONFLICT EXIST, THE CONTRACTOR SHALL NOTIFY THE CONSTRUCTION OBSERVER OR ENGINEER SO THAT THE CONFLICT CAN BE RESOLVED WITH A MINIMUM AMOUNT OF DELAY.
- 4. TWO (2) WORKING DAYS PRIOR TO ANY EXCAVATION, THE CONTRACTOR SHALL CONTACT LINE LOCATING SERVICE FOR LOCATION OF EXISTING UTILITIES.
- 5. ALL ELECTRICAL, TELEPHONE, CABLE TV, GAS AND OTHER UTILITY LINES, CABLES, AND APPURTENANCES ENCOUNTERED DURING CONSTRUCTION THAT REQUIRE RELOCATION, SHALL BE COORDINATED WITH THAT UTILITY. THE CONTRACTOR SHALL BE RESPONSIBLE FOR COORDINATION OF ALL NECESSARY UTILITY ADJUSTMENTS. NO ADDITIONAL COMPENSATION WILL BE ALLOWED FOR DELAYS OR INCONVENIENCES CAUSED BY UTILITY COMPANY WORK CREWS. THE CONTRACTOR MAY BE REQUIRED TO RESCHEDULE HIS ACTIVITIES TO ALLOW UTILITY CREWS TO PERFORM THEIR REQUIRED WORK.
- 6. THE CONTRACTOR IS RESPONSIBLE FOR PROTECTING ALL EXISTING UTILITY LINES WITHIN THE CONSTRUCTION AREA. ANY DAMAGE TO EXISTING FACILITIES CAUSED BY CONSTRUCTION ACTIVITY SHALL BE REPAIRED OR REPLACED AT THE CONTRACTOR'S EXPENSE AND APPROVED BY THE CONSTRUCTION OBSERVER.
- 7. CONSTRUCTION ACTIVITY SHALL BE LIMITED TO THE PROPERTY AND/OR PROJECT LIMITS. ANY DAMAGE TO ADJACENT PROPERTIES RESULTING FROM THE CONSTRUCTION PROCESS SHALL BE REPAIRED OR REPLACED AT THE CONTRACTOR'S EXPENSE.
- 8. OVERNIGHT PARKING OF CONSTRUCTION EQUIPMENT SHALL NOT OBSTRUCT DRIVEWAYS OR DESIGNATED TRAFFIC LANES. THE CONTRACTOR SHALL NOT STORE ANY EQUIPMENT OR MATERIAL WITHIN THE PUBLIC RIGHT-OF-WAY.
- 9. THE CONTRACTOR SHALL OBTAIN ALL THE NECESSARY PERMITS FOR THE PROJECT PRIOR TO COMMENCING CONSTRUCTION (I.E., BARRICADING, TOPSOIL DISTURBANCE, EXCAVATION PERMITS, EPA STORM WATER PERMITS, ETC.).
- 10. ALL PROPERTY CORNERS DESTROYED DURING CONSTRUCTION SHALL BE REPLACED AT THE CONTRACTOR'S EXPENSE. ALL PROPERTY CORNERS MUST BE RESET BY A REGISTERED LAND SURVEYOR.
- 11. THE CONTRACTOR SHALL PREPARE A CONSTRUCTION TRAFFIC CONTROL AND SIGNING PLAN AND OBTAIN APPROVAL OF SUCH PLAN FROM THE CITY OF ALBUQUERQUE, TRAFFIC ENGINEERING DEPARTMENT, PRIOR TO BEGINNING ANY CONSTRUCTION WORK ON OR ADJACENT TO EXISTING STREETS.
- 12. ALL BARRICADES AND CONSTRUCTION SIGNING SHALL CONFORM TO APPLICABLE SECTIONS OF THE "MANUAL ON UNIFORM TRAFFIC CONTROL DEVICES" (MUTCD),


  13. THE CONTRACTOR SHALL MAINTAIN ALL CONSTRUCTION DEVICES AND CONSTRUCTION OF THE "MANUAL ON UNIFORM TRAFFIC CONTROL DEVICES" (MUTCD),
- THE CONTRACTOR SHALL MAINTAIN ALL CONSTRUCTION BARRICADES AND SIGNING AT ALL TIMES. THE CONTRACTOR SHALL VERIFY THE PROPER LOCATION OF ALL BARRICADING AT THE END AND BEGINNING OF EACH DAY.
   THE CONTRACTOR SHALL TAKE ALL STEPS NECESSARY TO CONFORM WITH EPA REQUIREMENTS, INCLUDING COMPLIANCE WITH NPDES PHASE 2 REQUIREMENTS.

### UTILITY NOTES


- 1. THIS CONTRACTOR SHALL BE RESPONSIBLE FOR THE COMPLETE INSTALLATION OF ALL WORK RELATED TO MECHANICAL UTILITIES AS SHOWN ON THIS PLAN INCLUDING: TRENCHING, BACKFILL, SUPPORTS, CLEANOUT PADS, SERVICE STOPS AND BOXES, SERVICE LINES, TESTING, CLEANING, AND STERILIZING. ANY WORK NOT ACCEPTED BY THE ARCHITECT OR ENGINEER DUE TO IMPROPER WORKMANSHIP OR LACK OF PROPER COORDINATION SHALL BE REMOVED AND CORRECTLY INSTALLED AT THE CONTRACTOR'S EXPENSE, AS DIRECTED.
- 2. MINIMUM DEPTHS OF COVER SHALL BE: 48" FOR WATERLINES AND 48" FOR SEWER, EXCEPT AT BUILDING CONNECTION.
- 3. ALL WORK DETAILED ON THESE PLANS TO BE PERFORMED UNDER CONTRACT SHALL, EXCEPT AS OTHERWISE STATED OR PROVIDED OF HEREON, BE CONSTRUCTED IN ACCORDANCE WITH THE IAPMO UNIFORM PLUMBING CODE, LATEST EDITION.
- 4. UTILITY LINES SHALL BE INSTALLED PRIOR TO PAVEMENT, CURB AND GUTTER, AND/OR SIDEWALK, AS APPLICABLE.
  5. ROUGH GRADING OF SITE (±0.5') SHALL BE COMPLETED PRIOR TO INSTALLATION OF
- 6. CONTRACTOR WILL BE RESPONSIBLE FOR CONNECTIONS TO BUILDING DRAIN LINES AND ALL NECESSARY FITTINGS.
- 7. ALL VALVES SHALL BE ANCHORED PER COA STANDARD DWG. 2333.
- 8. FIRE LINES SHALL USE PIPE MATERIALS UNDERWRITERS LABORATORIES LISTED AND APPROVED FOR FIRE SERVICE.
- 9. CONTRACTOR SHALL BE RESPONSIBLE FOR ALL WATER METER, FIRE LINE, AND SEWER HOOKUP FEES FOR INSTALLATIONS. OWNER SHALL BE RESPONSIBLE FOR UTILITY EXPANSION CHARGES, PRORATA AND OTHER SPECIAL ASSESSMENTS.
- 10. CONTRACTOR SHALL VERIFY INVERTS AND LOCATIONS OF EXISTING WATER/SAS LINES PRIOR TO BEGINNING WORK. ALL CONFLICTS SHALL BE BROUGHT TO ATTENTION OF THE ENGINEER AND RESOLVED PRIOR TO BEGINNING WORK.

### O UTILITY KEYED NOTES

- A. EXISTING WATER SERVICE LINE,
- B. INSTALL NEW 1 1/2" WATER METER & METER BOX.
- C. STUB TO WITHIN 5' OF BUILDING, SEE PLUMBING PLANS FOR CONTINUATION.
- D. TIE NEW 6" FIRE LINE TO EXISTING 6" STUB OUT.
- E. TIE NEW 6" SAS TO EXISTING SAS STUB OUT.
- F. EXISTING SAS SERVICE LINE, NOT USED.
- G. CONSTRUCT CLEANOUT PER DETAIL THIS SHEET.

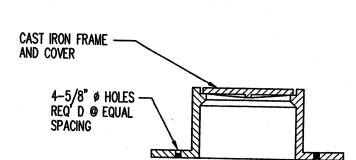


## CLEANOUT FRAME & COVER N.T.S.

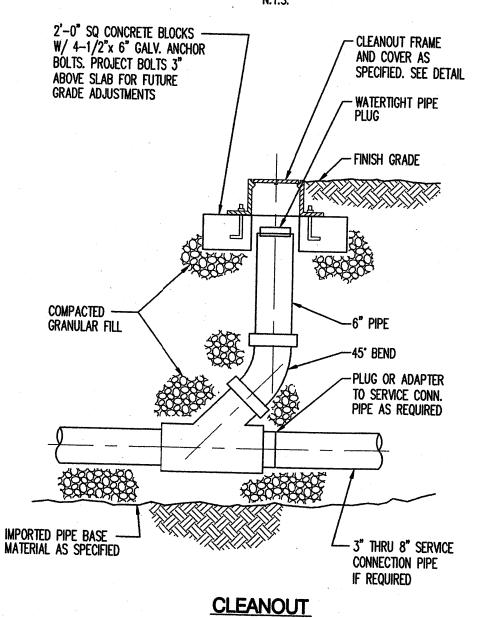

## Bohannan ▲ Huston≅

Courtyard i 7500 Jefferson St. NE Albuquerque, NM 87109-4335
ENGINEERING & SPATIAL DATA & ADVANCED TECHNOLOGIES

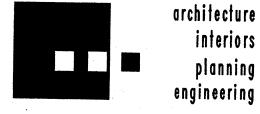

**BENCHMARK** 


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ACS ALUMINUM CAP STAMPED "6-L21, 1986" INTERSECTION OF CENTRAL AVE. & ELIZABETH ST.

## Dekker Perich Sahatini

6801 Jefferson NE Suite 100 Albuquerque, NM 87109 505761-9700 fax 761-4222 dps@dpsabq.com

ARCHITECT POPULATION APPROVAL

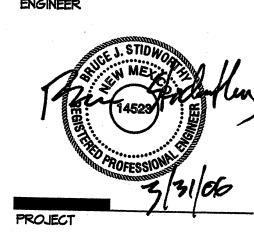

nnovation Center


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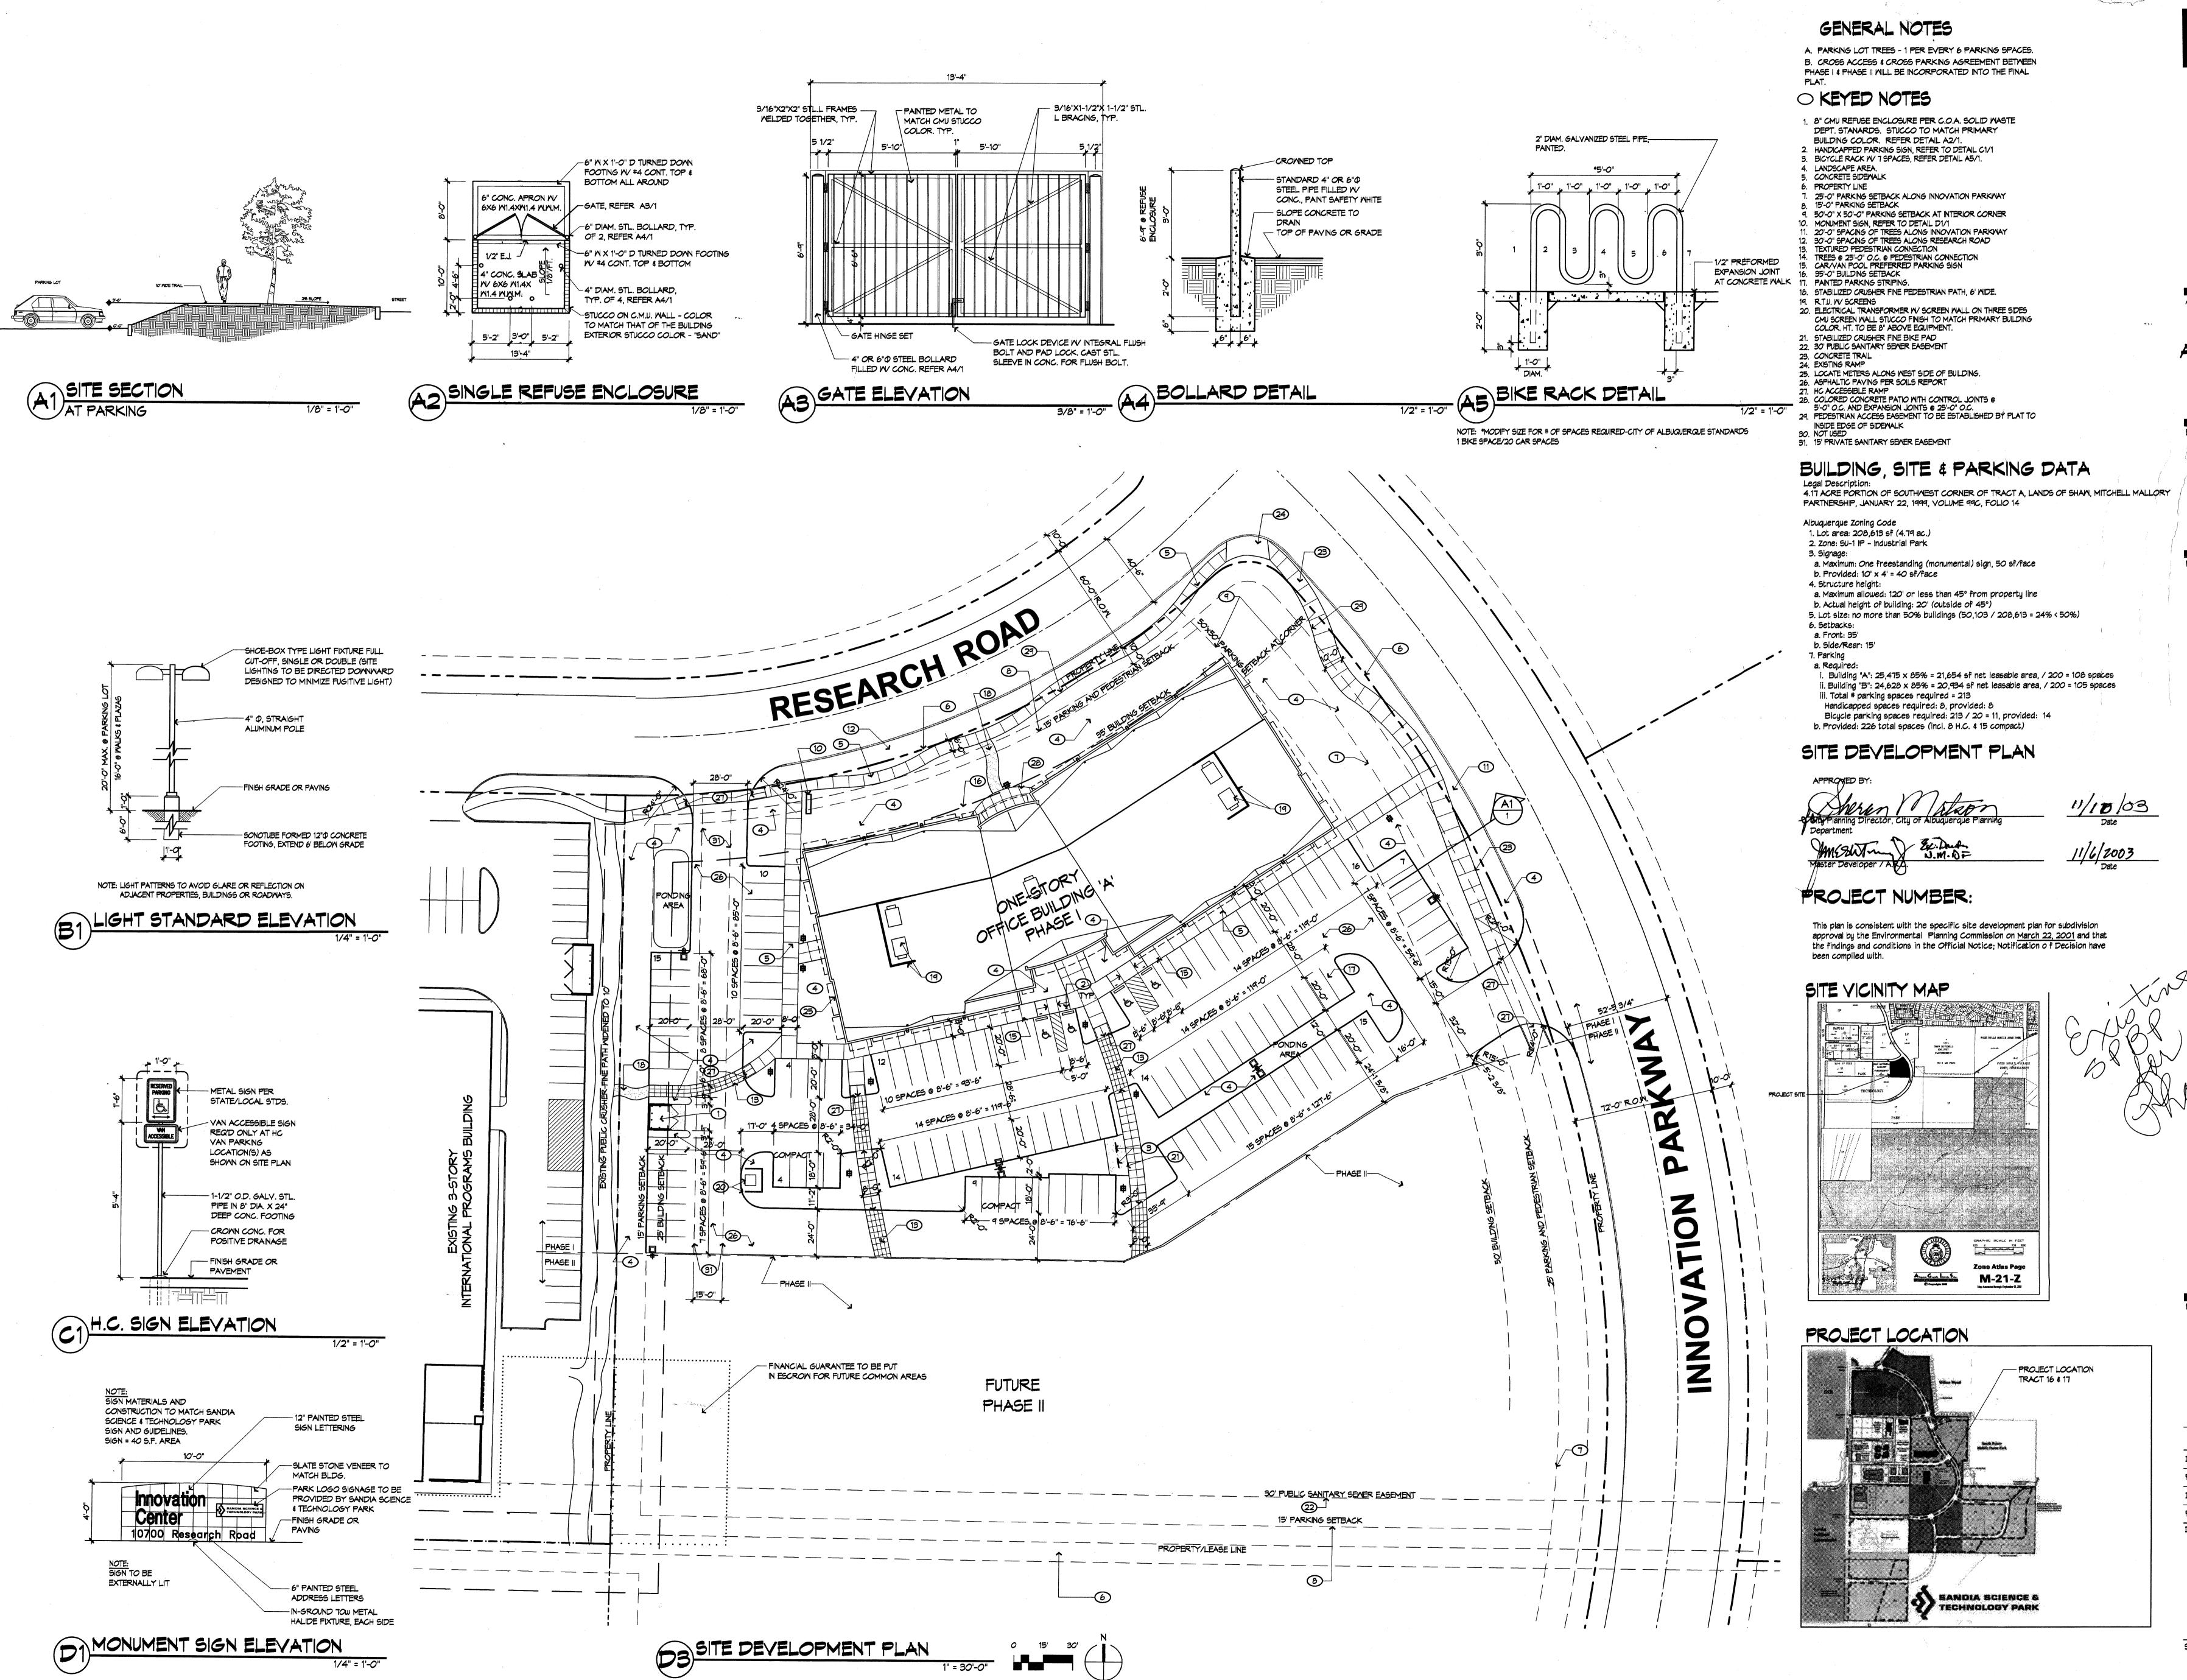
UTILITY

SHEET NO.

5

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architecture. interiors

6801 Jefferson NE Suite 100 Albuquerque, NM 87109 505 761-9700 fax 761-4222 dps@dpsabq.com

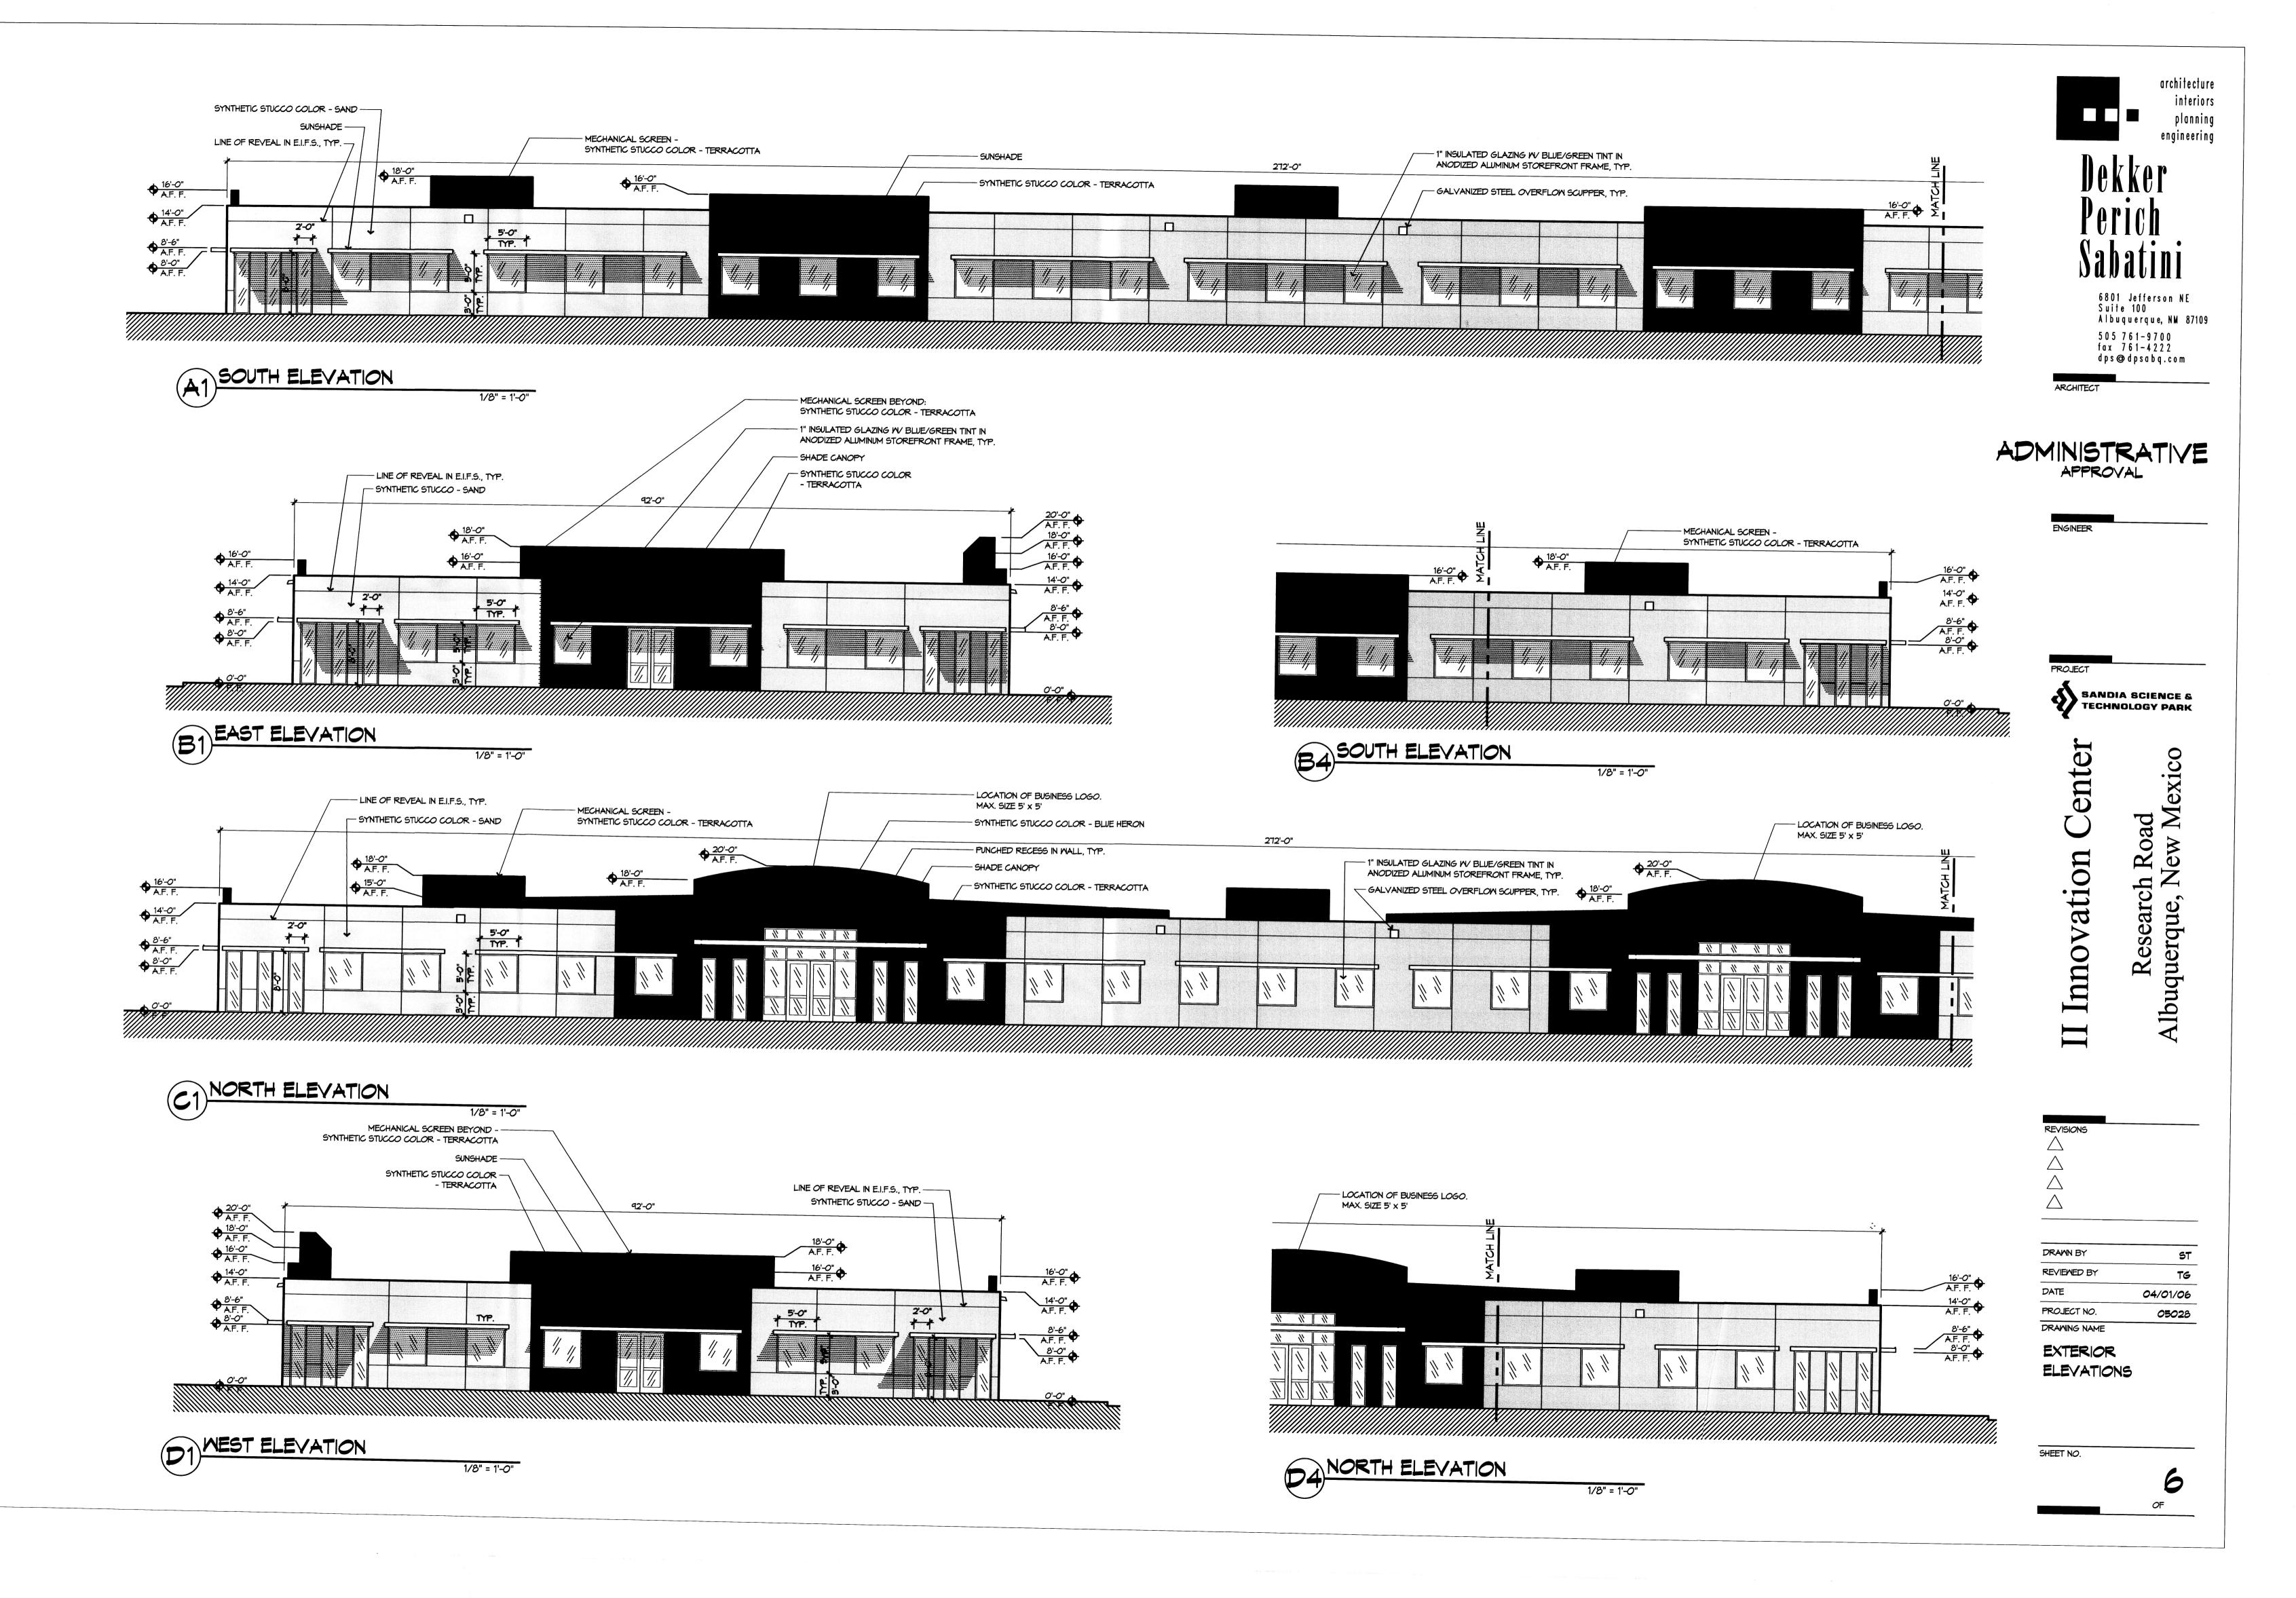ADMINISTRATIVE APPROVAL

SANDIA SCIENCE & TECHNOLOGY PARK

**AMELANG PARTNERS INC** DESIGN • BUILD • DEVEL

DRAWN BY SAS REVIEWED BY TG DATE 10/03/03 PROJECT NO. 03040.001 DRAWING NAME

SITE DEVELOPMENT PLAN FOR BUILDING PERMIT

LANDSCAPE NOTES: Landscape maintenance shall be the responsibility of the Property Owner.

It is the intent of this plan to comply with the City Of Albuquerque Water Conservation Landscaping and Water Waste Ordinance planting restriction approach.

Approval of this plan does not constitute or imply exemption from water waste provisions of the Water Conservation Landscaping and Water Waste Ordinance. Water management is the sole responsibility of the Property Owner.

All landscaping will be in conformance with the City of Albuquerque Zoning Code, Street Tree Ordinance, Pollen Ordinance, and Water Conservation Landscaping and Water Waste Ordinance. In general, water conservative, environmentally sound landscape principles will be followed in design and installation.

Plant beds shall achieve 75% live ground cover at maturity.

Tree Requirements: 1 per 1500sf landscape area/ 1 per 6 parking spaces, 1 tree 20' o.c. on Innovation Parkway, and 1 per 30' o.c. on Research Road.

Santa Ana Tan Gravel over Filter Fabric shall be placed in all landscape areas which are not designated to receive native seed.

Shrubs shall be planted a minimum of 3' from tree trunk, for ease of maintenance.

IRRIGATION NOTES:

Irrigation shall be a complete underground system with Trees to receive (5) 1.0 GPH Drip Emitters and Shrubs to receive (2) 1.0 GPH Drip Emitters. Drip and Bubbler systems to be tied to 1/2" polypipe with flush caps at each end.

Run time per each drip valve will be approximately 15 minutes per day, to be adjusted according to the season.

Point of connection/backflow preventer for irrigation system is unknown at current time and will be coordinated in the field.

Irrigation will be operated by automatic controller. Location of controller to be field determined and power source for controller to be provided by others.


Irrigation maintenance shall be the responsibility of the Property Owner.


FINAL LANDSCAPING LAYOUT AND DESIGN TO BE DETERMINED UPON RECEIPT OF FINAL GRADING PLAN.

## LANDSCAPE CALCULATIONS


### NET LANDSCAPE AREA

NET LANDSCAPE AREA		
TOTAL LOT AREA	208613	_ square
TOTAL PHASE 1 AREA	117072	_ square
TOTAL BUILDINGS AREA	-25475	_ square
OFFSITE AREA	<b>-4957</b>	_ square
NET LOT AREA	86640	_ square
LANDSCAPE REQUIREMENT	15%	
TOTAL LANDSCAPE REQUIREMENT _	12996	_ square
TOTAL LANDSCAPE PROVIDED	33316	_ square
TOTAL SOD PROVIDED	0	_ square
TOTAL NATIVE SEED PROVIDED	0	_
TOTAL BED PROVIDED	33316	_ square
TOTAL PONDS PROVIDED	-1314	_ square
TOTAL MINUS PONDS	32002	_ square 1
GROUNDCOVER REQ.	75%	_ square 1
TOTAL GROUNDCOVER REQUIREMENT_	24001	_ square 1
TOTAL GROUNDCOVER PROVIDED	27064	 _ square 1

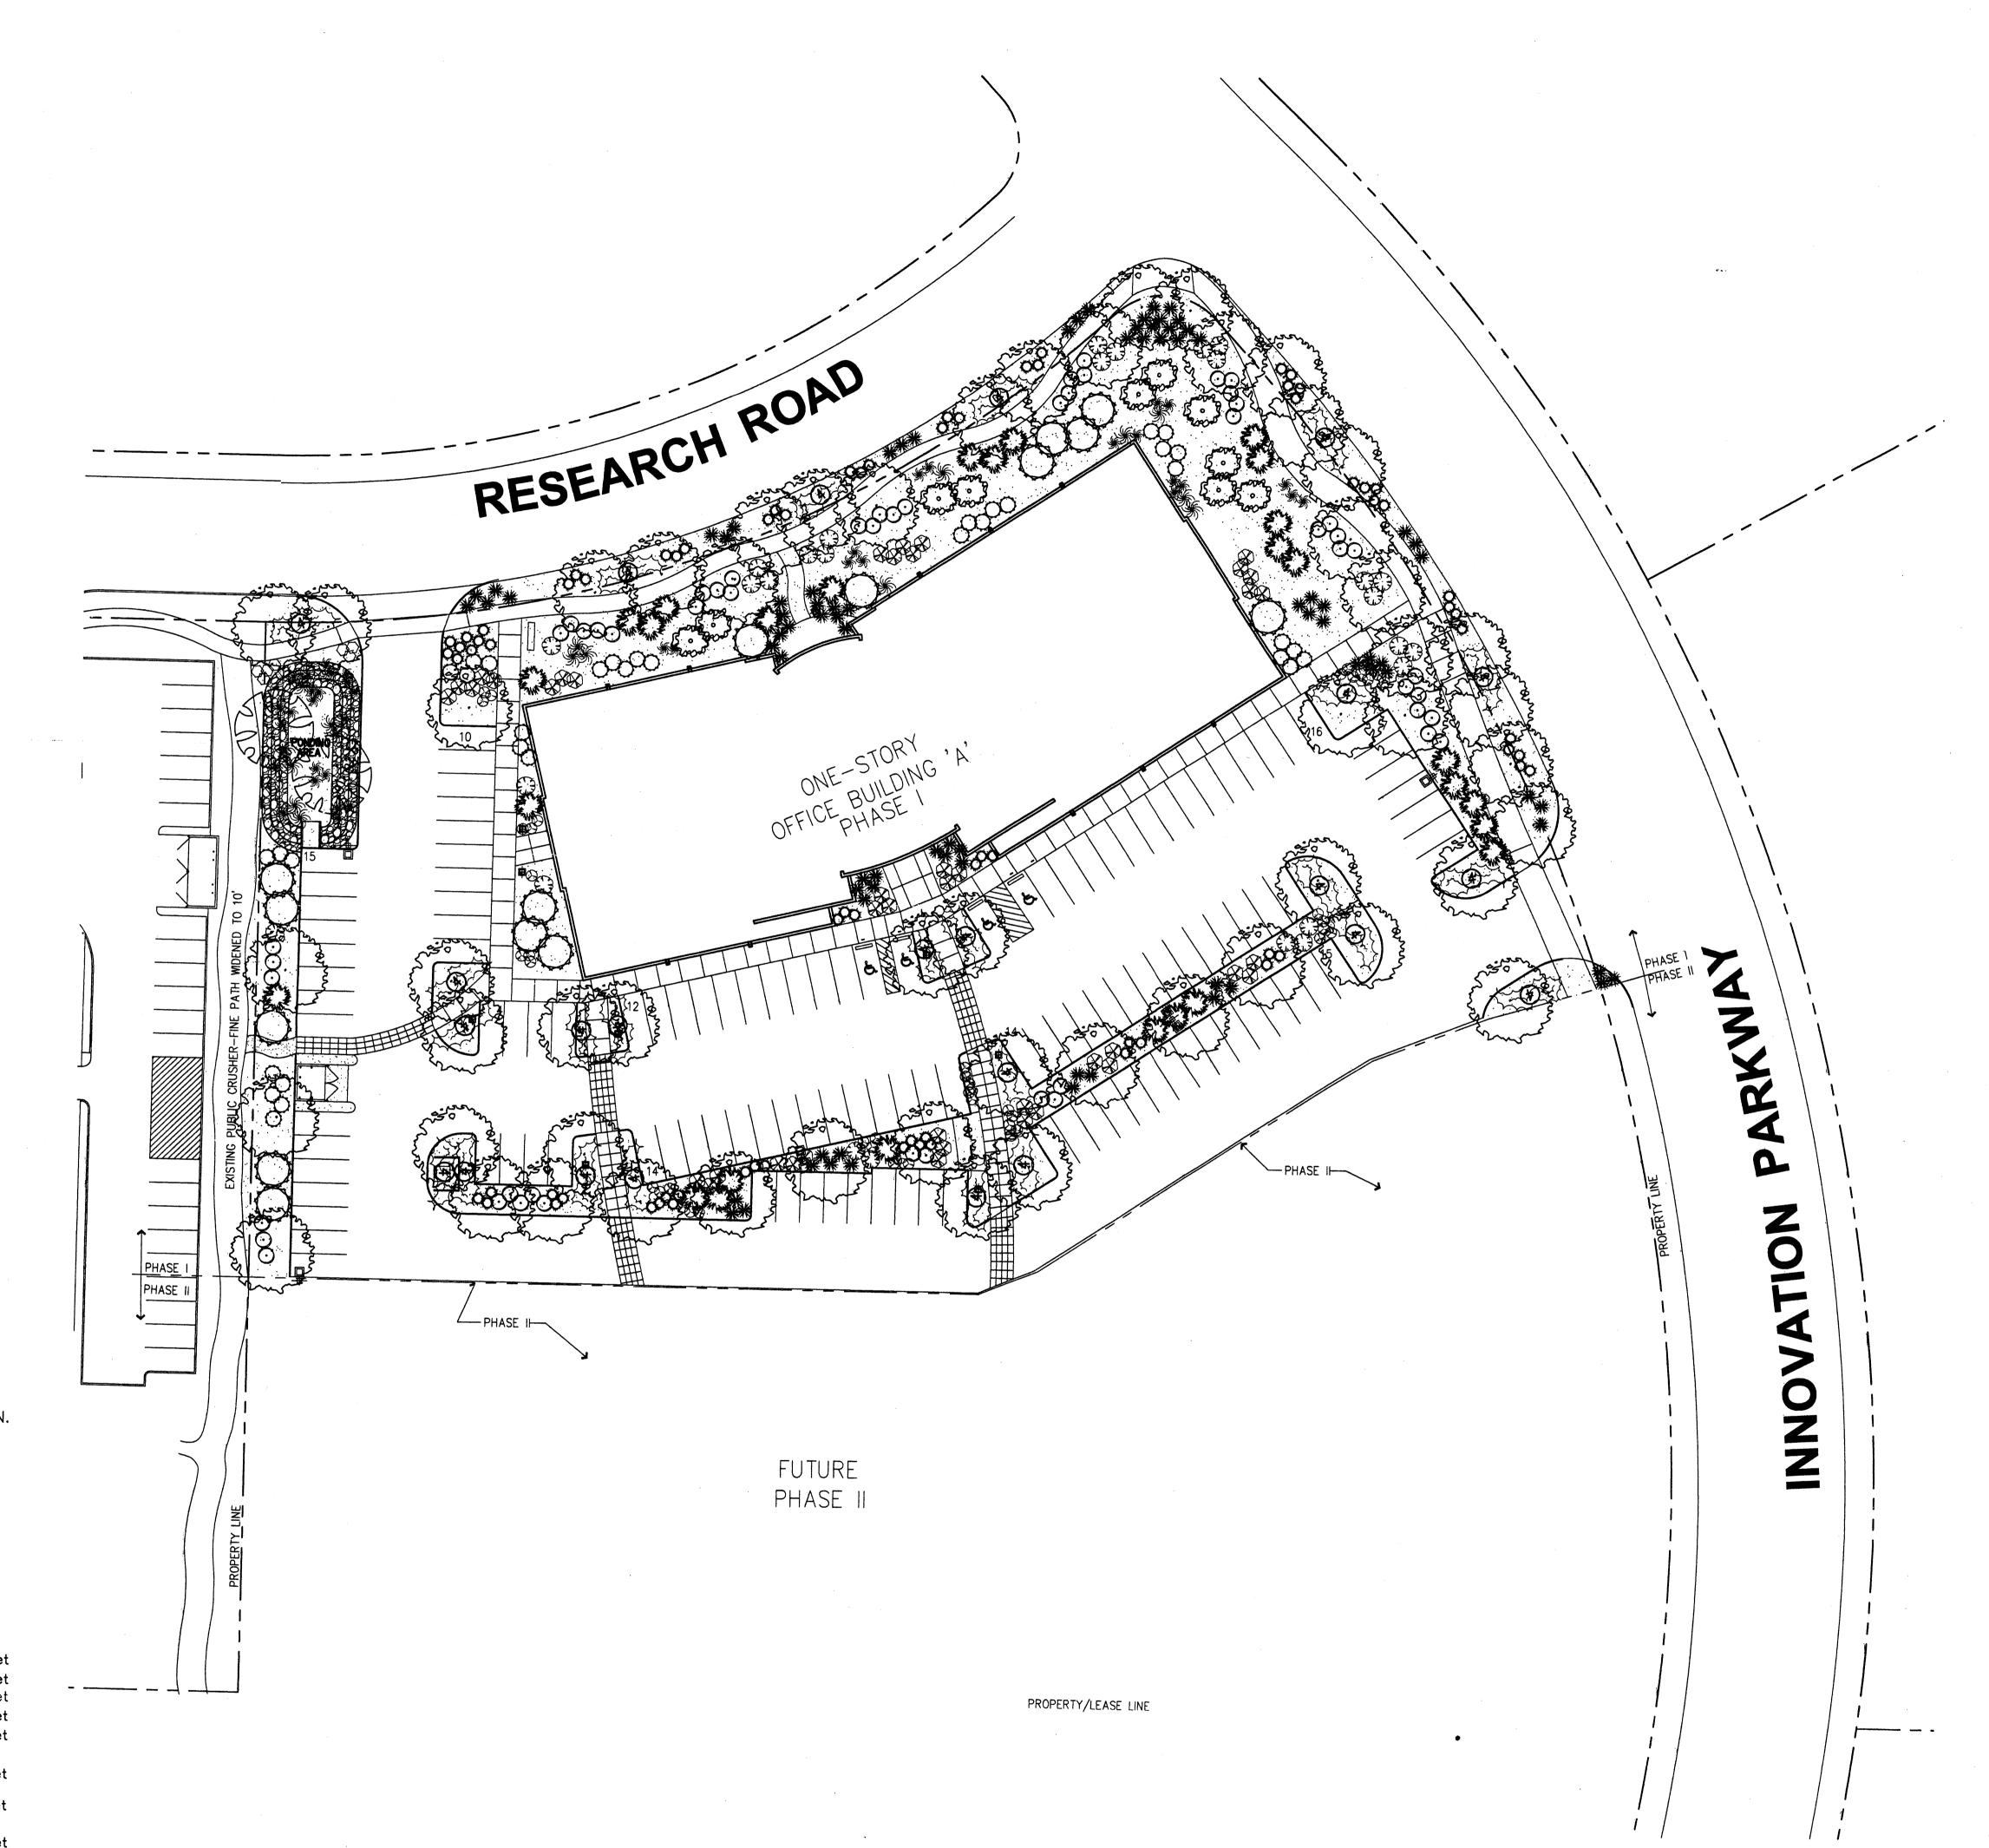

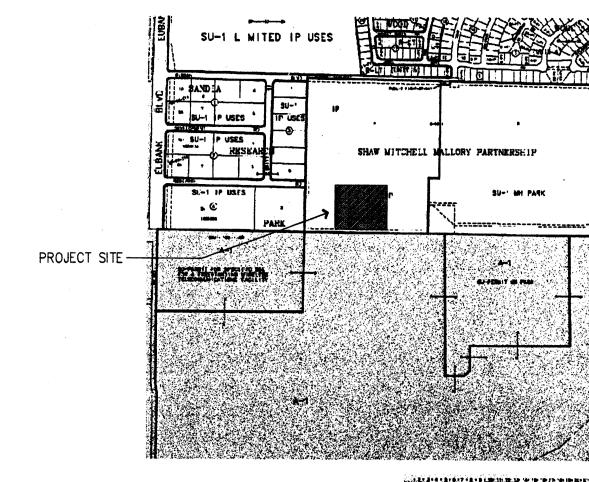

Zone Atlas Page M-21-Z

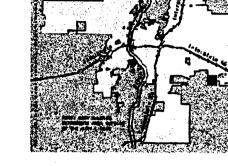

6801 Jefferson NE

505 761-9700 fax 761-4222

dps@dpsabq.com

Albuquerque, NM 87109

Suite 100

ADMINISTRATIVE

APPROVAL

10700 Research Road Albuquerque, New Mexi

ARCHITECT

PLANT LEGEND

NEW MEXICO OLIVE (M) 10 Forestiera neomexicana 15 Gal. 225sf

RED YUCCA (M) 84 Hesperaloe parvifiora 1 Gal. 9sf

OVERSIZED GRAVEL SLOPES 3:1 OR GREATER

APACHE PLUME (L) 27

WILDFLOWER 44

1 Gal. 4sf
Including but not limited to:
BLACK EYE SUSAN, PENSTEMON,
SANTOLINA, PRIMROSE,
YARROW, BLANKETFLOWER,
SNOW IN SUMMER, POPPY,
DAYLILIES,
ICEPLANT, RED HOT POKER,
AND CONEFLOWER.

LANDSCAPE ARCHITECTS & CONTRACTORS Cont. Lic. #26458

7909 Edith" N.E. Albuquerque, NM 87184 Ph. (505) 898-9690 Fax (505) 898-7737 cmd@hilltoplandscaping.com All creative ideas contained Herein remains the property of The Hilltop Landscape Architects and

Contractors and are protected by copyright laws. This is an original design and must not be released or copied unless applicable fees have been paid or job order

LANDSCAPE

DRAWN BY

REVIEWED BY

PROJECT NO.

DRAWING NAME

DATE

SHEET NO.

10/03/03

03040.001

Innovation

COMPACTED TO 95% OF MAX.

CONCRETE RUNDOWN DETAILS

P:\040088\cdp\general\040088gp01.dwg November 05, 2003 — 9:53am

GRADING PLAN

### **GRADING NOTES**

1. EXCEPT AS PROVIDED HEREIN, GRADING SHALL BE PERFORMED AT THE ELEVATIONS AND IN ACCORDANCE WITH THE DETAILS SHOWN ON THIS PLAN.

2. THE COST FOR REQUIRED CONSTRUCTION DUST AND EROSION CONTROL MEASURES SHALL BE INCIDENTAL TO THE PROJECT COST.

3. ALL WORK RELATIVE TO FOUNDATION CONSTRUCTION, SITE PREPARATION, AND PAVEMENT INSTALLATION, AS SHOWN ON THIS PLAN, SHALL BE CONSTRUCTED IN ACCORDANCE WITH THE "GEOTECHNICAL INVESTIGATION," AS PROVIDED BY THE ARCHITECT OR OWNER. ALL OTHER WORK SHALL, UNLESS OTHERWISE STATED OR PROVIDED FOR

HEREON, BE CONSTRUCTED IN ACCORDANCE WITH THE PROJECT, (FIRST PRIORITY) SPECIFICATIONS, AND/OR THE CITY OF ALBUQUERQUE (COA) STANDARD SPECIFICATIONS FOR PUBLIC WORKS (SECOND PRIORITY).

4. EARTH SLOPES SHALL NOT EXCEED 3 HORIZONTAL TO 1 VERTICAL UNLESS SHOWN

5. IT IS THE INTENT OF THESE PLANS THAT THIS CONTRACTOR SHALL NOT PERFORM ANY WORK OUTSIDE OF THE PROPERTY BOUNDARIES EXCEPT AS REQUIRED BY THIS PLAN.

6. THE CONTRACTOR IS TO ENSURE THAT NO SOIL ERODES FROM THE SITE ONTO ADJACENT PROPERTY OR PUBLIC RIGHT-OF-WAY. THIS SHOULD BE ACHIEVED BY CONSTRUCTING TEMPORARY BERMS AT THE PROPERTY LINES PER DETAIL ON SHEET C203 AND WETTING THE SOIL TO PROTECT IT FROM WIND EROSION.

7. A DISPOSAL SITE FOR ANY & ALL EXCESS EXCAVATION MATERIAL, AND UNSUITABLE MATERIAL AND/OR A BORROW SITE CONTAINING ACCEPTABLE FILL MATERIAL SHALL BE OBTAINED BY THE CONTRACTOR IN COMPLIANCE WITH APPLICABLE ENVIRONMENTAL REGULATIONS AND APPROVED BY THE OBSERVER. ALL COSTS INCURRED IN OBTAINING A DISPOSAL OR BORROW SITE AND HAUL TO OR FROM SHALL BE CONSIDERED INCIDENTAL TO THE PROJECT AND NO SEPARATE MEASUREMENT OR PAYMENT SHALL BE MADE.

8. PAVING AND ROADWAY GRADES SHALL BE +/- 0.1' FROM PLAN ELEVATIONS. PAD ELEVATION SHALL BE +/- 0.05' FROM BUILDING PLAN ELEVATION.

9. ALL PROPOSED CONTOURS REFLECT TOP OF PAVEMENT ELEVATIONS IN THE PARKING AREA AND MUST BE ADJUSTED FOR MEDIANS AND ISLANDS.

10. VERIFY ALL ELEVATIONS SHOWN ON PLAN FROM BASIS OF ELEVATION CONTROL STATION PRIOR TO BEGINNING CONSTRUCTION.

### GRADING & DRAINAGE KEYED NOTES

- 1. INSTALL NEW 4' DIA. TYPE "C" STORM DRAIN MANHOLE AS PER COA STD. DWG 2101
- 2. NEW 12" STORM DRAIN

3. TIE NEW 12" STORM DRAIN TO EXISTING STUBOUT. REMOVE & DISPOSE IF EXISTING PLUG. PROVIDE CONCRETE COLLAR AT CONNECTION. INV.=83.47 (INVERT BASED ON AS-BUILTS, CONTRACTOR SHALL VERIFY)

4. DAYLIGHT NEW STORM DRAIN, INSTALL FLARED END SECTION, INV.=89.50.

5. 18" WIDE SIDEWALK CULVERT AS PER COA STD. DWG. 2236

6. CONCRETE RUNDOWN AS PER DETAILS, THIS SHEET. PROVIDE CURB OPENING TO MATCH WIDTH OF RUNDOWN.

8. EXISTING CRUSHER FINES PATH SHALL BE REGRADE AND RESURFACED WITH CRUSHER FINES

7. DAYLIGHT 10" DRAINAGE PIPE. MITER END OF PIPE TO MATCH SLOPE. SEE PLAN FOR

SUCH THAT THE PATH SURFACE = 94.5 OR HIGHER.

- 9. ELEVATION AT PROPERTY LINE SHALL BE 94.00
- 10. PROVIDE 18" WIDE CURB OPENING FOR DRAINAGE
- 11. TRANSFORMER PAD ELEVATION = 94.30
- 12. DRAINAGE SWALE SHALL BE 13' MIN. FROM FACE OF BUILDING
- 13. NOT USED
- 14. VALLEY GUTTER AS PER DETAIL THIS SHEET.
- 15. CURB & GUTTER AS PER "MEDIAN CURB AND GUTTER", COA STD. DWG. 2415.
- 16. 12" STORM DRAIN PIPE. MITER ENDS TO MATCH SLOPE.
- 17. MAXIMUM THEORETICAL LIMIT OF POND.
- 18. INSTALL 6" EXTRUDED ASPHALT CURB ALONG SOUTH EDGE OF PARKING LOT
- 19. TIE TO 3" ROOF DRAIN, DAYLIGHT AT FACE OF CURB

architecture

6801 Jefferson NE Suite 100 Albuquerque, NM 87109 505761-9700 fax761-4222 dps@dpsabq.com

ENLARGED GRADING PLAN
SCALE: 1"=10"


DRAWN BY REVIEWED BY 11/05/03 PROJECT NO. 03040.001 DRAWING NAME

GRADING & DRAINAGE PLAN

**BENCHMARK** ACS ALUMINUM CAP STAMPED "6-L21, 1986" INTERSECTION OF CENTRAL AVE. & ELIZABETH ST. ELEV=5503.35 NAVD 88

Courtyard I 7500 Jefferson St. NE Albuquerque, NM 87109-4335

ENGINEERING \* SPATIAL DATA \* ADVANCED TECHNOLOGIES

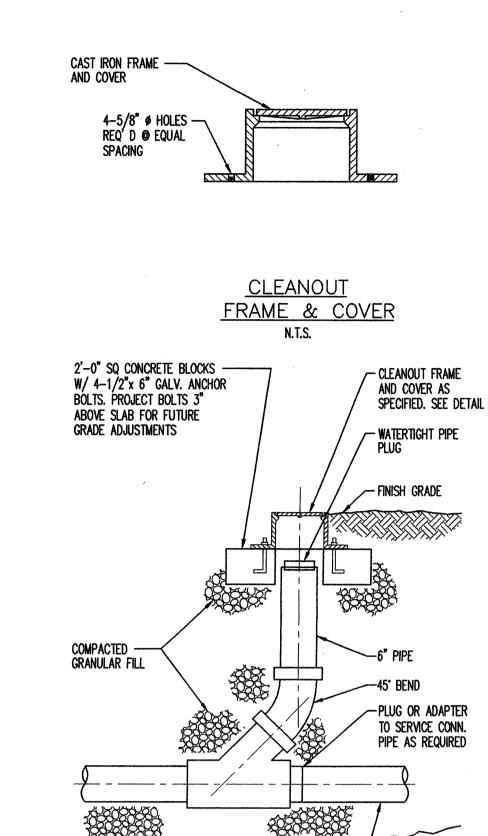

CONNECTION PIPE if required

GENERAL NOTES

IMPORTED PIPE BASE — MATERIAL AS SPECIFIED

1. ALL WORK DETAILED ON THESE PLANS AND PERFORMED UNDER THIS CONTRACT SHALL BE CONSTRUCTED IN ACCORDANCE WITH THE PROJECT SPECIFICATIONS AND THE PROJECT GEOTECHNICAL REPORT. WHERE APPLICABLE, CITY OF ALBUQUERQUE PUBLIC WORKS STANDARDS SHALL APPLY.

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UTILITY NOTES

1. THIS CONTRACTOR SHALL BE RESPONSIBLE FOR THE COMPLETE INSTALLATION OF ALL WORK RELATED TO MECHANICAL UTILITIES AS SHOWN ON THIS PLAN INCLUDING: TRENCHING, BACKFILL, SUPPORTS, CLEANOUT PADS, SERVICE STOPS AND BOXES, SERVICE LINES, TESTING, CLEANING, AND STERILIZING. ANY WORK NOT ACCEPTED BY THE ARCHITECT OR ENGINEER DUE TO IMPROPER WORKMANSHIP OR LACK OF PROPER COORDINATION SHALL BE REMOVED AND CORRECTLY INSTALLED AT THE CONTRACTOR'S EXPENSE, AS DIRECTED.

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3. ALL WORK DETAILED ON THESE PLANS TO BE PERFORMED UNDER CONTRACT SHALL, EXCEPT AS OTHERWISE STATED OR PROVIDED OF HEREON, BE CONSTRUCTED IN ACCORDANCE WITH THE IAPMO UNIFORM PLUMBING CODE, LATEST EDITION.

4. UTILITY LINES SHALL BE INSTALLED PRIOR TO PAVEMENT, CURB AND GUTTER, AND/OR SIDEWALK, AS APPLICABLE.

5. ROUGH GRADING OF SITE (±0.5') SHALL BE COMPLETED PRIOR TO INSTALLATION OF UTILITY

6. CONTRACTOR WILL BE RESPONSIBLE FOR CONNECTIONS TO BUILDING DRAIN LINES AND ALL NECESSARY FITTINGS.

7. ALL VALVES SHALL BE ANCHORED PER COA STANDARD DWG. 2333.

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6801 Jefferson NE Suite 100 Albuquerque, NM 87109 505 761-9700 fax 761-4222

dps@dpsabq.com

ARCHITECT

ADMINISTRATIVE APPROVAL

UTILITY KEYED NOTES

(A) CONTRACTOR SHALL COORDINATE W/ CITY FOR INSTALLATION OF 1.5" WATER

C STUB 2" WATER SERVICE TO WITHIN 5' OF BUILDING. SEE PLUMBING PLANS FOR CONTINUATION.

(D) THE NEW 6" FIRE LINE TO EXISTING 6" FIRE LINE STUB. REMOVE EXISTING CAP. INSTALL 6" FIRE LINE AS SHOWN.

E STUB 6" FIRE LINE TO WITHIN 5' OF BUILDING, SEE PLUMBING PLANS FOR

F STUB 6" SANITARY SEWER 10" PAST PROPERTY LINE

G REMOVE EXISTING CAP, INSTALL 6" GATE VALVE AND VALVE LBOX AS PER COA.

H TIE NEW 6" SAS TO EXISTING SAS STUB OUT.

(J) INSTALL CLEANOUT PER DEATIL, THIS SHEET.

K STUB SAS TO WITHIN 5' OF BUILDING, SEE PLUMBING PLAN FOR CONTINUATION.

UPSTREAM OF TEE-WYE.

M INSTALL 6" FIRE LINE WITHIN THE SITE AND INSTALL FIRE HYDRANT AS PER COA. STD. DWG. 2340. FLANGE ELEV. = 94.40.

LINE WITHIN CITY ROW, INCLUDING CONNECTION TO 10" CITY MAIN AND INSTALLATION OF GATE VALVE ON NEW 6" WATER LINE.

METER AND METER BOX. CONTRACTOR SHALL TIE 2" WATER SERVICE LINE TO 1.5" TAIL PIECE ON DOWNSTREAM SIDE OF WATER METER AND INSTALL 27 LF OF 2" WATER SERVICE LINE.

STD DWGS. 2333, 2326, 2328.

(L) INSTALL 6"x6" TEE-WYE. INSTALL CLEANOUT ON MAIN LINE IMMEDIATELY

(N) CONTRACTOR SHALL COORDINATE AND PAY FOR CITY INSTALLATION OF 6" WATER

**TECHNOLOGY PARK** AMELANG PARTNERS INC

REVIEWED BY DATE 10/03/03 PROJECT NO. 03040.001

UTILITY PLAN

DRAWING NAME

## ADMINISTRATIVE APPROVAL

dps 🕲 dpsabq.com

Park

'ation

- LOCATION OF BUILDING SIGNAGE -

NOT TO EXCEED 6% OF FACADE

— 1" INSULATED GLAZING W/ BLUE/GREEN TINT IN

— GALVANIZED STEEL OVERFLOW SCUPPER, TYP.

MECHANICAL SCREEN -

SAND COLORED STUCCO

ANODIZED ALUMINUM STOREFRONT FRAME, TYP.

- LOCATION OF BUILDING LOGO -

- SLATE STONE VENEER MECHANICAL

— ANODIZED ALUMINUM SHADE CANOPY

SYNTHETIC STUCCO COLOR - SAND -

MAX. SIZE 5' X 5'

PARAPET SCREENWALL

- PUNCHED OPENING, TYP.

280'-1"

◆ 19'-0" A.F. F.

17'-0" A.F. F.

◆ 16'-8" A.F. F.

5'-0" a

246'-8 1/4" MECHANICAL SCREEN -SAND COLORED STUCCO — SLATE STONE VENEER MECHANICAL PARAPET SCREENWALL 1" INSULATED GLAZING W/ BLUE/GREEN TINT IN ANODIZED ALUMINUM STOREFRONT FRAME, TYP.

GALVANIZED STEEL OVERFLOW SCUPPER, TYP. - ANODIZED ALUMINUM SHADE CANOPY - PUNCHED OPENING, TYP. ◆ 17'-0" A.F. F. - SYNTHETIC STUCCO COLOR - SAND

B1 BUILDING 'A' NORTH ELEVATION

1/8" = 1'-0"

BUILDING 'A' SOUTH ELEVATION

1/8" = 1'-0"

O

4'
8'

MECHANICAL SCREEN

SAND COLORED STUCCO

- LOCATION OF BUILDING SIGNAGE -NOT TO EXCEED 6% OF FACADE

- SYNTHETIC STUCCO COLOR - TERRACOTTA

- ANODIZED ALUMINUM SUNSHADE

MECHANICAL SCREEN - --

- ANODIZED ALUMINUM SUNSHADE - LINE OF REVEAL IN E.I.F.S., TYP.

- SYNTHETIC STUCCO COLOR - TERRACOTTA


SAND COLORED STUCCO

◆ 17'-0" A.F. F.

◆ 17'-0" A.F. F.

--- LINE OF REVEAL IN E.I.F.S., TYP.

101'-10 1/4" - SYNTHETIC STUCCO — MECHANICAL SCREEN -SAND COLORED STUCCO COLOR - TERRACOTTA ----- ANODIZED ALUMINUM SUNSHADE **♦** 20'-0" A.F. F. --- LINE OF REVEAL IN E.I.F.S., TYP. - SYNTHETIC STUCCO COLOR - SAND 33'-5" 18'-0" A.F. F. 17'-O" A.F. F. 15'-6" A.F. F. ◆ 17'-0" A.F. F.

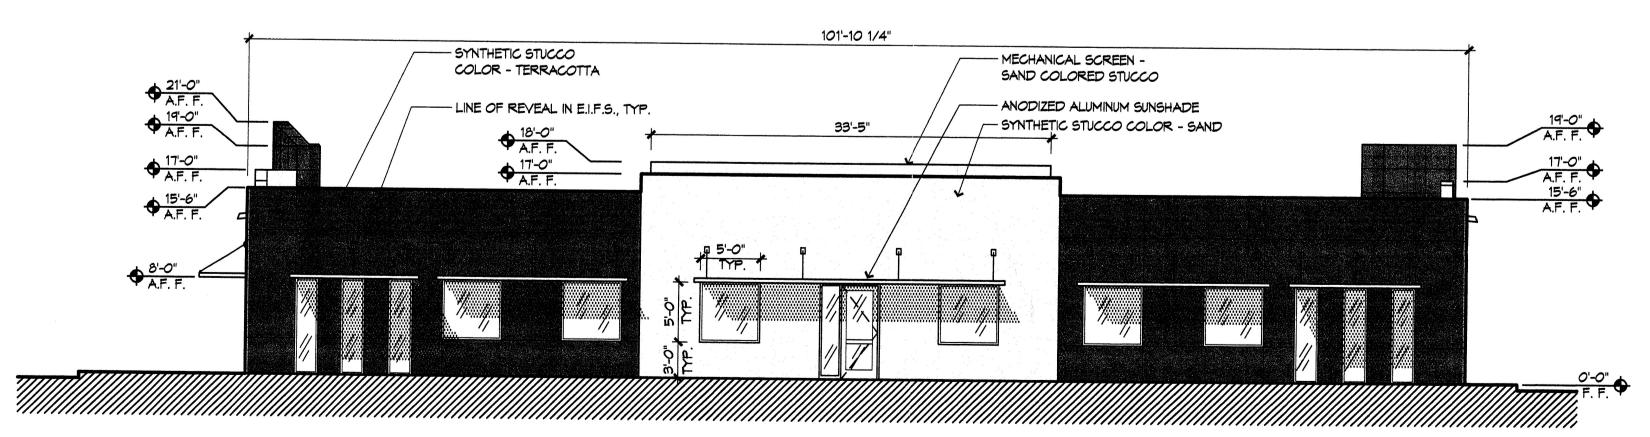

BUILDING 'A' WEST ELEVATION

1/8" = 1'-0"

O 4' 8'

C1 BUILDING 'A' EAST ELEVATION

SHEET NO.

SANDIA SCIENCE & TECHNOLOGY PARK

AMELANG PARTNERS INC.

SAS

10/03/03

03040.001

REVISIONS

DRAWN BY

DATE

REVIEWED BY

PROJECT NO.

EXTERIOR

ELEVATIONS

BUILDING "A"

### SP-2003403410 1-G-1 MANZANO D2A1A2 SANDIA DEPARTMENT SCIENCE RESEARCH ENERGY AND MALLORY PARTNERSHIP PARK TECHNOLOGY STATE PARK

### LOCATION MAP

ZONE ATLAS INDEX MAP No. M-21-Z NOT TO SCALE

### SUBDIVISION DATA

I. DRB No.

2. ZONE ATLAS INDEX NO. M-21-Z.

3. GROSS SUBDIVISION ACREAGE: 4.7891 ACRES. . TOTAL NUMBER OF TRACTS CREATED: TWO (2) TRACTS.

5. THIS PLAT SHOWS EXISTING EASEMENTS.

6. DATE OF SURVEY: OCTOBER, 2003 7. PLAT IS LOCATED WITHIN SECTION 33, TION, RAE, NMPM.

### DISCLOSURE STATEMENT

THE PURPOSE OF THIS PLAT IS TO SUBDIVIDE TRACT H OF THE BULK LAND PLAT OF SANDIA SCIENCE AND TECHNOLOGY PARK. ALBUQUERQUE, NEW MEXICO AS THE SAME IS SHOWN AND DESIGNATED ON THE PLAT THEREOF, RECORDED IN THE OFFICE OF THE COUNTY CLERK OF BERNALILLO COUNTY, NEW MEXICO ON DECEMBER 13, 2001 IN BOOK 2001C, PAGE 324 AS DOCUMENT NO. 2001148775 INTO TWO(2) TRACTS AND TO GRANT EASEMENTS.

### NOTES

"I. BEARINGS ARE NEW MEXICO STATE PLANE GRID BEARINGS (CENTRAL ZONE NAD 1927).

2. DISTANCES ARE GROUND DISTANCES.

3. A RECIPROCAL CROSS-ACCESS, PARKING AND DRAINAGE EASEMENT FOR THE BENEFIT OF TRACTS H-1 AND H-2, TO BE MAINTAINED BY SAME, IS GRANTED WITH THIS PLAT.

### PUBLIC UTILITY EASEMENTS

PUBLIC UTILITY EASEMENTS SHOWN ON THIS PLAT ARE FOR THE COMMON JOINT USE OF:

- A. PNM ELECTRIC SERVICES FOR THE INSTALLATION, MAINTENANCE AND SERVICE OF UNDERGROUND ELECTRICAL LINES, TRANSFORMERS, AND OTHER EQUIPMENT, FIXTURES, STRUCTURES, AND RELATED FACILITIES REASONABLY NECESSARY TO PROVIDE ELECTRICAL SERVICE.
- B. PNM GAS SERVICES FOR INSTALLATION, MAINTENANCE, AND SERVICE OF NATURAL GAS LINES, VALVES AND OTHER EQUIPMENT AND FACILITIES REASONABLY NECESSARY TO PROVIDE NATURAL GAS.
- C. QWEST FOR THE INSTALLATION, MAINTENANCE, AND SERVICE OF ALL BURIED COMMUNICATION LINES AND OTHER RELATED EQUIPMENT AND FACILITIES RY TO PROVIDE COMMUNICATION SERVICES, INCLUDING BUT NOT LIMITED TO ABOVE GROUND PEDESTALS AND CLOSURES.
- D. COMCAST CABLE FOR THE INSTALLATION, MAINTENANCE, AND SERVICE OF SUCH LINES, CABLE, AND OTHER RELATED EQUIPMENT AND FACILITIES REASONABLY NECESSARY TO PROVIDE CABLE TV SERVICE.

INCLUDED IS THE RIGHT TO BUILD, REBUILD, CONSTRUCT, RECONSTRUCT, LOCATE, RELOCATE, CHANGE, REMOVE, MODIFY, RENEW, OPERATE, AND MAINTAIN FACILITIES FOR THE PURPOSES DESCRIBED ABOVE, TOGETHER WITH FREE ACCESS TO, FROM, AND OVER SAID EASEMENTS, INCLUDING SUFFICIENT WORKING AREA SPACE FOR ELECTRIC TRANSFORMERS, WITH THE RIGHT AND PRIVILEGE TO TRIM AND REMOVE TREES, SHRUBS OR BUSHES WHICH INTERFERE WITH THE PURPOSES SET FORTH HEREIN. NO BUILDING, SIGN, POOL, (ABOVE GROUND OR SUBSURFACE), HOT TUB, CONCRETE OR WOOD POOL DECKING, OR OTHER STRUCTURE SHALL BE ERECTED OR CONSTRUCTED ON SAID EASEMENTS, NOR SHALL ANY WELL BE DRILLED OR OPERATED THEREON. PROPERTY OWNERS SHALL BE SOLELY RESPONSIBLE FOR CORRECTING ANY VIOLATIONS OF NATIONAL ELECTRIC SAFETY CODE CAUSED BY CONSTRUCTION OF POOLS, DECKING, OR ANY STRUCTURES ADJACENT TO OR NEAR EASEMENTS SHOWN ON THIS PLAT.

EASEMENTS FOR ELECTRIC TRANSFORMERS/SWITCHGEARS, AS INSTALLED SHALL EXTEND TEN FEET (10') IN FRONT OF TRANSFORMER/SWITCHGEAR DOORS AND FIVE FEET (5') ON EACH

### DESCRIPTION

A CERTAIN TRACT OF LAND SITUATE WITHIN SECTION 33, TOWNSHIP IO NORTH, RANGE 4 EAST, NEW MEXICO PRINCIPAL MERIDIAN, BERNALILLO COUNTY, ALBUQUERQUE, NEW MEXICO, BEING AND COMPRISING ALL OF TRACT H OF THE BULK LAND PLAT OF SANDIA SCIENCE AND TECHNOLOGY PARK, ALBUQUERQUE, NEW MEXICO, AS THE SAME IS SHOWN AND DESIGNATED ON THE PLAT THEREOF, RECORDED IN THE OFFICE OF THE COUNTY CLERK OF BERNALILLO COUNTY, NEW MEXICO ON DECEMBER 13, 2001 IN BOOK 2001C, PAGE 324 AS DOCUMENT NO. 2001148775 AND BEING MORE PARTICULARLY DESCRIBED BY NEW MEXICO STATE PLANE GRID BEARINGS (CENTRAL ZONE NAD 1927) AND GROUND DISTANCES AS FOLLOWS:

BEGINNING AT THE NORTHWEST CORNER OF SAID TRACT H, A POINT ON THE SOUTHERLY RIGHT-OF-WAY LINE OF RESEARCH ROAD SE, WHENCE THE ALBUQUERQUE CITY SURVEY (ACS) MONUMENT "6-L21", A 31/4 INCH ALUMINUM CAP SET FLUSH IN A CURB, HAVING NEW MEXICO STATE PLANE COORDINATES, CENTRAL ZONE, NAD 1927 OF X=417,974.01 AND Y=1,481,220.09 BEARS NO6-28'26"E, A DISTANCE OF 5794.77 FEET AND FROM SAID POINT OF BEGINNING RUNNING THENCE ALONG THE MORTHERLY BOUNDARY LINE OF SAID TRACT H AND ALSO ALONG SAID RIGHT-DE-WAY I INE

OF-WAY LINE, S89"15"56"E, A DISTANCE OF 4.23 FEET TO A POINT OF CURVATURE; THENCE, 326.96 FEET ALONG THE ARC OF A CURVE TO THE LEFT HAVING A RADIUS OF 430.00 FEET AND A CHORD WHICH BEARS N68"57"04"E, A DISTANCE OF 319.14 FEET TO A POINT OF REVERSE

39.03 FEET ALONG THE ARC OF A CURVE TO THE RIGHT HAVING A RADIUS OF 25.00 FEET AND A CHORD WHICH BEARS \$88.06.33.6, A DISTANCE OF 35.18 FEET TO A POINT OF COMPOUND CURVATURE ON THE EASTERLY BOUNDARY LINE OF SAID TRACT H AND ALSO BEING A POINT ON THE WESTERLY RIGHT-OF-WAY LINE OF INNOVATION PARKWAY SE, THENCE RUNNING ALONG THE EASTERLY BOUNDARY LINE OF SAID TRACT H AND ALSO ALONG SAID RIGHT-OF-WAY LINE, 548.68 FEET ALONG THE ARC OF A CURVE TO THE RIGHT HAVING A RADIUS OF 614.00 FEET AND A CHORD WHICH BEARS SI7\*47'10°E, A DISTANCE OF 530.60 FEET TO THE SOUTHEAST CORNER OF SAID TRACT H, THENCE LEAVING SAID RIGHT-OF-WAY LINE AND RUNNING THENCE ALONG THE SOUTHERLY BOLINDARY LINE OF SAID TRACT H, N89"15"56"W. A DISTANCE OF 504.17 FEET TO THE SOUTHWEST CORNER OF SAID TRACT H, THENCE

RUNNING ALONG THE WESTERLY BOUNDARY LINE OF SAID TRACT H.
NOO"42"53"E, A DISTANCE OF 385.40 FEET TO THE POINT AND PLACE OF BEGINNING.

, TRACT CONTAINS 4.7891 ACRE, MORE OR LESS.

### FREE CONSENT AND DEDICATION

THE FOREGOING PLAT OF THE CERTAIN TRACT OF LAND SITUATE WITHIN SECTION 33, TOWNSHIP IO NORTH, RANGE 4 EAST, NEW MEXICO PRINCIPAL MERIDIAN, BERNALILLO COUNTY, ALBUQUERQUE, NEW MEXICO, BEING AND COMPRISING ALL OF TRACT H OF THE BULK LAND PLAT OF SANDIA SCIENCE AND TECHNOLOGY PARK, ALBUQUERQUE, NEW MEXICO AS THE SAME ARE SHOWN AND DESIGNATED ON THE NEW MEXICO, BEING AND COMPRISING ALL OF TRACT H OF THE BULK LAND FLAT OF SANDIA SCIENCE AND TECHNOLOGY PARK, ALBUQUERQUE, NEW MEXICO AS THE SAME ARE SHOWN AND DESIGNATED ON THE PLAT THEREOF, RECORDED IN THE OFFICE OF THE COUNTY CLERK OF BERNALILLO COUNTY, NEW MEXICO ON DECEMBER 13, 2001 IN BOOK 2001C, PAGE 324 AS DOCUMENT NO. 2001148775, NOW COMPRISING TRACTS H-I AND H-2 OF THE PLAT OF SANDIA SCIENCE AND TECHNOLOGY PARK, ALBUQUERQUE, NEW MEXICO, IS WITH THE FREE CONSENT AND IN ACCORDANCE WITH THE DESIRES OF THE UNDERSIGNED OWNER(S) AND/OR PROPRIETOR(S) THEREOF AND SAID OWNER(S) AND/OR PROPRIETOR(S) DO HEREBY GRANT; ALL ACCESS, UTILITY AND DRAINAGE EASEMENTS HEREON INCLUDING THE RIGHT TO CONSTRUCT, OPERATE, INSPECT, AND MAINTAIN FACILITIES THEREIN; AND ALL PUBLIC UTILITY EASEMENTS SHOWN HEREON FOR THE COMMON AND JOINT USE OF GAS, ELECTRICAL PUBLIC UTILITY EASEMENTS SHOWN HEREON FOR THE COMMON AND JOINT USE OF GAS, ELECTRICAL PUBLIC UTILITY EASEMENTS SHOWN HEREON FOR THE COMMON AND JOINT USE OF GAS, ELECTRICAL PUBLIC UTILITY EASEMENTS SHOWN MAINTENANCE, AND THE RIGHT TO TIME HERIGHT OF INGRESS AND EGRESS FOR CONSTRUCTION AND MAINTENANCE, AND THE RIGHT TO TIME INTERFERING TREES AND SHRUBS. THE CITY HAS THE RIGHT TO ENTER UPON THE GRANTEES PROPERTY AT ANY TIME AND PERFORM WHATEVER INSPECTION, INSTALLATION, MAINTENANCE, REPAIR, MODIFICATION OR REMOVAL ("WORK") IT DEMS APPROPRIATE WITHOUT LIABILITY TO THE CITY. IF THE WORK EFFECTS ANY IMPROVEMENTS OR ENCROACHMENTS MADE BY THE GRANTEE, THE CITY WILL NOT BE FINANCIALLY OR OTHERWISE RESPONSIBLE FOR REBUILDING OR REPAIRING OF IMPROVEMENTS OR ENCROACHMENTS, THE GRANTEE SHALL, AT ITS OWN EXPENSE, TAKE WHATEVER IMPROVEMENTS OR ENCROACHMENTS, THE GRANTEE SHALL, AT ITS OWN EXPENSE, TAKE WHATEVER IMPROVEMENTS OR ENCROACHMENTS, SAID IMPROVEMENTS OR ENCROACHMENTS, THE GRANTEE SHALL, AT ITS OWN EXPENSE, TAKE WHATEVER PROTECTIVE MEASURES ARE REQUIRED TO SAFEGUARD THE IMPROVEMENTS OR ENCROACHMENTS. SAID PROTECTIVE MEASURES ARE REQUIRED TO SAFEGUARD THE IMPROVEMENTS OR ENCROACHMENTS. SAID OWNER(S) AND/OR PROPRIETOR(S) DO HEREBY CONSENT TO ALL OF THE FOREGOING AND DO HEREBY CERTIFY THAT THIS SUBDIVISION IS THEIR FREE ACT AND DEED.

WELLS FARGO BANK NEW MEXICO, N.A. AS TRUSTES FOR UNION PENSION TO SACTION TRUST 2000-7 NM GEORGE H. KUHN SENIOR VICE PRESIDENT AND SENIOR TRUST OFFICER, WELLS FARGO BANK, N.A., AS TRUSTEE FOR THE UNION PENSION TRANSACTION TRUST 2000-7 NM

STATE OF NEW MEXICO ) COUNTY OF BERNALILLO )

SURVEYOR'S CERTIFICATION

I, A. DWAIN WEAVER, A REGISTERED PROFESSIONAL NEW MEXICO SURVEYOR,

WAS PREPARED BY ME OR UNDER MY SUPERVISION, SHOWS ALL EASEMENTS OF

REGISTRATION FOR PROFESSIONAL ENGINEERS AND PROFESSIONAL SURVEYORS

AND SURVEYS CONTAINED IN THE ALBUQUERQUE SUBDIVISION ORDINANCE, AND

IS TRUE AND ACCURATE TO THE BEST OF MY KNOWLEDGE AND BELIEF.

A. DWAIN WEAVER

DATE: OCTOBER 3, 2003

NEW MEXICO PROFESSIONAL SURVEYOR 6544

IN OCTOBER, 2000 AND MEETS THE MINIMUM REQUIREMENTS FOR MONUMENTATION

RECORD, AND CONFORMS TO THE MINIMUM REQUIREMENTS OF THE BOARD OF


CERTIFY THAT I AM RESPONSIBLE FOR THIS SURVEY AND THAT THIS PLAT

THIS INSTRUMENT WAS ACKNOWLEDGED BEFORE ME ON \_\_\_\_\_ DAY OF ONTO DO . 2003 BY GEORGE H. KUHN, SENIOR VICE PRESIDENT AND SENIOR TRUST OFFICER, WELLS FARGO BANK, N.A., AS TRUSTEE FOR UNION PENSION TRANSACTION TRUST 2000-7 NM

MY COMMISSION EXPIRE: 6-24-07 Stephanie & Stratton



6544

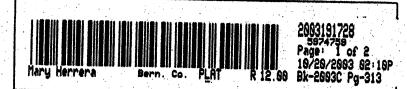

PLAT OF


### **TRACTS H-1 & H-2** SANDIA SCIENCE & TECHNOLOGY PARK

(A REPLAT OF TRACT H, SANDIA SCIENCE AND TECHNOLOGY PARKY ALBUQUERQUE, NEW MEXICO

OCTOBER, 2001

03 DRB- 01710 APPLICATION NUMBER

PLAT APPROVAL

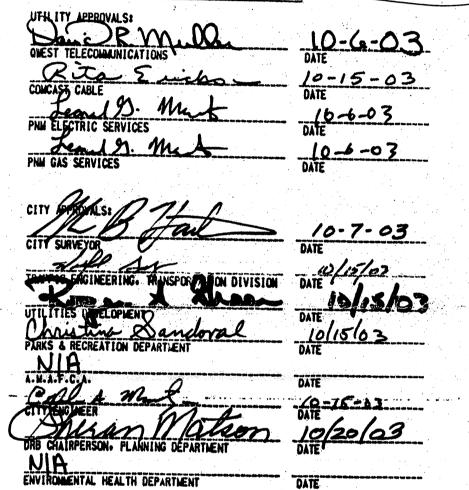

### TAX CERTIFICATION

THIS IS TO CERTIFY THAT TAXES ARE CURRENT AND PAID ON UPC #

102105519041520570

PROPERTY OWNER OF RECORD SHAW MITCHELL & MALLOS

### PNM STAMP

IN APPROVING THIS PLAT, PNM ELECTRIC SERVICES AND GAS SERVICES HEREON. CONSEQUENTLY, PNM DOES NOT WAIVE NOR RELEASE ANY


(PNM) DID NOT CONDUCT A TITLE SEARCH OF THE PROPERTIES SHOWN EASEMENT OR EASEMENT RIGHTS TO WHICH IT MAY BE ENTITLED.

## Burannan A Huston

Courtyard I 7500 Jefferson St. NE Albuquerque, NM 87109-4335 ENGINEERING A SPATIAL DATA A ADVANCED TECHNOLOGIES

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SHEET 1 OF 2

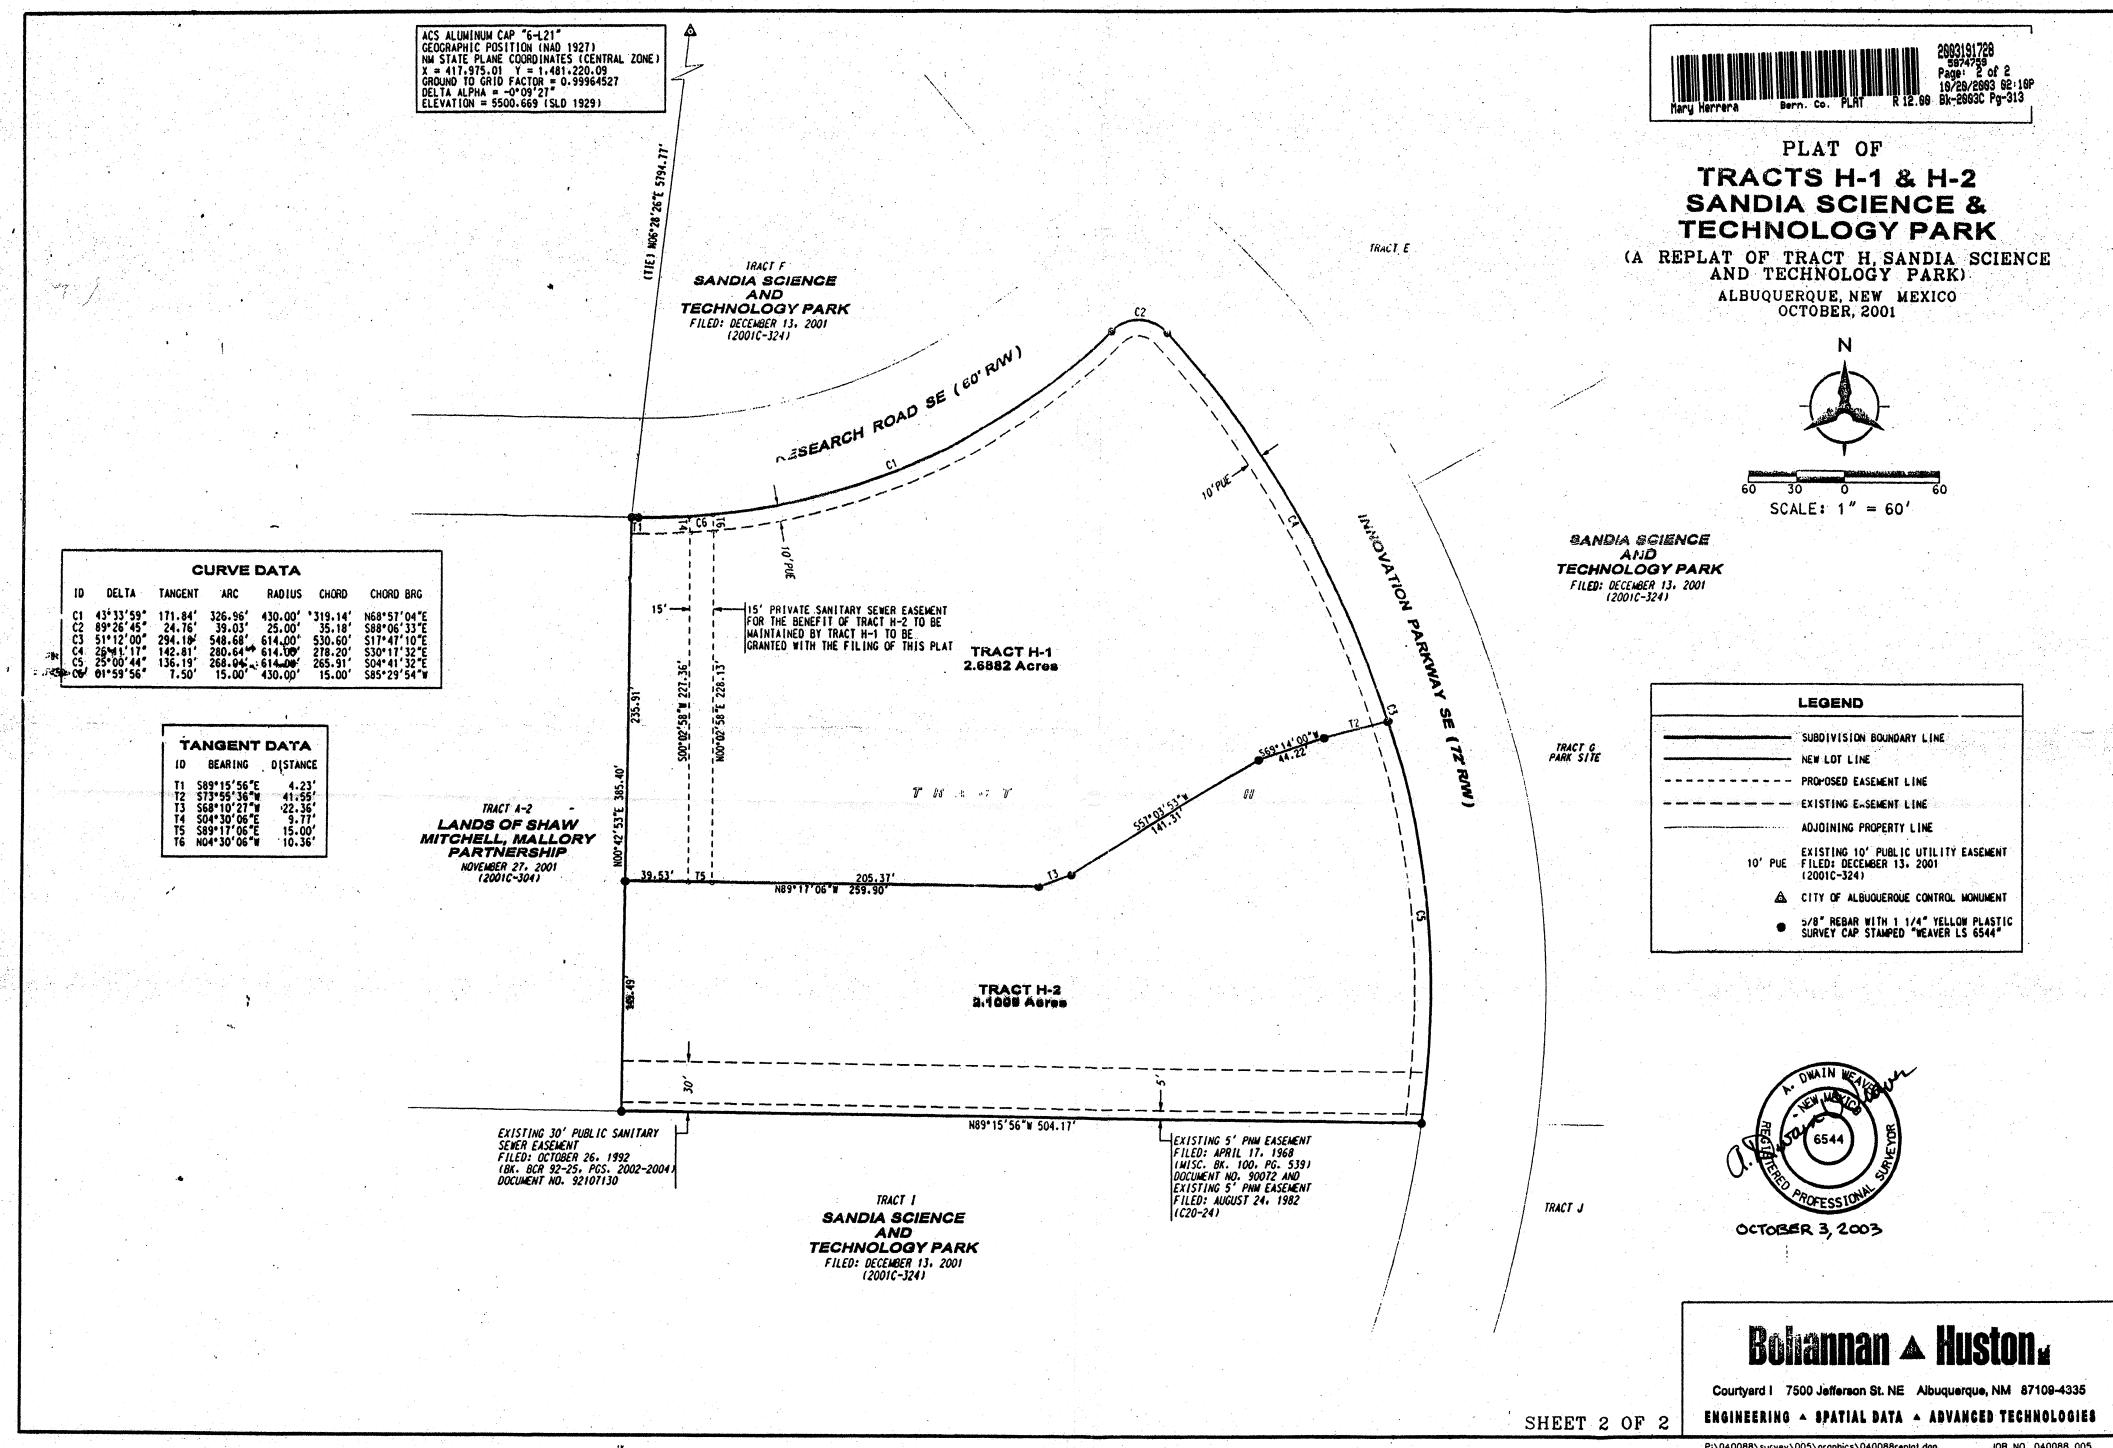

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JOB NO. 040088 005