



PROJECT # 1005157

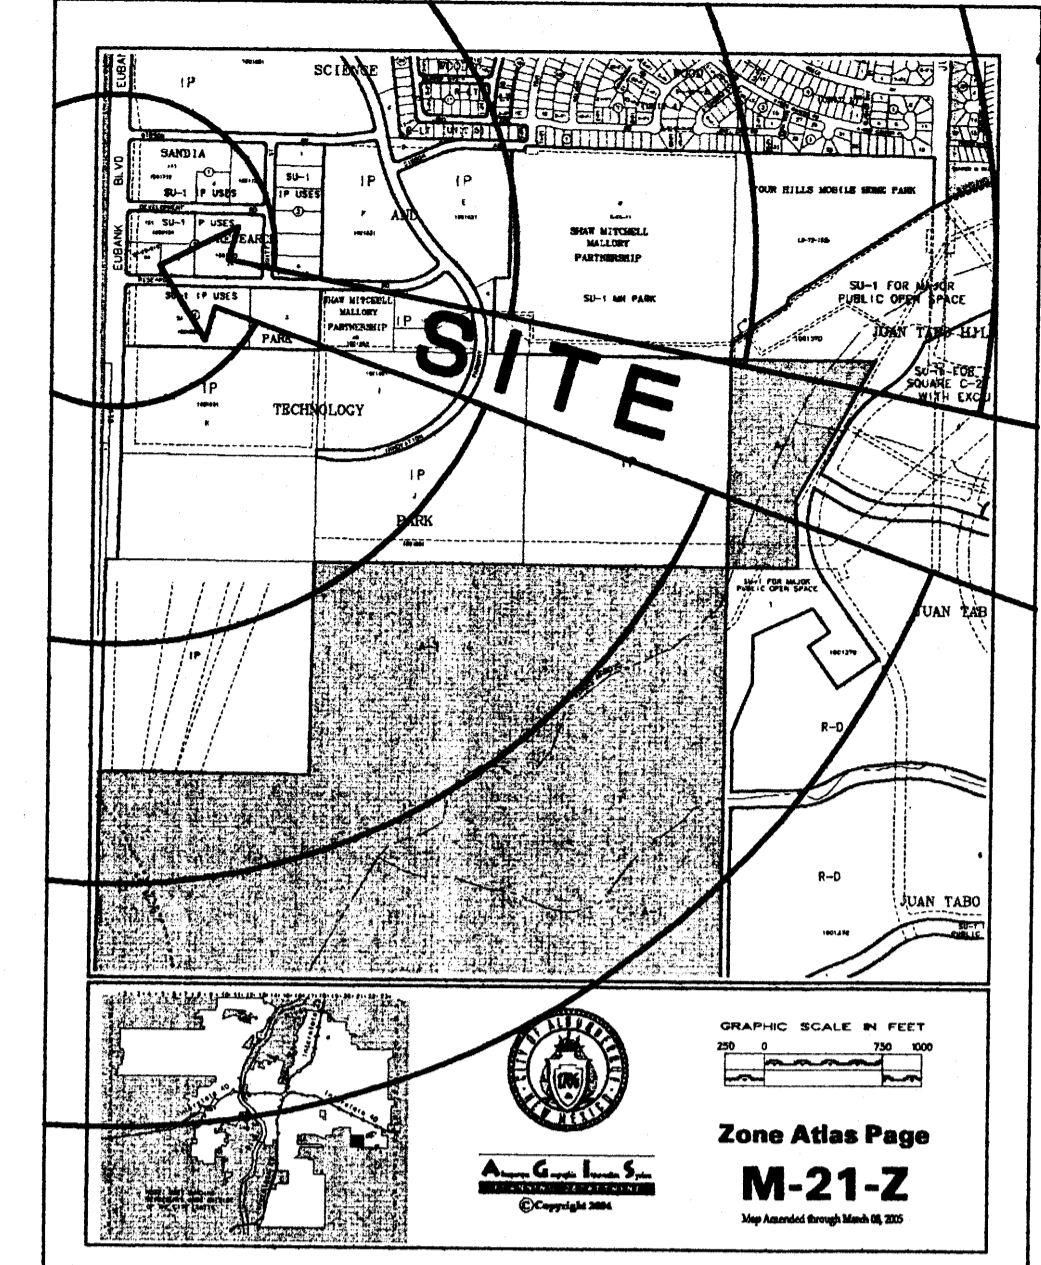

ZONE ATLAS MAP
SCALE: N.T.S. TRUE NORTH

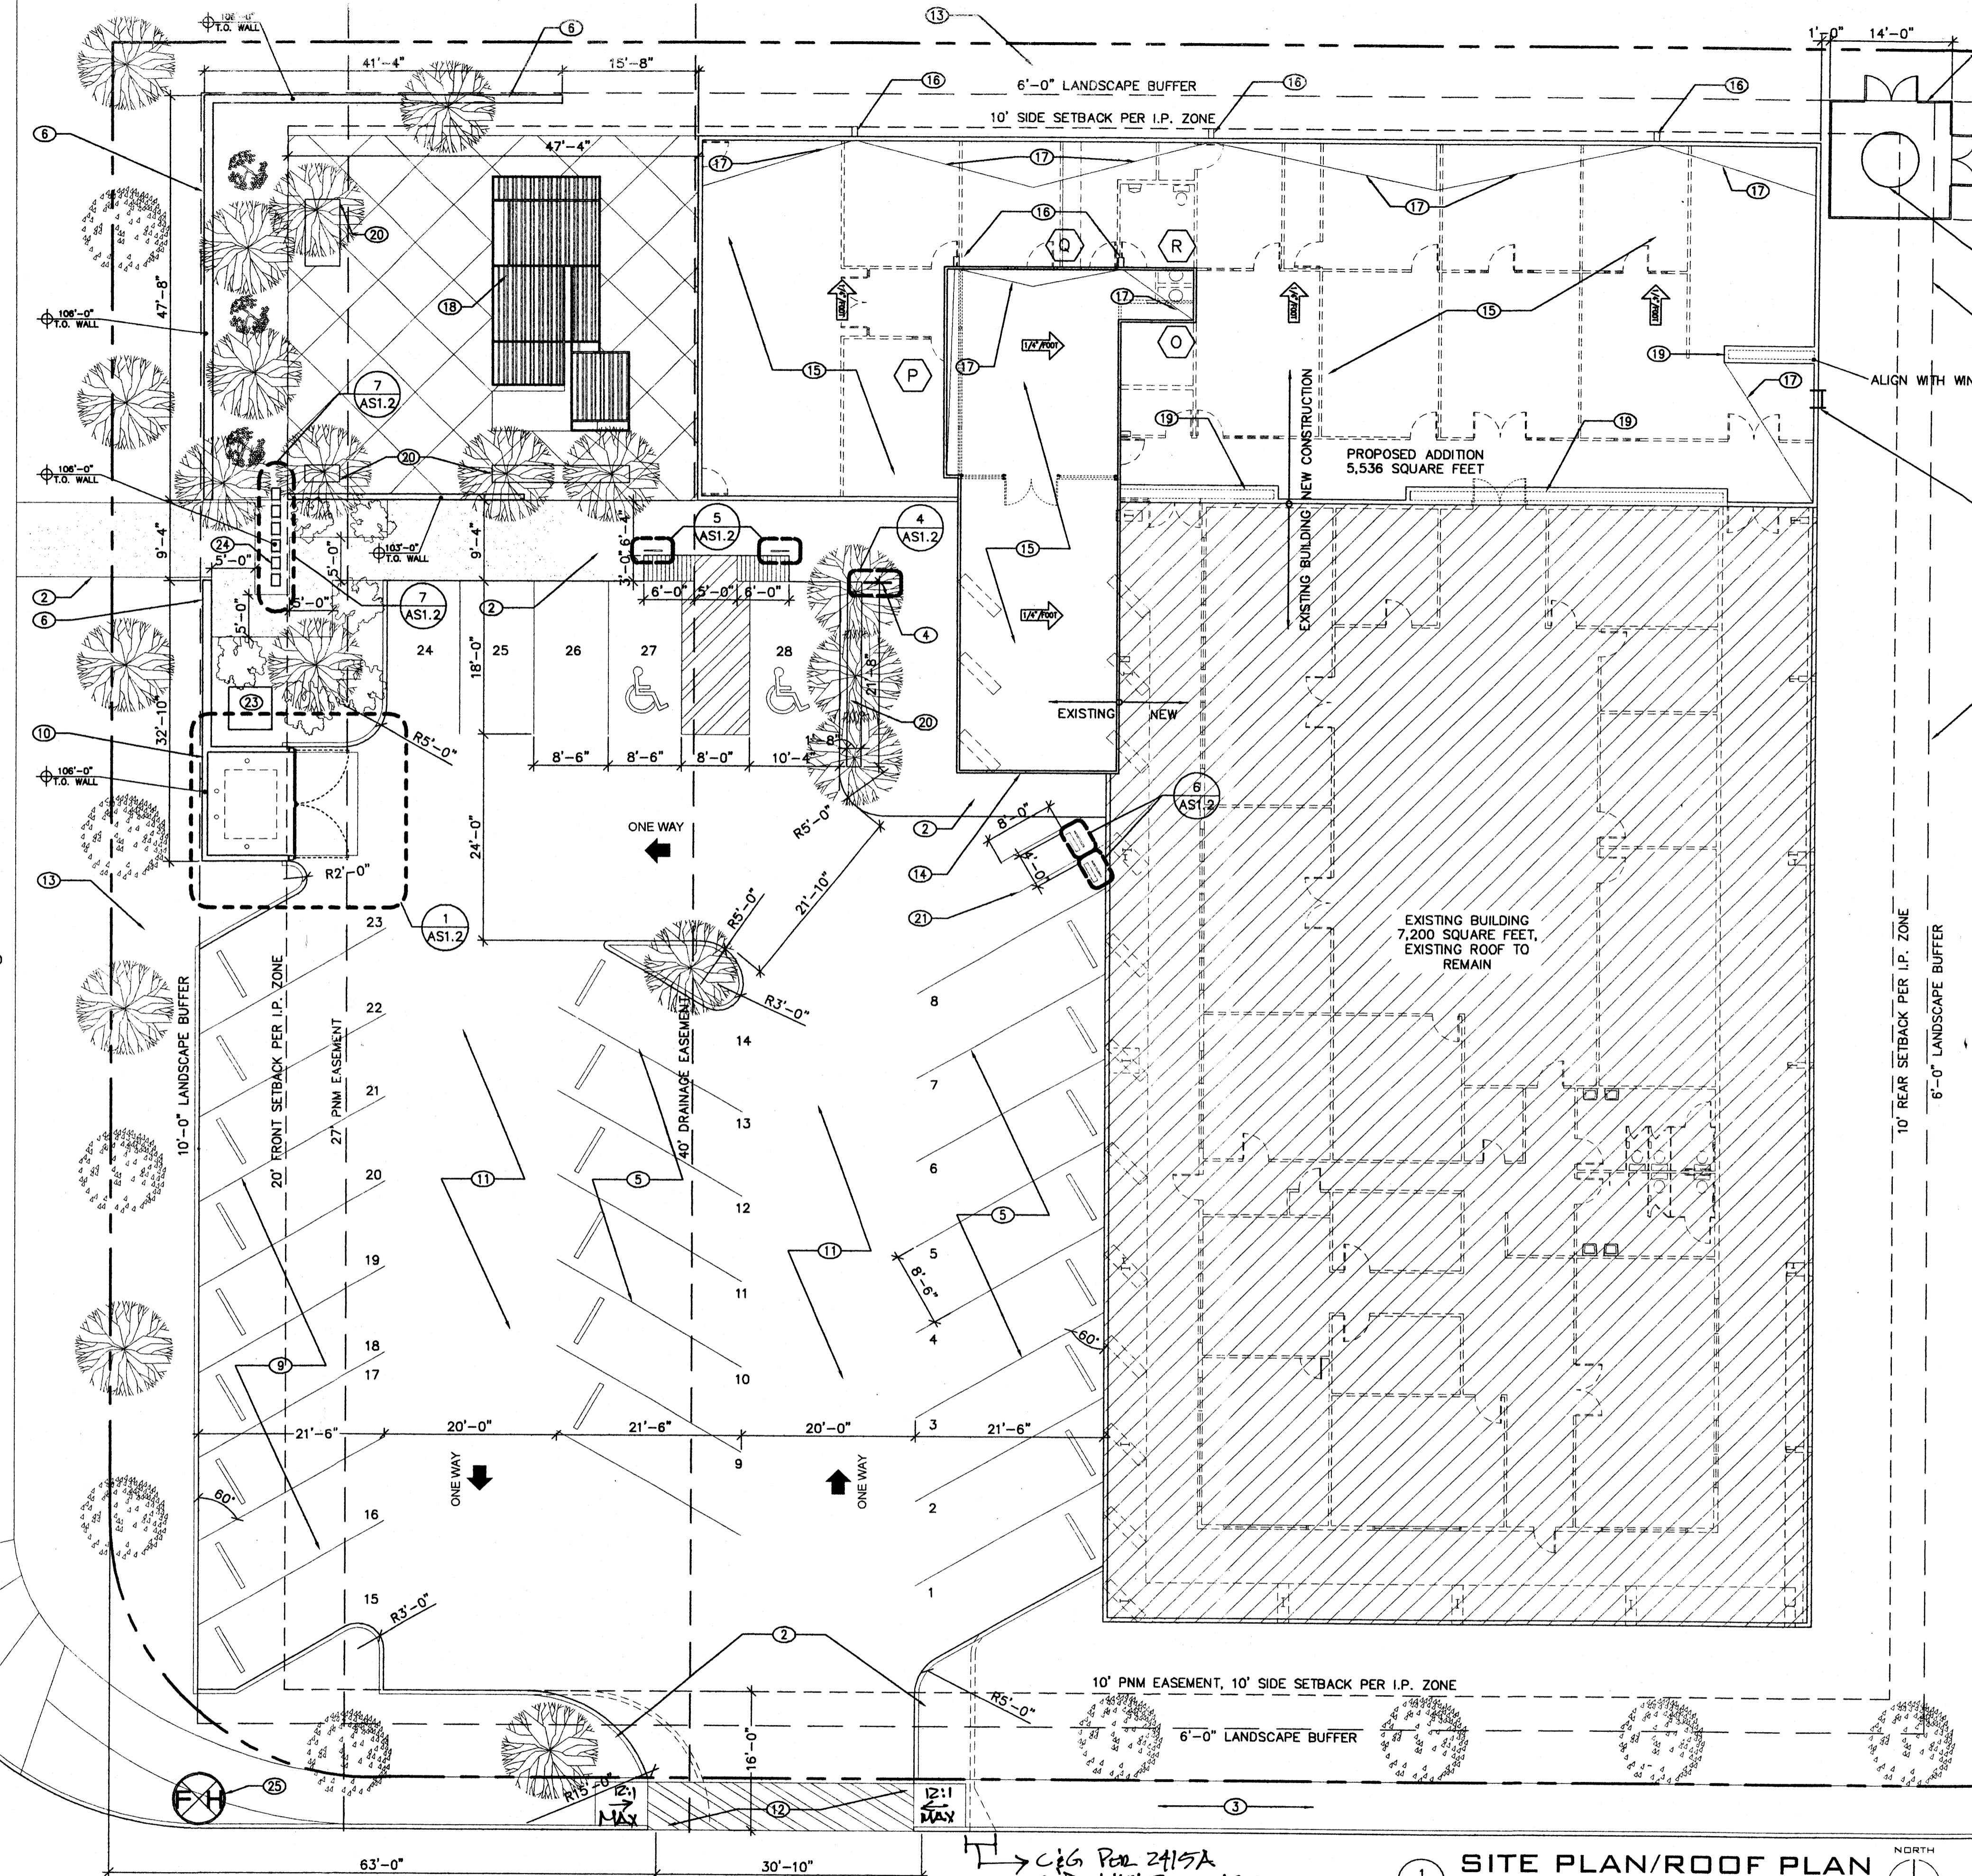

GENERAL NOTES

- DO NOT SCALE DRAWINGS
- CONTRACTOR TO COORDINATE ALL DRAWINGS PRIOR TO CONSTRUCTION
- VERIFY EXISTING CONDITIONS IN FIELD. BRING DISCREPANCIES TO ATTENTION OF ARCHITECT
- DIMENSIONS ARE TO FACE OF STUDS UNLESS OTHERWISE NOTED
- F.F. INDICATES THAT THE DIMENSION IS A CRITICAL FINISHED DIMENSION MEASURED FROM FINISHED FACE TO FINISHED FACE
- EXISTING GROUND FLOOR SLAB ELEVATION INDICATED AS 100'-0". ALL VERTICAL DIMENSIONS ARE MEASURED FROM THIS POINT

PARKING CALCULATIONS:

PARKING REQUIRED PER CITY ZONING CODE:
MANUFACTURING AND WHOLESALING: 1 SPACE PER 1,000 SQUARE FEET OF NET LEASABLE AREA
11,656 NET LEASABLE AREA,
12 PARKING SPACES REQUIRED
28 PARKING SPACES PROVIDED

KEYED NOTES

- SITE PLAN**
- NOT USED
 - NEW CONCRETE SIDEWALK
 - EXISTING SIDEWALK TO REMAIN
 - 3 SPACE BICYCLE RACK
 - TYP. PARKING STALL
 - NEW CMU WALL, STUCCO
 - NOT USED
 - RELOCATED ROOF LADDER
 - TYP. EMPLOYEE PARKING STALL
 - 6" HIGH TRASH ENCLOSURE
 - ASPHALT DRIVE LOT
 - CONCRETE DRIVE APRON PER COASTS DWG, 2425
 - LANDSCAPE AREA
 - COVERED ENTRY
 - WHITE T.P.O. ROOFING.
 - SCUPPER WITH SPLASHBLOCK BELOW.
 - ROOF CRICKET
 - FOUNTAIN, COMPLIES WITH § 6-1-1-9(i) [AREA IS 123 S.F. (500 S.F.MAX)]
 - SKYLIGHT, SEE A4.1
 - PLANTER
 - 2 SPACE MOTORCYCLE PARKING STALL
 - RELOCATED EXISTING LIQUID NITROGEN EQUIPMENT.
 - RELOCATED ELECTRICAL TRANSFORMER.
 - SEE AS1.2 FOR WALL ELEVATION.
 - LOCATION OF EXISTING FIRE HYDRANT

ADMINISTRATIVE
File # 24410368 Project # 1005157
5,555 sq. ft. addition
APPROVED BY: [Signature] DATE: 3/10/06


CITY OF ALBUQUERQUE
"SOLID WASTE"
MANAGEMENT DEPARTMENT
APPROVED 7/26/06

ANALYTICAL SOLUTIONS

10401 Research Road, SE
Albuquerque, NM 87123-3423

EUBANK BLVD.
111' ROW

1 SITE PLAN/ROOF PLAN
SCALE: 3/32"=1'
NORTH

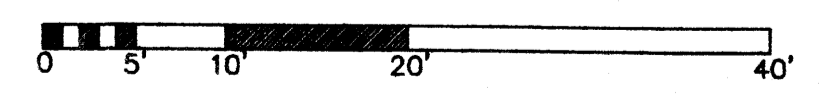

G. DONALD DUDLEY AIA
ARCHITECT
SIMMS TOWER STUDIO 850
400 GOLD AVENUE SW
ALBUQUERQUE, NEW MEXICO
8 7 1 0 2
TEL 505.243.8100
FAX 505.243.8101

DATE: SEPTEMBER 18, 2004
DRAWN BY: GDD, eh, etd

AS1.1
sequence no. 01

RESEARCH ROAD


CIG Per 2415A
SIDEWALK Per 2430

GENERAL NOTES


1. DO NOT SCALE DRAWINGS
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3. VERIFY EXISTING CONDITIONS IN FIELD. BRING DISCREPANCIES TO ATTENTION OF ARCHITECT
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KEYED NOTES


1. 1-1/2" O.D. GALVANIZED STEEL PIPE, PAINT BLACK
2. 3,000 P.S.I. CONCRETE FOOTING
3. ACCESSIBLE PARKING SIGN, NMBC APPROVED TYPE R7-8, WHITE FIELD, GREEN LETTERING AND BORDER, SYMBOL IS BLUE BACKGROUND WITH WHITE INTERNATIONAL SYMBOL OF ACCESSIBILITY
4. 1"x2"x1/8" STEEL TABS WELDED TO PIPE, PROVIDE HOLES FOR CARRIAGE BOLT/CAP NUT ATTACHMENT TO SIGN
5. "VAN ACCESSIBLE" PARKING SIGN, NMBC APPROVED TYPE R7-8A, WHITE FIELD, GREEN LETTERING AND BORDER
6. CONCRETE SIDEWALK RE: CIVIL, LIGHT BROOM FINISH
7. "THUNDERBOLT" TB-5-G PRE-MANUFACTURED BIKE RACK W. GALVANIZED FINISH AS MANUFACTURED BY CREATIVE PIPE, INC., HERMOSA BEACH, CA., PHONE (310)376-9536, WWW.CREATIVEPIPE.COM
8. 6"x6" STEEL GATE POST, GROUT SOLID
9. CANE BOLT/RECEIVER, GALVANIZED
10. NOT USED
11. 2"x4" TUBE STEEL
12. "KING KONG HINGE" AS MANUFACTURED BY KING ARCHITECTURAL METALS, 1-800-542-2379
13. 6" O.D. CONCRETE FILLED STEEL PIPE BOLLARD ENCASED IN 6" CONCRETE ALL AROUND, EMBEDDED 24"
14. NOT USED
15. CONC. SLAB 6" THICK; 4000 PSI 3/4" AGG., W6X6-10/10 WMM OR EQ. SLOPE TO DRAIN 1/8" PER FOOT
16. CMU WALL, STUCCOED
17. OUTLINE OF REINFORCED CONCRETE FOOTING BELOW
18. APRON: 6" THICK; 4000 PSI 3/4" AGG., W5X6-10/10 WMM OR EQ. 12'X8" WITH 1/2" EXPANSION JOINT
19. L 2x2x3/16 STEEL ANGLE, WELDED TO TUBE STEEL FRAME W. FLAT FACE OF ANGLE LEG AT MIDPOINT OF TUBE (AS SHOWN)
20. GALVANIZED STEEL "B" DECK, WELD TO INSIDE OF STEEL ANGLE WITH WIDE FACE OF DECK TO OUTSIDE OF ENCLOSURE (AS SHOWN)
21. VERTICAL #4 REBAR @ 32" O.C., GROUT CELL SOLID
22. HORIZONTAL #4 REBAR @ 12" O.C.
23. MATCH TOP OF BLOCK.

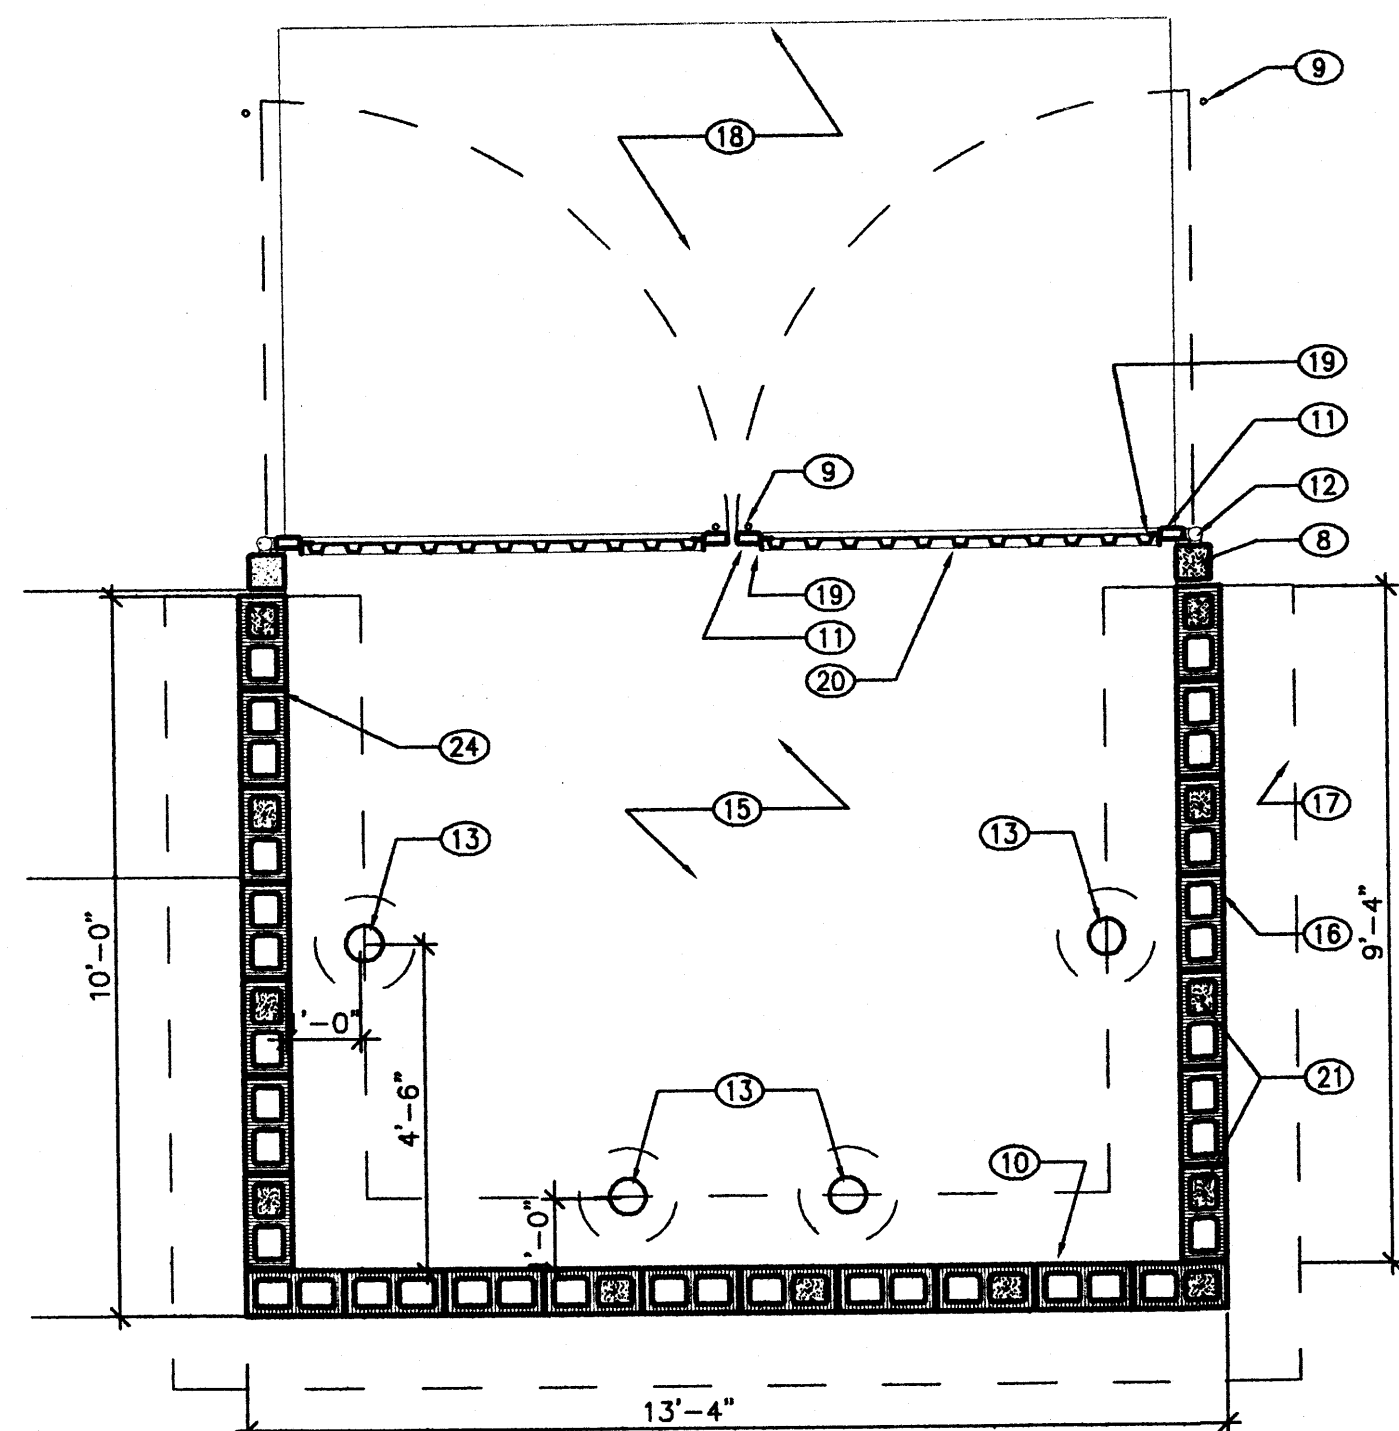


1 TRASH ENCLOSURE PLAN
SCALE: 3/8"=1'-0"

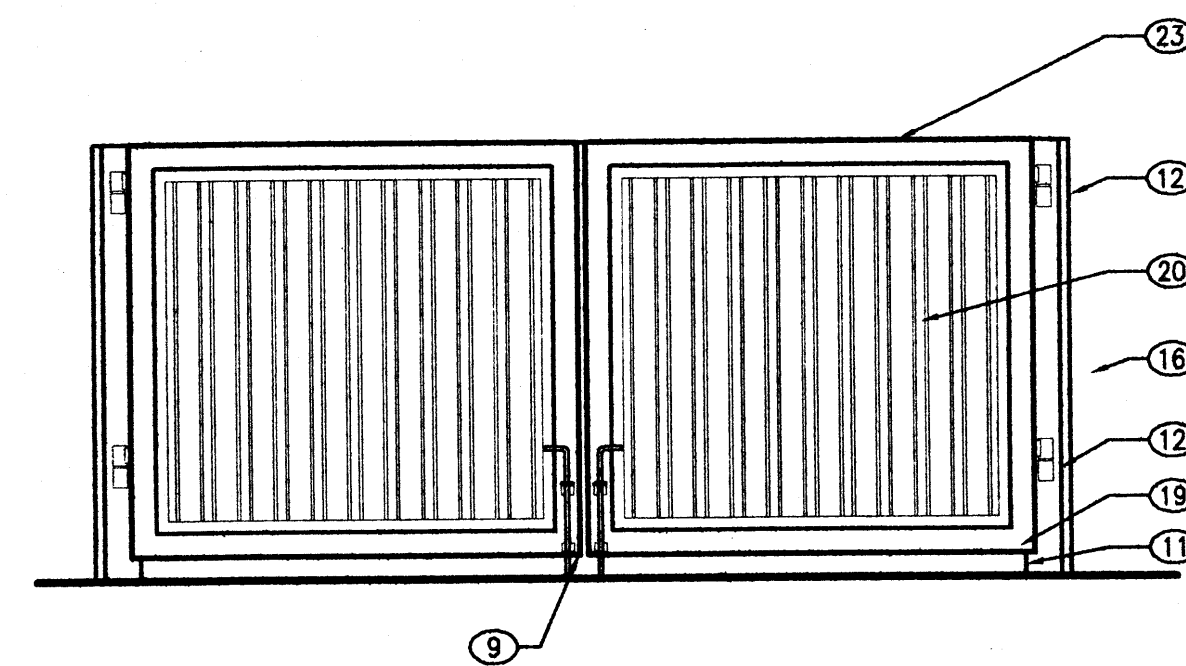


2 TRASH ENCLOSURE ELEVATION
SCALE: 3/8"=1'-0"

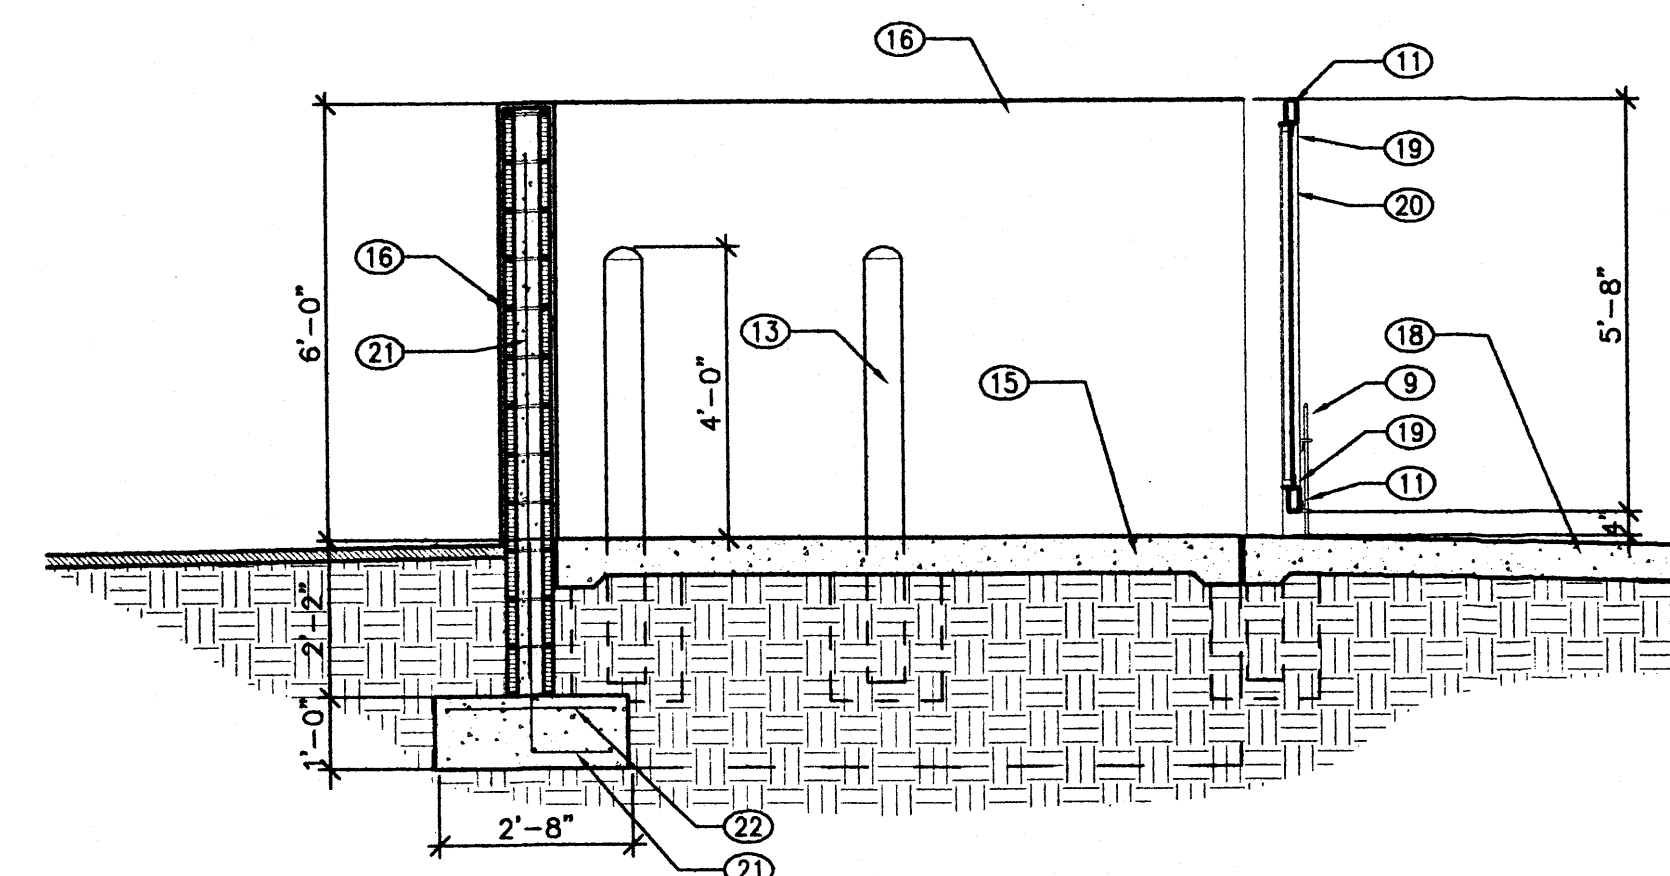


3 TRASH ENCLOSURE SECTION
SCALE: 3/8"=1'-0"

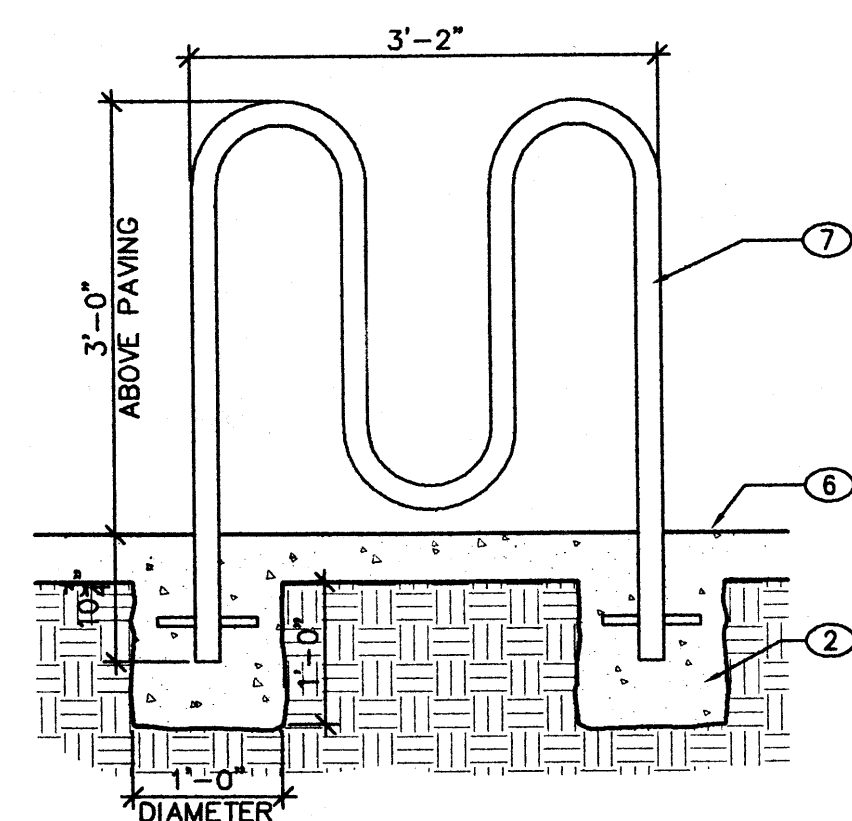


4 BIKE RACK DETAIL
SCALE: 3/4"=1'-0"

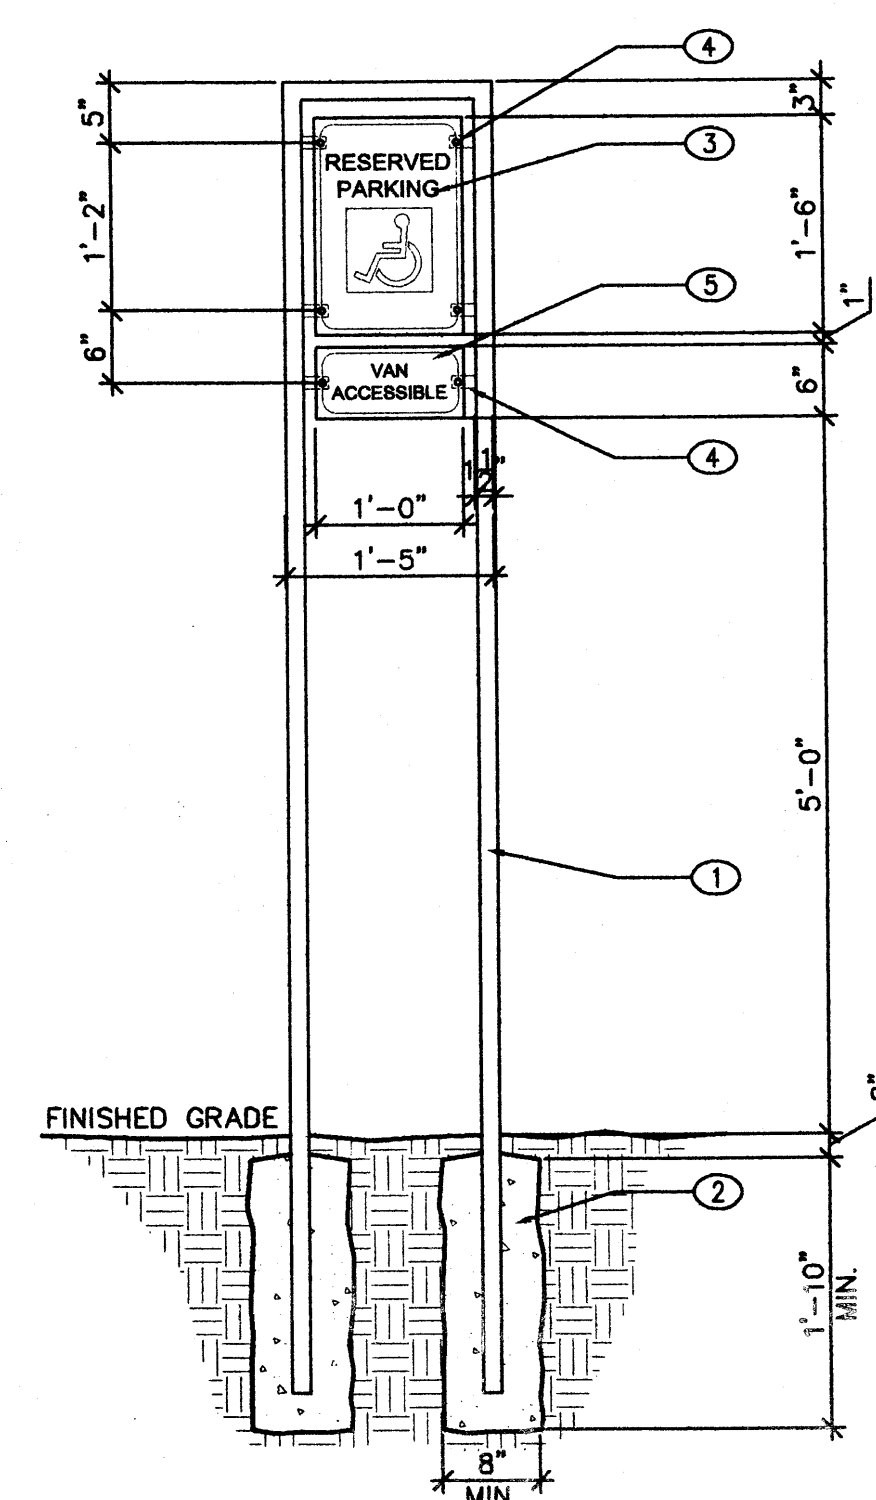


5 ACCESSIBLE SIGNAGE
SCALE: 3/4"=1'-0"

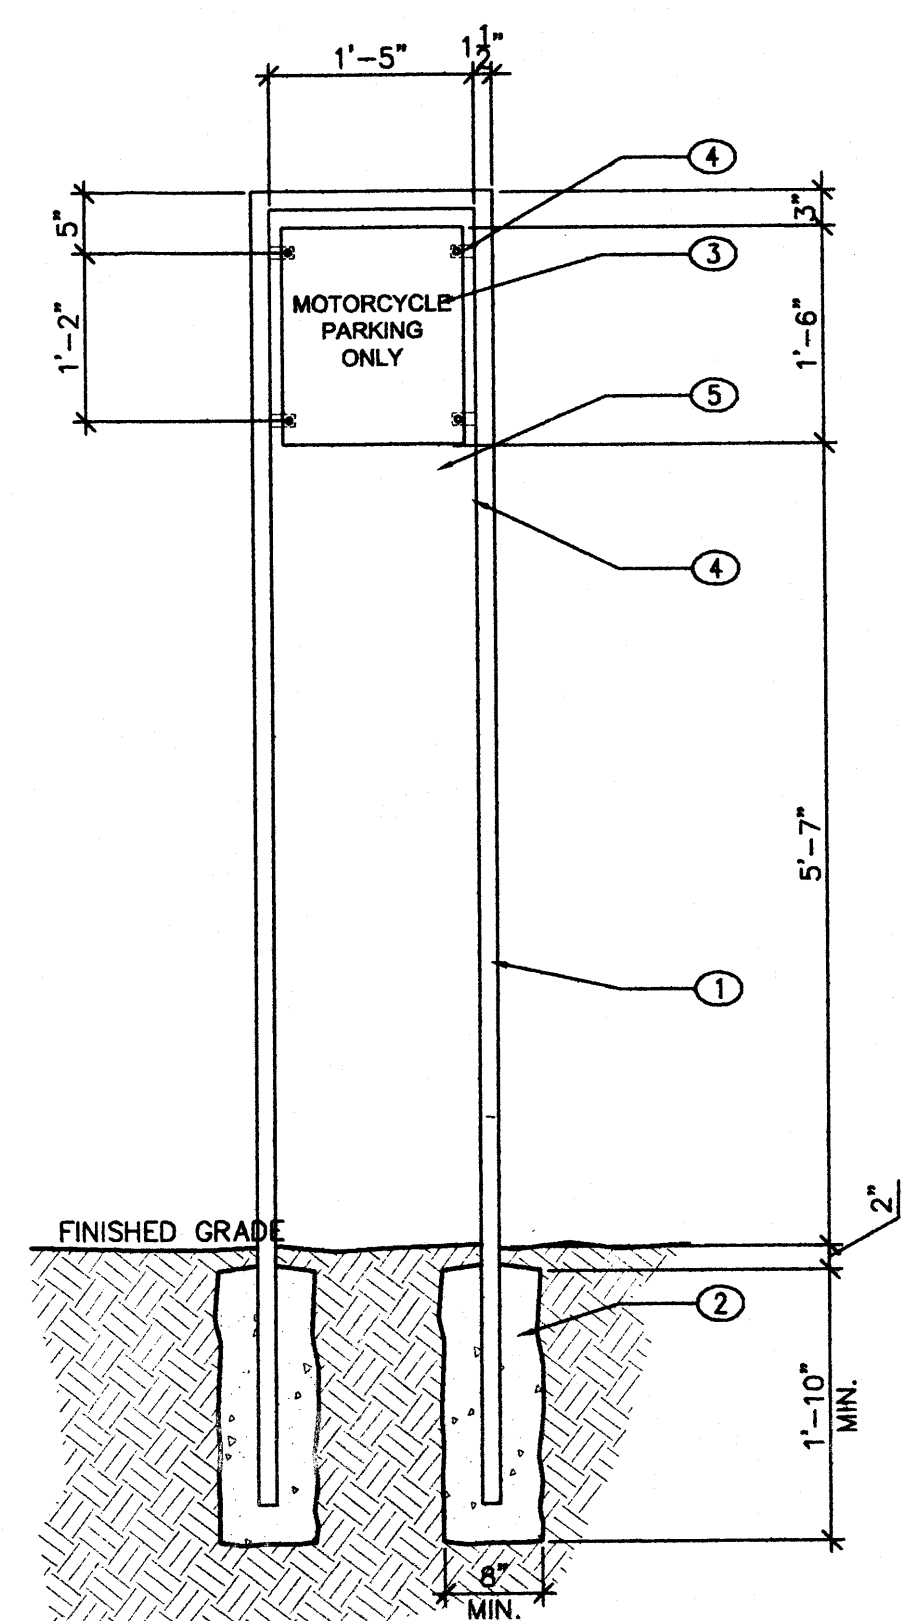

6 MOTORCYCLE SIGNAGE
SCALE: 3/4"=1'-0"

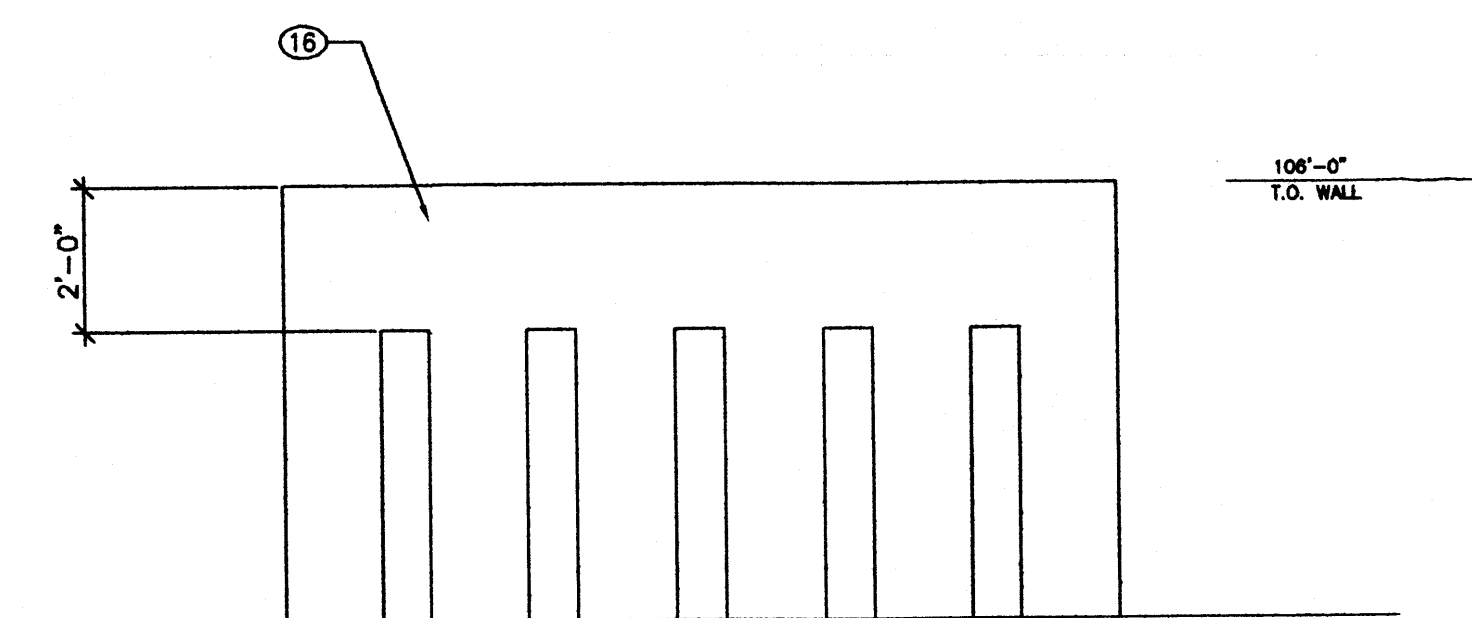

7 ENTRANCE WALL ELEVATION
SCALE: 3/8"=1'-0"

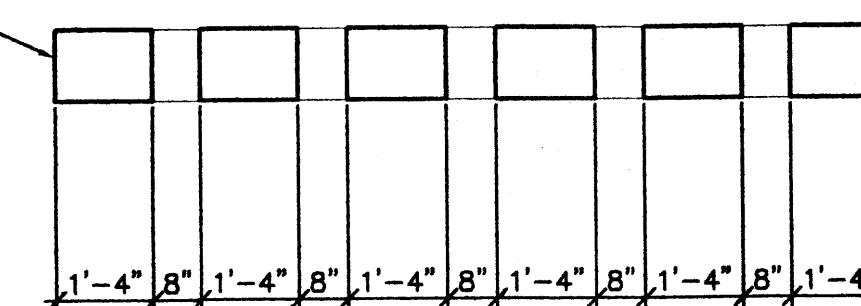


7 ENTRANCE WALL PLAN
SCALE: 3/8"=1'-0"

ANALYTICAL SOLUTIONS

10401 Research Road, SE
Albuquerque, NM 87123-3423

G. DONALD DUDLEY AIA
ARCHITECT

SIMMS TOWER STUDIO 850
400 GOLD AVENUE SW
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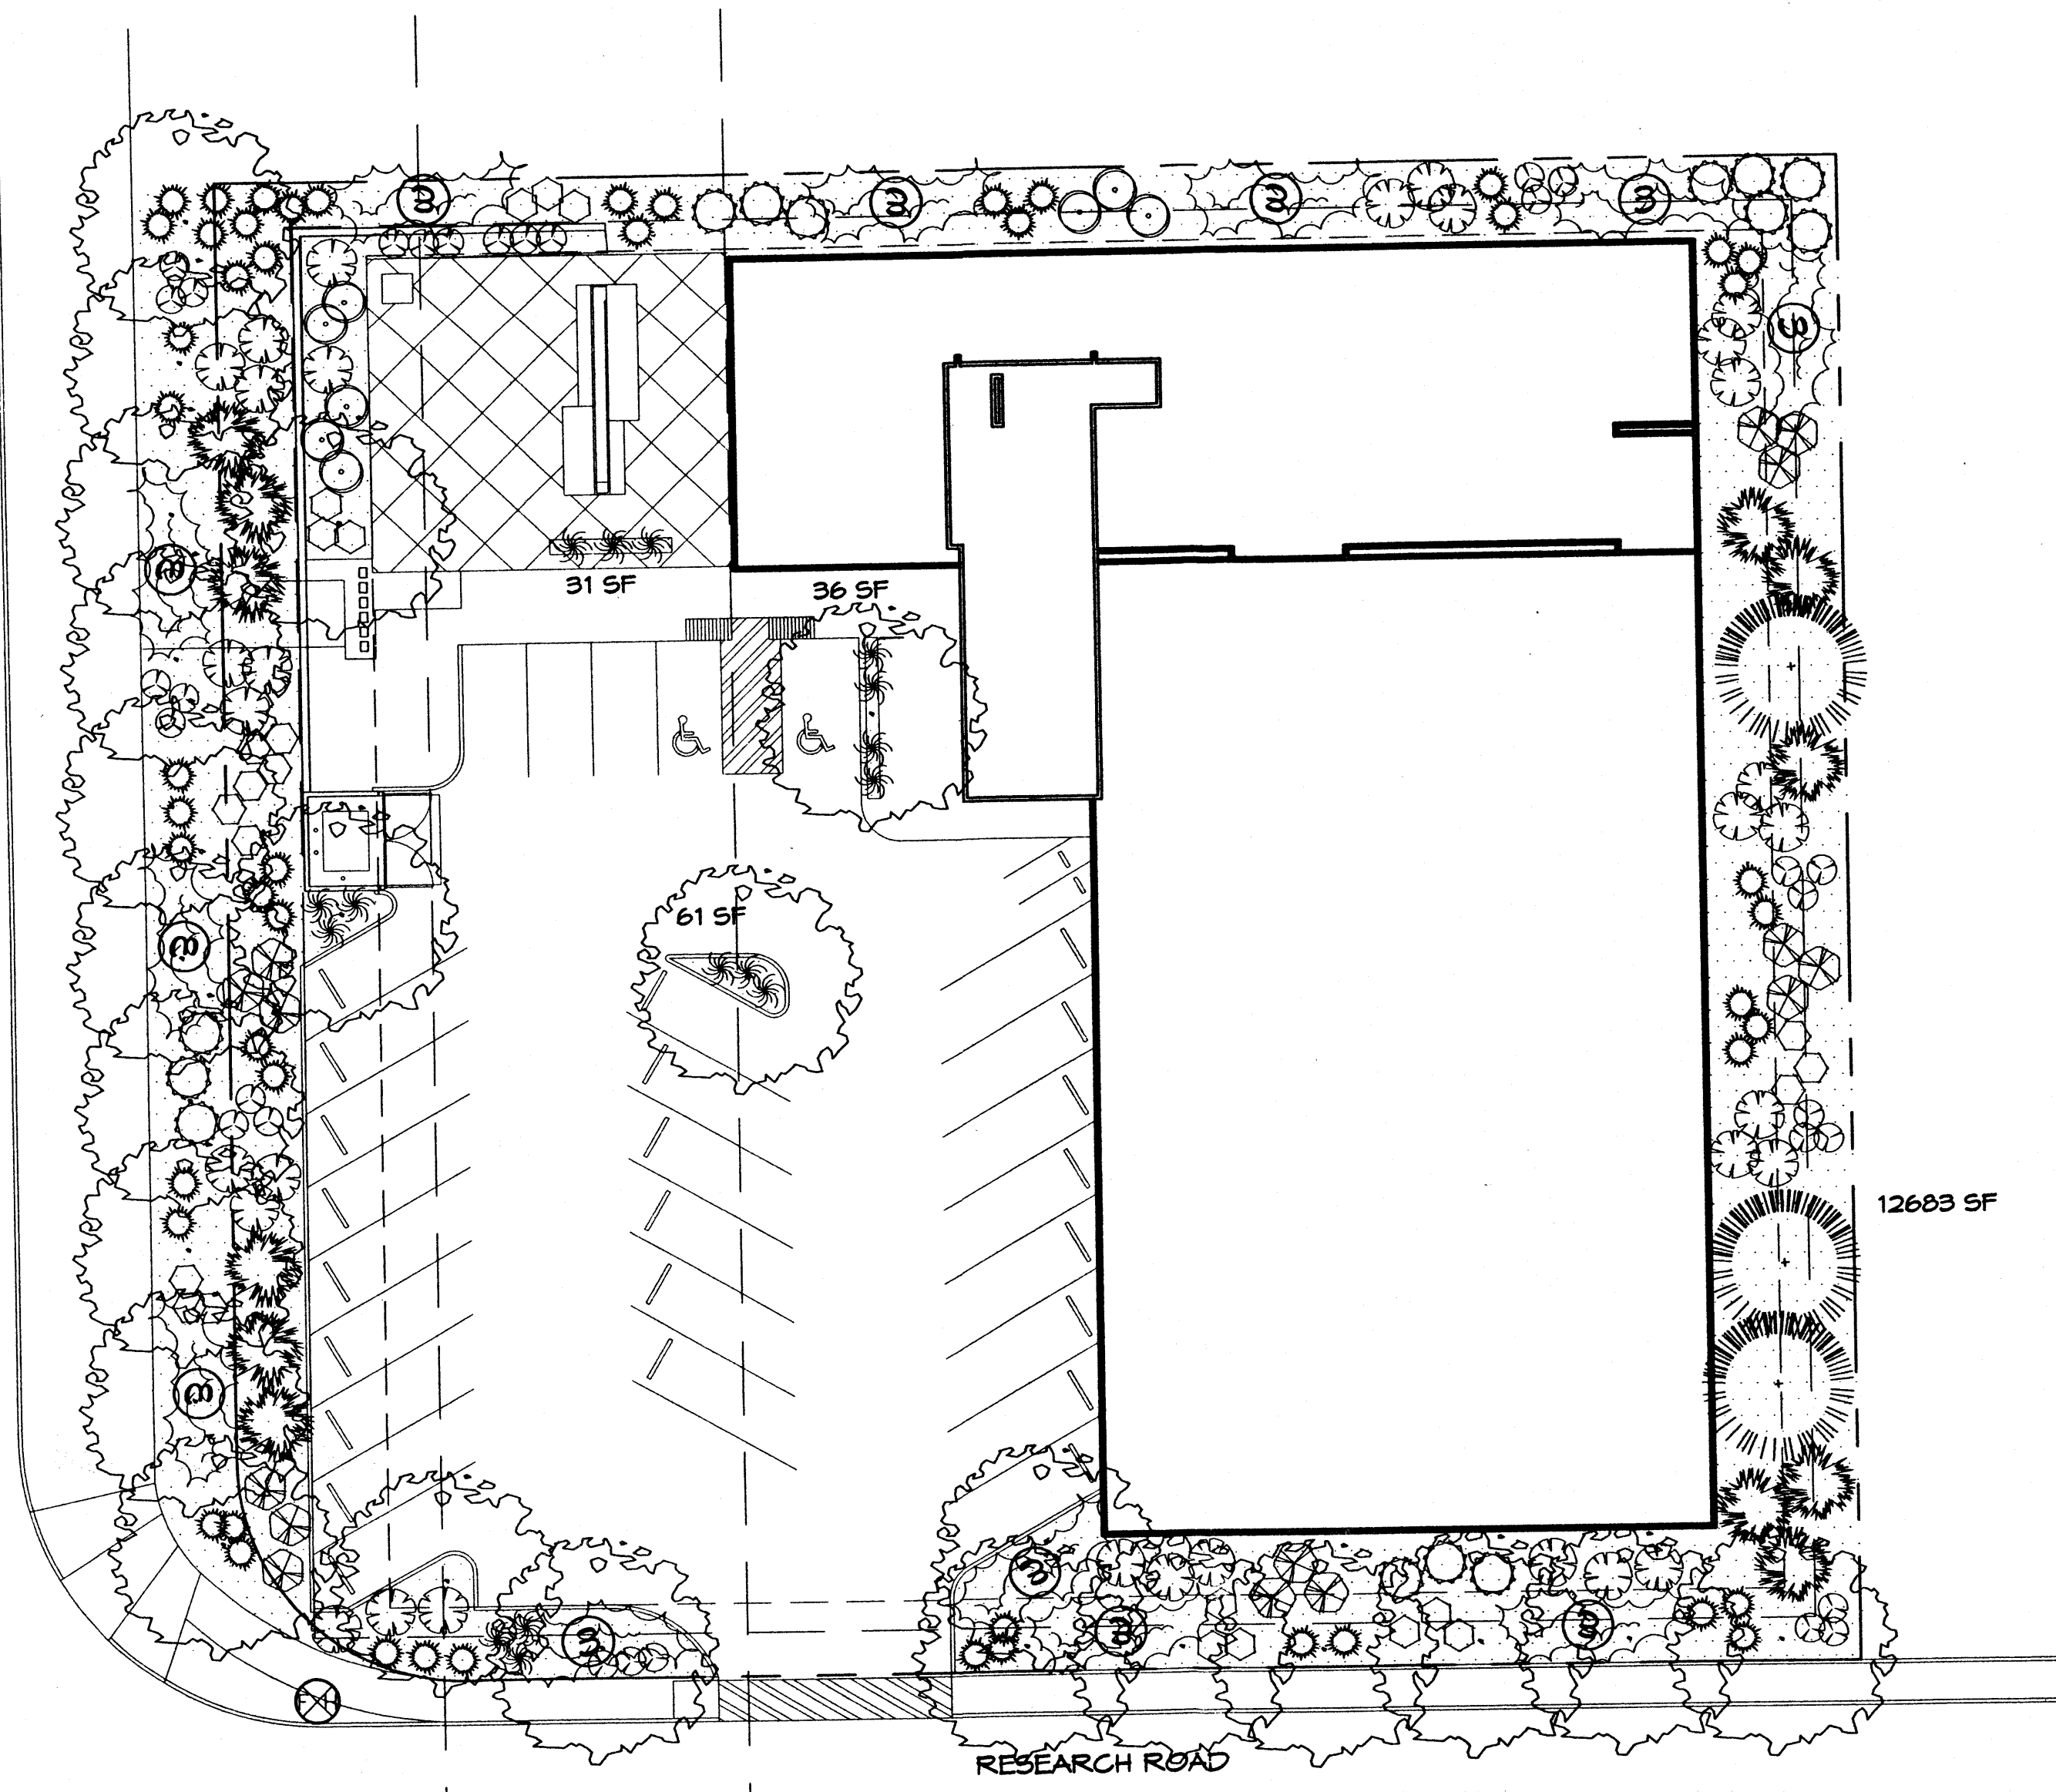


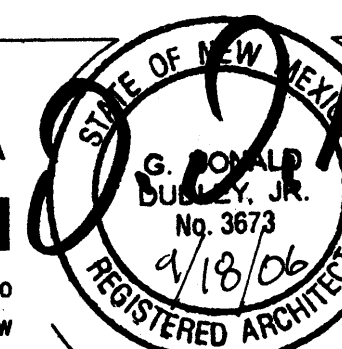SEPTEMBER 18, 2006
drawn by GDD, eh, etd

AS1.2

sequence no. 4 of 30

EUBANK BLVD.



PLANT LEGEND

- MODESTO ASH (M) 23**
Fraxinus velutina
2' Cal.
- BUTTERFLY BUSH (M) 12**
Buddleia davidii
5 Gal. 81sf
- ROSEMARY (M) 14**
Rosmarinus officinalis
2 Gal. 36sf
- INDIAN HAWTHORN (M) 15**
Raphiolepis indica
5 Gal. 36sf
- HALLS HONEYSUCKLE (M) 36**
Juniperus 'Halliana'
1 Gal. 144sf
Symbol indicates three plants.
- SCOTCH BROOM (M) 52**
Cytisus scoparius
1 Gal. 16sf
- SANTA ANA TAN WITH FILTER FABRIC 2" DEEP**
- AUSTRIAN PINE (M) 3**
Pinus nigra
6'-8'
- APACHE PLUME (L) 32**
Fallugia paradoxa
5 Gal. 25sf
- RUSSIAN SAGE (M) 8**
Perovskia atriplicifolia
5 Gal. 25sf
- AUTUMN SAGE (M) 24**
Salvia greggii
2 Gal. 4sf
- ORNAMENTAL GRASS (M) 16**
1 Gal. 25sf
MAIDEN GRASS
REGAL MIST
FOUNTAIN GRASS
BLUE AVENA
BLUE FESCUE
BEAR GRASS
- WILDFLOWER 30**
1 Gal. 4sf
Including but not limited to:
BLACK EYE SUSAN, PENSTEMON,
SANTOLINA, PRIMROSE,
YARROW, BLANKETFLOWER,
SNOW IN SUMMER, POPPY,
DAYLILIES,
ICEPLANT, RED HOT POKER,
AND CONEFLOWER.

LANDSCAPE CALCULATIONS

TOTAL LOT AREA	43525	square feet
TOTAL BUILDINGS AREA	16542	square feet
NET LOT AREA	26983	square feet
LANDSCAPE REQUIREMENT	15%	
TOTAL LANDSCAPE REQUIREMENT	4047	square feet
TOTAL BED PROVIDED	12811	square feet
GROUNDCOVER REQ.	75%	square feet
TOTAL GROUNDCOVER REQUIREMENT	9608	square feet
TOTAL GROUNDCOVER PROVIDED	9786	square feet
TOTAL LANDSCAPE PROVIDED	12811	square feet

LANDSCAPE NOTES:
Landscape maintenance shall be the responsibility of the Property Owner.

It is the intent of this plan to comply with the City Of Albuquerque Water Conservation Landscaping and Water Waste Ordinance planting restriction approach. Approval of this plan does not constitute or imply exemption from water waste provisions of the Water Conservation Landscaping and Water Waste Ordinance.

Water management is the sole responsibility of the Property Owner. All landscaping will be in conformance with the City of Albuquerque Zoning Code, Street Tree Ordinance, Pollen Ordinance, and Water Conservation Landscaping and Water Waste Ordinance. In general, water conservative, environmentally sound landscape principles will be followed in design and installation.

Plant beds shall achieve 75% live ground cover at maturity.

Santa Ana Tan Gravel over Filter Fabric shall be placed in all landscape areas which are not designated to receive native seed.

STREET TREE REQUIREMENTS

Street trees required under the City Of Albuquerque Street Tree Ordinance are as follows:

Name of Street: Eubank Blvd.
Required # 7 Provided # 10

Name of Street: RESEARCH ROAD
Required # 7 Provided # 7

PARKING LOT TREE REQUIREMENTS

Shade trees required under the City Of Albuquerque Parking Lot Tree Ordinance are as follows:

1 Shade tree per 10 spaces
Required # 5 Provided # 5

IRRIGATION NOTES:
Irrigation shall be a complete underground system with Trees to receive (5) 1.0 GPH Drip Emitters and Shrubs to receive (2) 1.0 GPH Drip Emitters. Drip and Bubbler systems to be tied to 1/2" poly pipe with flush caps at each end.


Run time per each drip valve will be approximately 15 minutes per day, to be adjusted according to the season.

Point of connection for irrigation system is unknown at current time and will be coordinated in the field. Irrigation will be operated by automatic controller.


Location of controller to be field determined and power source for controller to be provided by others.

Irrigation maintenance shall be the responsibility of the Property Owner.

Water and Power source shall be the responsibility of the Developer/Builder.

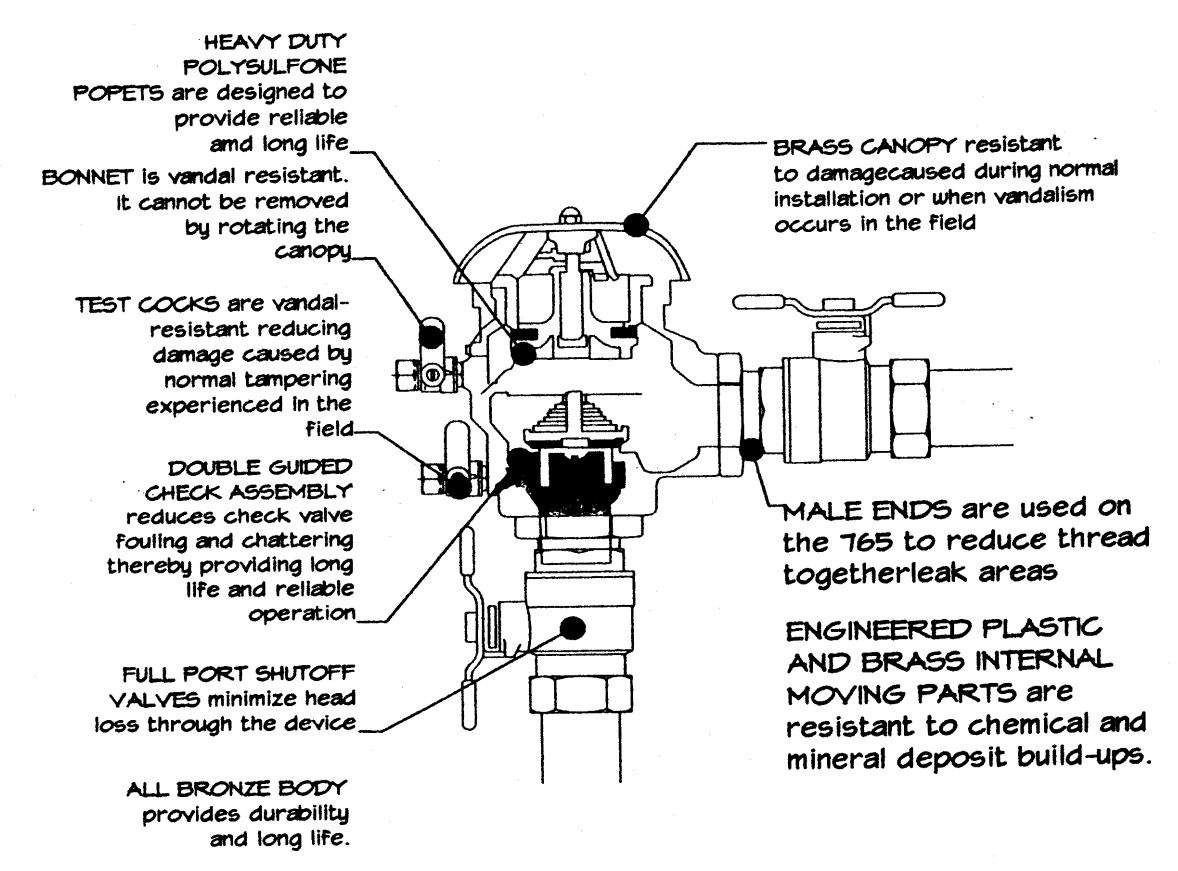


FEBCO MODEL 765 Pressure Vacuum Breaker Features

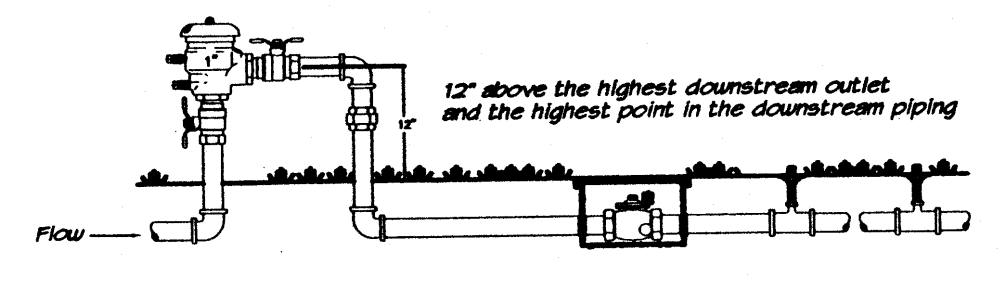


FEBCO MODEL 765 Pressure Vacuum Breaker Outside Installation

BACK FLOW DETAIL NOT TO SCALE

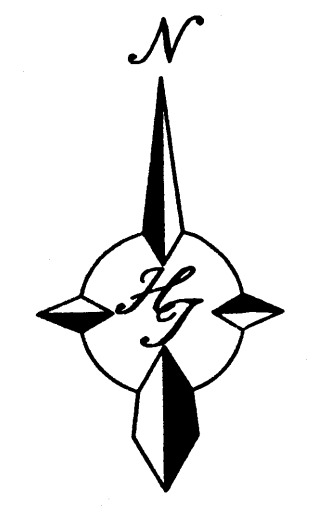

GRAPHIC SCALE

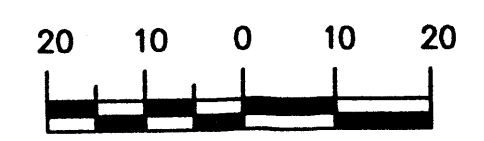

SCALE: 1"=20'



LANDSCAPE ARCHITECTS & CONTRACTORS
Cont. Lic. #26458
7909 Edith N.E.
Albuquerque, NM 87184
Ph. (505) 898-9690
Fax (505) 898-7737
cmj@hilltoplandscaping.com


All creative ideas contained herein remain the property of The Hilltop Landscape Architects and Contractors and are protected by copyright laws. This is an original design and must not be released or copied unless applicable fees have been paid or job order placed.

ANALYTICAL SOLUTIONS

10401 RESEARCH RD. SE
Albuquerque, NM

G. DONALD DUDLEY AIA
ARCHITECT

SIMMS TOWER STUDIO 850
400 GOLD AVENUE SW
ALBUQUERQUE, NEW MEXICO
8 7 1 0 2
TEL 505.243.8100
FAX 505.843.8820

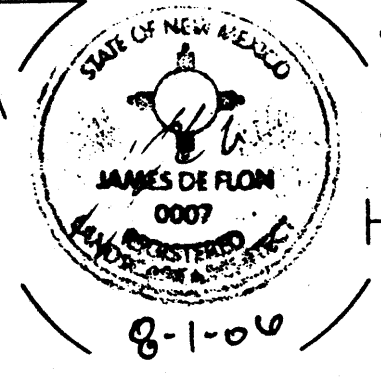


July 31, 2006

drawn by RMM



sequence no. 8 of 30

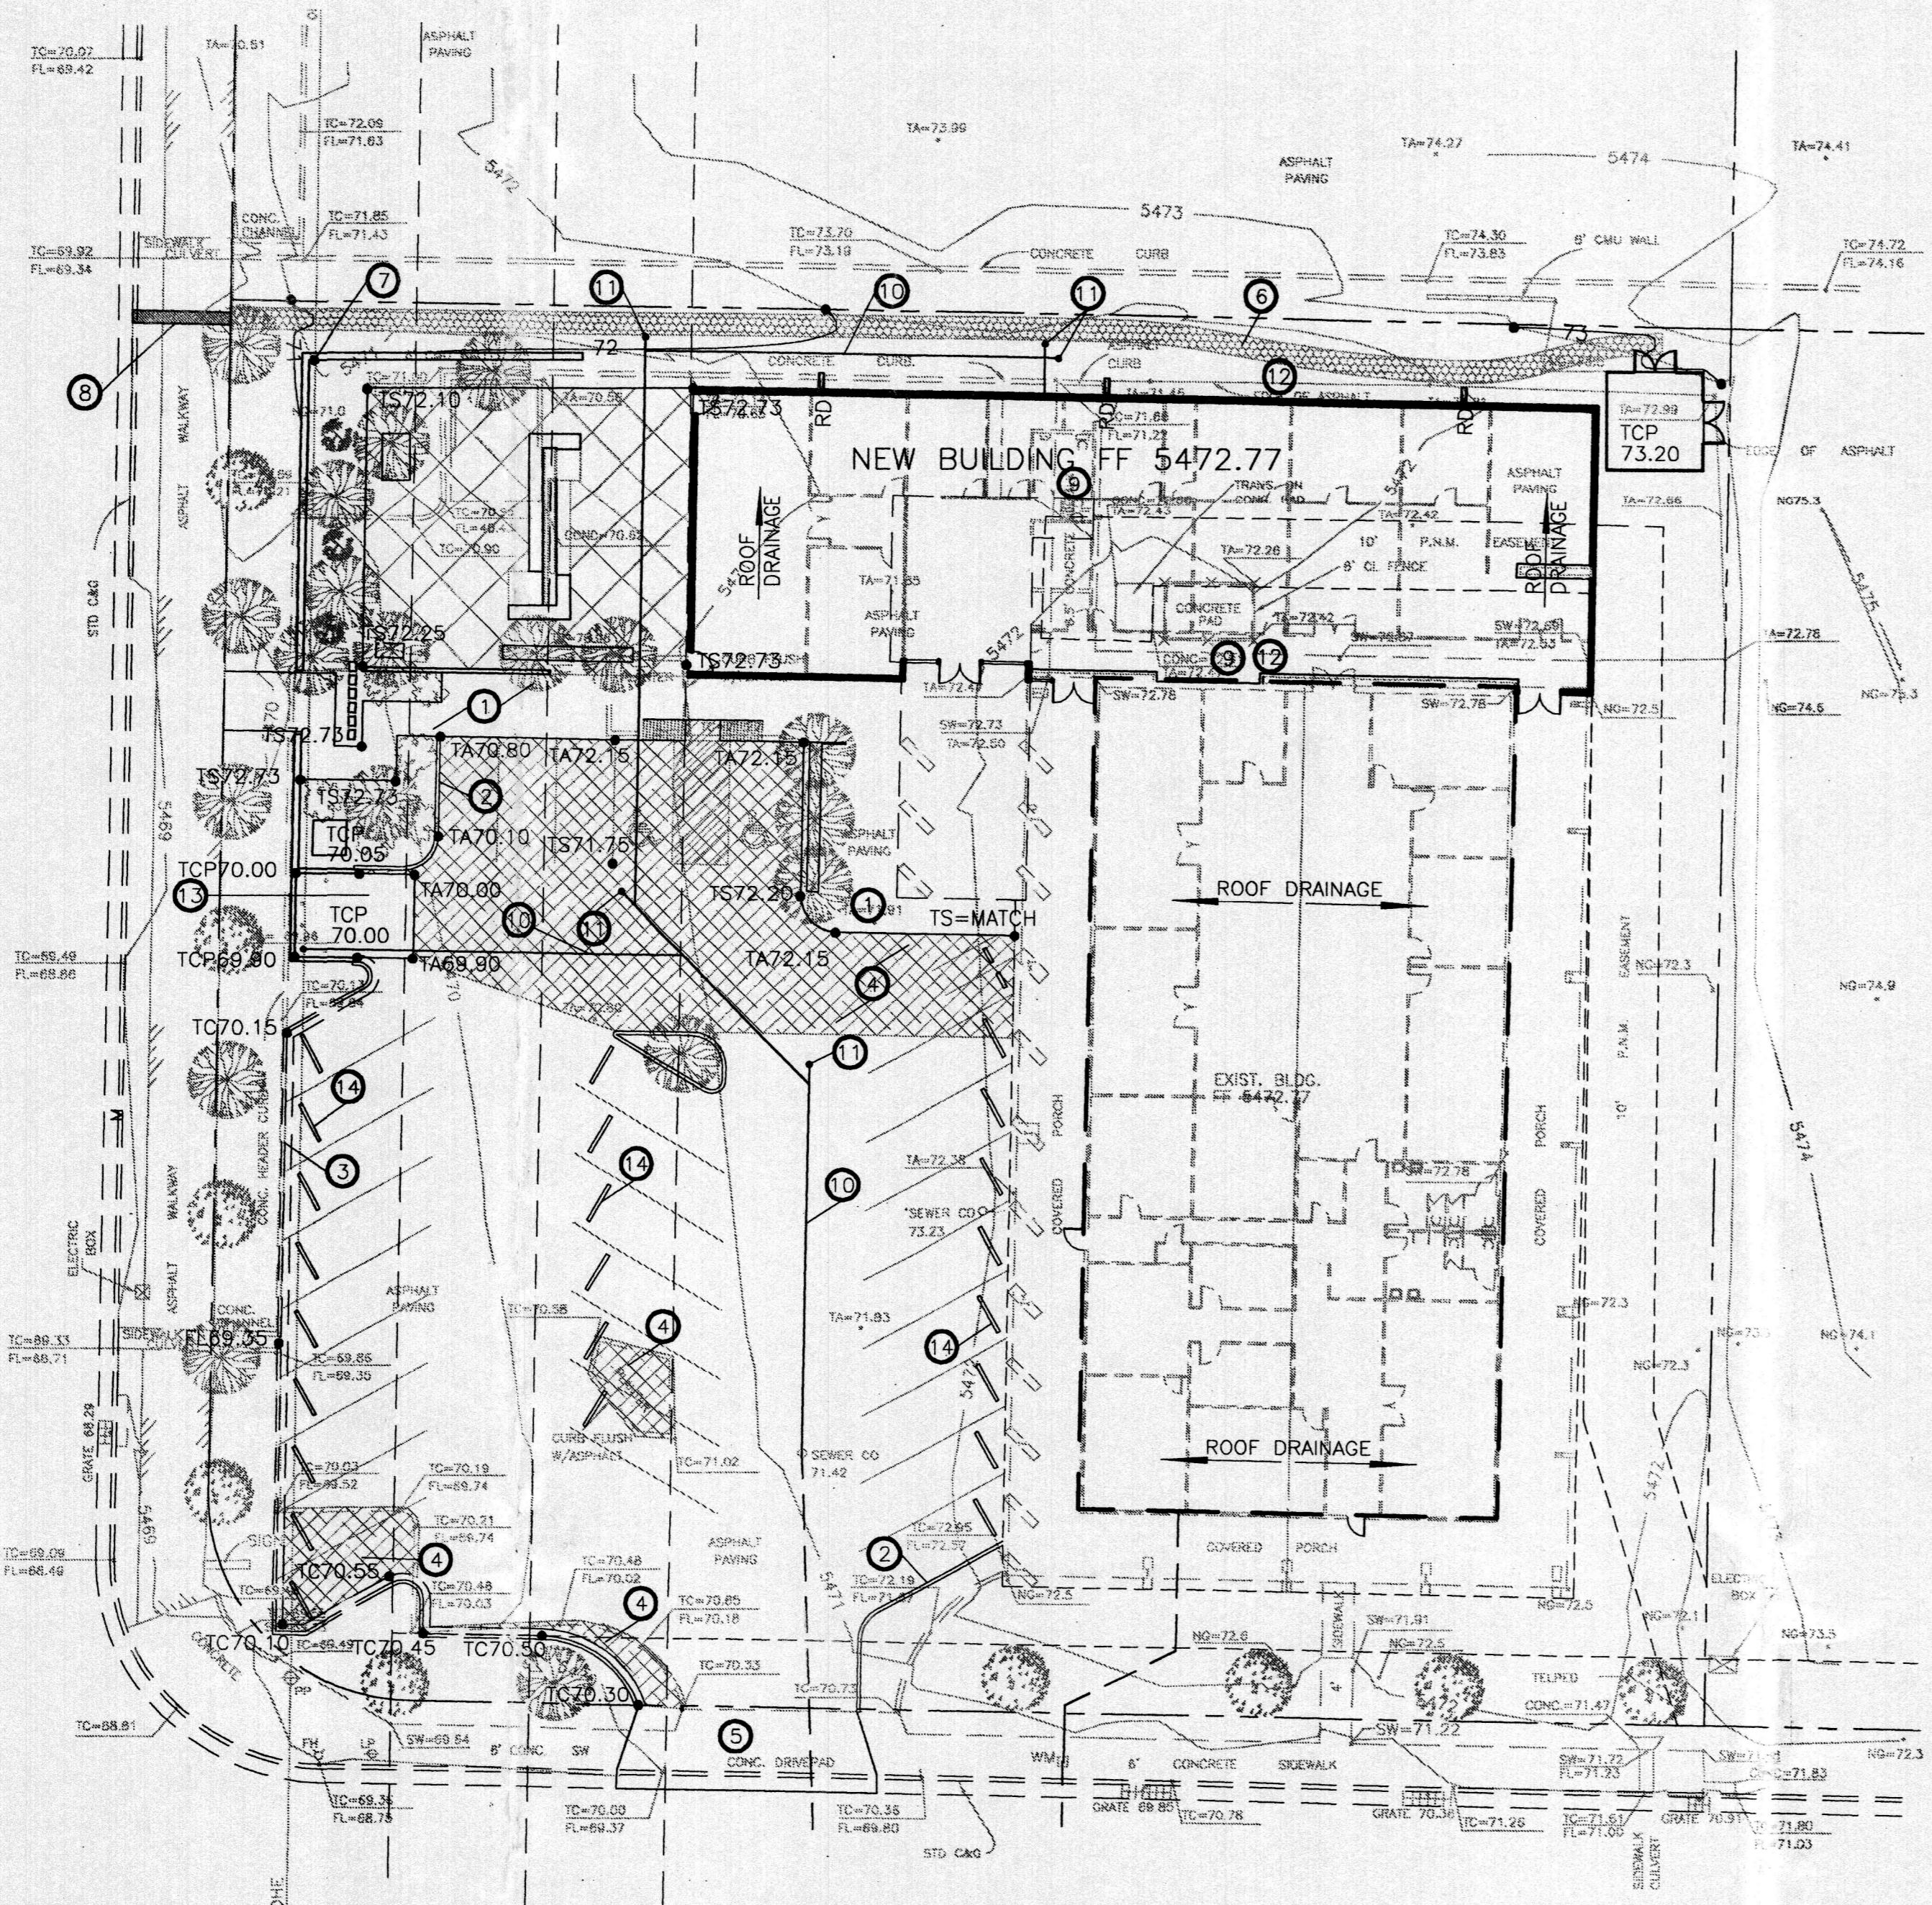

1 GRADING & DRAINAGE
 SCALE: 1" = 20'
 0 10' 20' 40' 80'

SEE SHEET C1.2 (CIVIL DETAILS) FOR 'OFFSITE DRAINAGE' AND 'DRAINAGE DATA'.
 SEE ARCHITECTURAL SHEETS FOR DEMO ITEMS.
 NEW TC AND TS SHALL BE 6" ABOVE ADJACENT TA.

SITE CONDITIONS

EXISTING CONDITION
 THE SITE IS PRESENTLY DEVELOPED WITH ONE BUILDING, WITH SEVERAL OUTDOOR EQUIPMENT FACILITIES AND PARKING LOT. THE WESTERLY HALF OF THE ROOF, THE EQUIPMENT AREA AND THE PARKING AREA DRAIN TO AN EXISTING SIDEWALK CULVERT TO EUBANK AT THE SOUTHWEST CORNER OF THE SITE AND THE EASTERLY HALF OF THE ROOF AND SIDE YARD DRAIN TO A SIDEWALK CULVERT TO RESEARCH AT THE SOUTHEAST CORNER OF THE SITE. OFFSITE FLOWS ARE LIMITED TO THE LOT EAST OF THE SITE WHICH IS PRESENTLY UNDEVELOPED. THIS REPORT ASSUMES THE OFFSITE AREA WILL CONTINUE TO ENTER THE SITE UNTIL THE LOT IS DEVELOPED.

PROPOSED CONDITION
 THE EXISTING BUILDING AND THE SOUTHERLY PORTION OF THE PARKING AREA WILL REMAIN. THE OUTDOOR EQUIPMENT AREA WILL BE REPLACED BY A BUILDING ADDITION AND THE NORTHERLY PORTION OF THE PARKING LOT WILL BE RECONFIGURED TO INCLUDE AN OUTDOOR EMPLOYEE AREA AND BUILDING ENTRY AREA. EXISTING WATER, SANITARY SEWER AND GAS SERVICE ARE TO REMAIN AND ALTERED AS SHOWN ON THIS SHEET. THE NEW BUILDING ADDITION AND A PORTION OF THE OUTDOOR EMPLOYEE AREA ARE TO BE ROUTED TO EUBANK VIA A NEW SIDEWALK CULVERT AT THE NORTHWEST CORNER OF THE SITE.

KEYED NOTES

1. TURNDOWN SIDEWALK. SEE DETAIL SHEET C1.2.
2. HEADER CURB. SEE DETAIL SHEET C1.2.
3. CURB & GUTTER. SEE DETAIL SHEET C1.2.
4. NEW ASPHALT (HATCHED AREA). SEE DETAIL SHEET C1.2.
5. REMOVE EXISTING DRIVEPAD. BUILD 30 FOOT WIDE DRIVEPAD DETAIL. SEE CITY OF ALBUQUERQUE STD. DWG. 2425, SECTION E-E.
6. 12" DRY STREAM. SEE DETAIL SHEET C1.2.
7. 2-3" PVC PIPES THRU WALL OR 2 CMU'S ON EDGE AT GROUND LEVEL TO PROVIDE FOR DRAINAGE.
8. 1 BARREL 18" WIDE SIDEWALK CULVERT. SEE CITY OF ALBUQUERQUE STD. DWG. 2236.
9. EXTEND 3/4" WATER LINE INTERNALLY FROM EXISTING SPIGOT TO BUILDING CONNECTIONS. SEE PLUMBING DRAWINGS.
10. EXTEND 4" SANITARY SEWER SERVICE FROM EXISTING CLEANOUT TO NEW BUILDING CONNECTIONS & REFUSE AREA. SEE PLUMBING DRAWINGS.
11. SANITARY SEWER CLEANOUT. SEE DETAIL SHEET C1.2.
12. RELOCATE GAS METER TO NORTH SIDE OF NEW BUILDING. SEE MECHANICAL DRAWINGS.
13. REFUSE ENCLOSURE w/8"x8" AREA DRAIN & 3" PVC OUTLET TO SANITARY SEWER SERVICE. AREA DRAIN GRATE ELEV. 69.85. SEE ARCHITECTURAL DRAWINGS.
14. CONCRETE PARKING BUMPERS.

SO19 NOTICE TO CONTRACTOR

1. AN EXCAVATION PERMIT WILL BE REQUIRED BEFORE BEGINNING ANY WORK WITHIN CITY RIGHT-OF-WAY.
2. ALL WORK ON THIS PROJECT SHALL BE PERFORMED IN ACCORDANCE WITH APPLICABLE FEDERAL, STATE AND LOCAL LAWS, RULES AND REGULATIONS CONCERNING CONSTRUCTION SAFETY AND HEALTH.
3. TWO WORKING DAYS PRIOR TO ANY EXCAVATION, THE CONTRACTOR MUST CONTACT THE LINE LOCATING SERVICE, NEW MEXICO ONE CALL AT 260-1990 FOR THE LOCATION OF EXISTING UTILITIES.
4. PRIOR TO CONSTRUCTION, THE CONTRACTOR SHALL EXCAVATE AND VERIFY THE LOCATIONS OF ALL OBSTRUCTIONS. SHOULD A CONFLICT EXIST, THE CONTRACTOR SHALL NOTIFY THE ENGINEER SO THAT THE CONFLICT CAN BE RESOLVED WITH A MINIMUM AMOUNT OF DELAY.
5. BACKFILL COMPACTION WITHIN THE CITY RIGHT-OF-WAY SHALL BE ACCORDING TO TRAFFIC/STREET USE.
6. MAINTENANCE OF THE SIDEWALK CULVERT SHALL BE THE RESPONSIBILITY OF THE OWNER OF THE PROPERTY BEING SERVED.
7. WORK ON ARTERIAL STREETS SHALL BE PERFORMED ON A 24-HOUR BASIS.


GRADING NOTES

1. TWO (2) WORKING DAYS PRIOR TO ANY EXCAVATION, THE CONTRACTOR MUST CONTACT THE NEW MEXICO ONE CALL SYSTEM AT 260-1990 FOR LOCATION OF EXISTING UTILITIES.
2. PRIOR TO CONSTRUCTION, THE CONTRACTOR SHALL EXCAVATE AND VERIFY THE HORIZONTAL AND VERTICAL LOCATION OF ALL OBSTRUCTIONS. SHOULD A CONFLICT EXIST, THE CONTRACTOR SHALL NOTIFY THE ENGINEER SO THAT THE CONFLICT CAN BE RESOLVED WITH A MINIMUM AMOUNT OF DELAY.
3. ALL WORK ON THIS PROJECT SHALL BE PERFORMED IN ACCORDANCE WITH THE APPLICABLE FEDERAL, STATE AND LOCAL LAWS, RULES AND REGULATIONS CONCERNING CONSTRUCTION SAFETY AND HEALTH.
4. ALL CONSTRUCTION WITHIN THE PUBLIC RIGHT-OF-WAY SHALL BE PERFORMED IN ACCORDANCE WITH APPLICABLE CITY OF ALBUQUERQUE STANDARDS AND PROCEDURES.


EROSION NOTES

1. THE CONTRACTOR SHALL ENSURE THAT NO SOIL ERODES FOR THE SITE ONTO PUBLIC RIGHT-OF-WAY OR PRIVATE PROPERTY. THIS CAN BE ACHIEVED BY THE CONSTRUCTION OF TEMPORARY SOIL BERMS OR SILT FENCES AT PROPERTY LINES AND WETTING SOIL TO PREVENT IT FROM BLOWING. IF THE SITE IS CONTROLLED BY A SWPPP PLAN, EROSION CONTROL SHALL BE ACCOMPLISHED ACCORDING TO THE PLAN.
2. THE CONTRACTOR SHALL PROMPTLY CLEAN UP ANY MATERIAL EXCAVATED WITHIN THE PUBLIC RIGHT-OF-WAY SO THAT THE EXCAVATED MATERIAL IS NOT SUSCEPTIBLE TO BEING WASHED DOWN THE STREET.
3. THE CONTRACTOR SHALL SECURE THE APPROPRIATE BARRICADING, TOP SOIL DISTURBANCE AND EXCAVATION PERMITS FROM THE CITY PRIOR TO BEGINNING CONSTRUCTION.

VICINITY MAP NO. M-21

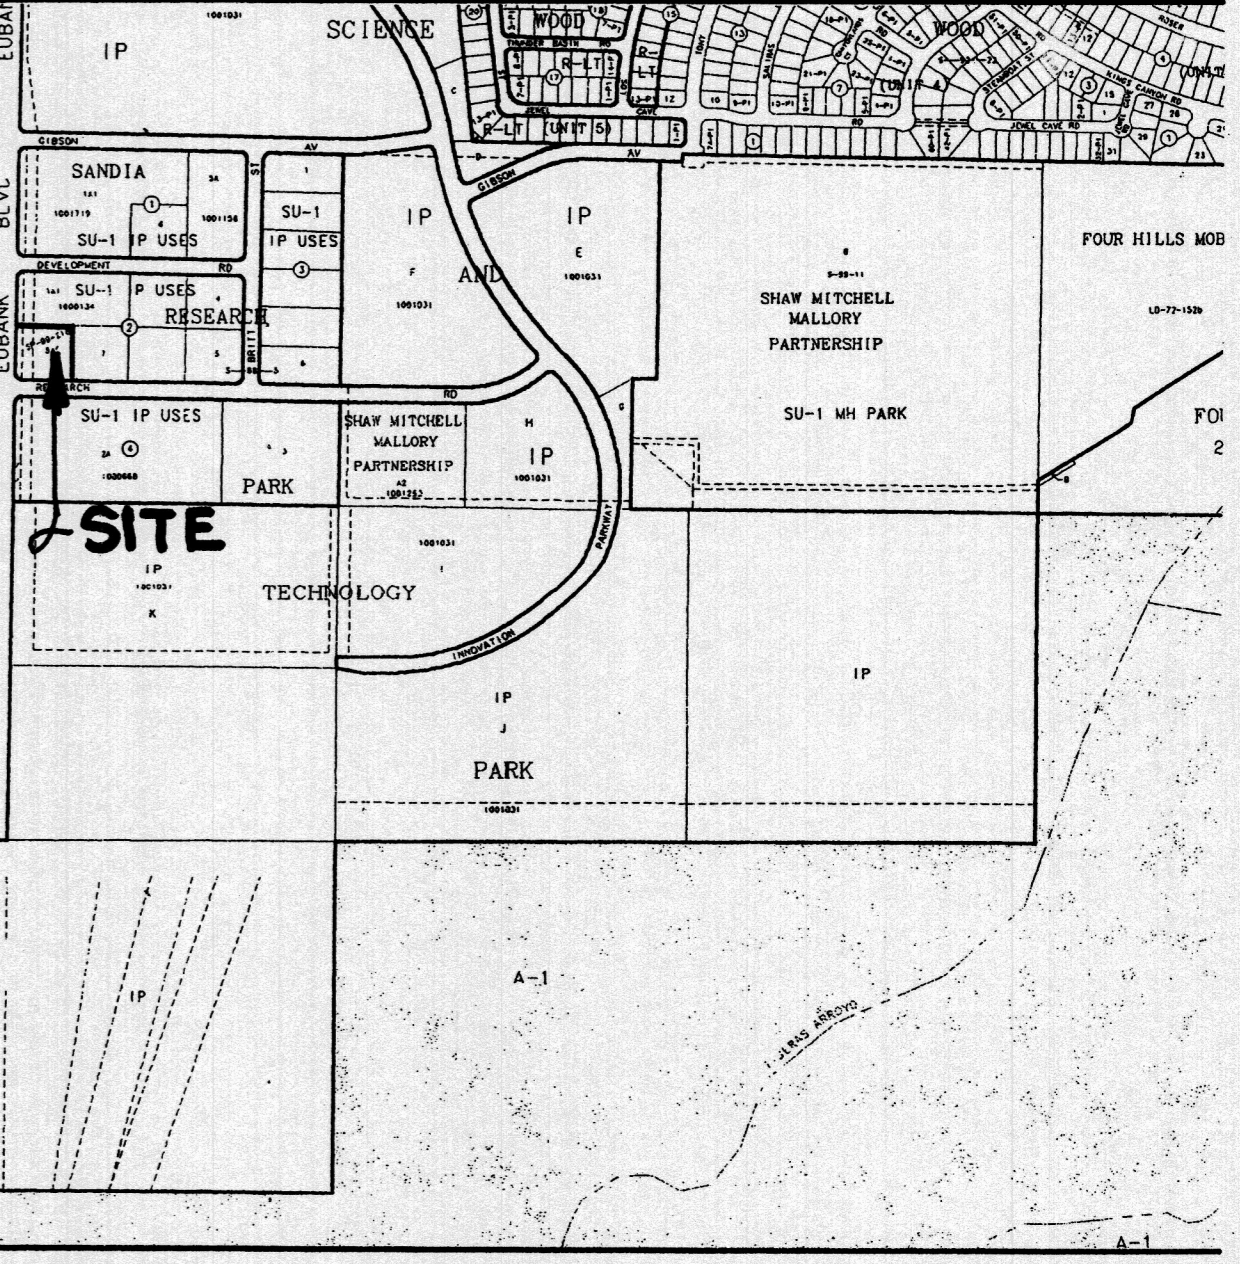

FEMA FIRM MAP NO. 366/367

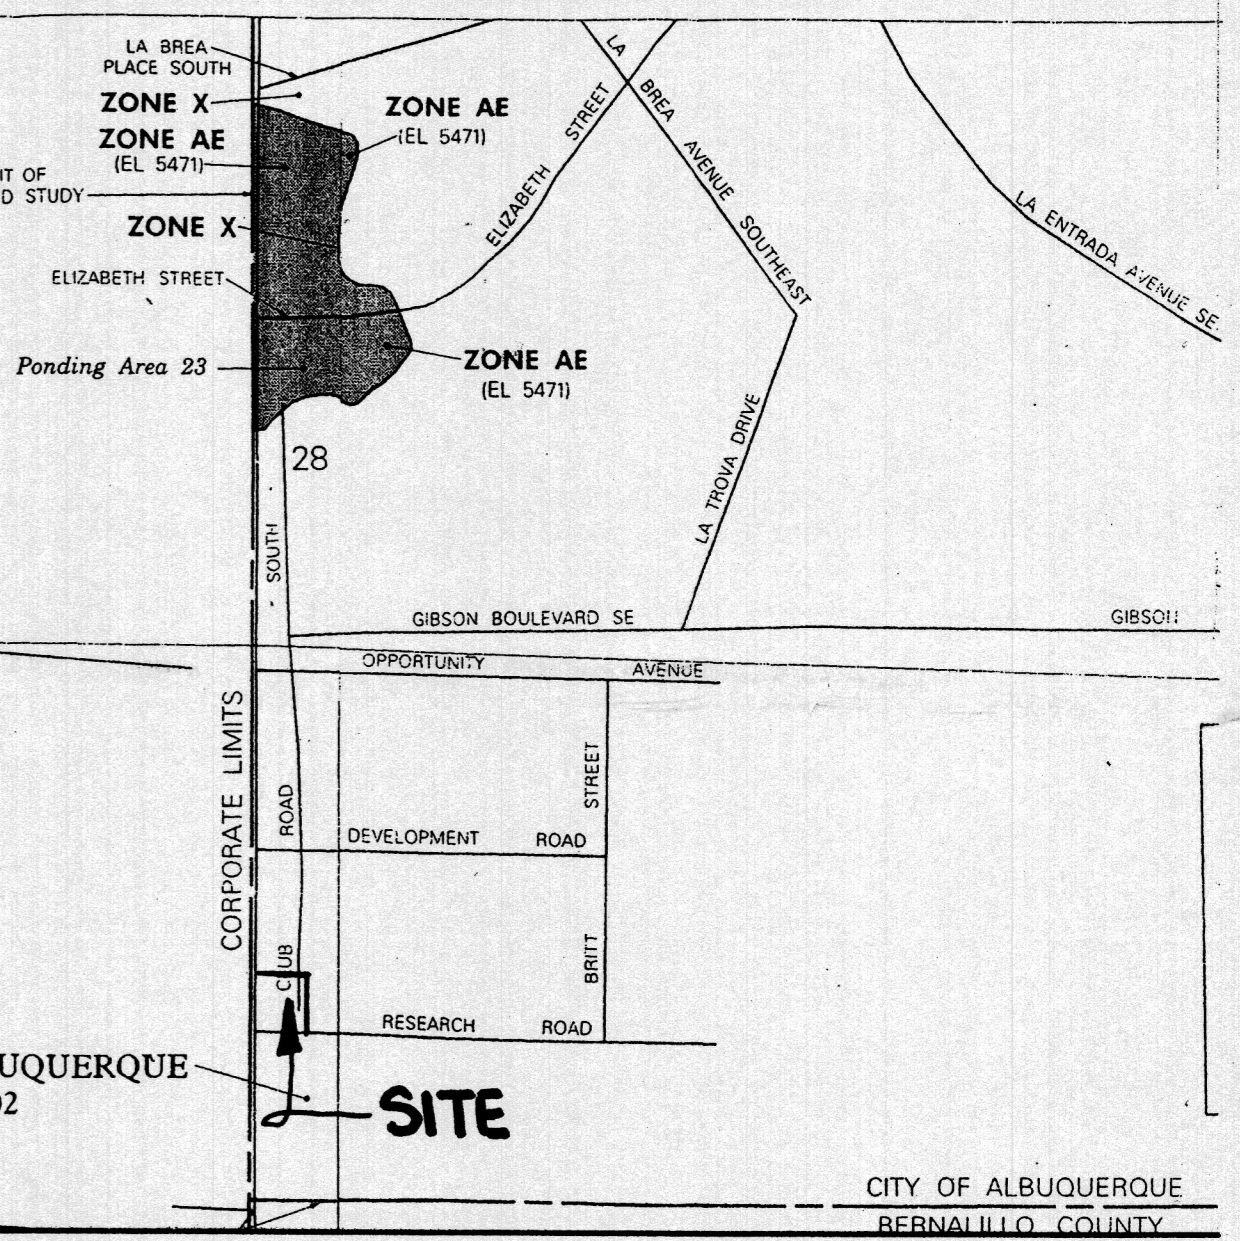

LEGAL DESCRIPTION

LOT 8-A, BLOCK 2, SANDIA RESEARCH PARK

PERMANENT BENCHMARK

ACS 10-L21 ELEVATION 5466.64 (NGVD 1929)

ANALYTICAL SOLUTIONS

10401 Research Road, SE
 Albuquerque, NM 87123-3423

ENGINEER'S CERTIFICATION

Blank area for the Engineer's Certification signature and stamp.

LEGEND

TBM	TEMPORARY BENCHMARK	LP	LIGHT POLE
NG	NATURAL GROUND	PP	POWER POLE
FF	FINISH FLOOR	CW	GUY WIRE
FG	FINISH GRADE	PED	ELEC. OR TEL. PEDESTAL
FL	FLOWLINE	RD	ROOF DRAINAGE POINT
TA	TOP OF ASPHALT		
TCP	TOP OF CONCRETE		
TC	TOP OF CURB		
TS	TOP OF SIDEWALK		
TW	TOP OF WALL	XX.XX	EXISTING SPOT ELEVATION
FH	FIRE HYDRANT	XX.XX	PROPOSED SPOT ELEVATION
WM	WATER METER	XX.XX	RECORD SPOT ELEVATION
WV	WATER VALVE	XX.XX	
MH	MANHOLE		
CB	CATCH BASIN GRATE		
GM	GAS METER		
GV	GAS VALVE		
		---	EXISTING CONTOUR
		---	PROPOSED CONTOUR


G. DONALD DUDLEY AIA
ARCHITECT

5110


DATE: August 8, 2006
 DRAWN BY: GDD, eh, etc

SIMMS TOWER STUDIO 850
 400 GOLD AVENUE SW
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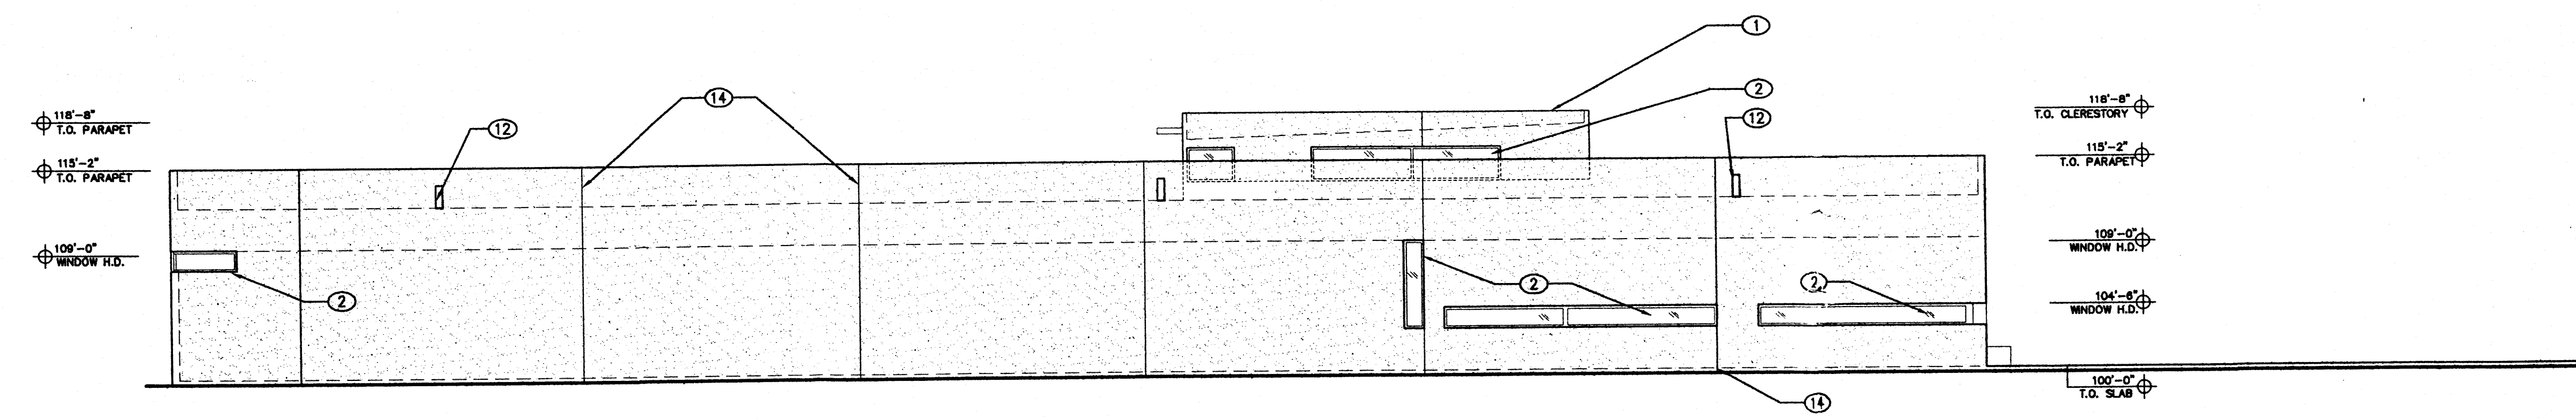
C1.1
 sequence no. etc

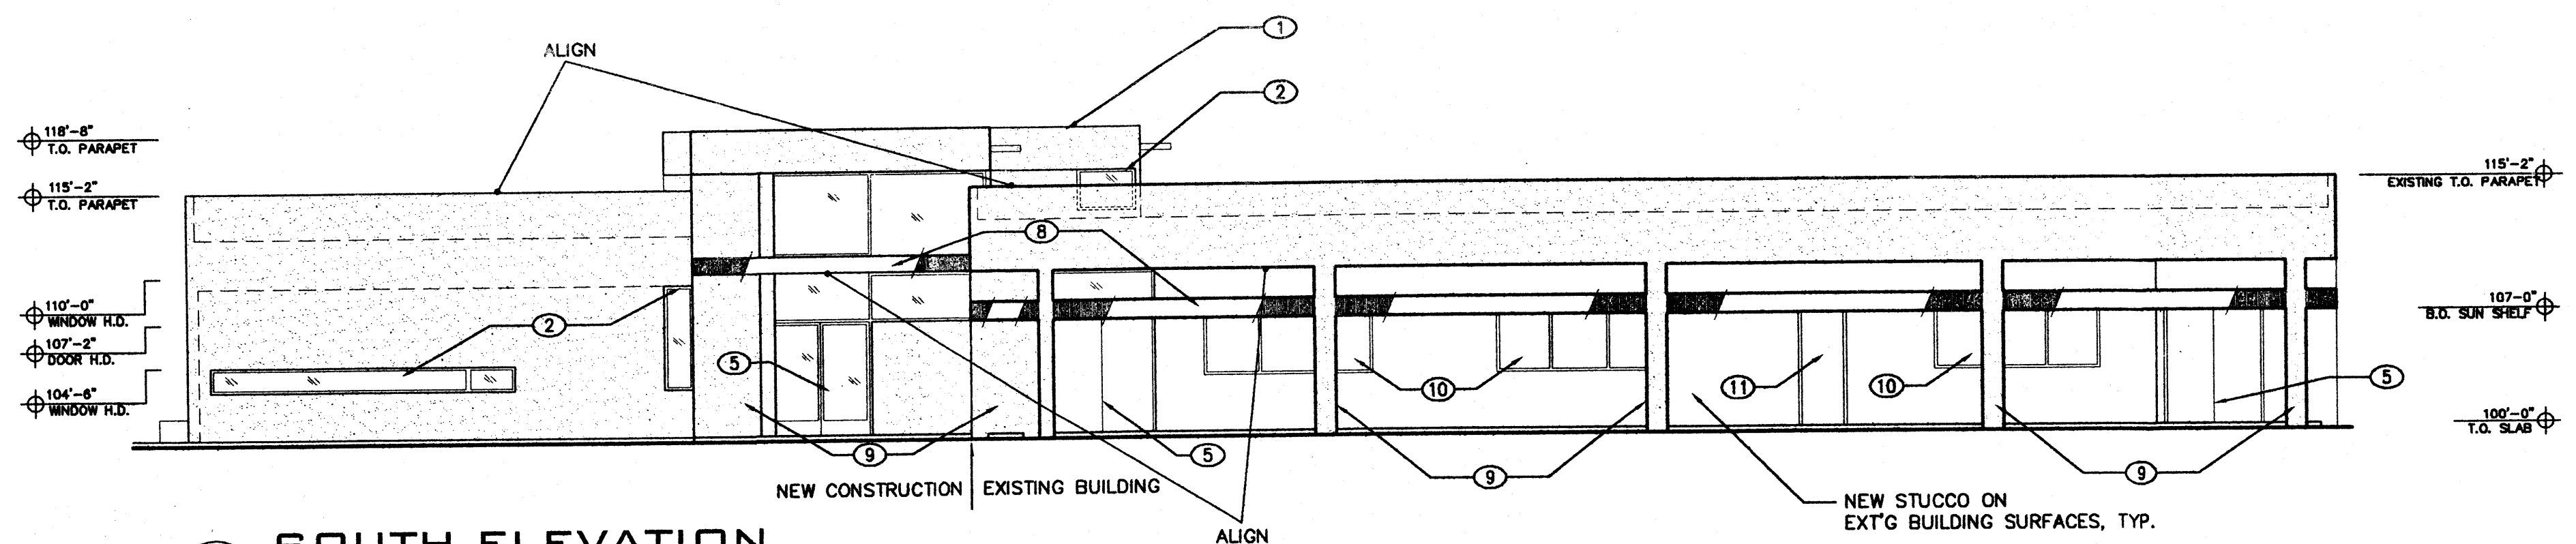


1 SOUTH ELEVATION
 SCALE: 1/8"=1'-0"

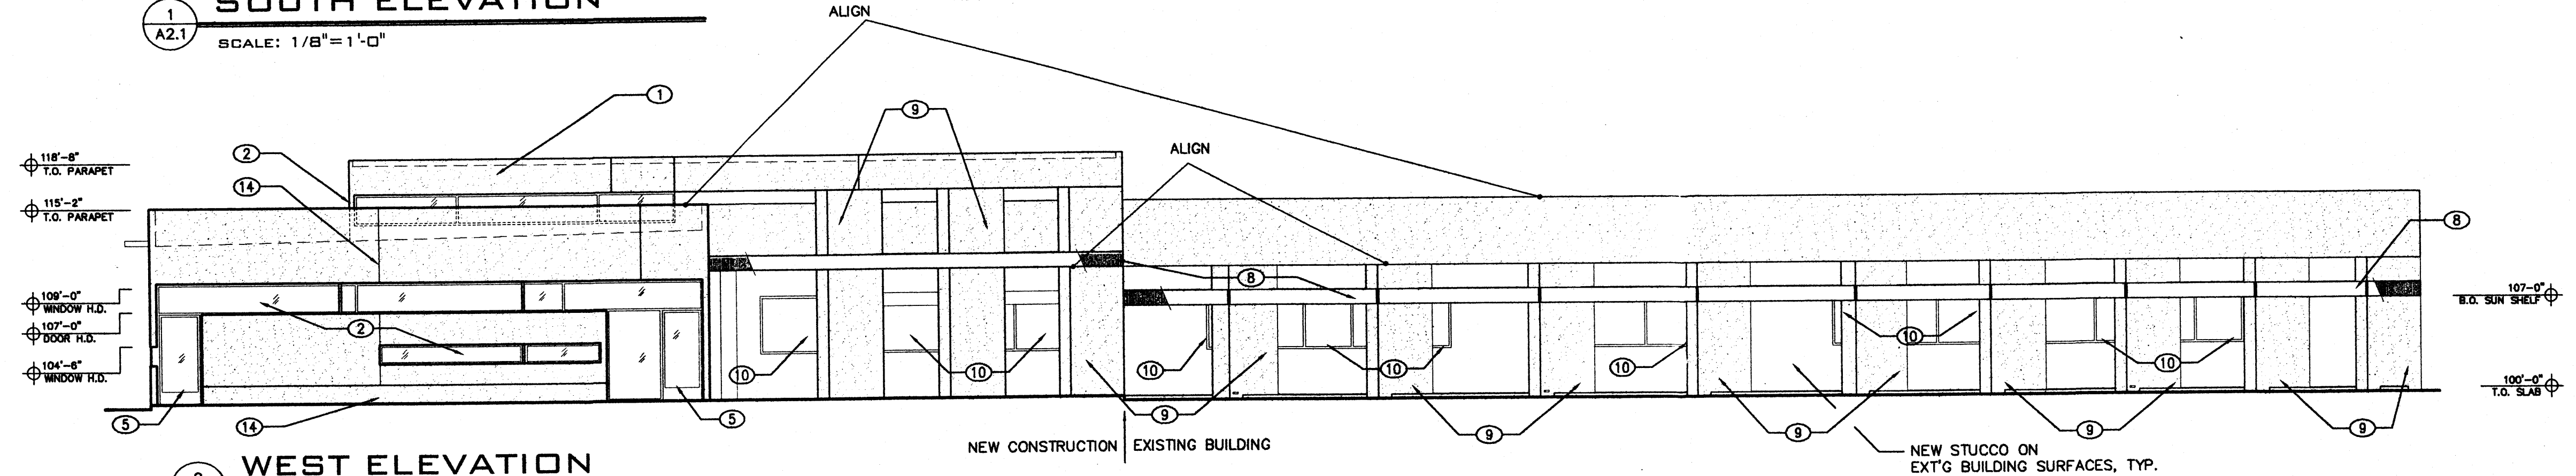

2 WEST ELEVATION
 SCALE: 1/8"=1'-0"



3 NORTH ELEVATION
 SCALE: 1/8"=1'-0"

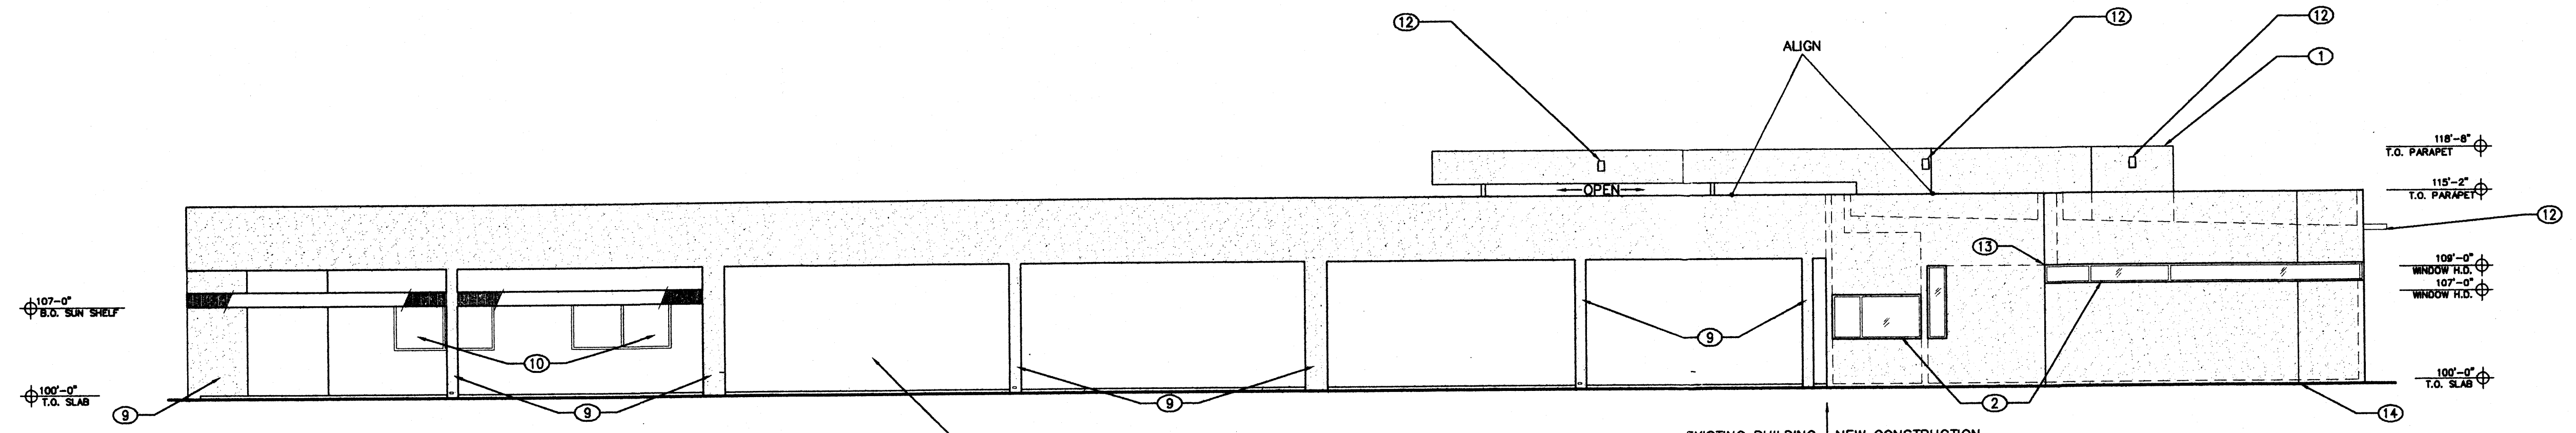

4 EAST ELEVATION
 SCALE: 1/8"=1'-0"

GENERAL NOTES

1. DO NOT SCALE DRAWINGS
2. CONTRACTOR TO COORDINATE ALL DRAWINGS PRIOR TO CONSTRUCTION
3. VERIFY EXISTING CONDITIONS IN FIELD. BRING DISCREPANCIES TO ATTENTION OF ARCHITECT
4. DIMENSIONS ARE TO FACE OF STUDS UNLESS OTHERWISE NOTED
5. F.F. INDICATES THAT THE DIMENSION IS A CRITICAL FINISHED DIMENSION MEASURED FROM FINISHED FACE TO FINISHED FACE
6. EXISTING GROUND FLOOR SLAB ELEVATION INDICATED AS 100'-0". ALL VERTICAL DIMENSIONS ARE MEASURED FROM THIS POINT

KEYED NOTES

1. RAISED ENTRY CANOPY WITH CLERESTORY
2. WINDOW, SEE SCHEDULE
3. STUCCO W/ HARD TROWELLED FINISH
4. SCUPPER
5. DOOR, SEE SCHEDULE
6. not used
7. ALIGN T.O. WIN HEAD W/ OPPOSITE SILL
8. HORIZONTAL SUN-SHELF: 22 GA. BRAKE METAL ON GYP. SHEATHING, PAINTED
9. VERTICAL SUN-FIN: STUCCO W/ HARD TROWELLED FINISH
10. EXISTING ALUMINUM STOREFRONT
11. EXISTING METAL DOOR
12. SCUPPER AND OVERFLOW
13. ALIGN WINDOW WITH SKYLIGHT ABOVE.
14. EXPANSION JOINT.

ANALYTICAL SOLUTIONS

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DATE: SEPTEMBER 18, 2006
 DRAWN BY: GDD, eh, etd

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