
TALOS LOG # 2007-2401-51

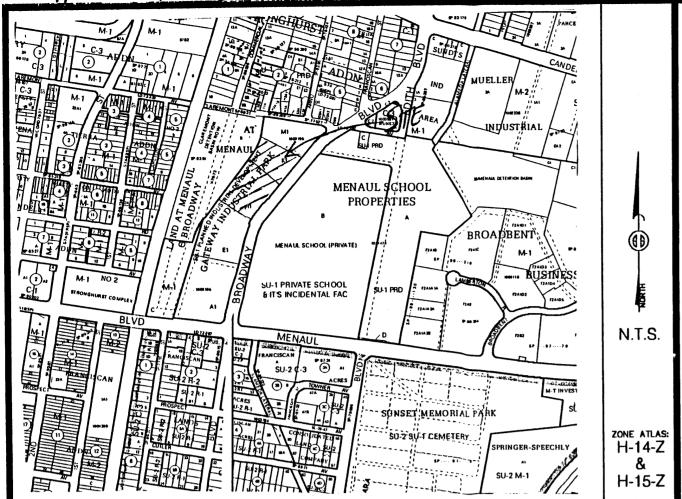

Vicinity Map

SUBDIVISION DATA / NOTES

- 1. PLAT WAS COMPILED USING EXISTING RECORD DATA & ACTUAL FIELD SURVEY.
- 2. BEARINGS ARE NEW MEXICO STATE PLANE GRID BEARINGS, CENTRAL ZONE, NAD 1927, AND ARE BASED ON ACS CONTROL MONUMENTS NM47-10 AND NM47-13, AS SHOWN HEREON
- 3. DISTANCES ARE GROUND DISTANCES.
- 4. PLAT SHOWS ALL EASEMENTS OF RECORD.
- 5. GROSS AREA: 4.3249 ACRES
- 7. NUMBER OF EXISTING TRACTS: 2
- 8. NUMBER OF TRACTS CREATED: 1
- 9. PROPERTY IS ZONED SU-1.

LEGAL DESCRIPTION

Tracts lettered H-1 and K-1 plat of Tracts E-1, M-1, and K-1 GATEWAY INDUSTRIAL PARK Town of Albuquerque Grant, City of Albuquerque, as the same is shown and designated on said plat thereof, filed in the Office of the County Clerk of Bernalillo County, New Mexico on October 17, 2005 in Book 2005C, page 345.

FREE CONSENT

THE UNDERSIGNED OWNER(S) AND PROPRIETOR(S) OF THE PROPERTY DESCRIBED HEREON DO HEREBY CONSENT TO THE PLATTING OF SAID PROPERTY AS SHOWN HEREON AND THE SAME IS WITH THE FREE CONSENT AND IN ACCORDANCE WITH THEIR DESIRES AND SAID OWNERS WARRANT THAT THEY HOLD COMPLETE AND INDEFEASIBLE TITLE IN FEE SIMPLE TO THE LAND SUBDIVIDED.

OWNER(S) SIGNATURE:	DATE: <u>6/11/0 7</u>
OWNER(S) PRINT NAME: ROBLE HENDRY	cson
	AM \$1107 TRACT:
ACKNOWLEDGMENT	OFFICIAL SEAL
STATE OF NEW MEXICO)	arab Arisato
).SS COUNTY OF BERNALILLO)	STATE 10/01/09
THIS INSTRUMENTOWAS ACKNOWLEDGED BEFORE	ME THIS THE DAY OF JUNE , 2007.
BY: 170BUN HENTREXSON	C + D
MY COMMISSION EXPIRES:	Sarah Cimate
10101119	NOTARY PUBLIC

EASEMENT NOTES

- (A) Existing 10' PUE per plat of July 5, 2000, Book 2000C, page 173.
- (B) Existing 10' Private Drainage Easement intended to benefit Tracts C through K. Each individual property owner shall be responsible for maintaining the portion of the Easement fronting Grantee's respective tract, Book 2000C, page173.
- (C) Existing Public Waterline and Sanitary Sewer Easement granted to the City of Albuquerque, Book 2000C, page 173.
- (D) Existing private access easement intended to benefit existing Tracts A through M, including Tract C. Each individual property owner shall be responsible for maintaining the portion of the easement fronting respective Tract, Book 2000C, page 173.
- (E) Private reciprocal access easement per plat filed October 17, 2005, Book 2005C, page 345, to benefit Tracts K-1, L and M. and is to be maintained by owner of Tract K-1.
- (F) Private reciprocal access easement per plat filed October 17, 2005, Book 2005C, page 345, to benefit Tracts H-1 and E-1, and is to be maintained by owner of Tract H-1 and Tract E-1.

A Reciprocal private cross-access easement exists across the original Tracts A through M and is to be maintained by said tract owners, Book 2000C, page 173.

PRELIMINARY PLAT APPROVED BY DRB

DISCLOSURE STATEMENT

ON_6/20/07 THE PURPOSE OF THIS PLAT IS TO COMBINE TWO (2) EXISTING TRACTS INTO ONE (1) NEW

PLAT OF TRACT H-1-A GATEWAY INDUSTRIAL PARK

TOWN OF ALBUQUERQUE GRANT
PROJECTED SECTIONS 8 & 9, T. 10 N., R. 3 E., N.M.P.M.
CITY OF ALBUQUERQUE
BERNALILLO COUNTY, NEW MEXICO

JUNE 2007

SHEET 1 OF 2

CITY APPROVALS: PROJECT NO.:	APPLICATION NO.
IL O Hat >	6-12-07
CITY SURVEYOR	DATE
TRAFFIC ENGINEERING	DATE
PARKS & RECREATION DEPARTMENT	DATE
WATER UTILITIES DEPARTMENT	DATE
A.M.A.F.C.A.	DATE
CITY ENGINEER	DATE
DRB CHAIRPERSON, PLANNING DEPARTMENT	DATE

SURVEYOR'S CERTIFICATION

I, Mitchell W. Reynolds, a duly qualified Registered Professional Land Surveyor under the laws of the State of New Mexico, do hereby certify that this plat and description were prepared by me or under my supervision, shows all easements as shown on the plat of record or made known to me by the owners and/or proprietors of the subdivision shown hereon, utility companies and other parties expressing an interest and meets the minimum requirements for monumentation and surveys of the Albuquerque Subdivision Ordinance, and further meets the Minimum Standards for Land Surveying in the State of New Mexico and is true and correct to the best of my knowledge and belief.

ew Mexico Professional Surveyor, 11224

06-11-07

SURVEYS SOUTHWEST LTD.

333 LOMAS BLVD., N.E. ALBUQUERQUE, NÉW MEXICO 87102


PHONE: (505) 998-0303 FAX: (505) 998-0306


T10N R3E SEC. 8 & 9

BERNALILLO COUNTY TREASURER'S OFFICE:

PROPERTY OWNER OF RECORD:

THIS IS TO CERTIFY THAT TAXES ARE CURRENT & PAID ON

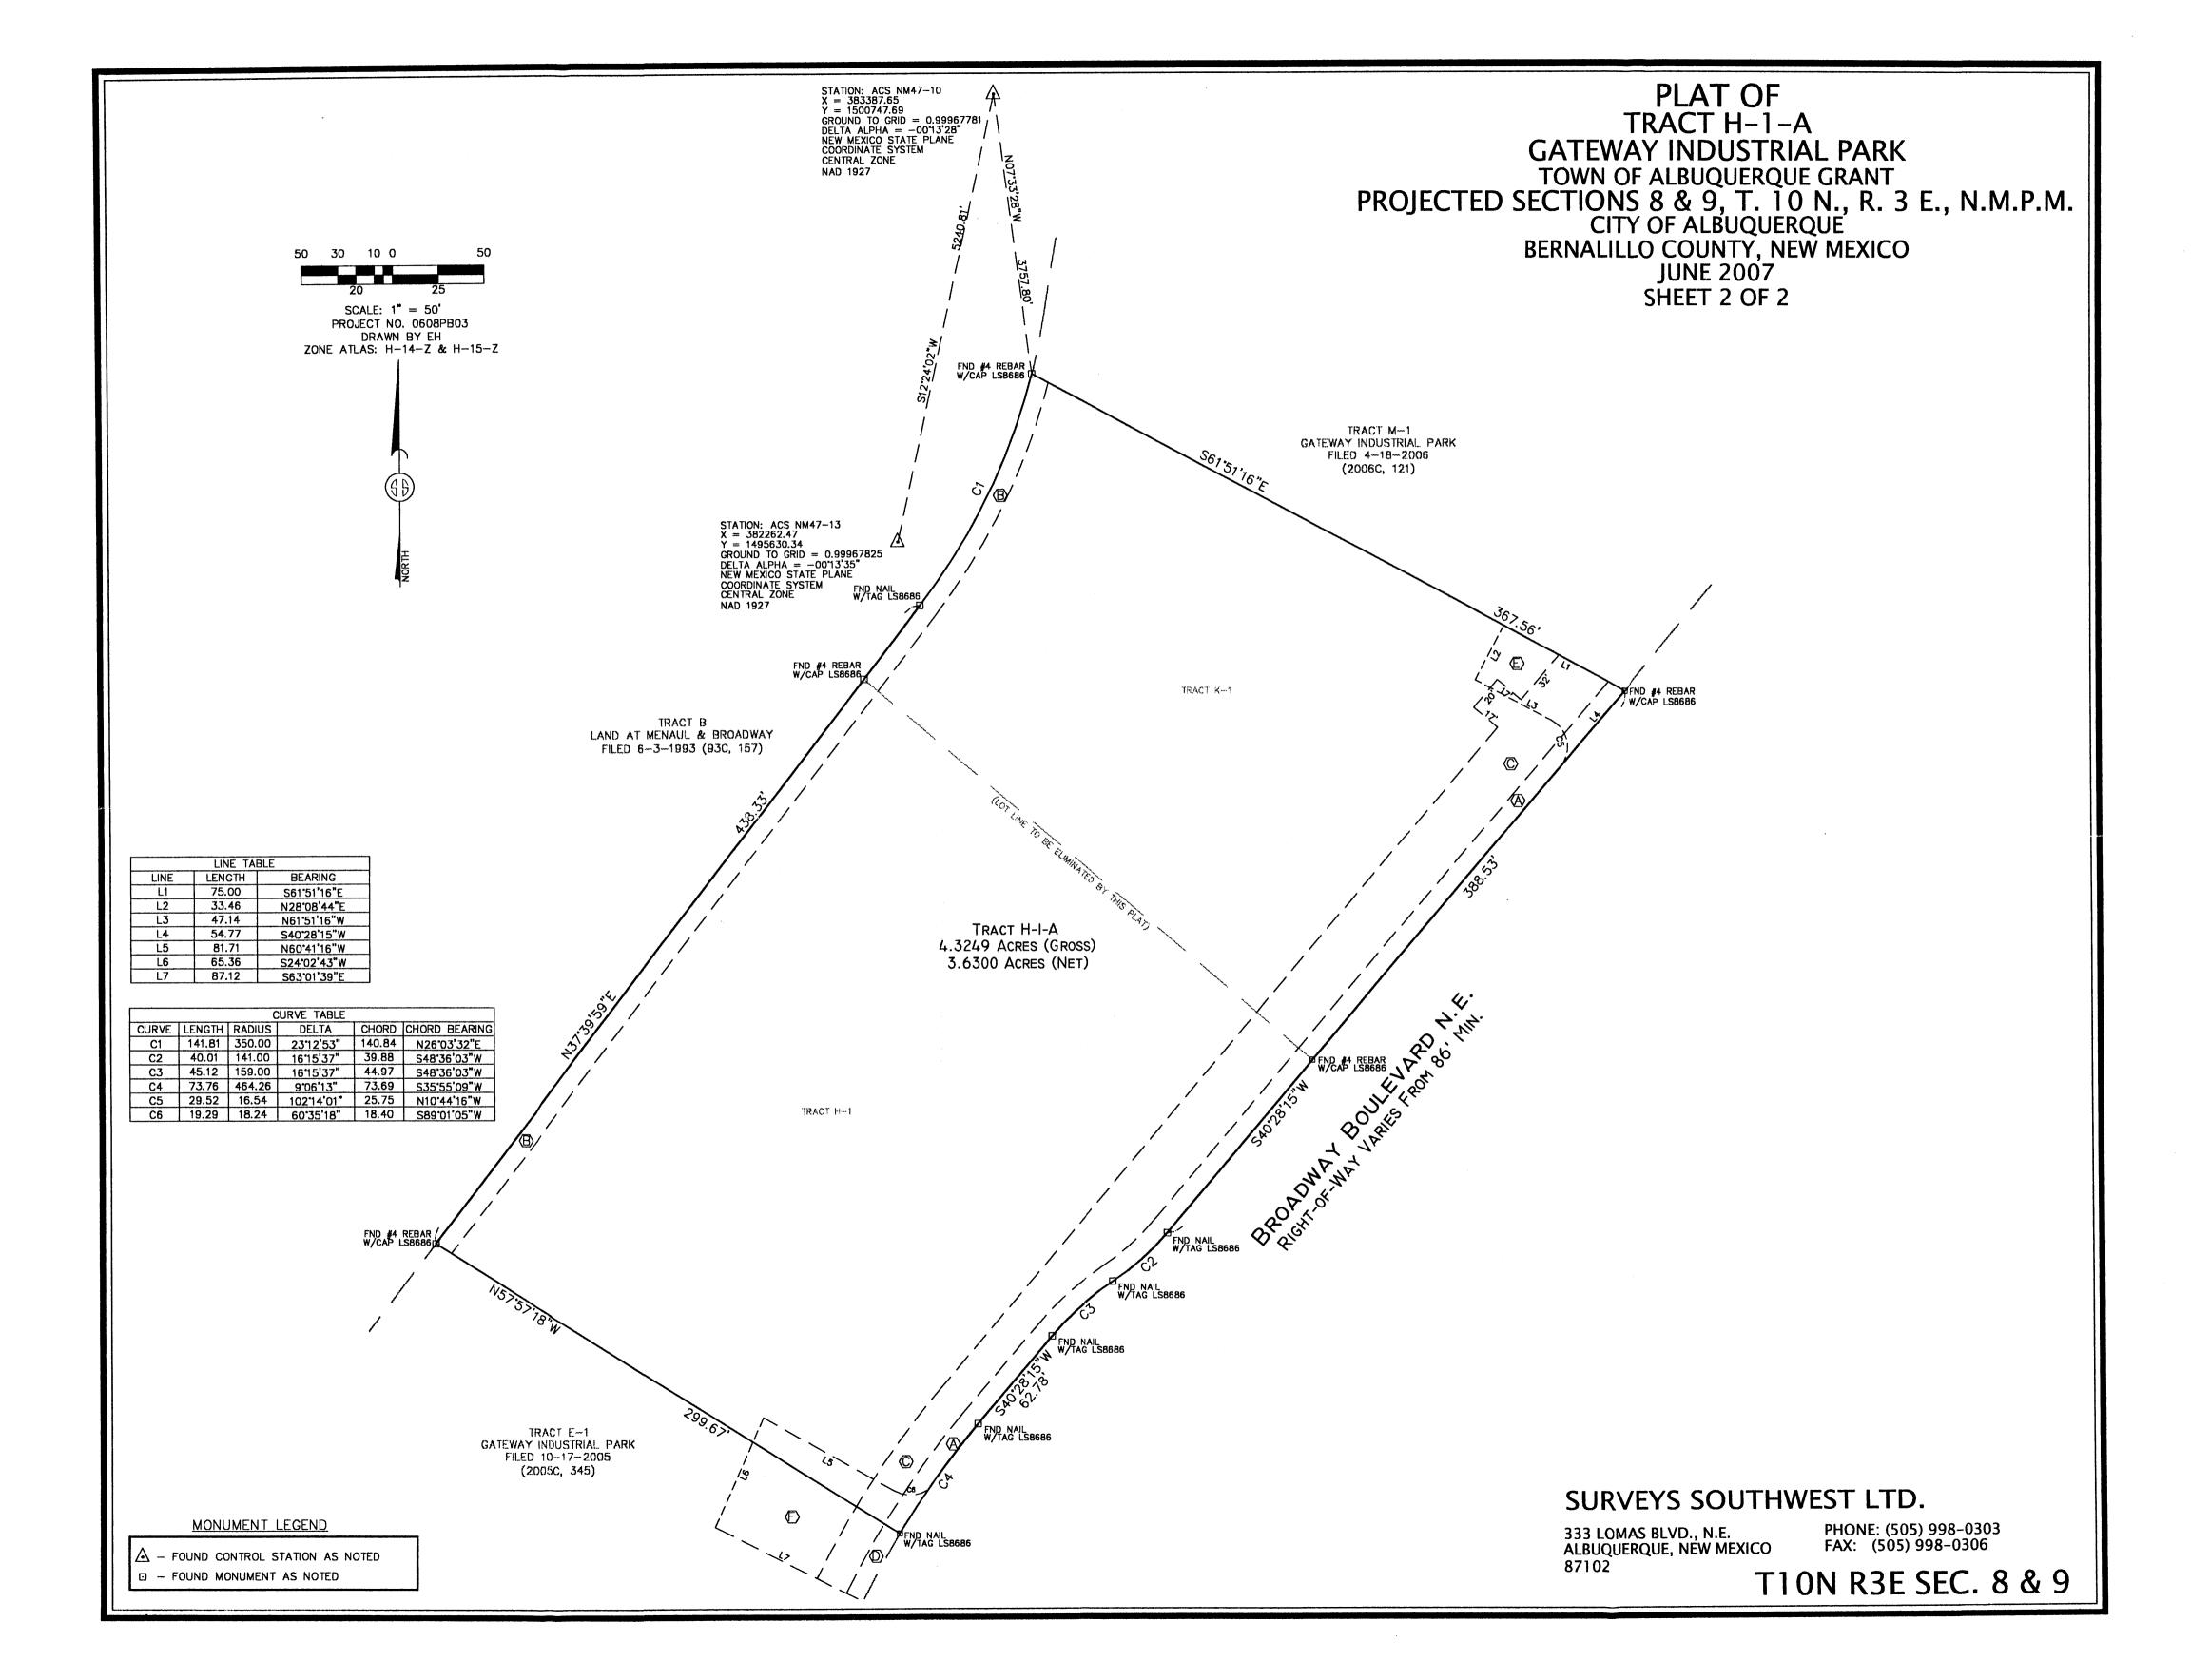

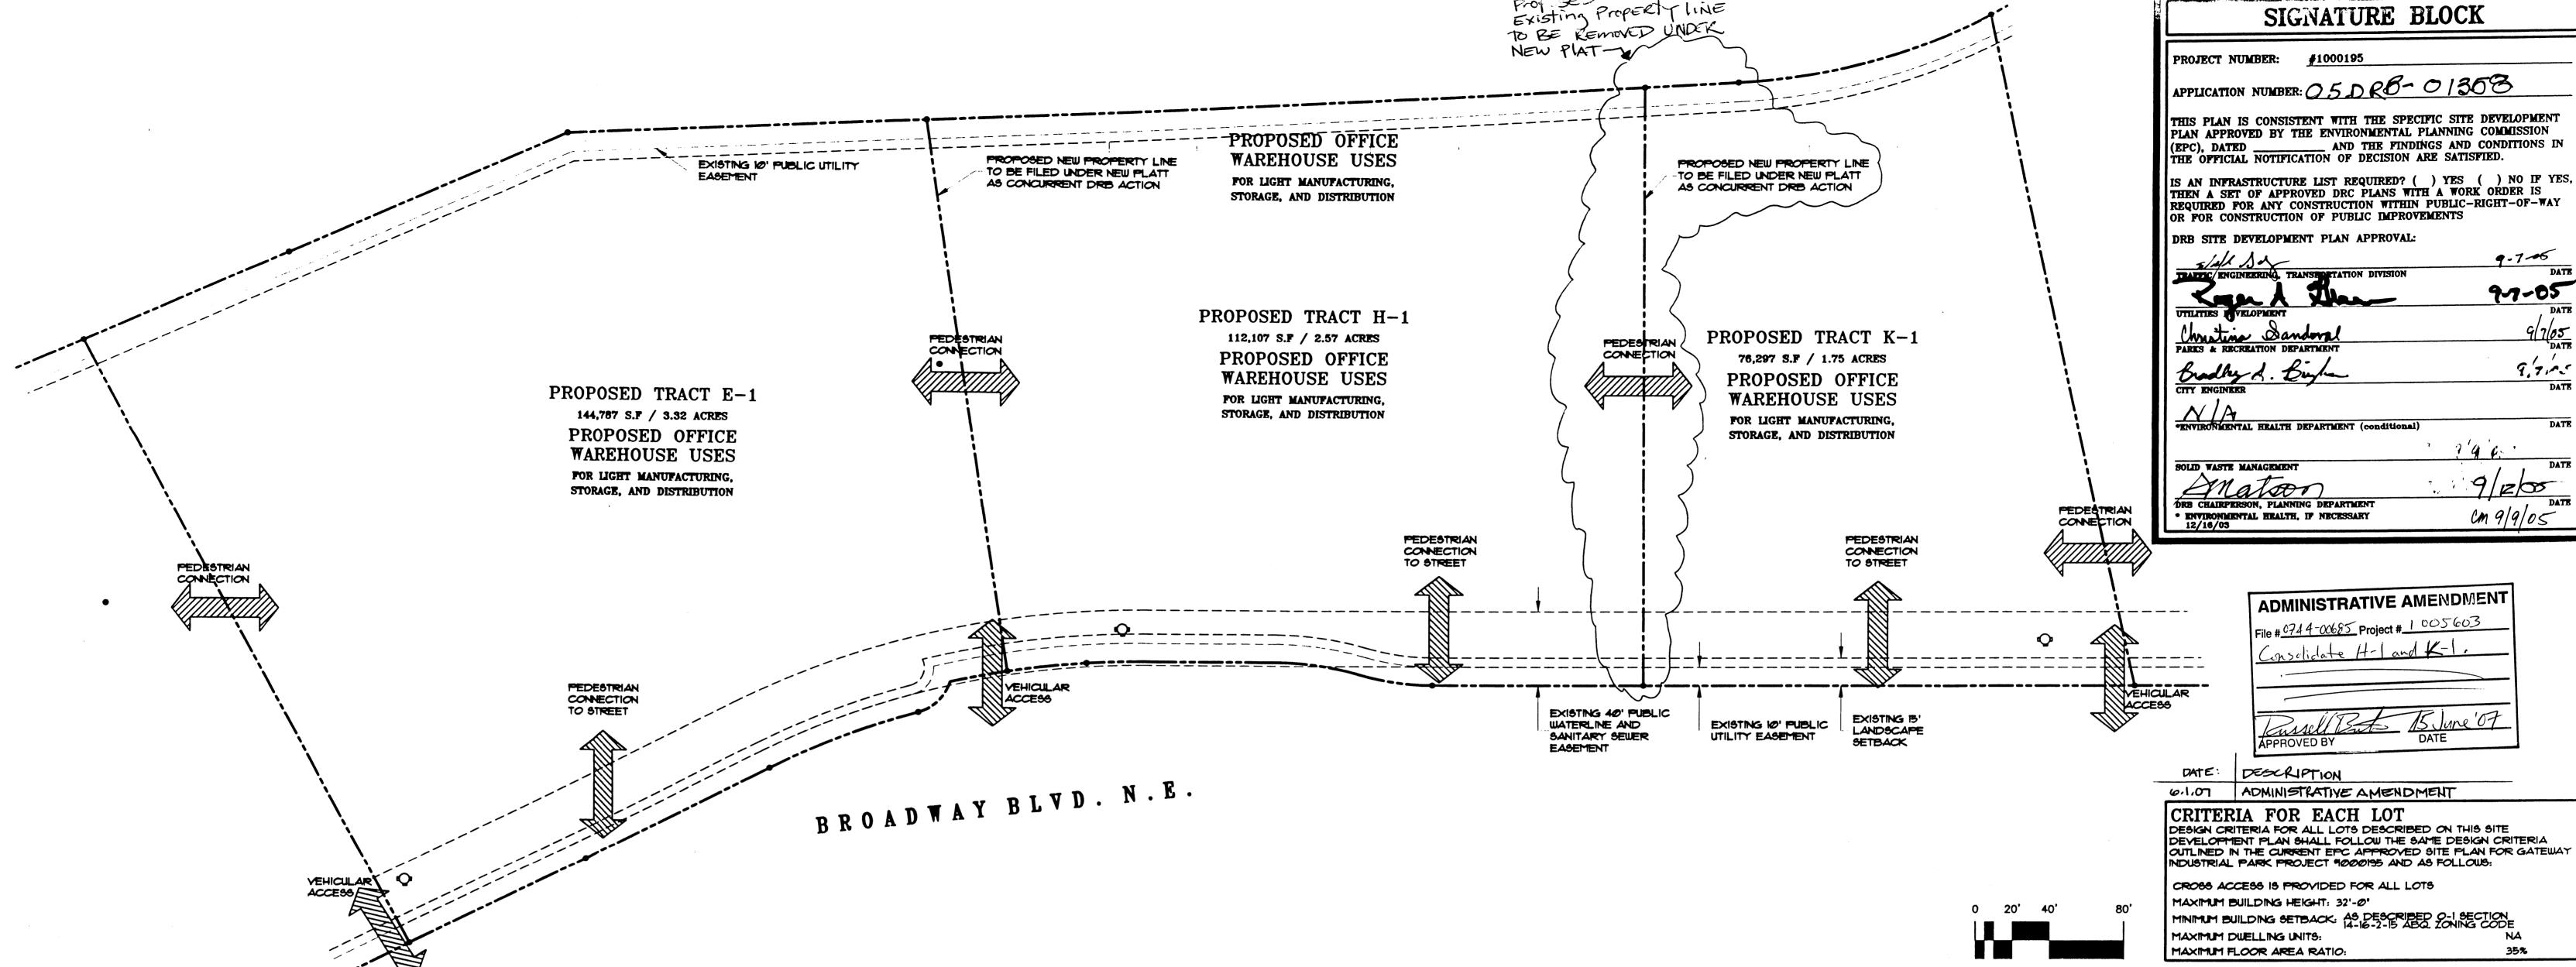

DESIGN GUIDELINES (IMPROVEMENTS ON EACH TRACT SHALL BE REQUIRED TO FOLLOW THESE GUIDELINES):

A MINIMUM OF 30' WIDTH CROSS ACCESS IS PROVIDED BETWEEN LOTS

PEDESTRIAN AND BICYCLE: EACH PREMISES SHALL INCORPORATE ADEQUATE PEDESTRIAN AND BICYCLE ACCESS PROVISIONS INTO ITS DESIGN IN ACCORDANCE WITH THE SIDEWALK ORDINANCE AND THE ZONING

A DIRECT PEDESTRIAN CONNECTION FROM EACH PREMISES TO THE STREET AND ADJACENT BUILDING SHALL BE PROVIDED.

PEDESTRIAN CROSSINGS AT DRIVES SHALL BE 6'-0" WIDE AND SHALL BE CONCRETE OR ANOTHER TEXTURED MATERIAL IN CONTRAST WITH ASPHALT.

ACCESS AND PARKING: EACH PREMISES SHALL PROVIDE ADEQUATE VEHICULAR ACCESS AND PARKING MEASURES IN ACCORDANCE WITH SECTION 14-16-3-1 OF THE ZONING ORDINANCE. A RECIPROCAL CROSS-LOT ACCESS AND PARKING EASEMENT OUTSIDE OF PROPOSED STRUCTURES SHALL BE GRANTED TO ALL LOTS SHOWN PARKING SHALL NOT EXCEED THE MINIMUM REQUIRED BY THE ZONING CODE PLUS 10%.

LANDSCAPING STANDARDS: ALL SITE PLAN FOR BUILDING PERMIT SUBMITTALS SHALL BE ACCOMPANIED BY A LANDSCAPE PLAN IN COMPLIANCE WITH CITY ORDINANCES. SHADE TREES SHALL BE PROVIDED AT WALKWAYS AND PARKING AREAS. TREES SHALL PROVIDE SHADE FOR WALKWAYS AND BUILDINGS WHERE FEASIBLE. PLANT SELECTION SHALL BE APPROPRIATE TO THE VALLEY.

GENERAL: UNIFORMITY OF DESIGN, MATERIALS, AND COLORS SHALL BE MAINTAINED THROUGHOUT THE SITE. THE SUBDIVISION ARCHITECTURE IS TO BE DEVELOPED AS HIGH QUALITY, ARTICULATED AND HARMONIOUS WITH FINISHED ELEVATIONS ON FOUR (4) SIDES OF EACH BUILDING DISPLAYING CONSISTENT MATERIALS AND SIGNAGE. IN GENERAL, ARCHITECTURE OF THE CENTER SHOULD RELATE TO ADJACENT BUILDINGS IN SCALE, COMPOSITION AND LANDSCAPE CONTINUITY. NO GENERIC FRANCHISE DESIGN ELEVATIONS ARE PERMITTED. ALL OUT BUILDINGS, CANOPIES AND STRUCTURES SHALL BE ARCHITECTURALLY INTEGRATED.

BUILDING MATERIALS: ROOFS: ROOFS SHALL BE FLAT OR PITCHED OF STANDING SEAM METAL! MAXIMUM PITCH PERCENTAGE: 50%, ROOF COLOR IF PITCHED IS TO BE SILVERIGREY, OR GREEN IN COLOR.

WALLS: WALLS ARE TO BE SPLIT FACE CONCRETE BLOCK, STUCCO, WROUGHT IRON, AND/OR TILT UP PANELS. NO METAL SIDING ON BUILDINGS AND NO CHAINLINK FENCING OR BARBED WIRE/CONCERTINA WIRE SHALL BE ALLOWEDNO PLASTIC OR BACK LIT FASCIA PANELS SHALL BE PERMITTED. A MAXIMUM 100' OF UNBROKEN LENGTH ON ANY FACADE OF A BUILDING SHALL BE OFFSET EVERY 100' WITH A 6' OFFSET. A B' SETBACK FOR SIDEWALK AND LANDSCAPING SHALL BE PROVIDED AT THE ENTY FACADE OF EVERY BUILDING WITH PORTALS, CANOPIES, OR TREES 25' ON CENTER IN 5' X 5' PLANTERS FOR THE ENTIRE LENGTH OF

GLASS: GLASS IS TO BE NON-REFLECTIVE OR SEMI-REFLECTIVE BLUE/GREEN, BLUE OR GREEN IN COLOR. GLASS FRAMES MAY BE WHITE OR COLORED ACCENT COLORS AS APPROVED BY ARCHITECT. TRIM: BUILDING TRIM SHALL BE WOOD OR METAL.

AUNINGS: AUNINGS, IF USED MUST BE OF DARK (10% OR MORE) SOLID COLOR WITH A MAXIMUM OF 20% SIGNAGE AREA. FULLY ILLUMINATED AUNINGS ARE NOT ALLOWED, ONLY SIGNAGE MAY BE BACKLIT. NO VINTL OR PLASTIC COLORED AWNINGS SHALL BE ALLOWED. AWNING COLORS SHALL COORDINATE WITH BUILDING COLORS.

SCREENING: ROOFTOP MECHANICAL UNITS MUST BE BELOW PARAPET HEIGHT OR CONCEALED WITH A SCREEN OF SOUND MATERIALS AS DEFINED IN "WALLS" OF THIS GUIDELINE.

HEIGHT: BUILDING HEIGHT IS LIMITED TO 32 FEET! BUT NO BUILDING MAY EXCEED OVER 60% OF 2ND FLOOR TO IST FLOOR RATIO. TELECOMMUNICATIONS ANTENNA SHALL BE CONCEALED AND ARCHITECTURALLY INTEGRATEDWITH THE BUILLIDNG DESIGN OR LIGHT STANDARD. ANTENNA SHALL NOT EXCEED 32 FEET IN HEIGHT. POLE MOUNTED LIGHTING IS NOT TO EXCEED 16' WITH OUT OFF SHIELDING INSTALLED TO PREVENT FUGITIVE LIGHT.


SETBACKS: ALL BUILDING SETBACKS SHALL BE IN ACCORDANCE WITH THE CITY OF ALBUQUERQUE ZONING CODE AS PROVIDED IN THE O-1 ZONE.


WALLS: ALL SOLID WALLS SHALL BE INTEGRATED WITH GENERAL BUILDING APPEARANCE, WALL DESIGN SHALL FOLLOW THE ADOPTED CITY OF ALBUQUERQUE WALL DESIGN GUIDELINES.

SIGNAGE: BUILDING SIGNAGE MAY BE OF AUNING, INTERNALLY LIT CHANNEL LETTERS, NEON, OR FIXED METAL LETTERS. FASCIA SIGNAGE MAY NOT EXCEED 10% OF BACKGROUND FASCIA ELEMENTS. MONUMENT SIGNS MAY BE USED WITH A MAXIMUM 12' HEIGHT. FREE STANDING POLE SIGNS ARE NOT PERMITTED. BUILDING SIGNAGE SHALL NOT EXCEED 6% OF THE FACADE IT IS LOCATED ON. NO OFF PREMISES SIGNS SHALL BE PERMITTED. BACK LIT LOGIO SIGNAGE IS PERMITTED. THE MAXIMUM LETTER SIZE OF SIGNAGE SHALL BE TWO FEET AND THE MAXIMUM LOGIO SIZE SHALL BE 2'X2'.

LIGHTING: GENERAL LIGHTING SHALL BE POLE MOUNTED NOT TO EXCEED 16' IN HEIGHT WITH CUTOFF SHIELDING TO PREVENT PUGITIVE LIGHT. CANOPY LIGHTING SHALL HAVE SHIELDING TO PREVENT PUGITIVE LIGHT. CANOPIES: ALL OUT BUILDINGS SHALL BE ARCHITECTURALLY INTEGRATED WITH MAIN BUILDINGS, LOADING DOCKS SHALL HAVE CANOPIES AND SCREEEN WALLS THAT ARE COMPATIBLE IN MATERIAL, COLOR, AND DESIGN WITH THE RELATED BUILDING.

LOADING DOCKS: SHALL HAVE CANOPIES TO MATCH ROOF AND SCREEN WALLS.

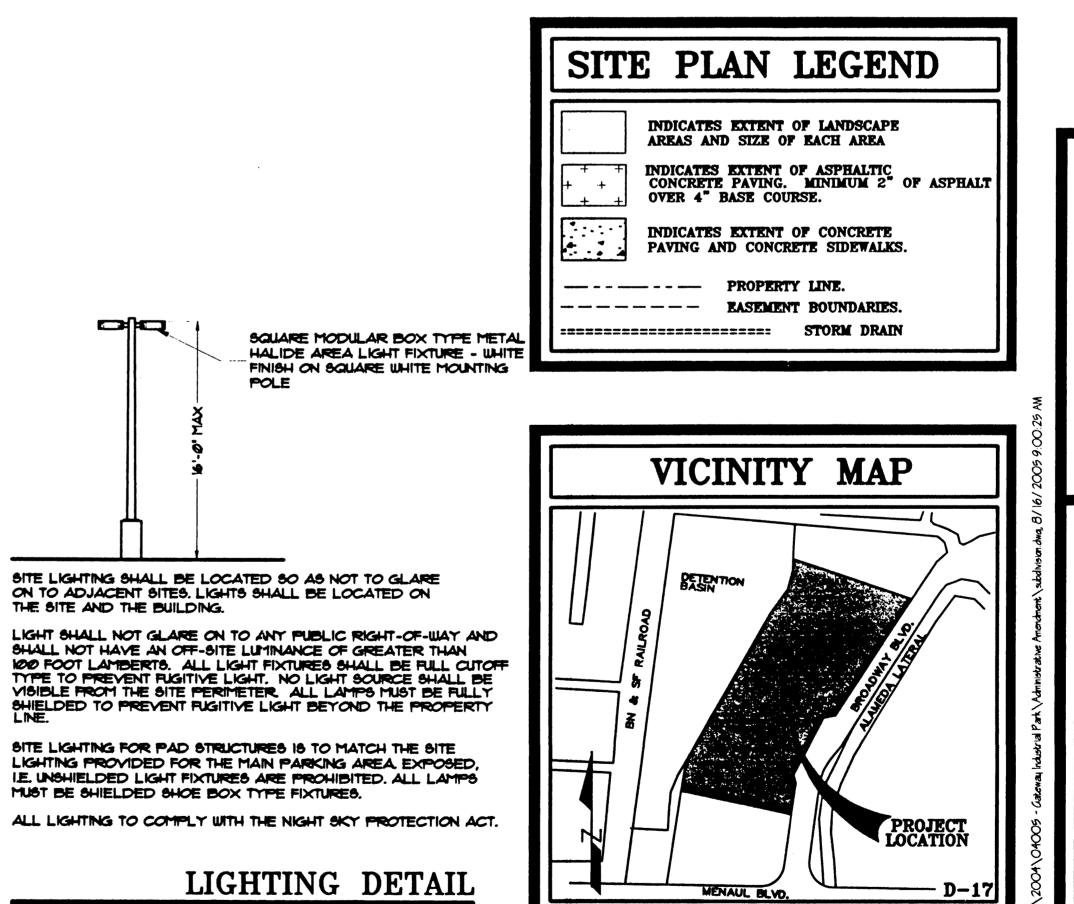

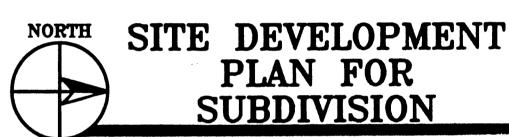

AUGUST 23, 2005

SCALE: 1" = 40'

SCALE: 1'' = 40'-0'' (U.N.O)

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9-7-05


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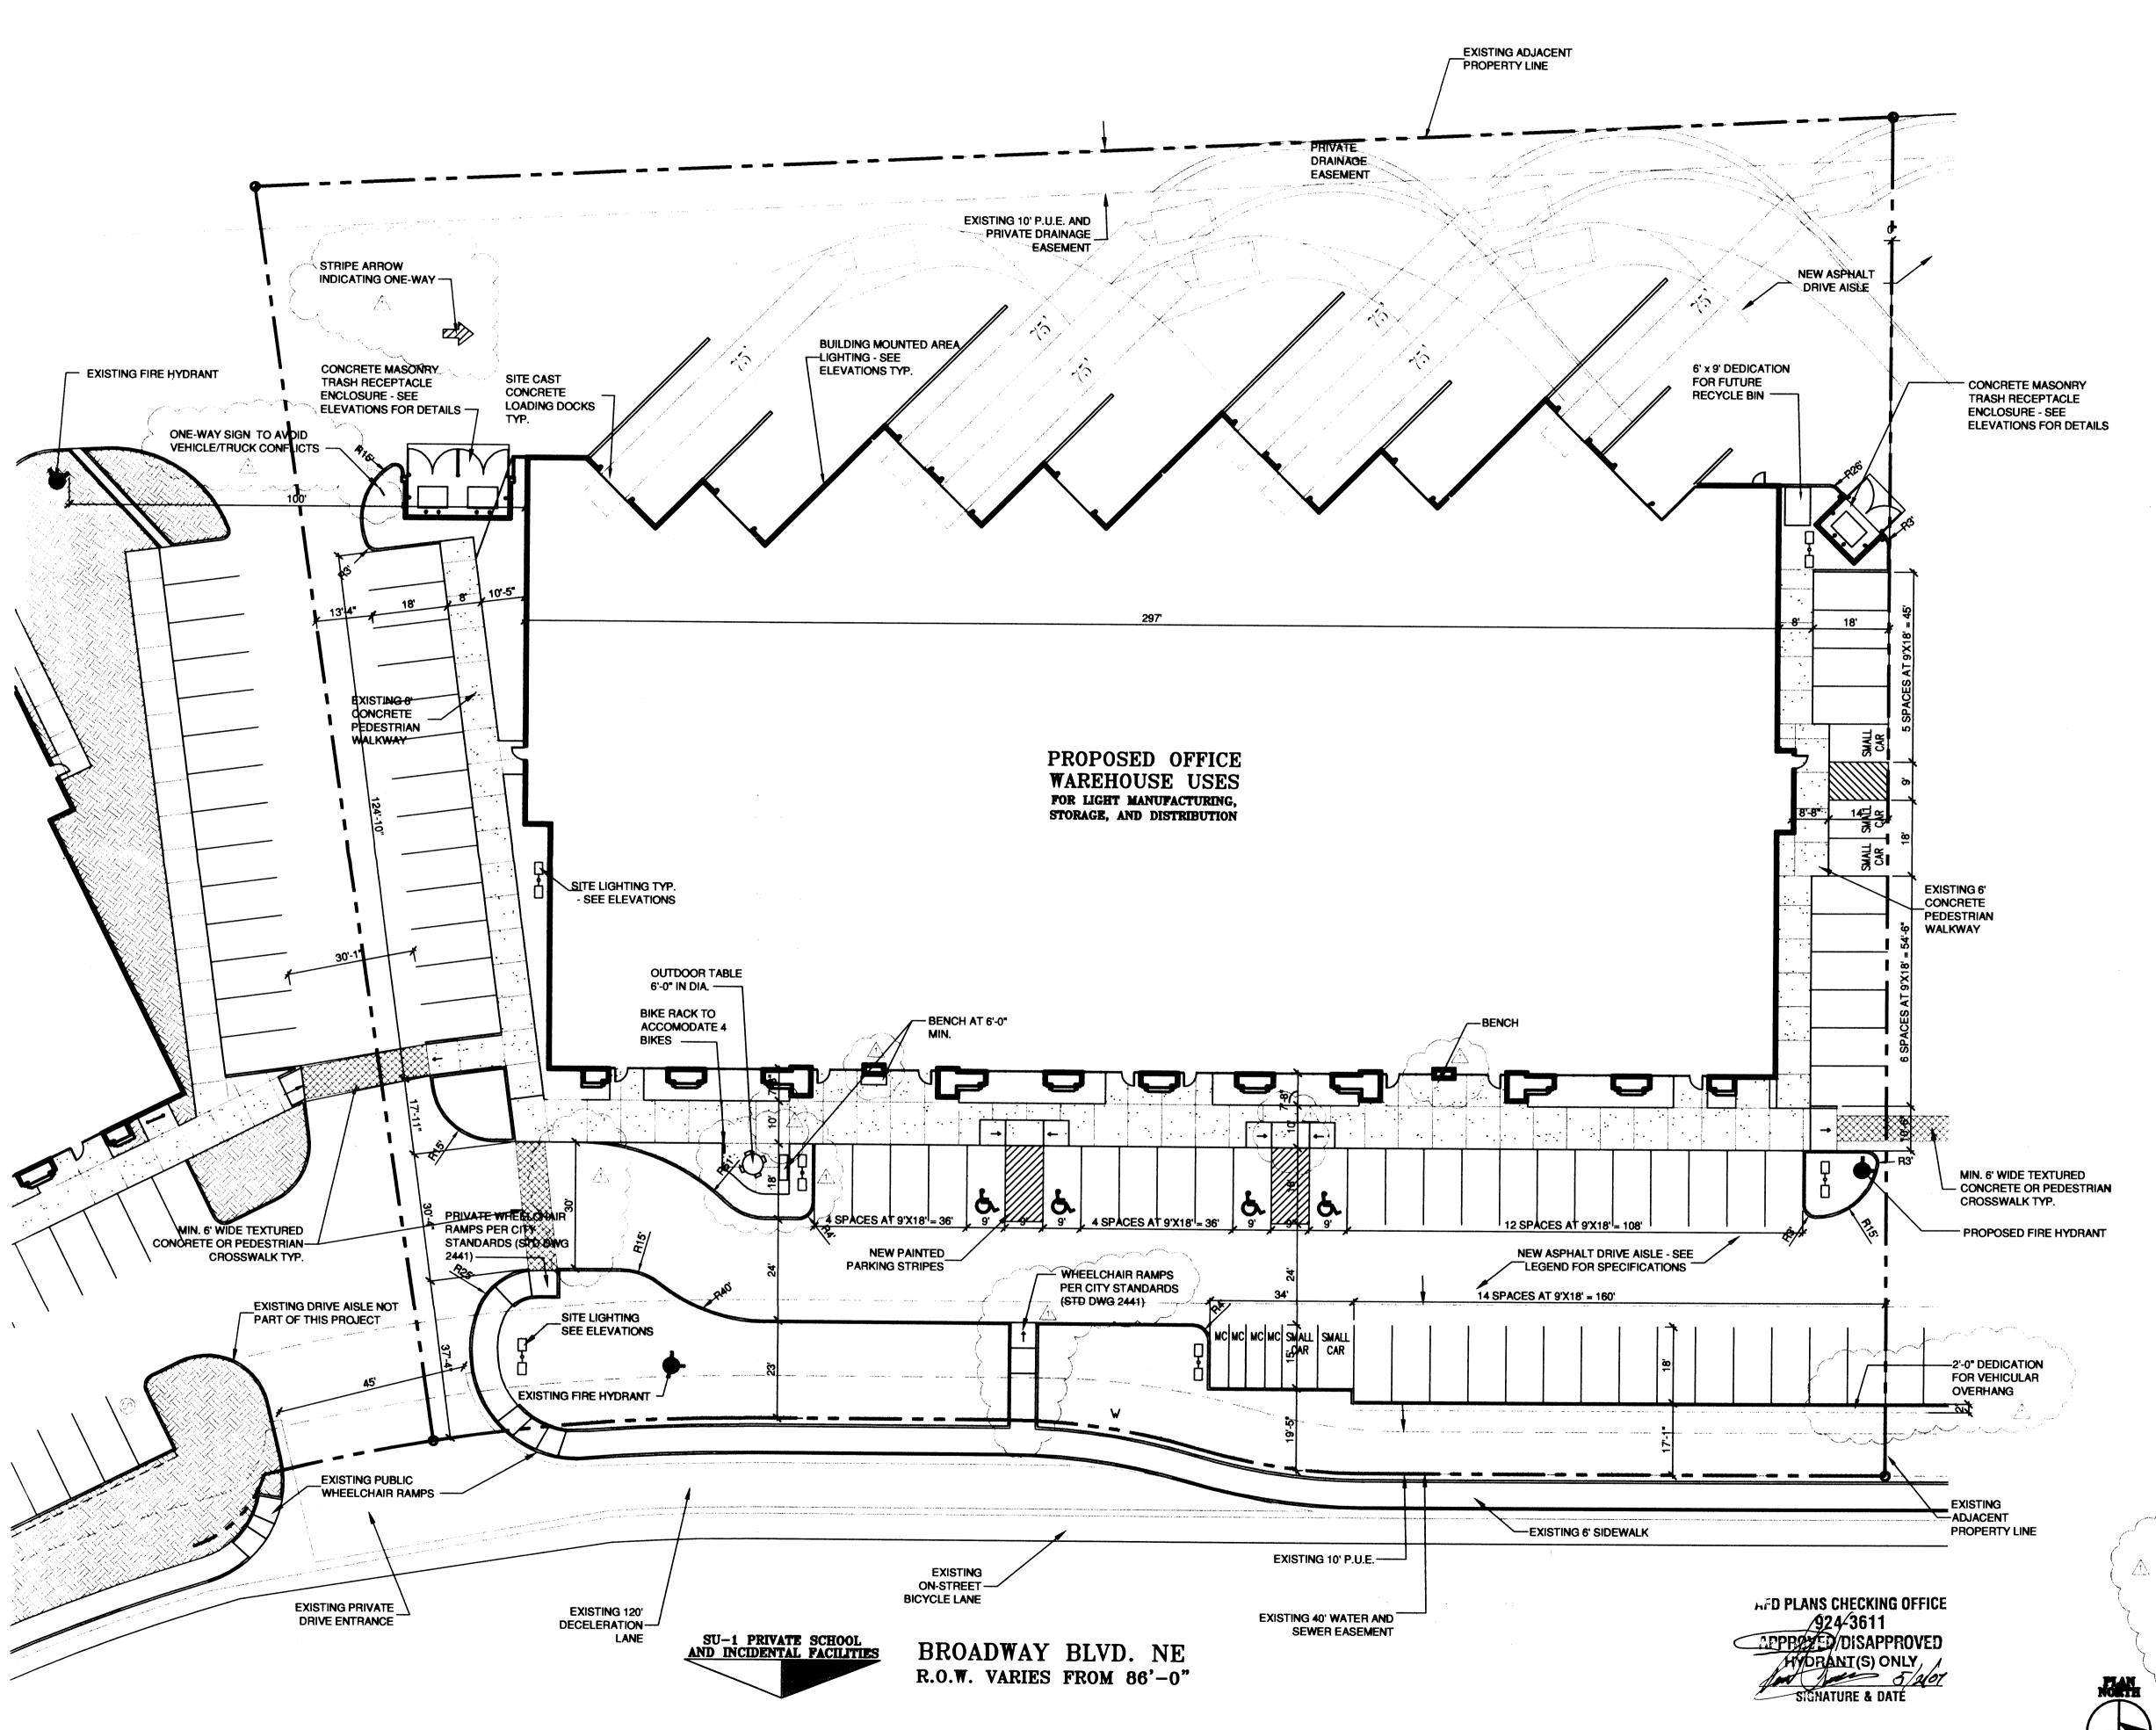
GATEWAY


INDUSTRIAL PARK 2701 BROADWAY BLVD. N.E. ALBUQUERQUE, NEW MEXICO




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1801 Rio Grande NW, Albuquerque, NM 87104 Phone: 505/842-1113 Fax: 505/842-1330



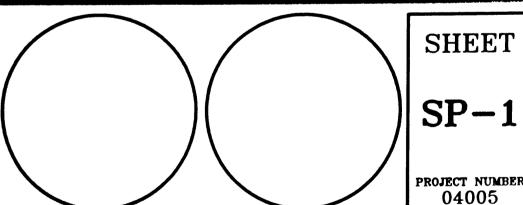

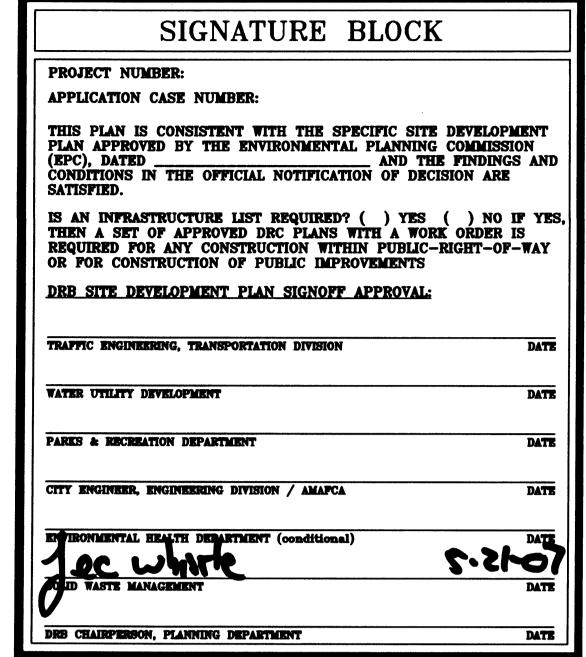

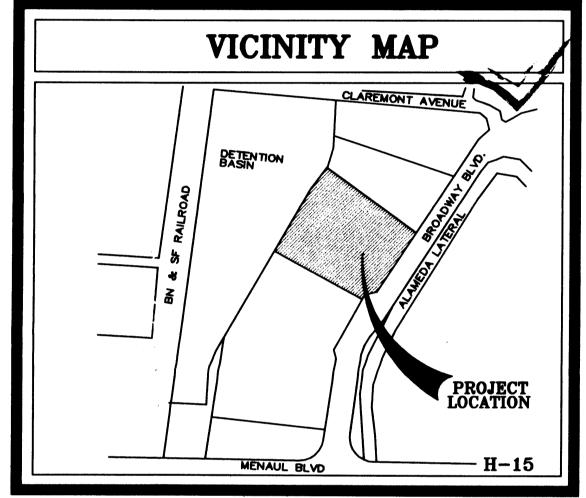PROJECT INFORMATION

PROJECT: GATEWAY II INDUSTRIAL PARK
OWNER:

MECH-CON INVESTMENTS
216 CLAREMONT NW
ALBUQUERQUE, NM 87107

ARCHITECT: CLAUDIO VIGIL ARCHITECTS
1801 RIO GRANDE BLVD. NW
ALBUQUERQUE NM, 87104

LEGAL DESCRIPTION: TRACT H-1
LAND AT BROADWAY AND MENAUL
ZONING ATLAS MAP: H-15
ZONING CLASSIFICATION: EXISTING: IP
PROPOSED: NO CHANGE
APPLICABLE BUILDING CODE: 2005 IBC

BUILDING TYPE: OFFICE/WAREHOUSE
CONSTRUCTION TYPE: TYPE IIB 100% SPRINKLED

OCCUPANCY GROUP: GROUP B, AND S-2
NUMBER OF FLOORS: ONE
GROSS SQUARE FOOTAGE: 31,581.75 WAREHOUSE (75%)
10,527.25 OFFICE (25%)

ALLOWABLE AREA:
GROUP S-2 TYPE II-B = 26,000 SQ. FT. + 300% SPRINKLER INCREASE = 104,000 SQ. FT.

42,109 TOTAL SQ. FT.

TOTAL PARKING/PAVED AREA:

OCCUPANT LOAD: OFFICE AREA: 10,527.25/100 = 105.27 OCCUPANTS
WAREHOUSE AREA: 31,581.75/500 = 63.16 OCCUPANTS

EXIT WIDTH REQUIRED: 169 x .2 = 33.8" = 3'-8"
EXIT WIDTH PROVIDED: 396"
NUMBER OF EXITS PROVIDED: ELEVEN
BUILDING HEIGHT ABOVE GRADE: 32'

PARKING ANALYSIS:

REQUIRED PARKING = 31,581.75 (WAREHOUSE)/2000 =15.79 =16 SPACES

REQUIRED PARKING = 10,527.25 (OFFICE) /200 =52.65 =53 SPACES

TOTAL PARKING REQUIRED = / 69 SPACES

TOTAL PARKING SPACES PROVIDED
57 REGULAR + 4 H.C. + 5 SMALL CAR +4 MOTORCYCLE= 70 PARKING SPACES
PARKING SPACES SIZES:

8'-0" x 15'-0"

REGULAR CAR PARKING SPACES = 9'-0" x 18'-0" WITH A 2'-0" OVERHANG

HANDICAP PARKING SPACE = 9'-0" x 18'-0" WITH A 2'-0" OVERHANG

COMPACT PARKING SPACE = BICYCLE SPACES:

SITE PLAN

REQUIRED PARKING - 70/20 = 3.5 BICYCLES (4 SPACES)

TOTAL BICYCLE SPACES PROVIDED = 4 BICYCLE SPACES



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CONSULTANTS

PROFESSIONAL SEAL

GATEWAY INDUSTRIAL PARK

BUILDING II

BROADWAY BLVD. NE ALBUQUERQUE, NEW MEXICO


Δ	5.14.07	EPC CONDITIONS
MARK	DATE	DESCRIPTION

PROJECT NUM	IBER: 06065
DRAWING FILE	}:
DRAWN BY:	JJF
CHECK BY:	-
COPYRIGHT:	CLAUDIO VIGIL ARCHITECTS 2006
DATE:	OCTOBER 30, 2006

PRELIMINARY
SITE PLAN
FOR BUILDING PERMIT

SHEET NUMBER
C-101

SCALE: 1" = 20'-0"

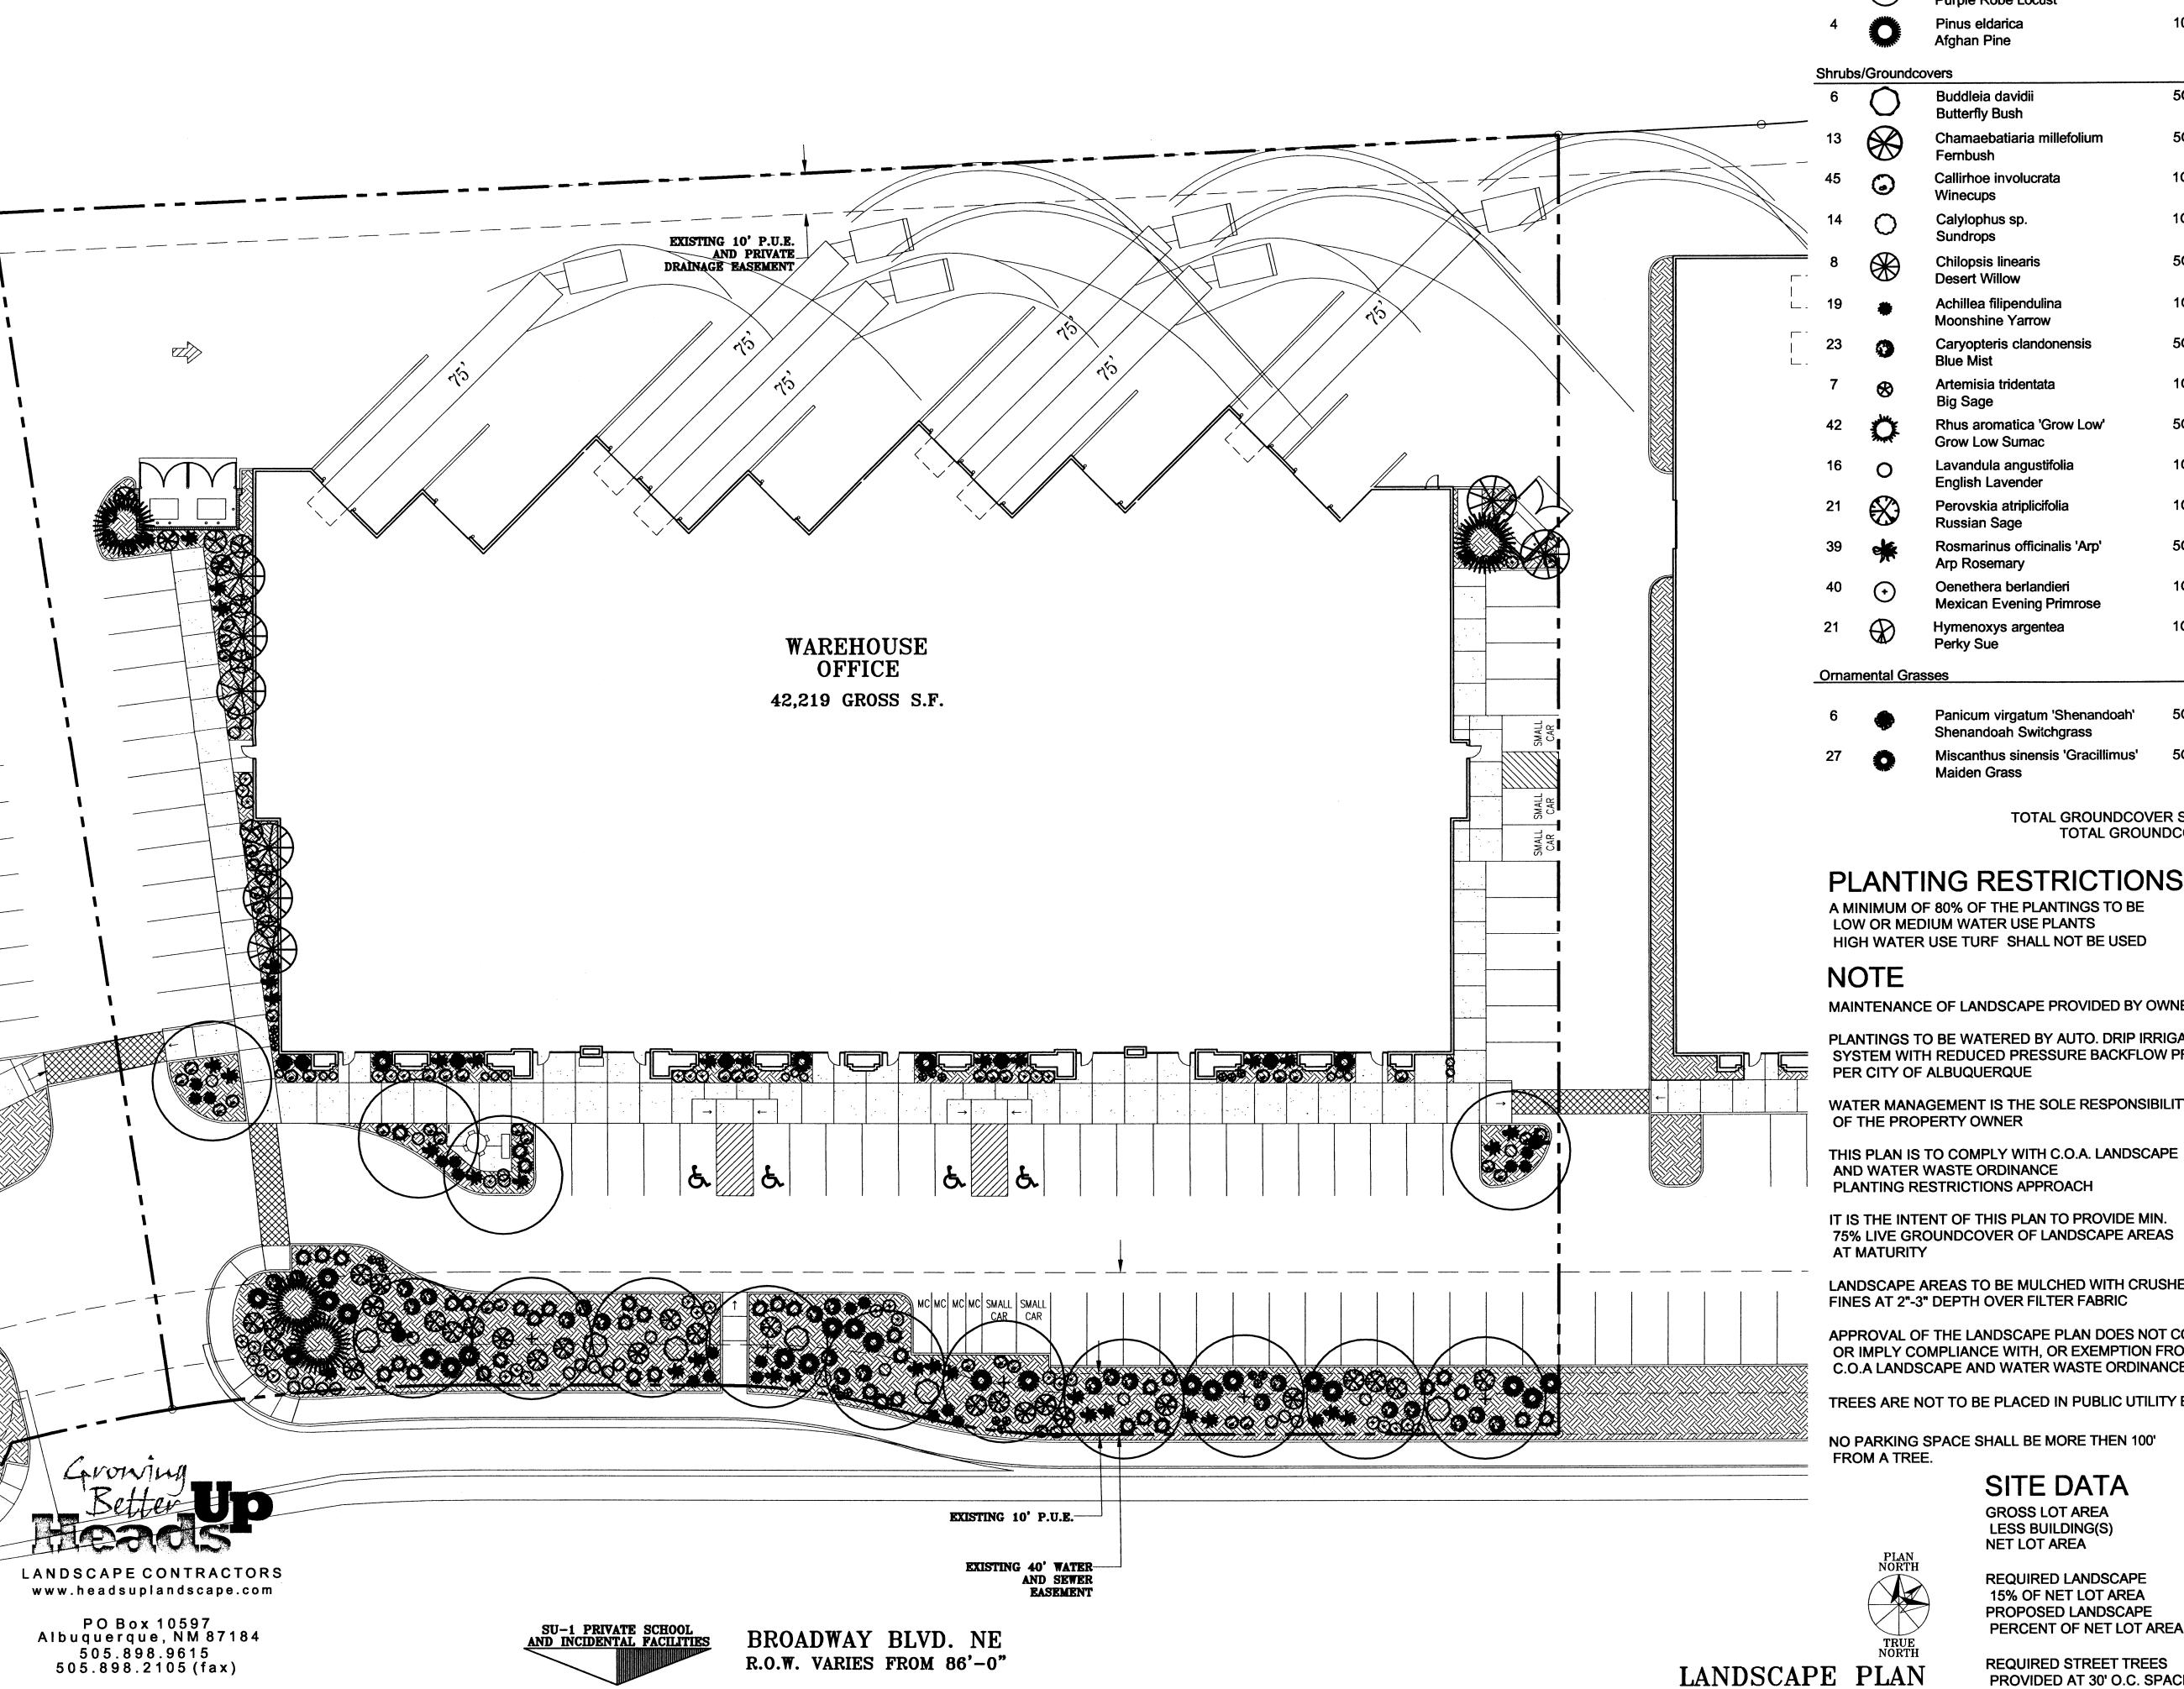

PLANT LEGEND

Qty.	Symbol	Scientific Name Common Name	Size	Water Use	Coverage
	Trees				
5	\odot	Pistacia chinensis Chinese Pistache	2"	Medium+	
9	\odot	Robinia ambigua 'Purple Robe' Purple Robe Locust	2"	Medium+	
4		Pinus eldarica Afghan Pine	10'	Medium	

Shrubs/Groundcovers

6	0	Buddleia davidii Butterfly Bush	5G	Medium	36SF X 6 = 216SF
13	\bigotimes	Chamaebatiaria millefolium Fernbush	5G	Low	25SF X 13= 325SF
45	0	Callirhoe involucrata Winecups	1G	Low+	8SF X 45 = 360SF
14	0	Calylophus sp. Sundrops	1G	Low	6SF X 14= 84SF
8	\Re	Chilopsis linearis Desert Willow	5G	Medium	50SF X 8 = 400SF
19	*	Achillea filipendulina Moonshine Yarrow	1G	Medium	8SF X 19= 152SF
23	0	Caryopteris clandonensis Blue Mist	5G	Medium	32SF X 23= 736SF
7	⊗	Artemisia tridentata Big Sage	1G	Low+	18SF X 7= 126SF
42		Rhus aromatica 'Grow Low' Grow Low Sumac	5G	Low +	50SF X 42= 2100SF
16	0	Lavandula angustifolia English Lavender	1G	Low	12SF X 16= 192SF
21	\bigotimes	Perovskia atriplicifolia Russian Sage	1G	Medium	25SF X 25 = 625SF
39	*	Rosmarinus officinalis 'Arp' Arp Rosemary	5G	Low +	30SF X 39 =1170SF
40	\odot	Oenethera berlandieri Mexican Evening Primrose	1G	Medium	25SF X 40= 1000SF
21		Hymenoxys argentea	1G	Low	2SF X 21= 42SF

TOTAL GROUNDCOVER SF REQ. 75% OF 10492SF= 7869SF TOTAL GROUNDCOVER SF PROVIDED 8323SF (80%)

Medium 20SF X 6= 120SF

Medium 25SF X 27= 675SF

PLANTING RESTRICTIONS APPROACH

A MINIMUM OF 80% OF THE PLANTINGS TO BE LOW OR MEDIUM WATER USE PLANTS HIGH WATER USE TURF SHALL NOT BE USED

MAINTENANCE OF LANDSCAPE PROVIDED BY OWNER

Panicum virgatum 'Shenandoah'

Miscanthus sinensis 'Gracillimus'

Shenandoah Switchgrass

PLANTINGS TO BE WATERED BY AUTO. DRIP IRRIGATION SYSTEM WITH REDUCED PRESSURE BACKFLOW PREVENTER PER CITY OF ALBUQUERQUE

WATER MANAGEMENT IS THE SOLE RESPONSIBILITY OF THE PROPERTY OWNER

AND WATER WASTE ORDINANCE PLANTING RESTRICTIONS APPROACH

IT IS THE INTENT OF THIS PLAN TO PROVIDE MIN. 75% LIVE GROUNDCOVER OF LANDSCAPE AREAS AT MATURITY

LANDSCAPE AREAS TO BE MULCHED WITH CRUSHER FINES AT 2"-3" DEPTH OVER FILTER FABRIC

APPROVAL OF THE LANDSCAPE PLAN DOES NOT CONSTITUTE OR IMPLY COMPLIANCE WITH, OR EXEMPTION FROM, THE C.O.A LANDSCAPE AND WATER WASTE ORDINANCE

TREES ARE NOT TO BE PLACED IN PUBLIC UTILITY EASEMENTS

NO PARKING SPACE SHALL BE MORE THEN 100' FROM A TREE.

SITE DATA

GROSS LOT AREA 42219 SF 69951 SF LESS BUILDING(S) NET LOT AREA

REQUIRED LANDSCAPE 15% OF NET LOT AREA PROPOSED LANDSCAPE 10544 PERCENT OF NET LOT AREA 16

REQUIRED STREET TREES

PROVIDED AT 30' O.C. SPACING ALONG STREET 12 **REQUIRED PARKING LOT TREES** PROVIDED AT 1 PER 10 SPACES (49 SPACES/10) 5



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CONSULTANTS



GATEWAY INDUSTRIAL PARK BUILDING II

BROADWAY BLVD. NE ALBUQUERQUE, NEW MEXICO

		·
MARK	DATE	DESCRIPTION

PROJECT NUME	BER: 06065
DRAWING FILE:	
DRAWN BY:	JJF
CHECK BY:	-
COPYRIGHT:	CLAUDIO VIGIL ARCHITECTS 2006
DATE:	OCTOBER 30, 2006

SHEET TITLE **PRELIMINARY** LANDSCAPE PLAN

> SHEET NUMBER L - 101

SCALE: 1" = 20'-0"



THE PROPOSED IMPROVEMENTS AS SHOWN BY THE VICINITY MAP, ARE LOCATED WEST OF BROADWAY BOULEVARD NORTH OF THE MENAUL BOULEVARD. THE SITE IS UNDEVELOPED AND SLOPES FROM EAST TO WEST AT AN APPROXIMATE SLOPE OF 1.5%. THE SITE DOES NOT LIE WITHIN A FLOOD HAZARD ZONE. THE SITE IS HIGHER THAN THE LANDS TO THE WEST. THE EXISTING STREET BLOCKS THE FLOWS FROM THE NORTH AND EAST THE LAND TO THE SOUTH SLOPE TO THE EXISTING ASPHALT DRAINAGE CHANNEL ALONG THE WEST PROPERTY LINE. THEREFORE OFFSITE FLOWS ARE CONSIDERED NEGLIGIBLE.

THE PROPOSED DEVELOPMENT LIE WITHIN GATEWAY INDUSTRIAL PARK TRACT H-1 (PREVIOUSLY TRACTS H & I) A CONCEPTUAL MASTER DRAINAGE PLAN FOR THIS SITE WAS PREPARED BY MARK GOODWIN & ASSOCIATES. THE MASTER DRAINAGE PLAN ESTABLISHED UNRESTRICTED DISCHARGE OF DEVELOPED FLOWS INTO THE ADJACENT THE CALCULATIONS ANALYZE THE EXISTING AND PROPOSED CONDITIONS FOR 6-HOUR, 100 YEAR RAINFALL EVENT. THE ANALYSIS IS IN ACCORDANCE WITH THE CITY OF ALBUQUERQUE DEVELOPMENT PROCESS MANUAL VOLUME II.

CALCULATIONS PRECIPITATION ZONE = 2

TOTAL SITE AREA = 2.575 ACRES EXISTING CONDITIONS

LAND TREATMENT A=100%

E = 0.53(1.00) = 0.53 INCHES V = 0.53(2.575) / 12 = 0.114 ACRE FEET

Q = 1.56(1.00) (2.275) = 4.0 CFS

DEVELOPED CONDITIONS

VICINITY MAP

PROJECT
GATEWAY INDUSTRIAL PARKS
BUILDING II

ADDRESS: xxxx BROADWAY BLVD., N.W. LEGAL DESCRIPTION:
TRACT H-1 GATEWAY INDUSTRIAL PARK




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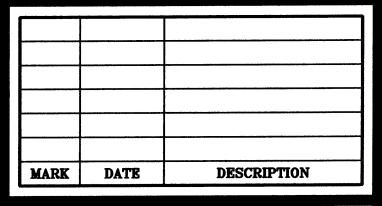
CONSULTANTS

PROFESSIONAL SEAL



GATEWAY INDUSTRIAL **PARK BUILDING II**

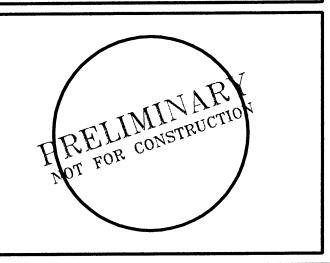BROADWAY BLVD. NE ALBUQUERQUE, NEW MEXICO





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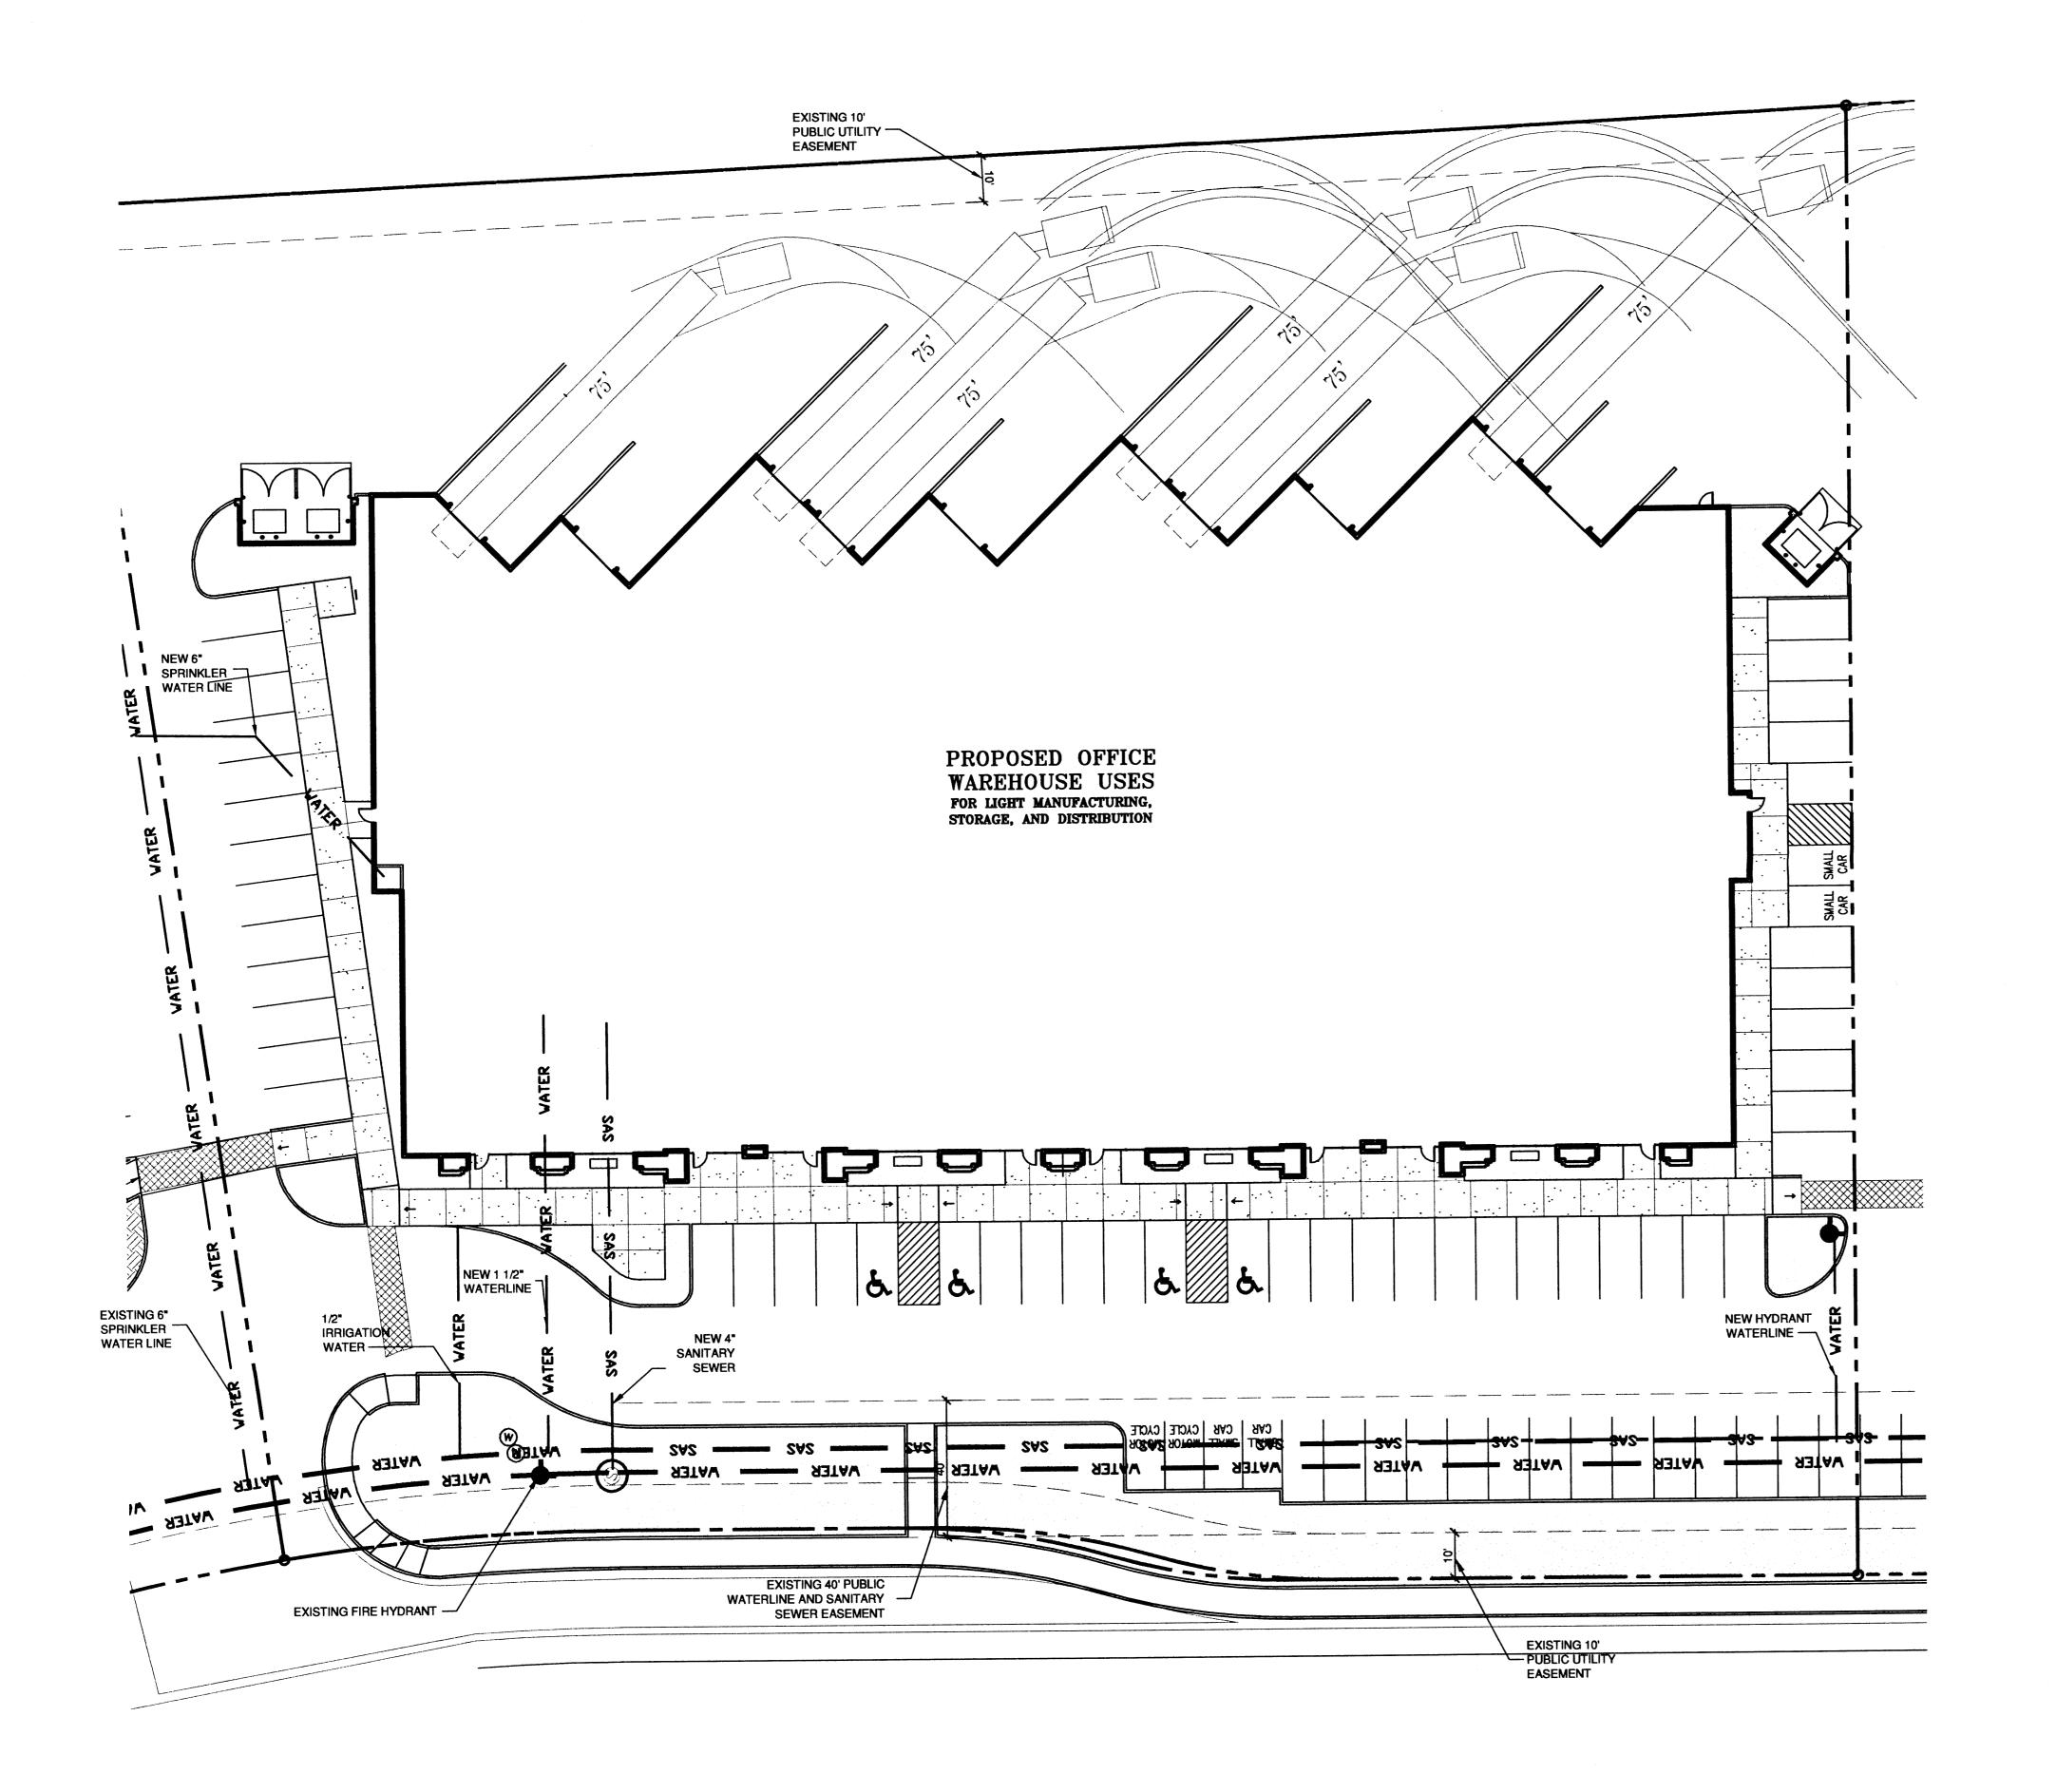
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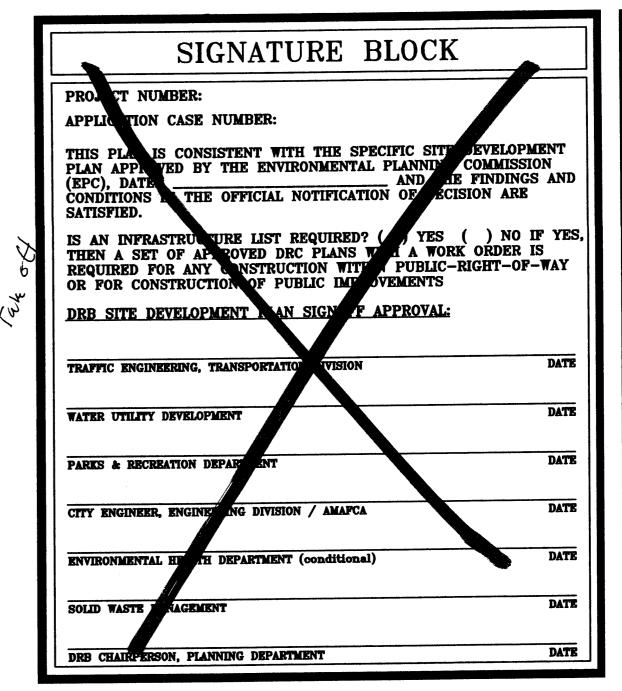
PRELIMINARY GRADING PLAN


C-102





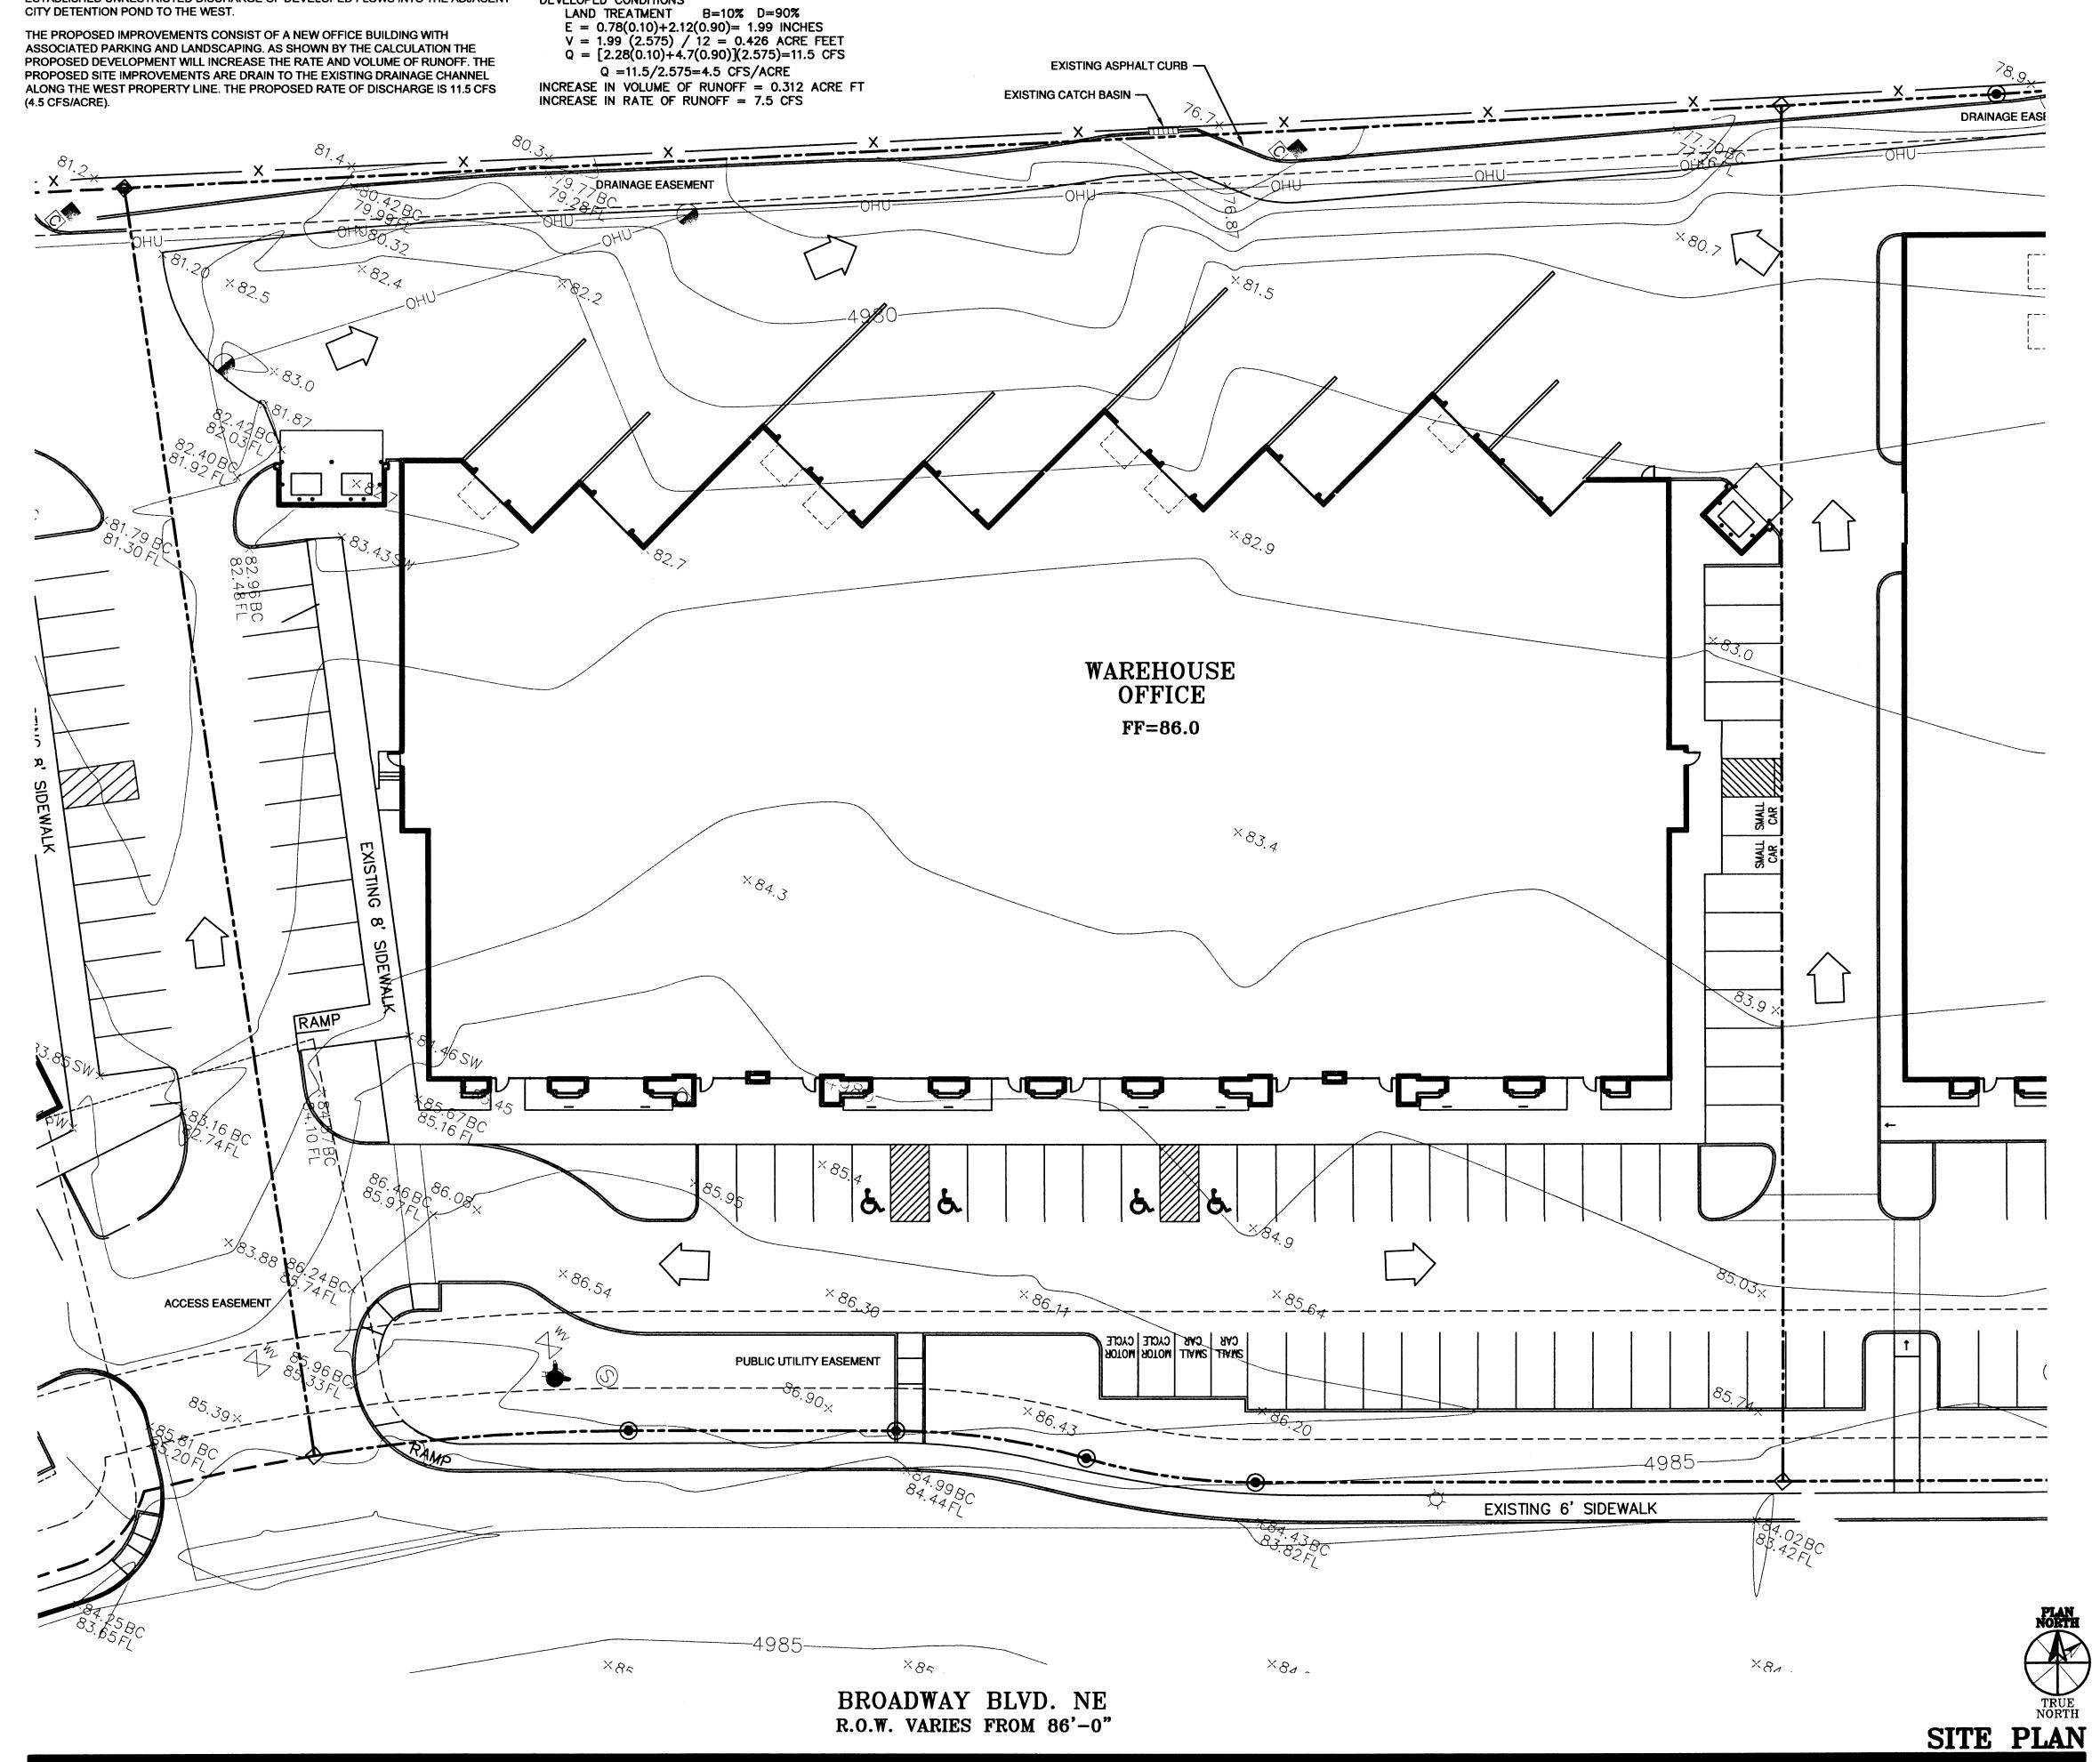

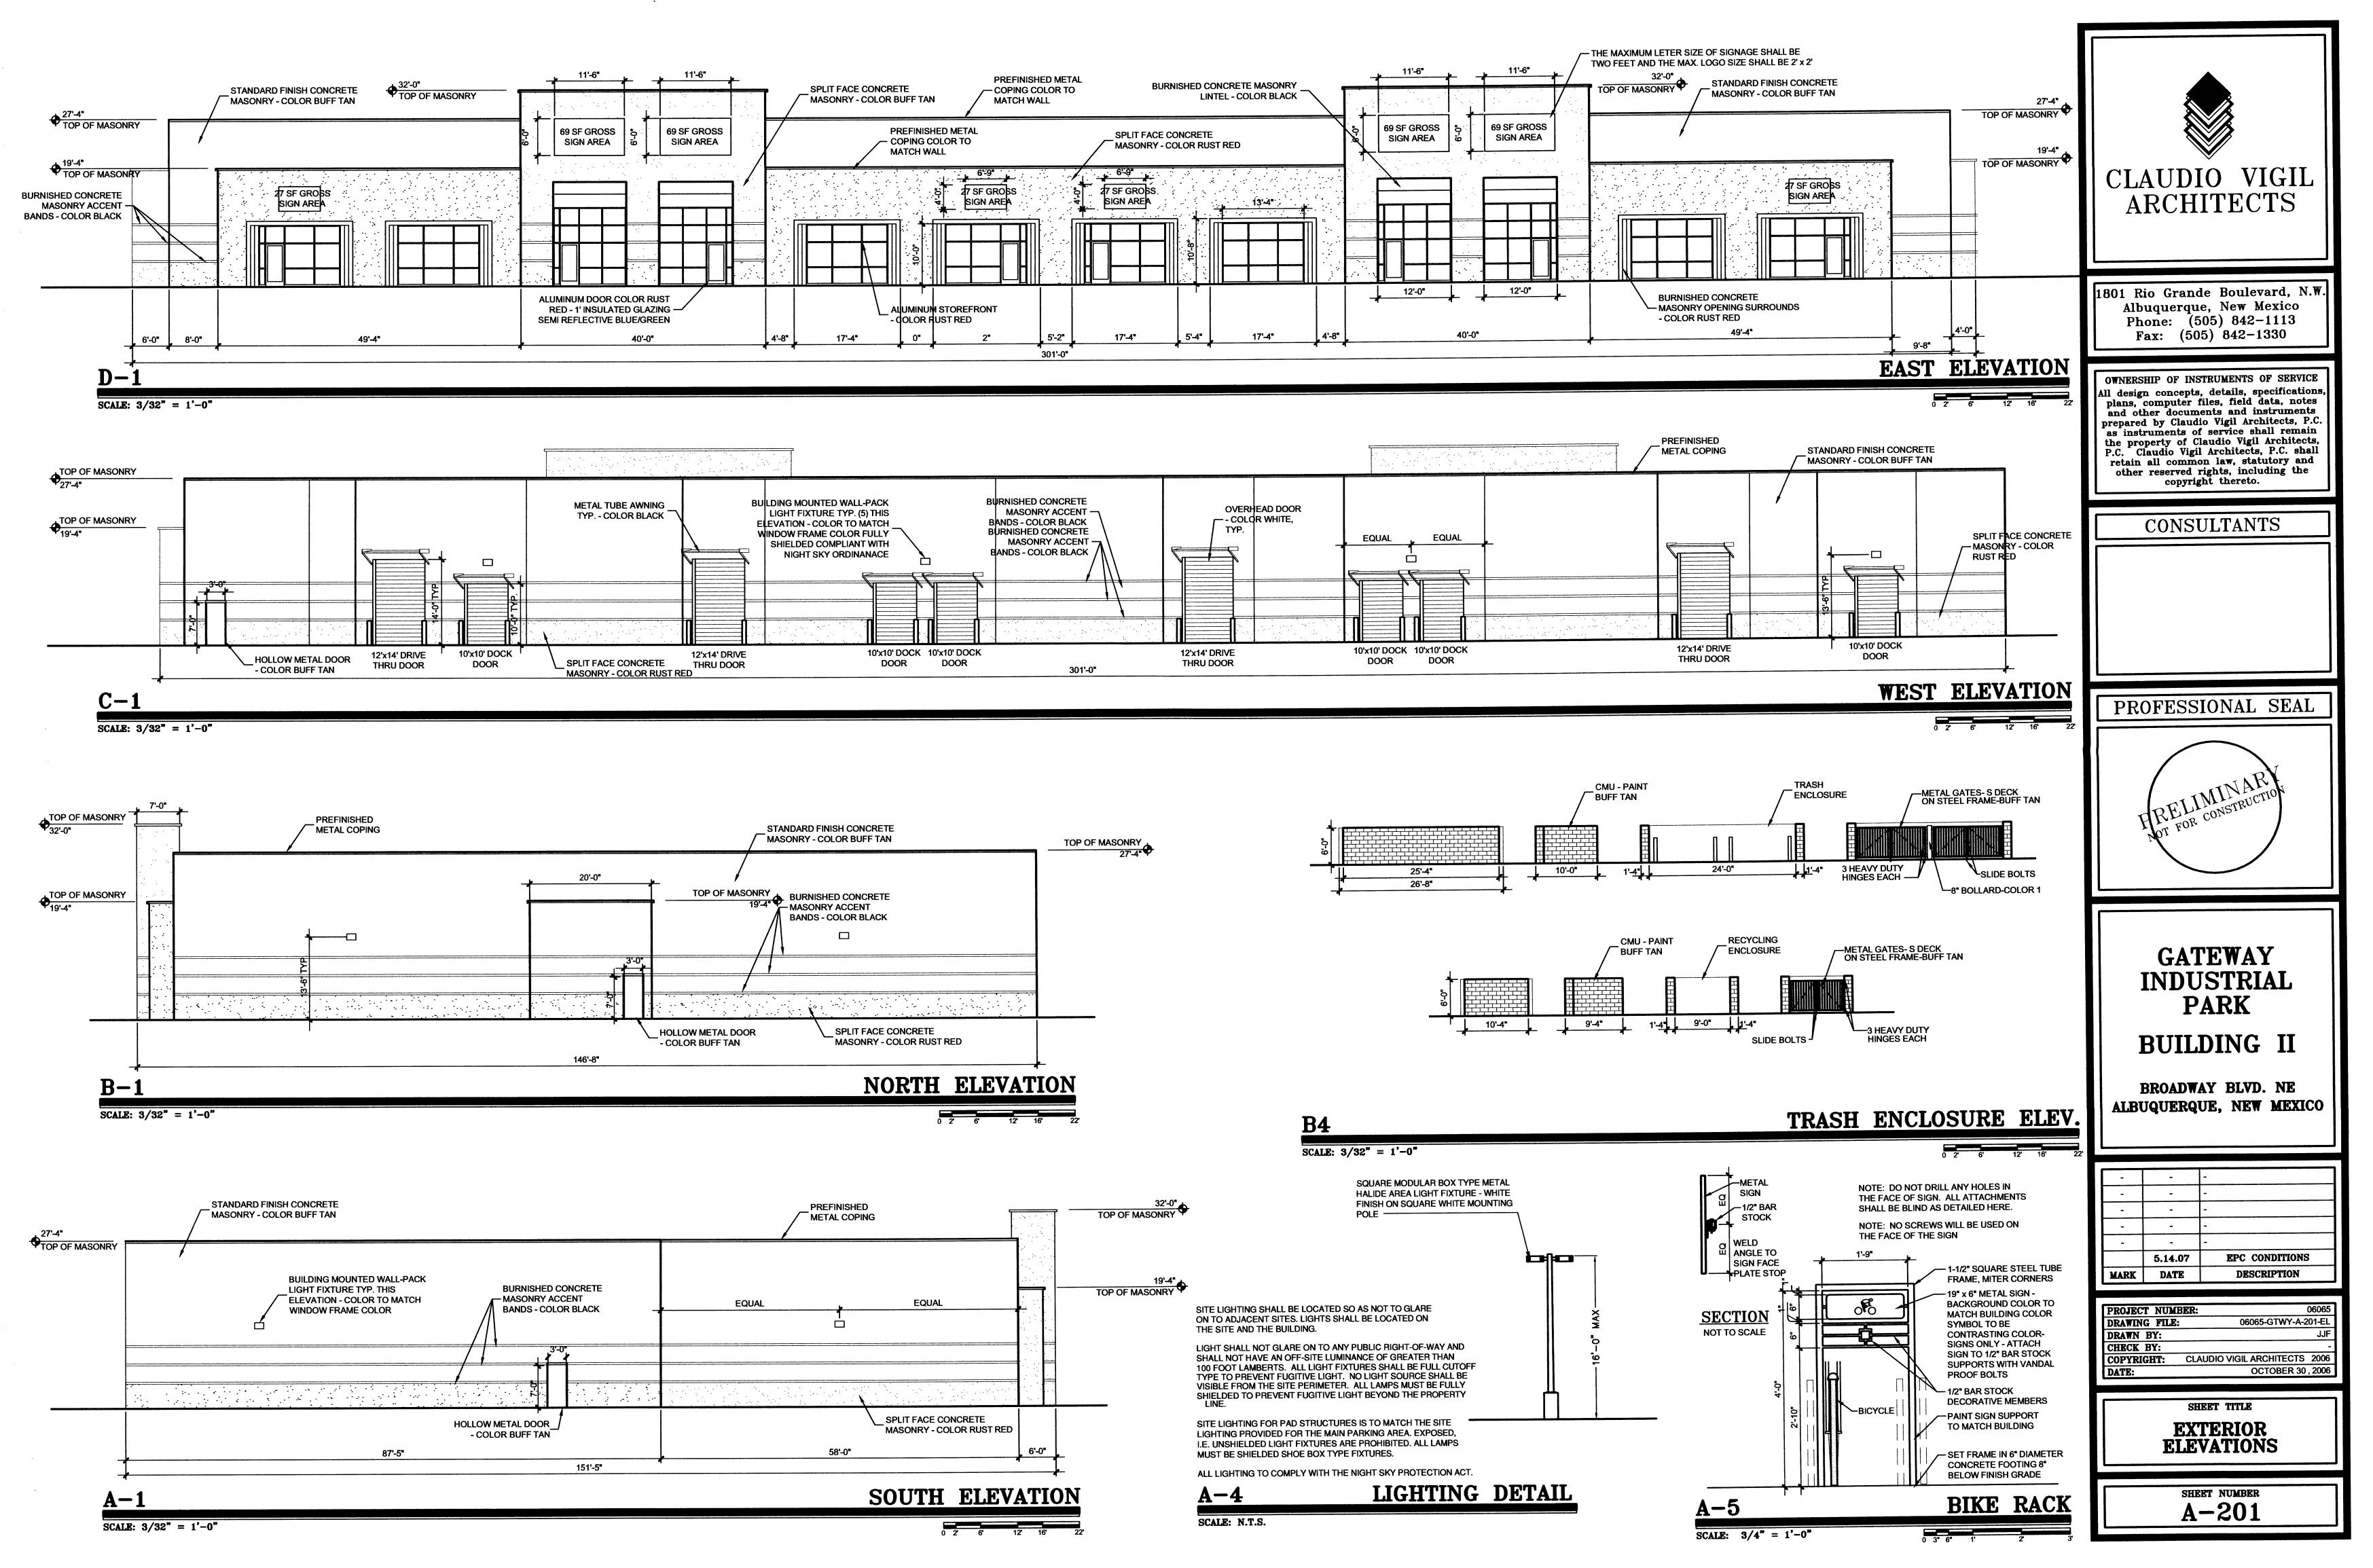

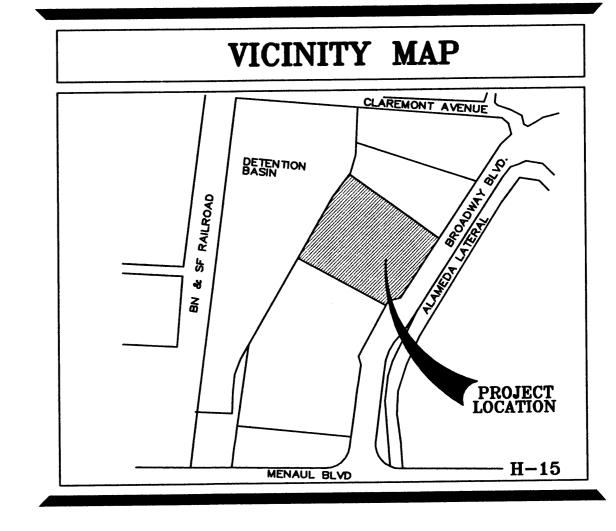



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CONSULTANTS



GATEWAY INDUSTRIAL PARK BUILDING II

BROADWAY BLVD. NE ALBUQUERQUE, NEW MEXICO

	5.14.07	EPC CONDITIONS
MARK	DATE	DESCRIPTION

PROJECT NUM	BER: 06065
DRAWING FILE	
DRAWN BY:	JJF
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DATE:	OCTOBER 30, 2006

CONCEPTUAL UTILITY PLAN


SHEET NUMBER
C-101



SITE PLAN

SU-1 PRIVATE SCHOOL AND INCIDENTAL FACILITIES

TALOS LOG # 2007-2401-51

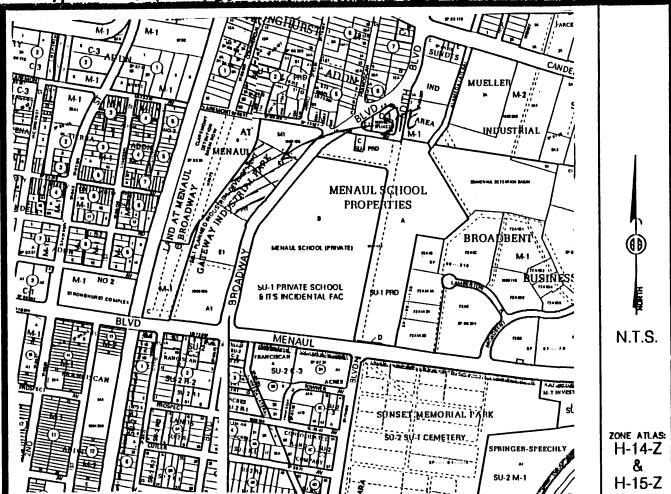

Vicinity Map

SUBDIVISION DATA / NOTES

- 1. PLAT WAS COMPILED USING EXISTING RECORD DATA & ACTUAL FIELD SURVEY.
- 2. BEARINGS ARE NEW MEXICO STATE PLANE GRID BEARINGS, CENTRAL ZONE, NAD 1927, AND ARE BASED ON ACS CONTROL MONUMENTS NM47-10 AND NM47-13, AS SHOWN HEREON
- 3. DISTANCES ARE GROUND DISTANCES.
- 4. PLAT SHOWS ALL EASEMENTS OF RECORD.
- 5. GROSS AREA: 4.3249 ACRES
- 7. NUMBER OF EXISTING TRACTS: 2
- 8. NUMBER OF TRACTS CREATED: 1
- 9. PROPERTY IS ZONED SU-1.

LEGAL DESCRIPTION

Tracts lettered H-1 and K-1 plat of Tracts E-1, M-1, and K-1 GATEWAY INDUSTRIAL PARK Town of Albuquerque Grant, City of Albuquerque, as the same is shown and designated on said plat thereof, filed in the Office of the County Clerk of Bernalillo County, New Mexico on October 17, 2005 in Book 2005C, page 345.

FREE CONSENT

THE UNDERSIGNED OWNER(S) AND PROPRIETOR(S) OF THE PROPERTY DESCRIBED HEREON DO HEREBY CONSENT TO THE PLATTING OF SAID PROPERTY AS SHOWN HEREON AND THE SAME IS WITH THE FREE CONSENT AND IN ACCORDANCE WITH THEIR DESIRES AND SAID OWNERS WARRANT THAT THEY HOLD COMPLETE AND INDEFEASIBLE TITLE IN FEE SIMPLE TO THE LAND SUBDIVIDED.

OWNER(S) SIGNATURE:	DATE: <u>6/1/0 7</u>
OWNER(S) PRINT NAME: ROBLN HENDRIKSON	(' '
ADDRESS: 2921 ZNO NW ANDUR NM &	1107 TRACT:
ACKNOWLEDGMENT (EFICIAL SEAL
STATE OF MENNINEVICO \	irah Ansito
	10/01/09
THIS INSTRUMENT WAS ACKNOWLEDGED BEFORE ME THIS	DAY OF JUNE , 2007.
BY: 170BUN HENDREXSON	O(1)O(1)
	Sarah Mimate
70101104	NOTARY PUBLIC

EASEMENT NOTES

- (A) Existing 10' PUE per plat of July 5, 2000, Book 2000C, page 173.
- (B) Existing 10' Private Drainage Easement Intended to benefit Tracts C through K. Each individual property owner shall be responsible for maintaining the portion of the Easement fronting Grantee's respective tract, Book 2000C, page 173.
- (C) Existing Public Waterline and Sanitary Sewer Easement granted to the City of Albuquerque, Book 2000C, page 173.
- (D) Existing private access easement intended to benefit existing Tracts A through M, including Tract C. Each individual property owner shall be responsible for maintaining the portion of the easement fronting respective Tract, Book 2000C, page 173.
- (E) Private reciprocal access easement per plat filed October 17, 2005, Book 2005C, page 345, to benefit Tracts K-1, L and M, and is to be maintained by owner of Tract K-1.
- (F) Private reciprocal access easement per plat filed October 17, 2005, Book 2005C, page 345, to benefit Tracts H-1 and E-1, and is to be maintained by owner of Tract H-1 and Tract E-1.
- A Reciprocal private cross-access easement exists across the original Tracts A through M and is to be maintained by said tract owners, Book 2000C, page 173.

PLAT OF

TRACT H-1-A

GATEWAY INDUSTRIAL PARK

TOWN OF ALBUQUERQUE GRANT

PROJECTED SECTIONS 8 & 9, T. 10 N., R. 3 E., N.M.P.M.

CITY OF ALBUQUERQUE BERNALILLO COUNTY, NEW MEXICO **JUNE 2007** SHEET 1 OF 2

Doc# 2007093662

Ropt #:0003334 Page: 1 of 2 06/27/2007 09:59 AM PLAT R:\$12.00 B: 2007C P: 0170 M. Toulouse, Bernalillo County

DISCLOSURE STATEMENT

THE PURPOSE OF THIS PLAT IS TO COMBINE TWO (2) EXISTING TRACTS INTO ONE (1) NEW TRACT.

CITY APPROVALS: PROJECT NO.: 1005240 AF	PPLICATION NO. 07DRB-7005
HBHAL >	6-12-07
CITY SURVEYOR	DATE
If Da	6-20-07
TRAFFIC ENGINEERING	DATE
Christina Sandoval	4/20/07
PARKS & RECREATION DEPARTMENT	DATE
' Hand Sheen	6-20-07
WATER UTILITY & DEPARTMENT	DATE
Bradler J. Binglan	6/21/07
A.M.A.F.C.A.	DATE
KSD 25	6/20/07
CITY ENGINEER	DAJE
Do atson	6/20/07
DRB CHAIRPERSON, PLANNING DEPARTMENT	DATE

SURVEYOR'S CERTIFICATION

I, Mitchell W. Reynolds, a duly qualified Registered Professional Land Surveyor under the laws of the State of New Mexico, do hereby certify that this plat and description were prepared by me or under my supervision, shows all easements as shown on the plat of record or made known to me by the owners and/or proprietors of the subdivision shown hereon, utility companies and other parties expressing an interest and meets the minimum requirements for monumentation and surveys of the Albuquerque Subdivision Ordinance, and further meets the Minimum Standards for Land Surveying in the State of New Mexico and is true and correct to the best of my knowledge and belief.

New Mexico Professional Surveyor, 11224

06-11-07

SURVEYS SOUTHWEST LTD.

333 LOMAS BLVD., N.E. ALBUQUERQUE, NEW MEXICO

87102

PHONE: (505) 998-0303 FAX: (505) 998-0306

T10N R3E SEC. 8 & 9

