



SCALE:  $1^{\circ} = 20^{\circ} - 0^{\circ}$ 

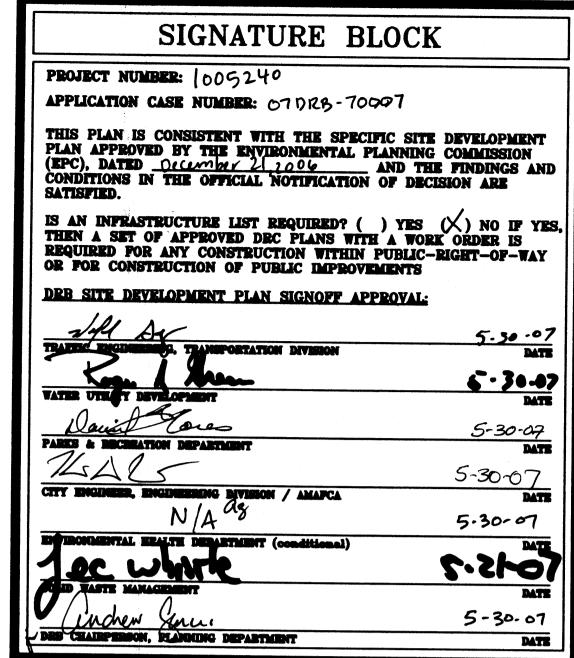

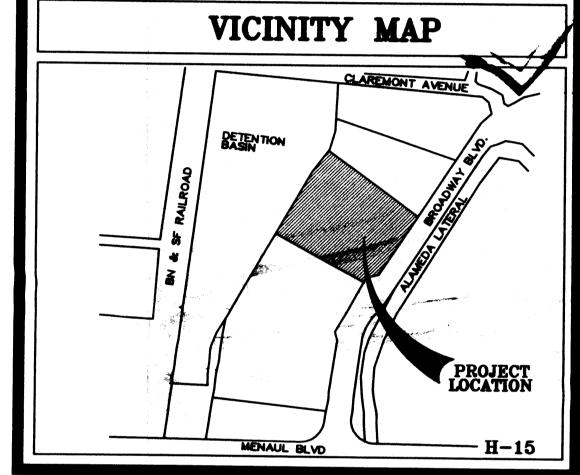

## PROJECT INFORMATION

PROJECT: GATEWAY II INDUSTRIAL PARK OWNER: MECH-CON INVESTMENTS 216 CLAREMONT NW ALBUQUERQUE, NM 87107

ARCHITECT: CLAUDIO VIGIL ARCHITECTS
1801 RIO GRANDE BLVD. NW
ALBUQUERQUE NM, 87104

LEGAL DESCRIPTION: TRACT H-1
LAND AT BROADWAY AND MENAUL
ZONING ATLAS MAP: H-15

ZONING CLASSIFICATION: EXISTING: IP PROPOSED: NO CHANGE APPLICABLE BUILDING CODE: 2005 IBC BUILDING TYPE: OFFICE/WAREHOUSE

CONSTRUCTION TYPE: TYPE IIB 100% SPRINKLED OCCUPANCY GROUP: GROUP B, AND S-2

NUMBER OF FLOORS: ONE
GROSS SQUARE FOOTAGE: 31,581.75 WAREHOUSE (75%)
10,527.25 OFFICE (25%)

ALLOWABLE AREA:

GROUP S-2 TYPE II-B = 26,000 SQ. FT. + 300% SPRINKLER INCREASE = 104,000 SQ. FT.

TOTAL PARKING/PAVED AREA:

OCCUPANT LOAD: OFFICE AREA: 10,527.25/100 =105.27 OCCUPANTS WAREHOUSE AREA: 31,581.75/500 = 63.16 OCCUPANTS

**EXIT WIDTH REQUIRED:** 169 x .2 = 33.8" = 3'.8" EXIT WIDTH PROVIDED: 396" NUMBER OF EXITS PROVIDED: ELEVEN

PULDING HEIGHT ABOVE GRADE: 32'
PARKING ANALYSIS:
REQUIRED PARKING = 31,581.75 (WAREHOUSE)/2000 =15.79 =16 SPACES
REQUIRED PARKING = 10,527.25 (OFFICE) /200 =52.65 =53 SPACES
TOTAL PARKING REQUIRED = / 69 SPACES

TOTAL PARKING SPACES PROVIDED
57 REGULAR + 4 H.C. + 5 SMALL CAR +4 MOTORCYCLE= 70 PARKING SPACES

8'-0" x 15'-0"

PARKING SPACES SIZES:

REGULAR CAR PARKING SPACES = 9'-0" x 18'-0" WITH A 2'-0" OVERHANG HANDICAP PARKING SPACE = 9'-0" x 18'-0" WITH A 2'-0" OVERHANG

COMPACT PARKING SPACE = BICYCLE SPACES:

SITE PLAN

REQUIRED PARKING - 70/20 = 3.5 BICYCLES (4 SPACES) TOTAL BICYCLE SPACES PROVIDED = 4 BICYCLE SPACES

CLAUDIO **ARCHITECTS** 1801 Rio Grande Boulevard, N. Albuquerque, New Mexico Phone: (505) 842-1113 Fax: (505) 842-1330

All design concepts, details, specifications plans, computer files, field data, notes and other documents and instruments prepared by Claudio Vigil Architects, P.C. as instruments of service shall remain the property of Claudio Vigil Architects, P.C. Claudio Vigil Architects, P.C. shall retain all common law, statutory and other reserved rights, including the copyright thereto.

CONSULTANTS

PROFESSIONAL SEAL HRELIMINAR OF FOR CONSTRUCTION

> **GATEWAY** INDUSTRIAL P'ARK **BUILDING II**


BROADWAY BLVD. NE ALBUQUERQUE, NEW MEXICO

Δ	5.14.07	EPC CONDITIONS
MARK	DATE	DESCRIPTION

PROJECT NUM	BER:	0606	K
DRAWING FILE:			_
DRAWN BY:		N	F
CHECK BY:		-	1
COPYRIGHT:	<b>CLAUDIO VIGIL ARCHITECTS</b>	2006	` 3
DATE:	OCTOBER 30	, 2006	3

PRELIMINARY SITE PLAN
FOR BUILDING PERMIT

> SHEET NUMBER C - 101

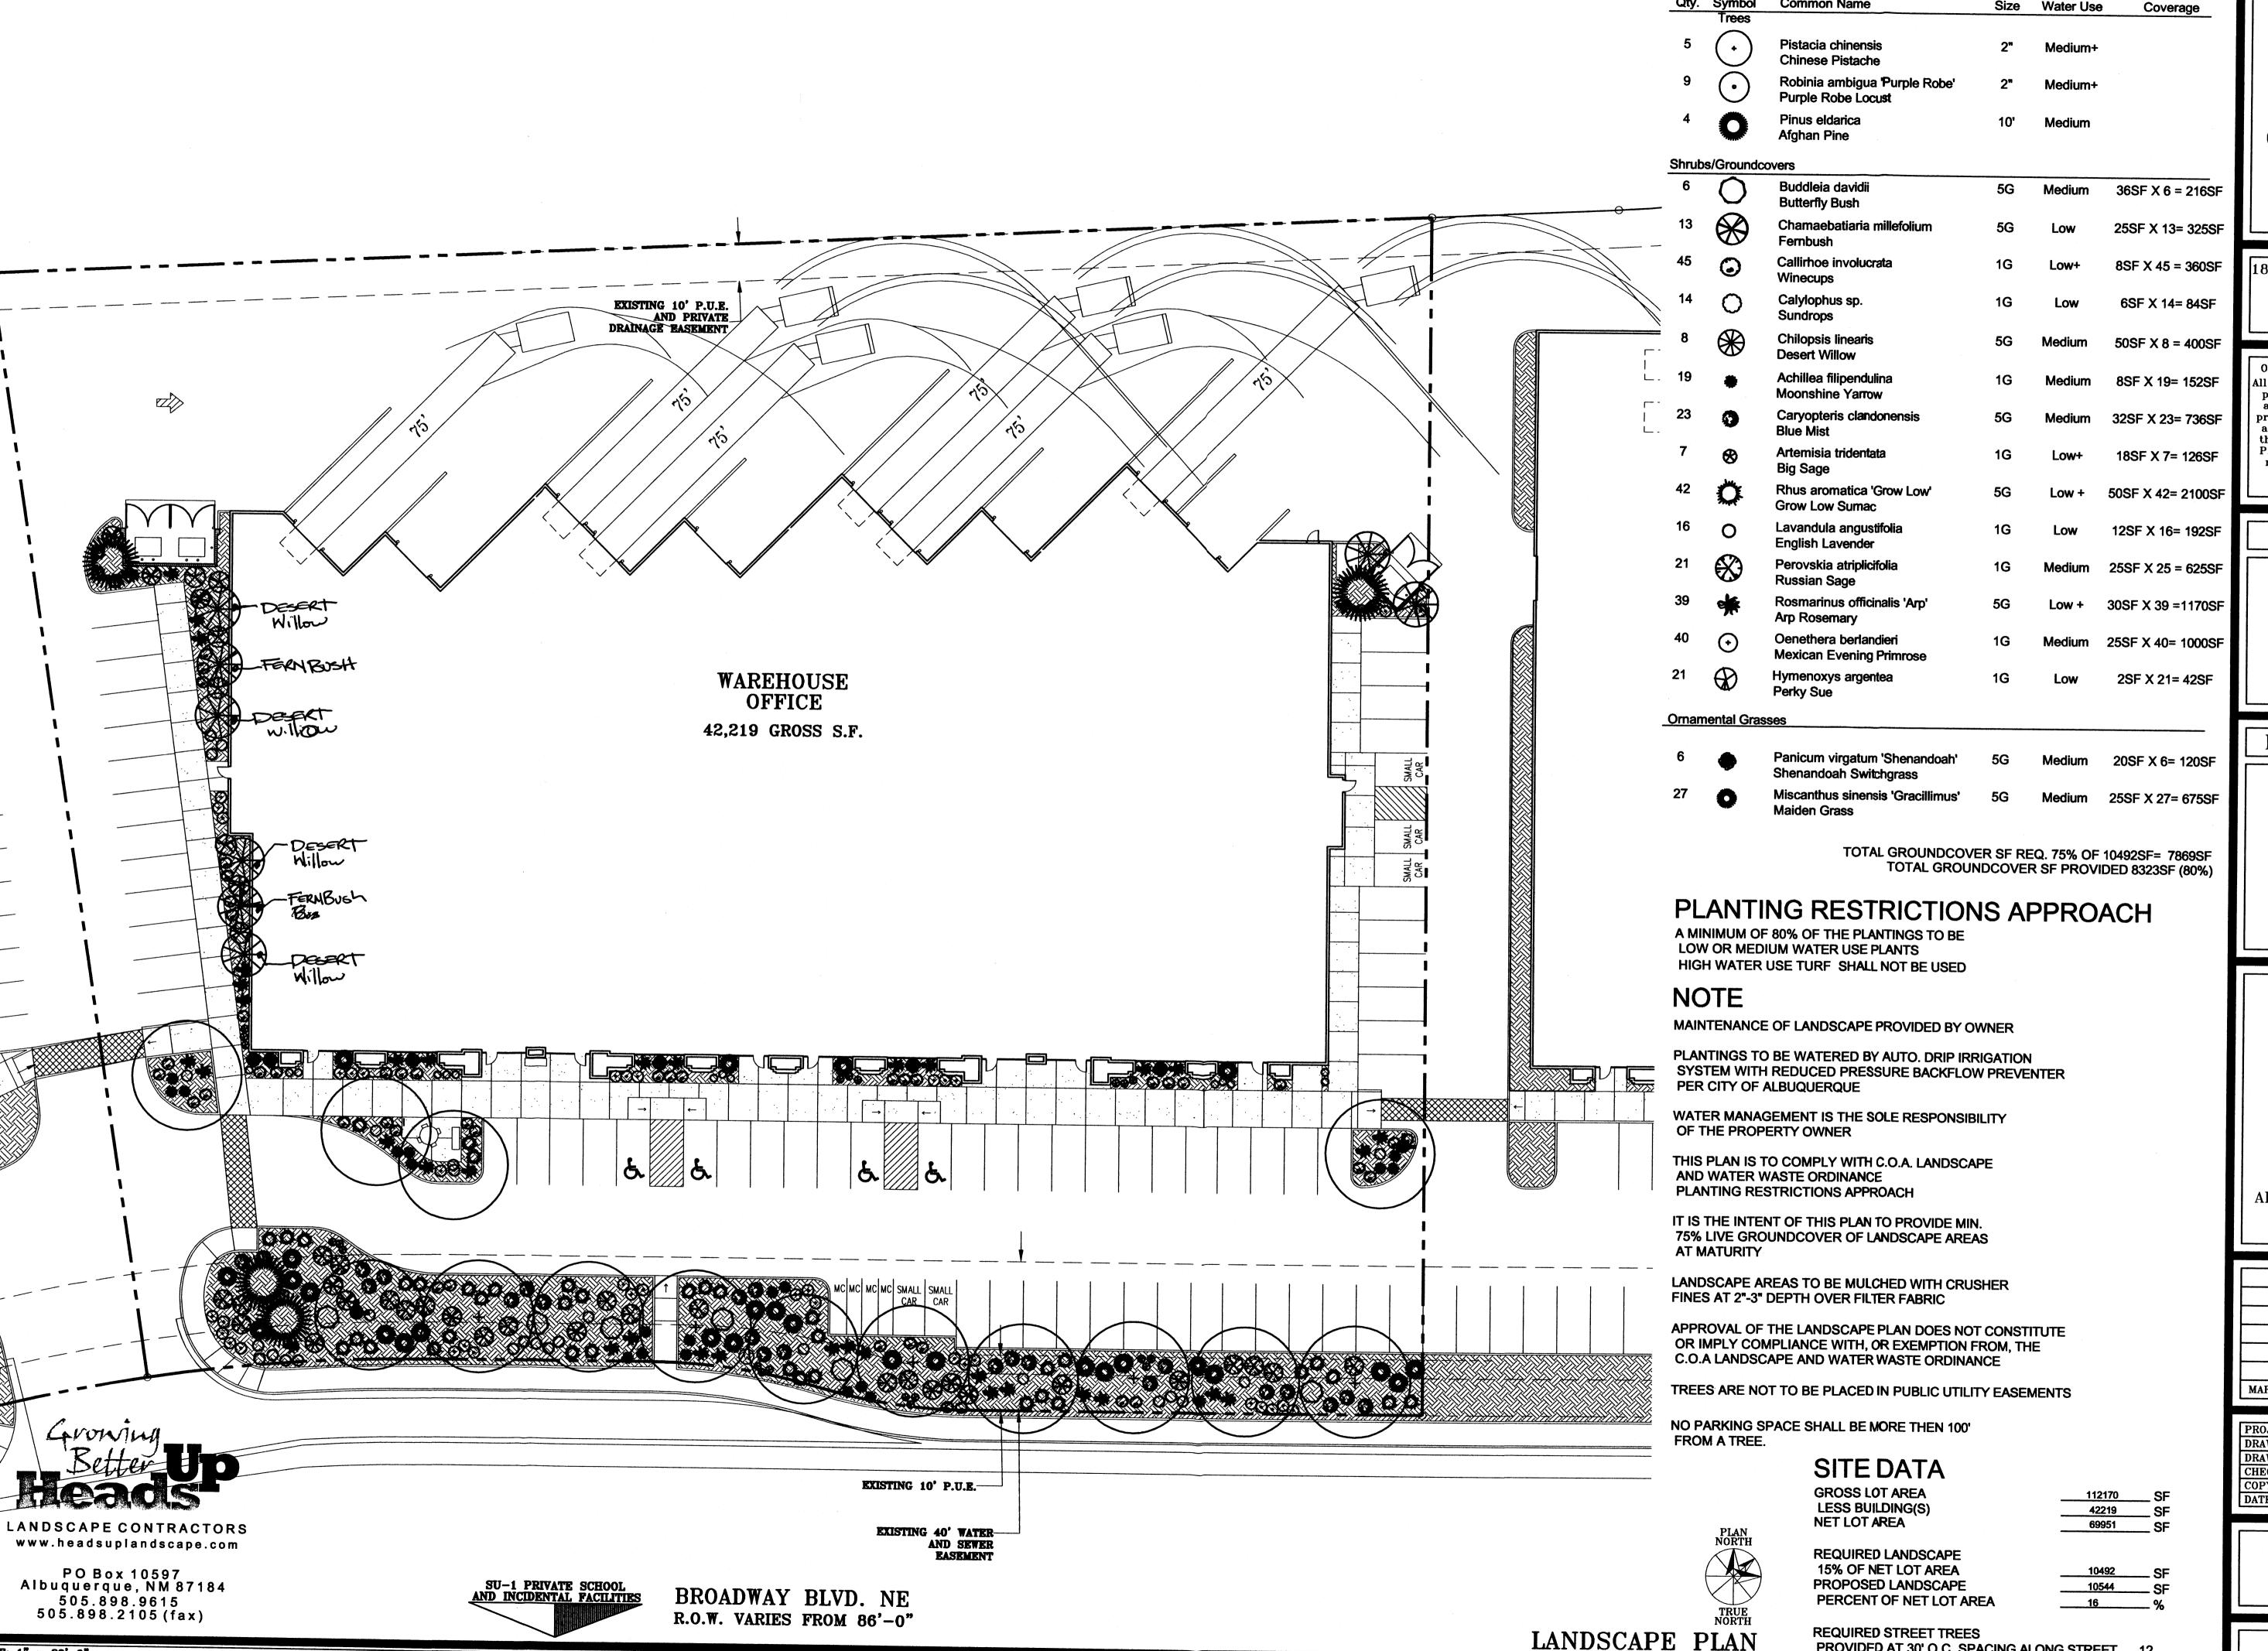

SCALE: 1" = 20'-0"



PLANT LEGEND

Qty. Symbol Common Name


Scientific Name

1801 Rio Grande Boulevard, N.W Albuquerque, New Mexico Phone: (505) 842-1113 Fax: (505) 842-1330

OWNERSHIP OF INSTRUMENTS OF SERVICE All design concepts, details, specifications, plans, computer files, field data, notes and other documents and instruments prepared by Claudio Vigil Architects, P.C. as instruments of service shall remain the property of Claudio Vigil Architects, P.C. Claudio Vigil Architects, P.C. shall retain all common law, statutory and other reserved rights, including the copyright thereto.

CONSULTANTS

PROFESSIONAL SEAL

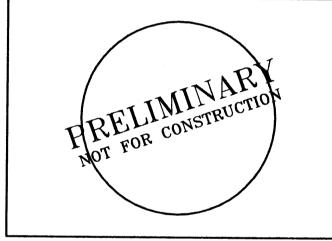

**GATEWAY** INDUSTRIAL **PARK** BUILDING II

BROADWAY BLVD. NE ALBUQUERQUE, NEW MEXICO

MARK	DATE	DESCRIPTION

PROJECT NUMBER: DRAWING FILE: DRAWN BY: CHECK BY: COPYRIGHT: CLAUDIO VIGIL ARCHITECTS 2006 OCTOBER 30, 2006 DATE:

> SHEET TITLE **PRELIMINARY** LANDSCAPE PLAN

> > SHEET NUMBER L-101

PROVIDED AT 30' O.C. SPACING ALONG STREET 12

PROVIDED AT 1 PER 10 SPACES (49 SPACES/10) 5

REQUIRED PARKING LOT TREES

## DRAINAGE PLAN

THE PROPOSED IMPROVEMENTS AS SHOWN BY THE VICINITY MAP, ARE LOCATED WEST OF BROADWAY BOULEVARD NORTH OF THE MENAUL BOULEVARD. THE SITE IS UNDEVELOPED AND SLOPES FROM EAST TO WEST AT AN APPROXIMATE SLOPE OF 1.5%. THE SITE DOES NOT LIE WITHIN A FLOOD HAZARD ZONE. THE SITE IS HIGHER THAN THE LANDS TO THE WEST. THE EXISTING STREET BLOCKS THE FLOWS FROM THE NORTH AND EAST THE LAND TO THE SOUTH SLOPE TO THE EXISTING ASPHALT DRAINAGE CHANNEL ALONG THE WEST PROPERTY LINE. THEREFORE OFFSITE FLOWS ARE CONSIDERED

THE PROPOSED DEVELOPMENT LIE WITHIN GATEWAY INDUSTRIAL PARK TRACT H-1 (PREVIOUSLY TRACTS H & I) A CONCEPTUAL MASTER DRAINAGE PLAN FOR THIS SITE WAS PREPARED BY MARK GOODWIN & ASSOCIATES. THE MASTER DRAINAGE PLAN ESTABLISHED UNRESTRICTED DISCHARGE OF DEVELOPED FLOWS INTO THE ADJACENT CITY DETENTION POND TO THE WEST.

THE PROPOSED IMPROVEMENTS CONSIST OF A NEW OFFICE BUILDING WITH ASSOCIATED PARKING AND LANDSCAPING. AS SHOWN BY THE CALCULATION THE PROPOSED DEVELOPMENT WILL INCREASE THE RATE AND VOLUME OF RUNOFF. THE PROPOSED SITE IMPROVEMENTS ARE DRAIN TO THE EXISTING DRAINAGE CHANNEL ALONG THE WEST PROPERTY LINE. THE PROPOSED RATE OF DISCHARGE IS 11.5 CFS

THE CALCULATIONS ANALYZE THE EXISTING AND PROPOSED CONDITIONS FOR 6-HOUR, 100 YEAR RAINFALL EVENT. THE ANALYSIS IS IN ACCORDANCE WITH THE CITY OF ALBUQUERQUE DEVELOPMENT PROCESS MANUAL VOLUME II.

## <u>CALCULATIONS</u> PRECIPITATION ZONE = 2

TOTAL SITE AREA = 2.575 ACRES

EXISTING CONDITIONS

LAND TREATMENT A=100%


E = 0.53(1.00) = 0.53 INCHES V = 0.53(2.575) / 12 = 0.114 ACRE FEET

Q = 1.56(1.00) (2.275) = 4.0 CFS
DEVELOPED CONDITIONS

LAND TREATMENT B=10% D=90%

E = 0.78(0.10)+2.12(0.90)= 1.99 INCHES V = 1.99 (2.575) / 12 = 0.426 ACRE FEET Q = [2.28(0.10)+4.7(0.90)](2.575)=11.5 CFS


Q =11.5/2.575=4.5 CFS/ACRE INCREASE IN VOLUME OF RUNOFF = 0.312 ACRE FT EXISTING ASPHALT CURB

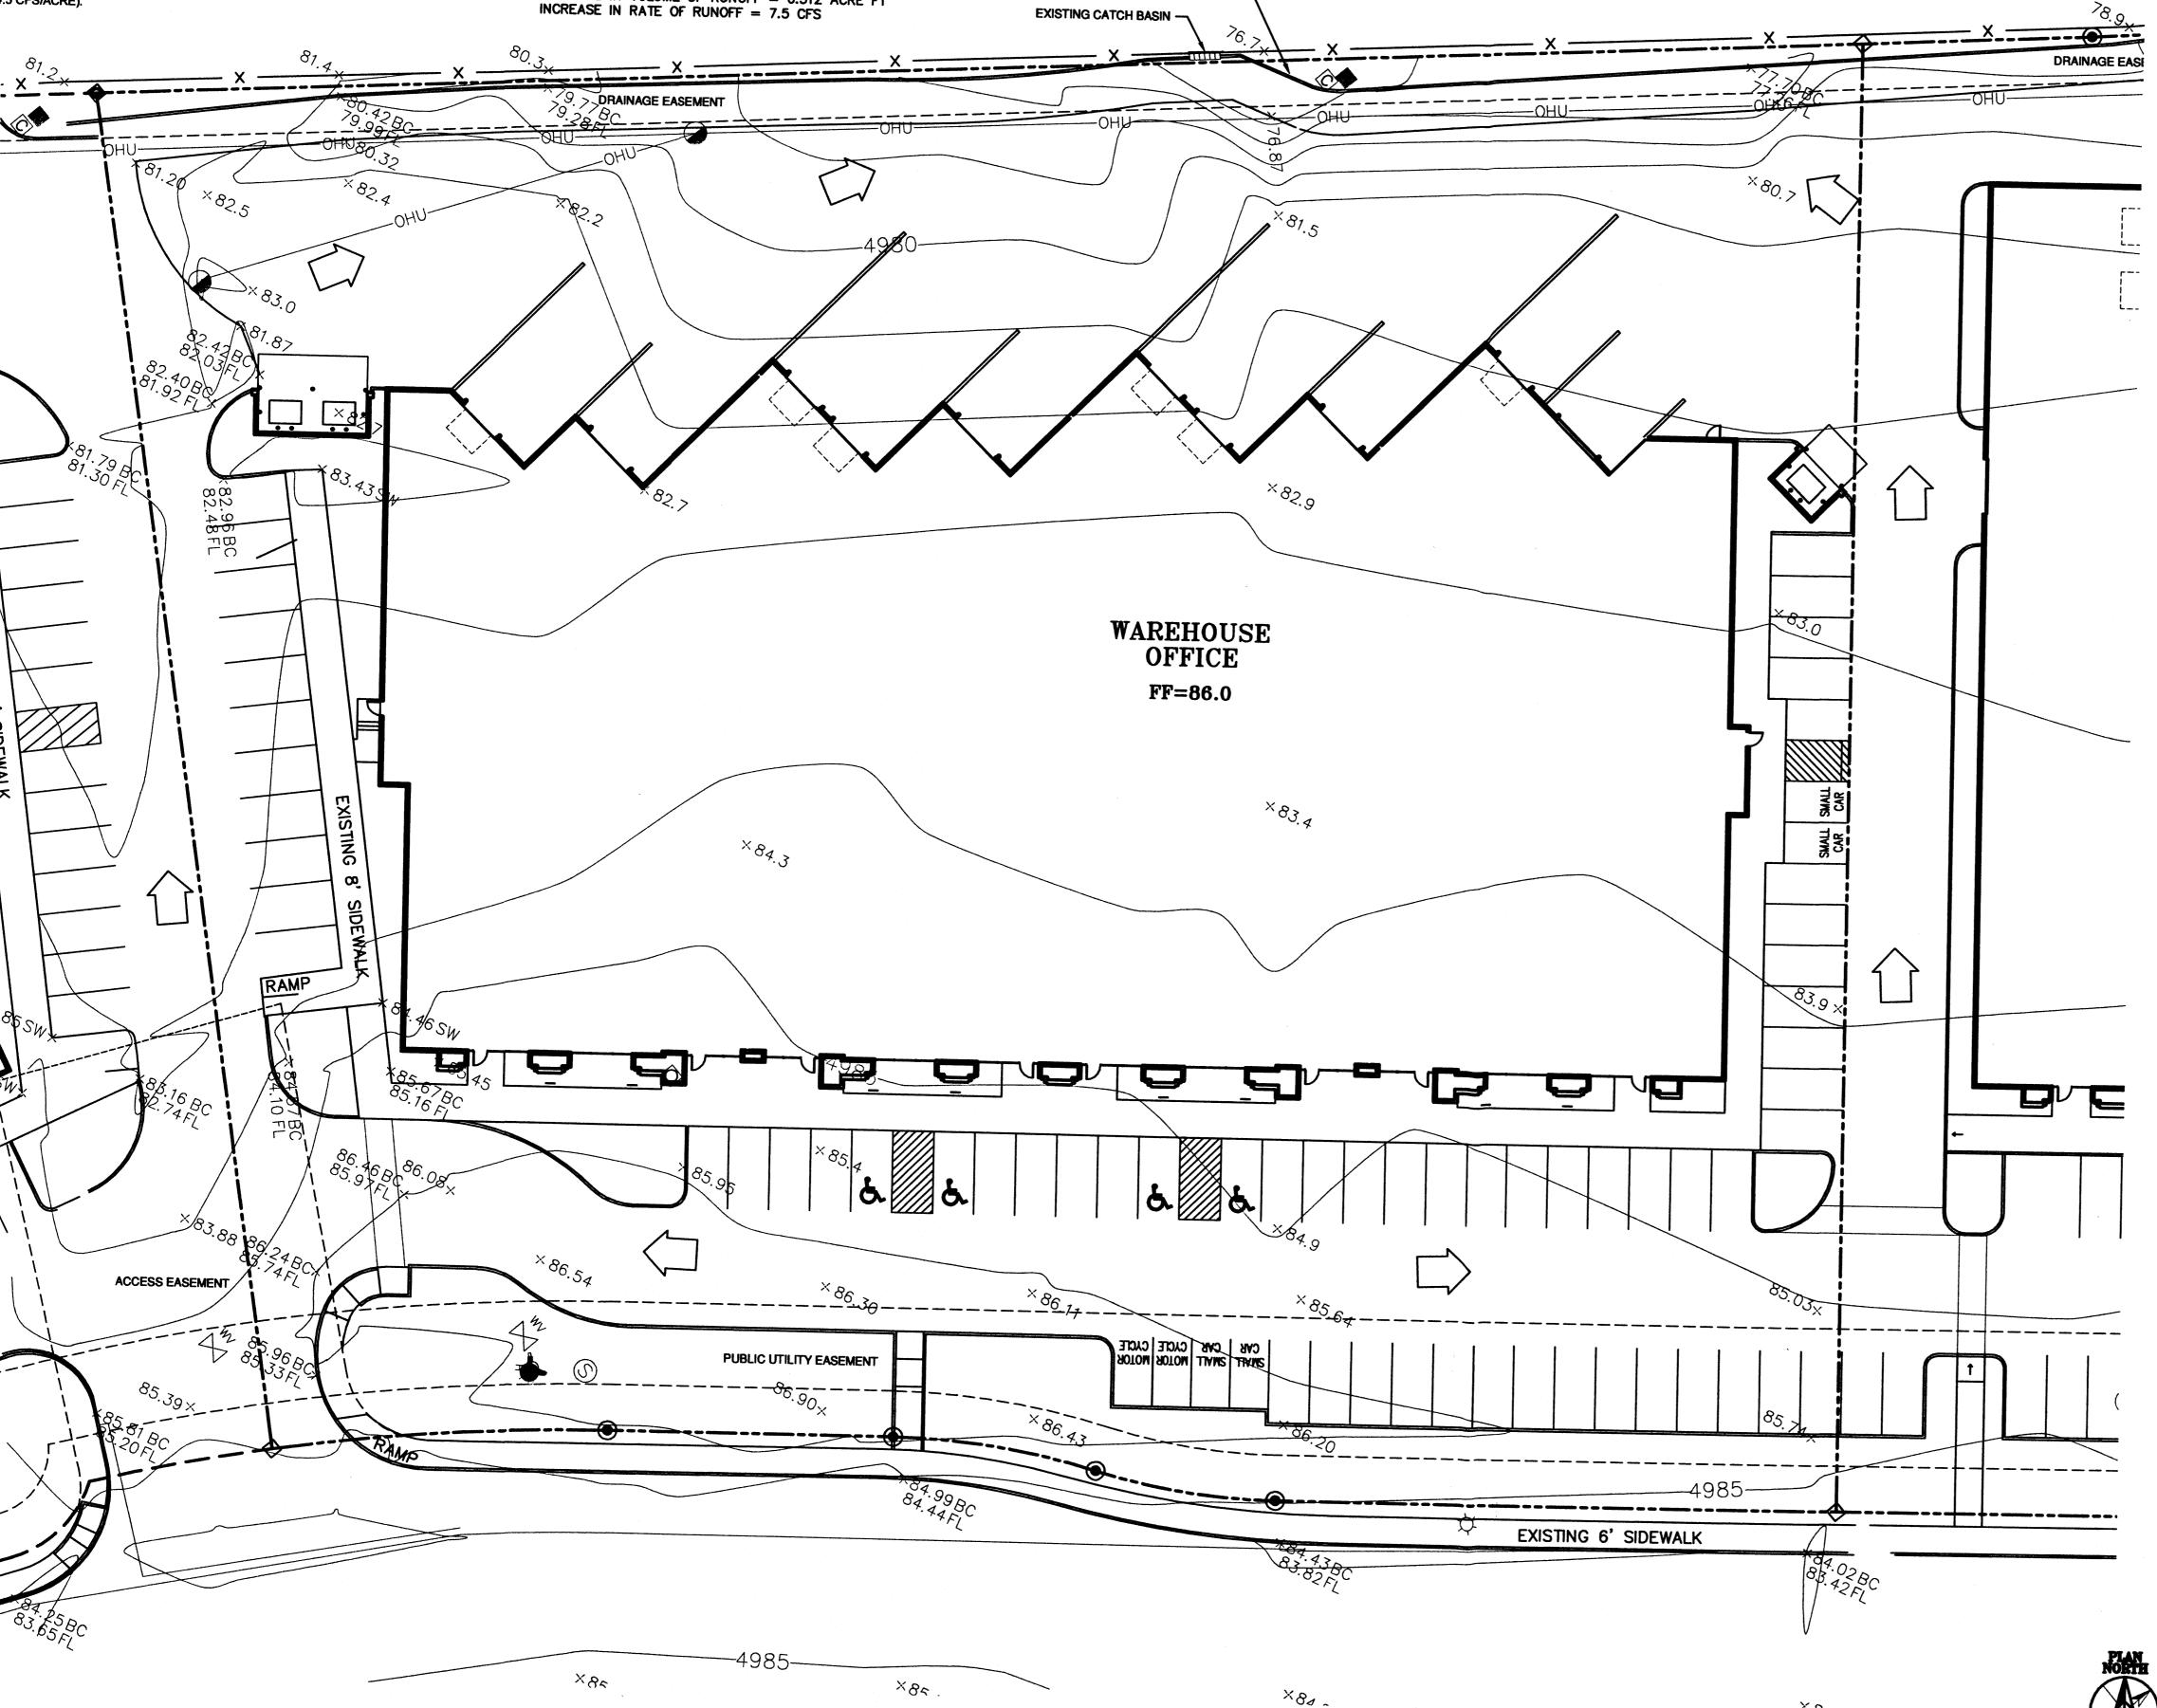

BROADWAY BLVD. NE R.O.W. VARIES FROM 86'-0"



SITE PLAN

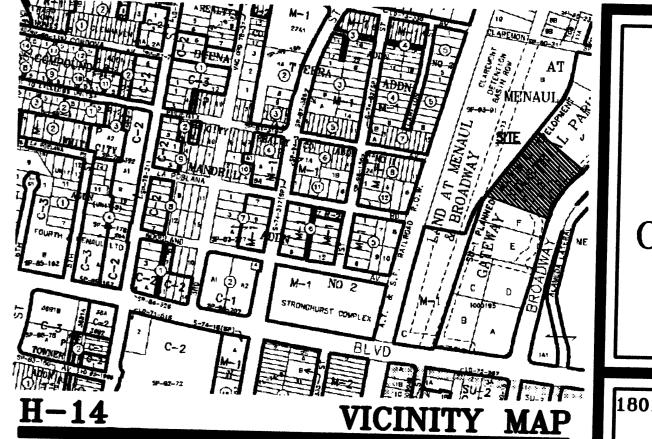

PROJECT GATEWAY INDUSTRIAL PARKS BUILDING II

ADDRESS: xxx Broadway blvd., n.w. LEGAL DESCRIPTION: TRACT H-1 GATEWAY INDUSTRIAL PARK



1801 Rio Grande Boulevard, N.W. Albuquerque, New Mexico Phone: (505) 842-1113 Fax: (505) 842-1330

OWNERSHIP OF INSTRUMENTS OF SERVICE All design concepts, details, specifications, plans, computer files, field data, notes and other documents and instruments prepared by Claudio Vigil Architects, P.C. as instruments of service shall remain the property of Claudio Vigil Architects, P.C. Claudio Vigil Architects, P.C. shall retain all common law, statutory and other reserved rights, including the copyright thereto.

CONSULTANTS

PROFESSIONAL SEAL

**GATEWAY** INDUSTRIAL **PARK** BUILDING II


BROADWAY BLVD. NE ALBUQUERQUE, NEW MEXICO


MARK	DATE	DESCRIPTION
<del>                                     </del>		

PROJECT NUMBER: DRAWING FILE: CHECK BY: COPYRIGHT: CLAUDIO VIGIL ARCHITECTS 2005 **SEPTEMBER 28, 2006** 

> SHEET TITLE PRELIMINARY GRADING PLAN

> > SHEET NUMBER C - 102

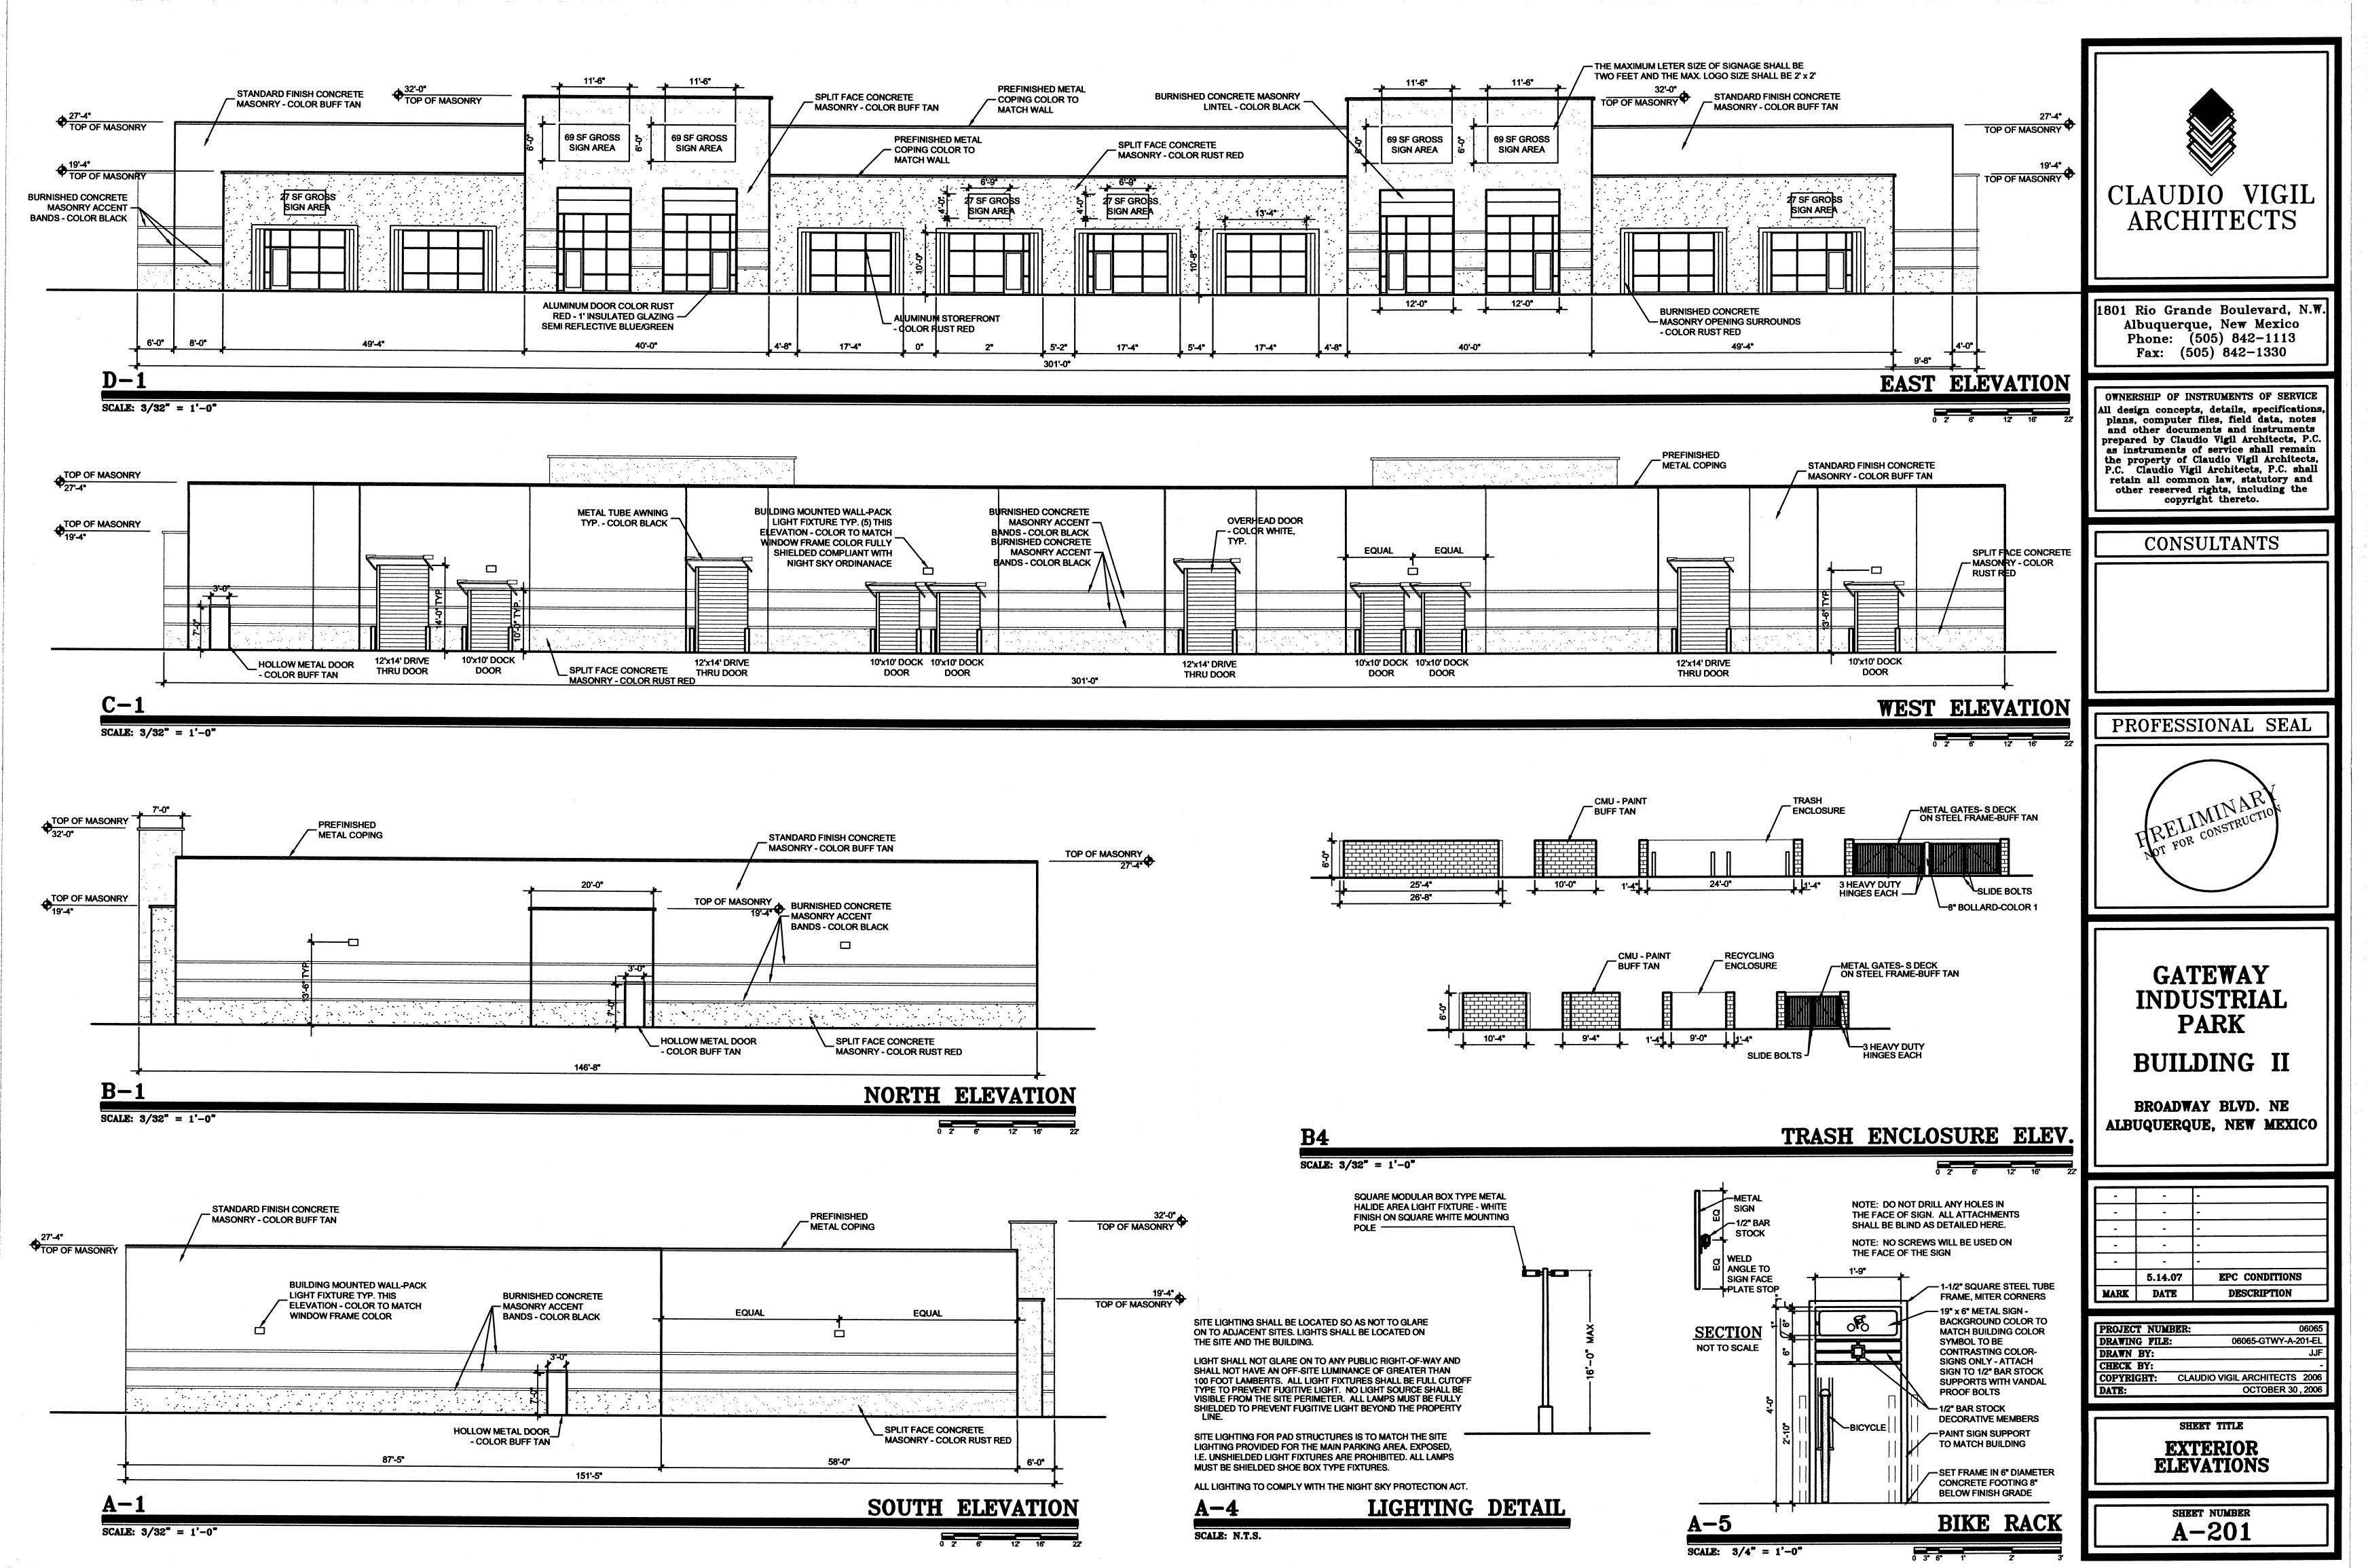

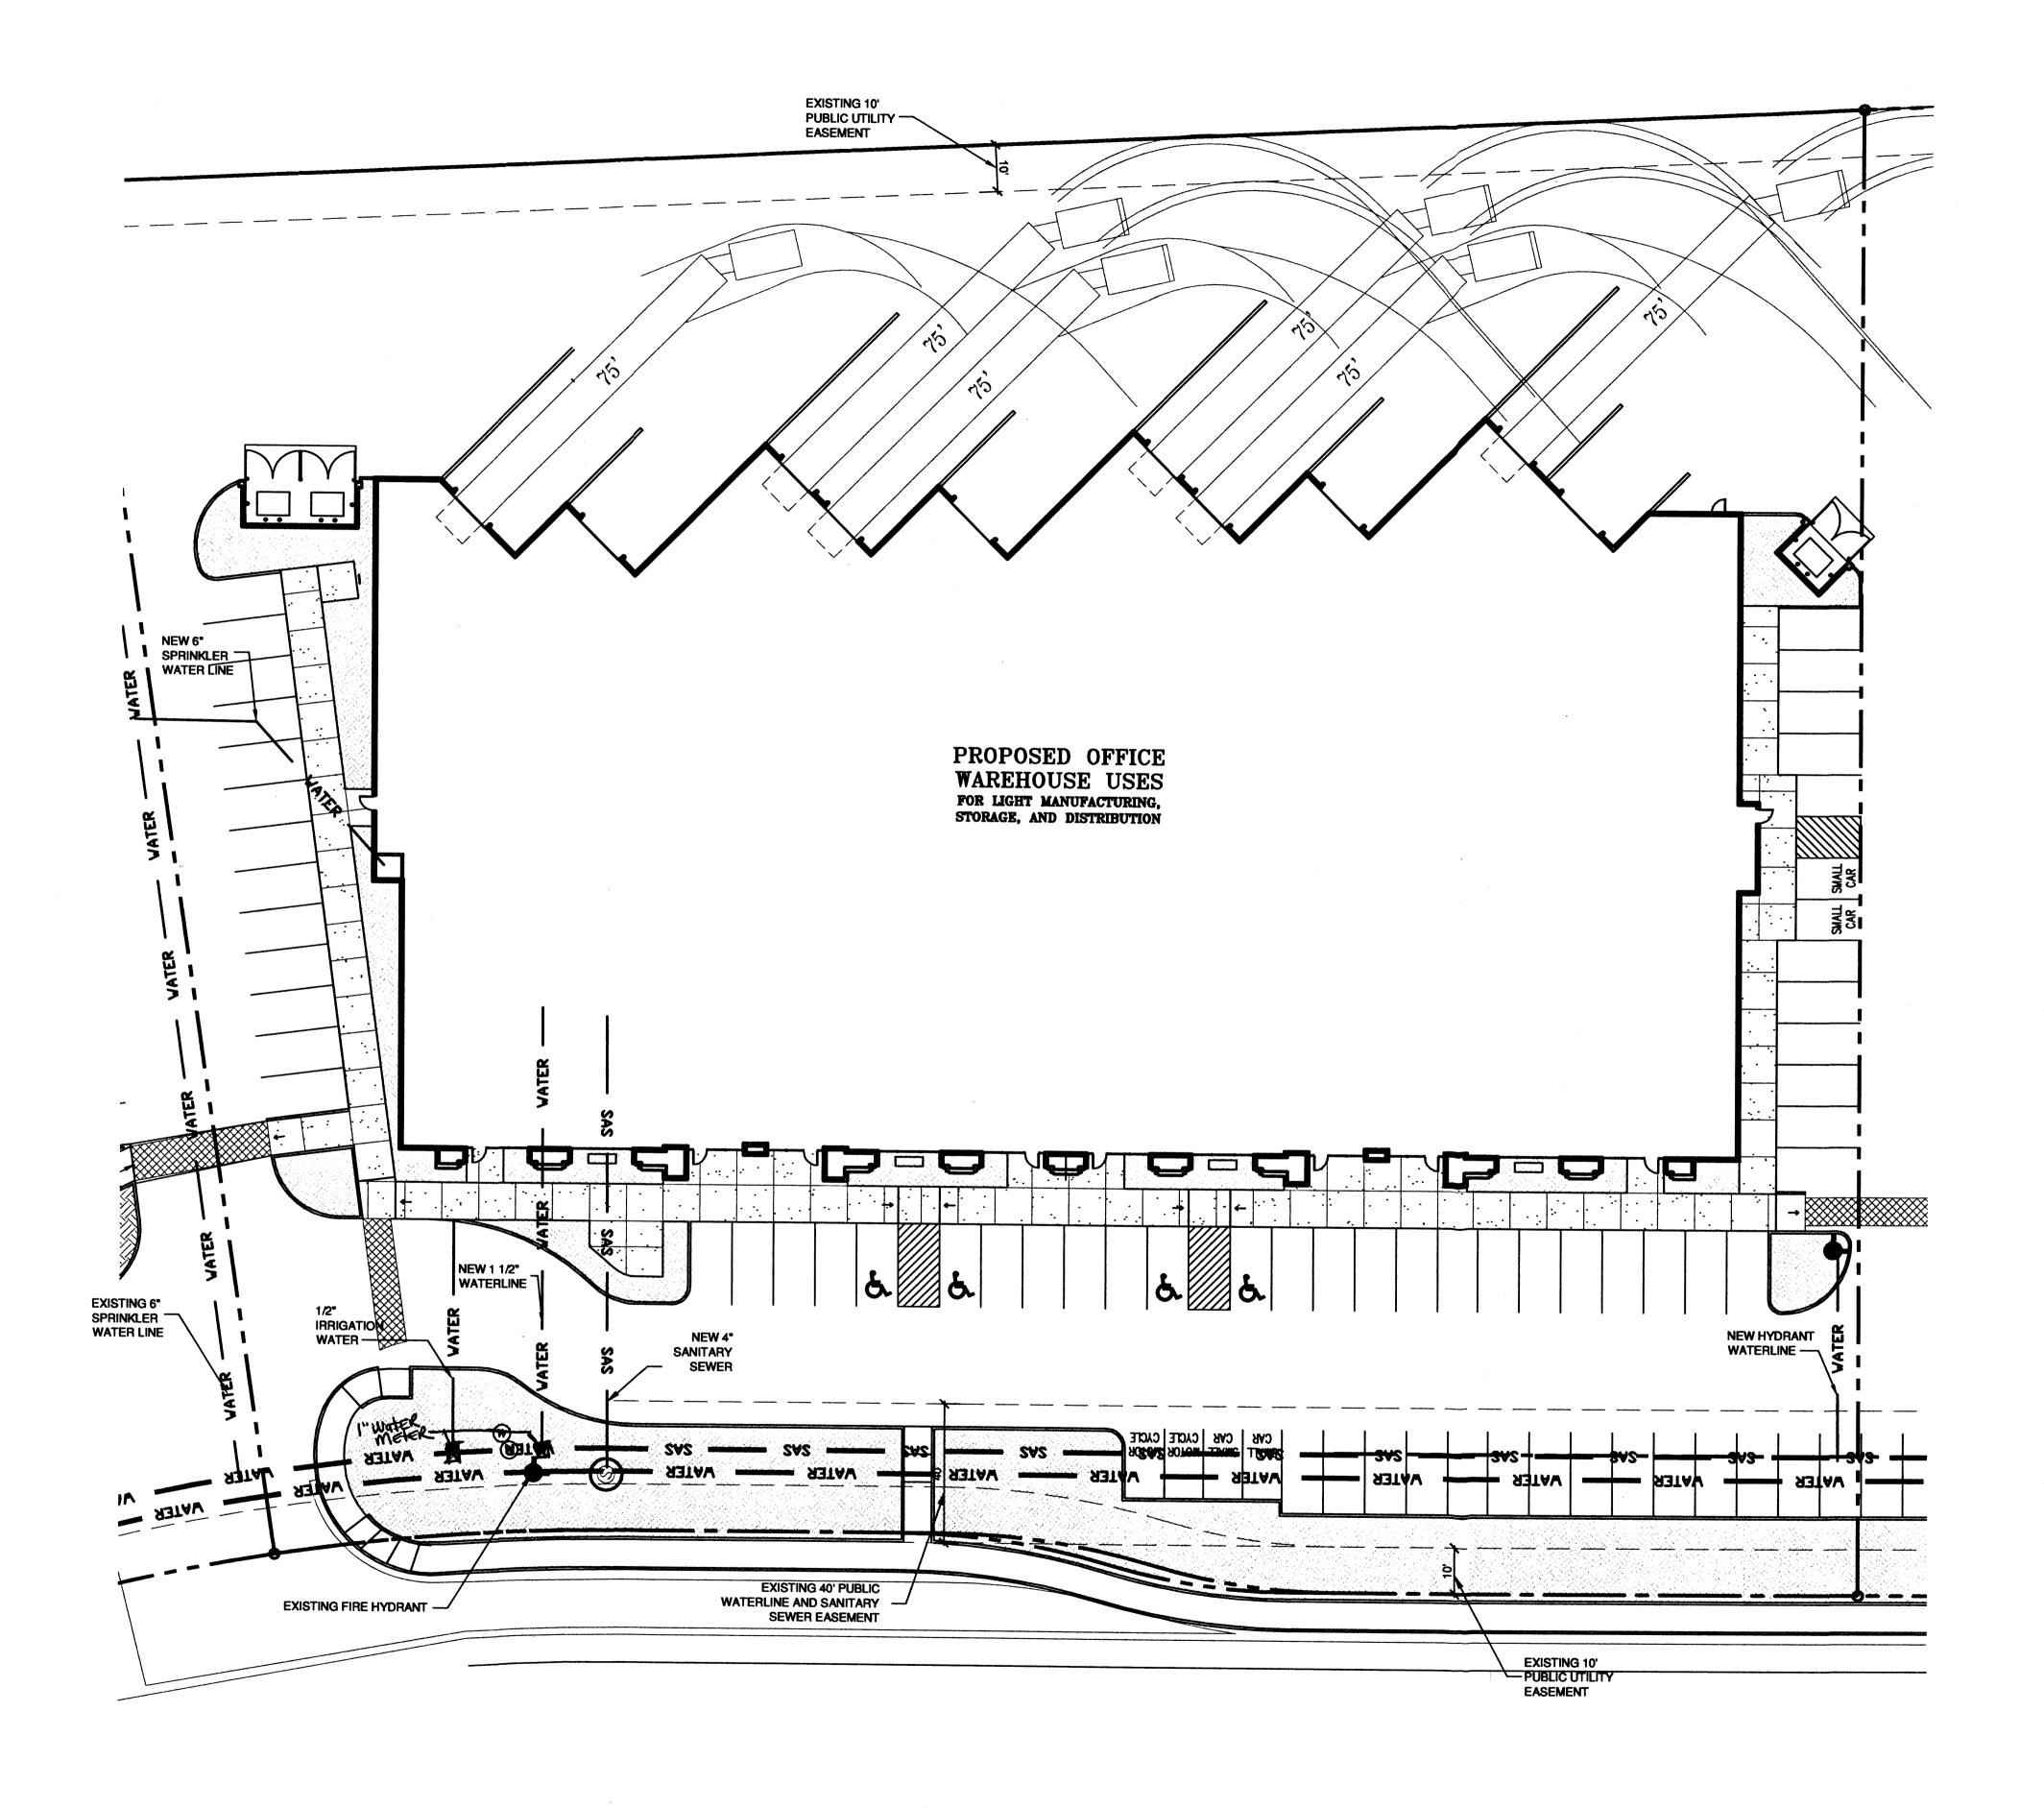



1801 Rio Grande Boulevard, N.W. Albuquerque, New Mexico Phone: (505) 842-1113 Fax: (505) 842-1330

All design concepts, details, specifications, plans, computer files, field data, notes and other documents and instruments prepared by Claudio Vigil Architects, P.C. as instruments of service shall remain the property of Claudio Vigil Architects, P.C. Claudio Vigil Architects, P.C. Claudio Vigil Architects, P.C. shall retain all common law, statutory and other reserved rights, including the copyright thereto.

## CONSULTANTS

VICINITY MAP

— H-15



INDUSTRIAL **PARK BUILDING II** 

**GATEWAY** 

BROADWAY BLVD. NE ALBUQUERQUE, NEW MEXICO

	5 4 4 6 M	
	5.14.07	EPC CONDITIONS
MARK	DATE	DESCRIPTION

PROJECT NUMI	BER: 06065
DRAWING FILE:	
DRAWN BY:	JJF
CHECK BY:	-
COPYRIGHT:	CLAUDIO VIGIL ARCHITECTS 2006
DATE:	OCTOBER 30, 2006

CONCEPTUAL UTILITY PLAN

SHEET NUMBER C-101



SITE PLAN

SU-1 PRIVATE SCHOOL AND INCIDENTAL FACILITIES