Zone Atlas Page: H & J-15-Z

The Site Phase I:

Legal Description:

Lots 1 - 10 within the Town of Albuquerque Grant in Projected Sections 7 and 18. Township 10 North, Range 3 East, New Mexico Principal Meridian, City of Albuquerque, Bernalillo County, New Mexico Address: 1701 Bellamah Ave. N.W.

Zoning: SU-2/SU-1 for PRD Acreage: 7.4628

Legal Description:

Tract 2-D of the Arbolera de Vida subdivision, Albuquerque, New Mexico. filed in the office of the County Clerk of Bernalillo County, New Mexico, on April 11, 2005 in Plat Book 2005C, Page 106 Zoning: SU-2/SU-1 for PRD with Microbrewery

Acreage: 2.5132 Total acreage for both sites is 9.976

Cross access and drainage easements provided.

Phase II site development plans for building permit are delegated to the DRB for approval.

SAMMILL

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Site is being developed in two phases as mixed-use with housing, retail and active space (small rental spaces for artisan and incubator office space). Phase II has two single story Retail buildings and a building with Active Spaces and Apartments above. The following is Phase I development: Lot 2 is ground floor Retail and two floors of Condominiums above. Lot 1 has two buildings with ground floor Active Spaces and Apartments on two floors above. The remaining three buildings on Lot 1 are Apartments on three floors. Lots 3 - 10 are Townhomes (eight total).

C1 and O1 permissive use allowed in PRD up to 25% of Total Gross Floor Area of Development.

> BUILDING AT FL#1 - BREMERY & RESTAURANT

ILLUSTRATIVE BUILDING FOOTPRINTS

EXISTING

POND

BUILDING C FL #1 - ACTIVE SPACES

FL#2 - APARTMENTS (2 LEVELS EACH)

Pedestrian Ingress & Egress

The existing public sidewalk at along 18th Street is extended into the site and continues the length of the property along Bellamah. At the east side of the site is an opening for a potential connection with the adjacent development. A pedestrian trail is connected to this development. Sidewalks and plaza areas provide for on site connectivity and separation from vehicular traffic.

Vehicular Ingress & Egress Primary access is from 18th and Bellamah. A potential connection to Bellamah is provided on the east side of the property.

Internal Circulation Requirements

Access is via drive aisles, 26' and 24' wide. Radii and parking spaces are shown on the Site Plan in compliance with the City D.P.M. An emergency vehicle path is shown from the north parking area across a roll-down curb and the paved plaza. This plan meets the criteria of City Traffic, Fire Marshal, and Solid Waste Department.

Open Space (as defined in Zoning Code 14-16-1-5 and per R2 zone 14-16-2-11-H)

Required: (49 units @ 400 sf/unit) + (62 units @ 500sf/unit) + (63 units @ 600sf/unit) = 88.400 sf

Provided: 125,326 sf (does not include balconies) Phase II

Required: 10 units @ 500sf/unit = 5.000sf

Provided: 29,663 sf (does not include railroad easement or pond)

Maximum Building Heights Buildings A1 and A2: 36' maximum Building B: 48' maximum

Building C: 45' maximum Buildings D1, D2, E1, E2, E3: 45' maximum Townhomes F: 28' maximum

Minimum Building Setbacks:


SCALE: 1" = 50'-0"

(19)

WAREHOUSE

South: 15': East: 30': North: 30': West: 30' Accessory puildings allowed minimum setback of 0' lot line (14-16-3-3)

Residential Development Density: Density shall not exceed 20 DU's per acre.

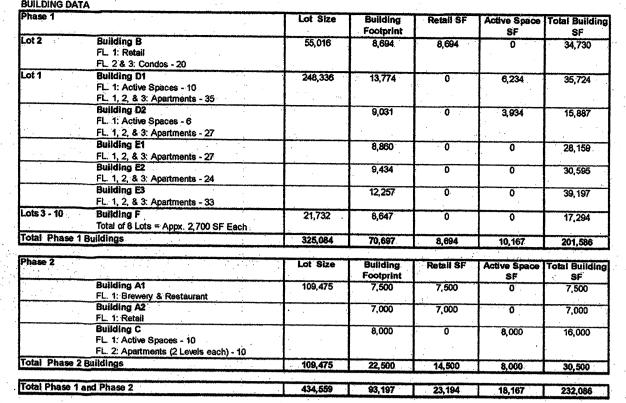

Notes:

1. All Square Footage is Approximate.

2. O-1 + C-1 Permissive Uses = 41,362 SF / Total Building SF (Total Gross Floor Area of Development) of 232,086 = 18%, under 25% allowed in PRD.

		700000000	Motorcycle	Hicycle	Provided.	Proposed Kato	Required Ratio	Require
ums	20				25	1.25/unit	1.5 or > 1000sf =2	- 30
3	146		' ·			1.25/unit		219
					105			219
	-8				16	2/unit	1 per bath	16
dental	174	:	· · · · · · · · · · · · · · · · · · ·		224			265
11								200
					23	3/1000 sq ft	1/200 sq ft	` 39
ces	16				. 16	1/unit	1/200 sq ft	52
Paridontial	46	-						
residential	10							.81
		10		99				358
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	dental ces Residential	3 146 8 dental 174 ces 16	3 146 8 dental 174 ces 16 Residential 16 10	3 146 8 dental 174 ces 16 Residential 16 10 8	3 146 8 8 dental 174 ces 16 Residential 16 10 8 88	183 184 185 186 187 188 188 188 188 188 188 188 188 188	146 183 1.25/unit 8 16 2/unit dentai 174 224 23 3/1000 sq ft 16 11/unit Residentiai 16 39 16 16	146 183 1.25/unit 1.5 or > 1000sf = 2 8 16 2/unit 1 per bath dental 174 224 ces 16 23 3/1000 sq ft 1/200 sq ft

RESIDENTIAL

GENERAL NOTES

- A. All existing Structures, Paving, Fencing, Walls, Foundations; Sidewalks, to be Demolished and
- B. Accesible curb cuts and ramps provided throughout

- C. Phase I: All development on Lots 1-10 D. Phase II: All development on Phase II
- E. See Plat for all easements.

KEYED NOTES


- 1. Property line, Typ. 2. Lot line, Typ.
- 3. New site drive per COA Std. Dwg. 2426.
- 4. Drainage pond, see Conceptual Grading Plan 5. Existing sidewalk to remain
- 6. Concrete sidewalk, 4' wide minimum (see plan), per COA Std. Dwg. 2430.
- 7. Asphalt Drive, Aisle and Parking Spaces 8. Entry feature from salvaged site metal/equipment.
- 9. 45° Parking space per D.P.M. Figure 23.7.1
- 10. Landscaping, typ. (See Landscape Plan) 11. 18"X18" Stop Sign
- 12. Future connection to Bellamah Street
- 13. Not used.
- 14. Decorative paving
- 15. Plaza extended over pond w/guardrail surround 16. Pedestrian passageway
- 17. Building overhang with columns
- 18. Plaza, w/ decorative paving & landscaping
- 19. Relocated steel Sawdust Hopper
- 20. Accessible parking space, 82 W. x 20 L. space W/5
- 21. Accessible van parking, 9' W. x 20' L. space W/ 9' W.
- 22. Standard parking space, 8½ W. x 20 L., typ.
- (18' L. where perimeter landscape strip) 23. Building on adjacent property (more than 20' from property line)
- 24. Motorcycle space, 4' W. x 8' L. min., typ.
- 25. Single refuse containers, enclosure & concrete
- 26. Double refuse containers, enclosure and concrete


SHEET INDEX:

- Site Development Plan for Subdivision SDP2 Landscape Plan
- SDP3
- Design Standards & Context Graphic SDP4 Buildings D & E Elevations
- SDP5 **Building B Elevations** SDP6 **Building F Elevations**
- SDP7 Not Used Conceptual Grading Plan SDP9 Conceptual Drainage Management Plan SDP10
- Conceptual Utility Plan 27. Mountable roll curb for emergency vehicle access
- 29. Parallel parking, typ. 30. 10' wide minimum landscape setback W/6' high planted open fencing
- 31. Existing power pole to be removed
- 32. Gravel with roll-up curb for emergency vehicle traffic. 33. Bicycle rack
- 34. Vehicle back-up space 35. Sidewalk connection to pedestrian trail on adjacent

28. Patio enclosure, 5' high maximum, typ.

- property 36. Not used.
- 37. 12' L. mountable roll curb for utility vehicle access 38. Backyard walls, 6' high maximum
- 39. Dedicated back-up space (No Parking) 40. Curb. 3' wide planting strip, and 6' wide sidewalk.
- 41. Existing power pole to remain. 42. Open steel tube fence, 6' high, to match fence at
- Sawmill Lofts.
- 43. Existing railroad tracks 44. Open metal fence w/vines
- 45. Compact parking space, 8'W. x 15'L., typ. Paint
- "Small Car Space" on pavement. 46. 6' high decorative wall
- 47. Sidewalk at west edge of diagonal parking curb to be
- constructed in Phase II 48. New location of power pole 49. Townhome driveway with apron at sidewalk to allow
- vehicle access 50. 26' public access easement at drive aisle starting
- east at Bellamah connection and south to 18th
- 51. Proposed future recycling area. 52. 24' wide access easement at drive aisle; starts south

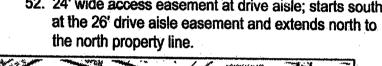

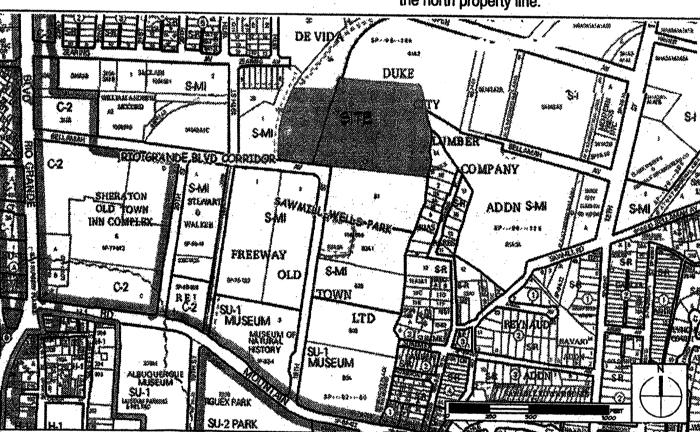

ZONING ATLAS PAGE: H&J-13-Z PROJECT NUMBER: 1005354

Application Number

This plan is consistent with the specific Site Development Plan approved by the Environmental Planning Commission (EPC), dated 03/16/2007 and the Findings and Conditions in the Official Notification of Decision are satisfied.

Is an Infrastructure List required? () Yes () No If yes, then a set of approved DRC plans with a work order is required for any construction within Public Right-of-Wayor for construction of public improvements.

DRB SITE DEVELOPMENT PLAN SIGNOFF APPROVAL:

7-11-07 Fraffic Engineering, Transportation Division 7/11/07 - حاليات Parks and Recreation Departmen *Environmental Heath Department (conditional) 7/10/07 DRB Chairperson, Panning Department ESPLANS CHECKING OFFICE 924-3617

*Environmental Health, if necessary

7601 Jefferson NE Suite 100 Albuquerque, NM 87109 505 761-9700 fax 761-4222 dps @ dpsdesign.org ARCHITECT

architecture

interiors

planning

engineering

SUBMITTAL 7/3/07

treet S Mexico ige 8th venu Albuquerque Bellamah


DRAWN BY BB, DM, MS, CM REVIEWED BY DATE

PROJECT NO. DRAWING NAME SITE DEVELOPMENT PLAN FOR

SUBDIVISION

SHEET NO.

site Acress

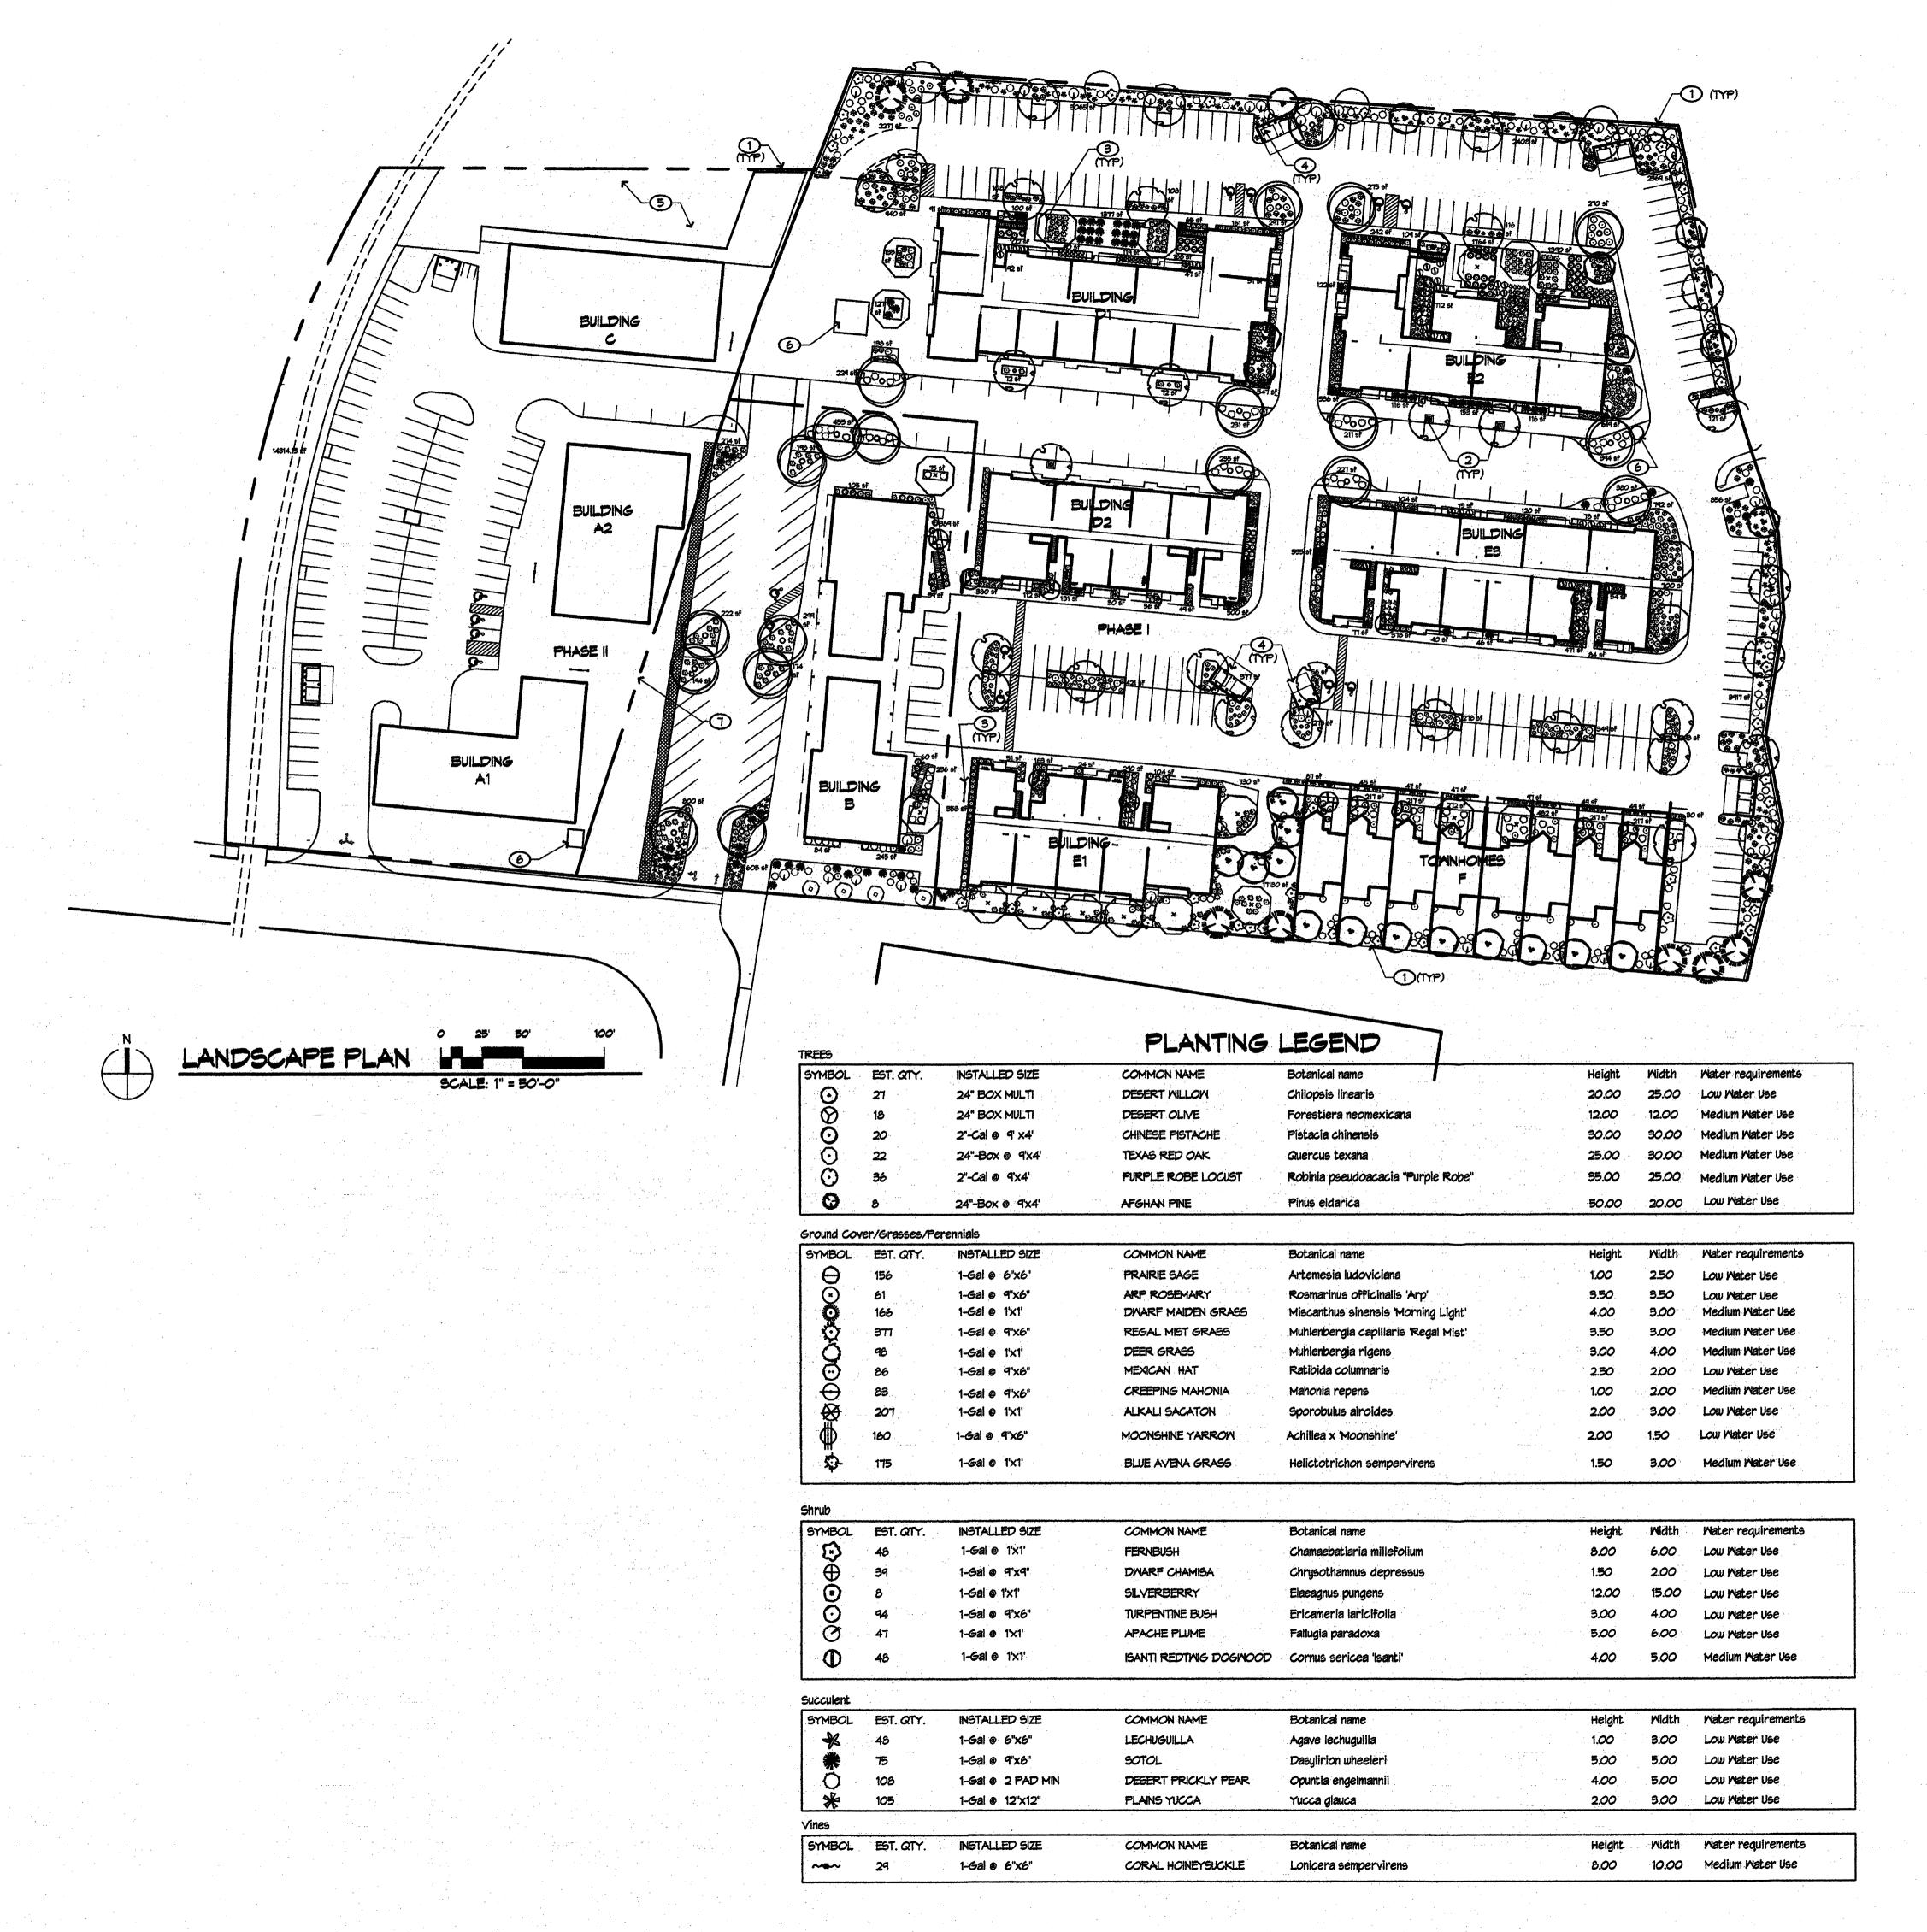

GENERAL NOTES

 CONTACT THE LOCAL UNDERGROUND UTILITY SERVICES FOR UTILITY LOCATION AND IDENTIFICATION.

2. REFER TO CIVIL ENGINEER'S UTILITY, EASEMENT AND GRADING PLANS FOR UTILITY LOCATION, EXISTING AND PROPOSED EASEMENTS AND GRADING.

3. SEE SITE PLAN FOR DESCRIPTIONS OF HARD ELEMENTS SUCH AS PAVING TYPES, SITE FURNISHINGS AND SITE ELEMENTS.

IRRIGATION NOTES

1. IRRIGATION DESIGN SHALL COMPLY WITH THE INTENT OF THE CITY OF ALBUQUERQUE WATER CONSERVATION, LANDSCAPING AND WATER WASTE ORDINANCE.

2. INSTALLATION AND MAINTENANCE OF IRRIGATION SHALL BE THE RESPONSIBILITY OF THE PROPERTY OWNER.

3. THE IRRIGATION SYSTEM SHALL BE RUN WITH A FULLY AUTOMATED IRRIGATION CONTROLLER. RUN TIME SHALL BE ADJUSTED ACCORDING TO SEASON, LOCATION AND PLANT PERFORMANCE. DRIP EMITTERS SHALL BE USED FOR ALL PLANT MATERIAL EXCEPT SOD AND POSSIBLY PERENNIAL GROUNDCOVERS. THESE AREAS SHALL BE IRRIGATED WITH SPRAY EMITTERS APPROPRIATELY DESIGNED TO AVOID OVERSPRAY ONTO IMPERMEABLE SURFACES AND ADJACENT PAVING.

4. THE USE OF HIGH WATER USE PLANT MATERIALS SHALL BE LIMITED.

5. POINT OF CONNECTION: A CONNECTION TO POTABLE WATER FOR IRRIGATION PURPOSES WILL BE MADE ON THE PROPERTY. VALVE BOXES AND EQUIPMENT SHALL BE SHIELDED FROM VIEW.

KEYED NOTES

PROPERTY LINE

TREE IN 36 SF TREE GRATE PER GENERAL REG 14-16-3-10, G.1.C. BIKE RACK.

DUMPSTER ENCLOSURE.
 PROPOSED POND SEE CIVIL ENGINEER'S DRAWINGS.

6. FOCAL POINT, SEE SITE PLAN.

1. PHASE DELINEATION LINE.

LANDSCAPE CALCULATIONS

SITE AREA: 434,559 (PHASE 1: 325,084 SF, PHASE 2: 109,475 SF)
BUILDING FOOTPRINT: 93,197 SF
NET SITE AREA: 341,362 SF

REQUIRED LANDSCAPE AREA: 51,204 SF (15% OF NET LOT AREA)
PROVIDED LANDSCAPE AREA: T7,661 SF (25% OF NET LOT AREA))
PHASE 1: 60,233 SF
PHASE 2: 17,428 SF

REQUIRED OFF-STREET PARKING TREES: 38 TREES
PROVIDED OFF-STREET PARKING TREES: 46 TREES
PHASE 1: 36 TREES
PHASE 2: 10 TREES (ASSUMED).
REQUIRED MULTI-FAMILY RESIDENTIAL TREES: 83 TREES
PROVIDED MULTI-FAMILY RESIDENTIAL TREES: 85 TREES
PHASE 1: 80 TREES
PHASE 2: 5 TREES (ASSUMED).

PROVIDED HIGH WATER USE TURF AREA: 0 SF (0%)
ALLOWED HIGH WATER USE TURF AREA: 10,195 SF (20%)

PLANTING NOTES

1. LANDSCAPE DESIGN:

THE PLANTING DESIGN INCLUDES A DIVERSE PALETTE OF DESERT AND HIGH DESERT PLANTS THAT WILL COMPLIMENT THE ARCHITECTURE OF THE PROJECT. THE INTENT IS TO REINFORCE A SENSE OF PLACE WITH PLANTS THAT ARE APPROPRIATE TO ALBUQUERQUES CLIMATE AND LOCALE. GRASSES AND ACCENT PLANTS SUCH AS YUCCA AND SOTOL WILL BE USED IN HIGHLY VISIBLE AND APPROPRIATE LOCATIONS. LANDSCAPE DESIGN WILL COMPLY WITH THE INTENT OF THE CITY OF ALBUQUERQUE WATER CONSERVATION, LANDSCAPING AND WATER WASTE ORDINANCE AND 14-16-3-10 OF THE CITY OF ALBUQUERQUE GENERAL REGULATIONS.

2. EXISTING PLANT MATERIAL:
THERE IS SOME LARGE SIZE VEGETATION ON THE SITE, HOWEVER IT IS OF POOR QUALITY AND WILL BE REMOVED. THE SITE HAS
BEEN DISTURBED, OTHER EXISTING VEGETATION IS COMPRISED OF GRASSES AND FORBS AT LOW DENSITIES.

3. PLANTING INSTALLATION AND MAINTENANCE SHALL BE THE RESPONSIBILITY OF THE PROPERTY OWNER INCLUDING AND REPLACEMENT OF NON-SURVIVING PLANTS WITHIN 90 DAYS.

4. LANDSCAPE BEDS SHALL ACHIEVE A MINIMUM 80% LIVE VEGETATIVE COVERAGE UPON PLANT MATURITY.

5. MULCH: ALL LANDSCAPE AREAS, EXCEPT FOR SODDED AREAS, SHALL BE COVERED WITH 2" OF ROCK MULCH IN ORDER TO MINIMIZE WEED GROWTH, ADD VISUAL INTEREST, AND PROTECT SOIL MOISTURE. COLOR TO BE DETERMINED. SEE PLAN FOR LOCATION.

6. CONTRACTOR SHALL VERIFY PLANT COUNTS AND SQUARE FOOTAGES. THIS INFORMATION IS PROVIDED AS OWNER INFORMATION ONLY. IF QUANTITIES ON PLANT LIST DIFFER FROM PLAN INDICATIONS, PLAN QUANTITIES SHALL PREVAIL.

7. EXACT LOCATION OF PLANT MATERIALS SHALL BE APPROVED BY THE ARCHITECT IN THE FIELD PRIOR TO INSTALLATION. THE ARCHITECT RESERVES THE RIGHT TO ADJUST PLANT PLACEMENT IN THE FIELD. DENSITIES AND OVERALL COUNT OF PLANTS SHALL MEET OR EXCEED THOSE SHOWN ON APPROVED PLAN.

8. ORGANIC SOIL BIOLOGY AMENDMENT SHALL BE APPLIED IN ALL TREE AND PLANT PITS.

9. PLANTS WITH SPINES WILL BE PLANTED 5' FROM WALKS.

planning engineering

Dekker Perich Sabatini

> 7601 Jefferson NE Suite 100 Albuquerque, NM 87109 505 761-9700 fax 761-4222 dps@dpsdesign.org

440.44

ENGINEER

DRB SUBMITTAL 7/3/07

PROJECT

Sawmill Village ellamah Avenue & 18th Stree Albuquerque, New Mexico

REVISIONS

DRAWN BY

DRAWN BY MRC
REVIEWED BY MRC

DATE
PROJECT NO. 06124

DRAWING NAME

LANDSCAPE PLAN

SHEET NO.

SDP2

Design Standards for Planned Residential Development (PRD)

Overall Design Theme and Land use Concept:

The purpose of these design standards is to establish a development framework for the area shown on the site development plan for subdivision. These design standards will create an attractive and innovative development that fosters a mixed-use community for residents, artisans and other small business owners, and retailers and their clients. The new community respects the history of the site (former lumber yard), the neighborhood (historic Sawmill and Old Town), and the City. It also allows for the privacy and well-being of the residents and other users. This mix of uses is unique to the City. These standards are complementary to the existing and new design of adjacent properties.

The housing will be affordable rental, and for-sale condominiums and townhome units (an agreement between Sawmill Community Land Trust & the developer allows for up to 20% of condominiums and townhomes to be affordable units). The Active Spaces will be short-term leased to artisans and incubator companies. Service-oriented Retail spaces might be a health club, management leasing office, and other small businesses. Phase II is envisioned with a restaurant with a small brewery, other retailers, and more Active Spaces with apartments above. Green and sustainable building practices shall be incorporated: passive interception of surface water in parking lot landscape surfaces, xeric planting, directing roof water from downspouts to landscape areas when feasible, Energy Star appliances, and some materials with recycled content.

The sawdust hoppers from the site will be relocated and used as site monuments (see 14-6-3-3 in the Zoning Code). The largest hopper is approximately 75' tall, including its sawdust attachments. Site monuments shall comply with regulations applicable to signs within 40 feet of residential zones and to signs in the O-1 zone, specifically:

- the monuments shall not be on the public right-of-way;
- no part of the monument shall move, flash, or rotate;
- any illumination shall comply with the City's Dark Sky requirements;
- no illuminated portion of the monument shall have a luminance greater than
 200 footlamberts at night nor change its illumination more than once an hour.

Various plazas serve both residents and visitors. Semi-private spaces for the residents are shown in the inner areas of the site and residents have private patios, courtyards, balconies, decks or roof decks. Salvage of steel and metal from the site's previous life as a lumber yard will be used on site as signage, markers, and sculpture.

All units that face property zoned industrial shall have sound reducing insulation and windows.

The Planning Director in accordance with the Albuquerque Comprehensive City Zoning Code shall approve minor amendments to this Site Plan for Subdivision. The Environmental Planning Commission shall approve major amendments to this Site Development Plan for Subdivision. Phase II site development plans for building permit are delegated to the DRB for approval.

Off-Street Parking:

Off-street parking space shall be provided in compliance with other similar mixed-use and infill developments. The site is designed as a shared parking environment for both residential and commercial uses. Parking space design is in compliance with regulation 14-16-3-1. Each townhome has a single-car garage and driveway parking for a second car. See SDP1 for Parking Calculation.

The guidelines also apply to disabled parking, and motorcycle and bicycle parking. Secure bicycle storage racks shall be conveniently located near building entrances. The minimum number of bicycle racks shall be determined by the number of parking spaces provided. Bicycle racks shall be constructed of metal and finished in colors harmonious with those of the buildings on site.

Architectural Design Guidelines:

Landscape

The landscape design for Phase I and Phase II of the project will strive to engage the users by providing a welcoming environment for the residents and public. Through the use of xeric plants outdoor spaces will have seasonal color, texture and scale and will compliment the architecture. Trees will be used to provide shade in pedestrian areas, highlight intersections and establish hierarchy of streets. Accent plants will be used to emphasize entries and provide sculptural interest. The remainder of the plant palette will be a mixture of shrubs, ornamental grasses and groundcovers. The landscape design will comply with the intent of the city of Albuquerque Water Conservation, Landscaping and Water Waste ordinance and 14–16-3-10 of the city of Albuquerque General Regulations.

A landscape plan for Phase II shall be included with the (first) site development plan for building permit of a building on the Phase II property, reflecting the calculations, plant palette and design theme of the approved Phase I landscape plan.

Exterior Wall Materials and Colors

Exterior wall materials reflect the vernacular in the Sawmill neighborhood, the previous lumber mill and its industrial buildings and geometric forms, and a modern blend of both.

Articulation of massing so as not to produce a long and flat building facade shall be considered and encouraged. Contemporary colonnades and portals provide shade and cover to the occupant and pedestrian and enrich the building planes with light changes. They further promote pedestrian site access and a place for people to work and socialize. The possible salvage of steel building frames could provide some of the columns and recall the former use of the site.

Stucco wall finish system (or synthetic version) reinforces the vernacular architectural expression as do metal wall panels, corrugated steel, rusted steel, and stained cement panels. Exterior wall color shall reflect a consistent overall palette of earth and sky-based tones, both pale and saturated with color, as is the palette from nature.

In Phase I the apartment buildings (D and E) will use a stucco wall finish system and metal wall panels in addition to metal shading devices. Color will be medium and deep earth tones, warm gray, and the metal will be silver with another accent color.

Building B will include red oxide painted metal shading devices. Structural steel columns that comprise the arcade along along the east and west face of the first floor retail spaces will also be red oxide color. Stucco colors of raw sienna, terracotta, indigo blue, and burnt ochre work in conjunction with the grouping of the building's different masses. Stairs and balconies have steel railings. They are in keeping with the industrial reference to the Sawmill district as are the aluminum framed windows and doors.

The townhomes will incorporate two stucco colors, light ochre and medium grey green along with terracotta stained cement board panels that will break up the facade texturally as well

Active Spaces are shown with aluminum framed overhead sectional doors or large windows. The purpose of these is to open those spaces to the public either by an artisan that may want to open an overhead door to share his or her craft or via a large window to provide both views in and out. (Overhead doors are not provided for vehicle access.)

Exterior detail trim such as shade canopies and louvers, trellises, and open railings shall be consistently detailed for each building to complement the overall architecture.

Phase II buildings will follow the same palette of materials and colors as Phase I.

Roof materials and colors

Rooflines shall be reminiscent of the turn of the century neighborhood roofs, including the simple pitches of the industrial ghosts, or clean line parapets. Apartment buildings will have low heat absorbing "flat" roofs hidden behind parapets. The retail-condos building will have a low slope roof and parapets all around. The roof will be a low heat absorbing single ply material in a light color that will help reduce heat gain in the building. Roofs on the townhomes will be low heat absorbing single ply roof material that will help reduce heat gain in the homes. Some townhome roofs are sloped (pitch ranges from 2:12 - 5:12). Phase II buildings will follow the same range of roof lines, materials and colors as Phase I.

Site Lighting

In order to enhance the safety, security, and visual aesthetics, careful consideration must be given to both the daytime and nighttime appearance of the lighting design and fixtures. The primary design objective of the site lighting system shall be to maximize public safety while not affecting adjacent properties, buildings, or roadways with unnecessary glare or reflection. In order to accomplish the lighting goals, the following guidelines shall be required for the design of the lighting system:

- Placement of fixtures and standards shall conform to state and local safety and illumination standards.
- All lights shall be shielded source to prevent spillage onto adjoining properties or light pollution of the existing "dark sky". Fixtures shall comply with the City of Albuquerque's Dark Skies requirements.

 The beinds of standard and interest in the light shall be least to the light of the light of the light.
- The height of street lights and parking area lights shall be kept to the minimum necessary to meet safety requirements.
- Individual site lighting standards shall blend with the architectural character of the buildings and other site fixtures.
- Perimeter parking (north and northeast in Phase I, west perimeter in Phase II): 25' high maximum pole with cutoff features provided that the lighting fixture does not directly shine on any residential premises.
- Other parking: 16' high maximum pole
 Buildings and adjacent pedestrian areas: Building mounted fixtures, bollards.

Placement of Mechanical Units

Care shall be made to hide the view of exposed mechanical units, riders, and other equipment from the ground directly adjacent to the building whenever possible, whether roof or pad mounted units are used. Ground level units shall be screened from public view through free-standing dense evergreen foliage or on "green walls". Roof mounted units shall be screened from public view through the use of parapet walls or roof screens that are architecturally coordinated with the building they serve.

Signage

The following standards were developed to regulate the size, location, type and quality of sign elements within the overall development. The goal is to provide consistency in appearance and quality, and compliments the visual character of the development.

- earance and quality, and compliments the visual character of the development.
 All signs shall comply with section 14-16-3-5 General Sign Regulations of the Zoning Code.
- Signs identifying the principal use of a building may be free-standing or wall-mounted. Signs identifying the use of an active or other commercial space within the building shall be wall-mounted or banner-type sign that projects no more than half of the adjacent sidewalk width.
- The design of the interior directional signs shall be coordinated with the design of the site signage.
- design of the site signage.
- No illuminated plastic panel signs are allowed.

Screen Walls and Fences

Site fencing will be designed to comply with section 14-6-3-19 in the Zoning Code to be harmonious with the development & adjacent properties.

"Green walls" - 6' high open metal fencing with plant material growing on or adjacent - will be used in all possible locations including the East and North site perimeter. The color will be neutral so as to harmonize with the plant material. Fencing along the Railroad line will be similar to the adjacent Sawmill Lofts - 6' high open metal picket painted in a neutral color. At the extended plaza area at the pond, similar material and color will be used as guardrails.

Patio walls shall reflect the same use of stucco finish to complement that of the buildings, or may contrast the building finish by use of metal fencing (rail or solid) to articulate semi-private patios and balconies. Patio walls shall not exceed 5'. Color shall be harmonious with the adjacent building.

Townhome yard separation walls will be a composite of cmu wall with stained cement board in a metal frame above the cmu. It will be stained and painted terracotta which is also used on the homes. Back yard walls shall not exceed 6'.

The west, south, and east sides of the detention pond will be fenced to the property line with a steel open rail fence or guardrail. These fences and guardrails will be painted a neutral color.

The decorative wall on the north side of the plaza will be constructed, in part, of industrial salvage materials from the site. Other possible materials are metal, cmu (not standard grey), and stucco. This wall will serve as the backdrop for the main gathering space and will recall the former life of the site.

The effective use of screening devices for utilitarian spaces, such as refuse areas, is critical to creating an attractive and functional development. The site orientation of these elements shall be placed away from public rights of way to the extent practical. Materials shall be chosen from cmu (not standard grey), stucco, and metal in colors harmonious with the adjacent buildings.


Trails and Sidewalks

Public and private walks provide important connectivity within the project as well as in and out of the site.


- The eastern edge of the site will join a pedestrian path providing for both off and on-site connectivity to recreation and facilities. All private trails and paths shall be soft surface, with a minimum of 5'-0" width. The use of asphalt is discouraged. Concrete or compacted crusher fines with stabilizer are acceptable materials.
- All hard surface pedestrian paths shall be designed to be handicapped accessible, except where topography makes this unfeasible.
- Pedestrian crossings shall be clearly demarcated with contrasting paving treatment.

Public Open Space

An important design of this mixed-use community is the inclusion of plazas: opportunities for residents to meet their neighbors and visitors to the site. The plazas are designed to provide quiet space in the shade for an individual, for a group listening to a local musician, and for a community-wide growers' market. The public areas are varied in size and character and will be suited to the same variety of interests. Open plazas and commercial areas shall have seating & shade covering a minimum of 25% of the area per 14-16-3-18 (c) (4) in the zoning code.

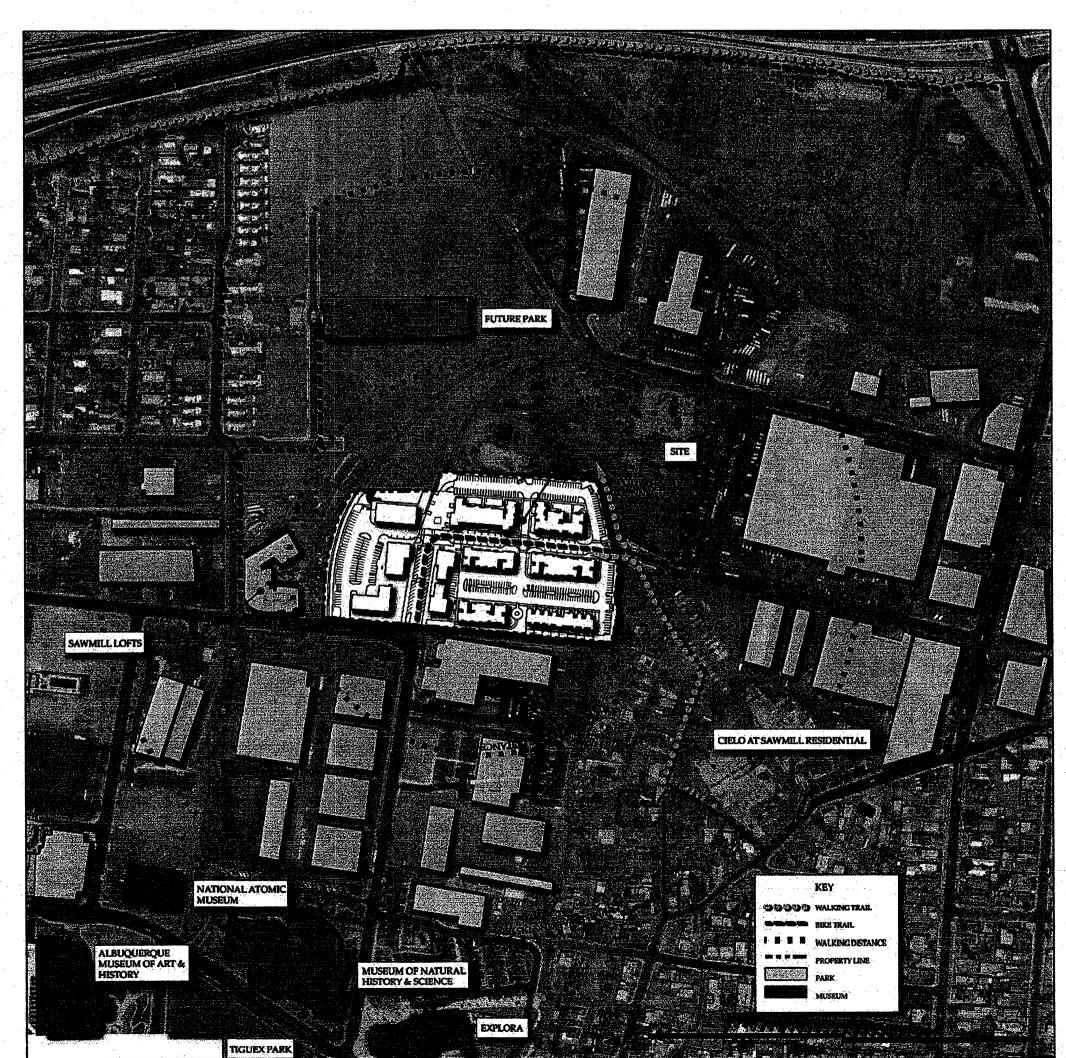

Context and Pedestrian Connections

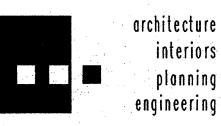

Dekker Perich Sabatini

> 7601 Jefferson NE Suite 100 Albuquerque, NM 87109 505 761-9700 fax 761-4222 dps@dpsdesign.org

ARCHITECT

ENGINEER

DRB SUBMITTAL

7/3/07

PRO IFCT

Sawmill Village

Sellamah Avenue & 18th Street

DRAWN BY CM, RW, MS
REVIEWED BY CM


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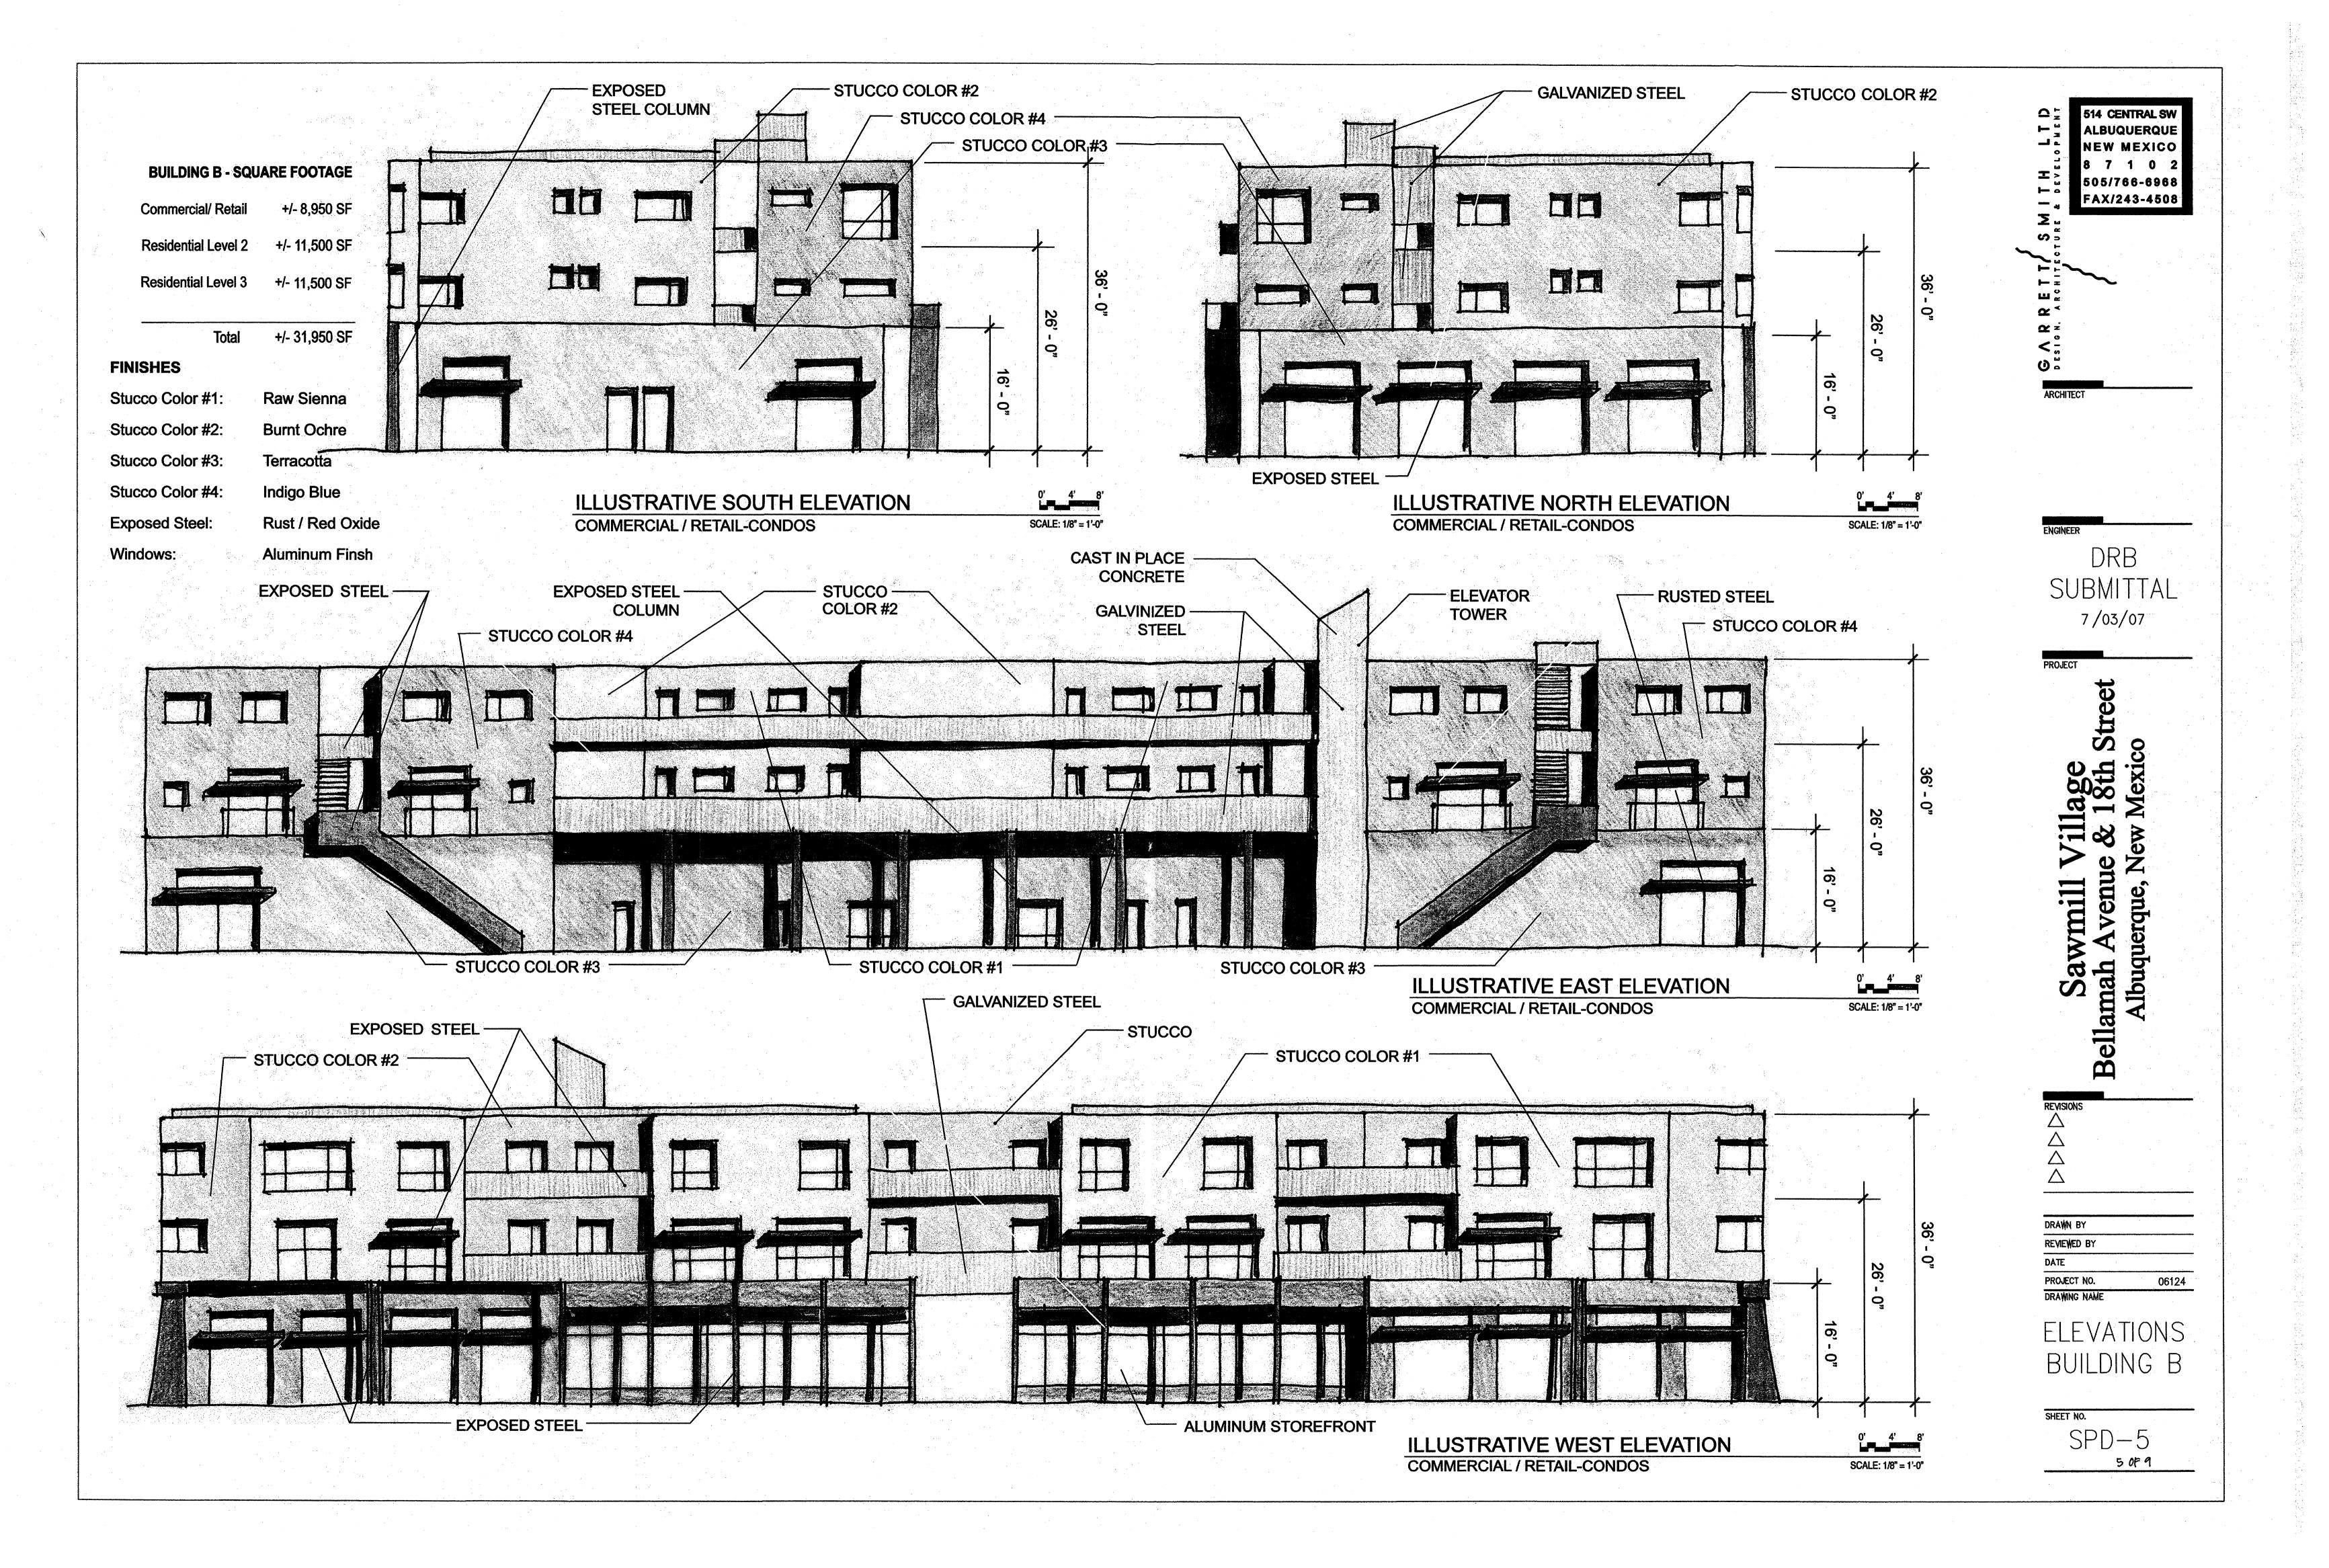
PROJECT NO. 06124


DEVELOPMENT
DESIGN STANDARDS,
CONTEXT GRAPHIC


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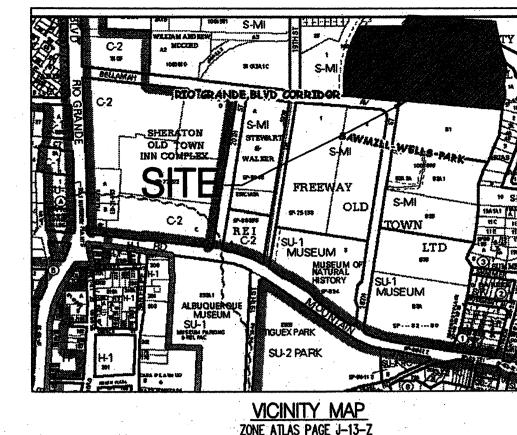







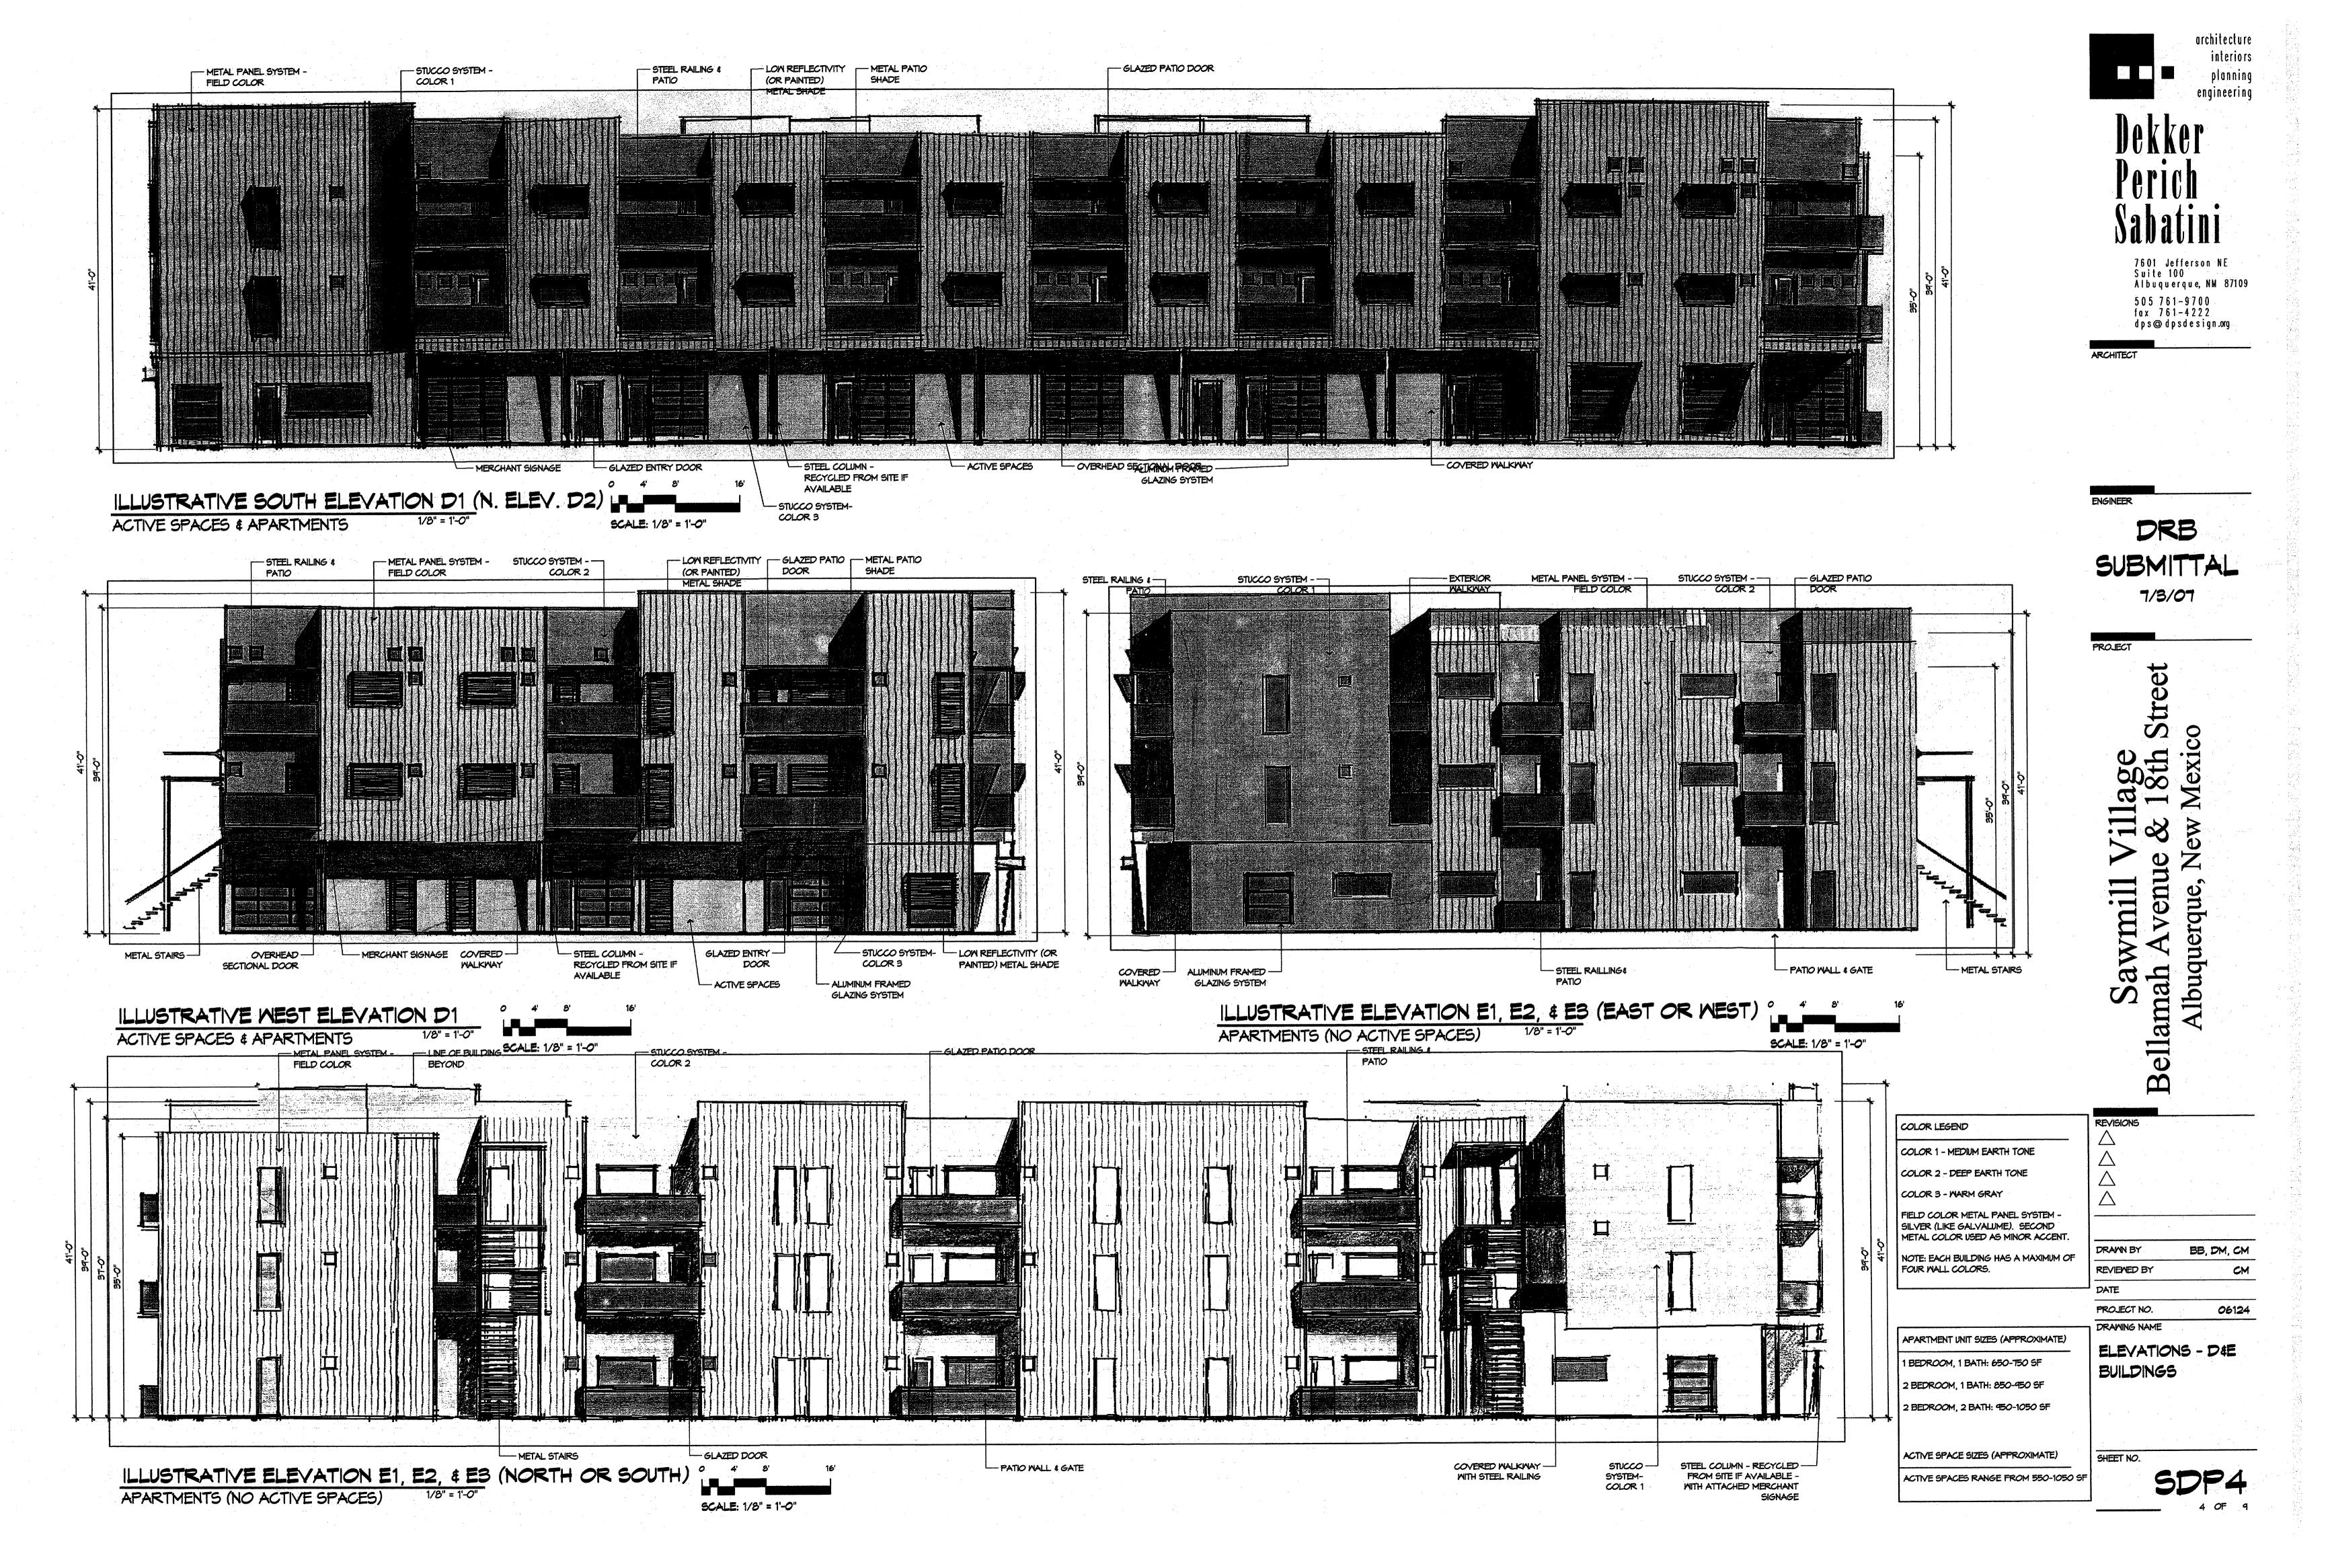

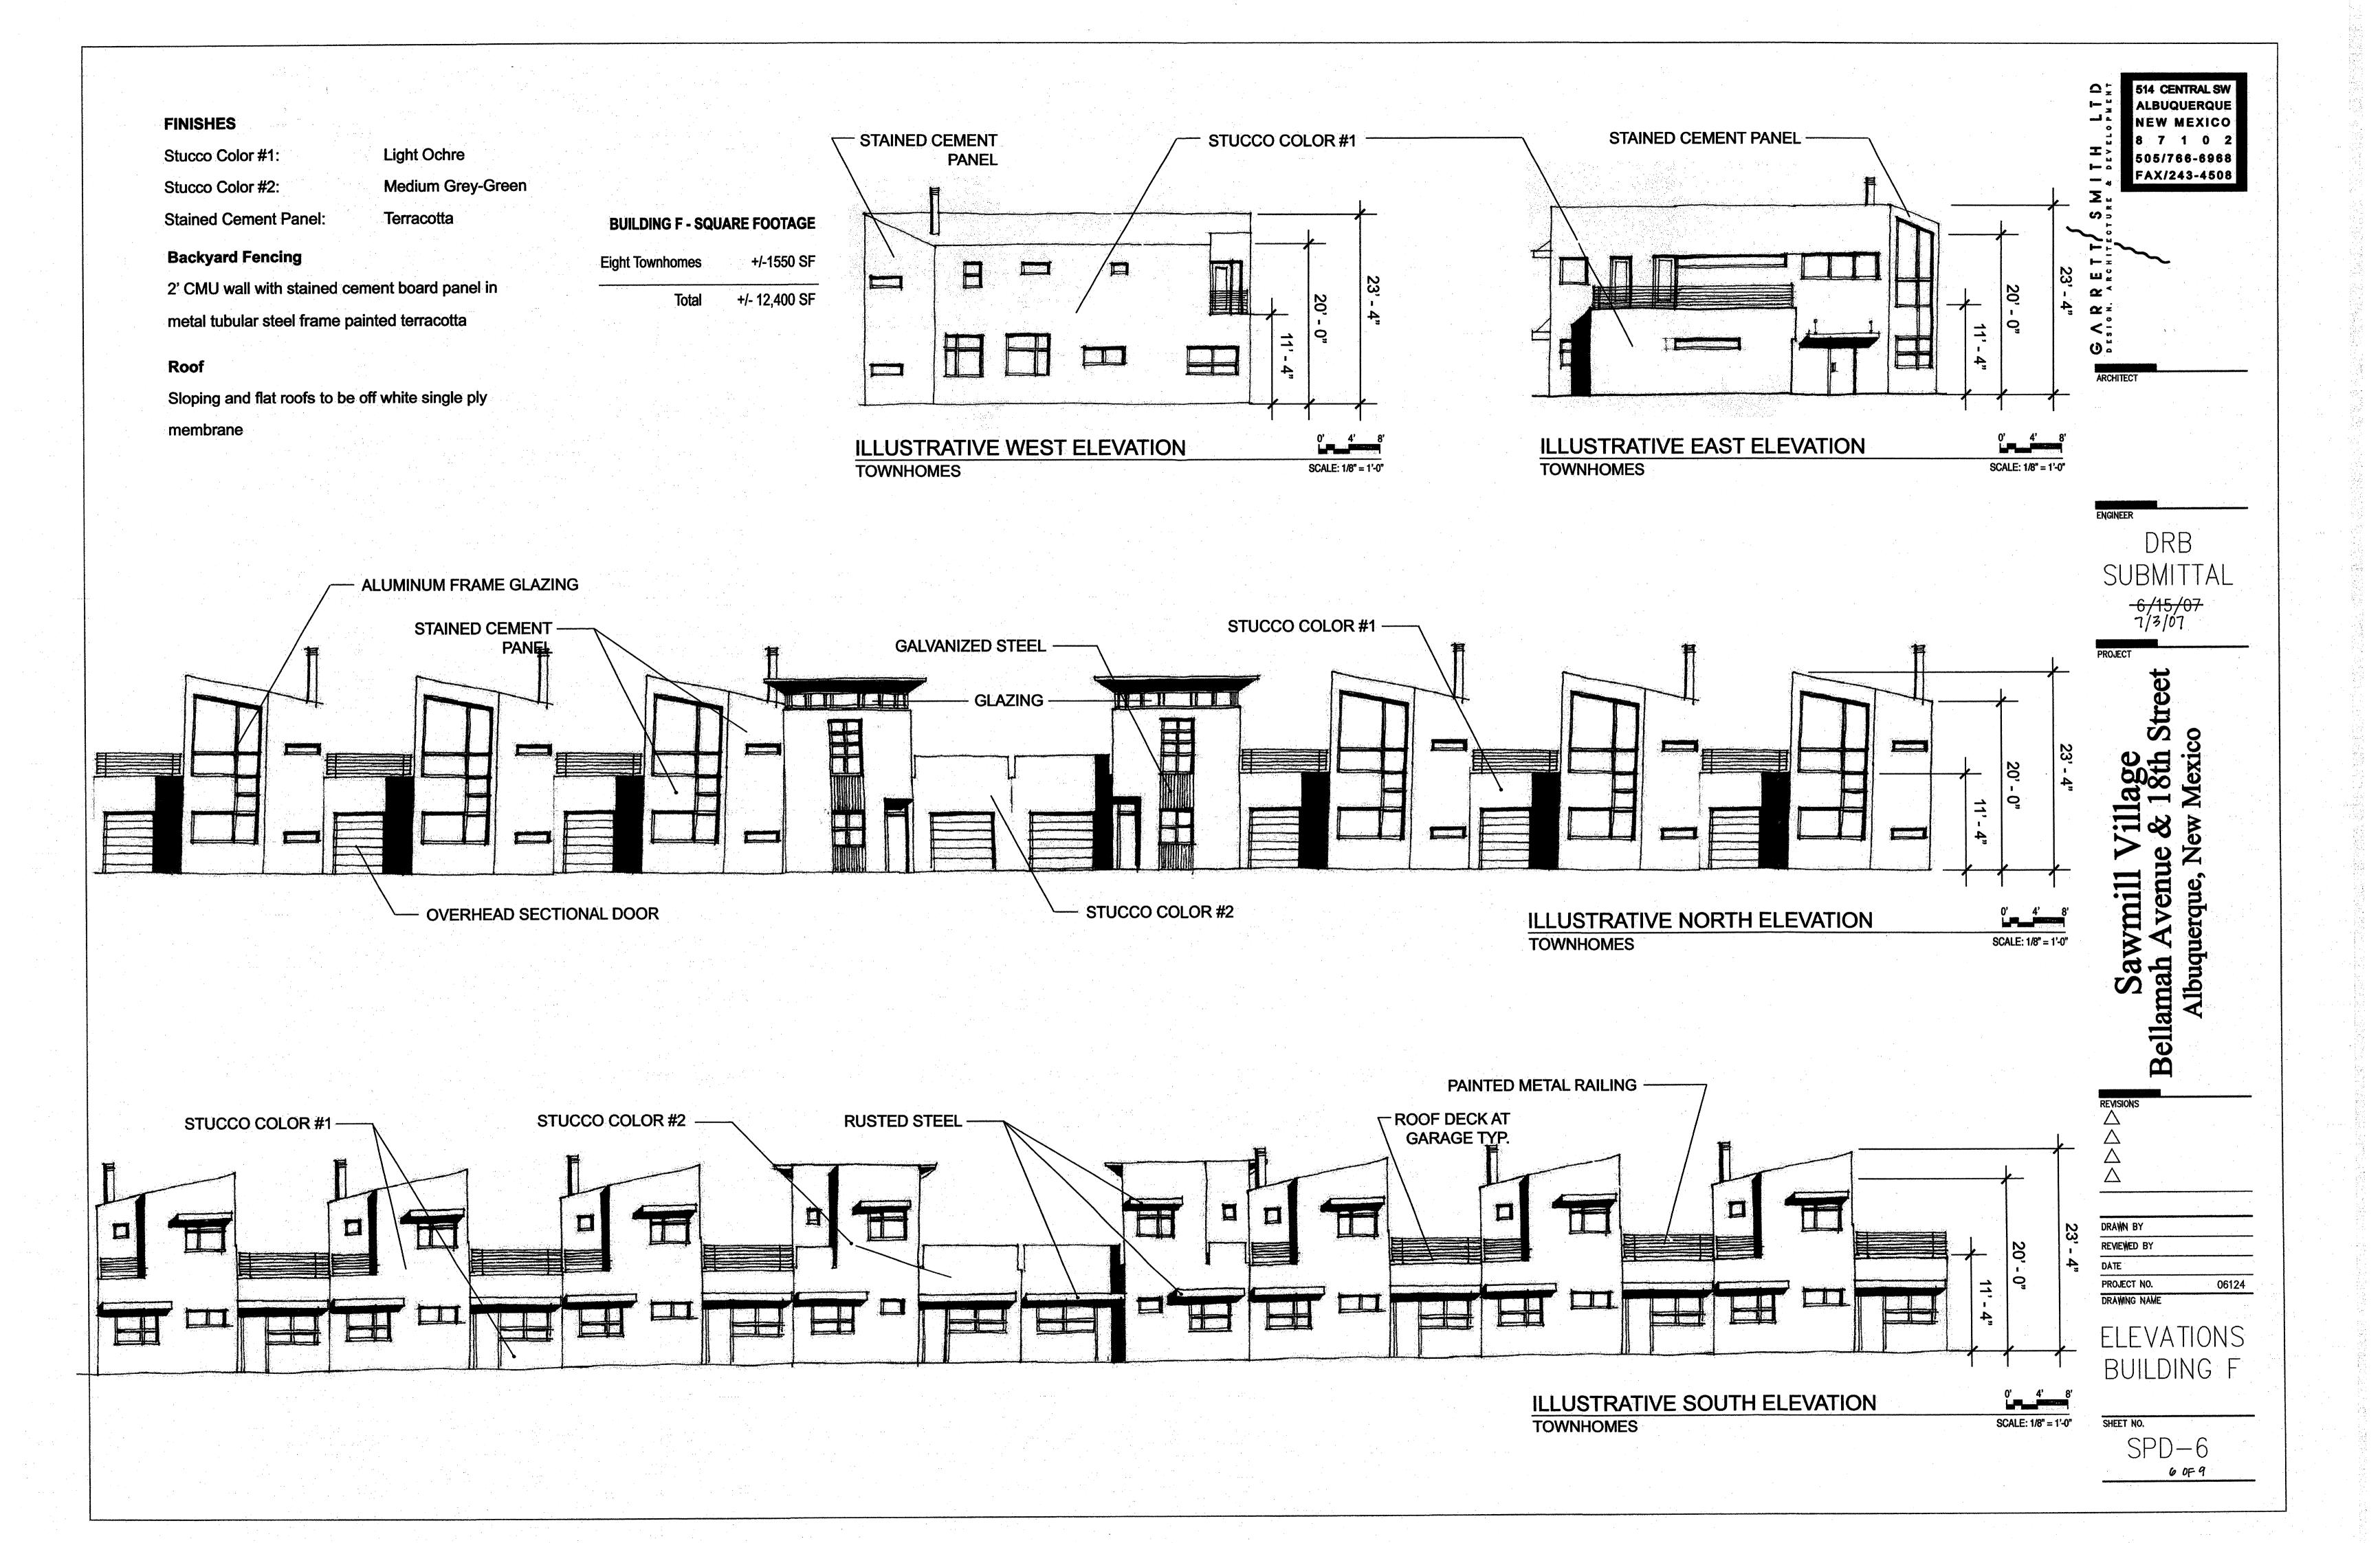

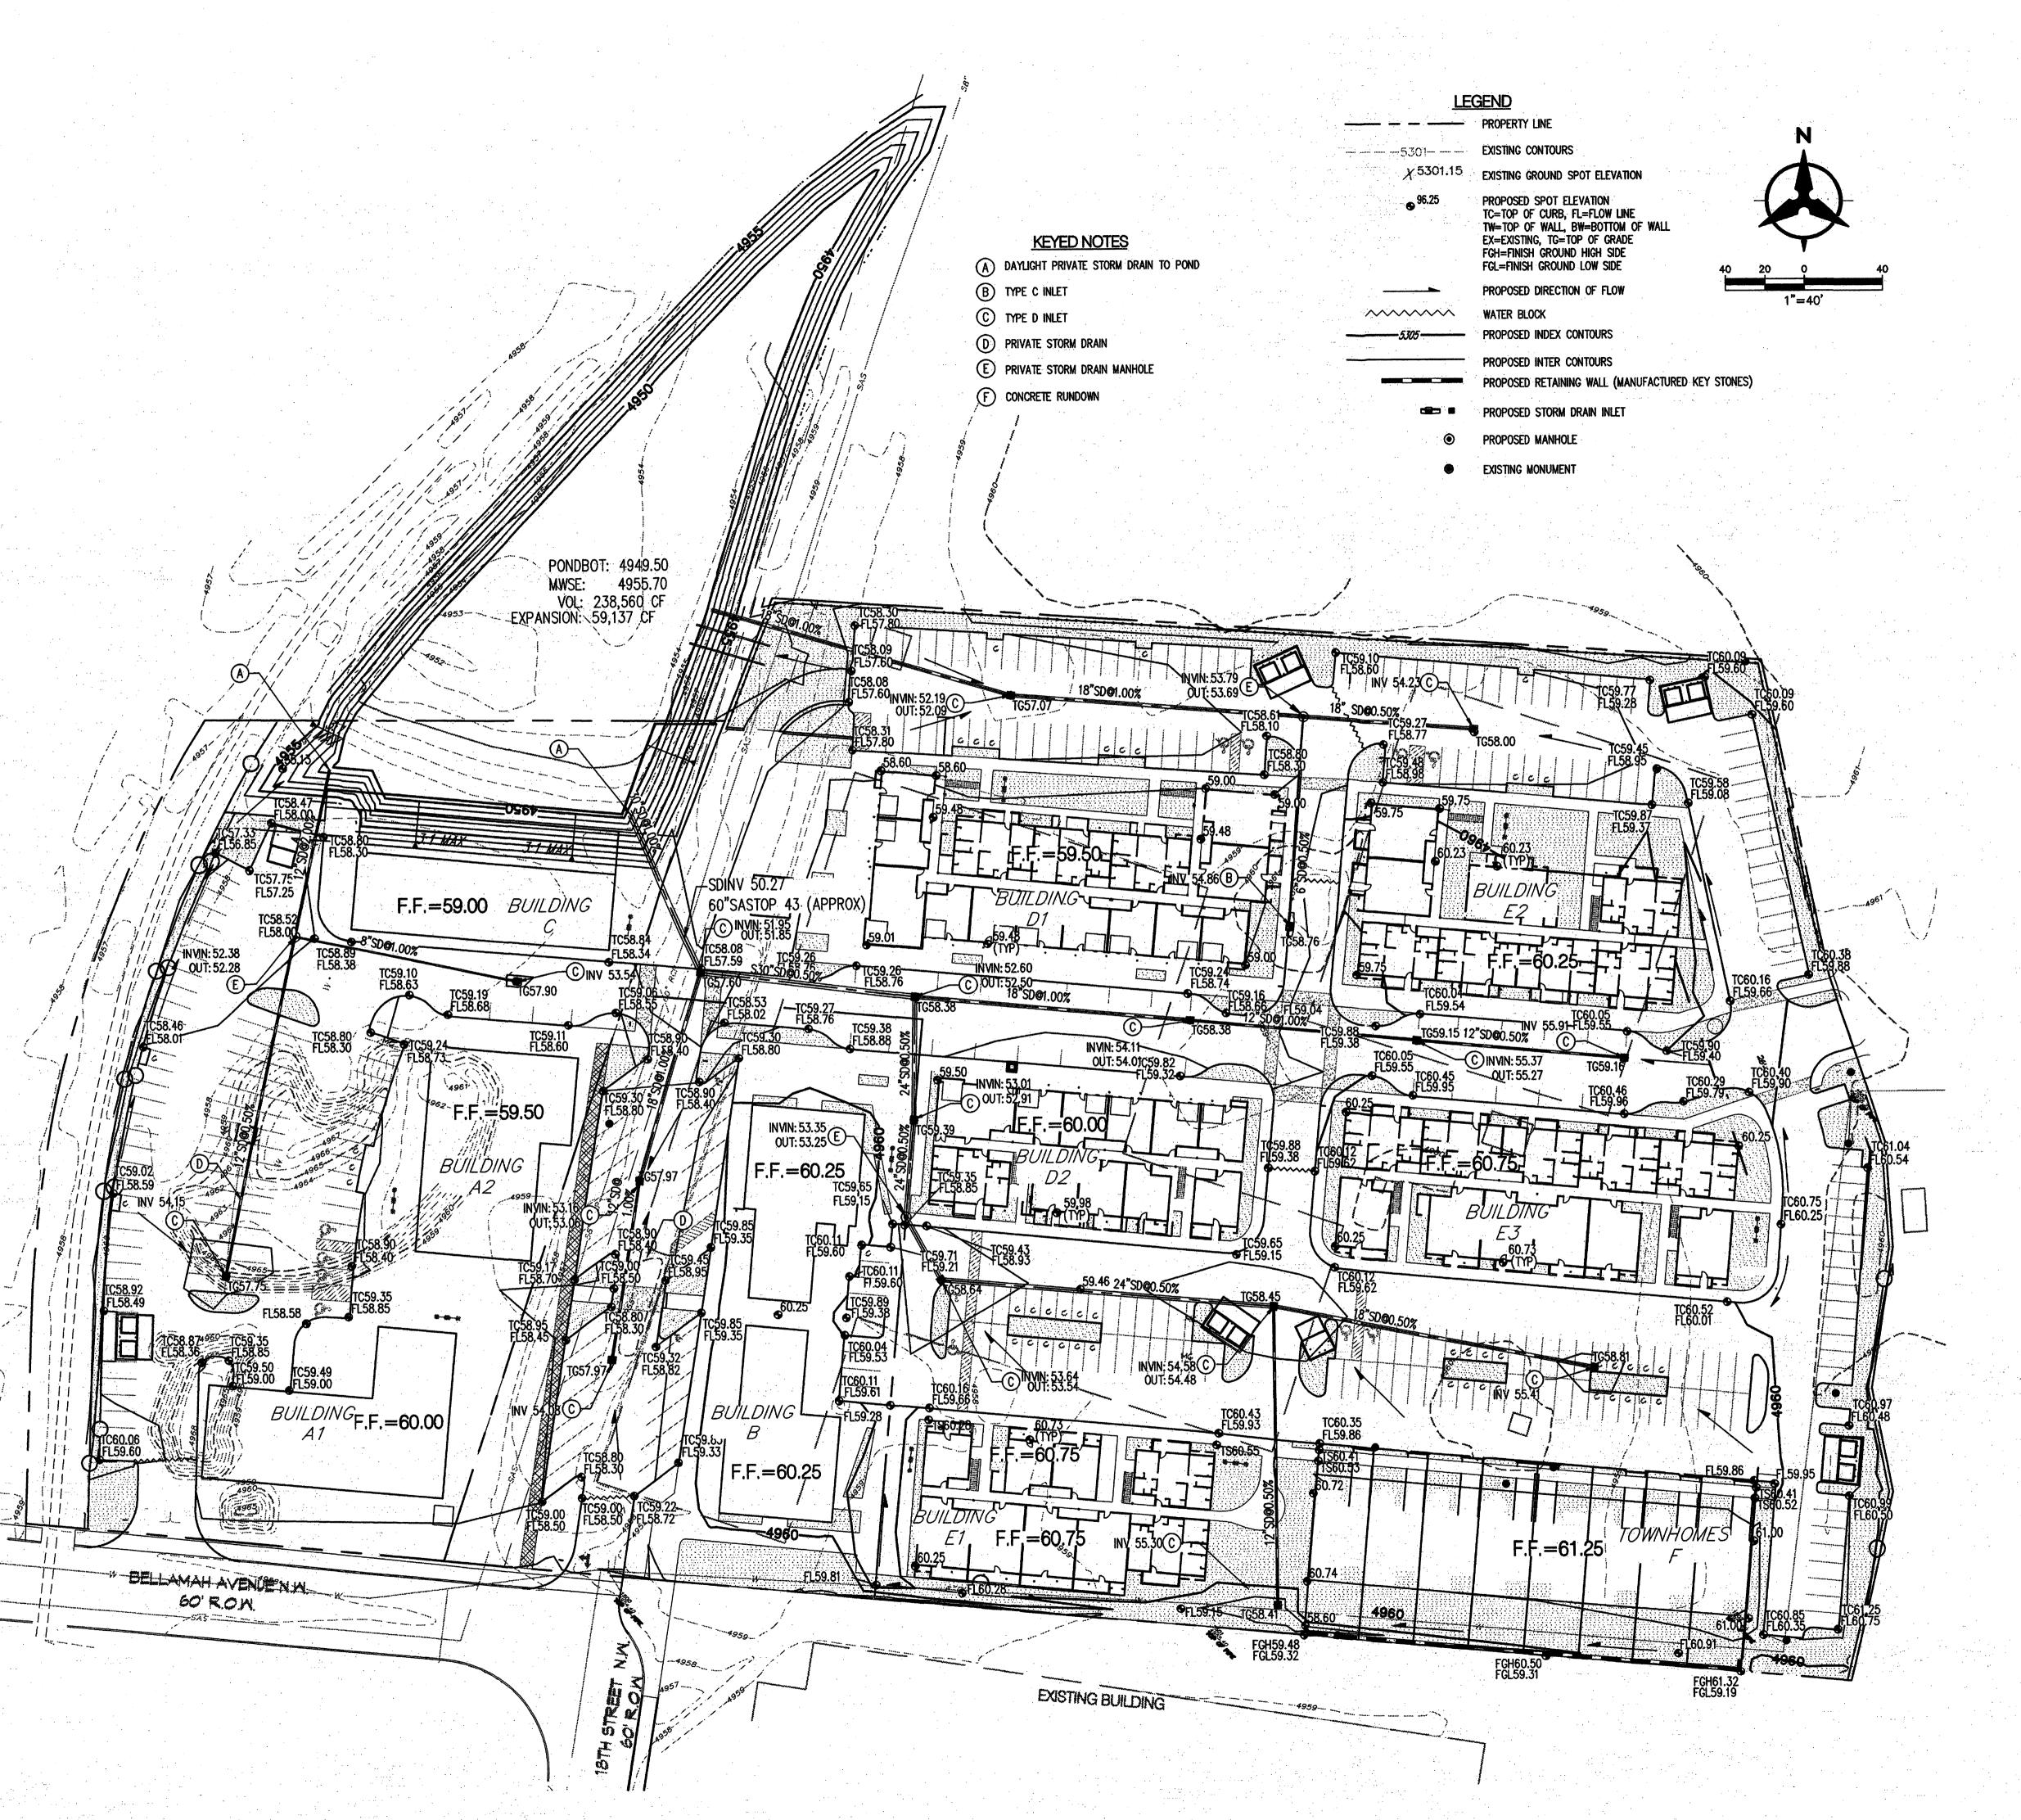

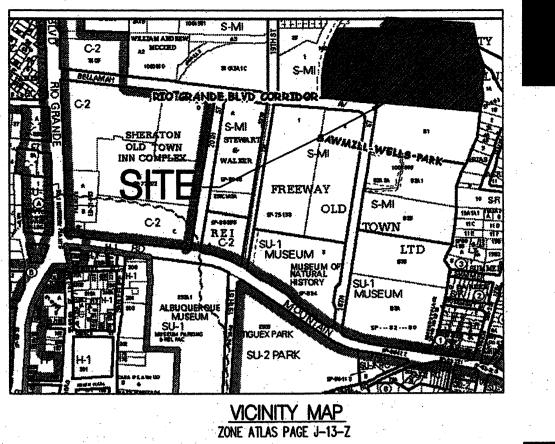

DRB SUBMITTAL

7/3/07

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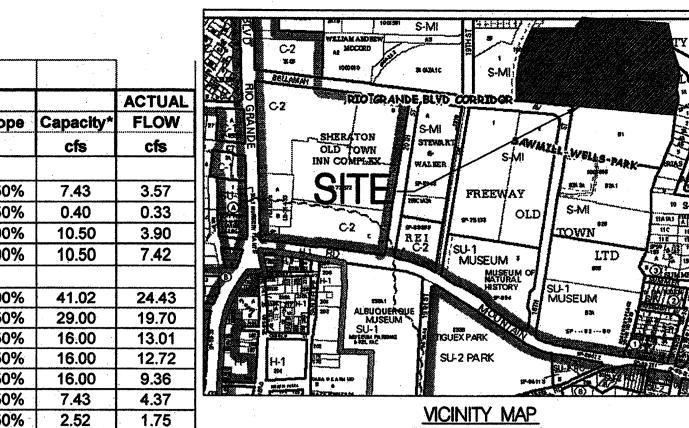
venue Sawmill Bellamah Avenu

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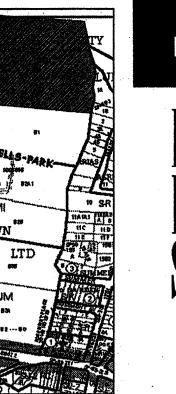
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CONCEPTUAL GRADING PLAN

	SAWMILL VILLAGE SITE BASIN PROPERTIES (PHASE I & II) STORM DRAIN PIPE TABLE	
	Proposed Ultimate Development Conditions Basin Data Table This table is based on the DPM Section 22.2, Zone: 2 PIPE # Basins and Storm Drains in Slope of the DPM Section 22.2, Zone: 2	ACTUAL Capacity* FLOW
<u>LEGEND</u> PROPERTY LINE	Basin Area Area Land Treatment Percentages Q(100) Q(100) V(100) V(100) HR	cfs cfs
5301 EXISTING CONTOURS	Tract B-2-A 226055 7.46 0.0% 5.0% 5.0% 90.0% 4.50 33.58 2.00 37742 NORTH	7.43 3.57
BASIN BOUNDARY	BASIN 1 34415 0.79 0.0% 10.0% 0.0% 90.0% 4.46 3.52 1.99 5696 SD3 BSN 2,5 18 1.00% BASIN 2 34871 0.80 0.0% 10.0% 0.0% 90.0% 4.46 3.57 1.99 5771 SD4 BSN 1,2,5 18 1.00% BSN 1,2,5 18 1.00%	0.40 0.33 10.50 3.90
PROPOSED DIRECTION OF FLOW	BASIN 2 34871 0.80 0.0% 10.0% 0.0% 90.0% 4.46 3.57 1.99 5771 SD4 BSN 1,2,5 18 1.00% BASIN 3 14171 0.33 0.0% 5.0% 0.0% 95.0% 4.58 1.49 2.05 2424 CENTRAL	10.50 7.42
WATER BLOCK WATER BLOCK	BASIN 4 17798 0.41 0.0% 5.0% 0.0% 95.0% 4.58 1.87 2.05 3045 BASIN 5 3260 0.07 0.0% 10.0% 0.0% 90.0% 4.46 0.33 1.99 540 SD6 BSN 3,4,6,7,9,10,11,12,13,14,19 30 1.00% SD6 BSN 3,4,6,7,9,10,11,12,14 30 0.50%	41.02 24.43 29.00 19.70
——————————————————————————————————————		16.00 13.01 16.00 12.72
$\frac{40}{20}$	BASIN 8 16442 0.38 0.0% 10.0% 0.0% 90.0% 4.46 1.68 1.99 2721 SD9 BSN 11,12,14 24 0.50%	16.00 9.36
PROPOSED STORM DRAIN INLET 1"=40;	BASIN 10 31998 0.73 0.0% 5.0% 0.0% 95.0% 4.58 3.36 2.05 5474 SD11 BSN 14 12 0.50%	7.43 4.37 2.52 1.75
		10.50 5.20 3.56 3.33
	BASIN 13 21398 0.49 0.0% 5.0% 0.0% 95.0% 4.58 2.25 2.05 3661 SD14 BSN 7 12 0.50% BASIN 14 22666 0.52 0.0% 55.0% 0.0% 45.0% 3.37 1.75 1.38 2612 SD15 BSN 8,13 18 1.00%	2.52 2.13 10.50 3.93
	BASIN 15 6813 0.16 0.0% 15.0% 0.0% 85.0% 4.34 0.68 1.92 1090 SD16 BSN 13 12 1.00%	3.56 2.25
	BASIN 17 14451 0.33 0.0% 65.0% 0.0% 35.0% 3.13 1.04 1.25 1504 SD17 BSN 15,16 12 2.00%	5.04 3.81
PONDROT, 4040 50	BASIN 18 62175 1.43 0.0% 10.0% 0.0% 90.0% 4.46 6.36 1.99 10290 SD18 BSN 15 8 1.00% BASIN 19 7620 0.17 0.0% 5.0% 0.0% 95.0% 4.58 0.80 2.05 1304 SD19 BSN 16 12 1.00%	
PONDBOT: 4949.50 MWSE: 4955.70	1) American de la companya del companya de la companya del companya de la company	<u>GRA</u>
VOL: 238,560 CF EXPANSION: 59,137 CF		Site Location and Backgroun The purpose of this submits
		levelopment to the North of development. There will be
		ainfall zone 2 as defined b site is Tract 2—D, Arbolera
		he vicinity map on this sho Irainage plan is submitted
	BASIN Le e BASIN 1	The Sawmill Master Drainage
		western site and the surrou submittal integrates the eas
0900	BASIN 2 / / / / / / / / / / / / / / / / / /	oond construction to be in
BASIN 18	THE THE LAND IN A VILLE OF THE PROPERTY OF THE	Existing Conditions
		This entire site (Tracts 2—D natural slope of the site is
F.F.=59.00 BUILDING	BUILDING BUILDING BUILDING	the southwest. There is an Orainage Plan. It currently
		The site is approximately le
SD18 IN15 W		Proposed Conditions Under proposed conditions
BASIN 15	CD10	drain systems to convey ru mpervious treatment D and
	BASIN 3 BASIN A SOLID ING SOLID	sizes the existing pond as elevation 4954 at which it
BASIN 19		accept runoff from the wes 3—2—A. With this project,
BUILDING ASSISTANCE AS	DACINA	59,000 CF. This expansion depth of retained water bel
F.F.=59.50	INO	proposed pond expansion vo
		Flood plain
BASIN 16 BASIN 8 IN 8		n accordance with FEMA co plain.
	BUILDING BUILDING	Offsite Flows
1 3 1 2 2 2 2 2 2 2 2 2 2 2 2 2 2 2 2 2		There are no significant ups Conclusions
	SD9 IN11	This drainage submittal has
	Cocccc Do	plan clearly demonstrates to concepts would result in th
I I I I I I I I I I I I I I I I I I I	BASIN 12	nydrology department appro
BASIN 13	BASIN 10 BASIN 11 BAS	
BUILDING		inlet inlet
A1		# Type
F.F.=60.00	25	IN1 1-SGL D IN2 1-SGL D
BASIN 17		IN3 1-SGL D IN4 1-SGL D
DAOIN 1 98 4960-	BUILDING F.F. = 60.75 75 TOWNHOMES F.F. = 61.25	IN5 1-SGL C
PELAMAH AVENDEN N		IN6 1-SGL D IN7 1-SGL D
60'RON	OCE PIES NIZIBASIN 14	IN8 1-SGL D
1959		IN9 1-SGL D IN10 1-SGL D
7-4958	1960	IN11 1-SGL D
4957	EXISTING BUILDING 1959	IN12 1-SGL D IN13 1-SGL D



VICINITY MAP ZONE ATLAS PAGE J-13-Z



The purpose of this submittal is to present a drainage and grading plan for the proposed Sawmill Village development to the North of Bellamah and 18th street. The design site proposes mixed use DRB SUBMITTAL the vicinity map on this sheet for a graphic depiction of the site location. This conceptual grading and

submittal integrates the eastern parcel 2-D into the Sawmill Master Drainage Plan and modifies the pond construction to be in compliance with the guidance and recommendations set forth in that report.

Existing Conditions

Site Location and Background Information

drainage plan is submitted in support site plan approval.

This entire site (Tracts 2-D & B-2-A) is approximately 10 acres and is an old industrial sawmill. The natural slope of the site is very flat. The slope across the site is less than 1% from the northeast to the southwest. There is an existing pond north of Tract 2-D that is part of the Sawmill Master Drainage Plan. It currently discharges into the storm drain in Bellamah at a maximum flow of 4 C.F.S. The site is approximately level with Bellamah and the surrounding properties.

GRADING AND DRAINAGE NARRATIVE

development. There will be some residential townhomes, and some commercial sites. The site is in

rainfall zone 2 as defined by figure A-1 of the DPM section 22. The existing legal description of the site is Tract 2-D, Arbolera De Vida and Lot B-2-A, Duke City Lumber Company Addition. Please see

The Sawmill Master Drainage Plan Area, prepared by Bohannan Huston Inc. addresses drainage off the western site and the surrounding area to the west and north (city hydrology file: H13-D25). This

Proposed Conditions

Under proposed conditions the site will slope slightly to the pond north of Tract 2-D and utilize storm drain systems to convey runoff to the pond w/ functional surface slopes. The site will be mostly impervious treatment D and the rest landscaped treatment B and C. The Sawmill Master Drainage Plan sizes the existing pond as a retention system to be conservative. The pond is a retention pond to elevation 4954 at which it can discharge 4 C.F.S. in a detention condition. The existing pond is sized to accept runoff from the western tract 2—D. The pond expansion is to include additional runoff from Lot B-2-A. With this project, we propose to expand the volume of the existing pond by approximately 59,000 CF. This expansion can be accomplished without lowering the pond bottom. Accordingly, the depth of retained water below the invert of the outlet pipe will not be increased with this project. The proposed pond expansion volume exceeds the 100yr, 6hr storm volume generated by tract B-2-A.

Flood plain

In accordance with FEMA community map panel #35001C0331 E, the site is not located within a flood

There are no significant upstream offsite flows which will impact this site.

This drainage submittal has been prepared in accordance with City of Albuquerque requirements. This plan clearly demonstrates the proposed grading and drainage concepts. The implementation of these concepts would result in the safe passage of the 100 year storm event. With this submittal we request hydrology department approval of this Grading and Drainage Plan for DRB site plan approval.

		INLET	TABLE		
inlet	Inlet	Top of	Actual	Avail	Capacit
#	Туре	Grate	Flow	Head ft	
IN1	1-SGL D	57.07	3.52	0.5	5.07
IN2	1-SGL D	58.00	3.57	0.5	5.07
IN3	1-SGL D	58.38	1.49	0.5	5.07
IN4	1-SGL D	58.38	1.87	0.5	5.07
IN5	1-SGL C	58.76	0.33	0.5	5.07
IN6	1-SGL D	59.15	1.20	0.5	5.07
IN7	1-SGL D	59.16	2.13	0.5	5.07
IN8	1-SGL D	57.97	1.68	0.5	5.07
IN9	1-SGL D	59.39	0.28	0.5	5.07
IN10	1-SGL D	58.64	3.36	0.5	5.07
IN11	1-SGL D	58.45	3.23	0.5	5.07
IN12	1-SGL D	58.81	4.37	0.5	5.07
IN13	1-SGL D	57.97	2.25	0.5	5.07
IN14	1-SGL D	58.80	1.75	0.5	5.07
IN15	1-SGL D	57.90	0.68	0.5	5.07
IN16	1-SGL D	57.75	3.13	0.5	5.07

* The actual head available varies with each inlet, but in no case is the available head less than 0.5'.

7/3/07

7601 Jefferson NE Suite 100

505 761-9700 fax 761-4222

dps Odpsdesign.org

Albuquerque, NH 87109

architecture interiors

planning

engineering

PROJECT

ARCHITECT

Street 200 H awmill Bellamah

DRAWN BY REVIEWED BY


DATE

PROJECT NO. DRAWING NAME

CONCEPTUAL DRAINAGE MANAGEMENT PLAN



06124

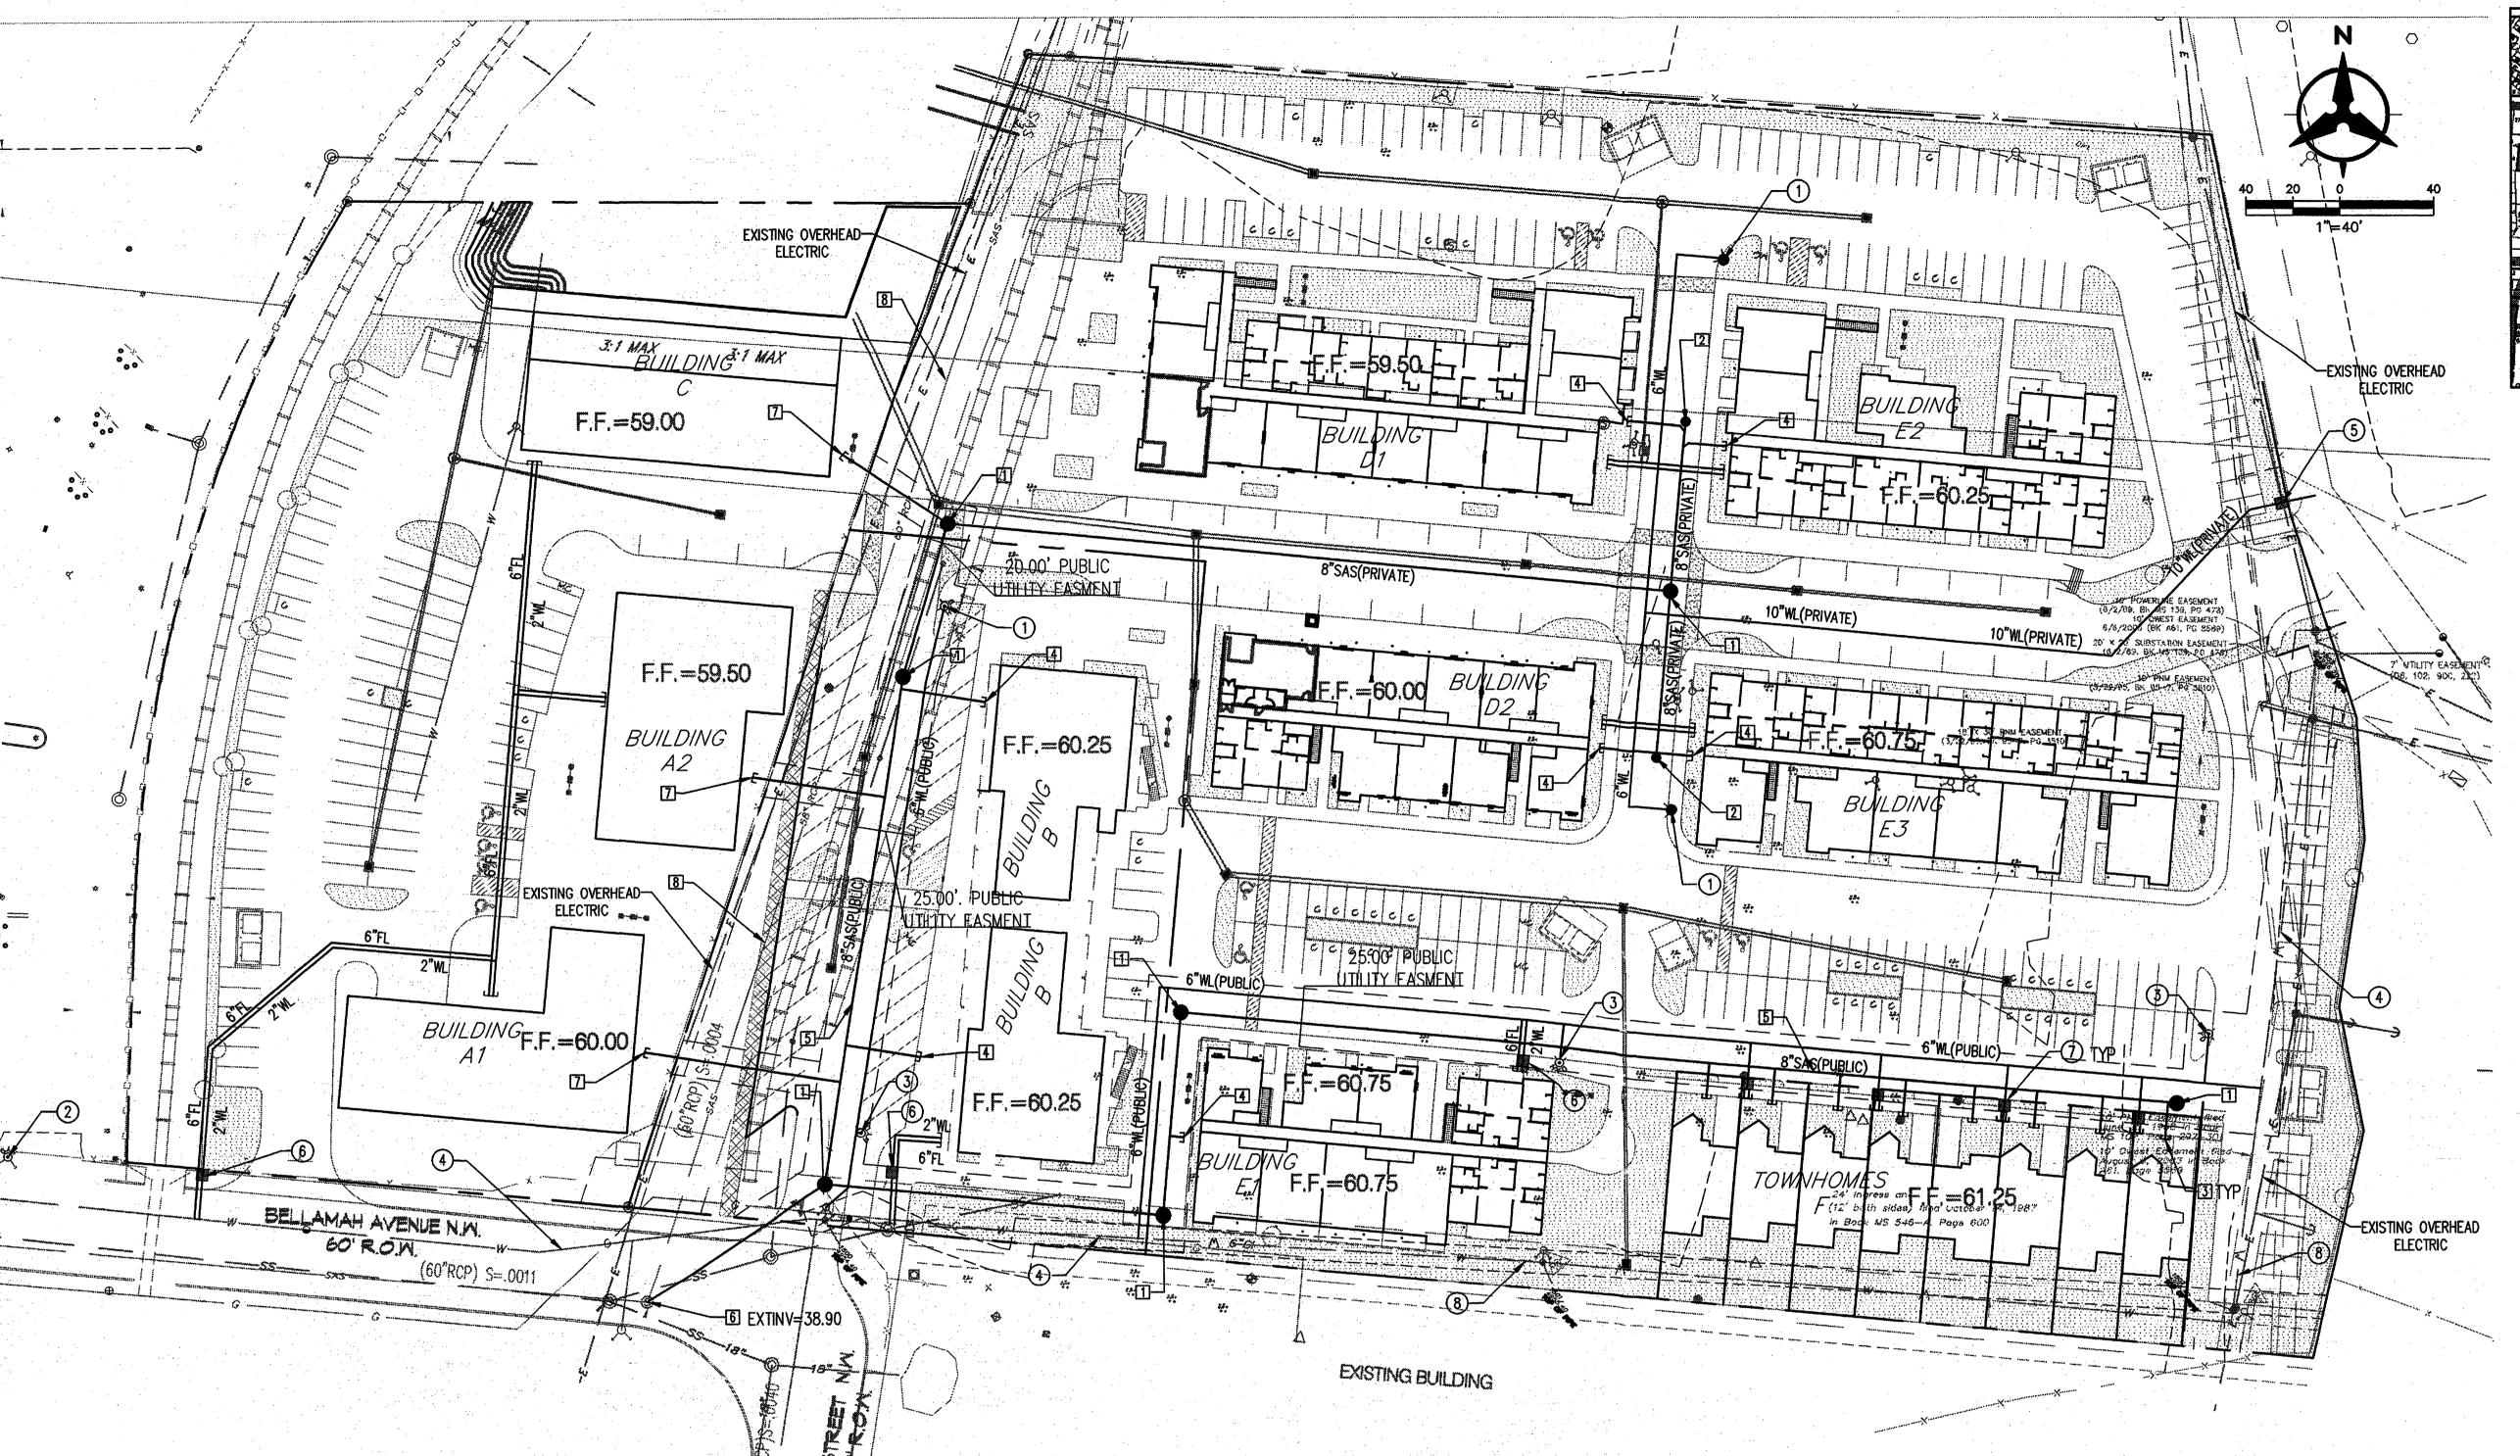

PUBLIC IMPROVEMENTS (PAVING, WATER, AND SANITARY SEWER) TO BE CONSTRUCTED WITH SIMULTANEOUS PUBLIC WORK ORDER PER DRC PLANS.

UTILITY NOTES

1. THIS CONTRACTOR SHALL BE RESPONSIBLE FOR THE COMPLETE INSTALLATION OF ALL WORK RELATED TO MECHANICAL UTILITIES AS SHOWN ON THIS PLAN INCLUDING: TRENCHING, BACKFILL, SUPPORTS, CLEANOUT PADS, SERVICE STOPS AND BOXES, SERVICE LINES, TESTING, CLEANING, AND STERILIZING. ANY WORK NOT ACCEPTED BY THE ARCHITECT OR ENGINEER DUE TO IMPROPER WORKMANSHIP OR LACK OF PROPER COORDINATION SHALL BE REMOVED AND CORRECTLY INSTALLED AT THE CONTRACTOR'S EXPENSE, AS DIRECTED.

2. MINIMUM DEPTHS OF COVER SHALL BE: 48" FOR WATERLINES AND 48" FOR SEWER, EXCEPT AT BUILDING CONNECTION.

3. ALL WORK DETAILED ON THESE PLANS TO BE PERFORMED UNDER CONTRACT SHALL, EXCEPT AS OTHERWISE STATED OR PROVIDED OF HEREON, BE CONSTRUCTED IN ACCORDANCE WITH THE IAPMO UNIFORM PLUMBING CODE, LATEST EDITION.

4. UTILITY LINES SHALL BE INSTALLED PRIOR TO PAVEMENT, CURB AND GUTTER, AND/OR SIDEWALK, AS APPLICABLE.

5. ROUGH GRADING OF SITE (±0.5') SHALL BE COMPLETED PRIOR TO INSTALLATION OF UTILITY LINES.

6. CONTRACTOR WILL BE RESPONSIBLE FOR CONNECTIONS TO BUILDING DRAIN LINES AND ALL NECESSARY FITTINGS.


7. ALL VALVES SHALL BE ANCHORED PER COA STANDARD DWG. 2333.

8. FIRE LINES SHALL USE PIPE MATERIALS UNDERWRITERS LABORATORIES LISTED AND APPROVED FOR FIRE SERVICE.

9. CONTRACTOR SHALL BE RESPONSIBLE FOR ALL WATER METER, FIRE LINE, AND SEWER HOOKUP FEES FOR INSTALLATIONS. OWNER SHALL BE RESPONSIBLE FOR UTILITY EXPANSION CHARGES, PRORATA AND OTHER SPECIAL ASSESSMENTS.

10. CONTRACTOR SHALL VERIFY INVERTS AND LOCATIONS OF EXISTING WATER/SAS LINES PRIOR TO BEGINNING WORK. ALL CONFLICTS SHALL BE BROUGHT TO ATTENTION OF THE ENGINEER AND RESOLVED PRIOR TO BEGINNING WORK.

11. CONTRACTOR SHALL PREPARE ALL SUBMITTAL MATERIALS & PAY APPLICABLE FEES REQUIRED TO OBTAIN THE "MINI WORK ORDER" REQUIRED FOR CONNECTION TO THE EXISTING CITY WATER MAIN AND OTHER 'PUBLIC' WATER LINE CONSTRUCTION.

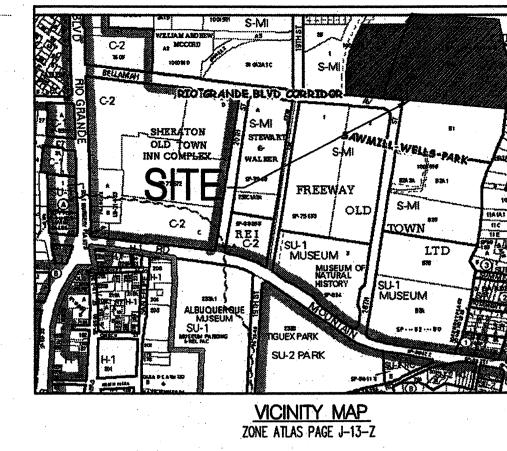

LEGEND

Dekker

Perich

Sabatini

7601 Jefferson NE

Sultanion

Albeguerque, NN 87109

505 761-9700

fax 761-4222

dp: Odpedesign.org

ARCHITECT

		PROPERTY DIVE	
, réservation		EX SANITARY SEWER & MANHOLE	
***************************************	ss(i)	EX STORM DRAIN & MANHOLE	
·····	***************************************	EX WATER LINE	
	×	RELOCATED PUBLIC FIRE HYDRANT	ENGINEER
	X	EX FIRE HYDRANT	DRB
	>	PRIVATE FIRE HYDRANT	
	• co .	PROPOSED CLEANOUT	SUBMITTA
	•	PROPOSED SANITARY SEWER MAN H	7/3/07 OLE
	8"SAS	PROPOSED SANITARY SEWER	
	2"WL	PROPOSED WATERLINE	PROJECT

WATER METER VAULT

WATER KEYED NOTESPRIVATE FIRE HYDRANT.

- 2. EXISTING PUBLIC FIRE HYDRANT TO REMAIN.
- 3. RELOCATE EXISTING OR INSTALL PUBLIC FIRE HYDRANT WITHIN NEW PUBLIC WATER LINE EASEMENT PER SIMULTANEOUS WORK ORDER.
- 4. EXISTING PUBLIC 6" CAST IRON WATER LINE TO REMAIN.
- 5. 2"x10" FIRE ASSEMBLY TYPE IN PUBLIC EASEMENT AS REQUIRED.
- 6. 2" WATER METER.
- 7. 3/4" SERVICE WATER METERS. (TWO PER BOX)
- 8. EXISTING 6" CAST IRON WATER LINE TO BE ABANDONED.

☐ SANITARY SEWER KEYED NOTES

- 1. SAS MAN HOLE
- 2. SAS CLEAN OUT

4. 6" SAS SERVICE.

- 3. 4" SAS SERVICE.
- 5. 8" PUBLIC SAS W/ 25' SHARED EASMENT PER SIMULTANEOUS WORK ORDER.

6. CONNECT TO EXISTING SAS.

- 7. 6" SAS SERVICE LINE WITH PRIVATE SAS EASEMENT.
- 8. EXISTING 60" SAS INTERCEPTOR W/ 30' EASEMENT.

REVISIONS

A
A
A

8

venu

ellamah

DRAWN BY
REVIEWED BY
DATE
PROJECT NO. 06124

CONCEPTUAL UTILITY PLAN

DRAWING NAME

SHEET NO.