

CHINESE PISTACHE (M) 8

BLACK LOCUST (M) 16

PURPLE LEAF PLUM (M) 12

COMMON HACKBERRY (M) 13

Robinia pseudoacia

Prunus cerasifera

Celtis occidentalis 2" Cal.

BANANA YUCCA (L) 1

Yucca baccata

5 Gal. 9sf

SHRUBS/ORNAMENTAL GRASSES

RED YUCCA (L) 6

Hesperaloe parviflora

PRICKLY PEAR (L) 3

BIRD OF PARADISE (L) 5

LITTLELEAF SUMAC (L+) 7

Caesalpinia gilliesii

Rhus microphylla 5 Gal. 81sf

SAND PLUM (M) 27

APACHE PLUME (L) 37

ALKALI SACATON (L) 18

Chrysothamnus nauseosus

VIRGINIA CREEPER (M) 10

Parthenocissus quinquefolia 5 Gal. 240sf

SANTA FE BROWN CRUSHER

FINES WITH FILTER FABRIC

TO A DEPTH OF 2"

nstaked-groundcover

RUBBER RABBITBRUSH (L) 90

Prunus americana

Fallugia paradoxa

Sporobolus airoides

5 Gal.

ONE GAL

GROUNDCOVERS

HARDSCAPES


5 Gal. 36sf

Opuntia macrocentra

DESERT ACCENTS

FIVE GAL.

Pistacia chinensis

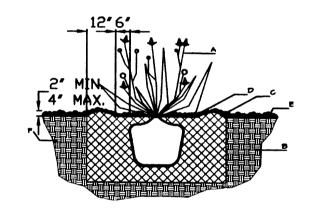

GENERAL NOTES:

1. THE OUTSIDE DIAMETER OF THE WATER RETENTION BASIN SHALL BE TWICE THE DIAMETER OF THE SHRUB PLANTING PIT.


SHRUB PLANTING DETAIL

CONSTRUCTION NOTES:

A. SHRUB.

B. BACKFILL WITH EXISTING SOIL. C. EARTH BERM AROUND WATER RETENTION

D. 4" DEPTH OF BARK MULCH. FINISH GRADE. UNDISTURBED SOIL

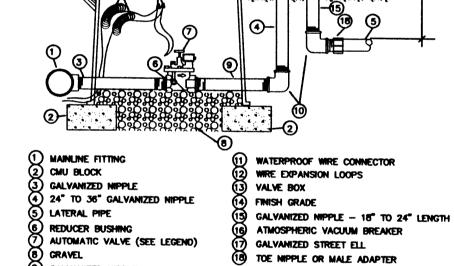


GALVANIZED NIPPLE

GALVANIZED ELBOW

LANDSCAPE NOTES:

AUTOMATIC VALVE W/ ATMOSPHERIC VACUUM BREAKER

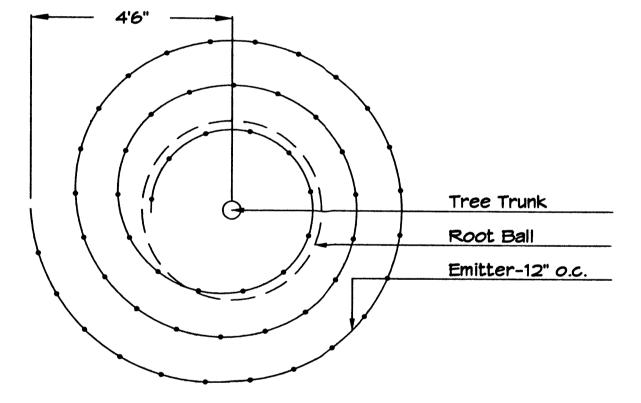

Netafim Spiral Detail

GENERAL NOTES:

1. ROOTBALL SHALL BE PLACED ON UNDISTURBED SOIL TO PREVENT TREE FROM SETTLING.

2. TOP OF ROOTBALL INDICATED LEVEL AT WHICH TREE WAS GROWN AND DUG; THIS REPRESENTS THE LEVEL AT WHICH THE TREE SHOULD BE INSTALLED; THAT LEVEL MAY BE EXC SEDED BY ONLY A ONE INCH LAYER OF

3. 'RIOR TO BACKFILLLING TREE, ALL WIRE. RO 'E AND SYNTHETIC MATERIALS SHALL BE REHOVED FROM THE TREE AND THE PLANTING PIT.

4. PRIOR TO BACKFILLING ALL BURLAP SHALL BE CUT AWAY EXCEPT FROM BOTTOM OF THE ROOTBALL.

CONSTRUCTION NOTES:

A. TREE

B. BACKFILL WITH EXISTING SOIL.

C. 4" DEPTH OF BARK MULCH. D. TURF AT FINISH GRADE.

E. UNDISTRUBED SOIL.

TREE PLANTING DETAIL NTS

Landscape maintenance shall be the responsibility

of the Property Owner.

It is the intent of this plan to comply with the City Of Albuquerque Water Conservation Landscaping and Water Waste Ordinance planting restriction approach. Approval of this plan does not constitute or imply exemption from water waste provisions of the Water Conservation Landscaping and Water Waste Ordinance. Mater management is the sole responsibility of

the Property Owner. All landscaping will be in conformance with the City of Albuquerque Zoning Code, Street Tree Ordinance, Pollen Ordinance, and Water Conservation Landscaping and Water Waste Ordinance. In general, water conservative, environmentally sound landscape principles will be followed in design and installation.

Plant beds shall achieve 75% live ground cover at maturity.

Santa Fe Brown Crusher Fines over Filter Fabric shall be placed in all landscape areas which are not designated to receive native seed.

IRRIGATION NOTES:

Irrigation shall be a complete underground sustem with Trees to receive 1 Netafim spiral (50' length) with 3 loops at a final radius of 4.5' from tree trunk, pinned in place. Netafim shall have emitters 12" o.c. with a flow of .6 gph. Shrubs to receive (2) 1.0 GPH Drip Emitters. Drip and Bubbler systems to be tied to 1/2" polypipe with flush caps at each end. Trees and shrubs shall be on separate valves.

Run time per each shrub drip valve will be approximately 15 minutes per day. Tree drip valve shall run 1.5 hours, 3 times per week. Run time will be adjusted according to the

Point of connection for irrigation system is unknown at current time and will be coordinated in the field. Irrigation will be operated by automatic controller.

Location of controller to be field determined and power source for controller to be provided by others.

Irrigation maintenance shall be the responsibility of the Property Owner.

responsibility of the Developer/Builder.

Mater and Power source shall be the

PARKING LOT TREE REQUIREMENTS

TOTAL LANDSCAPE PROVIDED

Parking Lot Tree Ordinance are as follows:

of the specified gravel, to stabilize the slope. All

vegetative material shall remain per plan.

1 Shade tree per 10 spaces Required # 27 Provided # 27


Shade trees required under the City Of Albuquerque

LANDSCAPE CALCULATIONS

TOTAL LOT AREA	135105	square feet
TOTAL BUILDINGS AREA	16000	square feet
OFFSITE AREA	1872	square feet
NET LOT AREA	119105	square feet
LANDSCAPE REQUIREMENT	15%	
TOTAL LANDSCAPE REQUIREMENT	17866	square feet
TOTAL BED PROVIDED	23602	square feet
GROUNDCOVER REQ.	75%	square feet
TOTAL GROUNDCOVER REQUIREMENT	17702	square feet
TOTAL GROUNDCOVER PROVIDED	20238 (86%)square feet
TOTAL SOD AREA (max. 20% of landscape required)	0	square feet

30 15 0 15

23602 (20%) square feet

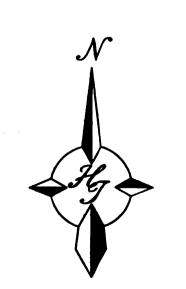

GRAPHIC SCALE

SCALE: 1"=30'



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CONSULTANT

PROFESSIONAL SEAL

UNIVERSITY OF

PHOENIX

COMPACT NANDINA (M) 24 Nandina domestica 1 Gal. 9sf

BLUE LEADWORT (M) 21

Cerastostigma plumbaginoides

NETLEAF HACKBERRY (M) 6

WASHINGTON HAWTHORN (M+) 4 Crataegus phaenopyrum

Celtis reticulata

Pinus nigra

AUSTRIAN PINE (M) 2

DESERT MILLOW (L) 2

NEM MEXICO OLIVE (L) 3

Forestiera neomexicana

BEARGRASS (L+) 17 Nolina microcarpa

5 Gal. 36sf

5 Gal. 95f

BLUE SOTOL (L) 1

Dasylirion wheeleri

Chilopsis linearis 15 Gal. 225sf

15 Gal. 225 sf

MEDIUM NATIVE GRASSES 8 INCLUDING BUT NOT LIMITED TO SAND LOVEGRASS AND LITTLE BLUESTEM 1 Gal. 9sf

PRAIRIE SAGE (L+) 42 Artemisia ludoviciana 1 Gal. 25sf

BARBERRY (M) 38

Berberis spp. 1 Gal. 16sf

1 Gal. 16sf

BLUE FESCUE (L) 18 1 *Gal*.

SAND DROPSEED (L) 24 Sporobolus cryptandrus

CRANBERRY COTONEASTER (L+) 16 Cotoneaster apiculatus

TRUMPET VINE (M) 14 Campsis radicans 1 Gal. 400sf Unstaked-Groundcover

OV PSIZED GRAVEL

ADULT EDUCATIONAL FACILITY (i) 4 11 BOULDERS BALLOON L'IESTA AVE. ALBUQUERQUE, NEW MEXI


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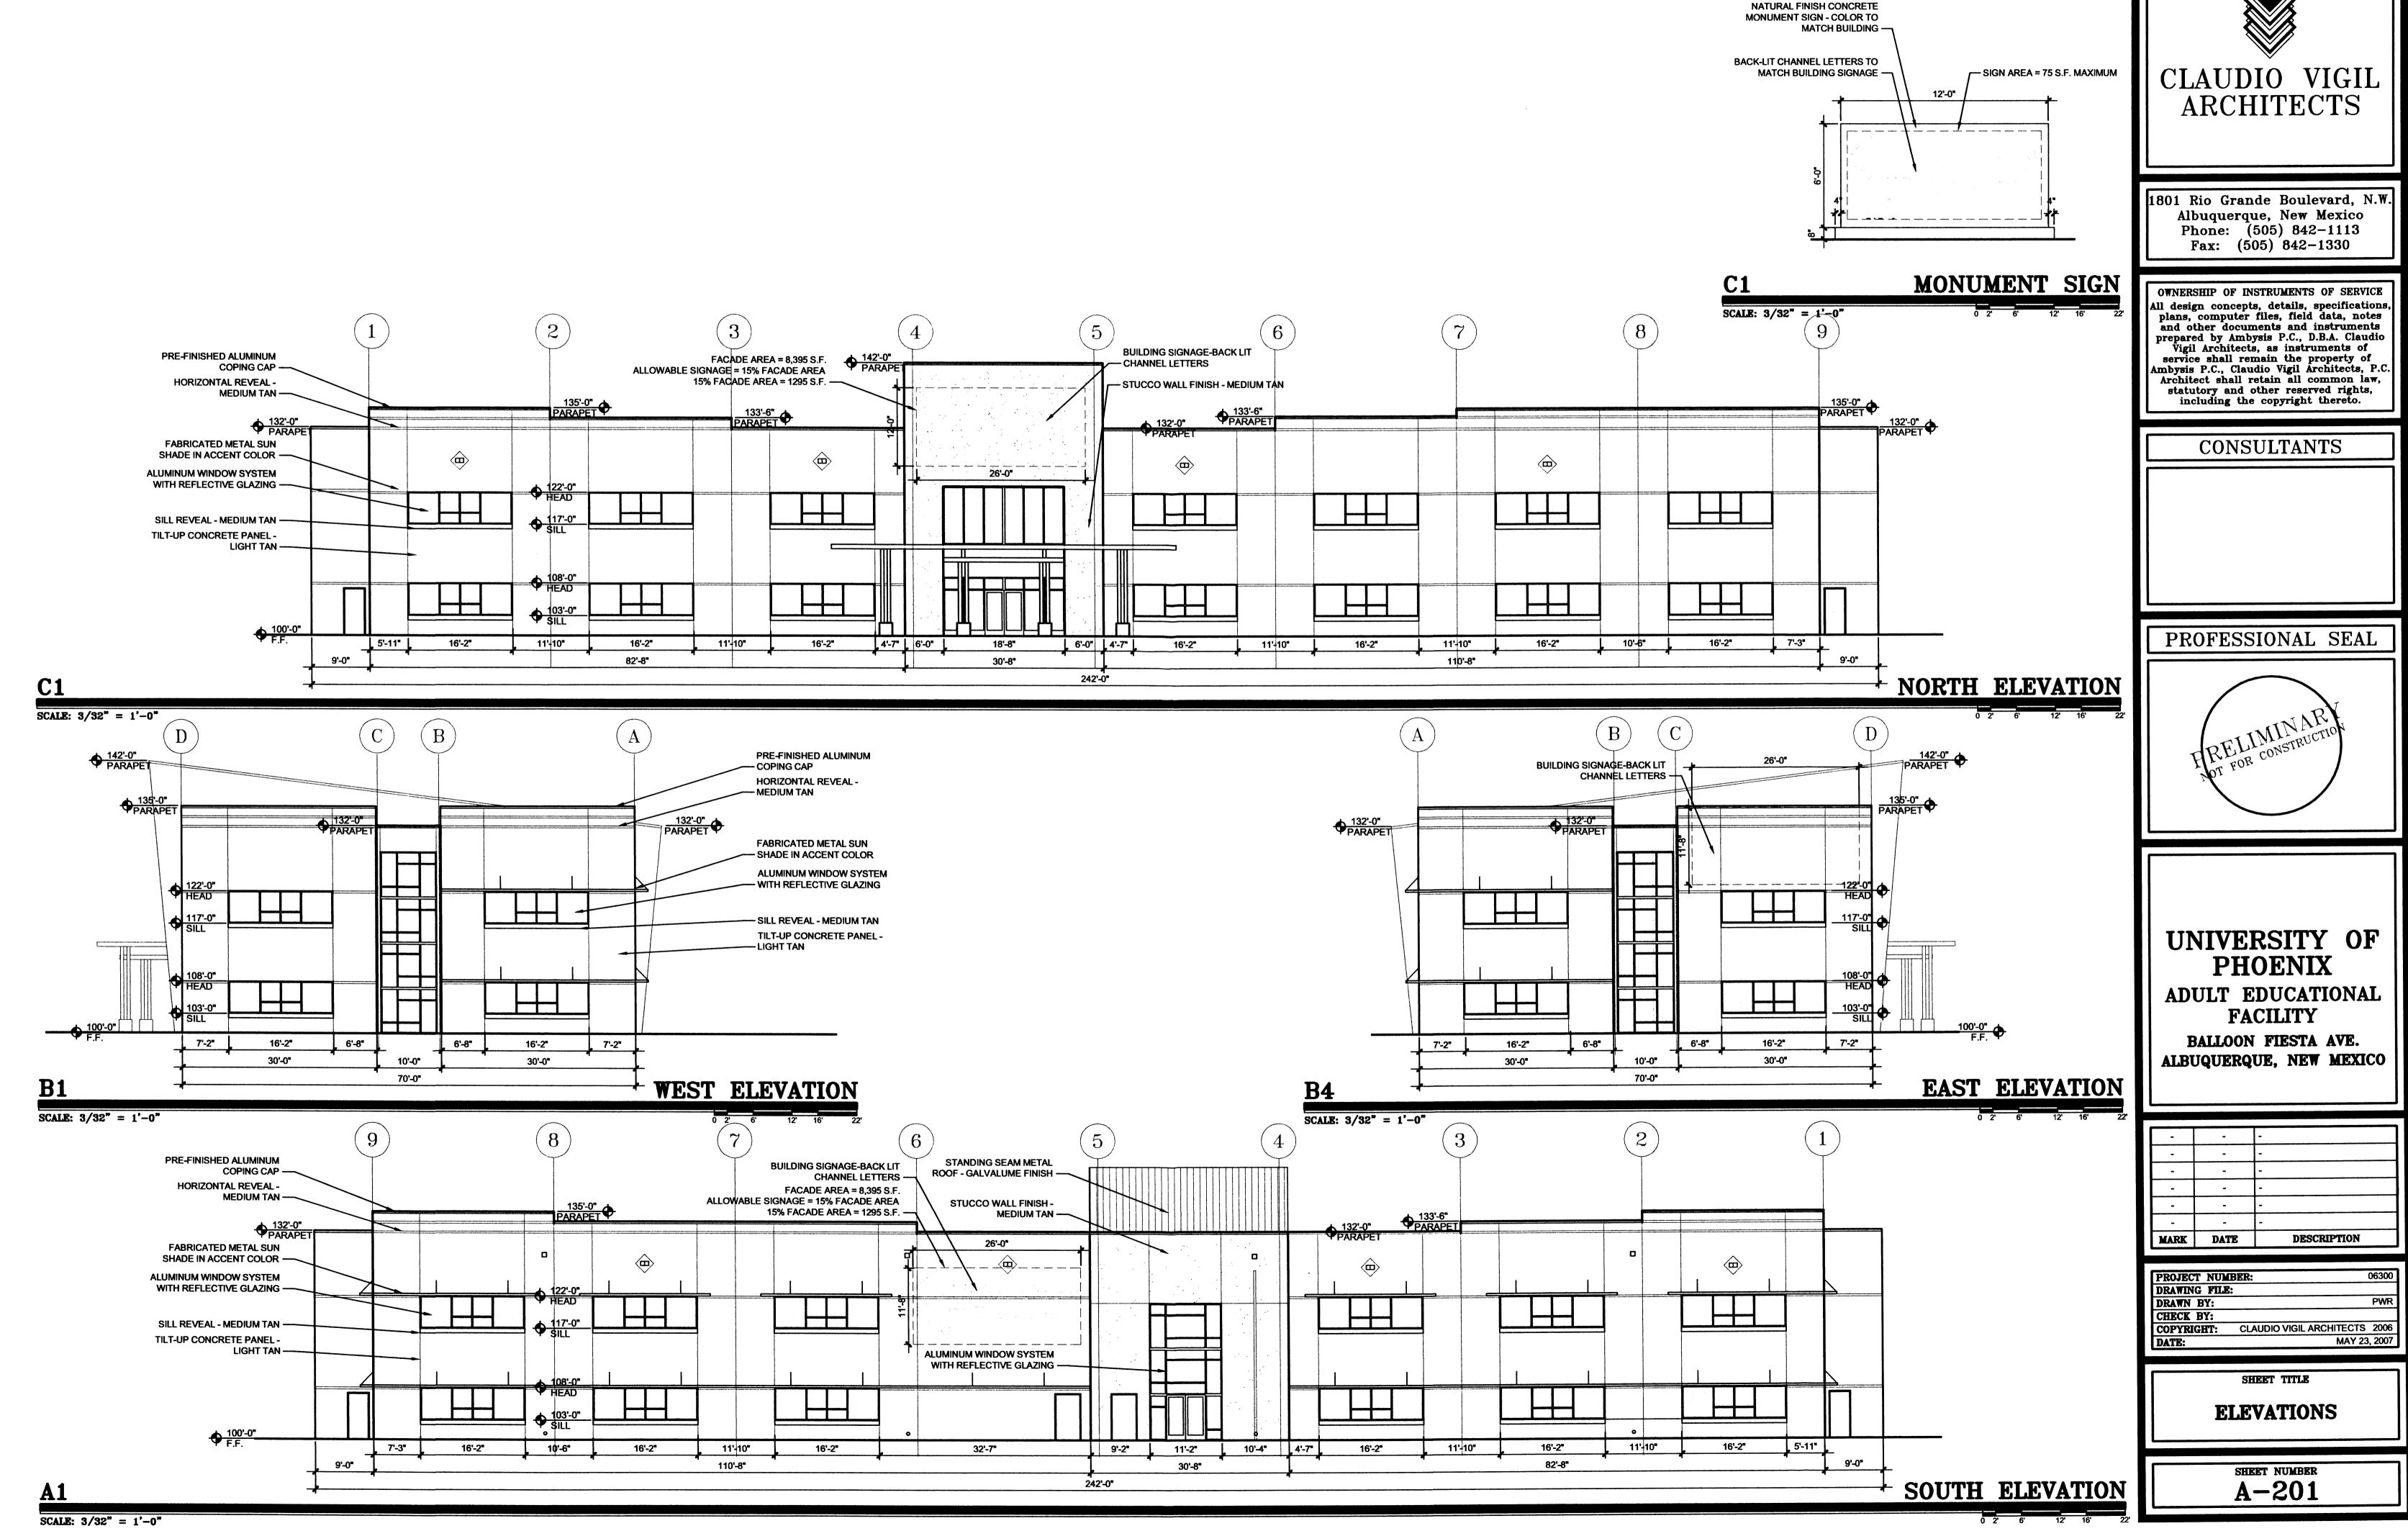
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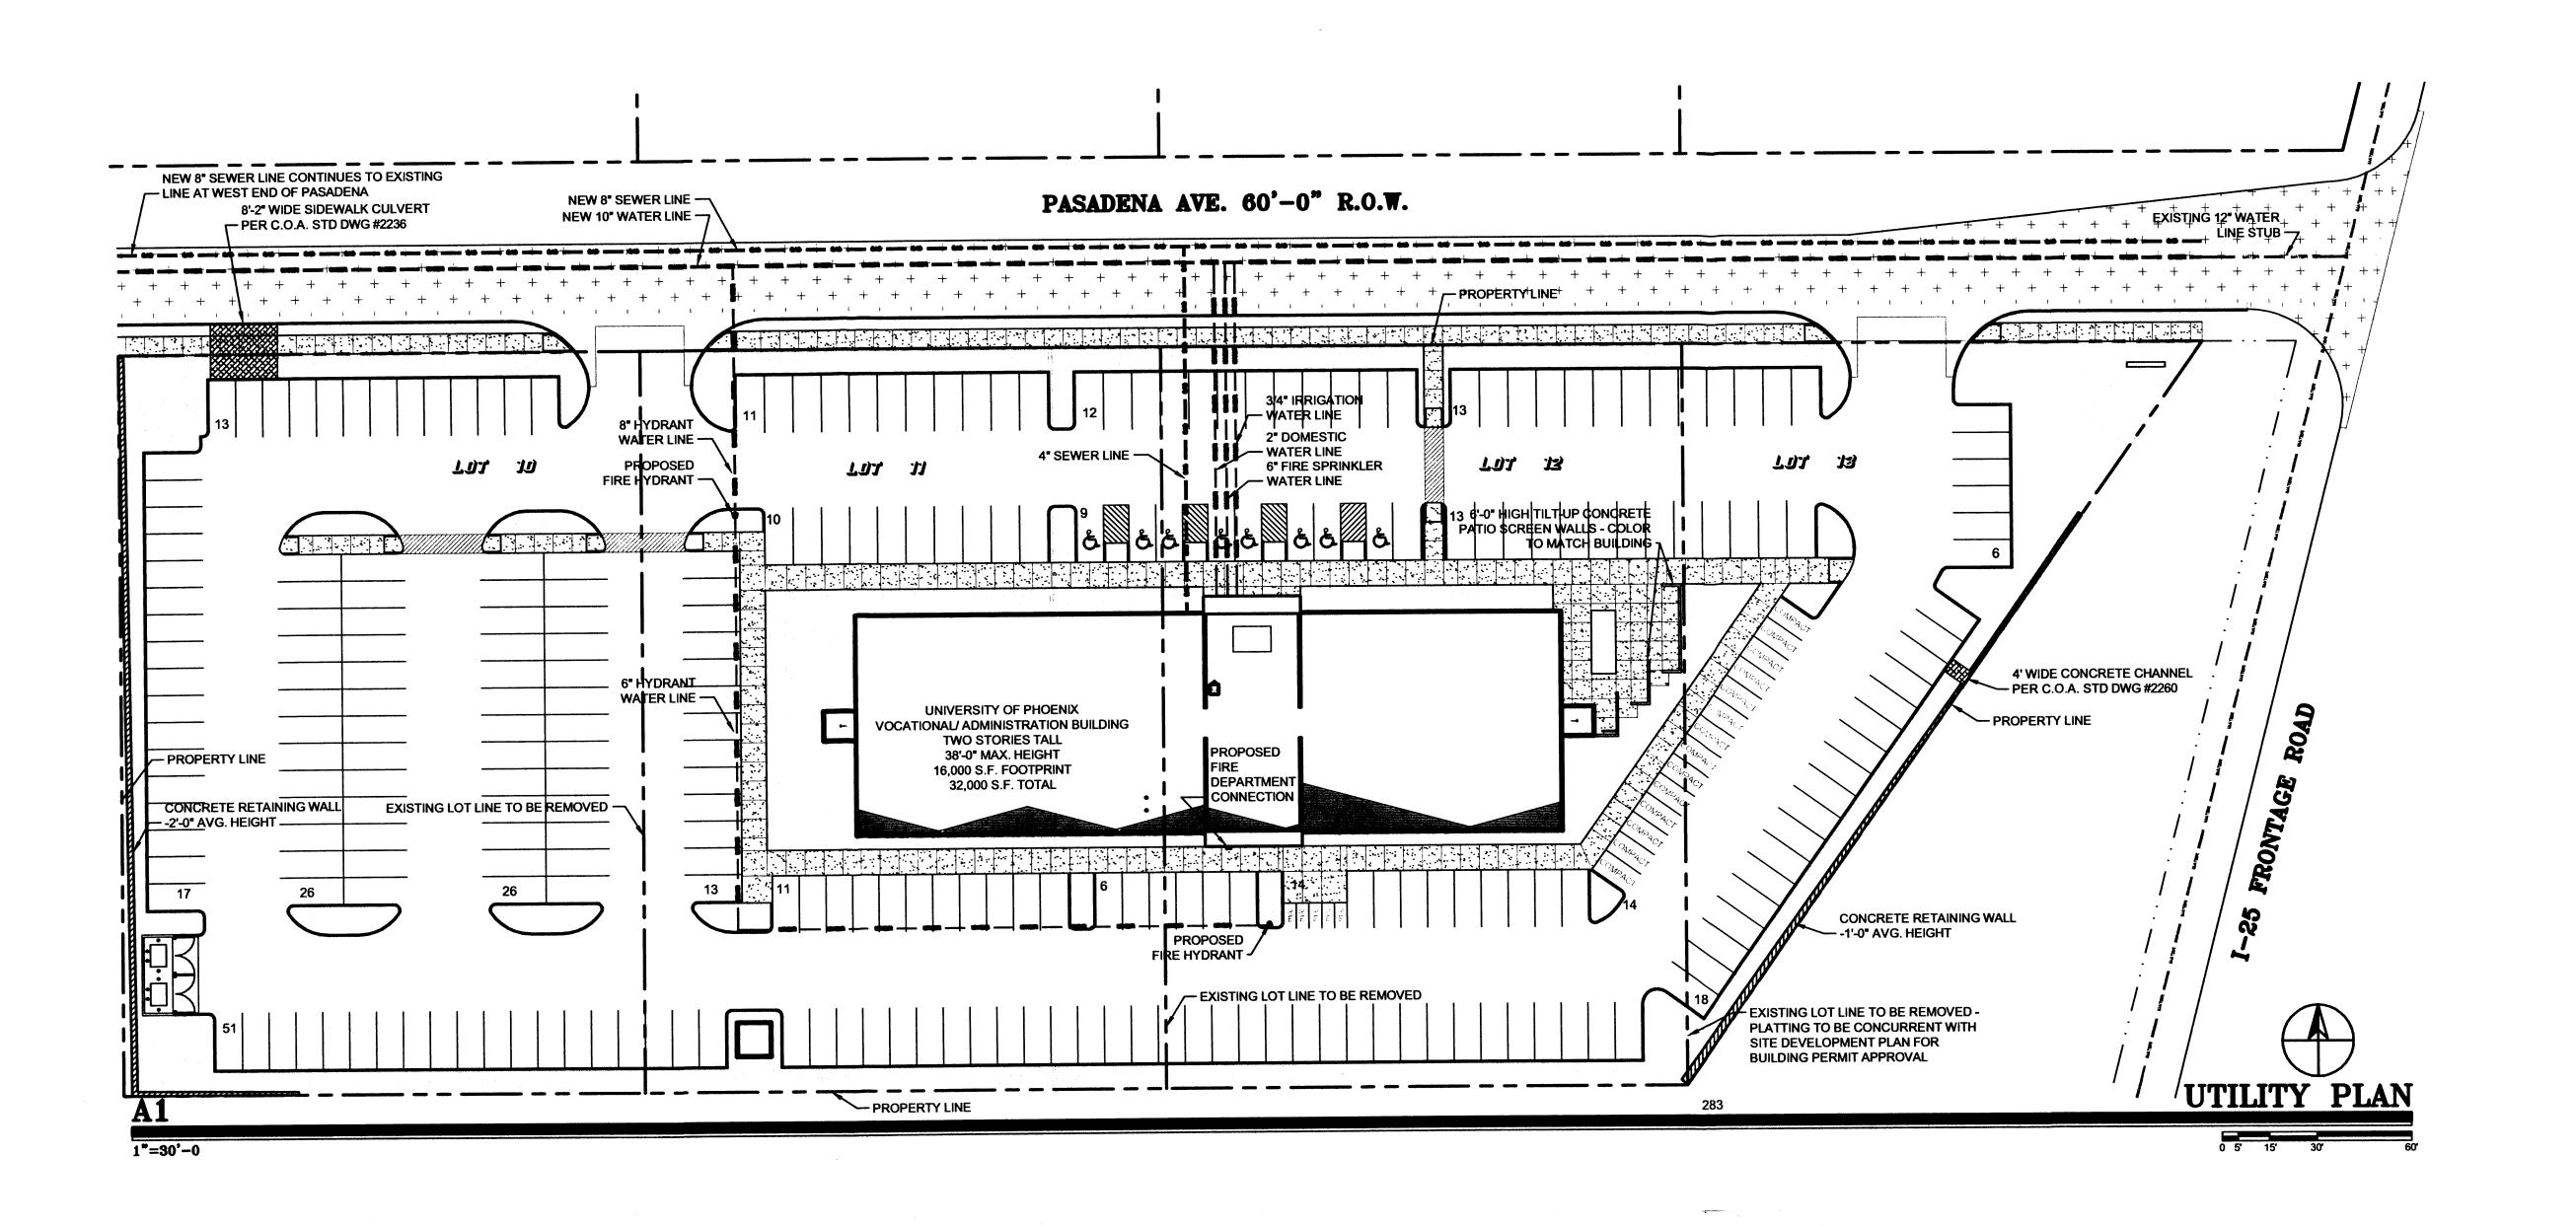
LANDSCAPE PLAN

SHEET NUMBER





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CONSULTANTS

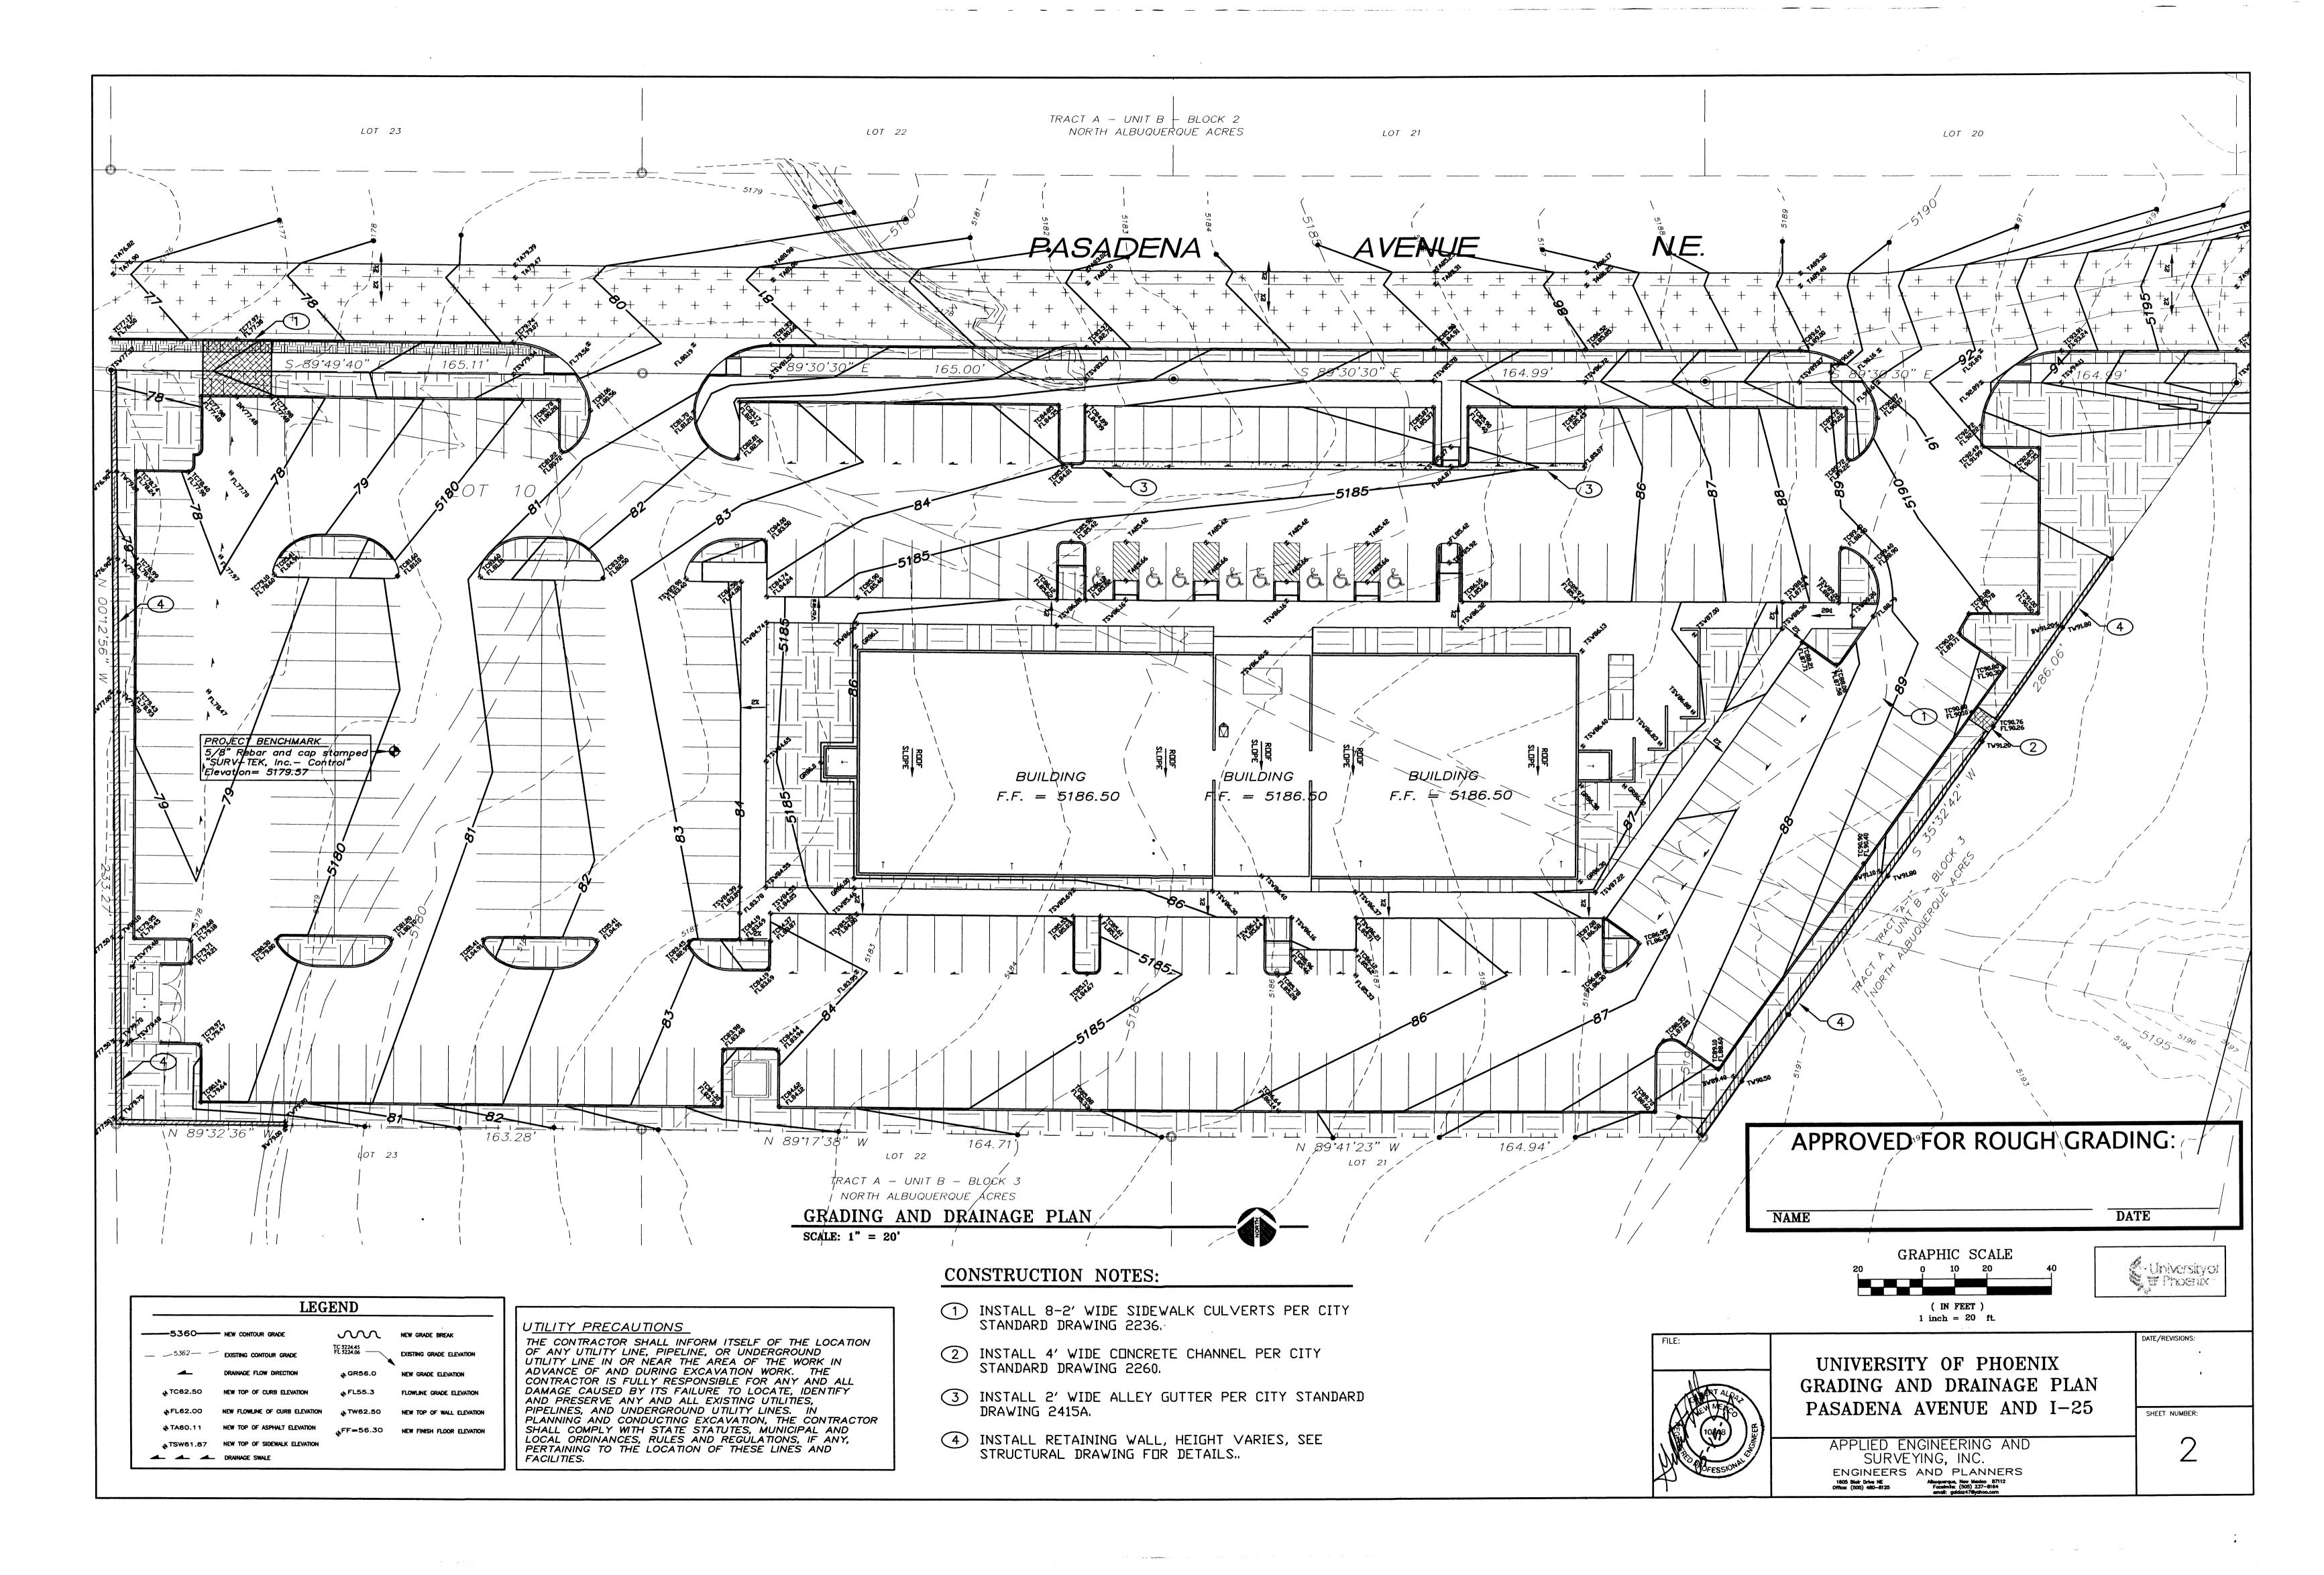

UNIVERSITY OF PHOENIX ADULT EDUCATIONAL FACILITY

BALLOON FIESTA AVE.
ALBUQUERQUE, NEW MEXICO

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SITE DEVELOPMENT
PLAN FOR SUBDIVISION

UTILITY PLAN