

McGraw-Hill Construction Information

Light-Fixture @25' Pole Light

Item	Description	Quantity	Notes
1	25' Pole Light	1	See Detail S4P AS102
2	Light Fixture	1	See Detail S4P AS102
3	Foundation	1	See Detail S4P AS102

LAND LAYOUT

Item	Description	Quantity	Notes
1	Land Area	1	See Detail S4P AS102
2	Site Area	1	See Detail S4P AS102
3	Building Area	1	See Detail S4P AS102

Mesa del Sol Level 'C' Plan
PRELIMINARY PLAN
APPROVED BY DRB
ON _____

General Submittal Requirements

A. WRITTEN SUMMARY

1. TWO STORY GOVERNMENT SERVICES FACILITY WITH FIRST FLOOR OFFICE PARKING, LOADING AND STORAGE FACILITIES AND SECOND FLOOR OFFICES

2. STONE FINISH ELEVATOR AND STAIR TOWERS RECALL THE SALINAS MOUNTAINS SOUTH EAST OF THE SITE, WITH CORNER CANTILEVER ASSEMBLY TO ADDRESS THE INTERSECTION OF FRUIT'S CROSSING

3. THE STUCCO COLORS ARE DESERT TONES AND THE GLAZING TINT WILL BE BLUE REINFORCING THE COLOR OF THE SKY

B. SITE DEVELOPMENT PLAN SHEETS

1. SITE PLAN INCLUDING UTILITIES + EASEMENTS, LIGHTING DATA AS101

2. SITE DETAILS AS102

3. BUILDING + STRUCTURE ELEVATIONS AS103

4. LANDSCAPE PLAN L101

5. PRELIMINARY GRADING PLAN (WATER HARVESTING DATA) C101

6. PRELIMINARY DRAINAGE PLAN (WATER HARVESTING DATA) C102

7. CONCEPTUAL UTILITY PLAN C103

C. 8 1/2 X 11 REDUCTIONS:

1. SITE PLAN INCLUDING UTILITIES + EASEMENTS, LIGHTING DATA AS101

2. SITE DETAILS AS102

3. BUILDING + STRUCTURE ELEVATIONS AS103

4. LANDSCAPE PLAN L101

5. PRELIMINARY GRADING PLAN (WATER HARVESTING DATA) C101

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7. CONCEPTUAL UTILITY PLAN C103

SITE DATA

LEGAL DESCRIPTION

TRACT II INNOVATION PARK, MESA DEL SOL, ALBUQUERQUE, BERNALILLO COUNTY, NEW MEXICO

PROPOSED USAGE: GOVERNMENT OFFICE + PARKING GARAGE (NOT HEATED)

LOT AREA: 21369.88 SF (5.00939 ACRES)

BLDG. AREA: 1ST FLR = 36,388 TOTAL = 12,024
2ND FLR = 35,136

ZONING: SU-2 FC, PLANNED COMMUNITY

PROPOSED FAR: 62005 HEATED FLOOR AREA / LOT AREA (COA ZONING 14-16-1-15) (6231 / 35,136) / 27639.88 + 0.19

BUILDING SETBACK: FRUIT'S CROSSING, VARIES FROM 0' TO 10' MAXIMUM TURNING DRIVE: 52'

THESE SETBACKS ARE DRIVEN BY THE FEDERAL GOVERNMENT STANDARDS FOR THE SECURITY OF THE FACILITY

PARKING REQUIREMENTS: 4780/2000 + 3 SPACES WAREHOUSE
1ST FLOOR REQUIRED 184/200 + 8 SPACES OFFICE
2ND FLOOR REQUIRED 336/11300 + 13 SPACES OFFICE
TOTAL SPACES REQUIRED 214

HC PROVIDED: 8 SPACES
4 STREET SPACES
10 SPACES NON-SECURE
2 SPACES NON-SECURE (1 VAN ACCESSIBLE)
63 SPACES ENCLOSED SECURE
3 SPACES ENCLOSED SECURE (1 VAN)
40 SPACES SECURE
HC PROVIDED: 3 SPACES SECURE (1 VAN ACCESSIBLE)
TOTAL PROVIDED 125 SPACES
125 TOTAL - 4 ON STREET = 121 MORE THAN 18 GSA LEASE REQD. MIN OF ONSITE SPACES

MOTORCYCLE SPACES: 4 REQUIRED PROVIDED SECURE

BICYCLE SPACES: 1 SPACES
REQUIRED 14/20
PROVIDED SECURE + 4 SPACES
PROVIDED ENCLOSED + 2 SPACES (EXCEEDS 10%)
PROVIDED NON-SECURE: 2 SPACES
TOTAL PROVIDED: 8

50 PREFERRED PARKING FOR CAR AND VAN POOL SHALL BE AS ADMINISTERED BY GSA + DEPARTMENT OF JUSTICE SECURITY SERVICES

LANDSCAPE CALCULATIONS: SEE SHP L101

KEY NOTES

- REFUSE BIN ENCLOSURE W/ GATE - SEE ENLARGED PLAN THIS SHEET + ELEVATIONS SHEET AS102
- CARD READER - SET IN CURBED ISLAND W/ CONCRETE FILLED BOLLARDS - SEE DETAIL ROLLING URGENT-IRON GATE SEE DETAILS SHEET AS102
- GRAVELLED BALCONY
- 8 FT HIGH NON-CLIMB FENCE TYPICAL + 50 FT SECURE PERIMETER - SEE DETAIL
- LINE OF 50 FT SECURE PERIMETER OFFSET
- 100 FT MAX SETBACK - SEE ELEVATION + FID EMPLOYMENT CENTER DESIGN STD PGS 2, 3
- ASPHALT PAVING PER GSA REPORT RECOMMENDATIONS
- MERC LANDSCAPE - SEE SHEET L101
- FIRST FLOOR PROGRAM - SEE SHEET PER GSA
- ENCLOSED PARKING ON FIRST FLOOR
- SEMI-TRUCK MANEUVERING SPACE W/ DOCK WELL + LIFT + EXTERIOR SIDE OF OVERHEAD DOOR
- STORM WATER DISCHARGE - SEE SHP C101
- PROPERTY LINE
- 10' WIDE PUBLIC UTILITY EASEMENT
- PROPOSED WATER METER LOCATION
- FIRELINE LOCATION
- PRIVATE FIRE HYDRANT
- POST INDICATOR VALVE LOCATION
- SEWER LINE LOCATION
- DOUBLE CLEARENTH SANITARY SEWER
- EXISTING CURB + GUTTER IN RIGHT-OF-WAY
- EXISTING CURB + PAVING ON ADJACENT PROPERTY
- SCREEN WALL + HVAC UNIT - SEE PLAN THIS SHEET + TYPICAL ELEVATION SHP AS102
- SCREEN WALL + ELECTRICAL TRANSFORMER + GAS METER - SEE PLAN THIS SHEET + TYPICAL ELEVATION SHP AS102
- SCREEN WALL + ELECTRICAL PULL BOX + ABOVE GROUND UNIT + IN-GROUND VALVE IS USED - SEE TYPICAL SCREEN WALL ELEVATION SHP AS102
- EXISTING 6" WIDE CONCRETE SIDEWALK + CURB + GUTTER - ENCROACHES ON PROPERTY
- NEW 6" WIDE CONCRETE SIDEWALK
- ON-STREET PARKING - 8' X 23' TYPICAL
- STANDARD 8' X 20' PARKING SPACE
- 11' HIGH RADIO ANTENNA W/ ONE 1" DIAMETER DISH AFFIXED TO TRUSS TYPE STRUCTURE PER GSA REQUIREMENTS
- CURB CUT W/ 25' RADII + 30" THROAT
- HANDICAPPED ACCESSIBLE PARKING SPACE W/ SIGN PER DETAIL S4P AS102
- VAN ACCESSIBLE SPACE W/ SIGN PER DETAIL S4P AS102
- STANDARD BLUE ACCESSIBLE SYMBOL PAINTED ON ASPHALT
- 6" THICK FLAGSTONE PATTERNEED CONCRETE LOADING ZONE + ACCESSIBLE PATH - COLOR TO MATCH CONCRETE + ENTRY SIDEWALK
- TUBE STEEL TWO BIKE RACK IN PARKING STRUCTURE - SEE DETAIL S4P AS102 (EXCEEDS 10%)
- NOT USED
- 6" WIDE MINIMUM DECORATIVE CONCRETE WALK
- ELECTRICAL TRANSFORMER BY FPM
- GAS METER BY FPM
- ELECTRICAL PULL BOX BY FPM
- 1000# METAL HALIDE FULL CUTOFF FIXTURE IN BOLLARD ARRANGED PER FEDERAL PROTECTIVE SERVICES REQUIREMENTS TO PROVIDE 1 FOOTCANDLE + IN COMPLIANCE W/ DARK SKY ORDINANCE OF NEW MEXICO - SEE BOLLARD DETAIL S4P AS102
- 400# METAL HALIDE FULL CUTOFF SINGLE FIXTURE ATTACHED POLE W/ CONCRETE BASE - MAX HEIGHT OF FIXTURE ABOVE GRADE 25' INCLUDING 30" MAX HT CONCRETE BASE - SEE DETAIL S4P AS102, ARRANGE PER FEDERAL PROTECTIVE SERVICES REQUIREMENTS TO PROVIDE 1 FOOTCANDLE + IN COMPLIANCE W/ DARK SKY ORDINANCE OF NEW MEXICO
- EGRESS TO PUBLIC WAY DUE TO SECURITY CONCERNS, PEDESTRIAN + BIKE ACCESS TO FUTURE OPEN SPACE CORRIDOR MUST BE MADE VIA SIDEWALK + ROADWAY ALONG FRUIT'S CROSSING RIGHT-OF-WAY. WE CANNOT ALLOW OR APPEAR TO ENCOURAGE ACCESS ACROSS THE SITE BY CONNECTIONS TO UNZONED PORTIONS OF THE SITE NOR BY PROVIDING A GATE THROUGH THE SECURITY FENCE
- SECURITY GATE W/ ELECTRIC STRIKE + PROXIMITY READER
- EXISTING FIRE HYDRANT
- FIRE DEPARTMENT CONNECTION

General Services Administration

2660 FRUIT'S CROSSING SE.
ALBUQUERQUE, NEW MEXICO 87106

STATE OF NEW MEXICO
LLOYD W. GOLDRICK
No. 2327
REGISTERED ARCHITECT

SITE PLAN
SHEET NO. AS101
JOB NO. : 08-119

City Project # 1006005

DURA BILT Products, Inc.
DESIGN / BUILDER Since 1950
LICENSE NO. 32-44

4808 JEFFERSON NE.
ALBUQUERQUE NM, 87109
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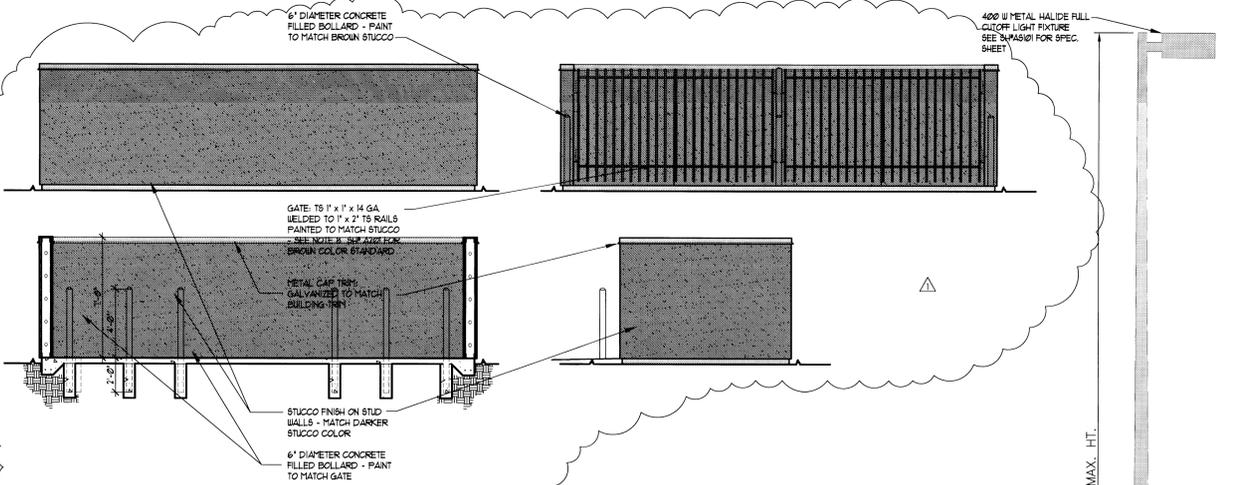
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DATE: 28 JUL 2008
PLOT DATE: 1 AUG 2009

REVISIONS:


- 1. 8/1/09 ARC LETTER RESPONSE
- 2. 10/3/09 ARC LETTER RESPONSE
- 3. 10/30/09 DRB COMMENTS RESPONSE

FILE: AS101.DWG




REFUSE BIN ELEVATIONS

1/4" = 1'-0"
0 2' 4' 8'

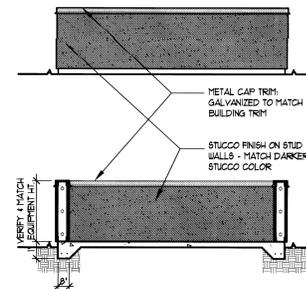


SCREEN WALL - TYPICAL

1/4" = 1'-0"
0 2' 4' 8'

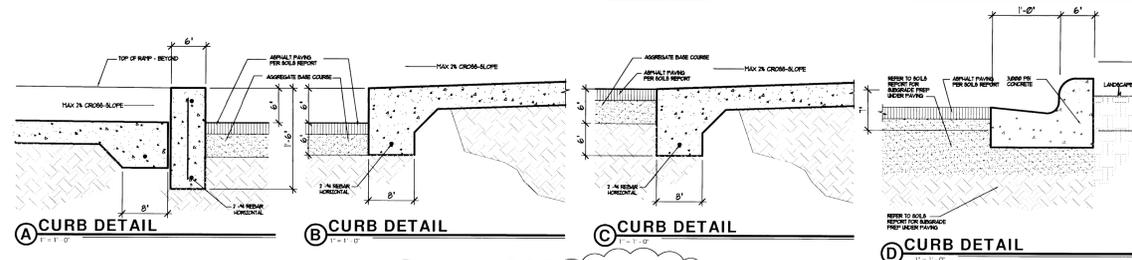

A CURB DETAIL B CURB DETAIL C CURB DETAIL D CURB DETAIL

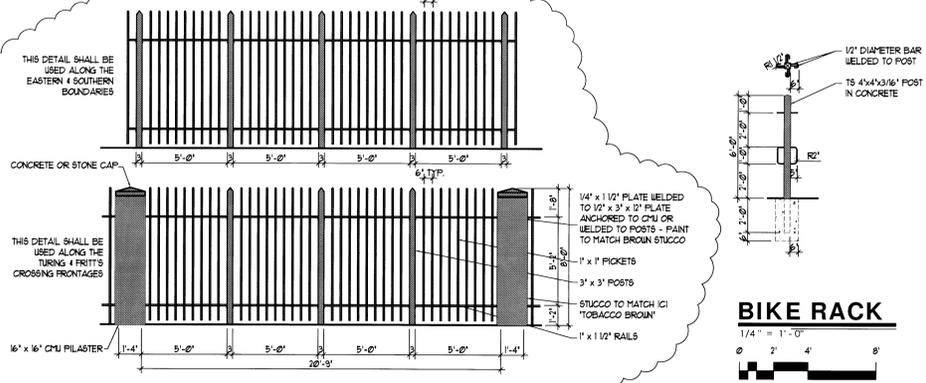


SECURITY FENCE - TYPICAL

1/4" = 1'-0"
0 2' 4' 8'

BIKE RACK

1/4" = 1'-0"
0 2' 4' 8'

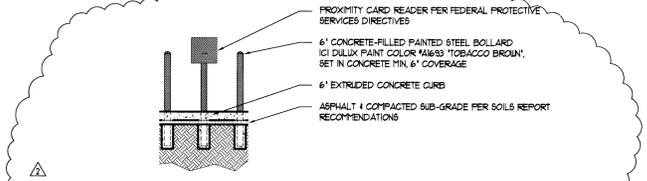


CARD READER SECTION

1/4" = 1'-0"
0 2' 4' 8'


LIGHT & POLE

NO SCALE

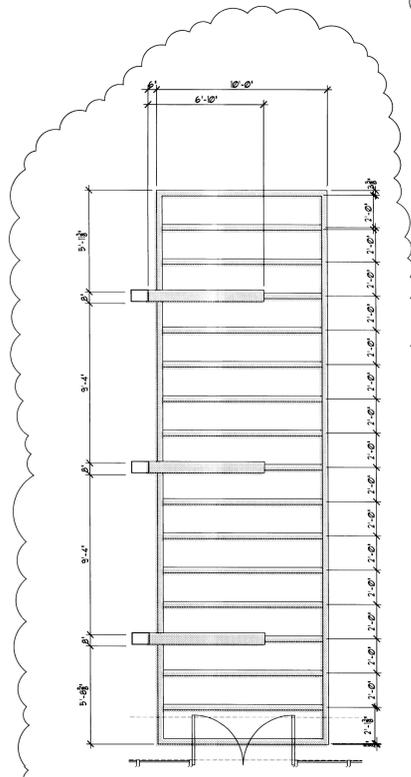


ENTRY TRELLIS - PLAN

1/4" = 1'-0"
0 2' 4' 8'

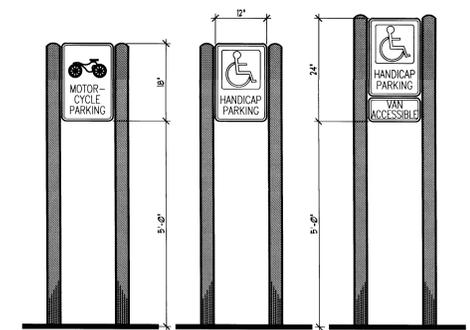


SIGNAGE

NO SCALE

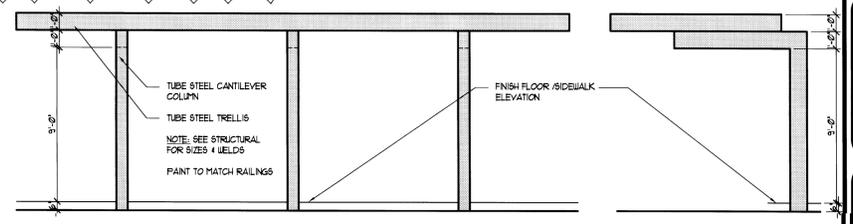

ENTRY TRELLIS - ELEVATIONS

1/4" = 1'-0"
0 2' 4' 8'

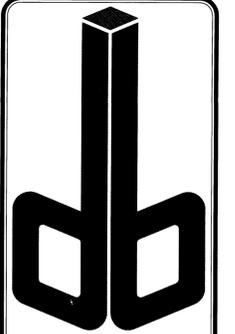

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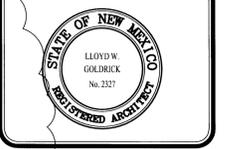
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DATE: 28 JUL 2008
PLOT DATE: 4 AUG 2009


REVISIONS:
A - 87109 ARC LETTER RESPONSE
B - 12310 DRB LETTER RESPONSE
C -
D -
E -
FILE: AS-102.DWG

OFFICE FACILITY PROVIDED BY
SEVEN PROPERTIES LLP FOR
General Services Administration
2660 FRITT'S CROSSING SE.
ALBUQUERQUE, NEW MEXICO 87106



SITE DETAILS

SHEET NO.
AS102
JOB NO. : 08-119

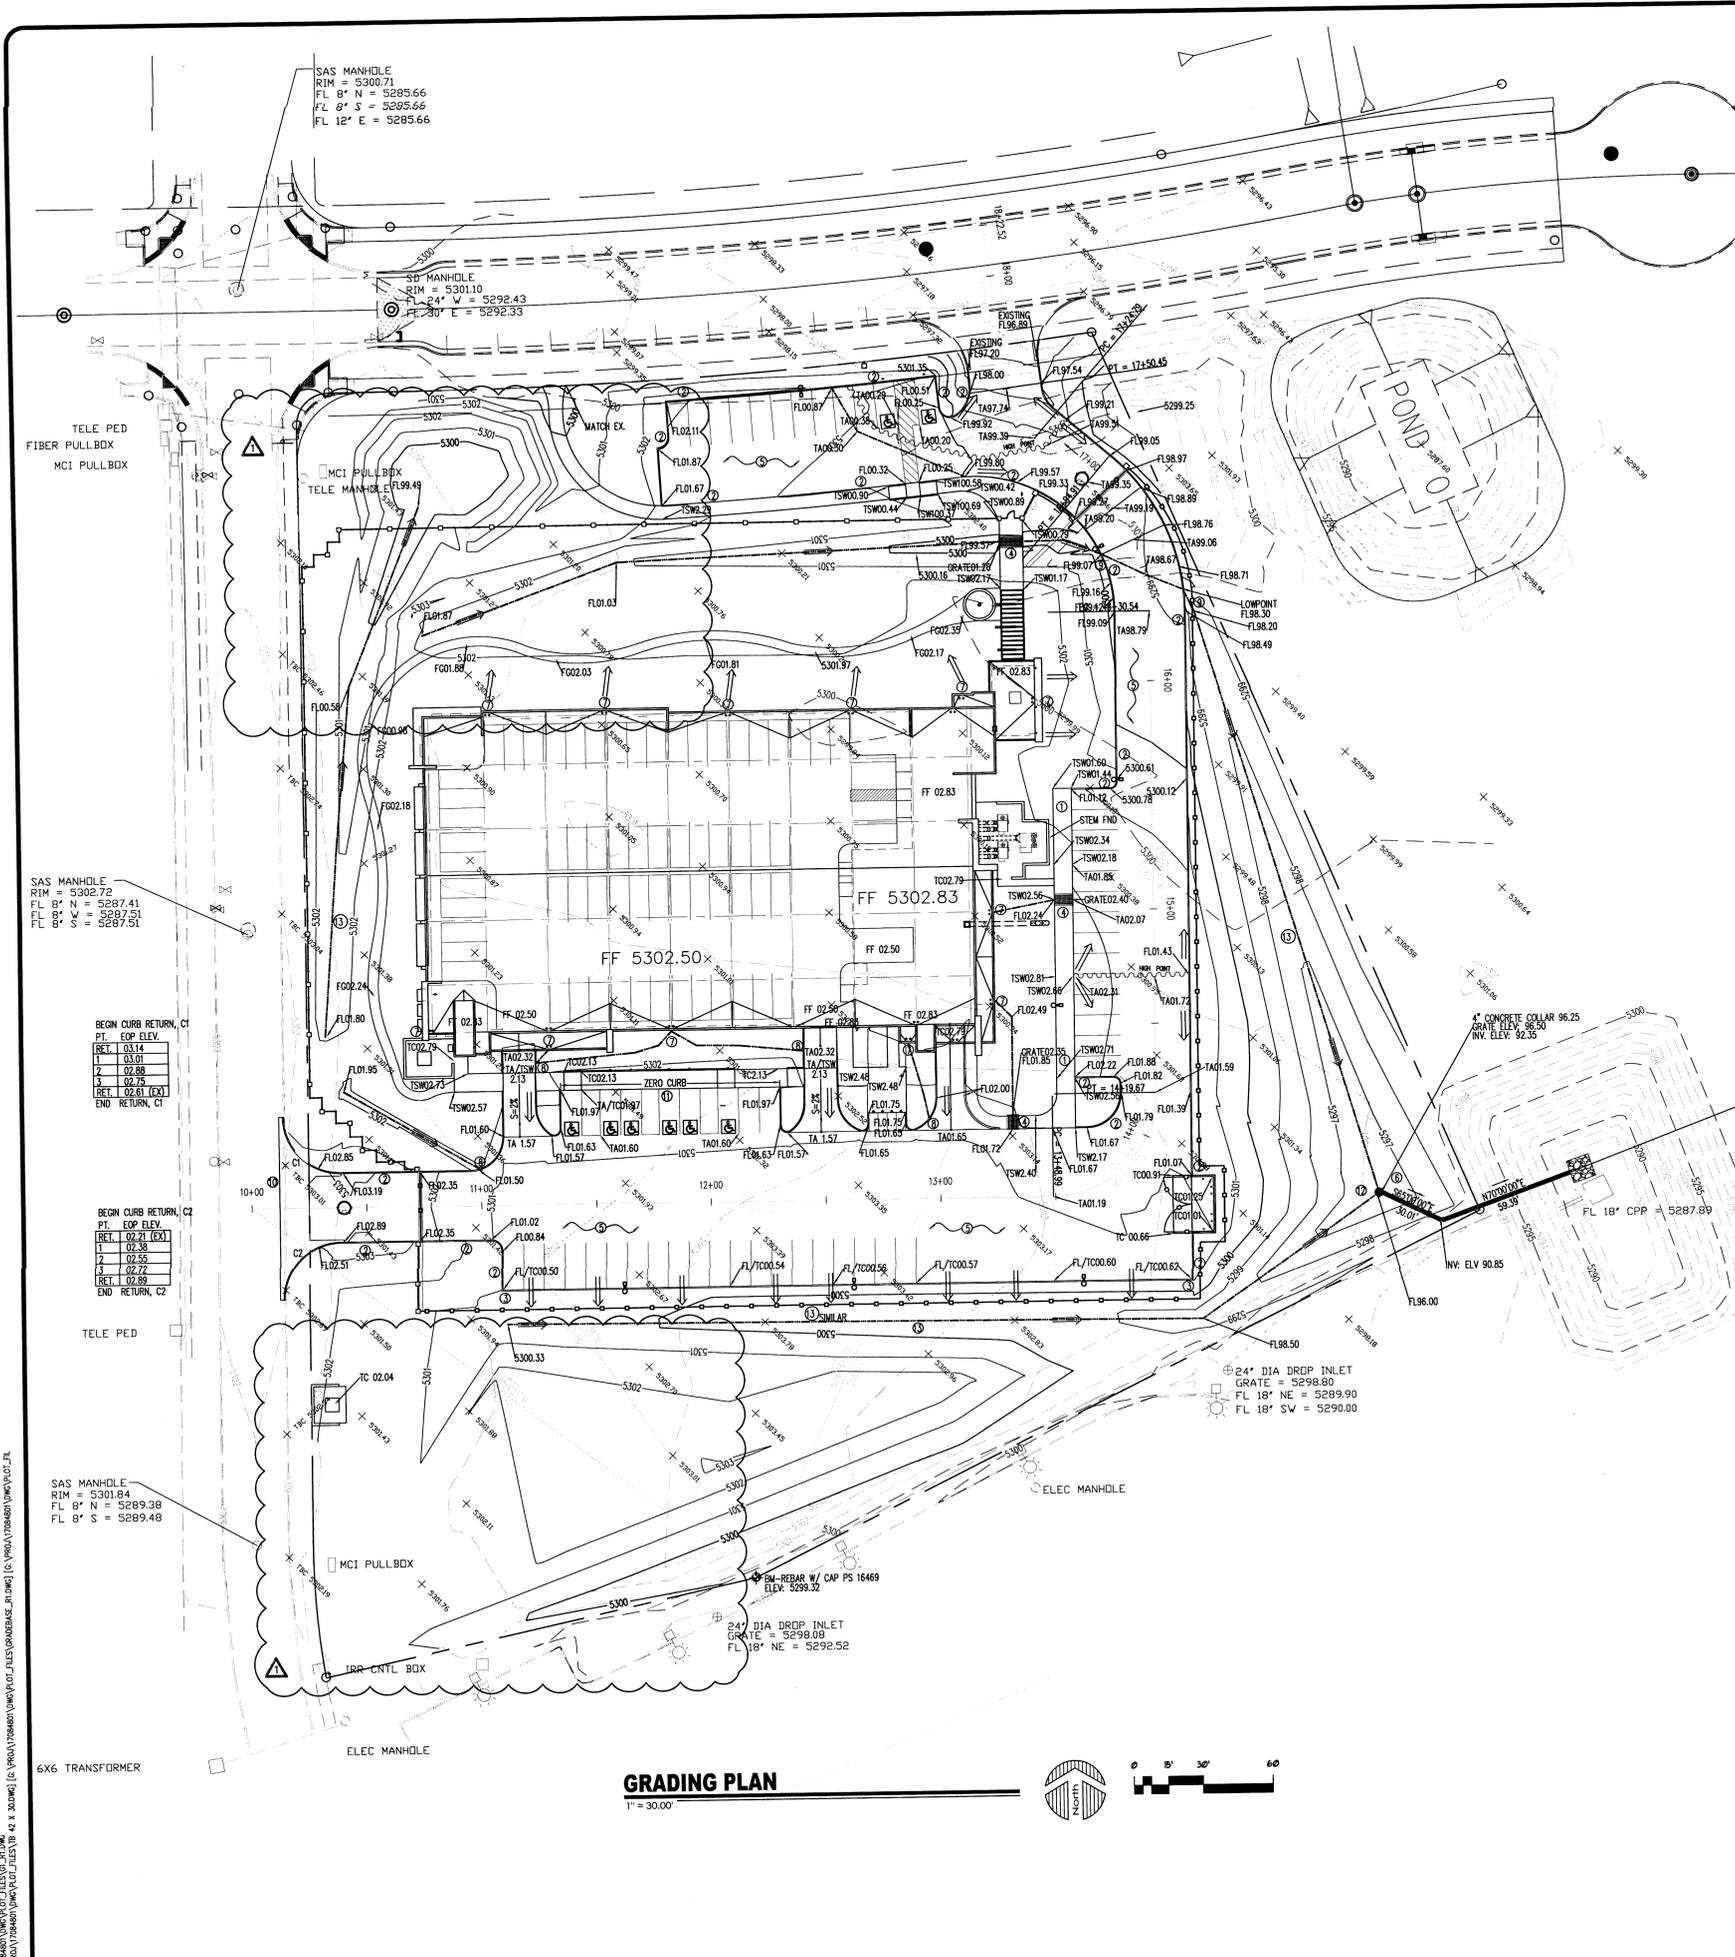

SOURCE OF EXISTING SURVEY

TOPOGRAPHIC SURVEY PERFORMED BY HUITT-ZOLLARS, INC. DATED JULY 10, 2008

KEYED NOTES

1. CONSTRUCT 6" TURN DOWN SIDEWALK
2. CONSTRUCT MEDIAN CURB & GUTTER STD. DWG 2415 B
3. CONSTRUCT CONCRETE CUTOFF WALL 8"x24" - COA STD. DWG 2415 B
4. CONSTRUCT 24" SIDEWALK CURB - COA STD. DWG 2236 - SIMILAR
5. 3" SP-III ASPHALT PAVEMENT OVER 4" TYPE 1 AGG. B.C. OVER 12" SUBGRADE PREPARATION
6. 24" HOPE-CULVERT
7. SPLASH BLOCK - SEE LANDSCAPE/ARCH PLANS
8. 1" WIDE CURB OPENING
9. 2" WIDE CURB OPENING
10. 4" VALLEY GUTTER - COA STD. DWG 2420
11. ZERO CURB
12. POND OUTLET - MANUFACTURER NEENAH MODEL R-2510-A 10x10" TYPE XL RIP RAP 12" DEEP
13. EARTHEN SWALE - 4 FOOT BOTTOM WITH 4:1 SIDESLOPES AND 1-FOOT DEEP

GENERAL NOTES

1. PRIOR TO ANY CONSTRUCTION, THE CONTRACTOR SHALL EXCAVATE AND VERIFY THE LOCATION OF ALL POTENTIAL OBSTRUCTIONS. SHOULD A CONFLICT EXIST, THE CONTRACTOR SHALL NOTIFY THE ENGINEER AS SOON AS POSSIBLE TO RESOLVE THE CONFLICT WITH A MINIMUM AMOUNT OF DELAY.
2. ALL WORK ON THIS PLAN SHALL BE PERFORMED IN ACCORDANCE WITH APPLICABLE FEDERAL, STATE AND LOCAL LAWS, RULES AND REGULATIONS CONCERNING CONSTRUCTION SAFETY AND HEALTH.
3. IF ANY UTILITY LINES, PIPELINES, OR UNDERGROUND UTILITY LINES ARE SHOWN ON THESE DRAWINGS, THEY ARE SHOWN IN AN APPROXIMATE LOCATION ONLY, AND LINES MAY EXIST WHERE NONE ARE SHOWN. THE LOCATION IS BASED UPON INFORMATION PROVIDED BY THE UTILITY OWNER OR FROM EXISTING PLANS, AND THIS INFORMATION MAY BE INCOMPLETE OR OBSOLETE AT THE TIME OF CONSTRUCTION. THE ENGINEER HAS NOT UNDERTAKEN ANY FIELD VERIFICATION OF THESE LOCATIONS, LINE SIZES OR MATERIAL TYPE. MAKES NO REPRESENTATION THERE TO, AND ASSUMES NO RESPONSIBILITY OR LIABILITY THEREFOR. THE CONTRACTOR SHALL INFORM ITSELF OF THE LOCATION OF ANY UTILITY LINE, PIPELINE OR UNDERGROUND INSTALLATION IN OR NEAR THE AREA IN ADVANCE OF AND DURING ANY EXCAVATION WORK. THE CONTRACTOR IS FULLY RESPONSIBLE FOR ANY AND ALL DAMAGES CAUSED BY ITS FAILURE TO LOCATE, IDENTIFY AND PRESERVE ANY AND ALL EXISTING UTILITIES, PIPELINES AND UNDERGROUND FACILITIES. IN PLANNING AND CONDUCTING EXCAVATIONS, THE CONTRACTOR SHALL COMPLY WITH ALL STATE STATUTES, MUNICIPAL AND LOCAL ORDINANCES, RULES AND REGULATIONS, IF ANY, PERTAINING TO THE LOCATION OF THESE LINES AND FACILITIES.
4. THE CONTRACTOR SHALL INSURE THAT NO SOIL ERODES FROM THE SITE INTO PUBLIC RIGHT-OF-WAY OR ONTO PRIVATE PROPERTY. THIS CAN BE ACHIEVED BY CONSTRUCTING TEMPORARY BERMS AND BY WETTING THE SOIL TO KEEP IT FROM BLOWING.
5. THE CONTRACTOR SHALL OBTAIN ANY AND ALL PERMITS REQUIRED BY BERNALILLO COUNTY FOR THE COMPLETION OF THE WORK PRIOR TO BEGINNING CONSTRUCTION.

GENERAL LEGEND

EXISTING CONTOUR	---	5290
EXISTING SPOT ELEVATION	+	5300.92
EXISTING SPOT ELEVATION	+	
EXISTING FIREHYDRANT	⊗	
EXISTING WATERVALVE	⊗	
EXISTING WATERLINE	---	
EXISTING MANHOLE	⊙	
EXISTING SANITARY SEWER LINE	---	
EXISTING LIGHT	⊙	
EXISTING ELECTRICAL EQUIPMENT	⊙	
PROPOSED SPOT ELEVATION	+	TC 40.00
WATER BLOCK	⊕	
EXISTING GROUND ELEVATION	+	5301.69
FLOW DIRECTION ARROW	→	
FLOW LINE ELEVATION	FL	
TOP OF CONCRETE	TC	
TOP OF ASPHALT	TA	
FINISHED FLOOR	FF	
INVERT	INV	
TOP OF GRATE	TG	
BENCH MARK	⊕	
PROPERTY CORNERS	⊕	
PROPOSED STORMDRAIN	---	
PROPOSED CURB AND GUTTER	---	
PROPOSED SIDEWALK	---	

BENCHMARK

THE STATION MARK IS A CITY OF ALBUQUERQUE SURVEY CONTROL 2-R15 A
 THE LOCAL BENCHMARK IS A PROPERTY CORNER ON THE SOUTH PROPERTY LINE AT THE ANGLE POINT. REBAR WITH CAP PS 1649
 NORTHING 1454441.9930
 EASTING 1530674.4370
 ELEVATION 5299.32

LEGAL DESCRIPTION

TRACT 11, INNOVATION PARK II, MESA DEL SOL




VICINITY MAP - ZONE ATLAS R-16

ENGINEER'S CERTIFICATION

I PERSONALLY INSPECTED THIS SITE AND NO GRADING, FILLING, OR EXCAVATION HAS OCCURRED SINCE THE PREPARATION OF THE TOPOGRAPHY SHOWN ON THIS PLAN.

FLOOD ZONE

THIS PROPERTY DOES LIE IN AN AREA COVERED BY A FORMAL F.E.M.A. FLOOD STUDY. PROPERTY LIES WITHIN ZONE 'X' (FLOOD HAZARD) AND IS NOT SUBJECT TO 100-YR FLOOD HAZARDS. REFERENCE: FLOOD INSURANCE RATE MAP, ALBUQUERQUE, NEW MEXICO PANEL 3500100556 EFFECTIVE DATE: SEPTEMBER 26, 2008.

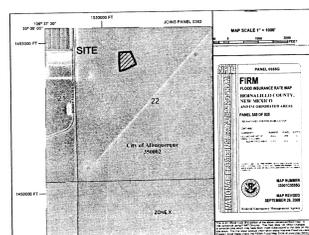

DURA BILT
Products, Inc.
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 Since 1950
 LICENSE NO. 3244

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REVISION - GRADING REVISION 12/10

OFFICE FACILITY PROVIDED BY
 SEVEN PROPERTIES LLP FOR
General Services Administration
 5600 TURING DRIVE S.E.
 ALBUQUERQUE, NEW MEXICO 87106

Designed By
HUITT-ZOLLARS
 Rio Rancho
 333 Rio Rancho Drive NE, Suite 101
 Rio Rancho, New Mexico 87104
 Phone (505) 892-5141 Fax (505) 892-3259



GRADING PLAN
 SHEET NO. **C101**

04.02.2010 2:11:08pm - User: addings
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DATE: 28 JUL 2008
PLOT DATE: 08 JUL 2009
REVISIONS:
1. 08-11-09

OFFICE FACILITY PROVIDED BY
SEVEN PROPERTIES LLP FOR
General Services Administration
2660 FRITTS CROSSING SE.
ALBUQUERQUE, NEW MEXICO 87106

PLANT LEGEND/FRITTS STREETSCAPE

Qty.	Symbol	Scientific Name Common Name	Installed Size	Mature Height/Spread	Landscape Coverage	Water Use	Drip Emitters Per Plant (see note)
Trees							
8	(Symbol)	Platanus Chinese Platanus	2 1/2" B&B	40/30'		Medium	6-2 gph
2	(Symbol)	Gleditsia triacanthos 'inermis' Thornless Honey Locust	2 1/2" B&B	80/80'		Medium	6-2 gph
Shrubs/Groundcovers							
24	(Symbol)	Rhus trilobata Three Leaf Sumac	5-Gal	6/6'	50 sf=1200 sf	Medium	2-2 gph
20	(Symbol)	Dasylirion Sotol	5-Gal	5/5'	20 sf=400 sf	Low+	2-1 gph
Ornamental Grasses							
38	(Symbol)	Muhlenbergia rigens Deer Grass	1-Gal	4/4'	20 sf=780 sf	Medium	2-2 gph

Total landscape coverage=2,360 sf
Required landscape coverage (30%)
Landscape area 2,350 sf x 30%=705 sf

PLANT LEGEND/TURING STREETScape


Qty.	Symbol	Scientific Name Common Name	Installed Size	Mature Height/Spread	Landscape Coverage	Water Use	Drip Emitters Per Plant (see note)
Trees							
1	(Symbol)	Gleditsia triacanthos 'inermis' Thornless Honey Locust	2 1/2" B&B	80/80'		Medium	6-2 gph
7	(Symbol)	Fraxinus velutina 'Modesto' Modesto Ash	2 1/2" B&B	40/40'		Medium+	6-2 gph
4	(Symbol)	Sophora japonica Japanese Pagoda Tree	2 1/2" B&B	35/35'		Medium	6-2 gph
Shrubs/Groundcovers							
26	(Symbol)	Artemisia frigida Fringed Sage	5-Gal	2/2'	18 sf=468 sf	Low+	2-1 gph
32	(Symbol)	Agave palmeri Palmer's Agave	5-Gal	3/4'	18 sf=576 sf	Low	2-1 gph

Total landscape coverage=1,044 sf
Required landscape coverage (30%)
Landscape area 1,825 sf x 30%=547 sf

PLANT LEGEND

Qty.	Symbol	Scientific Name Common Name	Installed Size	Mature Height/Spread	Landscape Coverage	Water Use	Drip Emitters Per Plant (see note)
Trees							
20	(Symbol)	Chilopsis linearis Desert Willow	15 Gal	20/25'		Low +	4-2 gph
18	(Symbol)	Quercus buckleyi Texas Red Oak	2" B&B	35/35'		Medium	6-2 gph
25	(Symbol)	Forsythia neomexicana New Mexico Olive	15 Gal	15/15'		Medium	6-2 gph
8	(Symbol)	Pinus nigra Austrian Pine	2" B&B	35/25'		Medium	6-2 gph
15	(Symbol)	Vitex agnus-castus Chaste Tree	15 Gal	20/20'		Medium	6-2 gph
11	(Symbol)	Quercus gambellii Gambel Oak	15 Gal	25/25'		Medium	6-2 gph
14	(Symbol)	Juniperus monosperma One Seed Juniper	15 Gal	15/15'		Low	4-1 gph
Shrubs/Groundcovers							
27	(Symbol)	Buddleia davidii Butterfly Bush	1-Gal	5/5'	20 sf=540 sf	Medium	2-2 gph
60	(Symbol)	Caryopteris clandonensis Blue Mist	1-Gal	3/3'	32 sf=1920 sf	Medium	2-2 gph
75	(Symbol)	Vauquelinia Rosewood	5-Gal	15/8'	50 sf=3750 sf	Low+	2-1 gph
48	(Symbol)	Prunus besseyi Sand Cherry	5-Gal	3/3'	25 sf=1200 sf	Medium	2-2 gph
19	(Symbol)	Ericameria nauseosus Chamisa	1-Gal	5/5'	32 sf=608 sf	Low	2-1 gph
33	(Symbol)	Fallugia paradoxa Apache Plume	1-Gal	6/7'	25 sf=825 sf	Low	2-1 gph
49	(Symbol)	Hesperaloe parviflora Red Yucca	5-Gal	3/4'	15 sf=735 sf	Low+	2-1 gph
68	(Symbol)	Rhus trilobata Three Leaf Sumac	1-Gal	6/6'	50 sf=3400 sf	Medium	2-2 gph
94	(Symbol)	Artemisia frigida Fringed Sage	1-Gal	2/2'	18 sf=1692 sf	Low+	2-1 gph
Ornamental Grasses							
53	(Symbol)	Muhlenbergia rigens Deer Grass	1-Gal	4/4'	20 sf=1060 sf	Medium	2-2 gph
21	(Symbol)	Nolina microcarpa Bear Grass	5-Gal	5/6'	18 sf=378 sf	Low+	2-1 gph
98	(Symbol)	Nassella tenuissima Thread Grass	1-Gal	2/2'	8 sf=464 sf	Low+	2-1 gph
57	(Symbol)	Schizachyrium scoparium Little Bluestem	5-Gal	2/3'	12 sf=684 sf	Medium	2-2 gph

Total landscape coverage=17,256 sf

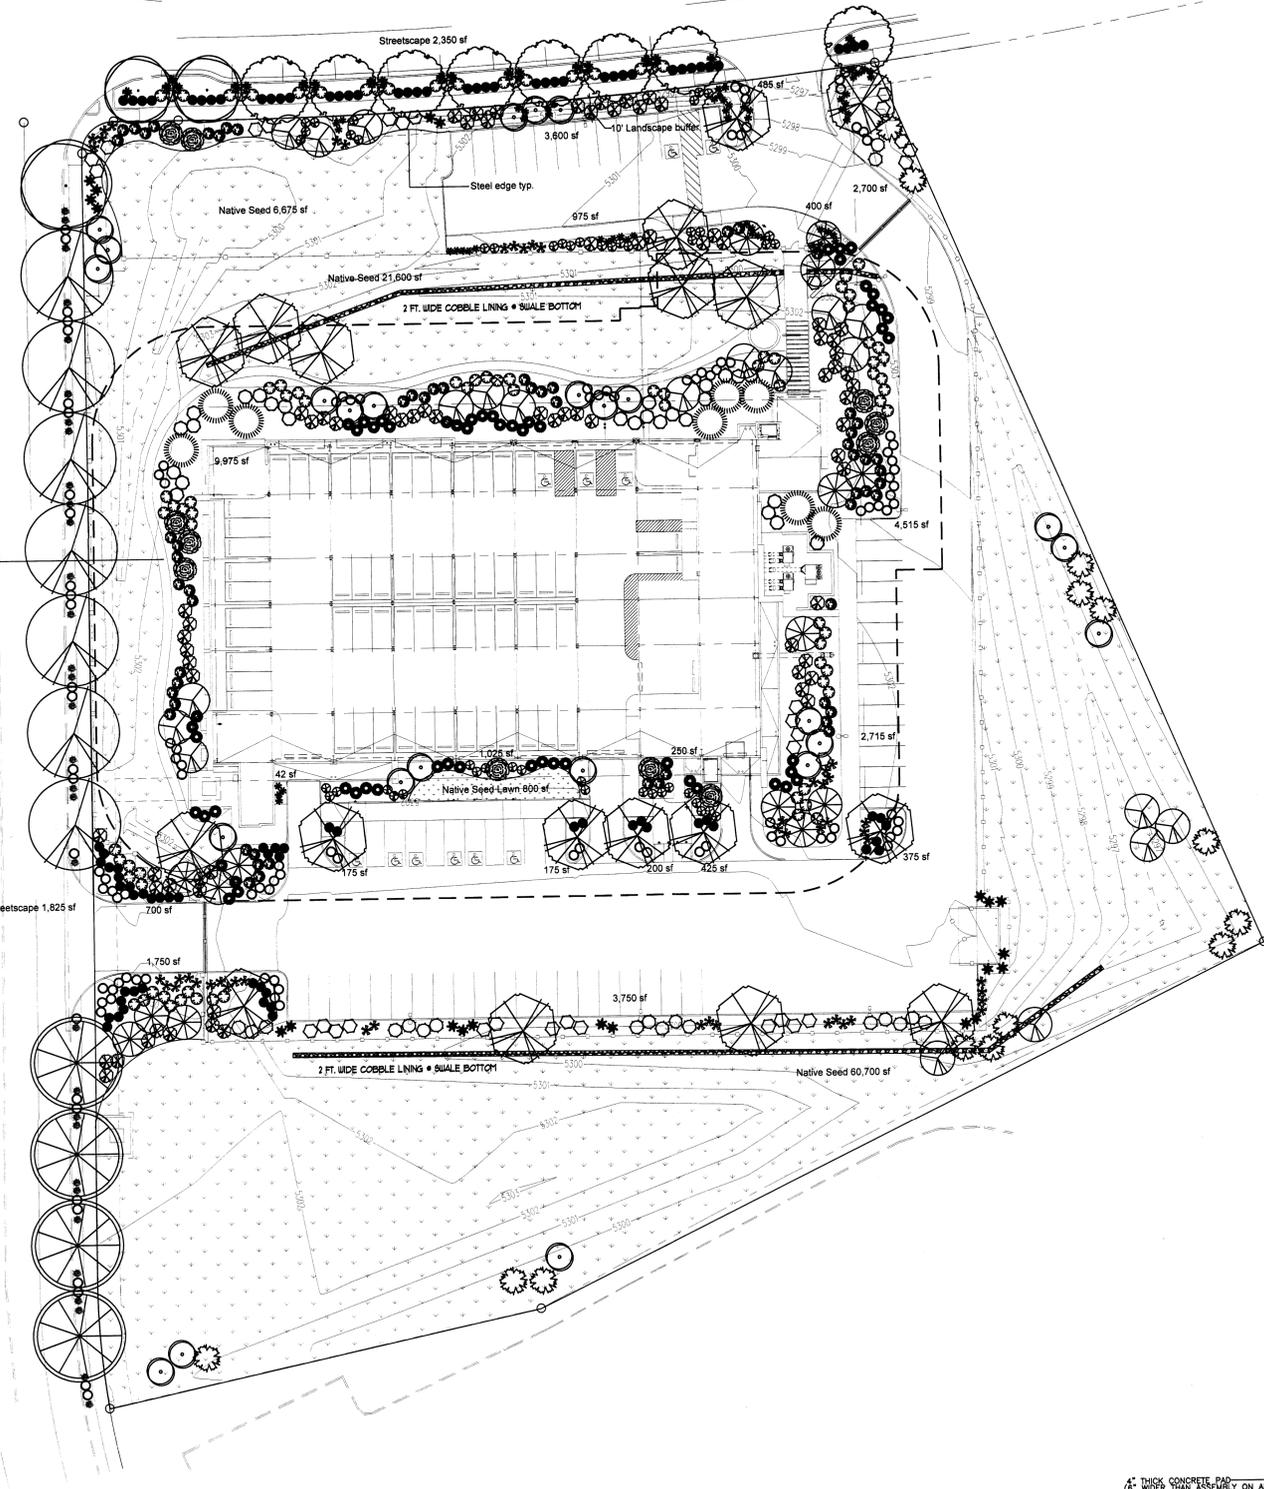

LANDSCAPE DATA

GROSS LOT AREA	217,968 SF
LESS BUILDINGS	36,388 SF
NET LOT AREA	181,581 SF
REQUIRED LANDSCAPE 15% OF NET LOT AREA	27,237 SF
PROPOSED LANDSCAPE PERCENT OF NET LOT AREA	127,104 SF 68 %
REQUIRED STREET TREES PROVIDED AT 30/40' O.C. SPACING STREET	22
REQUIRED PARKING LOT TREES PROVIDED AT 1 PER 10 SPACES (62 SPACES/10)	6
TOTAL REQUIRED TREES	28
TOTAL PROPOSED TREES	48
REQUIRED LANDSCAPE COVERAGE 75% LIVE VEGETATIVE MATERIAL (124,830 SF x 75%)	93,623 SF MIN.
NATIVE SEED LAWN COVERAGE/100%	800 SF
NATIVE SEED COVERAGE/100%	88,875 SF
PLANTING AREA/75% COVERAGE MIN. PROVIDED LANDSCAPE COVERAGE	17,256 SF 107,031 SF (64%)

NOTE

MAINTENANCE OF LANDSCAPE AND IRRIGATION IS THE RESPONSIBILITY OF THE OWNER

PLANTINGS TO BE WATERED BY AUTO. DRIP IRRIGATION SYSTEM SUPPLIED BY DRIP IRRIGATION SYSTEM AND PROTECTED WITH REDUCED PRESSURE BACKFLOW PREVENTER (WILKINS MODEL 975) PER CITY OF ALBUQUERQUE

WATER MANAGEMENT IS THE SOLE RESPONSIBILITY OF THE PROPERTY OWNER

THIS PLAN IS TO COMPLY WITH C.O.A. LANDSCAPE AND WATER WASTE ORDINANCE AND POLLEN ORDINANCE

THIS PLAN SHALL PROVIDE AT MINIMUM 75% LIVE GROUND COVER OF LANDSCAPE AREAS AT MATURITY

LANDSCAPE AREAS TO BE MULCHED WITH SANTA FE BROWN CRUSHER FINES MULCH AT 3" DEPTH

APPROVAL OF THE LANDSCAPE PLAN DOES NOT CONSTITUTE OR IMPLY COMPLIANCE WITH, OR EXEMPTION FROM, THE C.O.A. LANDSCAPE AND WATER WASTE ORDINANCE (6-1-1-1)

TREES ARE NOT TO BE PLACED IN PUBLIC UTILITY EASEMENTS

NO PARKING SPACE SHALL BE MORE THAN 10' FROM A TREE.

NATIVE SEED TO BE HOMESTEADERS CHOICE SEEDS AT 25 LB PER ACRE AND DRILL SEEDS A TEMPORARY SPRAY IRRIGATION SYSTEM WILL BE USED TO ESTABLISH AND MAINTAIN NATIVE SEED.

NATIVE SEED LAWN TO BE NATIVE WONDER SEEDS AT 2 LB PER 1000 SF AND BROADCAST SEEDS A PERMANENT SPRAY IRRIGATION SYSTEM WILL BE USED TO IRRIGATE NATIVE SEED LAWN.


ACTUAL BERM SIZE AND LOCATIONS TO BE DETERMINED BY AMOUNT OF SOIL GENERATED BY CONSTRUCTION.

NOTE

DRIP SYSTEM RUN CYCLES:
ESTABLISHMENT AND SUMMER:
1 HOUR/4 DAYS A WEEK
SPRING:
1 HOUR/3 DAYS A WEEK
FALL:
1 HOUR/3 DAYS A WEEK
WINTER:
1 HOUR/2 DAYS PER MONTH


LANDSCAPE PLAN

1" = 30' - 0"

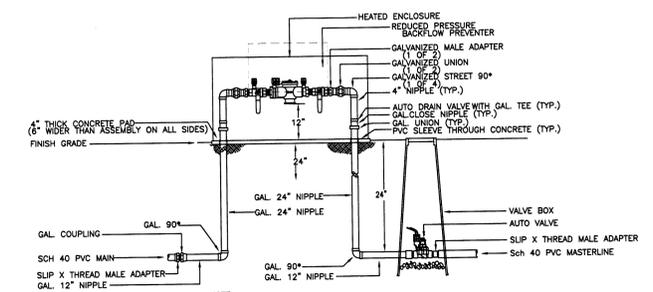

NOTE: 1. INSTALL BACKFLOW PREVENTER AS REQUIRED BY LOCAL CODES AND HEALTH DEPARTMENT. VERIFY LOCAL REQUIREMENTS PRIOR TO INSTALLATION.

RP BACKFLOW/MASTER VALVE DETAIL
PER C.O.A.

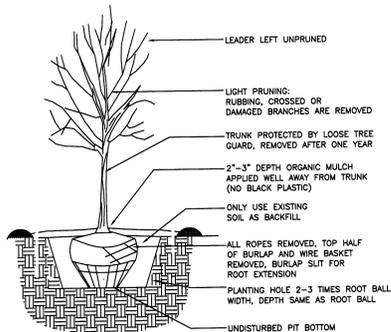

TREE PLANTING DETAIL
PER C.O.A. FORESTER

LANDSCAPE PLAN

SHEET NO.

L101

JOB NO. 08-19