## DRAWING INDEX

DWG.No. DESCRIPTIONS

**COVER SHEET** 

SITE PLAN - FULL BUILD OUT PLAZA ENLARGEMENT PHASING PLAN

LANDSCAPE PLAN COURTYARD LANDSCAPE PLAN & TREE DETAILS WATER HARVESTING PLAN LANDSCAPE PLAN - PHASE I SITE FURNISHINGS AND FINISHES

SITE PLAN - PHASE I

GRADING PLAN UTILITY PLAN


**BUILDING EXTERIOR ELEVATIONS ROOF PLAN** 

**ELECTRICAL SITE LIGHTING** 

ROOF DETAILS

Albuquerque, NM 87109 505 761-9700 fax 761-4222 dps@dpsdesign.org

**ARCHITECT** 

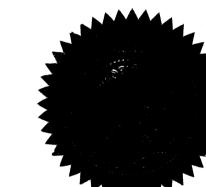


Project No. 1006539

LEVEL C PLAN PRELIMINARY PLAT APPROXED BY DRB ON 5-29-08

Approved for compliance with PC Zoning Level "A" and Level "B" Plans and compliance with the Design Standards of the Mesa del Sol Employment Center Convenants, Conditions & Restrictions.

Architectural Review Committee Mesa del Sol Employment Cente

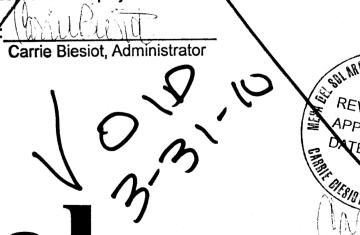

# SONY IMAGEWORKS (a) Mesa del Sol

PROJECT TEAM

**OWNER** 

FOREST CITY COVINGTON NM, LLC 801 UNIVERSITY BLVD., SE SUITE 200 ALBUQUERQUE, NM 87106 (505) 400-3021 FAX: (505)

## TENANT REPRESENTATIVE

ANTHONY MASON ASSOCIATES 11766 WILSHIRE BLVDL, SUITE 470 LOS ANGELES, CALIFORNIA 90025 (310) 312-6603 FAX: (310) 213-2982

## **ARCHITECT**

DEKKER/PERICH/SABATINI, LTD. 7601 JEFFERSON NE SUITE 100 ALBUQUERQUE, NM 87109 (505) 761-9700 FAX: (505) 761-4222

## STRUCTURAL ENGINEER

DEKKER/PERICH/SABATINI, LTD. 7601 JEFFERSON NE SUITE 100 ALBUQUERQUE, NM 87109 (505) 761-9700 FAX: (505) 761-4222

## **CIVIL ENGINEER**

**BOHANNAN HUSTON** 7500 JEFFERSON NE ALBUQUERQUE, NM 87109 (505) 823-1000 FAX: (505) 821-0892

## MEP ENGINEER

THE RESPONSE GROUP, INC. 11930 MENAUL BLVD. NE ALBUQUERQUE, NM 87112 (505) 323-7629 FAX: (505)

## **GENERAL CONTRACTOR**

**ENTERPRISE BUILDERS** 2732 VASSAR PL., NE, SUITE E **ALBUQUERQUE, NM 87107** (505) 857-0050 FAX: (505)

5/9/2008 - LEVEL C COMMENTS

PROJECT NO. 02/15/200

MESA DEL SO ARC FINAL SUBMITTAL


engineering

architecture

interiors

landscape

7601 Jefferson NE Suite 100

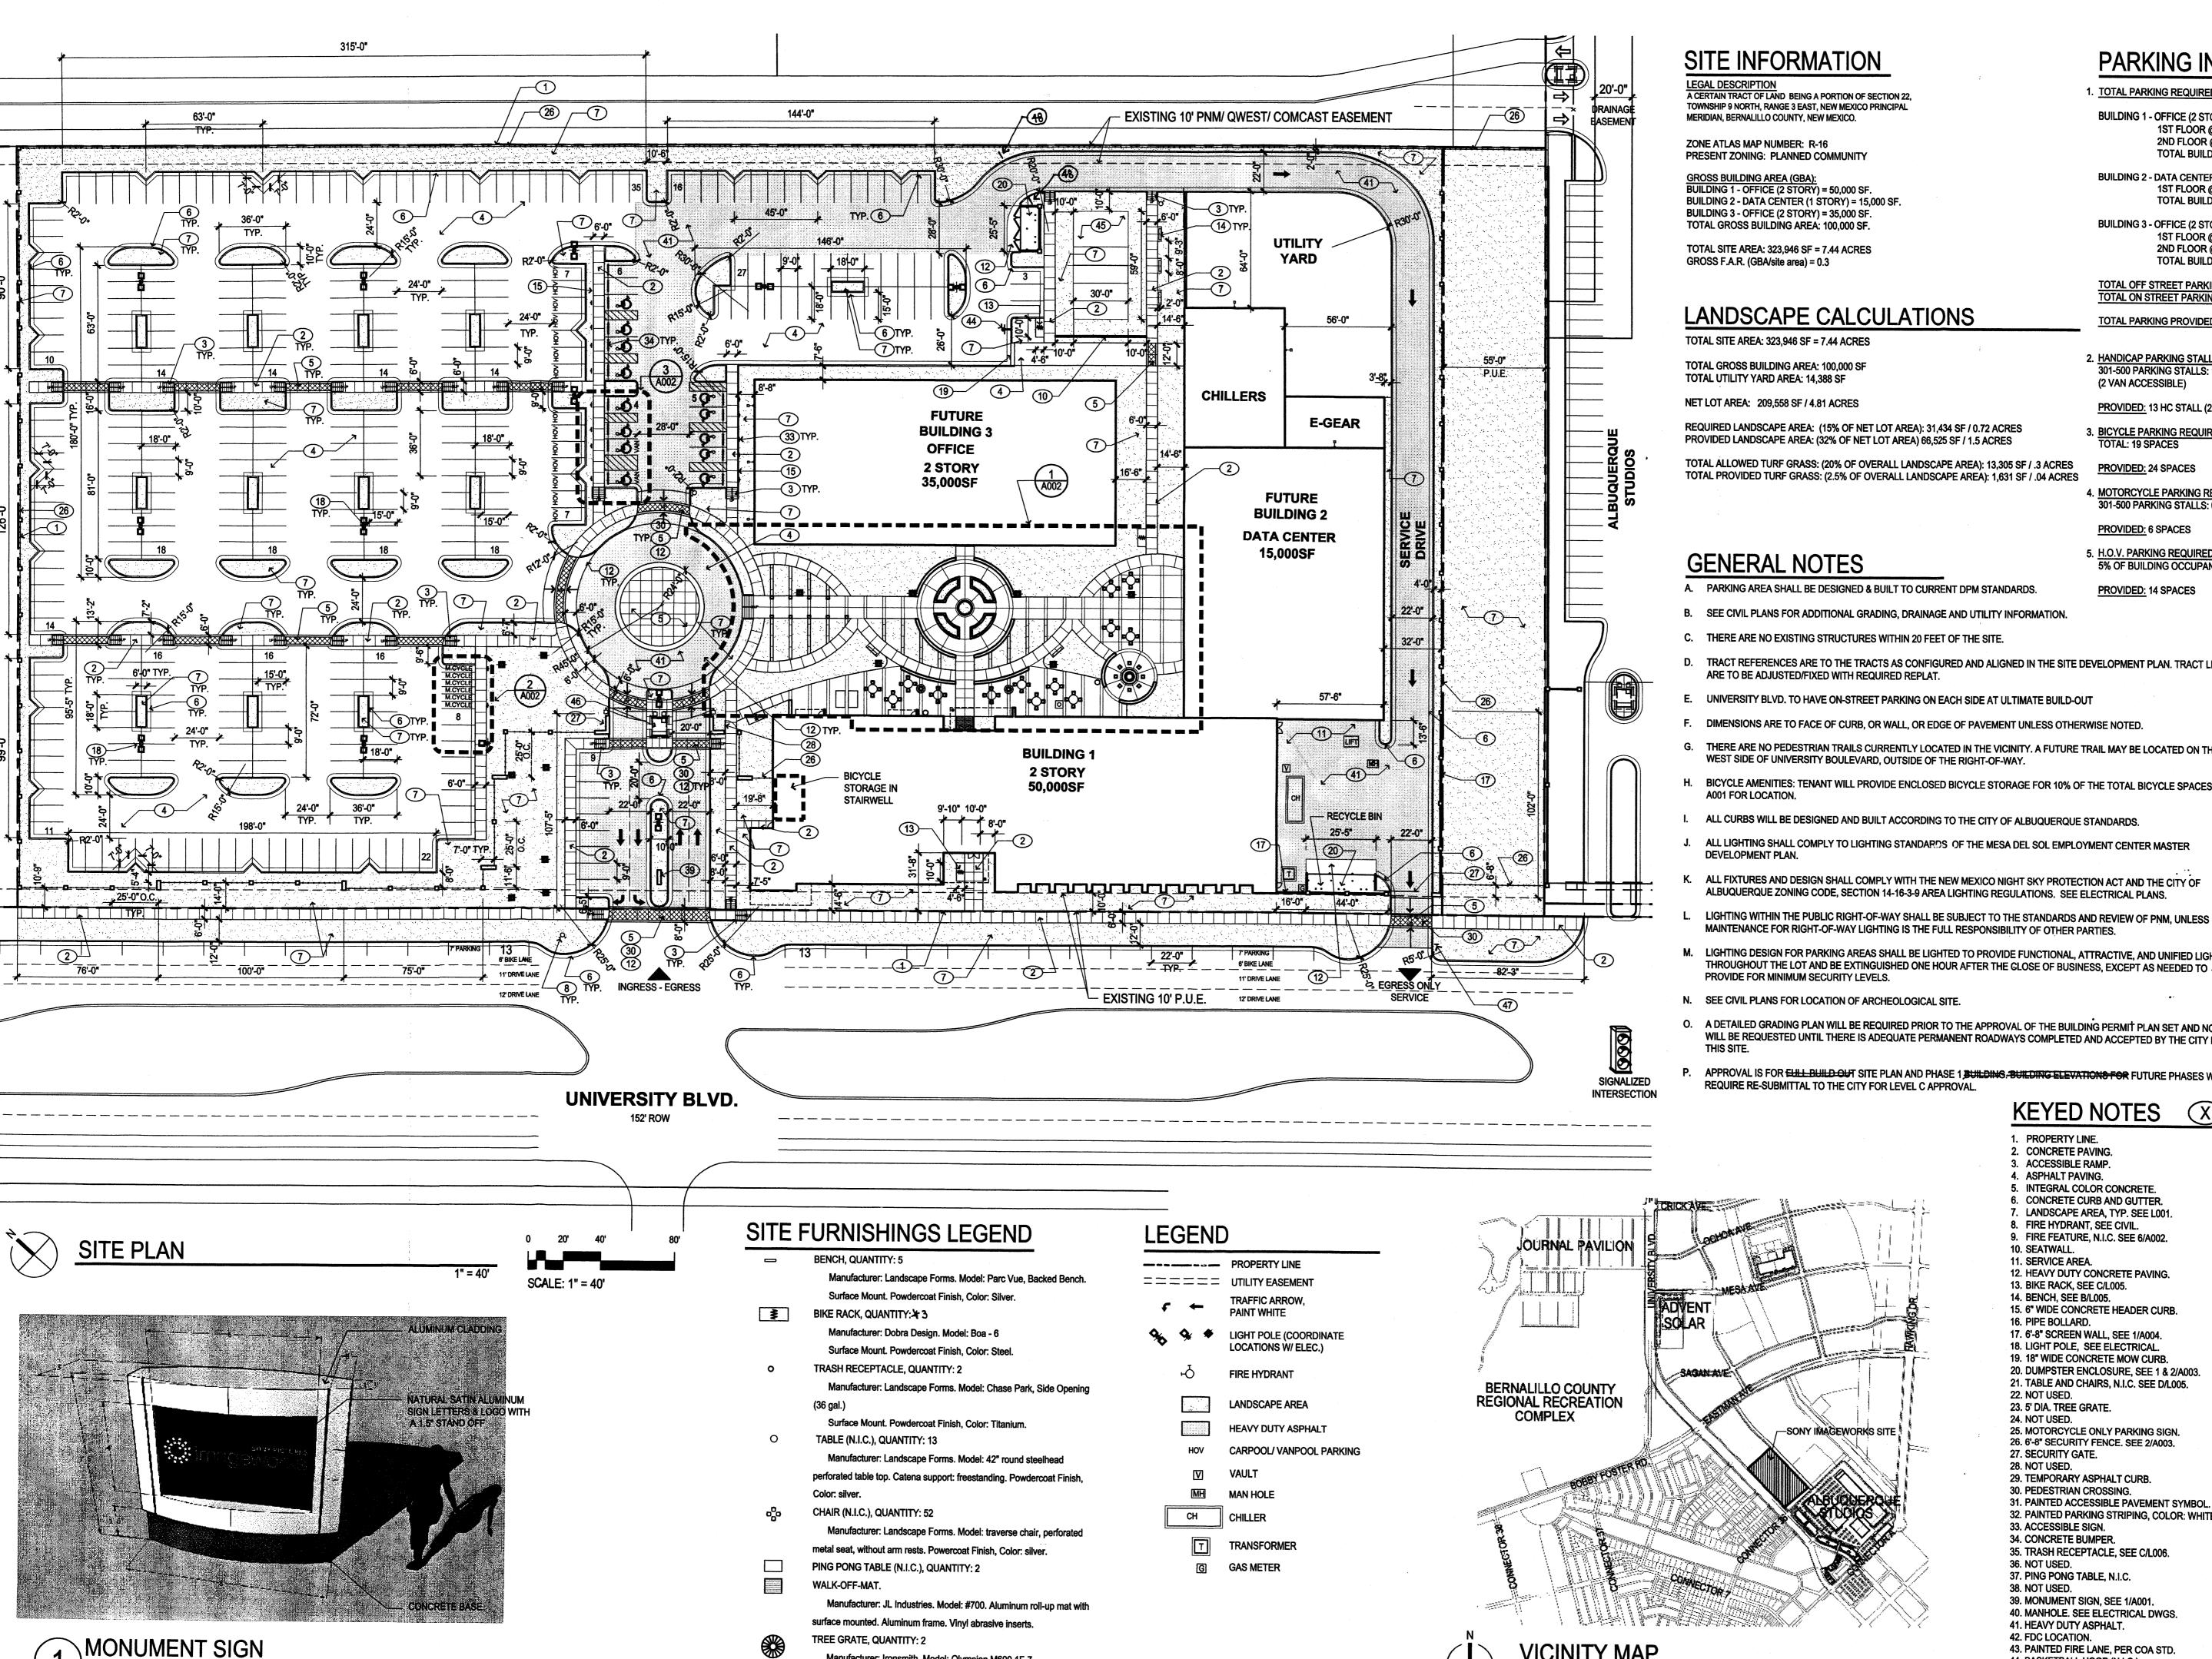

Manufacturer: Ironsmith. Model: Olympian M600 1F-7.

## PARKING INFORMATION

1. TOTAL PARKING REQUIRED = 371 PS

BUILDING 1 - OFFICE (2 STORY): 50,000SF 1ST FLOOR @ 1PS/200SF= 125 PS. 2ND FLOOR @ 1PS/300SF= 84 PS. **TOTAL BUILDING 1= 209 PS** 

BUILDING 2 - DATA CENTER (1 STORY): 15,000SF 1ST FLOOR @ 1PS/1,000SF= 15 PS. TOTAL BUILDING 2= 15 PS

BUILDING 3 - OFFICE (2 STORY): 35,000SF 1ST FLOOR @ 1PS/200SF= 88 PS. 2ND FLOOR @ 1PS/300SF= 59 PS. TOTAL BUILDING 1= 147 PS

TOTAL OFF STREET PARKING PROVIDED: 360 PS TOTAL ON STREET PARKING PROVIDED: 26 PS

TOTAL PARKING PROVIDED: 386 PS

2. HANDICAP PARKING STALLS REQUIRED 301-500 PARKING STALLS: 12 HC STALLS REQUIRED (2 VAN ACCESSIBLE)

PROVIDED: 13 HC STALL (2 VAN ACCESSIBLE)

3. <u>BICYCLE PARKING REQUIRED:</u> (1:20 AUTOS) TOTAL: 19 SPACES

4. MOTORCYCLE PARKING REQUIRED: 301-500 PARKING STALLS: 6 SPACES REQUIRED.

PROVIDED: 6 SPACES

5. <u>H.O.V. PARKING REQUIRED:</u>5% OF BUILDING OCCUPANTS: 13 SPACES REQUIRED.

PROVIDED: 14 SPACES

- A. PARKING AREA SHALL BE DESIGNED & BUILT TO CURRENT DPM STANDARDS.
- B. SEE CIVIL PLANS FOR ADDITIONAL GRADING, DRAINAGE AND UTILITY INFORMATION.
- C. THERE ARE NO EXISTING STRUCTURES WITHIN 20 FEET OF THE SITE.
- D. TRACT REFERENCES ARE TO THE TRACTS AS CONFIGURED AND ALIGNED IN THE SITE DEVELOPMENT PLAN. TRACT LINES
- E. UNIVERSITY BLVD. TO HAVE ON-STREET PARKING ON EACH SIDE AT ULTIMATE BUILD-OUT
- F. DIMENSIONS ARE TO FACE OF CURB, OR WALL, OR EDGE OF PAVEMENT UNLESS OTHERWISE NOTED.
- G. THERE ARE NO PEDESTRIAN TRAILS CURRENTLY LOCATED IN THE VICINITY. A FUTURE TRAIL MAY BE LOCATED ON THE WEST SIDE OF UNIVERSITY BOULEVARD, OUTSIDE OF THE RIGHT-OF-WAY.
- BICYCLE AMENITIES: TENANT WILL PROVIDE ENCLOSED BICYCLE STORAGE FOR 10% OF THE TOTAL BICYCLE SPACES. SEE
- ALL CURBS WILL BE DESIGNED AND BUILT ACCORDING TO THE CITY OF ALBUQUERQUE STANDARDS.
- ALL LIGHTING SHALL COMPLY TO LIGHTING STANDARDS OF THE MESA DEL SOL EMPLOYMENT CENTER MASTER
- ALL FIXTURES AND DESIGN SHALL COMPLY WITH THE NEW MEXICO NIGHT SKY PROTECTION ACT AND THE CITY OF ALBUQUERQUE ZONING CODE, SECTION 14-16-3-9 AREA LIGHTING REGULATIONS. SEE ELECTRICAL PLANS
- LIGHTING WITHIN THE PUBLIC RIGHT-OF-WAY SHALL BE SUBJECT TO THE STANDARDS AND REVIEW OF PNM, UNLESS MAINTENANCE FOR RIGHT-OF-WAY LIGHTING IS THE FULL RESPONSIBILITY OF OTHER PARTIES.
- M. LIGHTING DESIGN FOR PARKING AREAS SHALL BE LIGHTED TO PROVIDE FUNCTIONAL, ATTRACTIVE, AND UNIFIED LIGHTING
- N. SEE CIVIL PLANS FOR LOCATION OF ARCHEOLOGICAL SITE.

**VICINITY MAP** 

MESA DEL SOL

- O. A DETAILED GRADING PLAN WILL BE REQUIRED PRIOR TO THE APPROVAL OF THE BUILDING PERMIT PLAN SET AND NO C.O. WILL BE REQUESTED UNTIL THERE IS ADEQUATE PERMANENT ROADWAYS COMPLETED AND ACCEPTED BY THE CITY FOR
- APPROVAL IS FOR EVILL BUILD OUT SITE PLAN AND PHASE 1 BUILDING BUILDING ELEVATIONS FOR FUTURE PHASES WILL

## **KEYED NOTES**

 PROPERTY LINE. 2. CONCRETE PAVING. 3. ACCESSIBLE RAMP. 4. ASPHALT PAVING. INTEGRAL COLOR CONCRETE. 6. CONCRETE CURB AND GUTTER. 7. LANDSCAPE AREA, TYP. SEE L001. 8. FIRE HYDRANT, SEE CIVIL. 9. FIRE FEATURE, N.I.C. SEE 6/A002. 10. SEATWALL.

11. SERVICE AREA. 12. HEAVY DUTY CONCRETE PAVING. 13. BIKE RACK, SEE C/L005. 14. BENCH, SEE B/L005.

15. 6" WIDE CONCRETE HEADER CURB.

16. PIPE BOLLARD. 17. 6'-8" SCREEN WALL, SEE 1/A004. 18. LIGHT POLE, SEE ELECTRICAL 19. 18" WIDE CONCRETE MOW CURB 20. DUMPSTER ENCLOSURE, SEE 1 & 2/A003.

21. TABLE AND CHAIRS, N.I.C. SEE D/L005. 22. NOT USED. 23. 5' DIA. TREE GRATE. 24. NOT USED.

25. MOTORCYCLE ONLY PARKING SIGN. 26. 6'-8" SECURITY FENCE. SEE 2/A003. 27. SECURITY GATE. 28. NOT USED.

29. TEMPORARY ASPHALT CURB. 30. PEDESTRIAN CROSSING. 31. PAINTED ACCESSIBLE PAVEMENT SYMBOL. 32. PAINTED PARKING STRIPING, COLOR: WHITE.

33. ACCESSIBLE SIGN. 34. CONCRETE BUMPER. 35. TRASH RECEPTACLE, SEE C/L006. 36. NOT USED.

37. PING PONG TABLE, N.I.C. 38. NOT USED. 39. MONUMENT SIGN, SEE 1/A001. 40. MANHOLE. SEE ELECTRICAL DWGS.

45. VOLLEYBALL COURT (N.I.C.).

48. SERVICE DRIVE ONLY SIGN.

46. GUARD HOUSE (N.I.C.). 47. EXIT ONLY SIGN.

41. HEAVY DUTY ASPHALT. 42. FDC LOCATION. 43. PAINTED FIRE LANE, PER COA STD. 44. BASKETBALL HOOP (N.I.C.).

engineerin

architectui

7601 Jefferson NE Suite 100 Albuquerque, NM 8710' 505 761-9700 fax 761-4222

dps @ dpsdesign.org

ARCHITECT

**ARC SUBMITTAL** 

0

**REVISIONS** 1 01.28.08 - ARC Preliminary Review


2 02.14.08 - ARC Secondary Review

REVIEWED OF

/3\ 04.18.08 - LEVEL C COMMENTS

DRAWN BY IF/CM/SY **REVIEWED BY** MB/CG 05/06/08 PROJECT NO. 07-0116 DRAWING NAME

SITE PLAN **FULL BUILD OUT** 

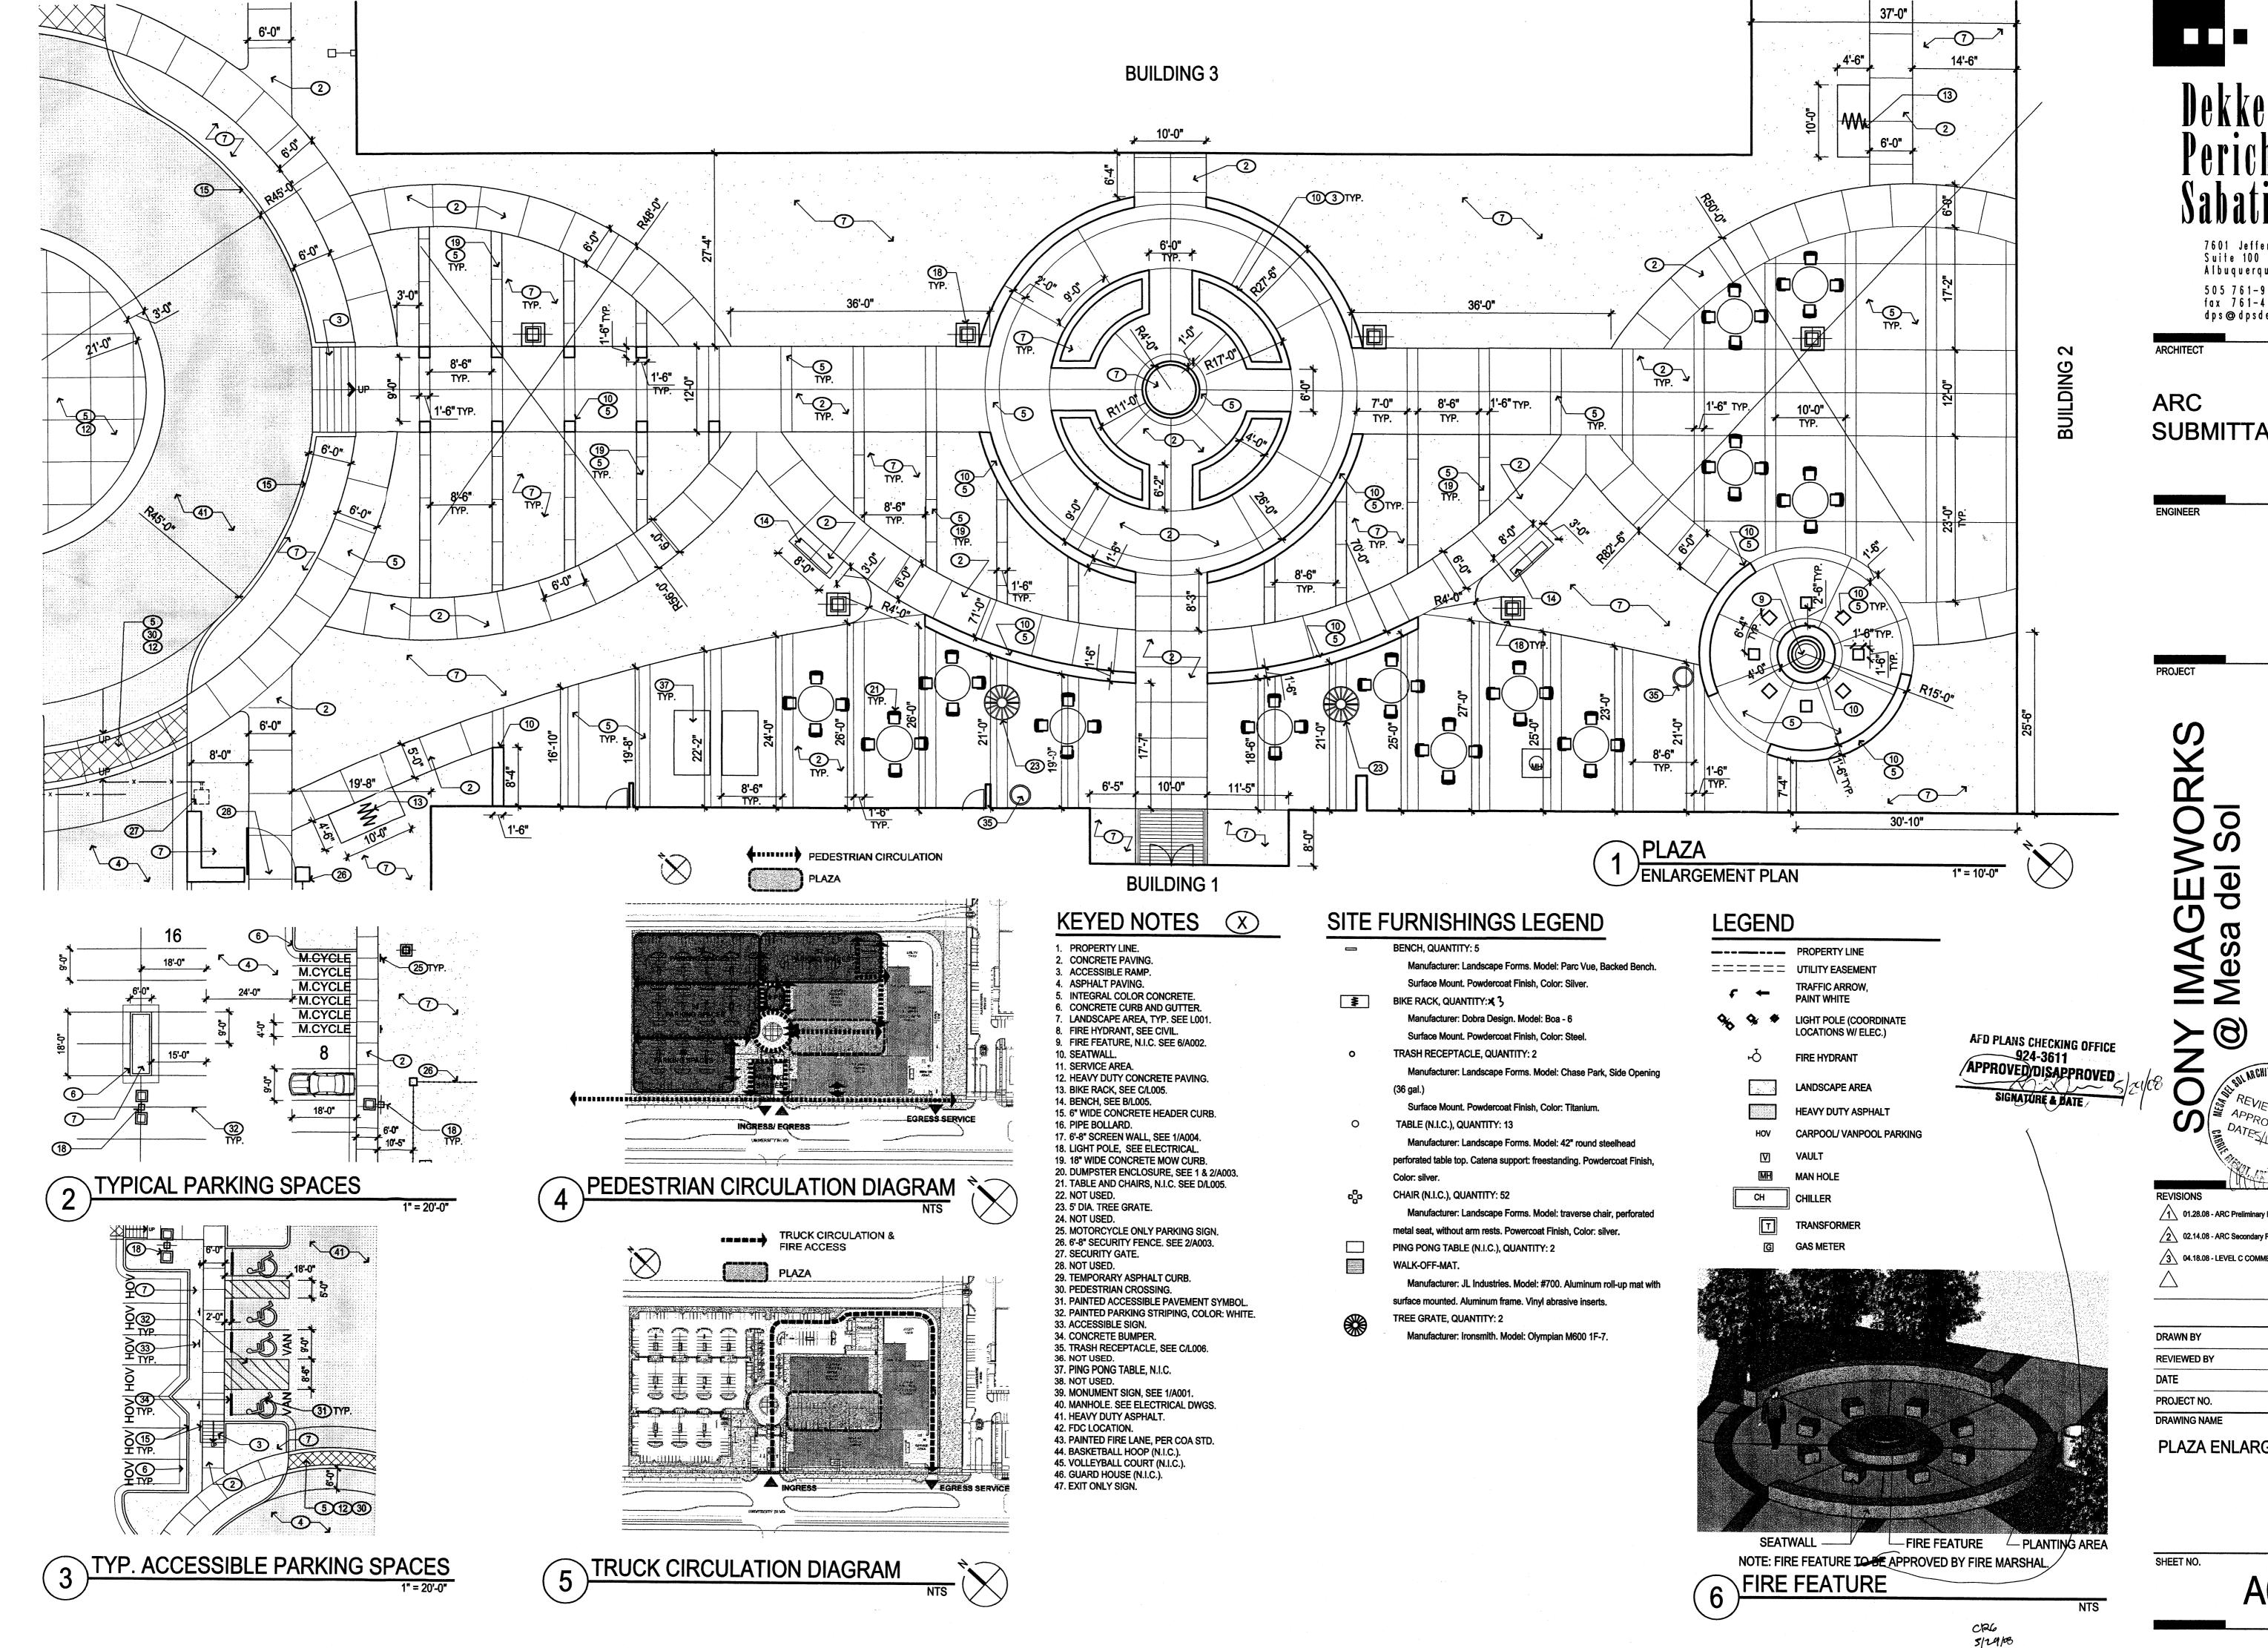

7601 Jefferson NE Suite 100 Albuquerque, NM 8710 505 761-9700 fax 761-4222 dps@dpsdesign.org

SUBMITTAL


1 01.28.08 - ARC Preliminary Review


2 02.14.08 - ARC Secondary Review 3 04.18.08 - LEVEL C COMMENTS

> IF/CM/SY MB / CG 05/06/08 07-0116


PLAZA ENLARGEMENT

A002

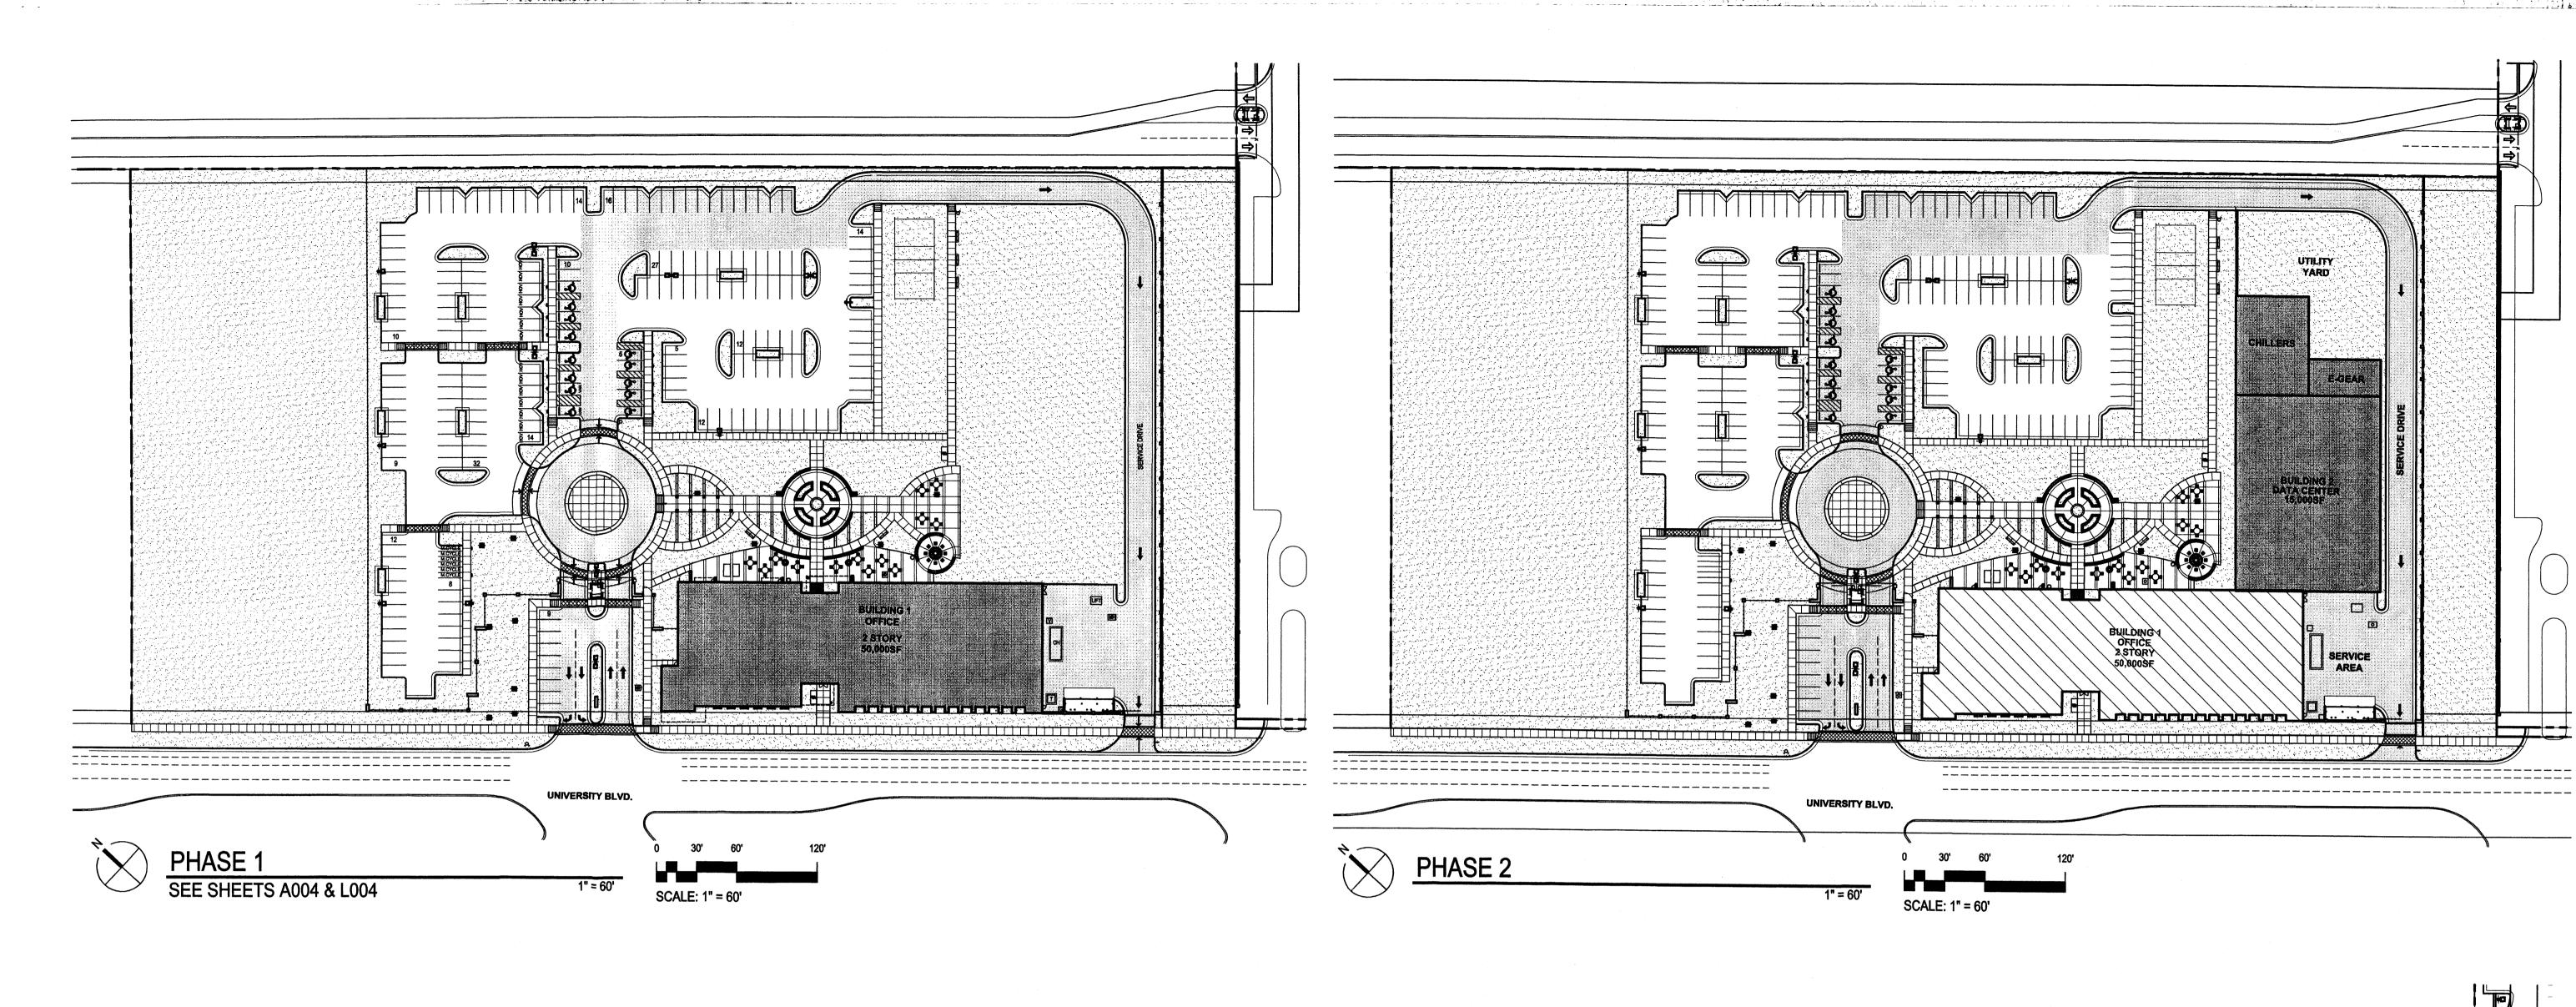

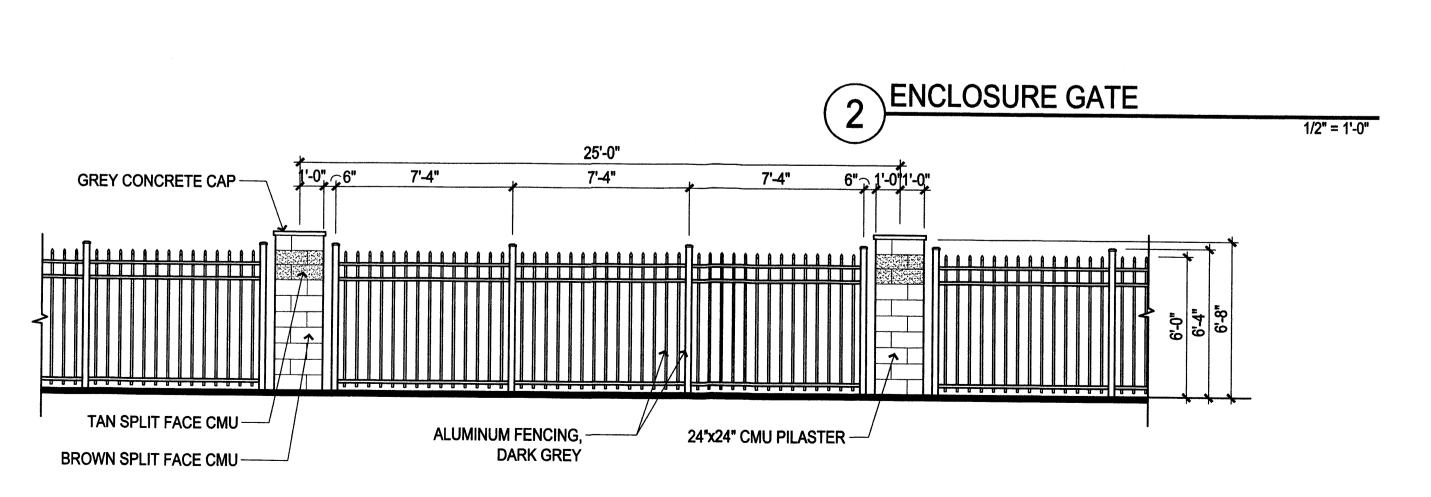



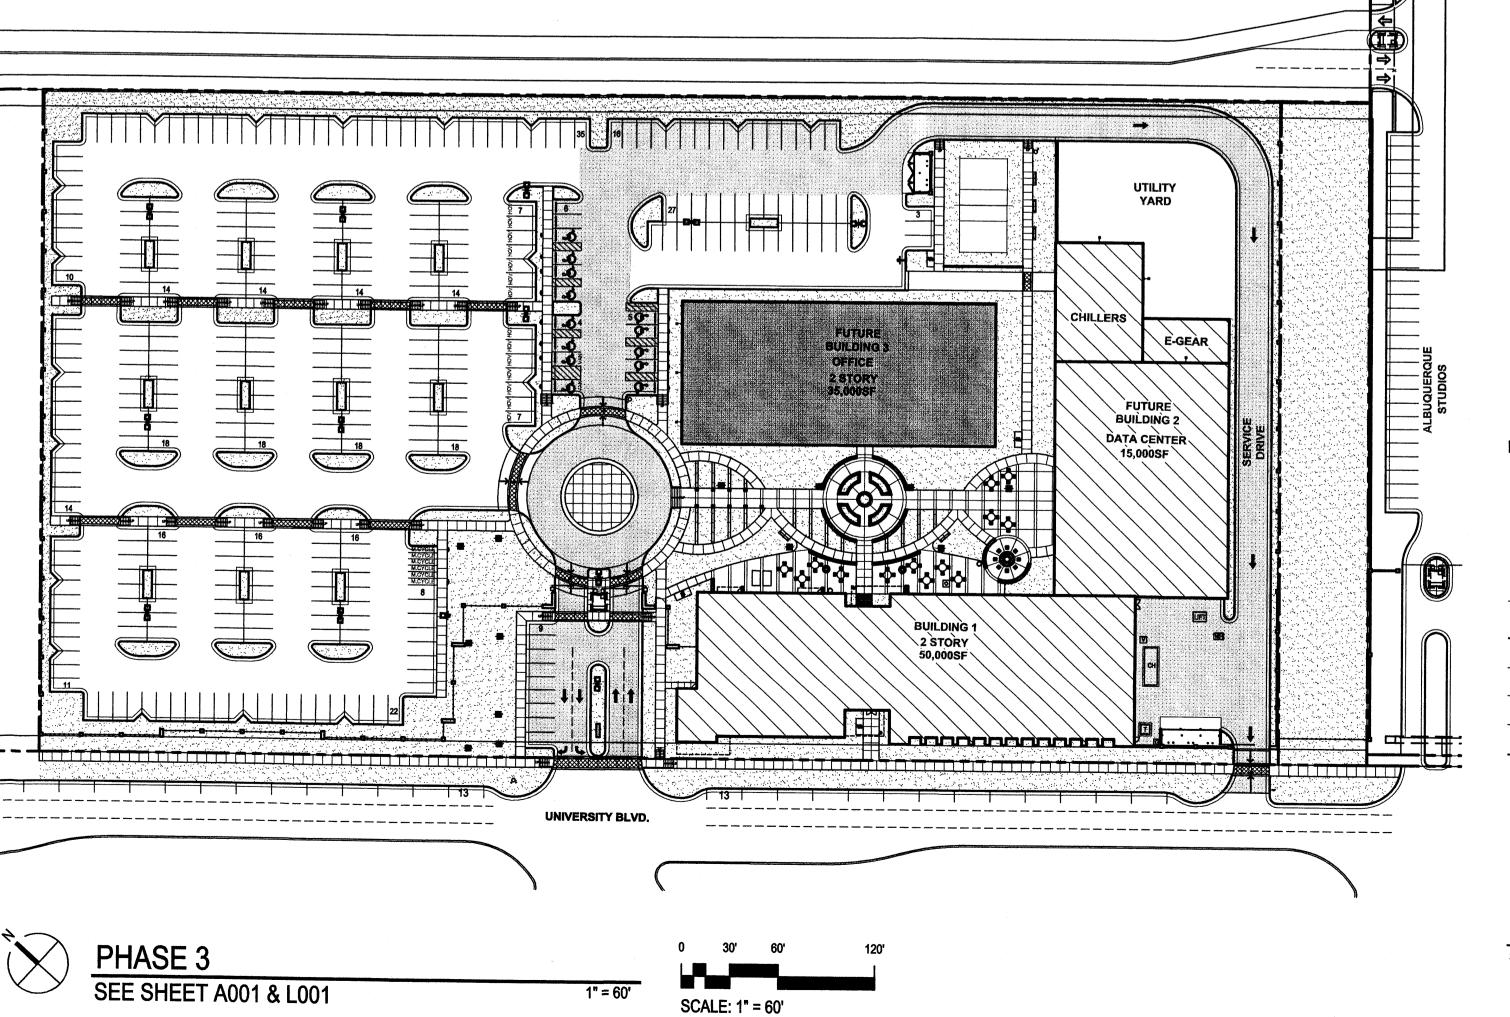

Dekker
Perich
Sahatini

7601 Jefferson NE Suite 100 Albuquerque, NM 8710! 505 761-9700 fax 761-4222 dps @ dpsdesign.org

ARC SUBMITTAL

ENGINEER

**ARCHITECT** 

PROJECT

IMAGEWORKS Mesa del Sol

REVISIONS

01.28.08 - ARC Preliminary Review

01.28.08 - ARC Preliminary Review

02.14.08 - ARC Secondary Review


04.18.08 - LEVEL C COMMENTS

DRAWN BY
REVIEWED BY
DATE
05/06/08
PROJECT NO.
07-0116

DRAWING NAME
PHASING PLAN

SHEET NO.

A003

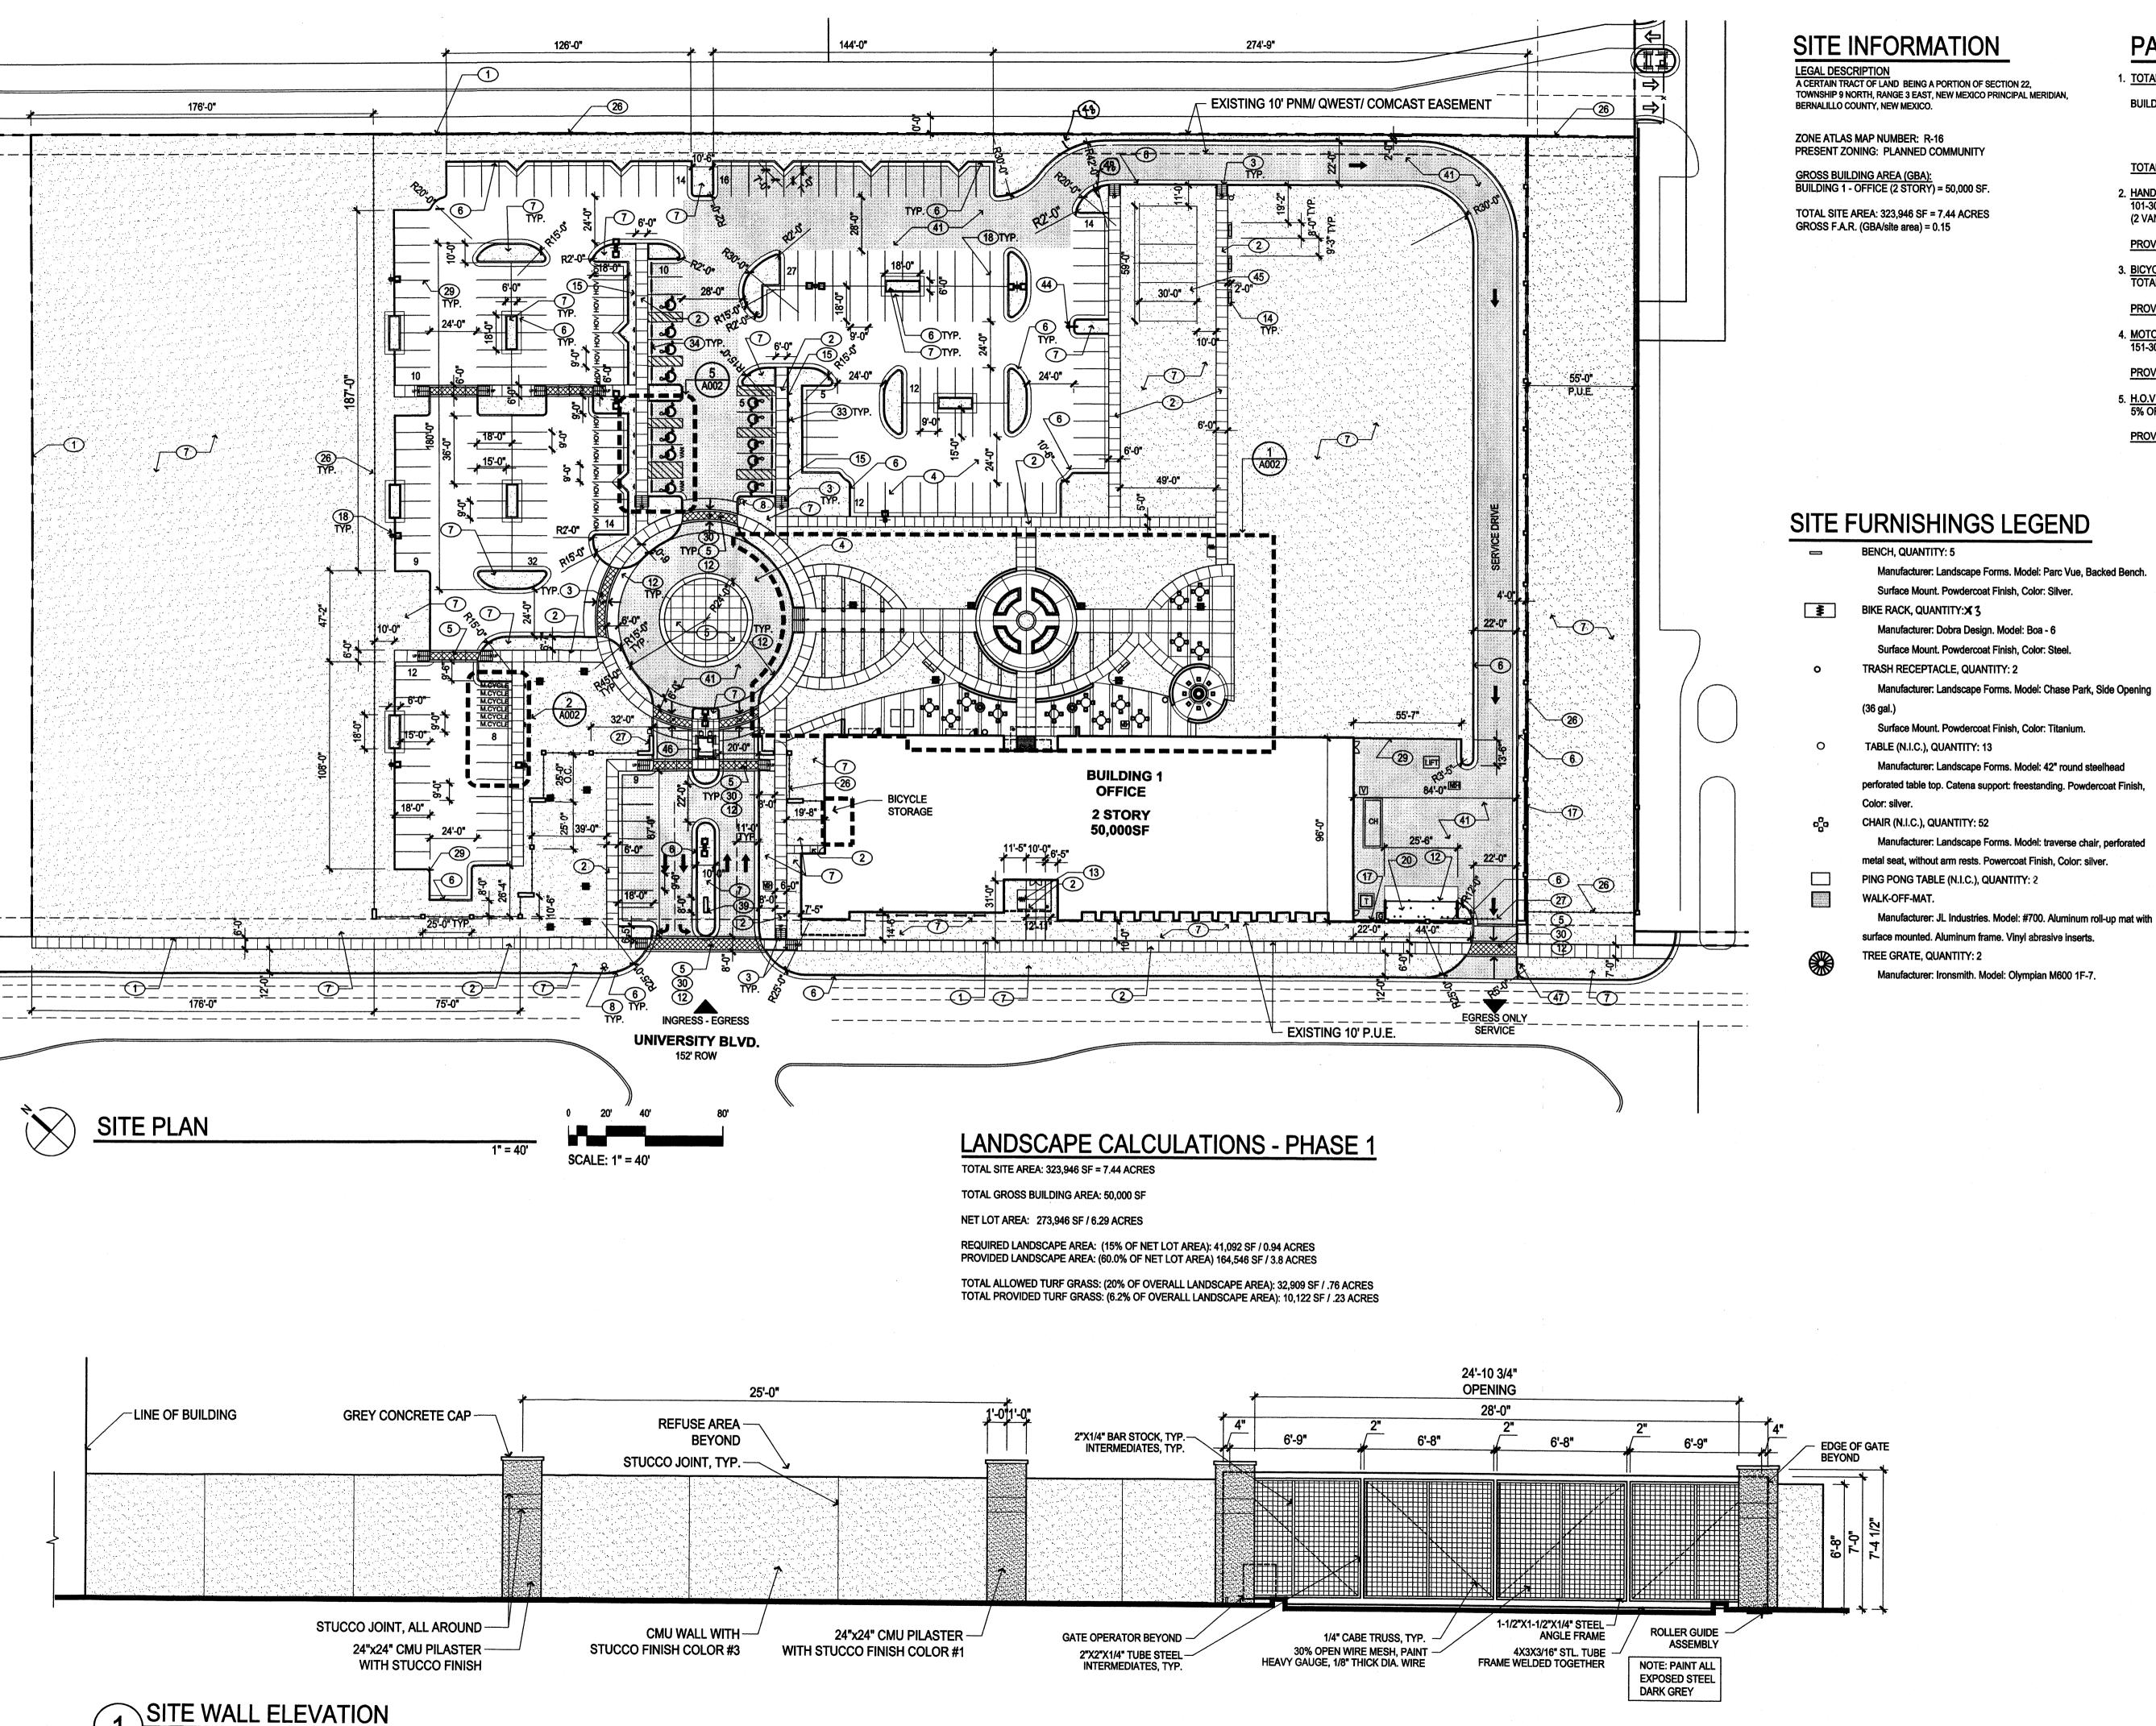

1/4" = 1'-0"

## PARKING INFORMATION

1. TOTAL PARKING REQUIRED = 209 PS

BUILDING 1 - OFFICE (2 STORY): 50,000SF 1ST FLOOR @ 1PS/200SF= 125 PS. 2ND FLOOR @ 1PS/300SF= 84 PS. TOTAL BUILDING 1= 209 PS

TOTAL OFF STREET PARKING PROVIDED: 227-28 209 (5.

2. HANDICAP PARKING STALLS REQUIRED: 101-300 PARKING STALLS: 8 HC STALLS REQUIRED (2 VAN ACCESSIBLE)

PROVIDED: 13 HC STALL (2 VAN ACCESSIBLE)

3. <u>BICYCLE PARKING REQUIRED:</u> (1:20 AUTOS) TOTAL: 11 SPACES

PROVIDED: 12 SPACES

4. MOTORCYCLE PARKING REQUIRED: 151-300 PARKING STALLS: 5 SPACES REQUIRED.

PROVIDED: 6 SPACES

5. <u>H.O.V. PARKING REQUIRED:</u>
5% OF BUILDING OCCUPANTS: 13 SPACES REQUIRED.

PROVIDED: 13 SPACES

## **LEGEND**

PROPERTY LINE ===== UTILITY EASEMENT

PAINT WHITE 🐪 拳 LIGHT POLE (COORDINATE LOCATIONS W/ ELEC.)

FIRE HYDRANT LANDSCAPE AREA

HEAVY DUTY ASPHALT CARPOOL/ VANPOOL PARKING

VAULT MAN HOLE CH CHILLER T TRANSFORMER

**G** GAS METER

# **KEYED NOTES**

1. PROPERTY LINE.

2. CONCRETE PAVING. 3. ACCESSIBLE RAMP. 4. ASPHALT PAVING.

5. INTEGRAL COLOR CONCRETE. 6. CONCRETE CURB AND GUTTER. 7. LANDSCAPE AREA, TYP. SEE L001. 8. FIRE HYDRANT, SEE CIVIL.

9. FIRE FEATURE, N.I.C. SEE 6/A002. 10. SEATWALL. 11. SERVICE AREA. 12. HEAVY DUTY CONCRETE PAVING. 13. BIKE RACK, SEE C/L005.

14. BENCH, SEE B/L005. 15. 6" WIDE CONCRETE HEADER CURB. 16. PIPE BOLLARD. 17. 6'-8" SCREEN WALL, SEE 1/A004.

18. LIGHT POLE, SEE ELECTRICAL. 19. 18" WIDE CONCRETE MOW CURB. 20. DUMPSTER ENCLOSURE, SEE 1 & 2/A003. 21. TABLE AND CHAIRS, N.I.C. SEE D/L005.

22. NOT USED. 23. 5' DIA. TREE GRATE. 24. NOT USED. 25. MOTORCYCLE ONLY PARKING SIGN.

26. 6'-8" SECURITY FENCE. SEE 2/A003. 27. SECURITY GATE. 28. NOT USED. 29. TEMPORARY ASPHALT CURB.

30. PEDESTRIAN CROSSING. 31. PAINTED ACCESSIBLE PAVEMENT SYMBOL. 32. PAINTED PARKING STRIPING, COLOR: WHITE.

33. ACCESSIBLE SIGN. 34. CONCRETE BUMPER. 35. TRASH RECEPTACLE, SEE C/L006. 36. NOT USED.

37. PING PONG TABLE, N.I.C. 38. NOT USED. 39. MONUMENT SIGN, SEE 1/A001. 40. MANHOLE. SEE ELECTRICAL DWGS. 41. HEAVY DUTY ASPHALT. 42. FDC LOCATION.

43. PAINTED FIRE LANE, PER COA STD. 44. BASKETBALL HOOP (N.I.C.). 45. VOLLEYBALL COURT (N.I.C.). 46. GUARD HOUSE (N.I.C.). 47. EXIT ONLY SIGN.

48. SERVICE DRIVE ONLY SIGN

5/29/08

architectur

plannin

engineerin

7601 Jefferson NE

Albuquerque, NM 8710!

Suite 100

ARCHITECT

ARC

**ENGINEER** 

PROJECT

**SUBMITTAL** 


505 761-9700 fax 761-4222 dps ⊚ dpsdesign.org

REVIEWED ( APPROVED W **REVISIONS** 

1 01.28.08 - ARC Preliminary Review 2 02.14.08 - ARC Secondary Review 3 04.18.08 - LEVEL C COMMENTS

DRAWN BY IF/CM/SY **REVIEWED BY** MB/CG DATE 05/06/08 PROJECT NO. 07-0116 DRAWING NAME

SITE PLAN PHASE 1

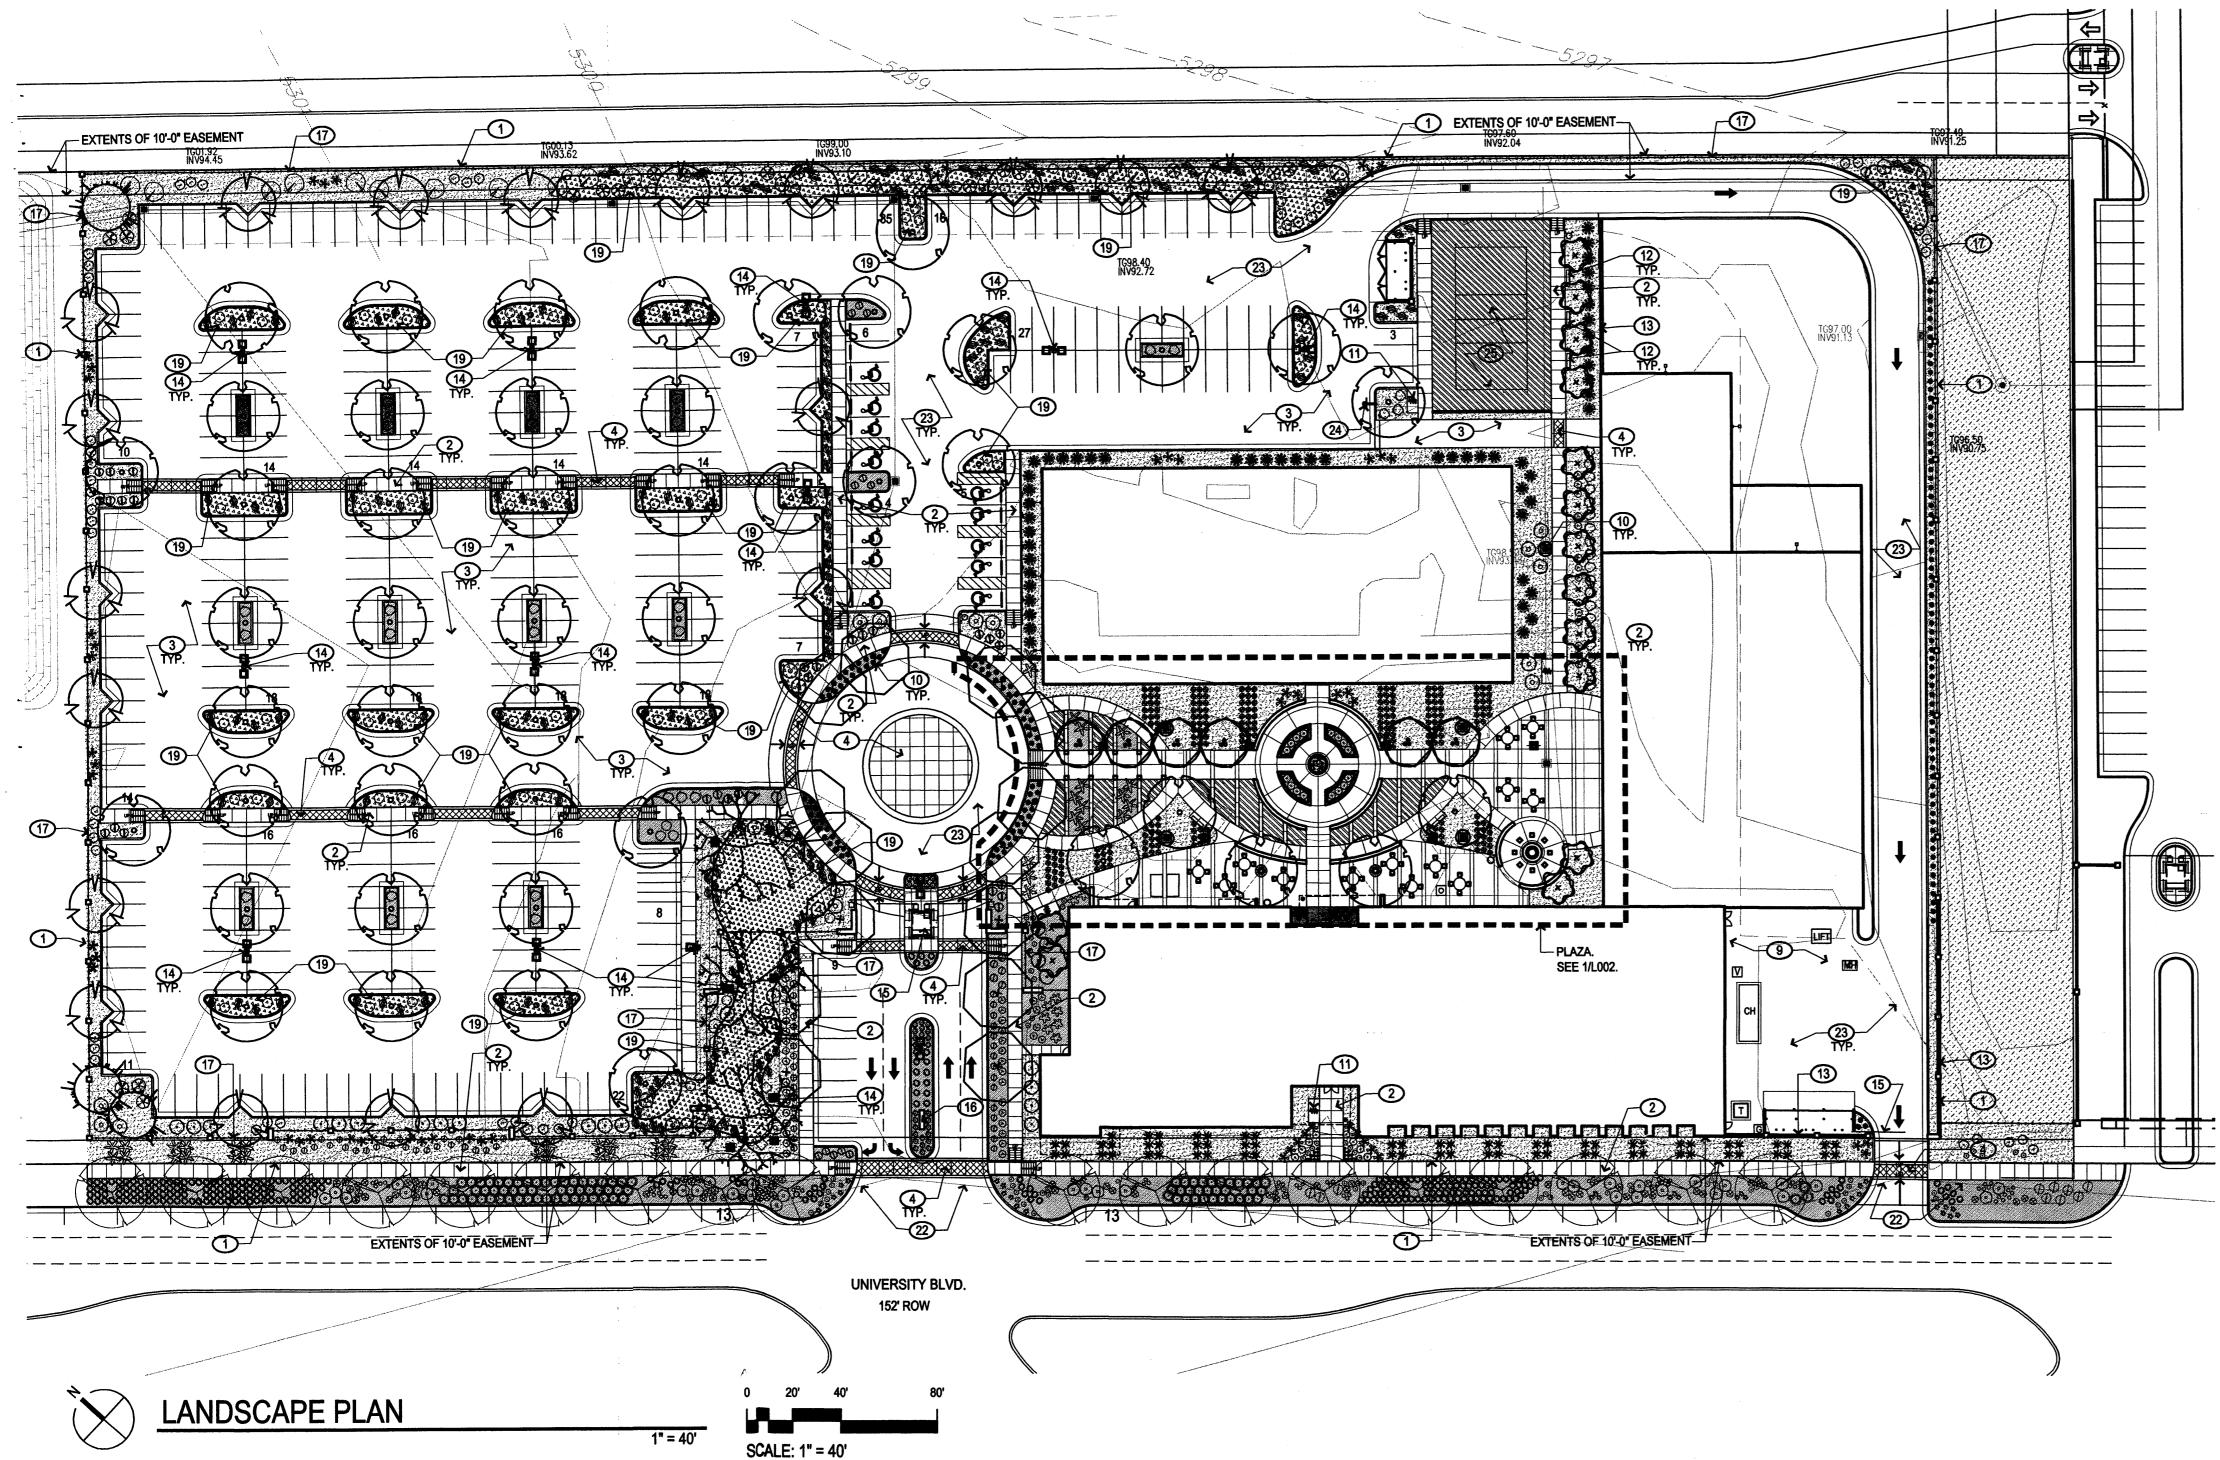

## **PLANTING NOTES**

1. LANDSCAPE DESCRIPTION THE LANDSCAPE DESIGN UTILIZES NATIVE PLANTS AND OTHER LOW-WATER-USE PLANTS THAT WILL REINFORCE THE SPECIAL LOCATION OF THE PROJECT - ON A HIGH DESERT GRASSLAND MESA. THE SELECTED SHRUBS, TREES AND ACCENTS ADD SEASONAL COLOR AND SCALE TO THE PROJECT, FOLLOW THE MESA DEL SOL DESIGN GUIDELINES, AND ESTABLISH AREAS OF WILDLIFE HABITAT.

2. EXISTING PLANT MATERIAL THERE IS NO LARGE SIZE VEGETATION ON THE SITE. THE EXISTING VEGETATION IS COMPRISED OF GRASSES AND FORBS AND SOME SHRUBS AT LOW DENSITIES.

3. INSTALLATION AND MAINTENANCE OF LANDSCAPING AND

IRRIGATION SHALL BE THE RESPONSIBILITY OF THE PROPERTY

4. AFTER SUBSTANTIAL COMPLETION, THE OWNER WILL BE

OVER WALKS AND STREETS WHERE MULTI-TRUNK TREES ARE USED. 5. THE LANDSCAPE DESIGN SHALL COMPLY WITH THE INTENT OF THE

CITY OF ALBUQUERQUE WATER CONSERVATION, LANDSCAPING AND WATER WASTE ORDINANCE.

6. WATER USE DESCRIPTION:

PLANT MATERIALS HAVE BEEN CHOSEN FOR THEIR XERIC QUALITIES IN ADDITION TO THEIR AESTHETIC AND HABITAT VALUES. A MINIMAL AMOUNT OF TURF IS USED IN THIS DESIGN.

7. MINIMUM INSTALLATION SIZES FOR PLANT MATERIAL VARY BY SPECIES. SEE PLANT LEGEND.

8. SOIL BOND SHALL BE ADDED TO SEED INSTALLATION IN WATER HARVESTING AREAS AND ON SLOPES GREATER THAN 3:1.

9. LANDSCAPE FABRIC: ALL LANDSCAPE AREAS, EXCEPT FOR SEEDED AND SODDED AREAS, SHALL BE COVERED WITH LANDSCAPE WEED BARRIER FABRIC PRIOR TO MULCHING, IN ORDER TO MINIMIZE WEED GROWTH AND HELP MAINTAIN SOIL MOISTURE.

10. LANDSCAPE AREAS SHALL BE COVERED WITH EITHER SEED, SOD, OR ROCK MULCH. SEE LANDSCAPE LEGEND, LOO1. PLANT QUANTITIES AND AREA SQUARE FOOTAGES ARE APPROXIMATE, CONTRACTOR IS RESPONSIBLE FOR VERIFYING QUANTITIES FOR FINAL PRICING.

11. SOIL PREPARATION WITHIN ROW IS REQUIRED TO CLEAR DEBRIS AND DE-COMPACT LANDSCAPE ZONE PRIOR TO PLANTING. SEE SPECIFICATIONS.

12. ALL LANDSCAPING WITHIN THE R.O.W. MUST CONFORM TO THE MESA DEL SOL STREETSCAPE MASTER PLAN.

13. SOIL SECRETS SOIL BIOLOGY AMENDMENTS SHALL BE USED ON ALL PLANTING, SODDED, AND SEEDED AREAS. (SOIL SECRETS: 505-550-3246 RESPONSIBLE FOR MAINTAINING APPROPRIATE BRANCH CLEARANCES OR WWW.SOILSECRETS.COM).

A. PRODUCTS AND RATES SHALL BE AS FOLLOWS: 1. SOIL INNOCULUM: TERRA PRO-COMMERCIAL OR APPROVED EQUAL. TERRA PRO-COMMERCIAL IS A FULL SPECTRUM ORGANIC SOIL INNOCULUM WITH BACTERIA, ENZYMES, COENQYMES, MYCHORRIZAE, AND PROTOZOA. TERRA PRO-COMMERCIAL IS PRODUCED BY SOIL SECRETS (505-550-3246, WWW.SOILSECRETS.COM). APPLY AT A RATE OF 2000 LBS. PER ACRE, WHICH IS ONE .6 CUBIC FOOT BAG PER 1000 SF OR 43 BAGS PER ACRE.

2. CATALYST: PROTEIN CRUMBLIES OR APPROVED EQUAL. PROTEIN CRUMBLIES IS A NATURAL SOURCE OF CRUDE PROTEIN. PROTEIN CRUMBLIES IS PRODUCED BY SOIL SECRETS. APPLY AT A RATE OF 800 LBS. PER ACRE. WHICH IS ONE .6 CUBIC FOOT BAG PER 2000 SF OR 22 BAGS PER ACRE.

B. APPLICATIONS OF SOIL AMENDMENTS ARE REQUIRED AT

PLANT PIT. FOR PURPOSES OF BIDDING, ASSUME THE

INSTALLATION AND AGAIN DURING THE WARRANTY PERIOD. C. APPLICATION OF SOIL AMENDMENTS FOR TREES, GROUND COVERS, SHRUBS, AND SUCCULENTS IS TO BE MADE OVER EACH

**FOLLOWING AREAS:** TREES: 78.5 SF EACH

SHRUBS, GRASSES, GROUND COVERS, SUCCULENTS: 5 GAL.: 28 SF EACH/1 GAL.: 12 SF EACH

D. FOLLOWING PLANTING AND SEEDING, SOIL AMENDMENTS SHALL BE SPREAD UNIFORMLY OVER PLANTING PIT AND SEEDED AREAS. CONTRACTOR SHALL WATER AMENDMENTS INTO SOIL PER MANUFACTURER'S INSTRUCTIONS.

14. NATIVE SOILS SHALL BE USED FOR LANDSCAPE INSTALLATION. IMPORT OF PLANTING MIX OR HIGH QUALITY TOPSOIL IS NOT REQUIRED UNLESS THE SOILS HAVE BEEN CONTAMINATED DURING THE

15. PASSIVE WATER HARVESTING: PASSIVE WATER HARVESTING, SUCH AS HARVESTING OF STORM WATER SURFACE RUNOFF AND ROOF RUNOFF, IS UTILIZED WHERE FEASIBLE. SEE KEYED NOTES.

16. THIS LANDSCAPE PLAN IS COMPLIANT WITH THE REQUIREMENTS SET FORTH BY THE THE MESA DEL SOL DESIGN GUIDELINES BOOK.

17. STREETSCAPE PLANTING WAS DESIGNED BY EDAW AND IS SHOWN WITH A SEPARATE PLANTING LEGEND TO CLARIFY THAT THIS AREA WAS DESIGNED BY THEM.

## **IRRIGATION NOTES**

1. THE LANDSCAPE DESIGN REQUIRES A PERMANENT, FULLY AUTOMATIC IRRIGATION SYSTEM TO SUPPORT THE PLANT MATERIAL, THE IRRIGATION SYSTEM SHALL BE DESIGNED TO ACCOMMODATE NON-POTABLE WATER. IRRIGATION SHALL BE PROVIDED TO ALL CONTAINER PLANTS, AND POTENTIALLY TO SEEDED AREAS.

2. IRRIGATION: WE ARE NOT SHOWING AN IRRIGATION PLAN FOR THE

FOLLOWING REASONS: 1) AN IRRIGATION PLAN AT THIS LEVEL OF SUBMISSION WOULD ONLY REFLECT A CONCEPTUAL DESIGN, AND NOT A CONSTRUCTION DOCUMENT LEVEL. THE LANDSCAPE CONTRACTOR WILL SUPPLY THE IRRIGATION PLAN.

2) THE CITY OF ALBUQUERQUE DOES NOT REQUIRE AN IRRIGATION PLAN AT THIS LEVEL OF DOCUMENTATION.

3. THE CONTRACTOR SHALL CREATE AN IRRIGATION PLAN TO PERMANENTLY IRRIGATE THE PROPOSED PLANTINGS, AND SHALL SUBMIT THIS TO THE LANDSCAPE ARCHITECT FOR REVIEW AND APPROVAL. THE PLAN SHALL INCLUDE A PIPING AND EMITTER LAYOUT WITH SIZING, VALVE SCHEDULE AND CONSTRUCTION DETAILS. CONTROLLER: THE IRRIGATION SYSTEM SHALL BE RUN WITH FULLY AUTOMATED IRRIGATION CONTROLLER. RUN TIME WILL BE ADJUSTED ACCORDING TO PLANT MATURITY, ADDITIVE ALTERNATES, SEASON, LOCATION, AND PLANT PERFORMANCE.

4. DRIP EMITTERS SHALL BE USED FOR ALL PLANT MATERIAL OTHER THAN SEEDED AREAS.

## KEYED NOTES X

PROPERTY LINE CONCRETE PAVING

ASPHALT PAVING 4. INTEGRAL COLOR CONCRETE, SEE 1/L005

NOT USED NOT USED

18" WIDE CONCRETE MOW CURB 8. SEATWALL 9. SERVICE AREA

10. STORM DRAIN INLET, SEE CIVIL 11. BIKE RACK, SEE B/L005 12. BENCH, SEE A/L005 13. 6'-8" SCREEN WALL, SEE 1/A004

14. LIGHT POLE, SEE ELECTRICAL 15. FIRE PIT, N.I.C. 16. MONUMENT SIGN, 1/A001 17. 6'-8" SECURITY FENCE, SEE 2/A003

18. TRASH RECEPTACLE, SEE C/L005 19. WATER HARVESTING AREA, SEE L003 20. PING PONG TABLE, N.I.C. 21. TABLE & CHAIRS, N.I.C., SEE D/L005

22. CLEAR SIGHT TRIANGLE 23. HEAVY DUTY ASPHALT 24. BASKETBALL HOOP, N.I.C.

25. VOLLEYBALL COURT, N.I.C. 26. 5' DIA. TREE GRATE, SEE E/L005

27. TEMPORARY SAND FENCE - PHASE I ONLY

## PLANTING SCHEDULE - MDS STREETSCAPE - FULL BUILD

_	EST. QTY.	INSTALLED SIZE	COMMON NAME	Botanical name	Height	Width	Water requirements
$\bigcirc$	18	3" Cal.	CHINESE PISTACHE	Pistacia chinensis	35.00	30.00	Low Water Use
RASS - SEE E	31 & B3/L003				· ······		
SYMBOL	EST. QTY.	INSTALLED SIZE	COMMON NAME	Botanical name	Height	Width	Water requirement
$\Diamond$	253	5 Gal.	REGAL MIST GRASS	Muhlenbergia capillaris 'Regal Mist'	3.50	3.00	Medium Water Use
$\Theta$	21	1 Gal.	NASHVILLE MUHLEY	Muhlenbergia rigida 'Nashville'	2.00	3.00	Medium Water Us
ROUND COV	ER - SEE B3/L003						
SYMBOL	EST. QTY.	INSTALLED SIZE	COMMON NAME	Botanical name	Height	Width	Water requirement
Q	63	1 Gal.	PURPLE CONEFLOWER	Echinacea purpurea	3.00	1.50	Moist At All Times
$\oplus$	48	1 Gal.	SUNSET PENSTEMON	Pensternon clutei	3.00	2.00	Low Water Use
SHRUB - SEE E	B1 & C3/L003						
SYMBOL	EST. QTY.	INSTALLED SIZE	COMMON NAME	Botanical name	Height	Width	Water requirement
▣	35	5 Gai.	TRAILING INDIGO BUSH	Dalea greggii	1.50	8.00	Drought Tolerant
$\Theta$	10	5 Gal.	TURPENTINE BUSH	Ericameria laricifolia	3.00	4.00	Drought Tolerant
0	90	5 Gal.	GREEN CLOUD RANGER	Leucophyllum frutescens 'Green Cl	oud' 5.00	5.00	Drought Tolerant
$\odot$	43	3 Gal.	MEXICAN BLUE SAGE	Salvia chamaedryoldes	1.50	2.00	Low Water Use
SUCCULENT -							
SYMBOL	EST. QTY.	INSTALLED SIZE	COMMON NAME	Botanical name	Height	Width	Water requiremen
W	37	3 Gal. `	MESCAL AGAVE	Agave parryli 'Neomexicana'	2.00	2.00	Drought Tolerant
SEED / SOD / I	MULCH						****
	9,776 SF		Crusher Fines Rock Mulch,	3" min. Depth, For use in designated lar			

## PLANTING SCHEDULE - FULL BUILD

SYMBOL	EST. QTY.	INSTALLED SIZE	COMMON NAME	Botanical name	Height	Width	Water requirements
Q	3	6' Tall min.	ARIZONA CYPRESS (Non-Allergenic)	Cupressus arizonica	50.00	35.00	Drought Resistant
	14	40" Box	DESERT OLIVE (Multi-Trunk)	Forestiera neomexicana	12.00	12.00	Medium Water Use
$\odot$	48	2.5" Cal.	RAYWOOD ASH	Fraxinus oxycarpa 'Raywood'	35.00	30.00	Medium Water Use
	3	2.5" Cal.	RIO GRANDE COTTONWOOD (2 Trunk)	Populus wislizenii 'Rio Grande'	35.00	45.00	Heavy Water Use
$\odot$	14	2.5" Cal.	IDAHO LOCUST	Robinia ambigua 'Idahoensia'	35.00	30.00	Low Water Use
$\odot$	6	40" Box	CHASTE TREE	Vitex agnus-castus	25.00	20.00	Medium Water Use

3RM33 - 3EE 0	o i de Daylluua						
SYMBOL	EST. QTY.	INSTALLED SIZE	COMMON NAME	Botanical name	Height	Width	Water requirements
$\bigotimes$	231	1 Gal.	KARL FORESTER REED GRASS	Calamagrostis x acutifolia 'Karl Forester'	5.00	2.00	Low Water Use
$\odot$	44	1 Gal.	BLUE FESCUE	Festuca ovina glauca	1.00	1.00	Medium Water Use
O	17	5 Gal.	REGAL MIST GRASS	Muhlenbergia capillaris 'Regal Mist'	3.50	3.00	Medium Water Use
Ф	196	5 Gal.	EL TORO MUHLEY	Muhlenbergia emersleyi 'El Toro'	3.00	3.00	Low Water Use
*	163	1 Gal.	THREADGRASS	Nassella tenuissima	2.00	2.00	Low Water Use
$\odot$	50	1 Gal.	DWARF FOUNTAIN GRASS	Pennisetum aloepecroides 'Hamein'	3.00	3.00	Medium Water Use
ROUND COV	ER - SEE B3/L003						
SYMBOL	EST. QTY.	INSTALLED SIZE	COMMON NAME	Botanical name	Height	Width	Water requirements
$\sim$							

Ø	58	1 Gal.	WINECUPS	Caliirhoe Involucrata	1.00	2.50	Low Water Use
0	89	1 Gal.	GAURA	Gaura lindheimeri	3.00	4.00	Medium Water Use
$\Diamond$	12	1 Gal.	DESERT FOUR C'CLOCK	Mirabilis multiflora	1.50	4.00	Low Water Use
Ó	28	1 Gal.	SANDPAPER VERBENA	Verbena rigida	1.50	3.50	Low Water Use
SHRUB - SEE I	B1 & C3/L003						
SYMBOL	EST. QTY.	INSTALLED SIZE	COMMON NAME	Botanical name	Height	Width	Water requirements
8	23	5 Gal.	FOURWING SALTBUSH	Atriplex canescens	6.00	6.00	Drought Resistant
$\odot$	20	5 Gal.	THOMPSON BROOM	Baccharis x Starn	2.00	6.00	Low Water Use
$\bigcirc$	19	40" Box	DESERT WILLOW (Multi-Trunk)	Chilopsis linearis	20.00	25.00	Low Water Use
0	5	5 Gal.	TURPENTINE BUSH	Ericameria laricifolia	3.00	4.00	Drought Tolerant
$\odot$	42	5 Gal.	BLACK DALEA	Dalea frutescens 'Sierra Nigra'	3.00	4.00	Drought Tolerant
	24	5 Gal.	ENCHANTRESS HAWTHORNE	Raphiolepis Indica 'Enchantress'	3.00	3.00	Medium Water Use

GRO-LOW SUMAC

THREELEAF SUMAC

MEXICAN BLUE SAGE

SEMI-PROSTRATE ROSEMAR

$\Box$	19	5 Gal.	PINK AUTUMN SAGE	Salvia greggli	2.50	3.00	Medium Water Use				
SUCCULE	SUCCULENT - SEE B2/L003										
SYMBOL	. EST. QTY.	INSTALLED SIZE	COMMON NAME	Botanical name	Height	Width	Water requirements				
	36	5 Gal.	PARRY'S AGAVE	Agave parryl 'Neomexicana'	1.50	2.00	Low Water Use				
N N	41	5 Gai.	BLUE SOTOL	Dasylirion wheeleri	5.00	6.00	Low Water Use				
*	67	5 Gal.	RED HESPERALOE	Hesperaloe parviflora	4.00	4.00	Low Water Use				
**	54	5 Gal.	BEARGRASS	Nolina texana	4.00	5.00	Low Water Use				
1 23	9	5 Gal.	BEAVERTAIL PRICKLY PEAR	Opuntia basilaris	2.00	4.00	Low Water Use				
*	61	5 Gal.	BANANA YUCCA	Yucca baccata	3.00	4.00	Low Water Use				

Rhus aromatica 'Gro-Low'

l XX	9	5 Gai.	BEAVERTAIL PRICKLY PEAR	Opuntia basilaris	2.00	4.00	Low Water Use			
*	61	5 Gal.	BANANA YUCCA	Yucca baccata	3.00	4.00	Low Water Use			
SEED / SOD / MU	EED / SOD / MULCH									
	5,542 SF	SOD	Fescue spp.	N/A						
	36,086 SF	ROCK MULCH	∛ Rock Mulch, 3" min. Depth Color: Santa Fe Brown	For use in designated landscape areas with weed barrier fabric.						
	6,238 SF	CRUSHER FINES MULCH	Crusher Fines Rock Muich 3" min. Depth, Color: Santa Fe Brown	For use in designated landscape areas with weed barrier fabric.						
7 4 4 4 4 4 4 4 4 4 4 4 4 4 4 4 4 4 4 4	15,143 SF	COBBLE	2"-4" Cobble Rock Mulch 3" min. Depth, Color: Santa Ana Tan	For soil stabilization in water harvesting area with weed barrier fabric.						
ADDITIONAL NAT	TIVE SEEDING - TO	BE INSTALLED UNDER A SEPERAT	E CONTRACT							
	22,409 SF	NATIVE SEEDING	East Side Mix (No Fourwing Saltbush)	Seed Rate: 11 PLS lbs / acre, Drill seed.						

For use in designated landscape are

<b>ANDSCAPE</b>	<b>CALCULATIONS</b>	- FULL BUILD OUT

🖟 Rock Mulch, 3" min. Dept

TOTAL SITE AREA: 323,946 SF = 7.44 ACRES


**TOTAL GROSS BUILDING AREA: 100,000 SF** TOTAL UTILITY YARD AREA: 14,388 SF

Ö

NET LOT AREA: 209,558 SF / 4.81 ACRES

REQUIRED LANDSCAPE AREA: (15% OF NET LOT AREA): 31,434 SF / 0.72 ACRES PROVIDED LANDSCAPE AREA: (30% OF NET LOT AREA) 63,009 SF / 1.4 ACRES

TOTAL ALLOWED TURF GRASS: (20% OF OVERALL LANDSCAPE AREA): 12.602 SF / .29 ACRES TOTAL PROVIDED TURF GRASS: (8.8% OF OVERALL LANDSCAPE AREA): 5,542 SF / .13 ACRES

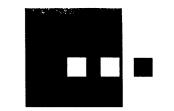

interiors

7601 Jefferson NE Albuquerque, NM 87109 505 761-9700 fax 761-4222 dps@dpsdesign.org

ARC **SUBMITTAL** 


Medium Water Use

**REVISIONS** 

1 01.28.08 - ARC Preliminary Review 2 02.14.08 - ARC Secondary Review /3\ 04.18.08 - LEVEL C COMMENTS

IF/CM/SY DRAWN BY **REVIEWED BY** MB/CG DATE 05/06/08 PROJECT NO. 07-0116 DRAWING NAME

LANDSCAPE PLAN **FULL BUILD OUT** 

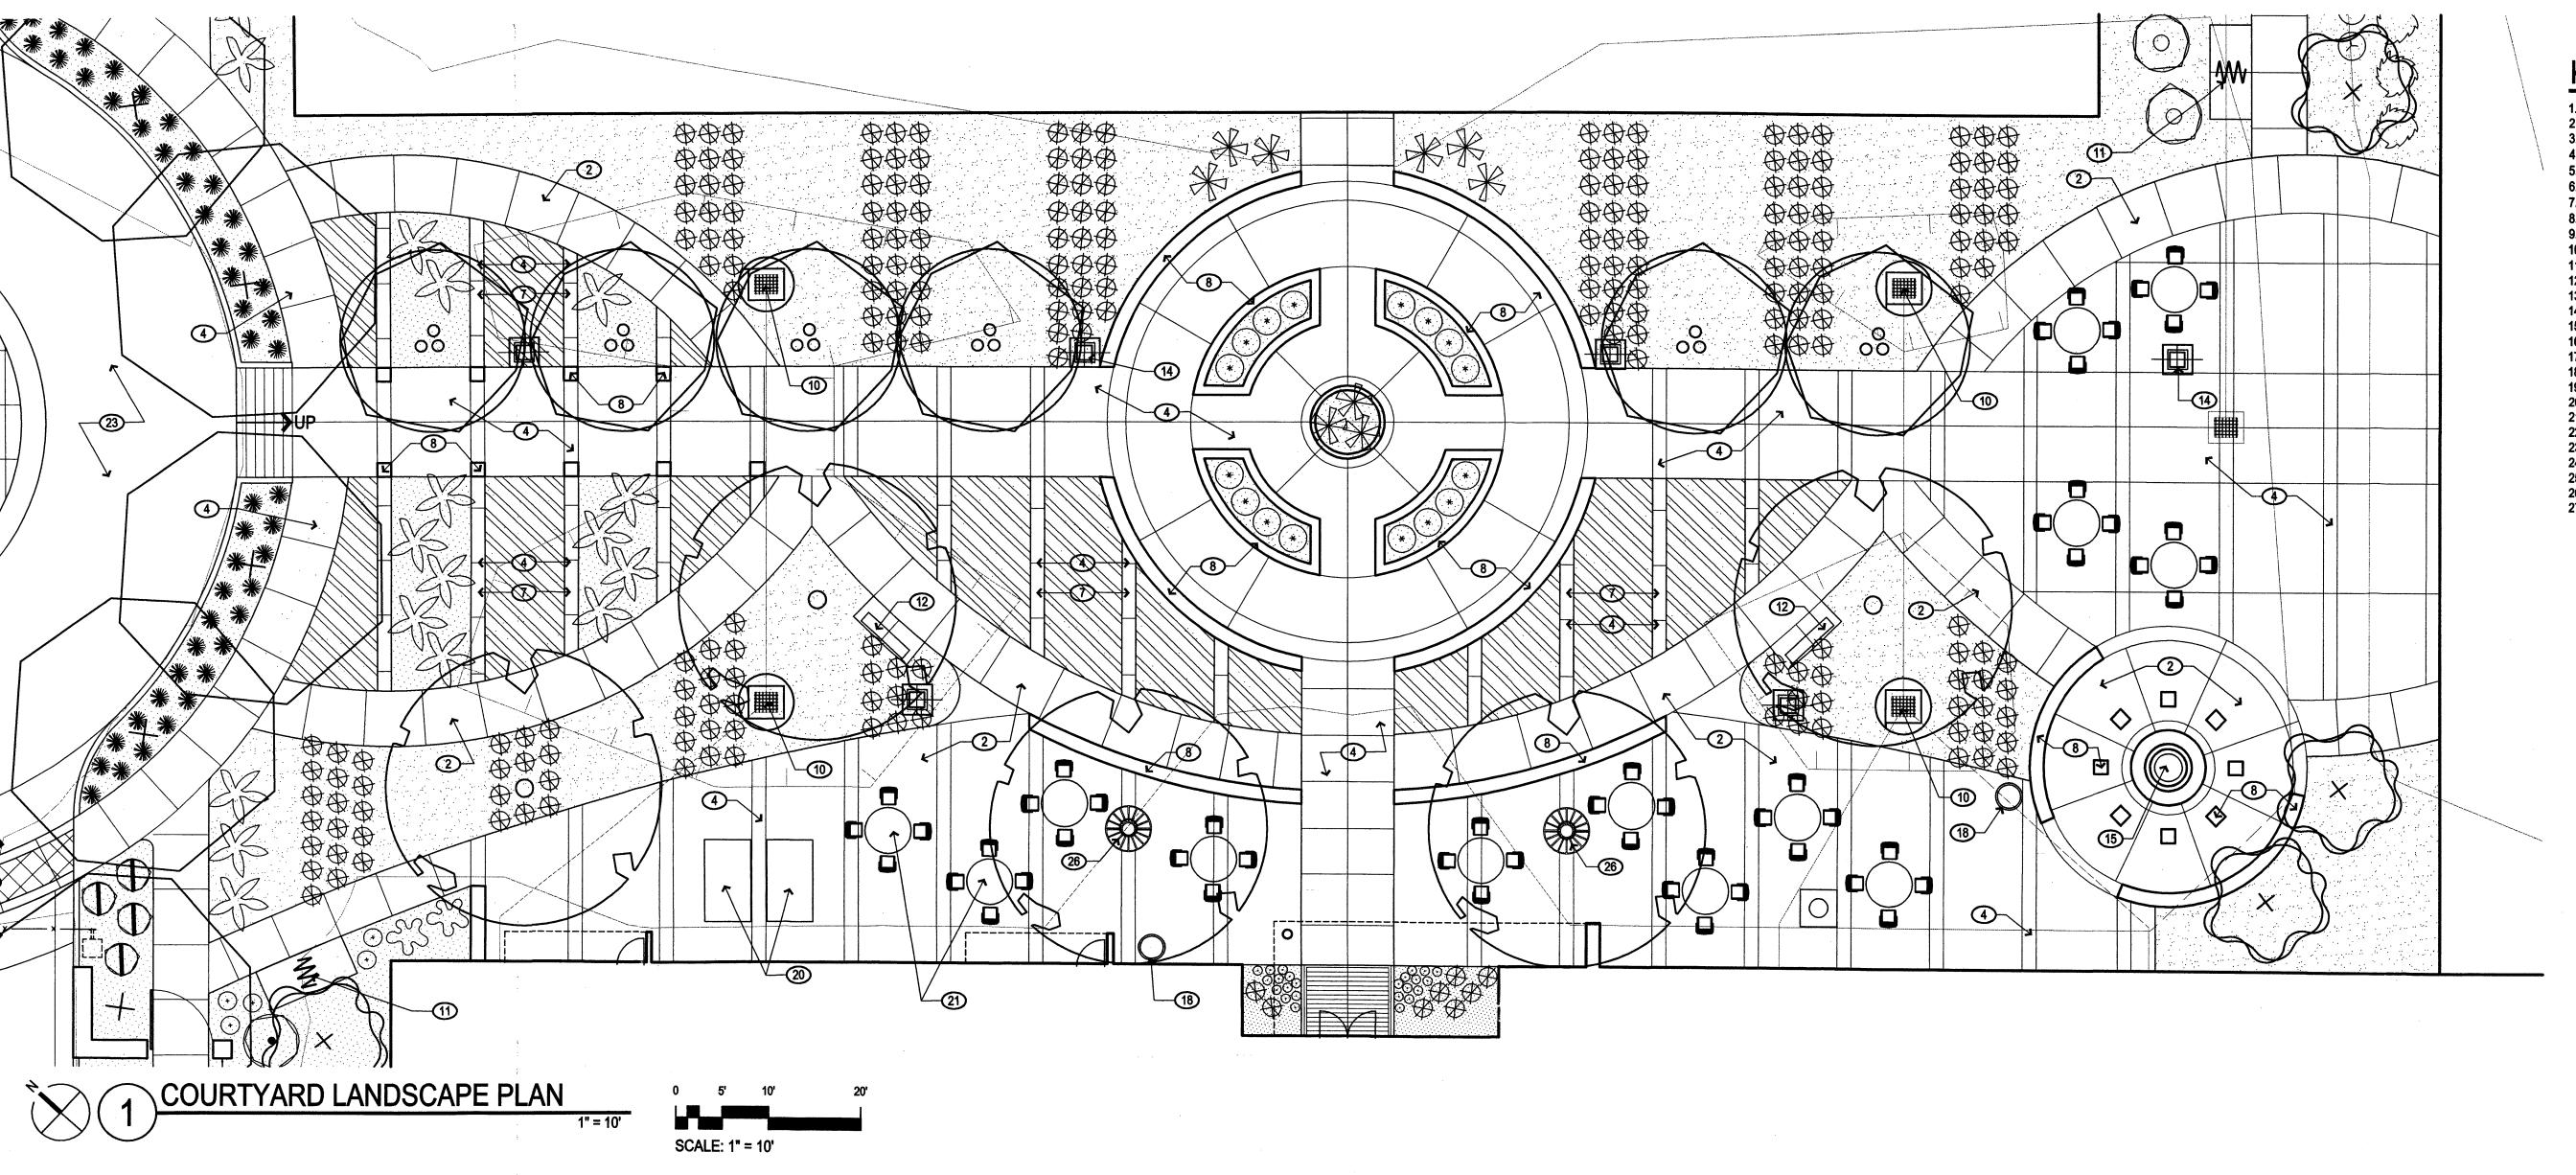

ROOT FLARE TO BE FLUSH WITH GRADE,

REMOVE SOIL TO EXPOSE ROOT FLARE

- NO MULCH 1"-2" FROM TRUNK FLARE

SLOPE GRADE AWAY FROM TRUNK

ROOTBALL ON UNDISTURBED SOIL

ROTARY TILL PLANT PIT; REMOVE

SOIL AT ROOT BALL ONLY. NATIVE SOIL BACKFILL PER SPECS.

- UNDISTURBED SOIL

PLANTING ZONE. HOWEVER, IF CALICHE

EXISTS, INSTALL 6" DEPTH OF ROUND

GRAVEL UNDER ROOTBALL, WITH (2) 6"

DIAMETER X 24" DEPTH GRAVEL-FILLED

HOLES THAT GO BELOW CALICHE LAYER

NOTE: NO CALICHE FOUND IN

FOR DRAINAGE

3/4" = 1'-0"

WEED BARRIER FABRIC

MULCH PER DRAWINGS AND

MULCH OVER PLANT CENTER,

ROUGH-UP SIDES OF PLANTING

SPECIFICATIONS. MAX. 1" DEPTH

TREE TO BE

SET PLUMB

FINISH GRADE -

NOTES:


3-5 TIMES ROOTBALL DIAMETER

TREE IN PLANTING BED

1. PRIOR TO BACKFILLING, ALL MATERIAL SUCH AS CONTAINERS,

WIRE, AND ROPE SHALL BE COMPLETELY REMOVED.

2. PRIOR TO BACKFILLING, REMOVE ALL BURLAP.

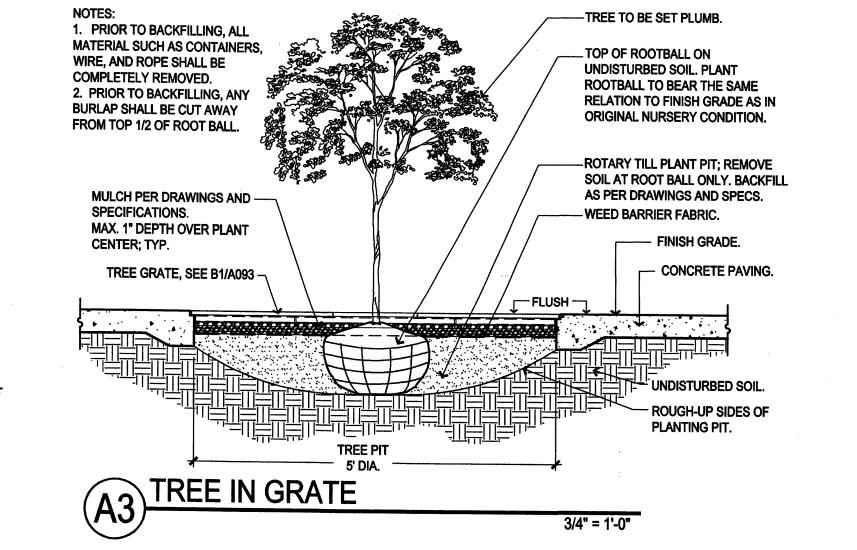



PROPERTY LINE CONCRETE PAVING 3. ASPHALT PAVING

4. INTEGRAL COLOR CONCRETE, SEE 1/L005 5. NOT USED 6. NOT USED

7. 18" WIDE CONCRETE MOW CURB 8. SEATWALL

9. SERVICE AREA 10. STORM DRAIN INLET, SEE CIVIL

11. BIKE RACK, SEE B/L005 12. BENCH, SEE A/L005 13. 6'-8" SCREEN WALL, SEE 1/A004

14. LIGHT POLE, SEE ELECTRICAL 15. FIRE PIT, N.I.C. 16. MONUMENT SIGN, 1/A001 17. 6'-8" SECURITY FENCE, SEE 2/A003

18. TRASH RECEPTACLE, SEE C/L005 19. WATER HARVESTING AREA, SEE L003 20. PING PONG TABLE, N.I.C.21. TABLE & CHAIRS, N.I.C., SEE D/L005

22. CLEAR SIGHT TRIANGLE 23. HEAVY DUTY ASPHALT 24. BASKETBALL HOOP, N.I.C.

25. VOLLEYBALL COURT, N.I.C. 26. 5' DIA. TREE GRATE, SEE E/L005 27. TEMPORARY SAND FENCE - PHASE I ONLY

7601 Jefferson NE Suite 100 Albuquerque, NM 87109 505 761-9700 fax 761-4222 dps ⊚ dpsdesign.org

architecture

interiors

planning

engineering

ARC **SUBMITTAL** 

PROJECT

REVIEWED OF


REVISIONS 01.28.08 - ARC Preliminary Review 2 02.14.08 - ARC Secondary Review


3 04.18.08 - LEVEL C COMMENTS

DRAWN BY IF/CM/SY **REVIEWED BY** DATE 05/06/08

PROJECT NO. 07-0116 DRAWING NAME COURTYARD

LANDSCAPE PLAN & TREE DETAILS

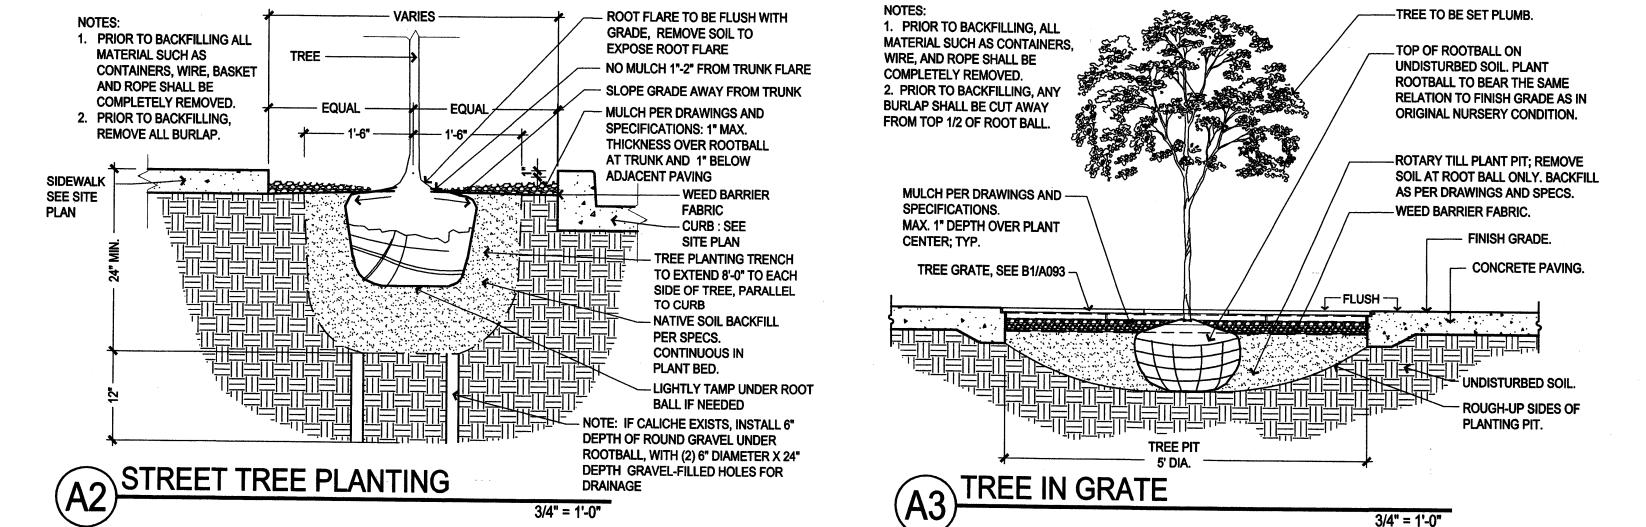

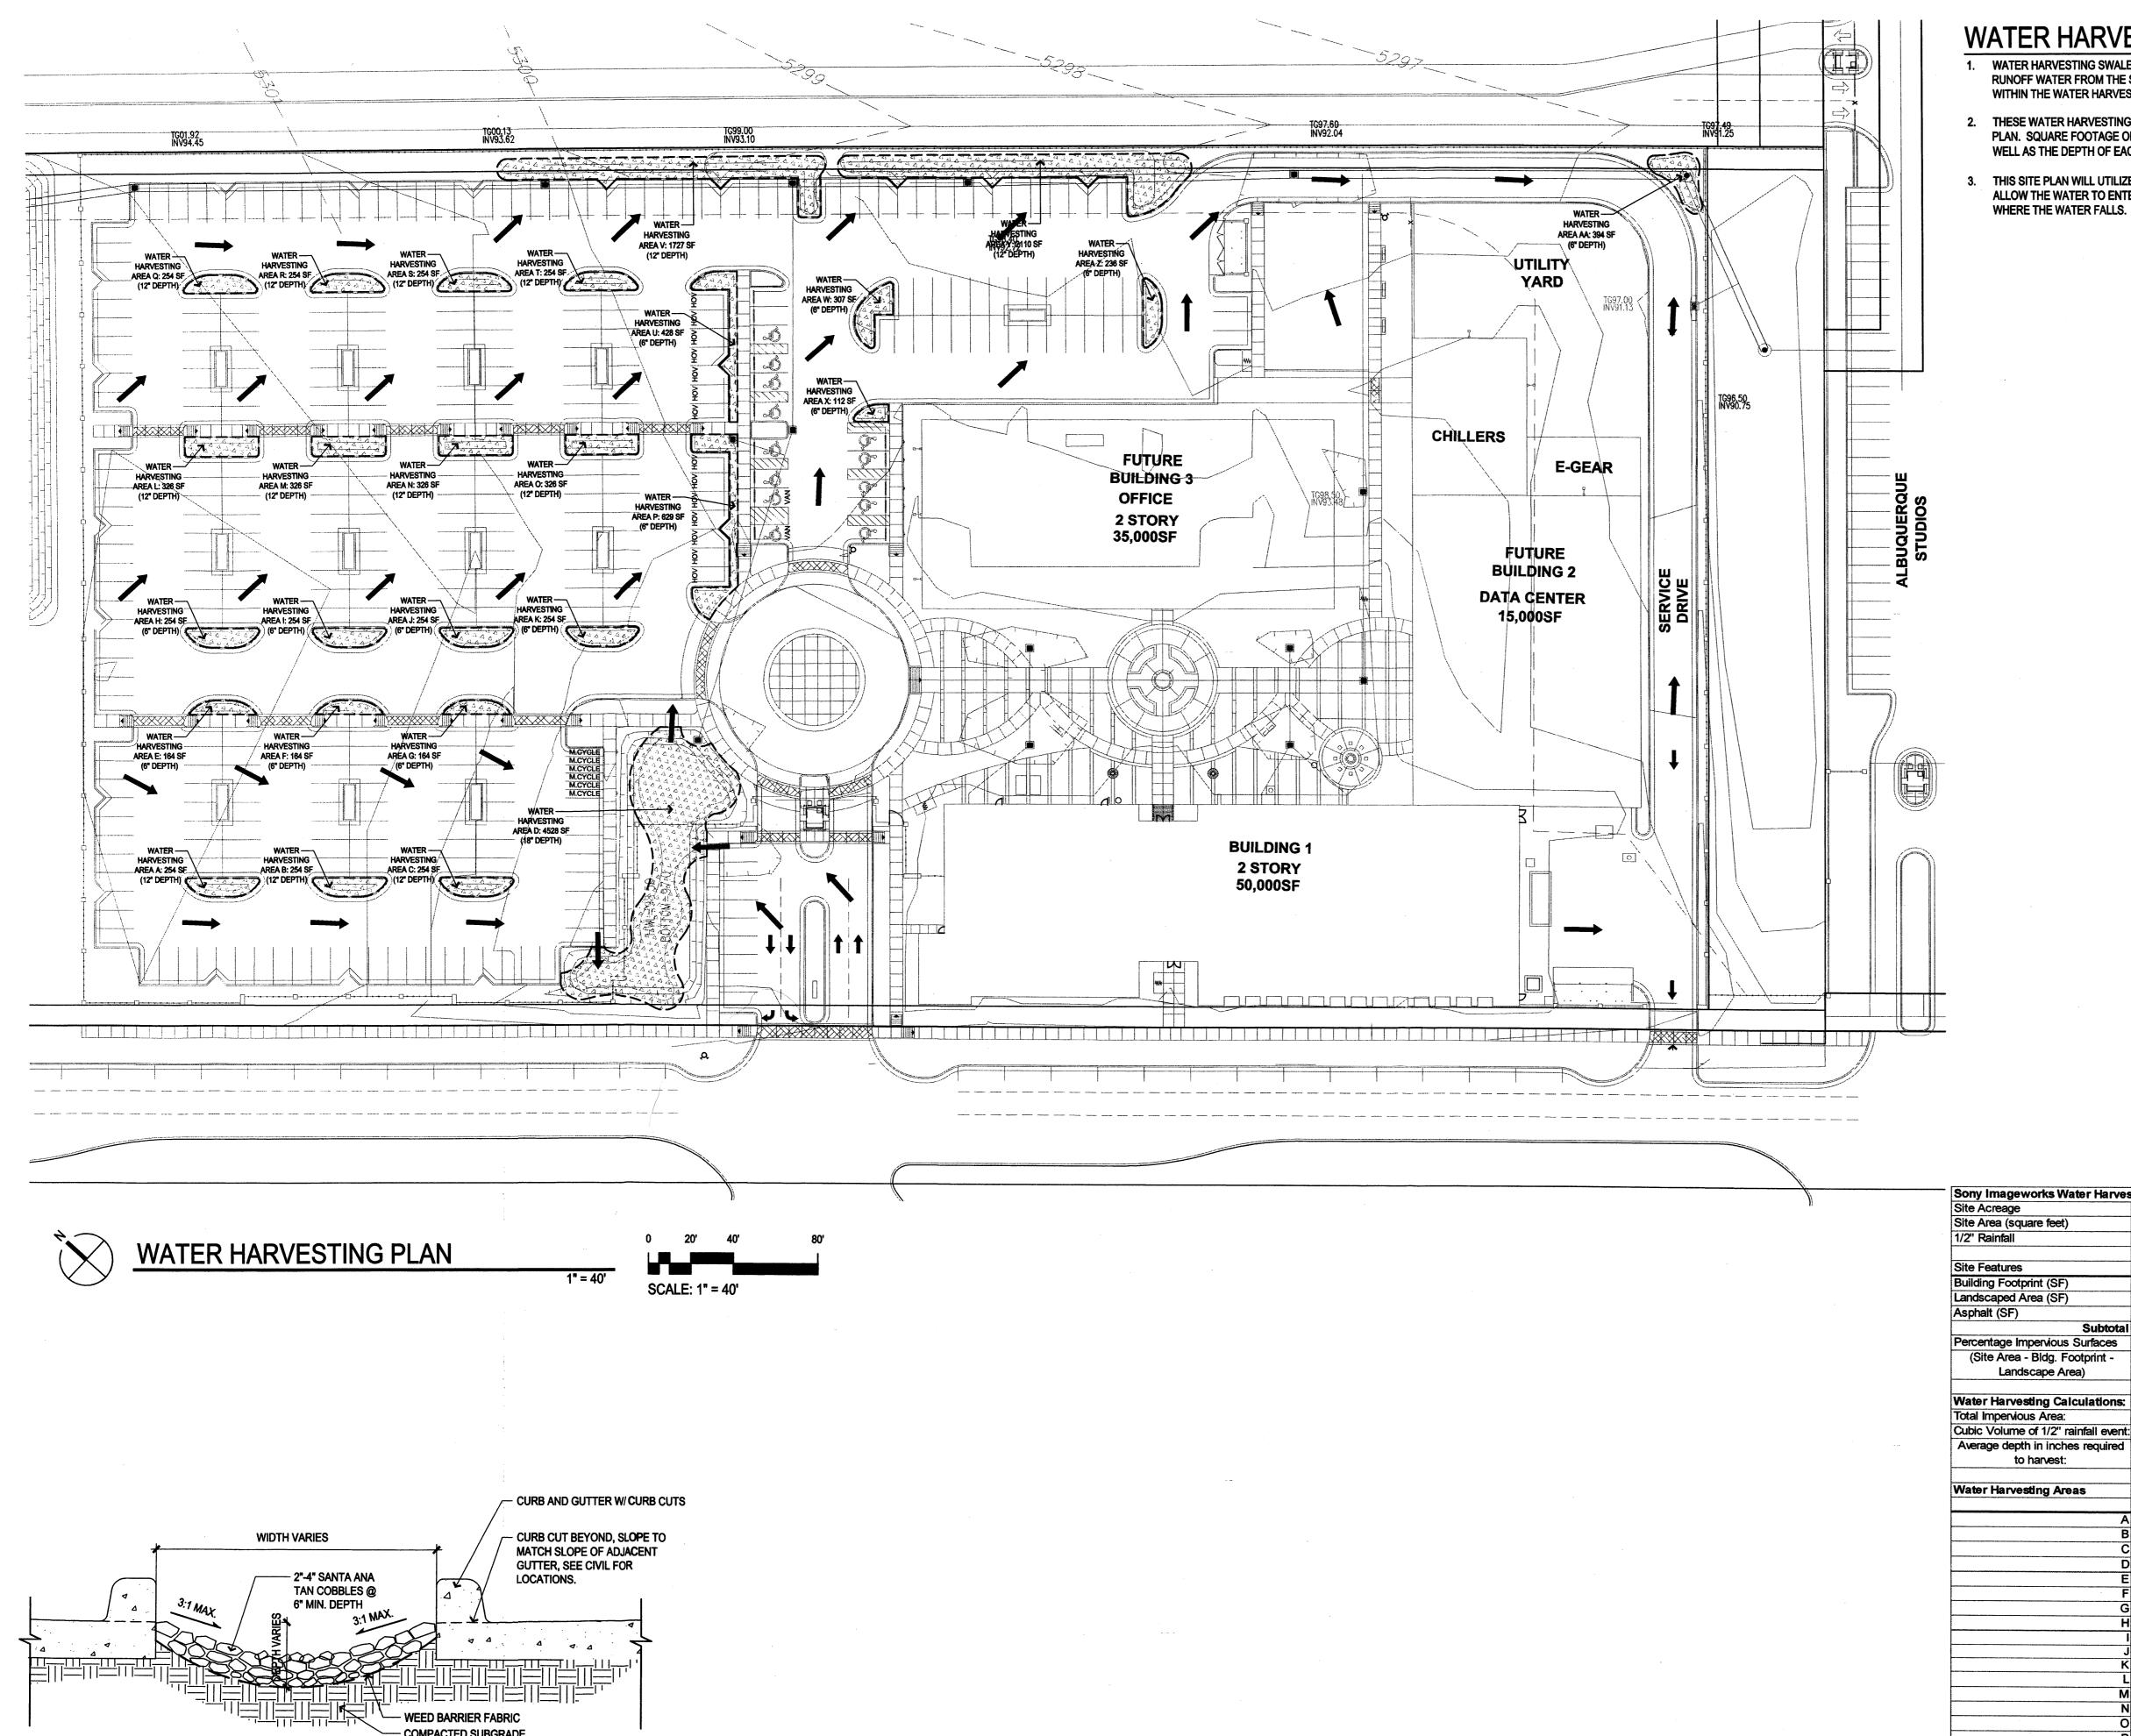

WATER HARVESTING AREA - CURB CUT SEE CIVIL FOR LOCATIONS

1" = 1'-0"

## WATER HARVESTING NOTES

- WATER HARVESTING SWALES AS SHOWN ON THE PLAN WILL HELP CAPTURE THE SURFACE RUNOFF WATER FROM THE SITE, AND WILL PROVIDE SUPPLEMENTAL WATER FOR PLANTS WITHIN THE WATER HARVESTING ZONES.
- THESE WATER HARVESTING AREAS ARE SHOWN AS THE HATCHED AREAS NOTED ON THE PLAN. SQUARE FOOTAGE OF TOP RIM OF EACH WATER HARVESTING AREA IS LISTED, AS WELL AS THE DEPTH OF EACH AREA.
- 3. THIS SITE PLAN WILL UTILIZE CURB CUTS IN NECESSARY LOCATIONS ACROSS THE SITE TO ALLOW THE WATER TO ENTER WATER HARVESTING AREAS AT THE LOCATION CLOSEST TO WHERE THE WATER FALLS. SEE CIVIL PLANS FOR CURB CUT LOCATIONS.



architecture interiors planning engineering

7601 Jefferson NE Suite 100 Albuquerque, NM 87109 505761-9700 fax761-4222 dps 🕲 dpsdesign.org

ARC **SUBMITTAL** 

323,946.00

63,009.00

160,937.00

Average SF Depth (feet) Volume Harvested

0.50

1.00

0.50

0.50

185

Slope of Pond Top Rim Bottom
Area SF Rim SF

4528

3 to 1

3 to 1

3 to 1

13,497.75 cubic feet

Area (SF) Run-off Co-efficient Impervious Area (SF

260,491.95

10,853.83 cubic feet

155.00

155.00

59.00

59.00

211.50

215.50 155.00

155.00 155.00 155.00

135.50 1,194.00 123.50

41.25

92.50

166.00

11,518.75 cubic feet

1,552.00

5,491.50

2.07 inches

95,000.00


12,601.80 152,890.15 260,491.95

01.28.08 - ARC Preliminary Review 2 02.14.08 - ARC Secondary Review

04.18.08 - LEVEL C COMMENTS

DRAWN BY	IF/CM/SY
REVIEWED BY	MB / CG
DATE	05/06/08
PROJECT NO.	07-0116

WATER HARVESTING PLAN

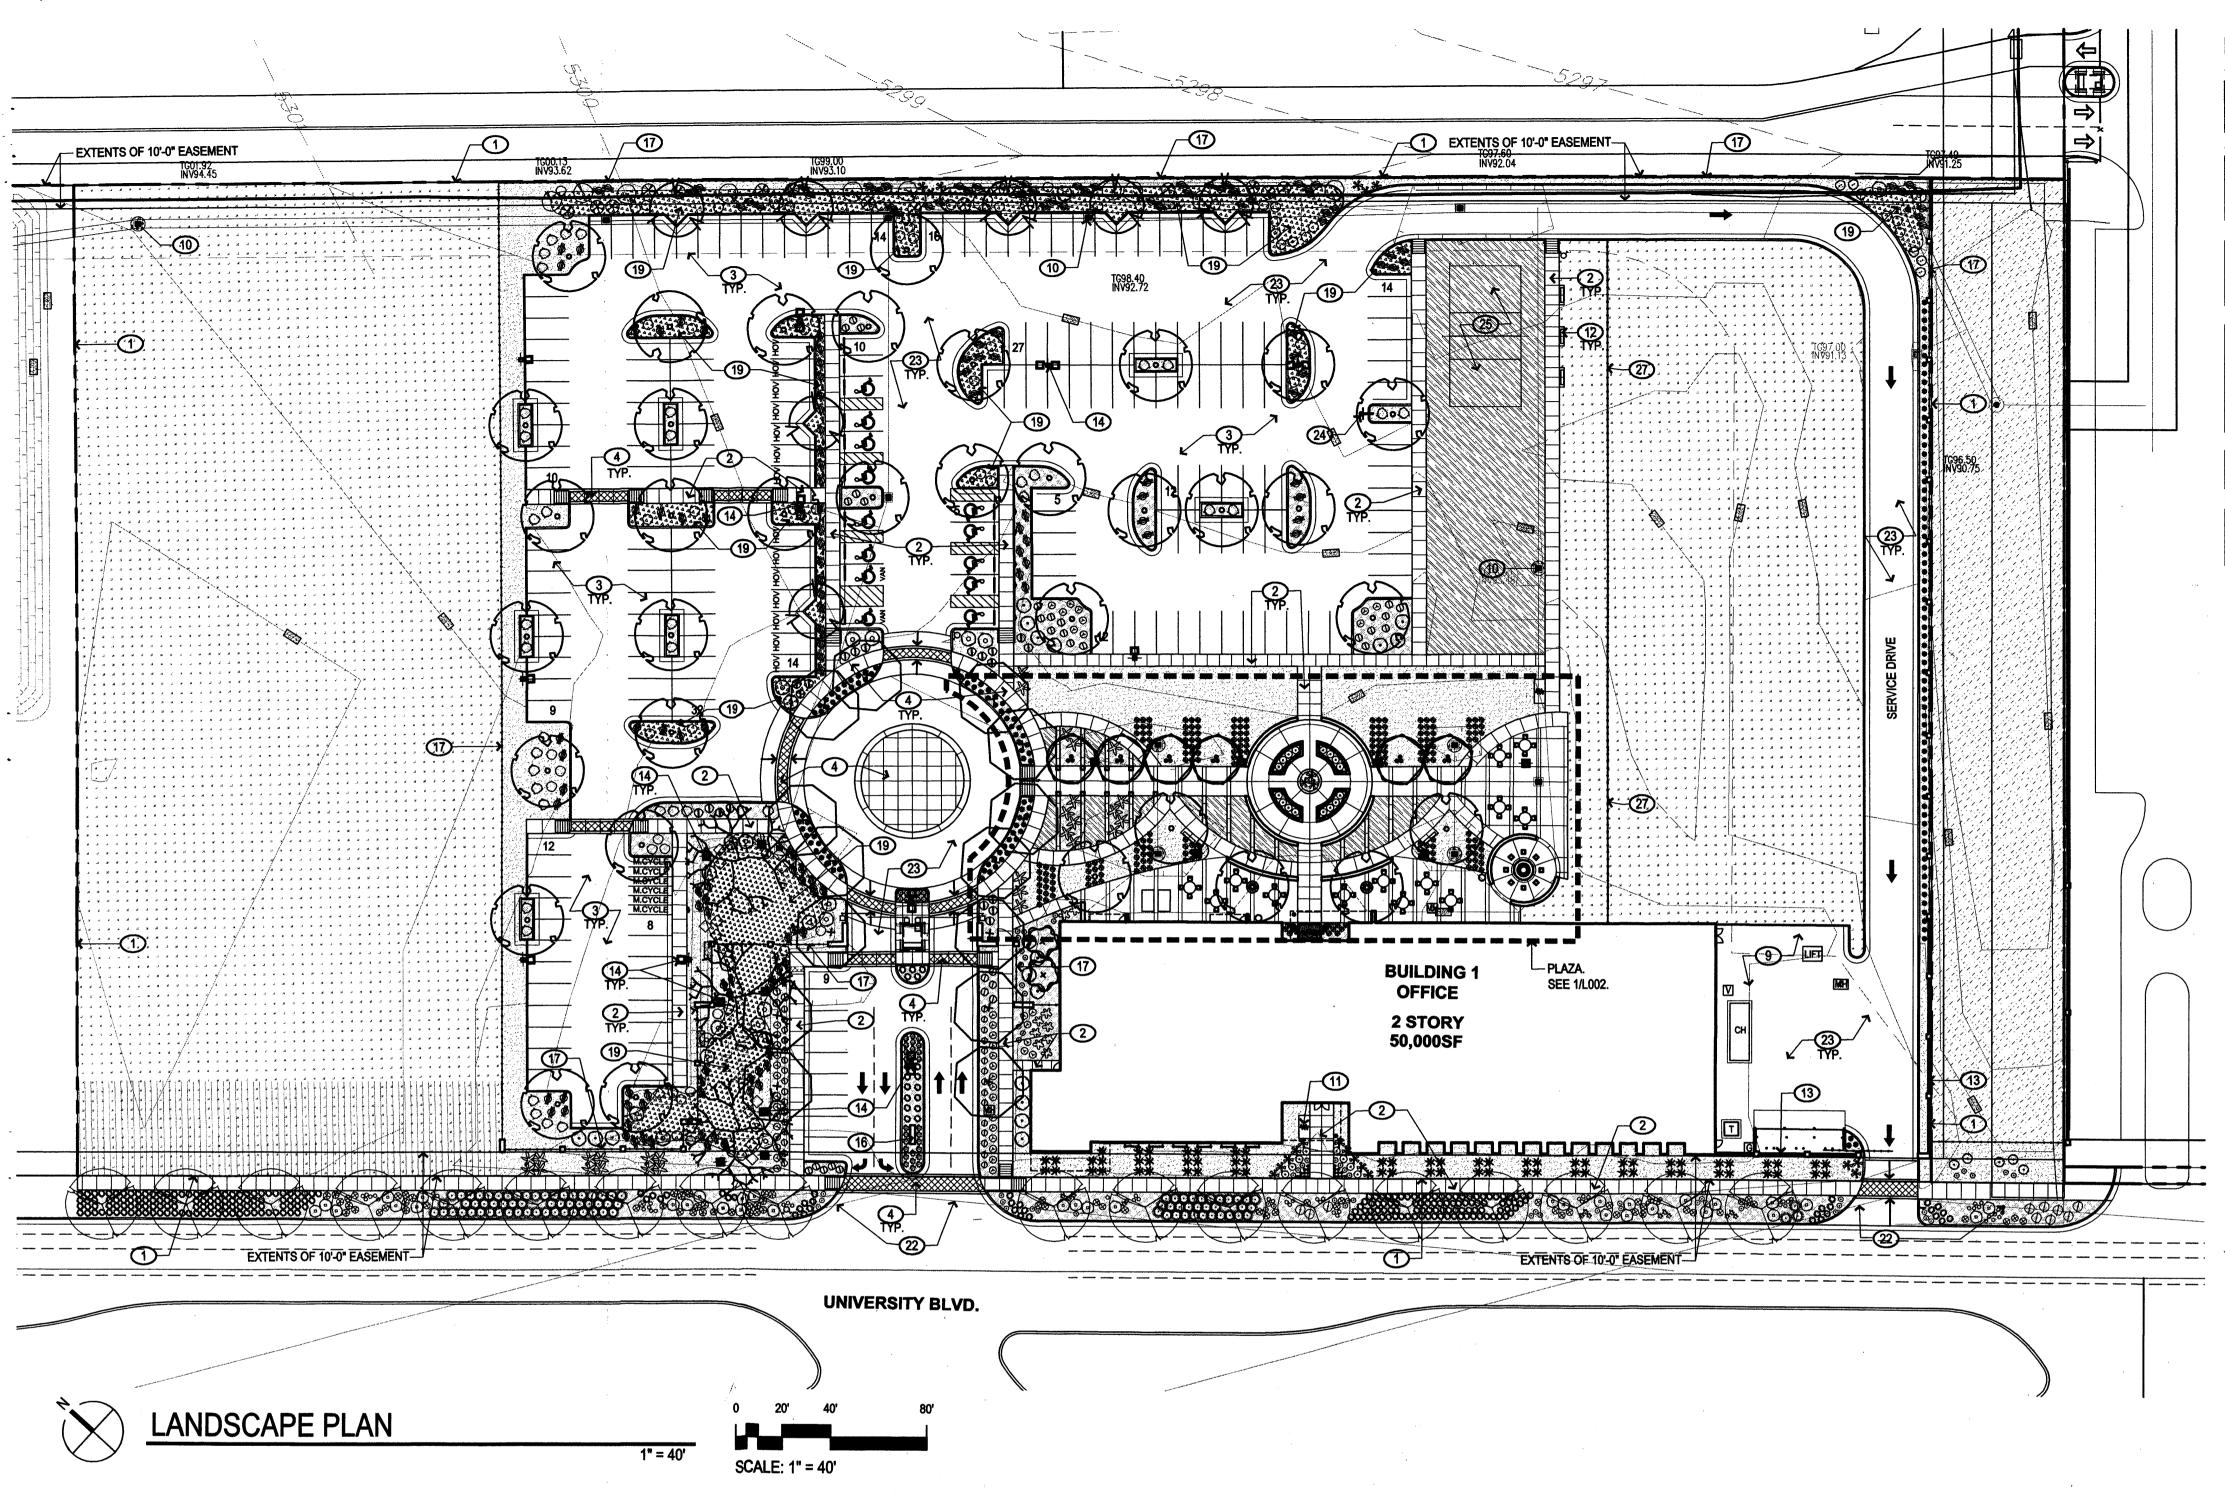

## **PLANTING NOTES**

1. LANDSCAPE DESCRIPTION THE LANDSCAPE DESIGN UTILIZES NATIVE PLANTS AND OTHER LOW-WATER-USE PLANTS THAT WILL REINFORCE THE SPECIAL LOCATION OF THE PROJECT - ON A HIGH DESERT GRASSLAND MESA. THE SELECTED SHRUBS, TREES AND ACCENTS ADD SEASONAL COLOR AND SCALE TO THE PROJECT, FOLLOW THE MESA DEL SOL DESIGN GUIDELINES, AND ESTABLISH AREAS OF WILDLIFE HABITAT.

2. EXISTING PLANT MATERIAL THERE IS NO LARGE SIZE VEGETATION ON THE SITE. THE EXISTING VEGETATION IS COMPRISED OF GRASSES AND FORBS AND SOME SHRUBS AT LOW DENSITIES.

3. INSTALLATION AND MAINTENANCE OF LANDSCAPING AND IRRIGATION SHALL BE THE RESPONSIBILITY OF THE PROPERTY

4. AFTER SUBSTANTIAL COMPLETION, THE OWNER WILL BE RESPONSIBLE FOR MAINTAINING APPROPRIATE BRANCH CLEARANCES OVER WALKS AND STREETS WHERE MULTI-TRUNK TREES ARE USED.

5. THE LANDSCAPE DESIGN SHALL COMPLY WITH THE INTENT OF THE CITY OF ALBUQUERQUE WATER CONSERVATION, LANDSCAPING AND WATER WASTE ORDINANCE.

6. WATER USE DESCRIPTION: PLANT MATERIALS HAVE BEEN CHOSEN FOR THEIR XERIC QUALITIES IN ADDITION TO THEIR AESTHETIC AND HABITAT VALUES. A MINIMAL AMOUNT OF TURF IS USED IN THIS DESIGN.

7. MINIMUM INSTALLATION SIZES FOR PLANT MATERIAL VARY BY SPECIES. SEE PLANT LEGEND.

8. SOIL BOND SHALL BE ADDED TO SEED INSTALLATION IN WATER HARVESTING AREAS AND ON SLOPES GREATER THAN 3:1.

9. LANDSCAPE FABRIC: ALL LANDSCAPE AREAS, EXCEPT FOR SEEDED AND SODDED AREAS, SHALL BE COVERED WITH LANDSCAPE WEED BARRIER FABRIC PRIOR TO MULCHING, IN ORDER TO MINIMIZE WEED GROWTH AND HELP MAINTAIN SOIL MOISTURE.

10. LANDSCAPE AREAS SHALL BE COVERED WITH EITHER SEED, SOD, OR ROCK MULCH. SEE LANDSCAPE LEGEND, L001. PLANT QUANTITIES AND AREA SQUARE FOOTAGES ARE APPROXIMATE, CONTRACTOR IS RESPONSIBLE FOR VERIFYING QUANTITIES FOR FINAL PRICING.

11. SOIL PREPARATION WITHIN ROW IS REQUIRED TO CLEAR DEBRIS AND DE-COMPACT LANDSCAPE ZONE PRIOR TO PLANTING. SEE

SPECIFICATIONS. 12. ALL LANDSCAPING WITHIN THE R.O.W. MUST CONFORM TO THE MESA DEL SOL STREETSCAPE MASTER PLAN.

13. SOIL SECRETS SOIL BIOLOGY AMENDMENTS SHALL BE USED ON ALL PLANTING, SODDED, AND SEEDED AREAS. (SOIL SECRETS: 505-550-3246 OR WWW.SOILSECRETS.COM)

A. PRODUCTS AND RATES SHALL BE AS FOLLOWS: 1. SOIL INNOCULUM: TERRA PRO-COMMERCIAL OR APPROVED EQUAL. TERRA PRO-COMMERCIAL IS A FULL SPECTRUM ORGANIC SOIL INNOCULUM WITH BACTERIA, ENZYMES, COENQYMES, MYCHORRIZAE, AND PROTOZOA. TERRA PRO-COMMERCIAL IS PRODUCED BY SOIL SECRETS (505-550-3246, WWW.SOILSECRETS.COM). APPLY AT A RATE OF 2000 LBS. PER ACRE, WHICH IS ONE .6 CUBIC FOOT BAG PER 1000 SF OR 43 BAGS PER ACRE.

2. CATALYST: PROTEIN CRUMBLIES OR APPROVED EQUAL PROTEIN CRUMBLIES IS A NATURAL SOURCE OF CRUDE PROTEIN. PROTEIN CRUMBLIES IS PRODUCED BY SOIL SECRETS. APPLY AT A RATE OF 800 LBS. PER ACRE. WHICH IS ONE .6 CUBIC FOOT BAG PER 2000 SF OR 22 BAGS PER ACRE.

#### B. APPLICATIONS OF SOIL AMENDMENTS ARE REQUIRED AT INSTALLATION AND AGAIN DURING THE WARRANTY PERIOD.

C. APPLICATION OF SOIL AMENDMENTS FOR TREES, GROUND COVERS, SHRUBS, AND SUCCULENTS IS TO BE MADE OVER EACH PLANT PIT. FOR PURPOSES OF BIDDING, ASSUME THE

TREES: 78.5 SF EACH

**FOLLOWING AREAS:** 

SHRUBS, GRASSES, GROUND COVERS, SUCCULENTS: 5 GAL.: 28 SF EACH/1 GAL.: 12 SF EACH

D. FOLLOWING PLANTING AND SEEDING, SOIL AMENDMENTS SHALL BE SPREAD UNIFORMLY OVER PLANTING PIT AND SEEDED AREAS. CONTRACTOR SHALL WATER AMENDMENTS INTO SOIL PER MANUFACTURER'S INSTRUCTIONS.

14. NATIVE SOILS SHALL BE USED FOR LANDSCAPE INSTALLATION. IMPORT OF PLANTING MIX OR HIGH QUALITY TOPSOIL IS NOT REQUIRED UNLESS THE SOILS HAVE BEEN CONTAMINATED DURING THE CONSTRUCTION PROCESS.

15. PASSIVE WATER HARVESTING: PASSIVE WATER HARVESTING, SUCH AS HARVESTING OF STORM WATER SURFACE RUNOFF AND ROOF RUNOFF, IS UTILIZED WHERE FEASIBLE.

16. THIS LANDSCAPE PLAN IS COMPLIANT WITH THE REQUIREMENTS SET FORTH BY THE THE MESA DEL SOL DESIGN GUIDELINES BOOK.

17. STREETSCAPE PLANTING WAS DESIGNED BY EDAW AND IS SHOWN WITH A SEPARATE PLANTING LEGEND TO CLARIFY THAT THIS AREA WAS DESIGNED BY THEM.

## **IRRIGATION NOTES**

1. THE LANDSCAPE DESIGN REQUIRES A PERMANENT, FULLY AUTOMATIC IRRIGATION SYSTEM TO SUPPORT THE PLANT MATERIAL. THE IRRIGATION SYSTEM SHALL BE DESIGNED TO ACCOMMODATE NON-POTABLE WATER. IRRIGATION SHALL BE PROVIDED TO ALL CONTAINER PLANTS, AND POTENTIALLY TO SEEDED AREAS.

2. IRRIGATION: WE ARE NOT SHOWING AN IRRIGATION PLAN FOR THE FOLLOWING REASONS:

1) AN IRRIGATION PLAN AT THIS LEVEL OF SUBMISSION WOULD ONLY REFLECT A CONCEPTUAL DESIGN, AND NOT A CONSTRUCTION DOCUMENT LEVEL. THE LANDSCAPE CONTRACTOR WILL SUPPLY THE IRRIGATION PLAN.

2) THE CITY OF ALBUQUERQUE DOES NOT REQUIRE AN IRRIGATION PLAN AT THIS LEVEL OF DOCUMENTATION.

3. THE CONTRACTOR SHALL CREATE AN IRRIGATION PLAN TO PERMANENTLY IRRIGATE THE PROPOSED PLANTINGS, AND SHALL SUBMIT THIS TO THE LANDSCAPE ARCHITECT FOR REVIEW AND APPROVAL. THE PLAN SHALL INCLUDE A PIPING AND EMITTER LAYOUT WITH SIZING, VALVE SCHEDULE AND CONSTRUCTION DETAILS. CONTROLLER: THE IRRIGATION SYSTEM SHALL BE RUN WITH FULLY AUTOMATED IRRIGATION CONTROLLER. RUN TIME WILL BE ADJUSTED ACCORDING TO PLANT MATURITY, ADDITIVE ALTERNATES. SEASON, LOCATION, AND PLANT PERFORMANCE.

4. DRIP EMITTERS SHALL BE USED FOR ALL PLANT MATERIAL OTHER THAN

## **KEYED NOTES**

PROPERTY LINE **CONCRETE PAVING ASPHALT PAVING** INTEGRAL COLOR CONCRETE, SEE 1/L005 NOT USED

NOT USED 18" WIDE CONCRETE MOW CURB SEATWALL SERVICE AREA 10. STORM DRAIN INLET, SEE CIVIL 11. BIKE RACK, SEE B/L005

13. 6'-8" SCREEN WALL, SEE 1/A004 14. LIGHT POLE, SEE ELECTRICAL 15. FIRE PIT. N.I.C. 16. MONUMENT SIGN, 1/A001 17. 6'-8" SECURITY FENCE, SEE 2/A003

18. TRASH RECEPTACLE, SEE C/L005 19. WATER HARVESTING AREA, SEE L003 20. PING PONG TABLE, N.I.C. 21. TABLE & CHAIRS, N.I.C., SEE D/L005 22. CLEAR SIGHT TRIANGLE 23. HEAVY DUTY ASPHALT

24. BASKETBALL HOOP, N.I.C.

12. BENCH, SEE A/L005

25. VOLLEYBALL COURT, N.I.C. 26. 5' DIA. TREE GRATE, SEE E/L005 27. TEMPORARY SAND FENCE - PHASE I ONLY

**TOTAL GROSS BUILDING AREA: 100,000 SF** 

REQUIRED LANDSCAPE AREA: (15% OF NET LOT AREA): 31,434 SF / 0.72 ACRES

TOTAL ALLOWED TURF GRASS: (20% OF OVERALL LANDSCAPE AREA): 13,305 SF / .3 ACRES TOTAL PROVIDED TURF GRASS: (2.5% OF OVERALL LANDSCAPE AREA): 1,631 SF / .04 ACRES

## PLANTING SCHEDULE - MDS STREETSCAPE - PHASE I

SYMBOL	EST. QTY.	INSTALLED SIZE	COMMON NAME	Botanical name	Height	Width	Water requiremen
$\bigcirc$	18	3" Cai.	CHINESE PISTACHE	Pistacia chinensis	35.00	30.00	Low Water Use
RASS - SEE I	31 & B3/L003						
SYMBOL	EST. QTY.	INSTALLED SIZE	COMMON NAME	Botanical name	Height	Width	Water requireme
$\Diamond$	252	5 Gal.	REGAL MIST GRASS	Muhlenbergia capitlaris 'Regal Mist'	3.50	3.00	Medium Water U
$\Theta$	21	1 Gal.	NASHVILLE MUHLEY	Muhlenbergia rigida 'Nashville'	2.00	3.00	Medium Water U
ROUND COV	ER - SEE B3/L003						
SYMBOL	EST. QTY.	INSTALLED SIZE	COMMON NAME	Botanical name	Height	Width	Water requireme
0	63	1 Gal.	PURPLE CONEFLOWER	Echinacea purpurea	3.00	1.50	Moist At All Time
$\bigoplus$	48	1 Gal.	SUNSET PENSTEMON	Penstemon clutel	3.00	2.00	Low Water Use
HRUB - SEE I	B1 & C3/L003						· · · · · · · · · · · · · · · · · · ·
SYMBOL	EST. QTY.	INSTALLED SIZE	COMMON NAME	Botanical name	Height	Width	Water requireme
<b>①</b>	34	5 Gal.	TRAILING INDIGO BUSH	Dalea greggii	1.50	8.00	Drought Tolerani
$\Theta$	10	5 Gal.	TURPENTINE BUSH	Ericameria laricifolia	3.00	4.00	Drought Toleran
0	89	5 Gal.	GREEN CLOUD RANGER	Leucophyllum frutescens 'Green Cloud'	5.00	5.00	Drought Toleran
$\odot$	33	3 Gal.	MEXICAN BLUE SAGE	Salvia chamaedryoides	1.50	2.00	Low Water Use
UCCULENT -	SEE B2/L003						
SYMBOL	EST. QTY.	INSTALLED SIZE	COMMON NAME	Botanical name	Height	Width	Water requireme
W.	13	3 Gai.	MESCAL AGAVE	Agave parryli 'Neomexicana'	2.00	2.00	Drought Tolerant
EED/SOD/N	MULCH						

### PLANTING SCHEDULE - PHASE

SYMBOL.	EST. QTY.	INSTALLED SIZE	COMMON NAME	Botanical name	Height	Width	Wa
	2	40" Box	DESERT OLIVE (Multi-Trunk)	Forestiera neomexicana	12.00	12.00	Me
E. 3	35	2.5" Cal.	RAYWOOD ASH	Fraxinus oxycarpa 'Raywood'	35.00	30.00	Me
	3	2.5" Cal.	RIO GRANDE COTTONWOOD (2 Trunk)	Populus wislizenii 'Rio Grande'	35.00	45.00	He
$\odot$	14	2.5" Cal.	IDAHO LOCUST	Robinia ambigua 'Idahoensis'	35.00	30.00	Lo
$\odot$	6	40" Box	CHASTE TREE	Vitex agnus-castus	25.00	20.00	Мө
GRASS - SEE I	B1 & B3/L003						
SYMBOL	EST. QTY.	INSTALLED SIZE	COMMON NAME	Botanical name	Height	Width	Wa
$\bigotimes$	195	1 Gal.	KARL FORESTER REED GRASS	Calamagrostis x acutifolia 'Kari Forester'	5.00	2.00	Lo
$\odot$	44	1 Gal.	BLUE FESCUE	Festuca ovina giauca	1.00	1.00	Ме
	17	5 Gal.	REGAL MIST GRASS	Muhlenbergia capillaris 'Regal Mist'	3.50	3.00	Me
<b>₩00</b> ₩	167	5 Gal	EL TORO MUHLEY	Muhlenbergia emersleyi El Toro	3.00	3.00	Lo
*	163	1 Gal.	THREADGRASS	Nassella tenuissima	2.00	2.00	Lo
(F).	45	1 Gai.	DWARF FOUNTAIN GRASS	Pennisetum alcepecroides 'Hamein'	3.00	3.00	Мө

FOURWING SALTBUSH Atriplex canescens 6.00 6.00 Low Water Use THOMPSON BROOM **DESERT WILLOW (Multi-Trunk** BLACK DALEA TURPENTINE BUSH 5 Gal. **ENCHANTRESS INDIA HAWTHOR!** GRO-LOW SUMAC THREELEAF SUMAC

PINK AUTUMN SAGE Salvia greggii SUCCULENT - SEE B2/L003 INSTALLED SIZ COMMON NAME PARRY'S AGAVE BLUE SOTOL RED HESPERALOE BEAVERTAIL PRICKLY PEAR 5 Gal. BANANA YUCCA 4.00 Low Water Use SEED / SOD / MULCH

SEMI-PROSTRATE ROSEMARY

MEXICAN BLUE SAGE

10.122 SF Reveille Sod Trufgrass GardnerTurfgrass, Inc. NATIVE SEEDING Seed Rate: 11 PLS lbs / acre, Drill seed 7,025 SF NATIVE SEEDING East Side Mix Curtis & Curtis 27,647 SF 7 Rock Mulch, 3" min. Depth For use in designated landscape areas Crusher Fines Rock Mulch, 3" min. Depth, For soil stabilization in water harvesting area 2"-4" Cobble Rock Mulch, 3" min. Depth, Color: Santa Ana Tan - Lafarge Materials

ADDITIONAL NATIVE SEEDING - TO BE INSTALLED UNDER A SEPARATE CONTRACT eed Rate: 11 PLS lbs / acre, Drill seed ROCK MULCH

## LANDSCAPE CALCULATIONS

TOTAL SITE AREA: 323,946 SF = 7.44 ACRES

**TOTAL UTILITY YARD AREA: 14,388 SF** 

NET LOT AREA: 209,558 SF / 4.81 ACRES

PROVIDED LANDSCAPE AREA: (32% OF NET LOT AREA) 66,525 SF / 1.5 ACRES

Albuquerque, NM 87109 505 761-9700 fax 761-4222 dps @ dpsdesign.org

**SUBMITTAL** 

0


1 01.28.08 - ARC Preliminary Review


2 02.14.08 - ARC Secondary Review 3 04.18.08 - LEVEL C COMMENTS

DRAWN BY IF/CM/SY **REVIEWED BY** MB / CG DATE 05/06/08 PROJECT NO. 07-0116


LANDSCAPE PLAN PHASE I

DRAWING NAME

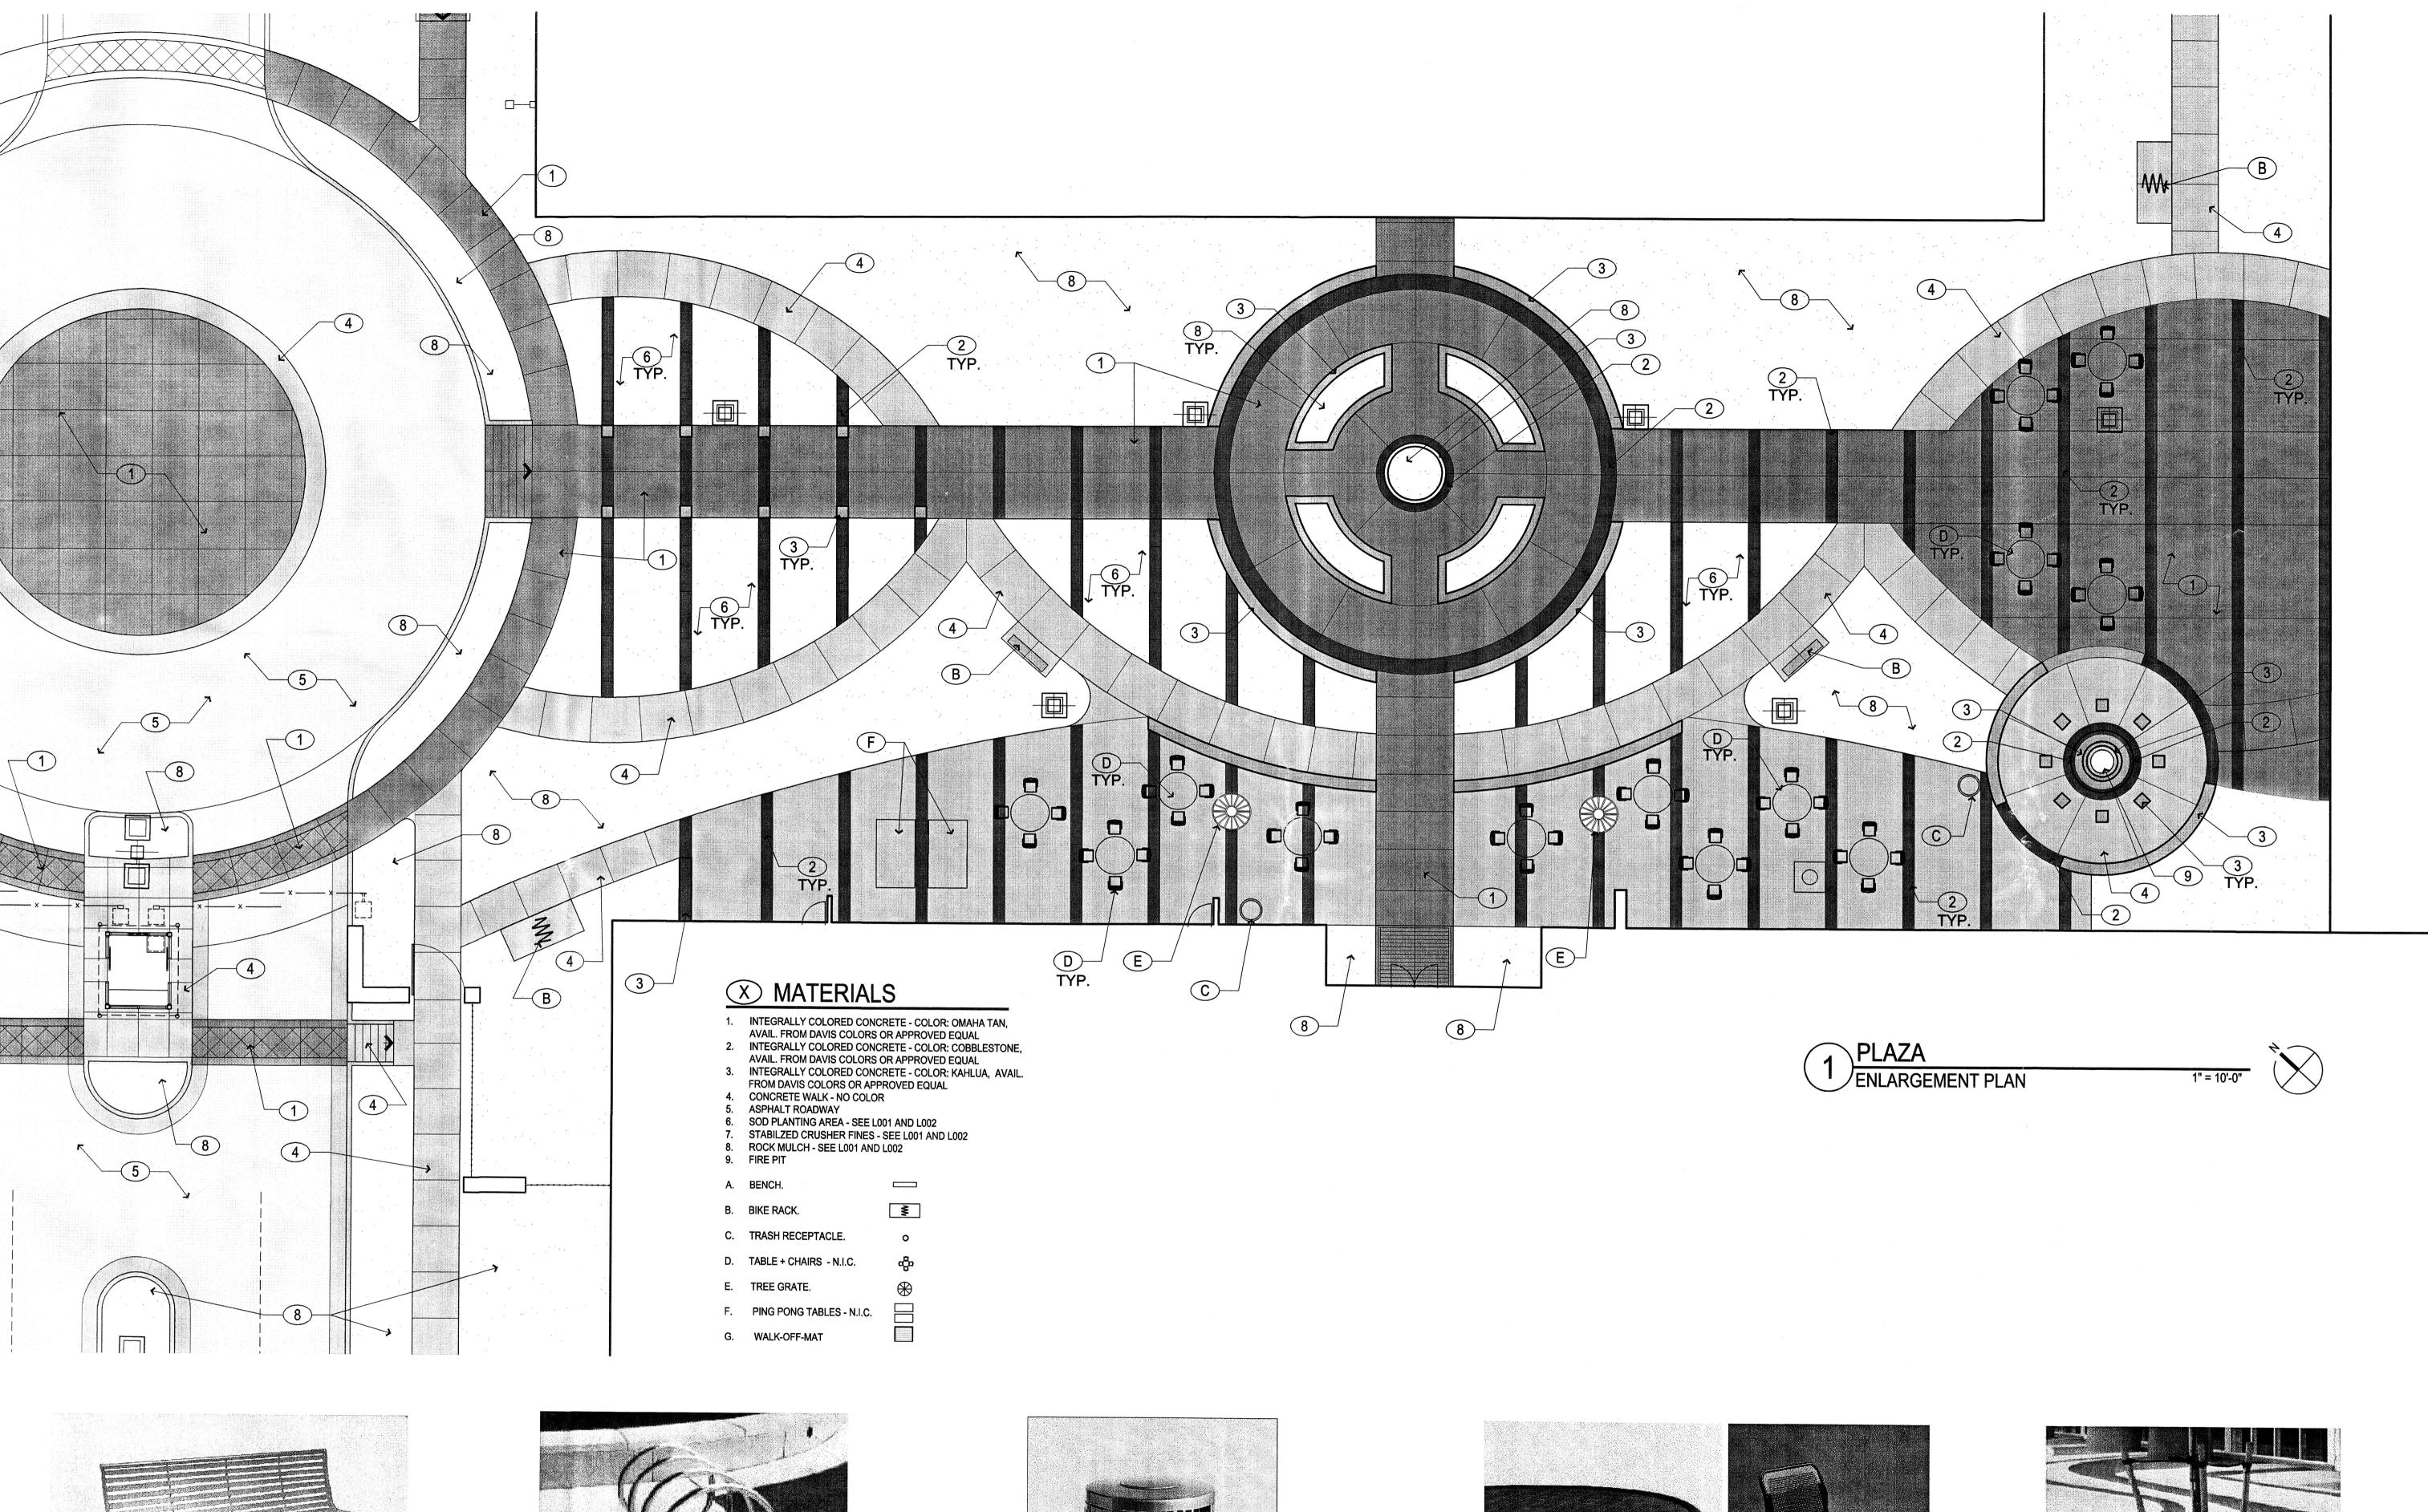

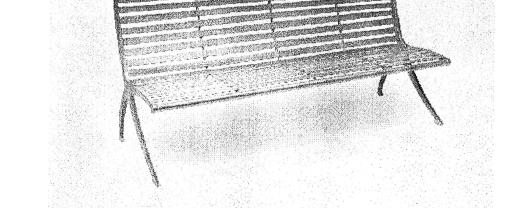


A PARC VUE BENCH

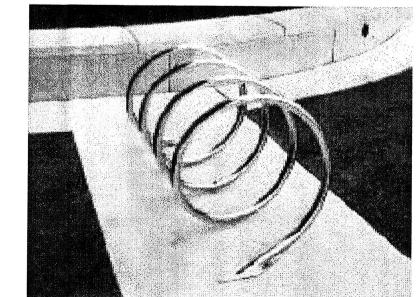


B)BIKE RACK

N.T.S.

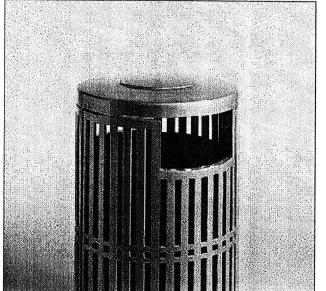

CHASE PARK TRASH RECEPTACLE

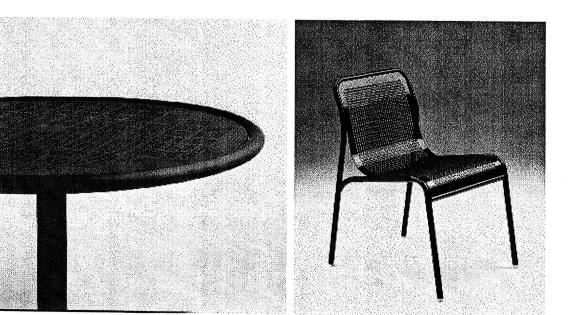

D TABLE AND CHAIRS



E TREE GRATE

Dekker Perich

architecture

interiors

7601 Jefferson NE Suite 100 Albuquerque, NM 87109 505 761-9700 fax 761-4222 dps @dpsdesign.org

ARCHITEC

ARC SUBMITTAL

ENGINE

PRO IF

SONY IMAGEWORKS

@ Mesa del Sol

Albuquerque

REVISIONS

01.28.08 - ARC Preliminary Review

02.14.08 - ARC Secondary Review

04.18.08 - LEVEL C COMMENTS

DRAWN BY

REVIEWED BY

MB / CG

DATE

05/06/08

PROJECT NO.

07-0116


DRAWING NAME


SITE FURNISHINGS & FINISHES

SHEET NO.

N.T.S.

L005

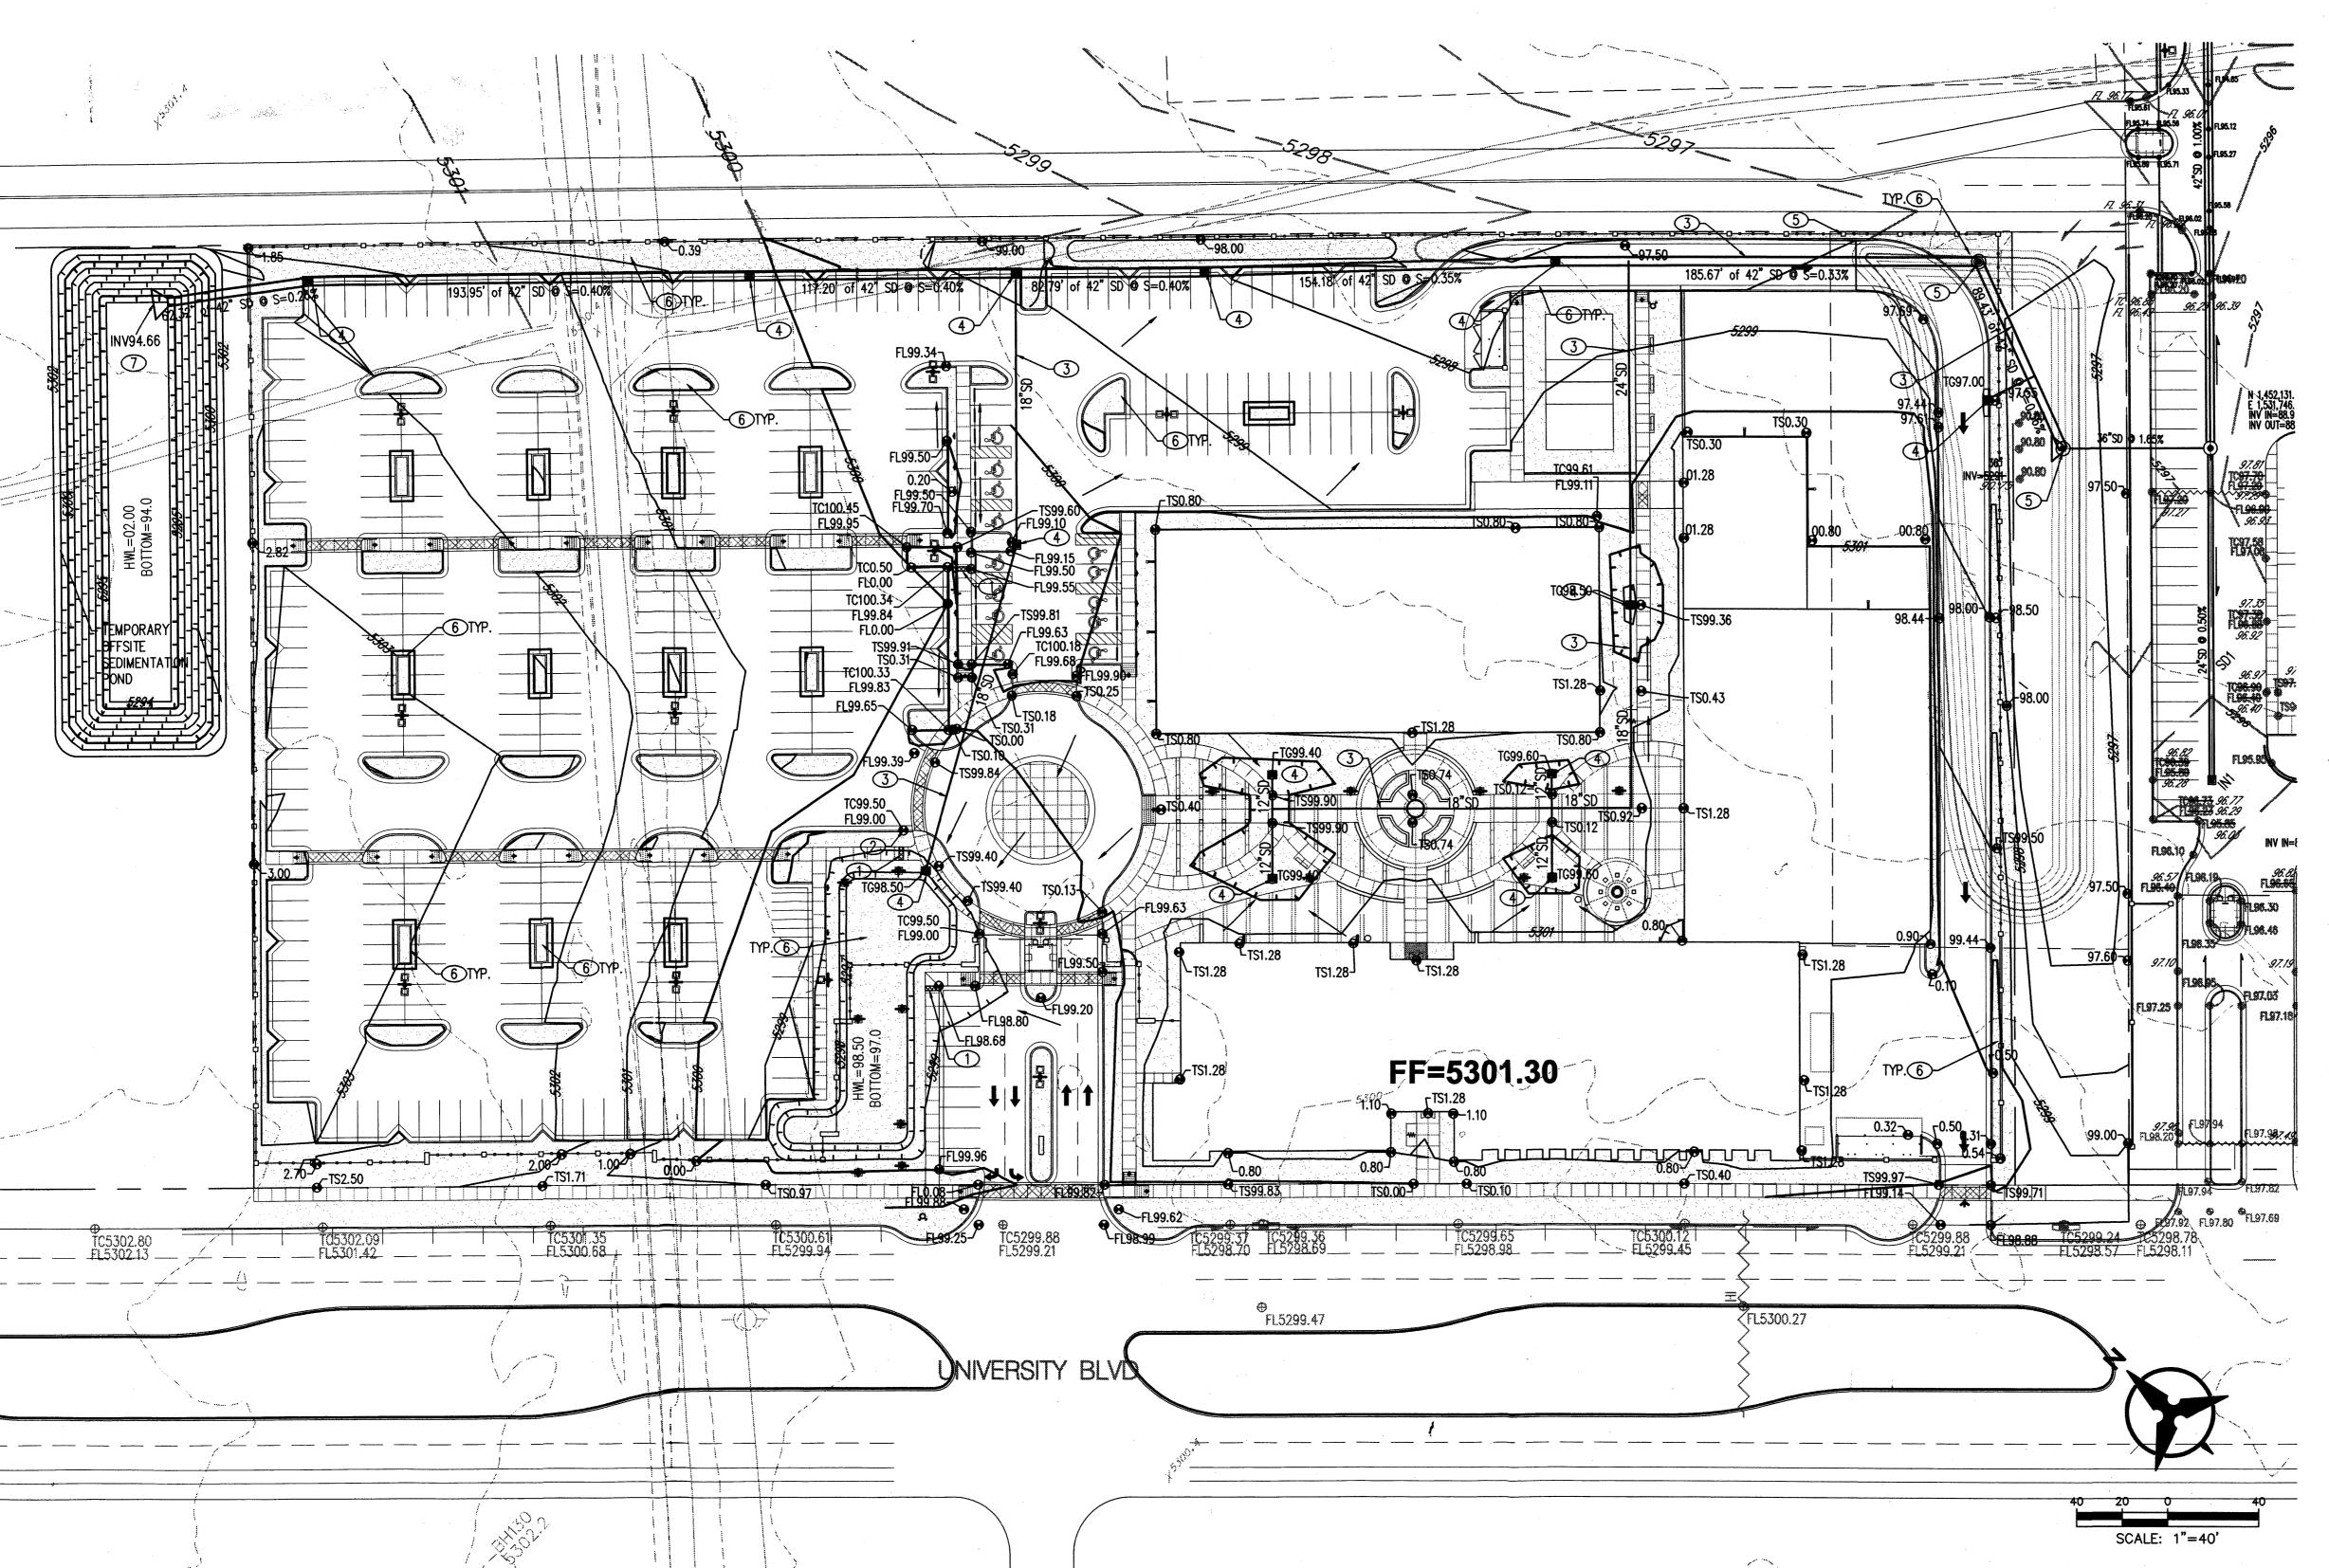

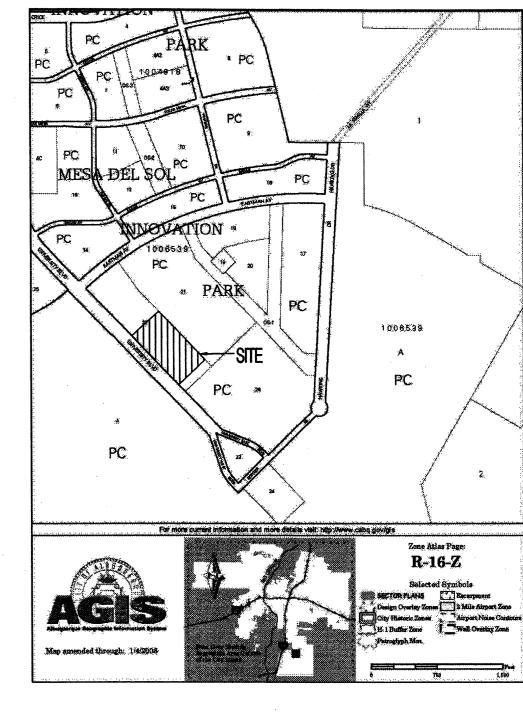

## **GRADING NOTES**

1. EXCEPT AS PROVIDED HEREIN, GRADING SHALL BE PERFORMED AT THE ELEVATIONS AND IN ACCORDANCE WITH THE DETAILS SHOWN ON THIS PLAN.

2. THE COST FOR REQUIRED CONSTRUCTION DUST AND EROSION CONTROL MEASURES SHALL BE

3. ALL WORK RELATIVE TO FOUNDATION CONSTRUCTION, SITE PREPARATION, AND PAVEMENT INSTALLATION, OTHERWISE STATED OR PROVIDED FOR HEREON, BE CONSTRUCTED IN ACCORDANCE WITH THE PROJECT, FOR PUBLIC WORKS (SECOND PRIORITY).

CR PUBLIC RIGHT-OF-WAY. THIS SHOULD BE ACHIEVED BY CONSTRUCTING TEMPORARY BERMS OR SILT

// A DISPUSAL SHE FUR ANY & ALL EXCESS EXCAVATION MATERIAL, AND UNSUITABLE MATERIAL AND/OR A BORROW SITE CONTAINING ACCEPTABLE FILL MATERIAL SHALL BE OBTAINED BY THE CONTRACTOR IN COMPLIANCE WITH APPLICABLE ENVIRONMENTAL REGULATIONS AND APPROVED BY THE OBSERVER. ALL COSTS INCURRED IN OBTAINING A DISPOSAL OR BORROW SITE AND HAUL TO OR FROM SHALL BE CONSIDERED INCIDENTAL TO THE PROJECT AND NO SEPARATE MEASUREMENT OR PAYMENT SHALL BE MADE.

8. PAVING AND ROADWAY GRADES SHALL BE +/- 0.1' From Plan Elevations. Pad Elevation Shall BE +/- 0.05' FROM BUILDING PLAN ELEVATION.

9. ALL PROPOSED CONTOURS REFLECT TOP OF PAVEMENT ELEVATIONS IN THE PARKING AREA AND MUST BE ADJUSTED FOR MEDIANS AND ISLANDS.

10. VERIFY ALL ELEVATIONS SHOWN ON PLAN FROM BASIS OF ELEVATION CONTROL STATION PRIOR TO BEGINNING CONSTRUCTION.

## GRADING KEYED NOTES

- 1. NEW SIDEWALK CULVERT
- 2. CURB OPENING
- 3. NEW STORM DRAIN
- 4. NEW STORM DRAIN INLET w/ GRATE INLET
- 5. NEW STORM DRAIN MANHOLE
- 6. WATER HARVESTING AREA
- 7. INSTALL END SECTION

## **GENERAL NOTES**

1. ALL WORK DETAILED ON THESE PLANS AND PERFORMED UNDER THIS CONTRACT SHALL BE CONSTRUCTED IN ACCORDANCE WITH THE PROJECT SPECIFICATIONS AND THE PROJECT GEOTECHNICAL REPORT. WHERE APPLICABLE, CITY OF ALBUQUERQUE PUBLIC WORKS STANDARDS SHALL APPLY.

2. THE CONTRACTOR SHALL ABIDE BY ALL LOCAL, STATE, AND FEDERAL LAWS, RULES AND REGULATIONS WHICH APPLY TO THE CONSTRUCTION OF THESE IMPROVEMENTS, INCLUDING EPA REQUIREMENTS WITH RESPECT TO STORM WATER DISCHARGE.

3. PRIOR TO CONSTRUCTION, THE CONTRACTOR SHALL FIELD VERIFY THE HORIZONTAL AND VERTICAL LOCATIONS OF ALL POTENTIAL OBSTRUCTIONS INCLUDING ALL UNDERGROUND UTILITIES. SHOULD A CONFLICT EXIST, THE CONTRACTOR SHALL NOTIFY THE CONSTRUCTION OBSERVER OR ENGINEER SO THAT THE CONFLICT CAN BE RESOLVED WITH A MINIMUM AMOUNT OF DELAY.

4. TWO (2) WORKING DAYS PRIOR TO ANY EXCAVATION, THE CONTRACTOR SHALL CONTACT LINE LOCATING SERVICE FOR LOCATION OF EXISTING UTILITIES.

5. ALL ELECTRICAL, TELEPHONE, CABLE TV, GAS AND OTHER UTILITY LINES, CABLES, AND APPURTENANCES ENCOUNTERED DURING CONSTRUCTION THAT REQUIRE RELOCATION, SHALL BE COORDINATED WITH THAT UTILITY. THE CONTRACTOR SHALL BE RESPONSIBLE FOR COORDINATION OF ALL NECESSARY UTILITY ADJUSTMENTS. NO ADDITIONAL COMPENSATION WILL BE ALLOWED FOR DELAYS OR INCONVENIENCES CAUSED BY UTILITY COMPANY WORK CREWS. THE CONTRACTOR MAY BE REQUIRED TO RESCHEDULE HIS ACTIVITIES TO ALLOW UTILITY CREWS TO PERFORM THEIR

The transfer of the contract o

6. THE CONTRACTOR IS RESPONSIBLE FOR PROTECTING ALL EXISTING UTILITY LINES WITHIN THE CONSTRUCTION AREA. ANY DAMAGE TO EXISTING FACILITIES CAUSED BY CONSTRUCTION ACTIVITY SHALL BE REPAIRED OR REPLACED AT THE CONTRACTOR'S EXPENSE AND APPROVED BY THE CONSTRUCTION OBSERVER.

7. CONSTRUCTION ACTIVITY SHALL BE LIMITED TO THE PROPERTY AND/OR PROJECT LIMITS. ANY DAMAGE TO ADJACENT PROPERTIES RESULTING FROM THE CONSTRUCTION PROCESS SHALL BE REPAIRED OR REPLACED AT THE CONTRACTOR'S

8. OVERNIGHT PARKING OF CONSTRUCTION EQUIPMENT SHALL NOT OBSTRUCT DRIVEWAYS OR DESIGNATED TRAFFIC LANES. THE CONTRACTOR SHALL NOT STORE ANY EQUIPMENT OR MATERIAL WITHIN THE PUBLIC RIGHT-OF-WAY.

9. THE CONTRACTOR SHALL OBTAIN ALL THE NECESSARY PERMITS FOR THE PROJECT PRIOR TO COMMENCING CONSTRUCTION (I.E., BARRICADING, TOPSOIL DISTURBANCE, EXCAVATION PERMITS, EPA STORM WATER PERMITS, ETC.).

10. ALL PROPERTY CORNERS DESTROYED DURING CONSTRUCTION SHALL BE REPLACED AT THE CONTRACTOR'S EXPENSE. ALL PROPERTY CORNERS MUST BE reset by a registered land surveyor.

11. THE CONTRACTOR SHALL PREPARE A CONSTRUCTION TRAFFIC CONTROL AND SIGNING PLAN AND OBTAIN APPROVAL OF SUCH PLAN FROM THE CITY OF ALBUQUERQUE, TRAFFIC ENGINEERING DEPARTMENT, PRIOR TO BEGINNING ANY CONSTRUCTION WORK ON OR ADJACENT TO EXISTING STREETS.

12. ALL BARRICADES AND CONSTRUCTION SIGNING SHALL CONFORM TO APPLICABLE SECTIONS OF THE "MANUAL ON UNIFORM TRAFFIC CONTROL DEVICES" (MUTCD), US DEPARTMENT OF TRANSPORTATION, LATEST EDITION.

13. THE CONTRACTOR SHALL MAINTAIN ALL CONSTRUCTION BARRICADES AND SIGNING AT ALL TIMES. THE CONTRACTOR SHALL VERIFY THE PROPER LOCATION OF ALL BARRICADING AT THE END AND BEGINNING OF EACH DAY.

14. THE CONTRACTOR SHALL TAKE ALL STEPS NECESSARY TO CONFORM WITH EPA REQUIREMENTS, INCLUDING COMPLIANCE WITH NPDES PHASE 2 REQUIREMENTS.

## **LEGEND** PROPOSED SPOT ELEVATION TC=TOP OF CURB, FL=FLOW LINE S=2.0% PROPOSED DIRECTION OF FLOW **~~~~** WATER BLOCK PROPOSED INDEX CONTOURS PROPOSED INTER CONTOURS PROPOSED CURB & GUTTER ----- --- EASEMENT PROPOSED STORM DRAIN INLET **EXISTING MONUMENT**

PROPOSED RETAINING WALL

PROPOSED CURB OPENING

 $\chi$  5301.15 Existing ground spot elevation

TW=TOP OF WALL, BW=BOTTOM OF WALL EX=EXISTING, TG=TOP OF GRADE FGH=FINISH GROUND HIGH SIDE FGL=FINISH GROUND LOW

**Bohannan A Huston** 

ENGINEERING A SPATIAL DATA A ADVANCED TECHNOLOGIES

SHEET NO.

P: \080321\cdp\general\ARC Drawings\080321GP01.dwg Tue, 6-May-2008 - 6:38:pm, Plotted by: MBALASKOVITS

architecture

7601 Jefferson NE

505 761-9700 fax 761-4222

**ARCHITECT** 

**ARC** 

**ENGINEER** 

**SUBMITTAL** 

gro. agis o beqb O eqb

Albuquerque, NM 87109

interiors

**REVISIONS** 01.28.08 - ARC Preliminary Review


2 02.14.08 - ARC Secondary Review 3 04.18.08 - LEVEL C COMMENTS

DRAWN BY MJB JLM **REVIEWED BY** 05/06/08 PROJECT NO. 07-0116

**GRADING PLAN** 

DRAWING NAME

Courtyard I 7500 Jefferson St. NE Albuquerque, NM 87109-4335

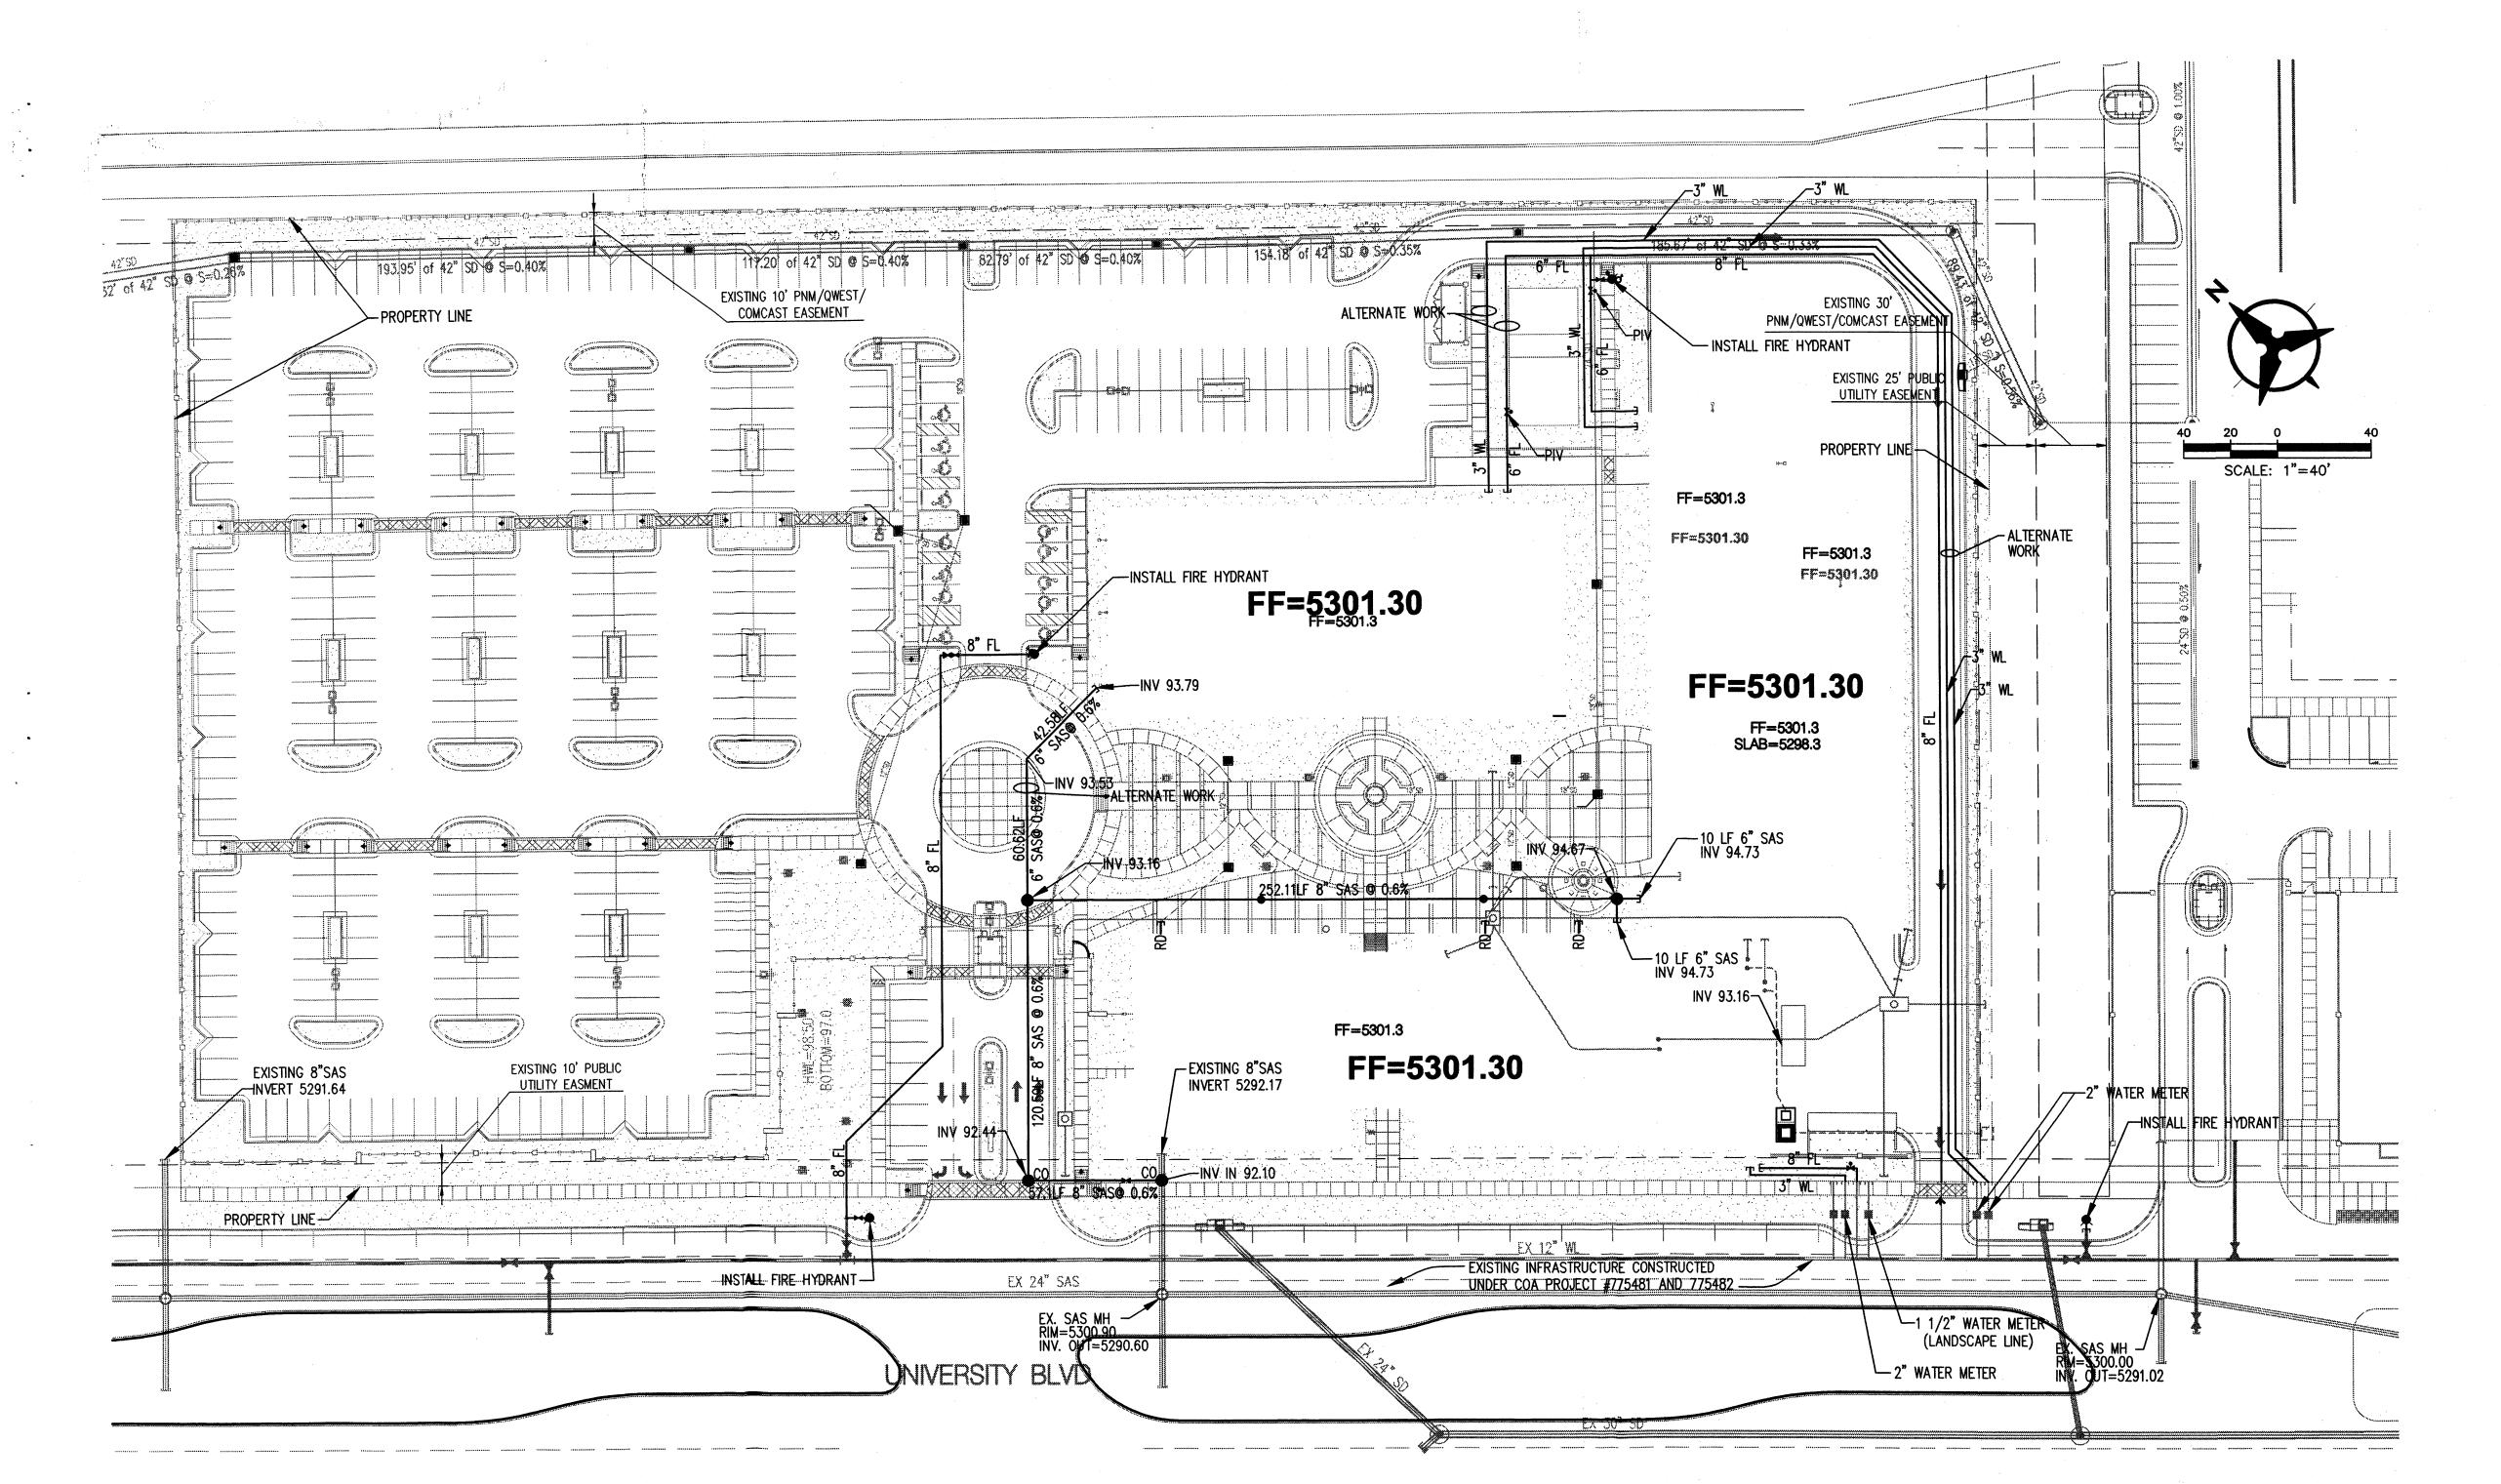

## UTILITY NOTES

1. THIS CONTRACTOR SHALL BE RESPONSIBLE FOR THE COMPLETE INSTALLATION OF ALL WORK RELATED TO MECHANICAL UTILITIES AS SHOWN ON THIS PLAN INCLUDING: TRENCHING, BACKFILL, SUPPORTS, CLEANOUT PADS, SERVICE STOPS AND BOXES, SERVICE LINES, TESTING, CLEANING, AND STERILIZING. ANY WORK NOT ACCEPTED BY THE ARCHITECT OR ENGINEER DUE TO IMPROPER WORKMANSHIP OR LACK OF PROPER COORDINATION SHALL BE REMOVED AND CORRECTLY INSTALLED AT THE CONTRACTOR'S EXPENSE, AS DIRECTED.

2. MINIMUM DEPTHS OF COVER SHALL BE: 36" FOR WATERLINES AND 48" FOR SEWER, EXCEPT AT BUILDING CONNECTION.

3. ALL WORK DETAILED ON THESE PLANS TO BE PERFORMED UNDER CONTRACT SHALL, EXCEPT AS OTHERWISE STATED OR PROVIDED OF HEREON, BE CONSTRUCTED IN ACCORDANCE WITH THE IAPMO UNIFORM PLUMBING CODE, LATEST EDITION.

4. UTILITY LINES SHALL BE INSTALLED PRIOR TO PAVEMENT, CURB AND GUTTER, AND/OR SIDEWALK, AS APPLICABLE.

5. ROUGH GRADING OF SITE  $(\pm 0.5^{\circ})$  SHALL BE COMPLETED PRIOR TO INSTALLATION OF UTILITY LINES.

6. CONTRACTOR WILL BE RESPONSIBLE FOR CONNECTIONS TO BUILDING DRAIN LINES AND ALL NECESSARY FITTINGS.

7. ALL VALVES SHALL BE ANCHORED PER COA STANDARD DWG. 2333.

8. FIRE LINES SHALL USE PIPE MATERIALS UNDERWRITERS LABORATORIES LISTED AND APPROVED FOR FIRE SERVICE.

9. CONTRACTOR SHALL BE RESPONSIBLE FOR ALL WATER METER, FIRE LINE, AND SEWER HOOKUP FEES FOR INSTALLATIONS. OWNER SHALL BE RESPONSIBLE FOR UTILITY EXPANSION CHARGES, PRORATA AND OTHER SPECIAL ASSESSMENTS.

10. CONTRACTOR SHALL VERIFY INVERTS AND LOCATIONS OF EXISTING WATER/SAS LINES PRIOR TO BEGINNING WORK. ALL CONFLICTS SHALL BE BROUGHT TO ATTENTION OF THE ENGINEER AND RESOLVED PRIOR TO BEGINNING WORK.

**LEGEND** 

	PROPERTY LINE
	EXISTING EASEMENT
SAS	EXISTING SANITARY SEWER
*	EXISTING WATER LINE
C	EXISTING WATER METER
r":	EXISTING CAP
<b>&gt;</b> d	EXISTING VALVE
Ø	EXISTING FIRE HYDRANT
	EXISTING SANITARY SEWER MANHOLE
0	EXISTING STORM DRAIN MANHOLE
·	EXISTING INLET
	PROPOSED EASEMENT
SAS	PROPOSED SANITARY SEWER LINE
•	PROPOSED SANITARY SEWER MANHOL
<b>●</b> co	PROPOSED CLEANOUT
WL	PROPOSED WATER LINE
H	PROPOSED VALVE
<u>FL</u>	PROPOSED FIRE LINE
*	PROPOSED HYDRANT
п	PROPOSED CAP
	PROPOSED WATER METER

NOTE: CONTRACTOR SHALL VERIFY DEPTH AND LOCATIONS OF ALL EXISTING UTILITIES AND CONTACT ENGINEER IMMEDIATELY WITH ANY DISCREPANCIES.

# Bohannan 📤 Huston<sub>z</sub>

Courtyard I 7500 Jefferson St. NE Albuquerque, NM 87109-4335
ENGINEERING \* SPATIAL DATA \* ADVANCED TECHNOLOGIES

# Dekker Perich Sahatin

7601 Jefferson NE Suite 100 Albuquerque, NN 87109 505 761-9700 fax 761-4222 dps⊕dpsdesign.org

architecture

planning engineering

ARCHITECT

ARC SUBMITTAL

ENGINEER

PROJECT

ONY IMAGEWORK

Mesa del Sol

Mesa del Sol

REVISIONS

01.28.08 - ARC Preliminary Review

11 01.28.08 - ARC Preliminary Review
2 02.14.08 - ARC Secondary Review
3 04.18.08 - LEVEL C COMMENTS

DRAWN BY

REVIEWED BY

DATE

05/06/08


PROJECT NO.

07-0116

DRAWING NAME

CONCEPTUAL UTILITY PLAN

SHEET NO. **C200** 

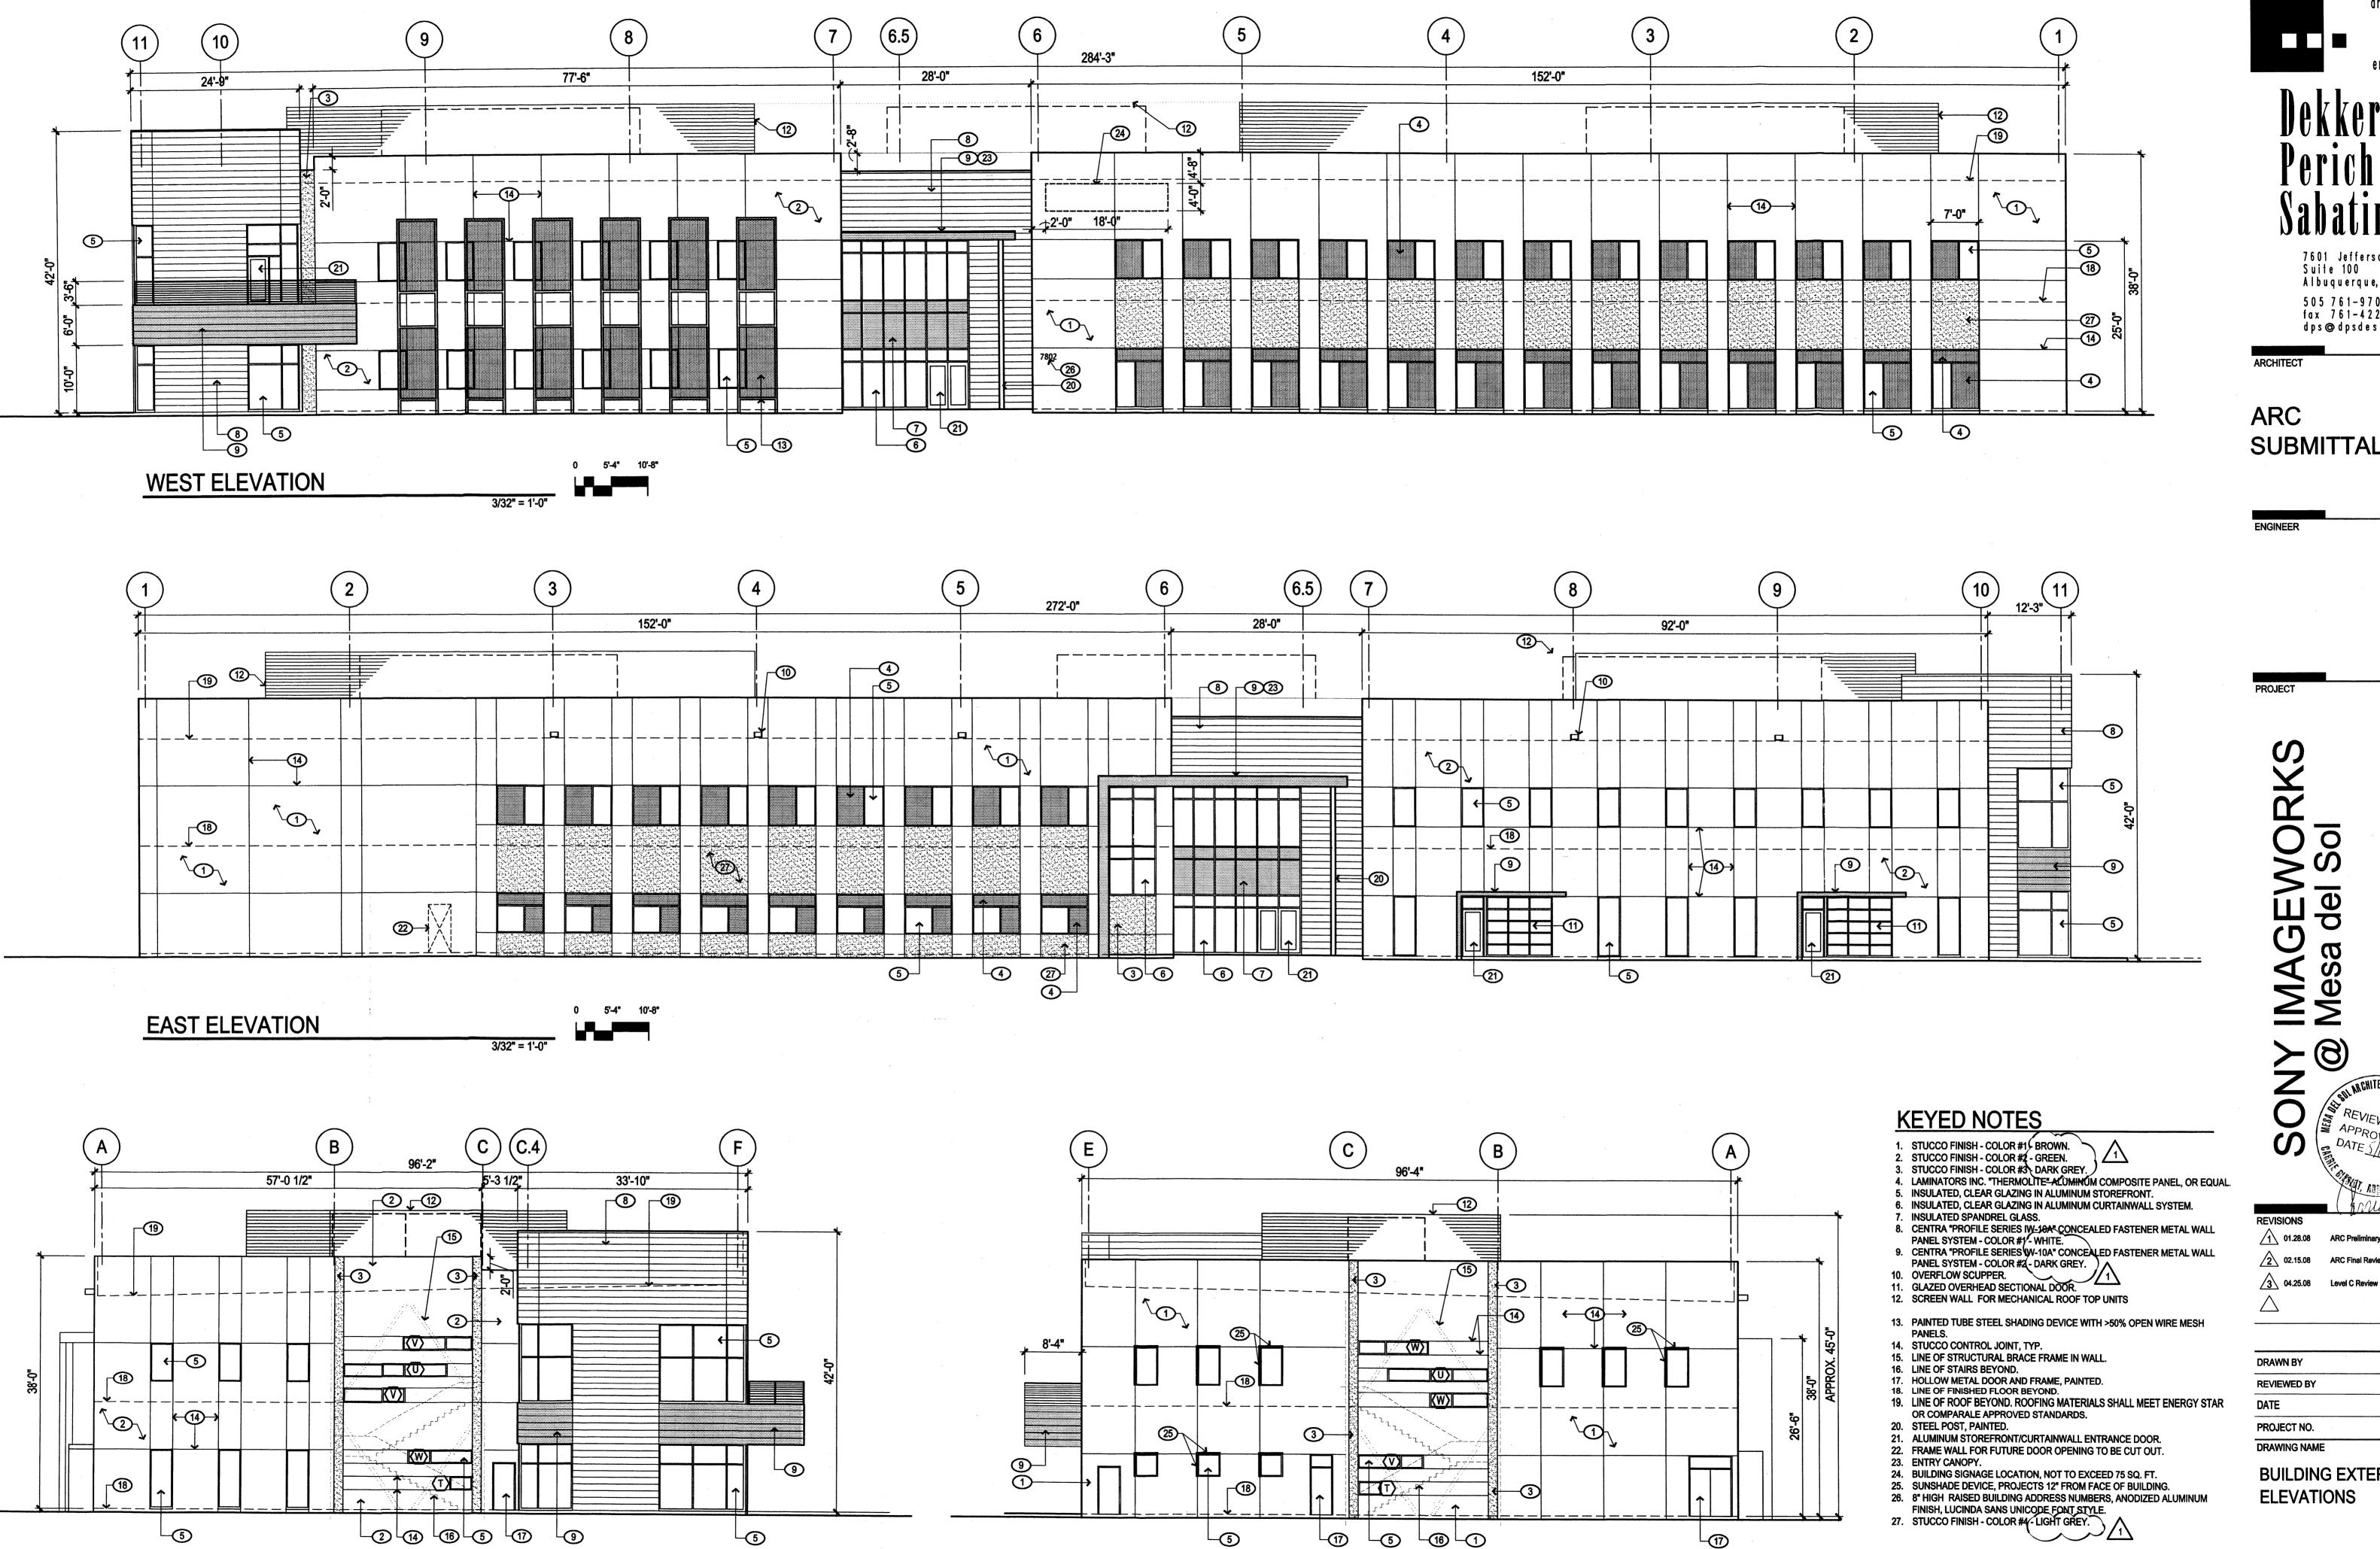

**SOUTH ELEVATION** 

0 5'-4" 10'-8"

3/32" = 1'-0"

5'-4" 10'-8"

3/32" = 1'-0"

**NORTH ELEVATION** 

architecture planning engineering

interiors

7601 Jefferson NE Suite 100 Albuquerque, NM 87109 505761-9700 fax761-4222 dps ⊚ dpsdesign.org

**SUBMITTAL** 

1 01.28.08 ARC Preliminary Review 2 02.15.08 ARC Final Review

Z

Albuquerque,

CG 02/15/08 07-0116

**BUILDING EXTERIOR** 

## **GENERAL NOTES**

- A. ALL ROOF TO SLOPE TO DRAIN AT 1/4" PER FOOT MINIMUM
  B. ALL DIMENSIONS ARE TO F.O. STUD UNLESS NOTED OTHERWISE.
  C. PROVIDE ROOF WALKWAY PADS FROM ROOF HATCH TO ALL
- SERVICABLE AREAS OF MECHANICAL EQUIPMENT.

  D. REFER TO DETAILS A1 & A2/A291 FOR TYPICAL ROOF PIPE PENETRATIONS.
- E. SCREEN WALL DIMENSIONS ARE TO CENTER OF STEEL.

## **KEYED NOTES**

- ROOF DRAIN RE: A3/A291 AND PLUMBING DRAWINGS.
   ROOF CRICKET, SLOPE TO DRAIN AT 1/4" PER FOOT MIN.
   36" X 30" ROOF HATCH, RE: A5/A291.
   OVERFLOW SCUPPER, RE: B4/A291.
   45 MIL. TPO ROOFING MEMBRANE ON RECOVERY BOARD ON R-30 RIGID INSULATION, SLOPE TO DRAIN AT 1/4" PER FOOT MIN.
- 6. MECHANICAL ROOFTOP UNIT, RE: MECHANICAL. 7. MECHANICAL EQUIPMENT, RE: MECHANICAL.
- 8. DUCTWORK DOWN TO BELOW, RE: MECHANICAL. PROVIDE "PENTHOUSE" ENCLOSURE AROUND OPENING.

  9. EXHAUST FAN, RE: MECHANICAL.

- 10. CANOPY BELOW.
  11. MECHANICAL SCREEN WALL, RE: DETAIL D4/A291.
  12. OVERFLOW DRAIN TO BE PIPED AT THIS LOCATION.

ARC SUBMITTAL

ARCHITECT

architecture

interiors

planning

engineering

7601 Jefferson NE Suite 100

5 0 5 7 6 1 - 9 7 0 0 fax 7 6 1 - 4 2 2 2


dps ⊚ dpsdesign.org

Albuquerque, NM 87109

DRAWN BY REVIEWED BY 02/15/08 07-0116 PROJECT NO.


**ROOF PLAN** 

DRAWING NAME

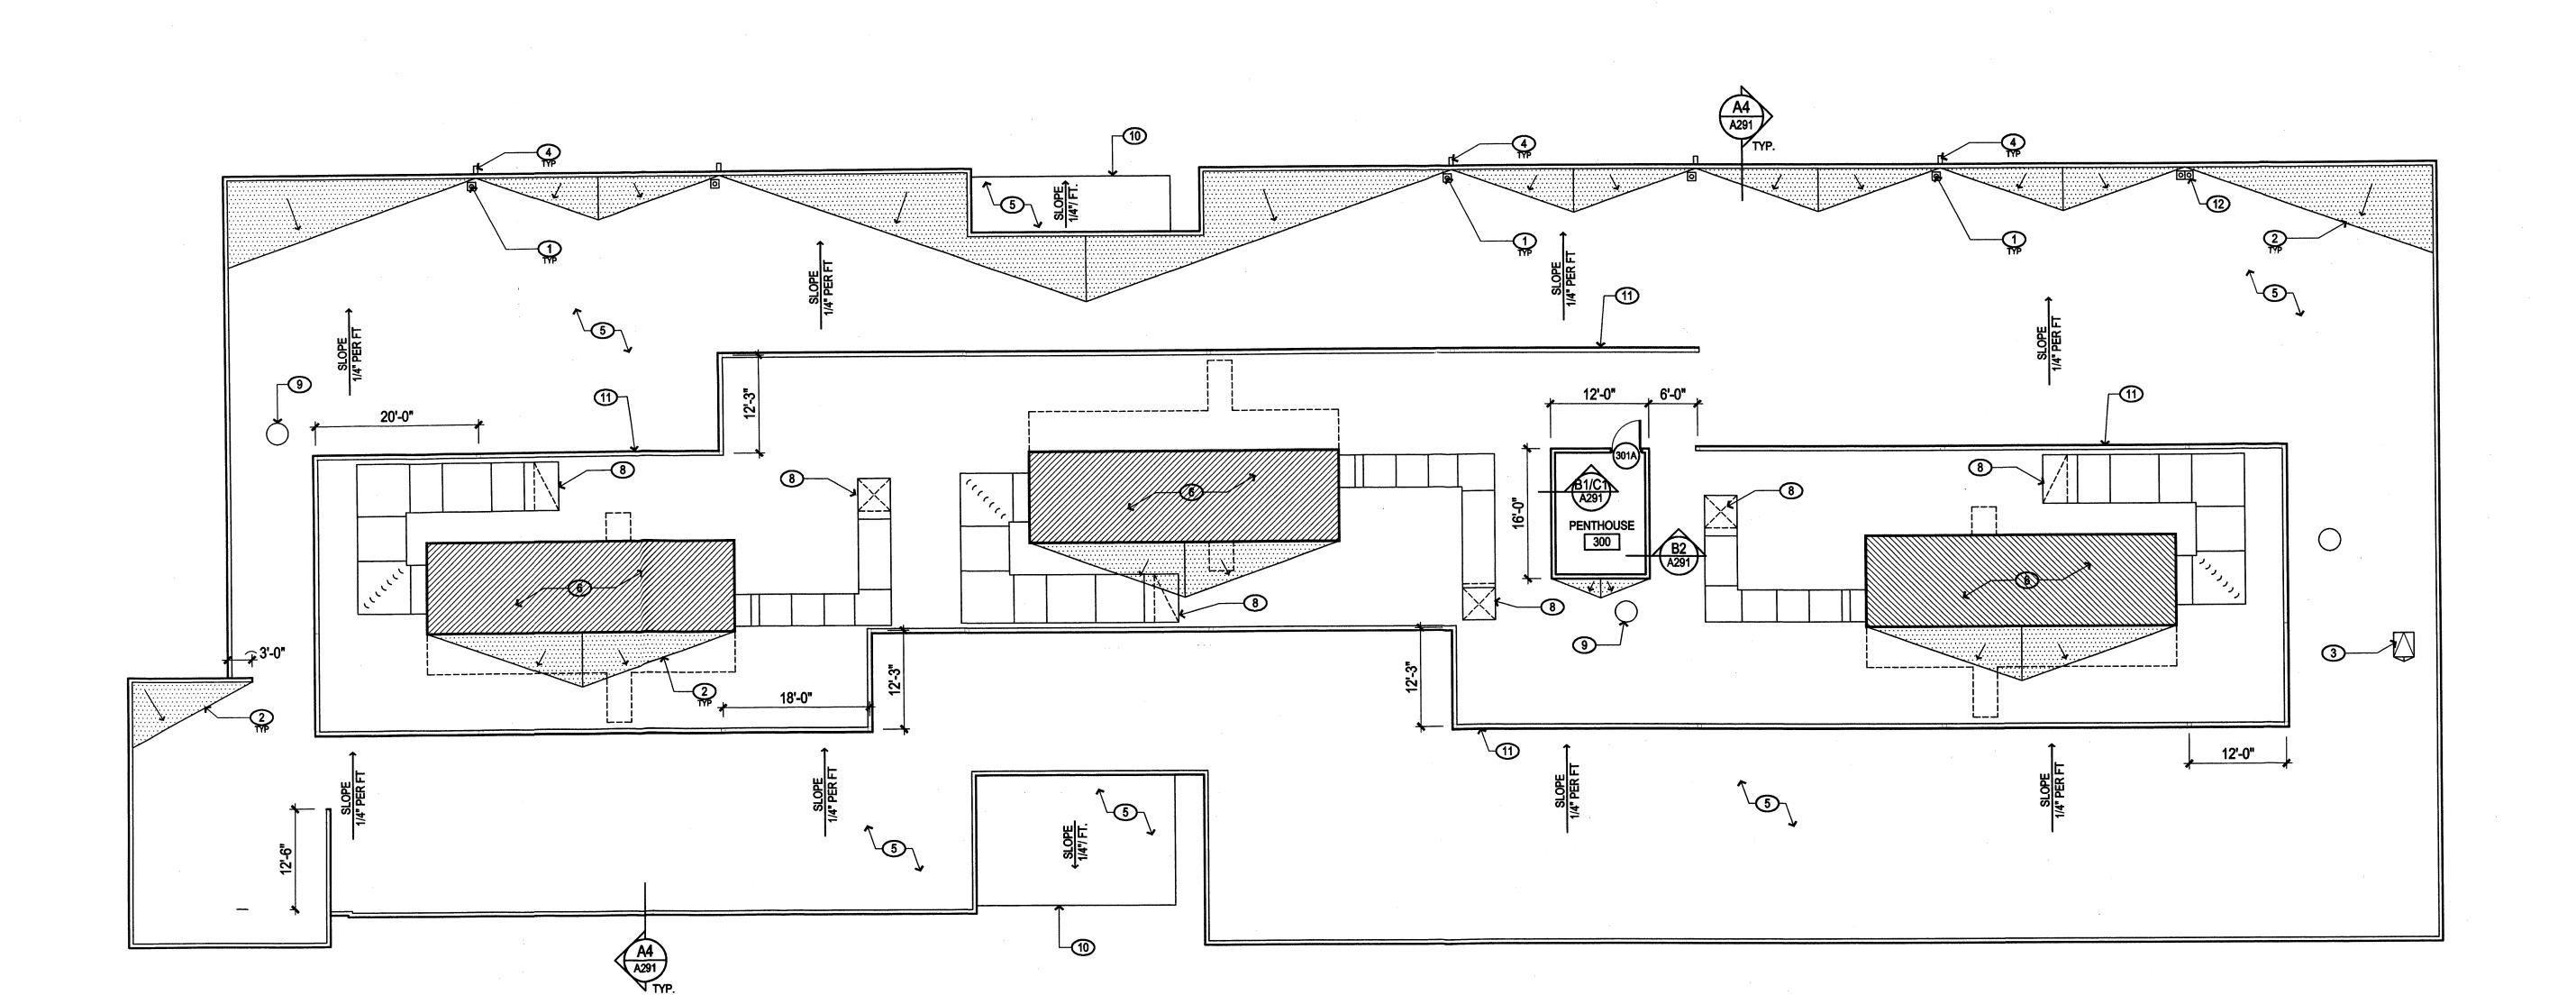



3/32" = 1'-0"

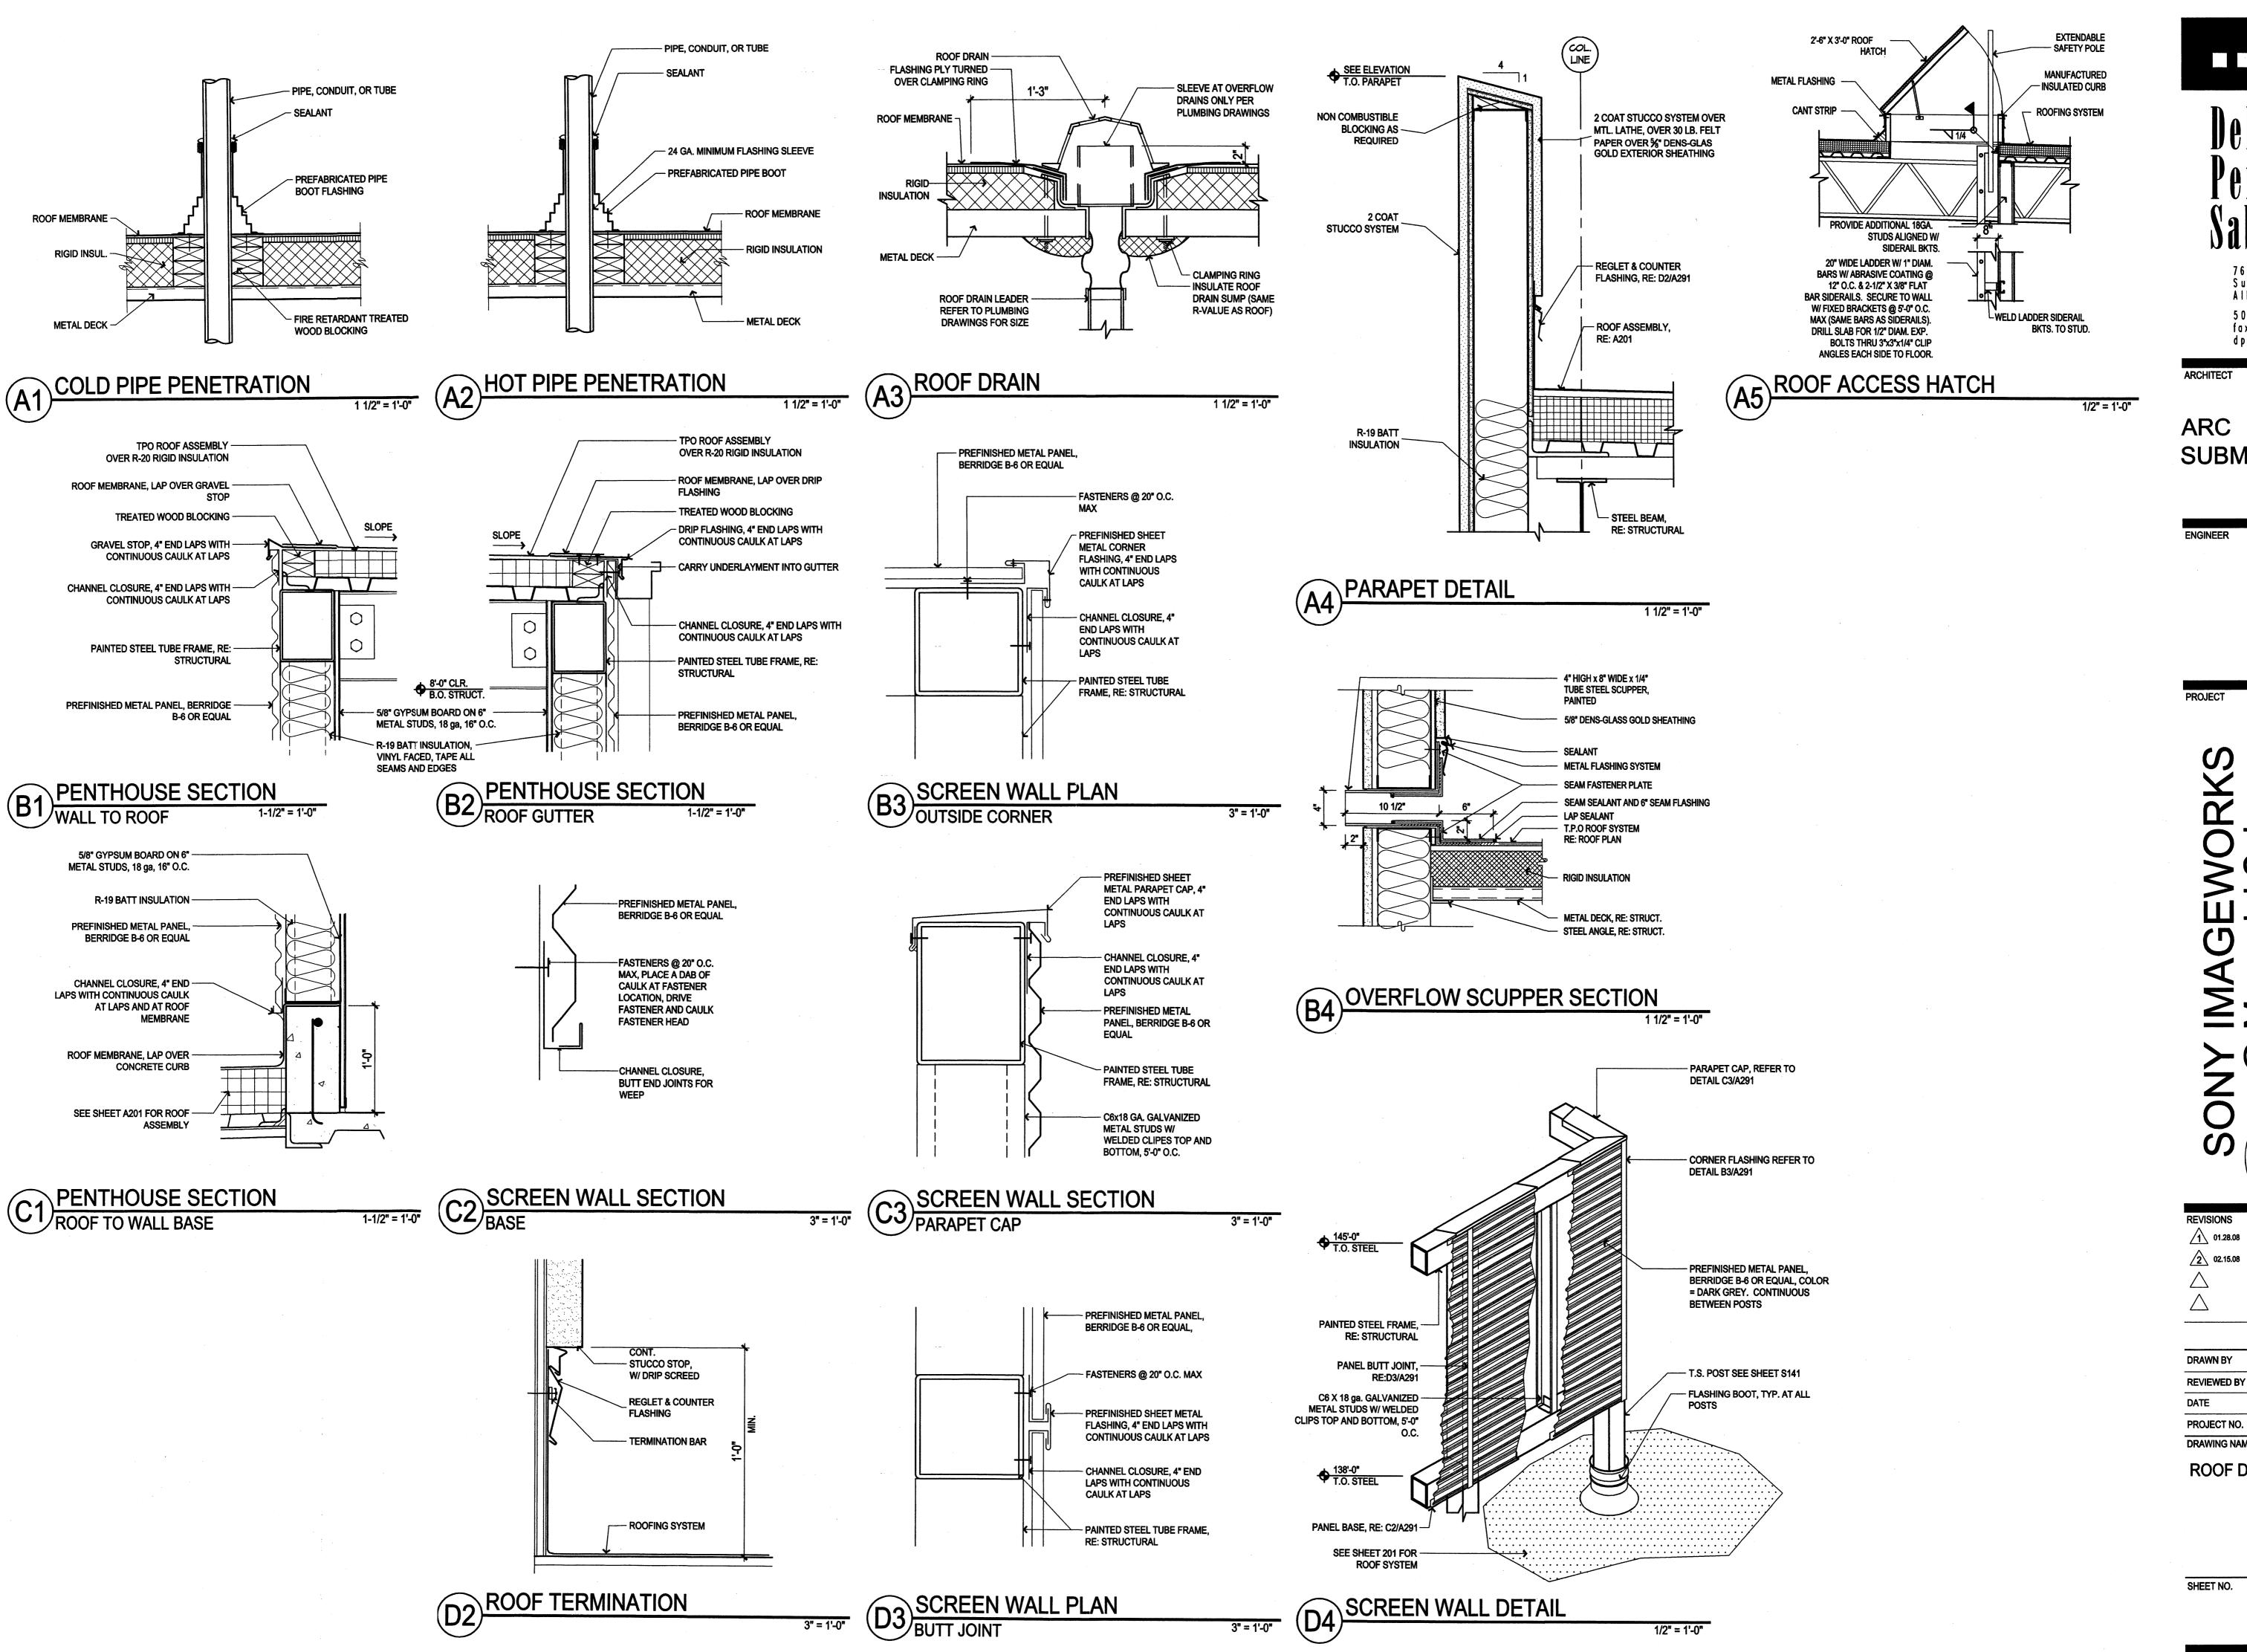

architecture interiors planning engineering

7601 Jefferson NE Suite 100 Albuquerque, NM 87109 505 761-9700 fax 761-4222 dps@dpsdesign.org

ARCHITECT

ARC **SUBMITTAL** 

Albuquerque

| REVIEWED D APPROVED 🗗 DATE 5/15/08


DRAWN BY **REVIEWED BY** CG 02/15/08

DRAWING NAME

**ROOF DETAILS** 

SHEET NO.

07-0116

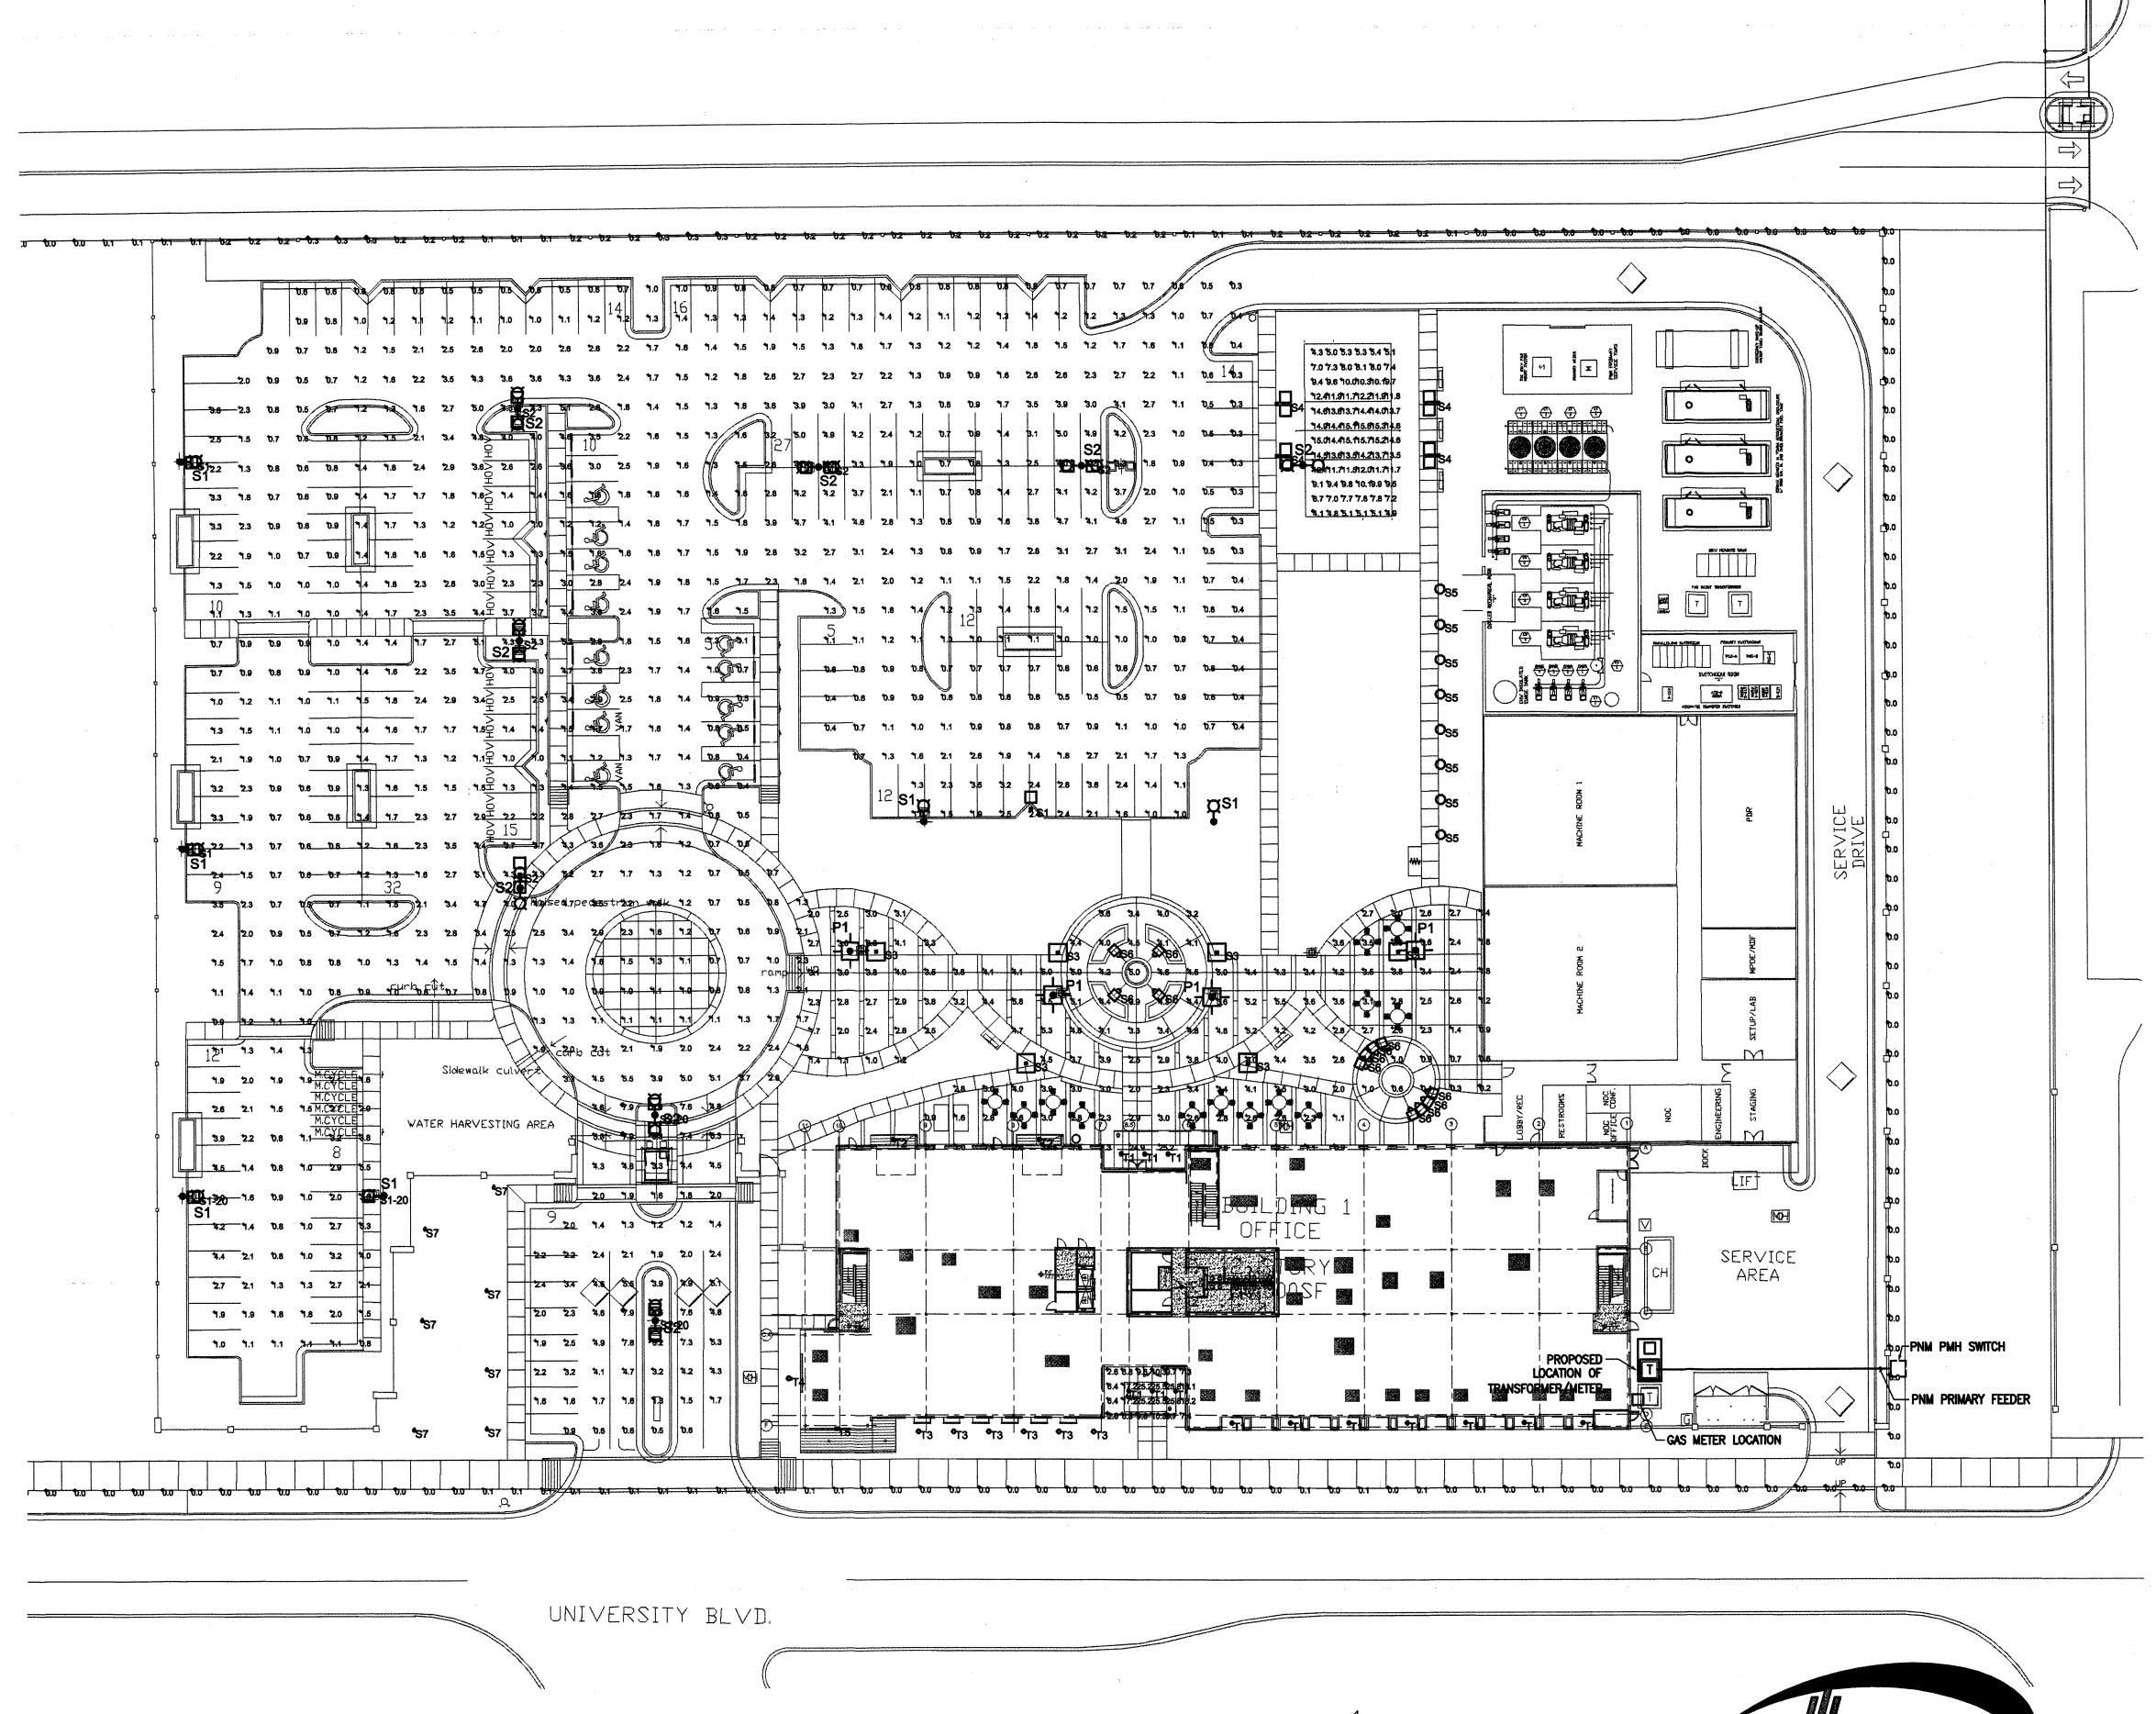

1. ALL SITE FIXTURES WITHIN 200' OF UNIVERSITY BLVD MOUNTED AT 20' AFG.

ONE 250-WATT CLEAR BT-28 METAL HALIDE, HORIZONTAL POSITION.

ONE 250-WATT CLEAR 8T-28 METAL HALIDE, HORIZONTAL POSITION.

ONE 250-WATT CLEAR BT-28 METAL HALIDE, HORIZONTAL POSITION.

ONE 250-WATT CLEAR BT-28 METAL HALIDE, HORIZONTAL POSITION.

ONE 250-WATT CLEAR BT-28 METAL HALIDE, VERTICAL BASE-UP POS.

ONE 70-WATT CLEAR PAR30LN CERAMIC METAL HALIDE, VERTICAL BASE UP POS.

ONE 35-WATT CLEAR PAR20 METAL HALIDE, VERTICAL BASE UP POS.

4.1 fc

2800 0.72

ELECTRICAL SITE LIGHTING

ALL OTHER SITE FIXTURES MOUNTED AT 25' AFG.

WINONA #PI 74 UB LO SIS FO SHO C2 B1 0 STD

HYDREL #PDX7 SS 70CMT6 120 NSP FLCAS 34S LPI

HYDREL #PDX7CL BSS 35CMT6 120 WWD FLCAS 34S LPI

STATISTICS

LITHONIA #APRH APRH 4" APERTURE P3070MHC 4AR PAR30 DOWNLIGHT 120 LPSP 70MHC SPOT

LITHONIA #APRH APRH 4" APRRTURE
P2035MHC 4AR PAR20 DOWNLIGHT 35M
120 LPFL FLOOD

SURFACE WALL
MOUNTED LUMINAIRE
W/DUAL LIGHT
DISTRIBUTION ONE
WIDE SPREAD,ONE
COLLIMATED SPIKE

15.8 fc

LUMINAIRE SCHEDULE

architecture interiors planning engineering

Dekker Perich Sabatini

> 7601 Jefferson NE Suite 100 Albuquerque, NM 87109 505761-9700 fax 761-4222 dps@dpsdesign.org

ARCHI

BUILDING
PERMIT
SUBMITTAL

ENGINEER

0808

PROJECT

MAGEWORKS - SHELL

@ Mesa del Sol

REVIEWED DATE S/15/08

VISIONS

1 02-04-08 Response To Mesa Del Sol Comments 01-28-08

2 4.18.06 Level C Comments

DRAWN BY TRG
REVIEWED BY DDR
DATE 04/15/08
PROJECT NO. 07-0116
DRAWING NAME

ELECTRICAL SITE LIGHTING

SHEET NO.

THE RESPONSE GROUP, INC.

An Electrical/Mechanical Engineering Corporation
11930 Manaul N.E. Suita 214
Albuquerque, New Mexico 87112
Phone: (505) 323-7629 Fax: (505) 323-7594
E-mail: TheResponseGroup@TRG-inc.net

E002

March 31, 2010



Mr. Richard Dourte, PE City Engineer / Division Manager City of Albuquerque, Development Review Services 600 Second Street, NW Albuquerque, New Mexico 87103

Re: Request to Void/Withdraw Building Permit #200890246

5640 University Blvd SE, 87106 Sony Imageworks @ Mesa del Sol Albuquerque, New Mexico

#### Dear Richard:

We are writing on behalf of our client Mesa del Sol to ask that the City void/withdraw the building permit referenced above. Please also destroy the two sets of building permit drawings.

Thank you for your attention to this matter.

Sincerely,

Dekker/Perich/Sabatini

Christopher R. Gunning, AIA. LEED AP

mmzymy

Principal

Cc: Chris Anderson, Mesa del Sol

John Myers, Myers Oliver Price

#### MYERS, OLIVER & PRICE, P.C.

LAWYERS
1401 CENTRAL AVENUE, N.W.
ALBUQUERQUE, NEW MEXICO 87104
www.moplaw.com

JOHN A. MYERS SCOTT OLIVER KEVIN J. McCREADY HOPE MEAD WYNN TELEPHONE (505)247-9080 FACSIMILE (505)247-9109

CHARLES P. PRICE III, Of Counsel FLOYID D. WILSON, Of Counsel

J. MATT MYERS

e-mail: jmyers@moplaw.com

February 25, 2010

#### HAND DELIVERED

Debbie Stover, Planning Director Planning Department City of Albuquerque Plaza del Sol, Third Floor Albuquerque, New Mexico 87103

Re: Mesa del Sol/Project No. 775488

#### Dear Debbie:

This office represents Mesa del Sol, LLC ("Mesa"). In early 2008, Mesa was working with Sony Imageworks ("Sony") regarding locating at Mesa del Sol. To facilitate the Sony transaction, Mesa processed a plat for the Sony parcel and a site development plan for the Sony building. A copy of the plat (Plat of Tracts 22-A, 22-B and 22-C, Mesa del Sol Innovation Park) and the site plan ("Sony Imageworks @ Mesa del Sol") are enclosed.

As a condition of the plat and site plan approvals, Mesa entered into a Subdivision Improvement Agreement (the "SIA"), a copy of which is enclosed. The infrastructure the subject of the SIA is the south one-half of Eastman Avenue from University Blvd. to the Albuquerque Studios' north access easement. This road is highlighted on the Plat vicinity map.

The Sony transaction fell through at the 11<sup>th</sup> hour. Therefore, Mesa no longer needs the approved Sony site plan. Consequently, Mesa desires to be relieved of the SIA obligation to construct this portion of Eastman Avenue. Therefore, Mesa requests that the City void the Sony site plan and release the SIA and the associated financial guarantee.

In these difficult economic times it creates a hardship for Mesa to construct (or to continue to bear the cost of a financial guarantee) for infrastructure which is not yet

PHONE: 505/452-2000



March 9, 2010

Mr. Richard Dourte
City Engineer
City of Albuquerque
Plaza del Sol Building, 2<sup>nd</sup> Floor
Albuquerque, New Mexico 87102

Re:

Mesa del Sol – Sony Site

City Project No. 775488

57. University West Blyd. Sb. Smit. 410, Albuquerque, NM 87106

Dear Mr. Dourte:

Mesa del Sol, LLC, hereby authorizes Myers, Oliver & Price, P.C. (John A. Myers) to do all things required by the City, including, but not limited to, execution of any documentation necessary to void the Site Plan (Sony Imageworks @ Mesa del Sol) approved May 15, 2008, the Subdivision Improvement Agreement and financial guaranty related to the Site Plan and filed in City Project No. 775488, and any work orders that may have been issued.

Very truly yours,

MESA DEL SOL. LLC

V:

Michael D. Dalv

Debble Stover, Planning Director Planning Department February 25, 2010 Page -2-

The City can condition future plat or site plan approvals upon the construction of this reach of Eastman Avenue.

Please advise us if you need additional information.

Thank you for your consideration of this request.

Very truly yours,

MYERS, OLIVER & PRICE, P.C.

JAM/kla **Enclosures** 

CC:

Kevin Curran, Assistant City Attorney (w/enc.) (Hand Delivered)

Mr. Richard Dourte, City Engineer (w/enc.) (Hand Delivered)

Mr. Manny Barrera, Mesa del Soi (w/out enclosures) (email)

H:\forestcity\Leases\Sony\letters\Stover ltr.docx