


LEGEND

FLOW ARROW

..____ FLOW LINE

- RIDGE LINE

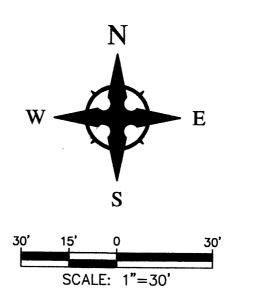

CAUTION - NOTICE TO CONTRACTOR

THE CONTRACTOR IS SPECIFICALLY CAUTIONED THAT THE LOCATION AND/OR ELEVATION OF EXISTING UTILITIES AS SHOWN ON THESE PLANS IS BASED ON RECORDS OF THE VARIOUS UTILITY COMPANIES AND, WHERE POSSIBLE, MEASUREMENTS TAKEN IN THE FIELD. THE INFORMATION IS NOT TO BE RELIED ON AS BEING EXACT OR COMPLETE. THE CONTRACTOR MUST CALL THE APPROPRIATE UTILITY COMPANY AT LEAST 48 HOURS BEFORE ANY EXCAVATION TO REQUEST EXACT FIELD LOCATION OF UTILITIES. IT SHALL BE THE RESPONSIBILITY OF THE CONTRACTOR TO RELOCATE ALL EXISTING UTILITIES WHICH CONFLICT WITH THE PROPOSED IMPROVEMENTS SHOWN ON THE PLANS.

DRAINAGE MANAGEMENT PLAN

INTRODUCTION

The purpose of this submittal is to provide a conceptual drainage management plan for the proposed additions to the McLeod YMCA, which includes the demolition of existing buildings and paved surfaces; and the installation of new buildings and parking areas. The site is located at the 12500 Comanche NE in Albuquerque, NM, which is the southwest corner Comanche and Moutainside Parkway. The site contains approximately 3.0 acres.

EXISTING HYDROLOGIC CONDITIONS

According to the latest approved Drainage Management Plan by Tierra West (COA Hydrology File G22Z-D16), dated September 8, 1997, the runoff from the site is as

Basin 'R' (Total of Basins 'A' and 'B'): 15.05 cfs using 90% Type 'D' and 10% Type 'B' land treatments.

When the improvements were done in +/-1997, most of the drainage from the site was diverted away from Comanche to a drainage swale/inlet located at the southwest corner of the property.

PROPOSED HYDROLOGIC CONDITIONS

The calculations for the developed site (see Table below) show the 100-year runoff rate to be 15.04 cfs, which is 0.01 cfs lower than the calculations prepared by Tierra West in 1997. Seeing that there is a slight decrease in runoff for the proposed condition, there will not be any negative impacts downstream of the site.

The below calculations are for the new asphalt Triangular Channel outlet located at the southwest corner of the site. The section used is the smallest/most critical section of the

Given Data:

Q (actual) = 15.04 cfsLeft Side Slope: +/-. 5:1 (5' long) Right Side Slope: +/- 4.7:1 (4.7' long) Depth: +/- 1' Manning's 'n' coefficient: 0.017


Wetted Perimeter: 9.9' R: 0.49 Channel Slope: +/- 1.88%

Channel Area: 4.85 Square Feet

Using Manning's Equation and the above data, the capacity of the Channel is 36.10 cfs which is well over the required flow rate of 15.04 cfs.

CONCLUSION

This drainage management plan provides for grading and drainage elements which are capable of safely passing the 100 year storm and which meets city requirements. According to the previous approved Drainage Management Plan by Tierra West dated September 8, 1997, the site is allowed to discharge developed flows directly to the southwest corner of the site, without causing a negative impact. With this submittal, we are requesting conceptual grading and drainage plan approval for Site Plan for Building

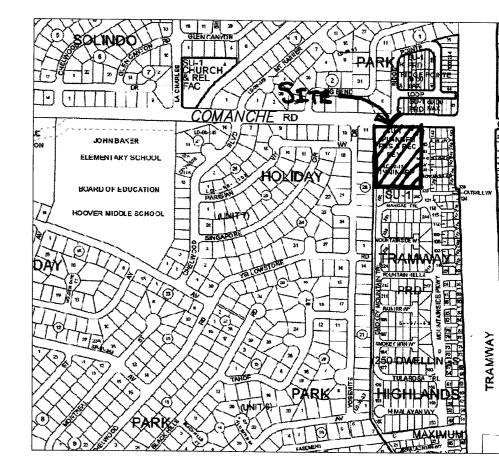

MEASURES SHALL BE INCIDENTAL TO THE PROJECT COST.

GRADING NOTES

1. EXCEPT AS PROVIDED HEREIN, GRADING SHALL BE PERFORMED AT THE ELEVATIONS AND IN ACCORDANCE WITH THE DETAILS SHOWN ON THIS PLAN. 2. THE COST FOR REQUIRED CONSTRUCTION DUST AND EROSION CONTROL

ALL WORK RELATIVE TO FOUNDATION CONSTRUCTION, SITE PREPARATION, AND PAVEMENT INSTALLATION, AS SHOWN ON THIS PLAN, SHALL BE CONSTRUCTED IN ACCORDANCE WITH THE "GEOTECHNICAL INVESTIGATION," AS PROVIDED BY THE ARCHITECT OR OWNER. ALL OTHER WORK SHALL, UNLESS OTHERWISE STATED OR PROVIDED FOR HEREON, BE CONSTRUCTED IN ACCORDANCE WITH THE PROJECT, (FIRST PRIORITY) SPECIFICATIONS, AND/OR THE CITY OF ALBUQUERQUE (COA) STANDARD SPECIFICATIONS FOR PUBLIC WORKS (SECOND PRIORITY).

4. EARTH SLOPES SHALL NOT EXCEED 3 HORIZONTAL TO 1 VERTICAL UNLESS SHOWN OTHERWISE.

5. IT IS THE INTENT OF THESE PLANS THAT THIS CONTRACTOR SHALL NOT PERFORM ANY WORK OUTSIDE OF THE PROPERTY BOUNDARIES EXCEPT AS


6. THE CONTRACTOR IS TO ENSURE THAT NO SOIL ERODES FROM THE SITE ONTO ADJACENT PROPERTY OR PUBLIC RIGHT-OF-WAY. THIS SHOULD BE ACHIEVED BY CONSTRUCTING TEMPORARY BERMS OR SILT FENCE AT THE PROPERTY LINES AND WETTING THE SOIL TO PROTECT IT FROM WIND

7. A DISPOSAL SITE FOR ANY & ALL EXCESS EXCAVATION MATERIAL, AND UNSUITABLE MATERIAL AND/OR A BORROW SITE CONTAINING ACCEPTABLE FILL MATERIAL SHALL BE OBTAINED BY THE CONTRACTOR IN COMPLIANCE WITH APPLICABLE ENVIRONMENTAL REGULATIONS AND APPROVED BY THE OBSERVER. ALL COSTS INCURRED IN OBTAINING A DISPOSAL OR BORROW SITE AND HAUL TO OR FROM SHALL BE CONSIDERED INCIDENTAL TO THE PROJECT AND NO SEPARATE MEASUREMENT OR PAYMENT SHALL BE MADE.

8. PAVING AND ROADWAY GRADES SHALL BE +/- 0.05' FROM PLAN ELEVATIONS. PAD ELEVATION SHALL BE +/- 0.05' FROM BUILDING PLAN

9. ALL PROPOSED CONTOURS REFLECT TOP OF PAVEMENT ELEVATIONS IN THE PARKING AREA AND MUST BE ADJUSTED FOR MEDIANS AND ISLANDS 10. VERIFY ALL ELEVATIONS SHOWN ON PLAN FROM BASIS OF ELEVATION CONTROL STATION PRIOR TO BEGINNING CONSTRUCTION.

11. THE CONTRACTOR SHALL PROVIDE THE SWPPP DOCUMENT (IF NECESSARY) AND SHALL ABIDE BY ALL LOCAL, STATE, AND FEDERAL LAWS, RULES AND REGULATIONS WHICH APPLY TO THE CONSTRUCTION OF THESE IMPROVEMENTS, INCLUDING EPA REQUIREMENTS WITH RESPECT TO STORM WATER DISCHARGE.

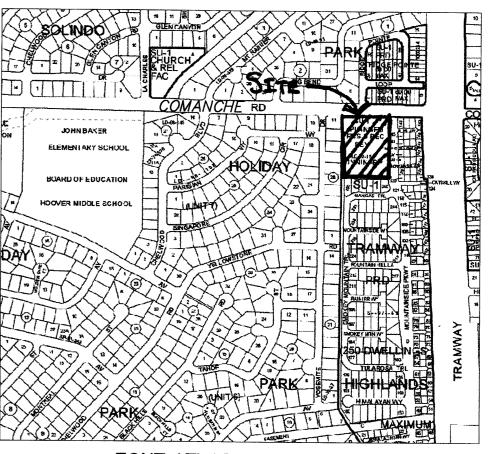

ZONE ATLAS PAGE G22

architecture

interiors

landscape

planning

engineering

7601 Jefferson NE Suite 100

Albuquerque, NM 87109

505 761-9700


fax 761-4222

ARCHITECT

ENGINEER

dps @ dpsdesign.org

	Evicting M	Icl and VM	ICA Drain	oro Col		n = /Da	T:	14/ 4 0				1
	LAISUIIG H	ICLEOU IN	CA DI alli	aye Car	Cuiauo	ns (Per	ilerra	west Ca	aicuiatio	ns Dated 9/	8/97	
	This	table is based o	on the COA DP	M Section 2	22.2, Zone:	: 4						
BASIN	Area	Area	Land Treatment Percentages				Q(100)	Q(100)	WTE	V(100) ₃₆₀	V(100) ₁₄₄₀	V(100) ₁₀
	(SQ. FT)	(AC.)	Α	В	С	D	(cfs/ac.)	(CFS)	(inches)	(CF)	(CF)	(CF)
Basin 'R'		3.00	0.0%	10.0%	0.0%	90.0%	5.02	15.05	n/a	n/a	n/a	n/a
			77000				alita paga ana ana ana ana ana ana ana ana ana				der der er e	
	and the state of t								And the second s			
		Proposed McLeod YMCA Drainage								*		
				Developme								<u> </u>
	This	table is based o										
BASIN	Area	Area		Land Treatment Percentages				Q(100)	WTE	V(100) ₃₆₀	V(100)	\((100)
	(SQ. FT)	(AC.)	A	В	С	l D	Q(100) (cfs/ac.)	(CFS)	(inches)		V(100) ₁₄₄₀	
Basin 'R'	130626	3.00	0.0%	10.0%	0.0%	90.0%	5.02	15.04	2.48	(CF) 27040	(CF) 35269	(CF) 44456

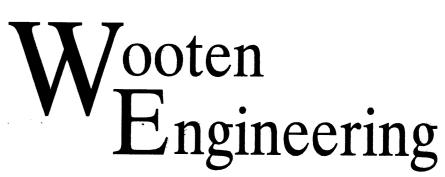

5017 Sanbusco Dr NE, Rio Rancho, NM 87144 Ph: 505.771.4200 Fax: 505.771.8905

DRAWN BY **REVIEWED BY** PROJECT NO.

DRAWING NAME

1. RELOCATE TRASH ENCLOSURE

GRADING & DRAINAGE PLAN

SHEET NO.





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09/06/07

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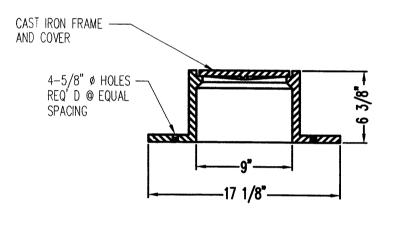


CAUTION - NOTICE TO CONTRACTOR


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UTILITY NOTES

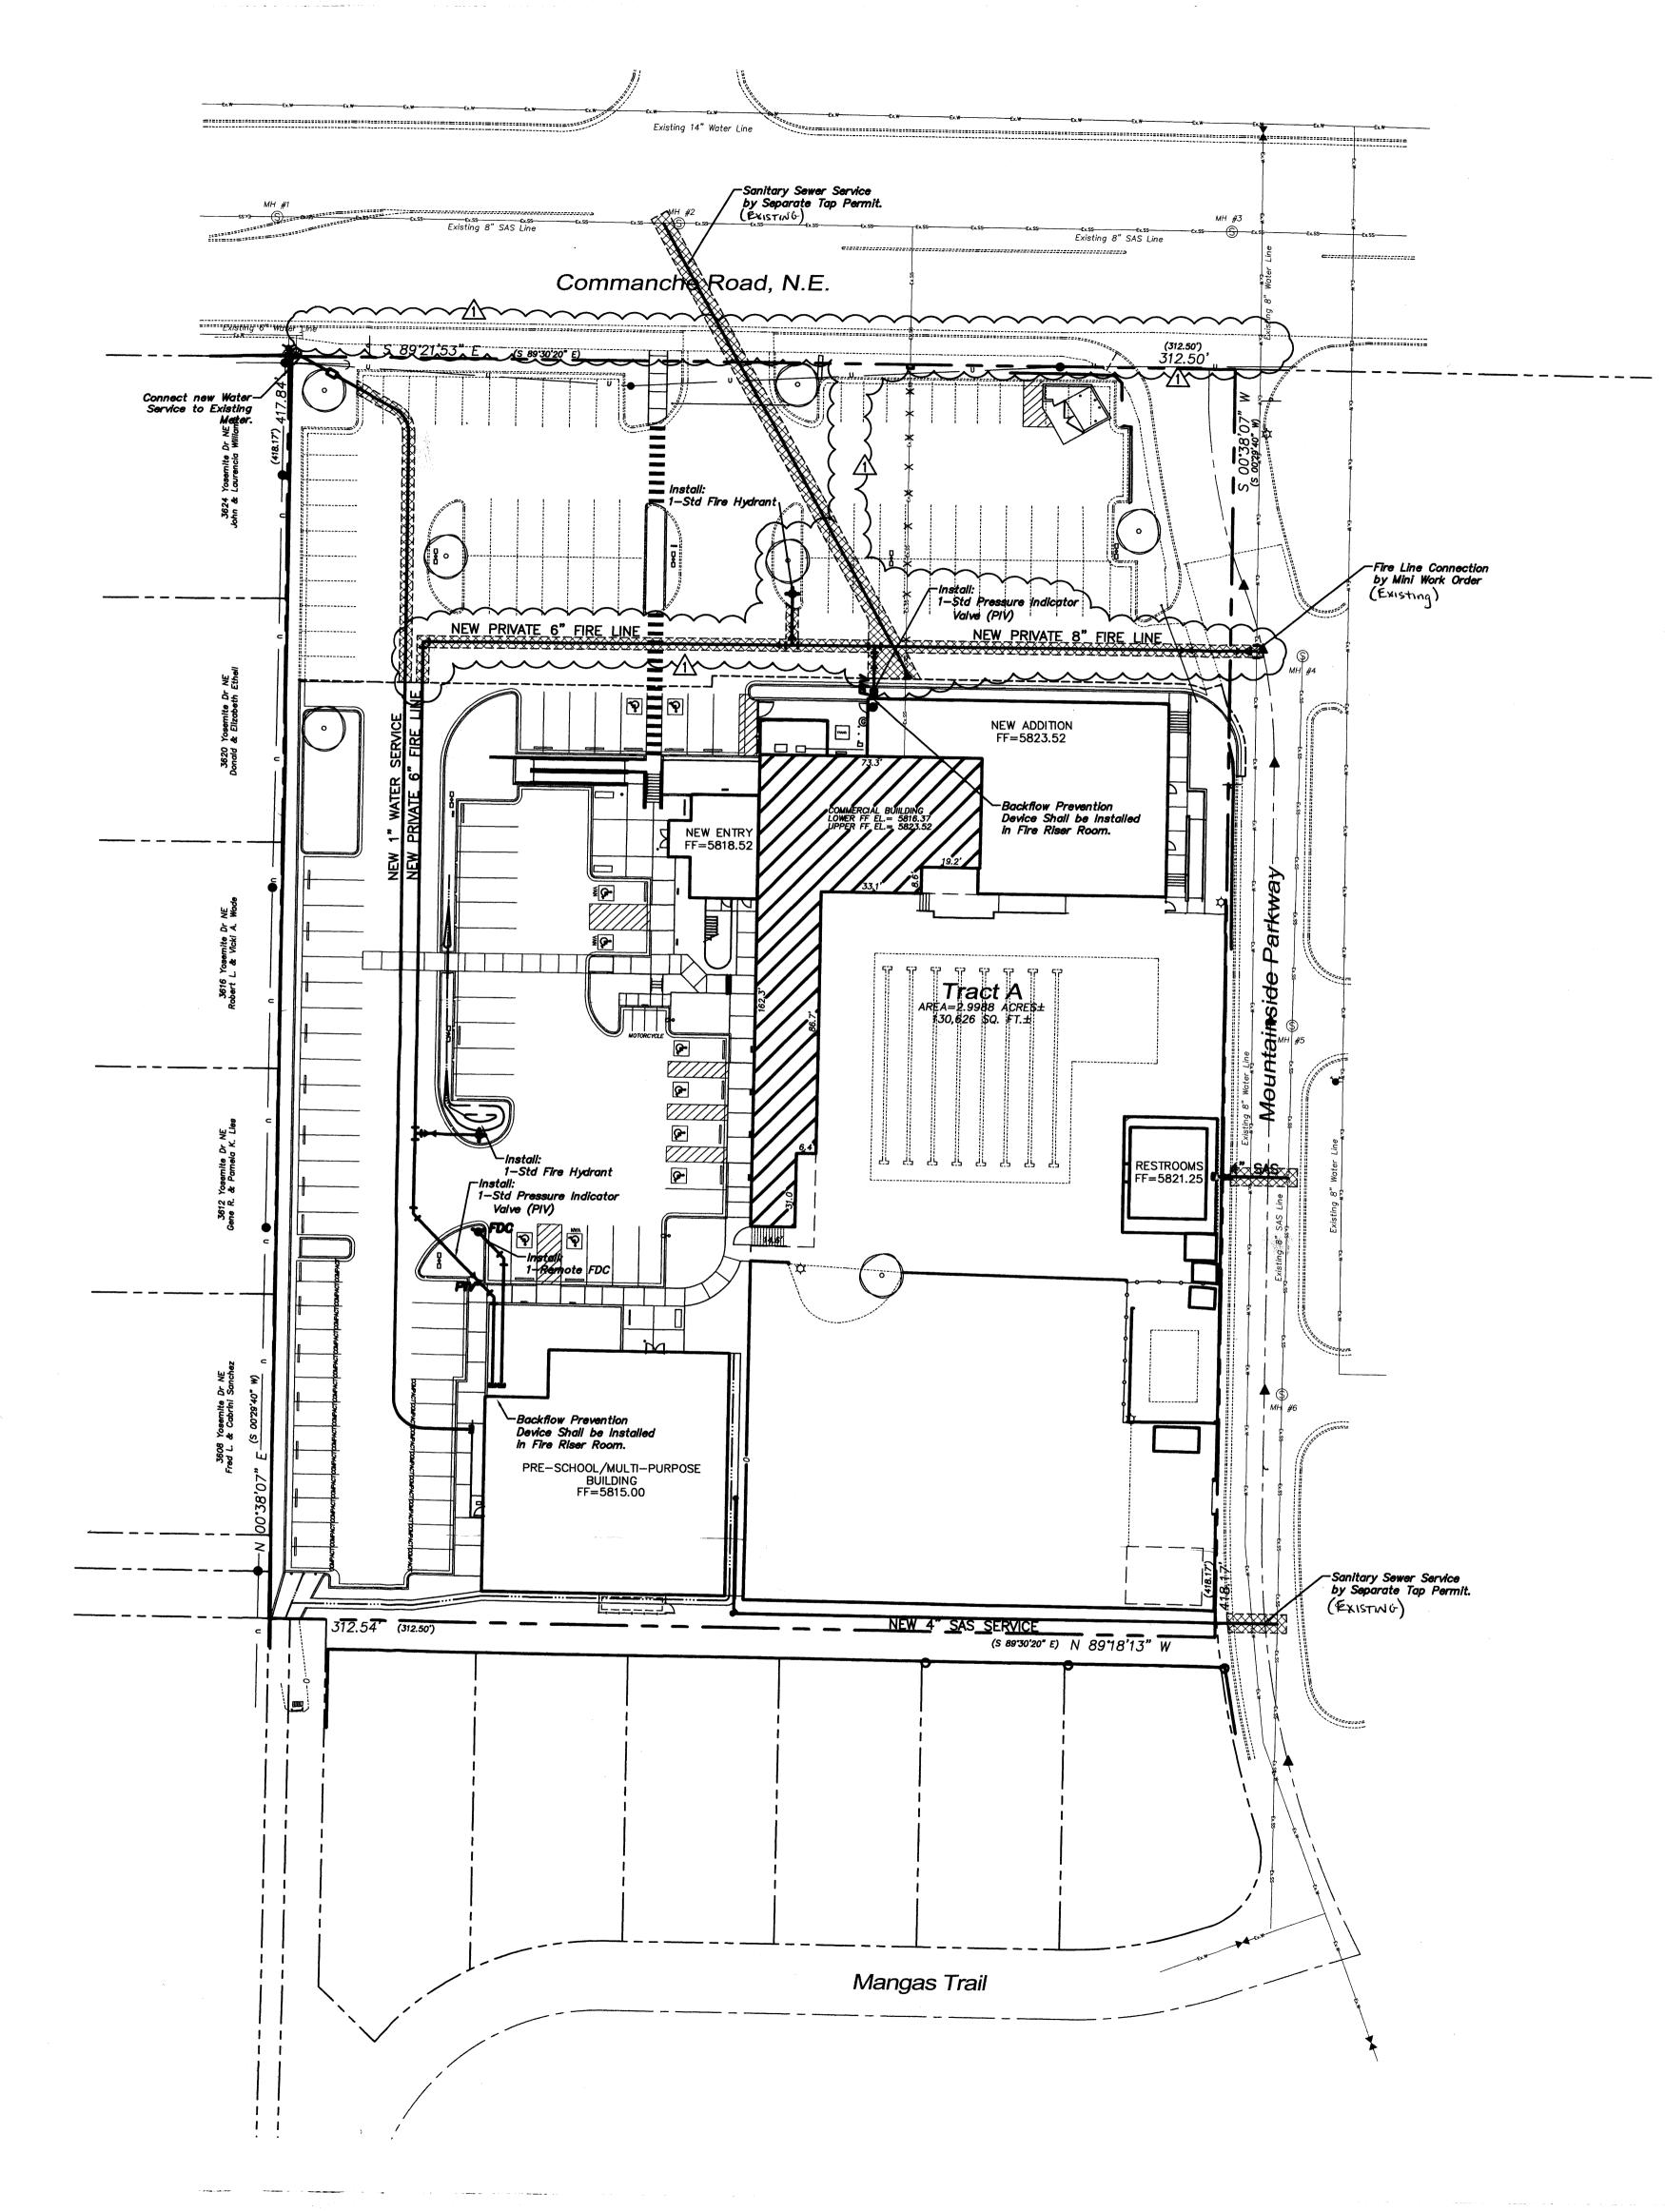- 1. THE CONTRACTOR SHALL BE RESPONSIBLE FOR THE COMPLETE INSTALLATION OF ALL WORK RELATED TO MECHANICAL UTILITIES AS SHOWN ON THIS PLAN INCLUDING: TRENCHING, BACKFILL, SUPPORTS, CLEANOUT PADS, SERVICE STOPS AND BOXES, SERVICE LINES, TESTING, CLEANING, AND STERILIZING. ANY WORK NOT ACCEPTED BY THE ARCHITECT OR ENGINEER DUE TO IMPROPER WORKMANSHIP OR LACK OF PROPER COORDINATION SHALL BE REMOVED AND CORRECTLY INSTALLED AT THE CONTRACTOR'S EXPENSE, AS DIRECTED.
- 2. MINIMUM DEPTHS OF COVER SHALL BE: 36" FOR WATERLINES AND 48" FOR SEWER, EXCEPT AT BUILDING CONNECTION.
- 3. ALL WORK DETAILED ON THESE PLANS TO BE PERFORMED UNDER CONTRACT SHALL, EXCEPT AS OTHERWISE STATED OR PROVIDED OF HEREON, BE CONSTRUCTED IN ACCORDANCE WITH THE IAPMO UNIFORM PLUMBING CODE, LATEST EDITION.
- 4. UTILITY LINES SHALL BE INSTALLED PRIOR TO PAVEMENT, CURB AND GUTTER, AND/OR SIDEWALK, AS APPLICABLE.
- 5. ROUGH GRADING OF SITE (±0.5") SHALL BE COMPLETED PRIOR TO installation of utility lines.
- 6. CONTRACTOR WILL BE RESPONSIBLE FOR CONNECTIONS TO BUILDING DRAIN LINES AND ALL NECESSARY FITTINGS.
- 7. ALL VALVES SHALL BE ANCHORED PER COA STANDARD DWG. 2333.
- 8. FIRE LINES SHALL USE PIPE MATERIALS UNDERWRITERS LABORATORIES LISTED AND APPROVED FOR FIRE SERVICE.
- 9. CONTRACTOR SHALL BE RESPONSIBLE FOR ALL WATER METER, FIRE LINE, AND SEWER HOOKUP FEES FOR INSTALLATIONS. CONTRACTOR SHALL BE RESPONSIBLE FOR UTILITY EXPANSION CHARGES, PRORATA AND OTHER SPECIAL ASSESSMENTS.
- 10. CONTRACTOR SHALL VERIFY INVERTS AND LOCATIONS OF EXISTING WATER/SAS LINES PRIOR TO BEGINNING WORK. ALL CONFLICTS SHALL BE BROUGHT TO ATTENTION OF THE ENGINEER AND RESOLVED PRIOR TO BEGINNING
- 11. CONTRACTOR SHALL PREPARE ALL SUBMITTAL MATERIALS & PAY APPLICABLE FEES REQUIRED TO OBTAIN THE "MINI WORK ORDER" REQUIRED FOR CONNECTION TO THE EXISTING CITY WATER MAIN AND OTHER 'PUBLIC' WATER LINE CONSTRUCTION.

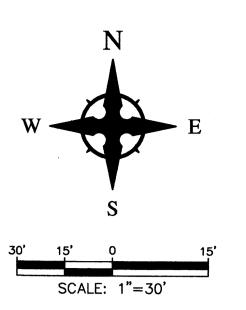

CLEANOUT FRAME & COVER

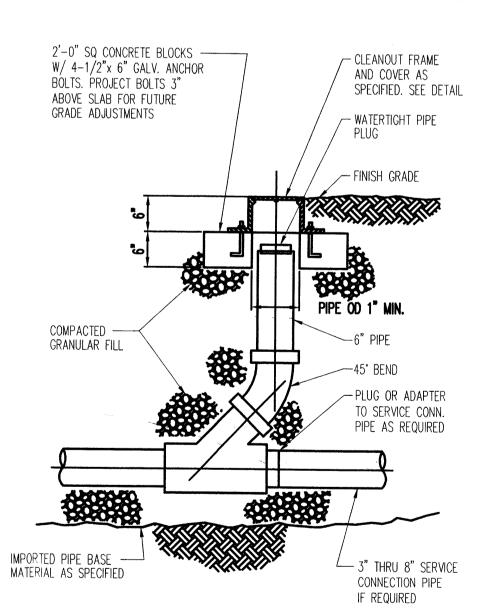

CLEANOUT DETAIL

5017 Sanbusco Dr NE, Rio Rancho, NM 87144 Ph: 505.771.4200 Fax: 505.771.8905



architecture interiors landscape planning engineering

7601 Jefferson NE Suite 100 Albuquerque, NM 87109 505 761-9700

fax 761-4222 dps@dpsdesign.org

ARCHITECT

ENGINEER

NOT FOR CONSTRUCTION


MOUNTAINSIDE YMC 12500 Comanche NE Albuquerque, NM 87111


1. REVISE FIRE LINES TO BE PRIVATE.


DRAWN BY MTL **REVIEWED BY** MTL DATE 09/06/07 PROJECT NO. 07060

DRAWING NAME UTILITY

PLAN

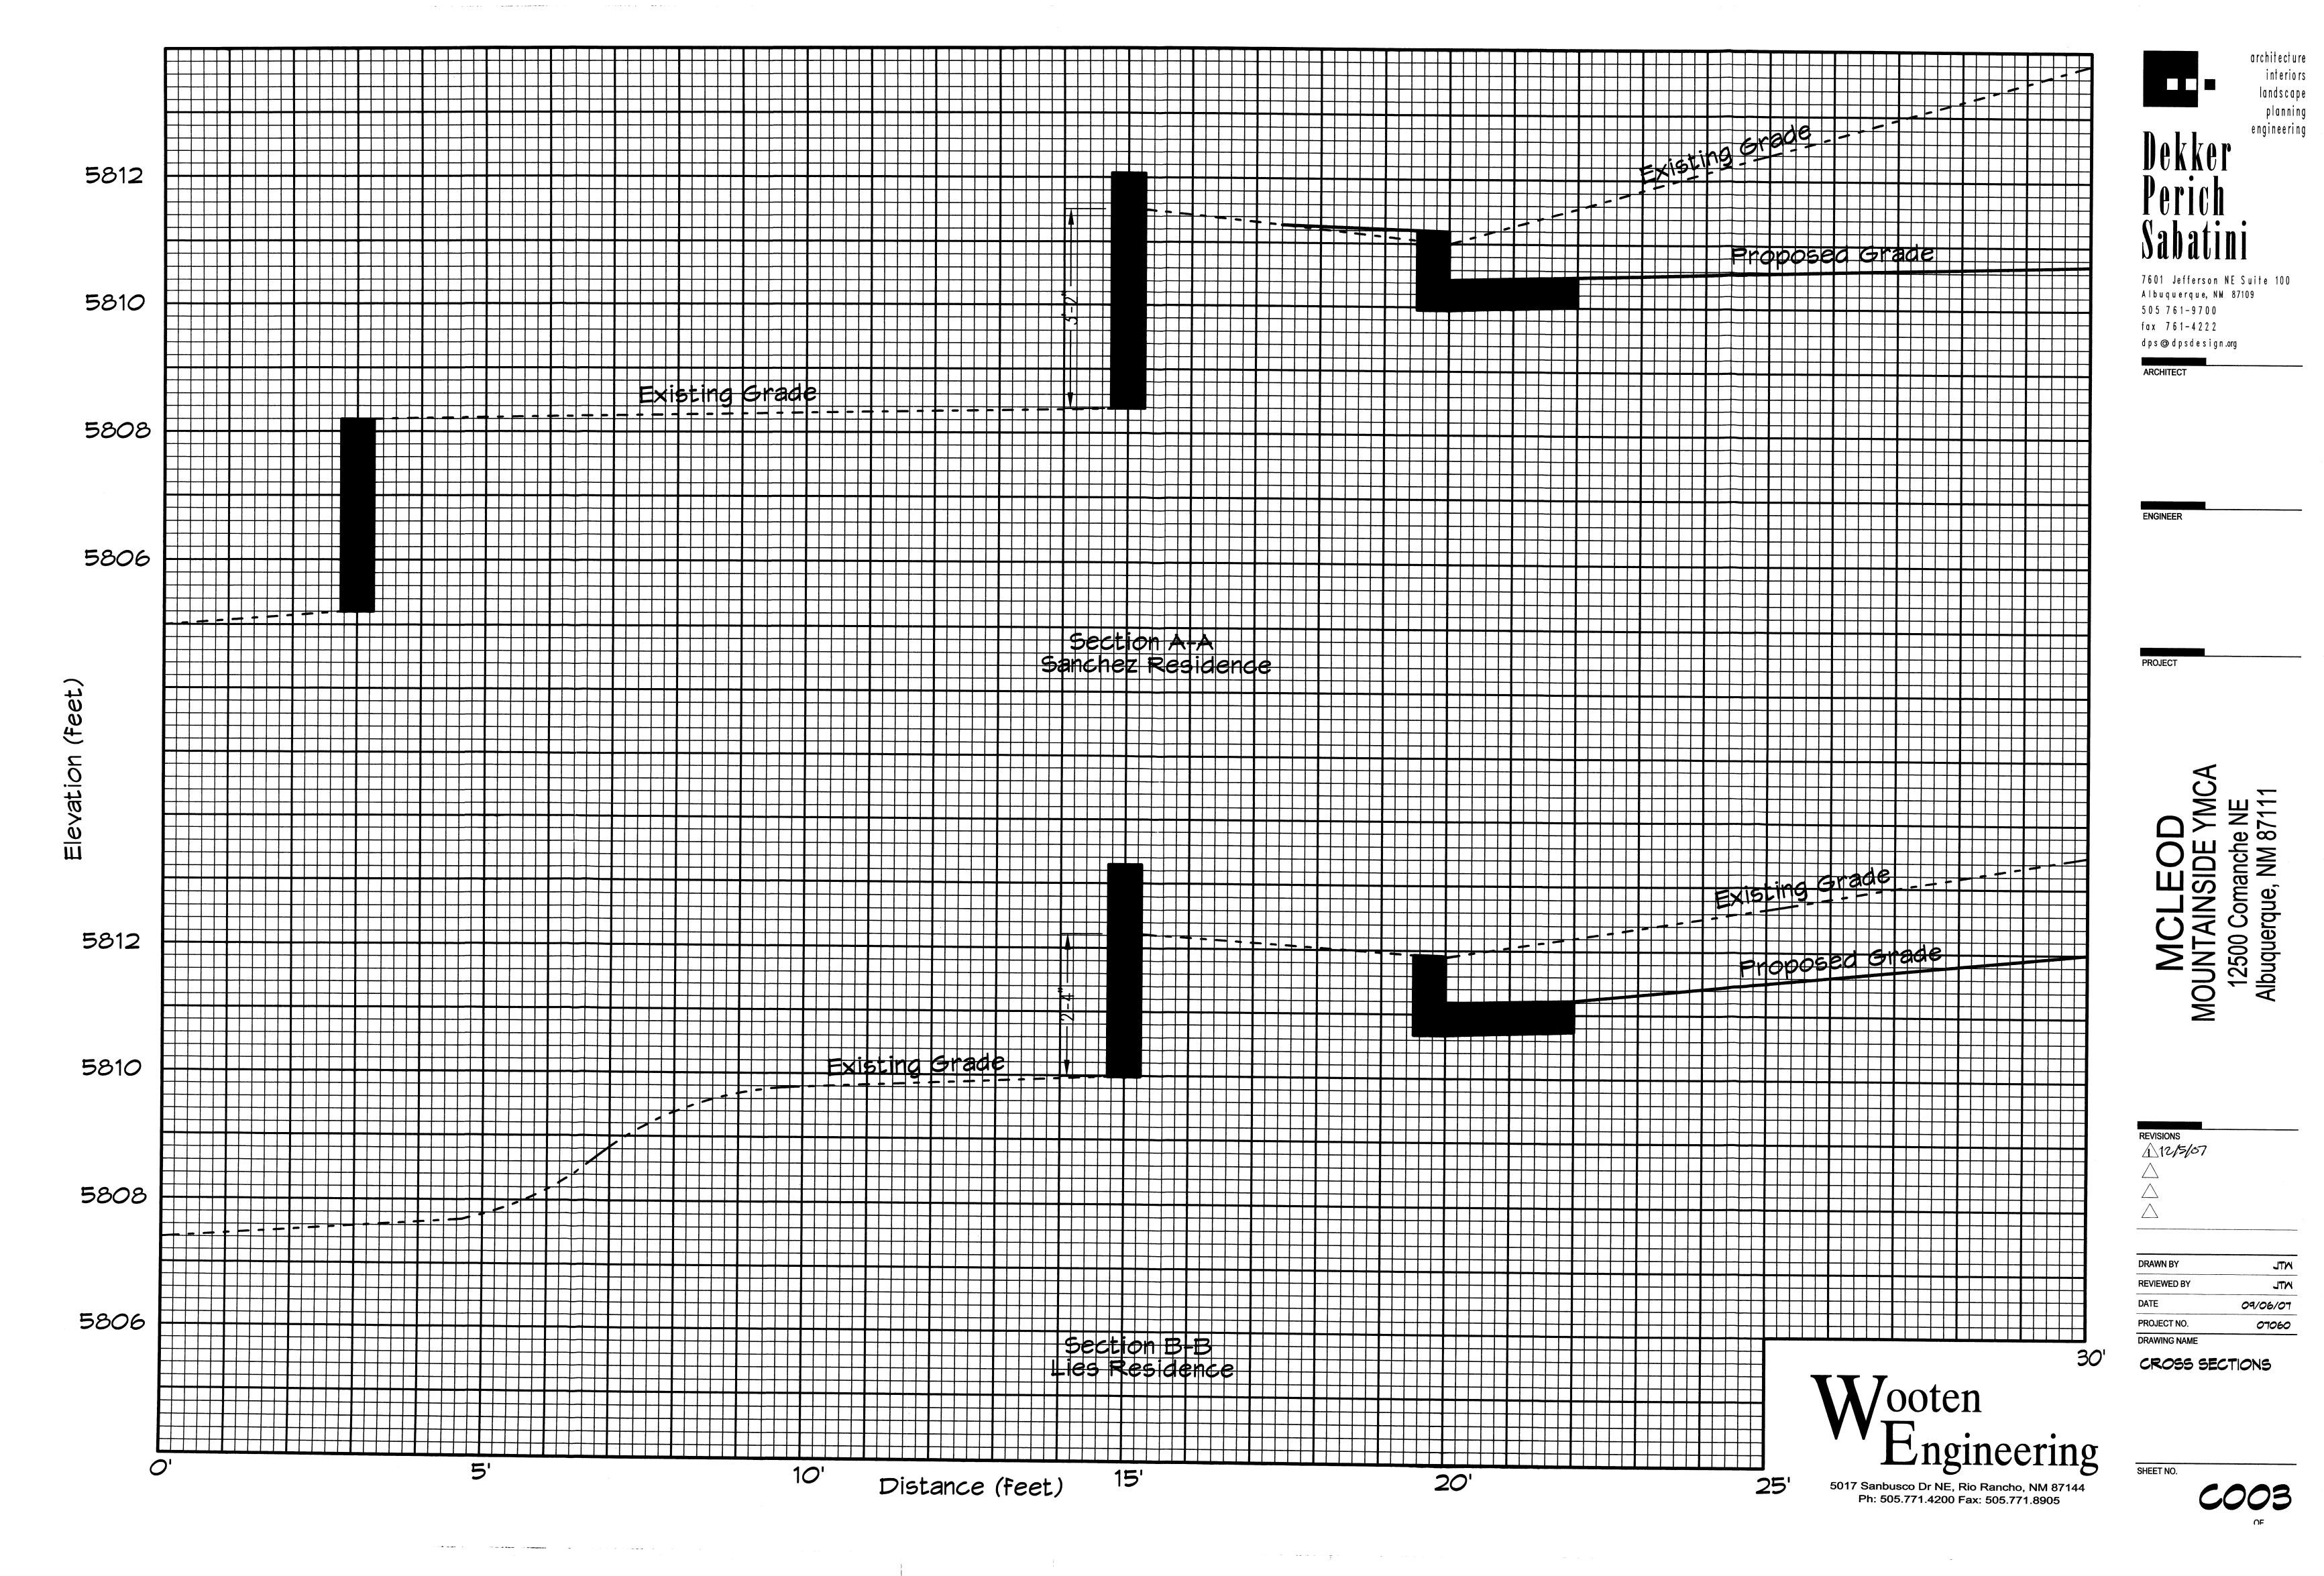

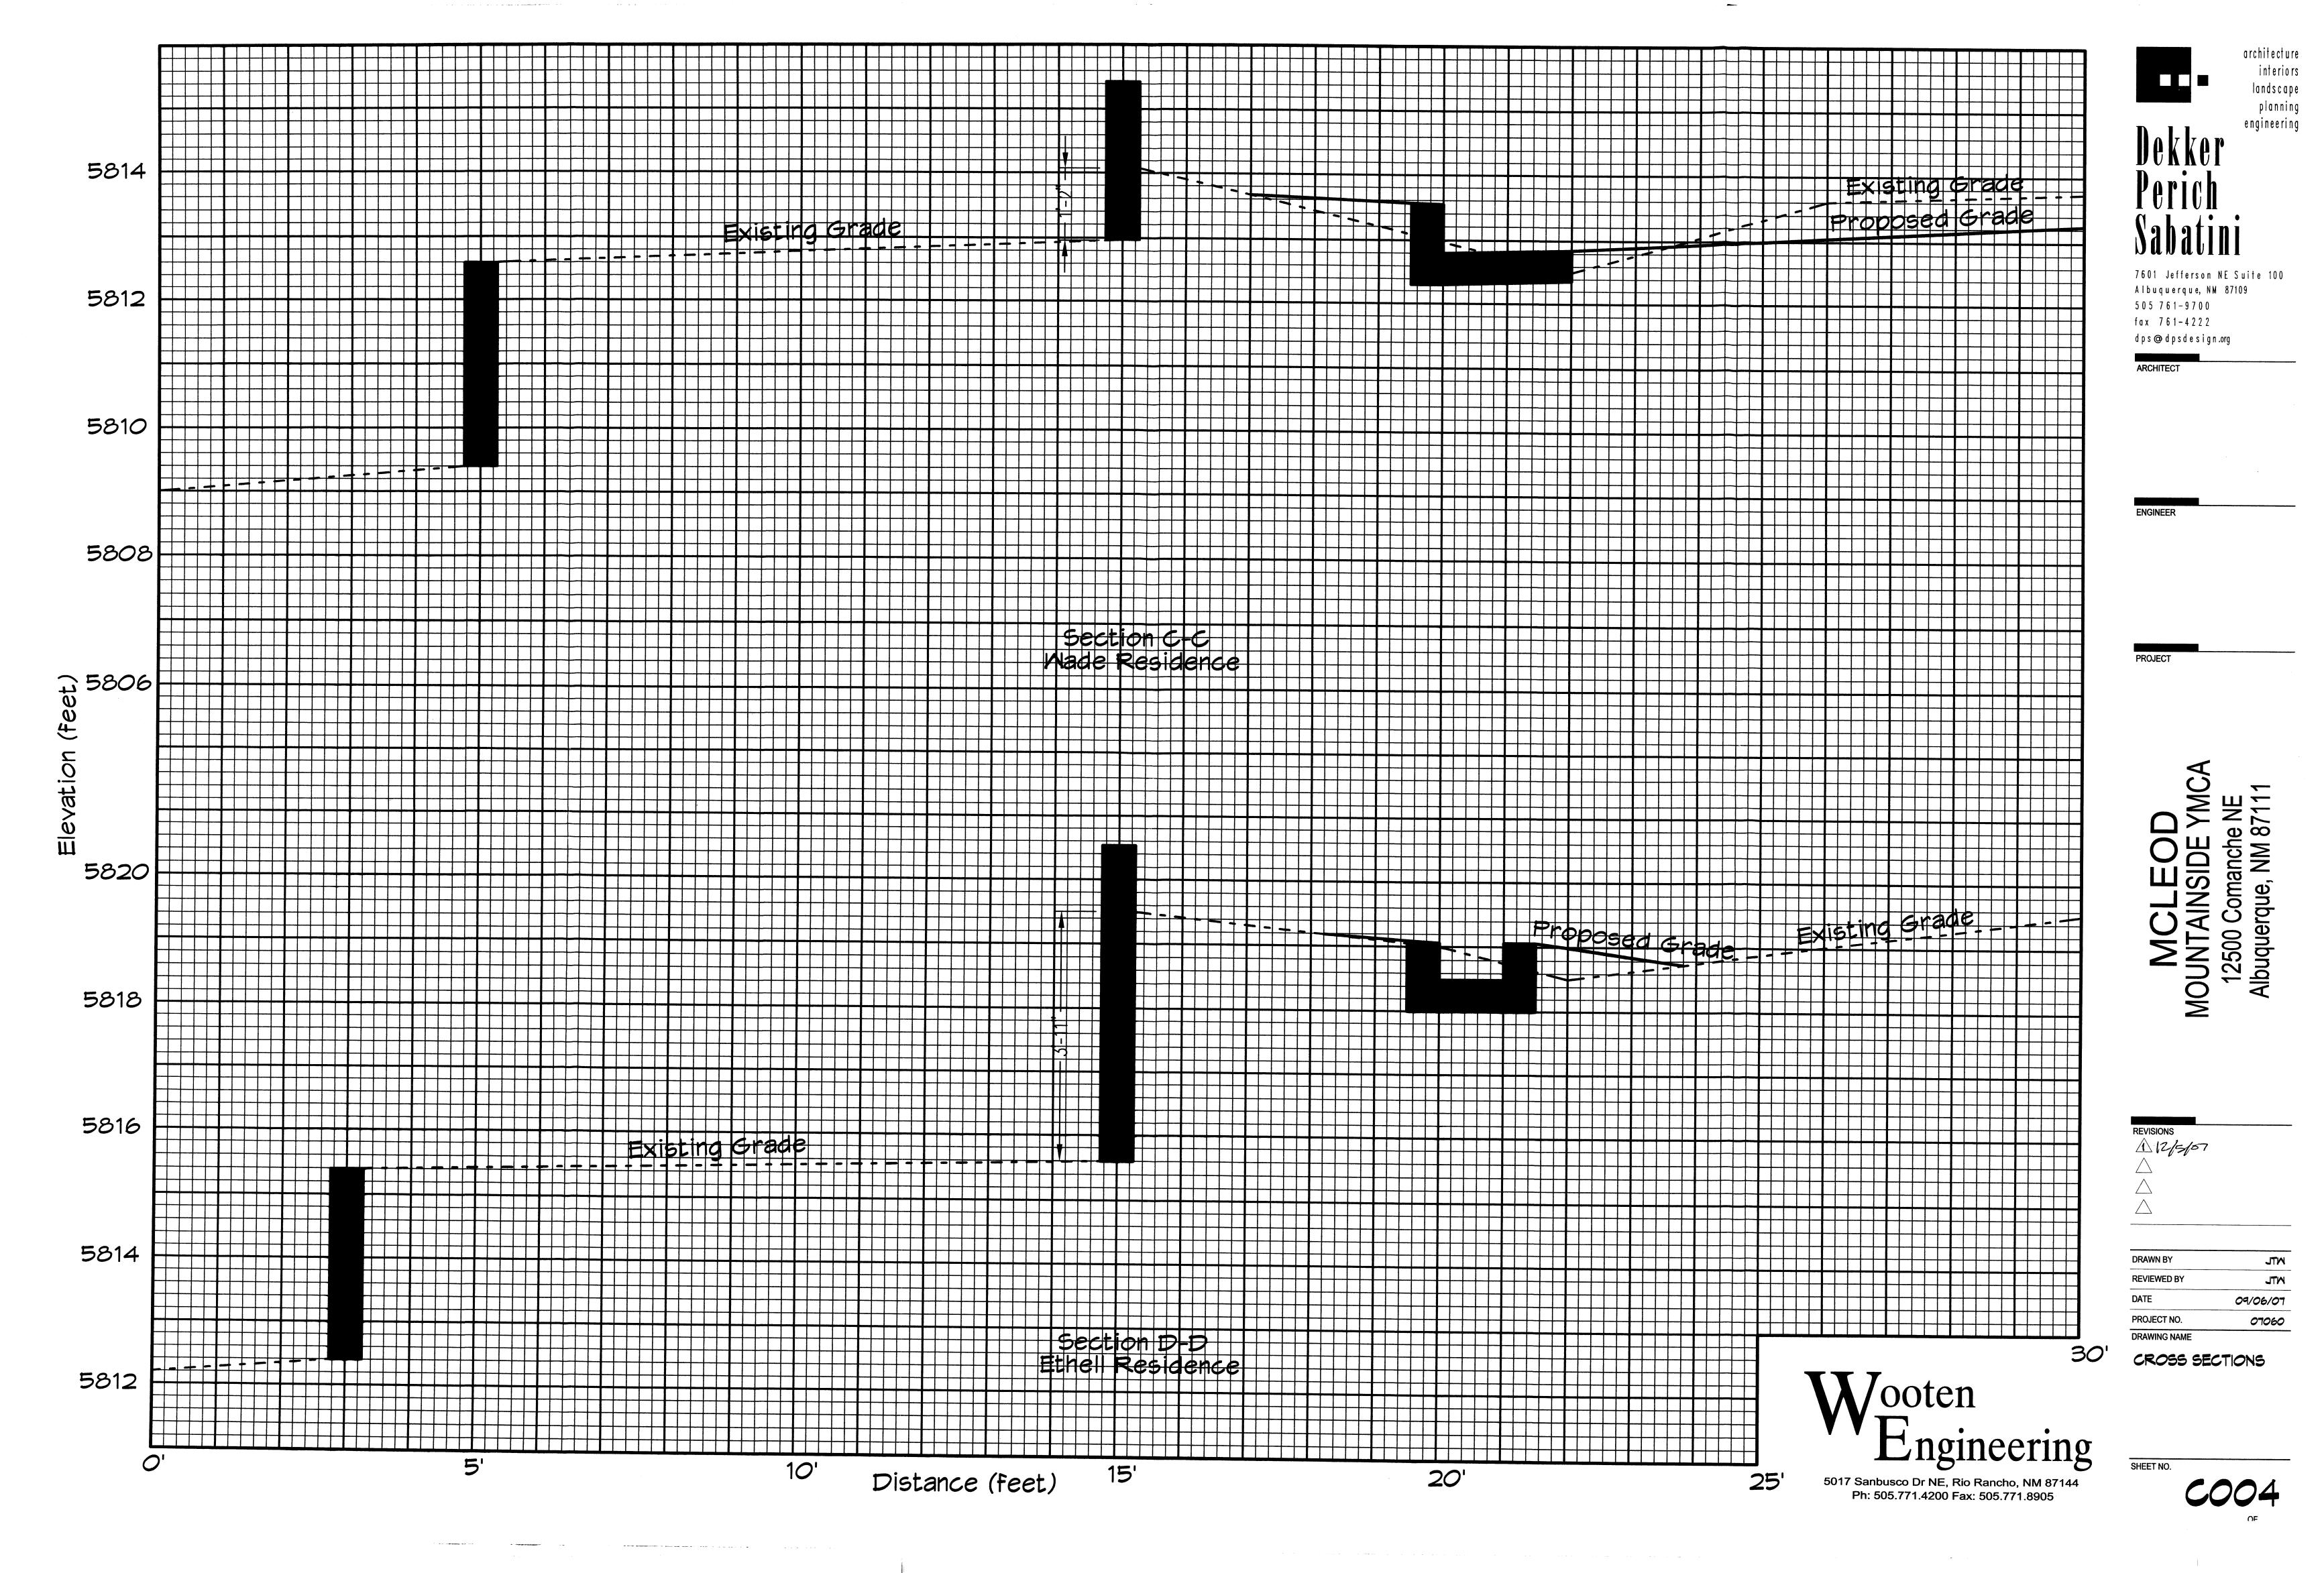

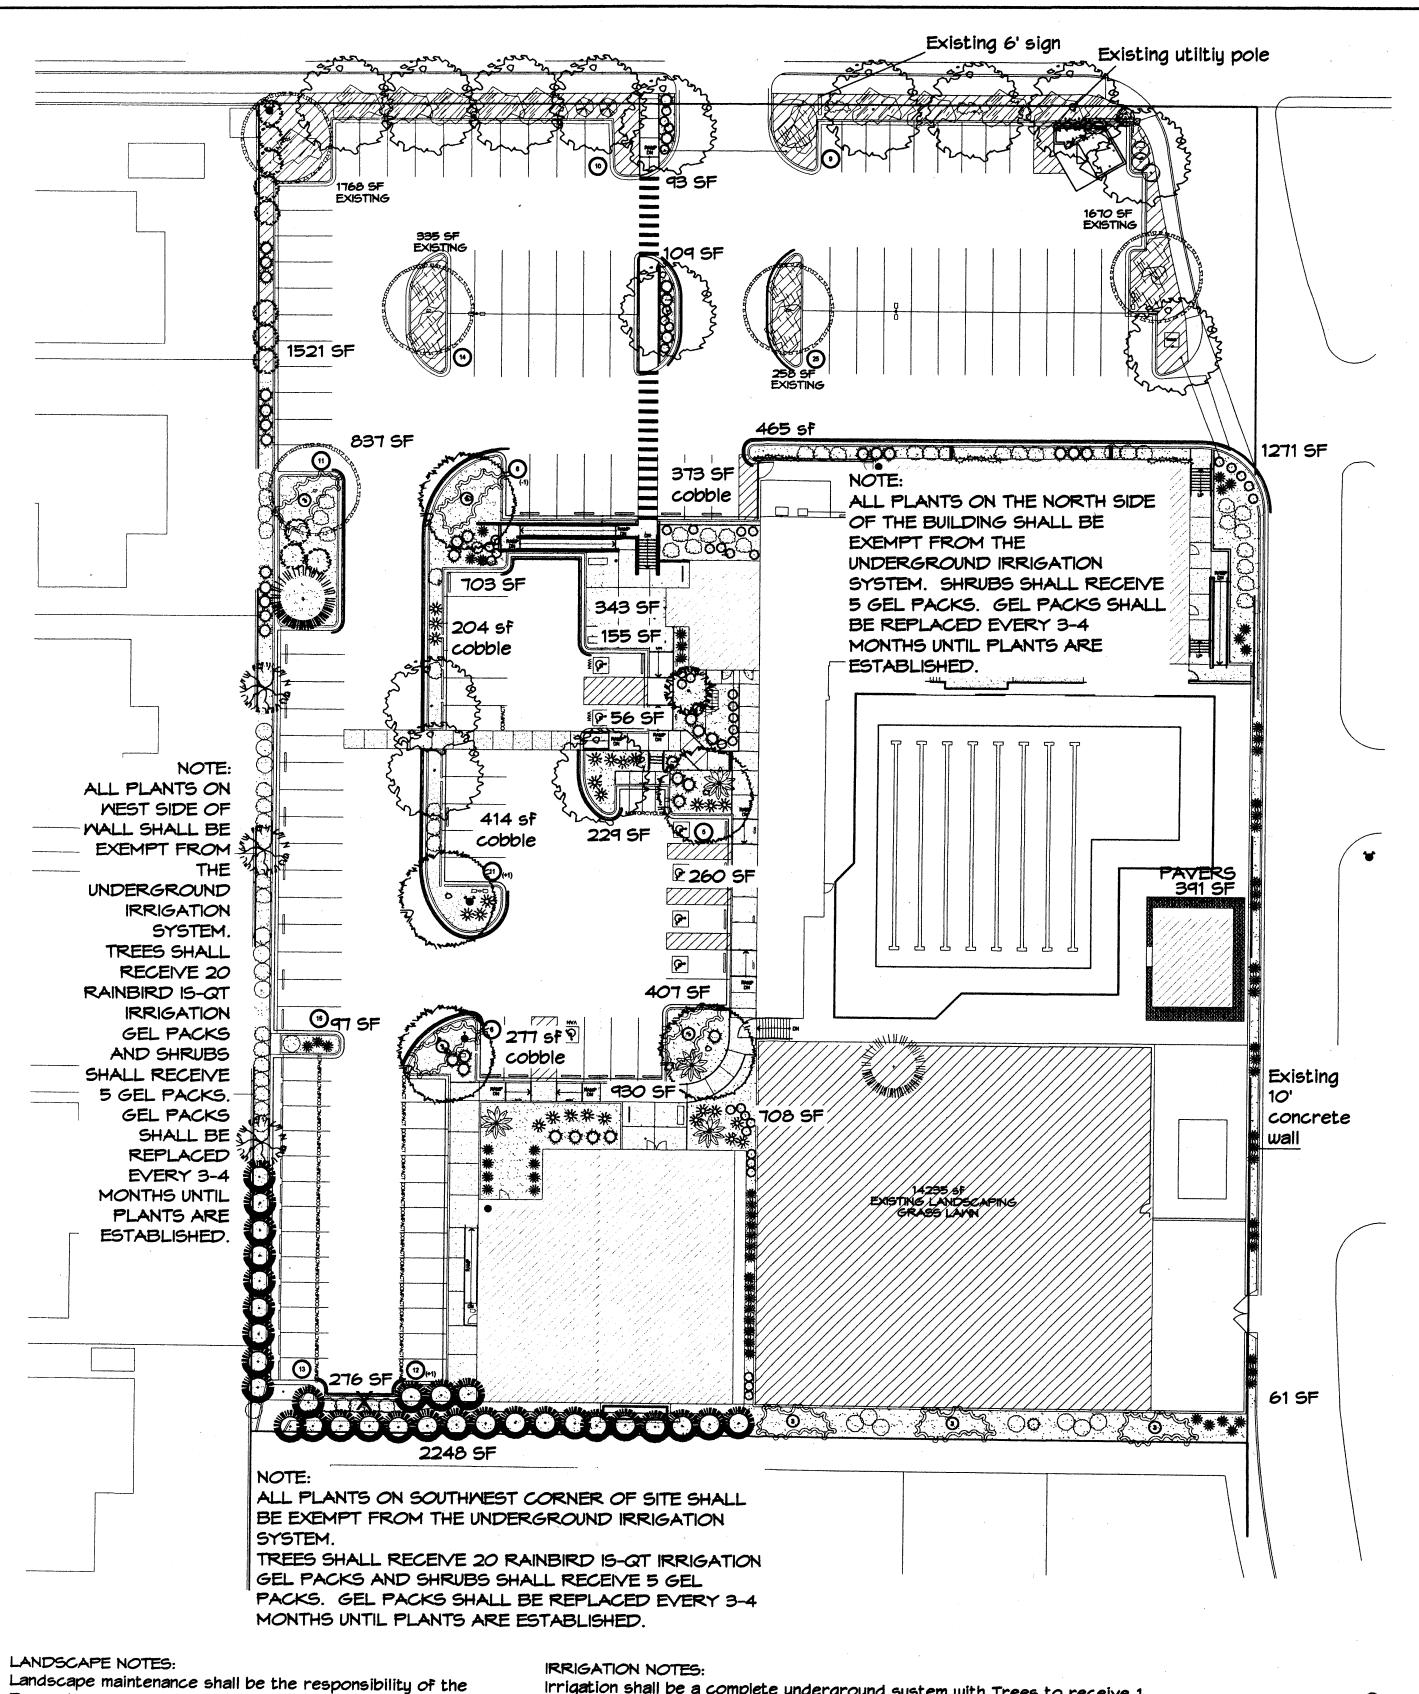

Irrigation shall be a complete underground system with Trees to receive 1

Netafim spiral (50' length) with 3 loops at a final radius of 4.5' from tree

trunk, pinned in place. Netafim shall have emitters 12" o.c. with a flow of .6 gph. Shrubs to receive (2) 1.0 GPH Drip Emitters. Drip and Bubbler

systems to be tied to 1/2" polypipe with flush caps at each end. Trees

Run time per each shrub drip valve will be approximately 15 minutes per

day. Tree drip valve shall run 1.5 hours, 3 times per week. Run time will

Point of connection for irrigation system is unknown at current time and

will be coordinated in the field. Irrigation will be operated by automatic

Location of controller to be field determined and power source for

Irrigation maintenance shall be the responsibility of the Property Owner.

and shrubs shall be on separate valves.

be adjusted according to the season.

controller to be provided by others.

PLANT PALETTE

CHINESE PISTACHE (M) 14 Pistacia chinensis 2" Cal.

SHUMARD OAK (M) 5 Quercus shumardii 2" Cal.

* AUSTRIAN PINE (M) 1 Pinus niara

> NEW MEXICO OLIVE (L) 3 Forestiera neomexicana 5 Gal. 225 sf

AMUR MAPLE (M) 1 Acer ginnala Multi-trunk B&B (2" Cal.)

* CURLLEAF MTN MAHOGANY(L+) 30 Cercocarpus ledifolius 5 Gal. 225 sf

DESERT ACCENTS

* BLUE SOTOL (L) 2 Dasylirion wheeleri 5 Gal. 9sf

HARDSCAPES

3/4" GRAY GRAVEL WITH FILTER FABRIC TO A MINIMUM DEPTH OF 3"

FILTER FABRIC TO A MINIMUM DEPTH OF 3"

* DENOTES EVERGREEN MATERIAL

EXISTING

SHRUBS/ORNAMENTAL GRASSES

FIVE GAL. MOCK ORANGE (M) 4

Philadelphus cultivars 5 Gal. 100sf * PHOTINIA (M+) 11 Photinia fraseri

* APACHE PLUME (L) 17 Fallugia paradoxa 5 Gal. 25sf

5 Gal. 64sf

* LENA'S BROOM (M) 42 Cytisus scoparius 5 Gal.

ONE GAL

* POWIS CASTLE SAGE (L+) 54 Artemisia X Powis Castle 1 Gal. 25sf

DEER GRASS (M) 26 Muhlenbergia rigens 1 Gal. 165f

CATMINT (M) 45 Nepeta mussini 1 Gal. 45f

BLUE AVENA/OAT GRASS (M) 67 Helictotrichon sempervirens 1 Gal.

GROUNDCOVERS

* GREYLEAF COTONEASTER (M) 21 Cotoneaster buxifolius 5 Gal. 81sf Symbol indicates 3 plants

ENGLISH MY (M) 4 Hedera helix

EXISTING LANDSCAPING TO REMAIN

PAVERS

PLANT PALETTE

ASH (M) 5

Fraxinus spp. FLOWERING PEAR (M+) 1

Pyrus calleryana

NUSTRIAN PINE (M) 1 Pinus nigra

RUSSIAN SAGE (M) 4 Perovskia atriplicifolia

INDIAN HAMTHORN (M) 2 Raphiolepis indica

BLUE CHIP JUNIPER (L+) 3 Juniperus horizontalis 'Blue Chip'

TAM JUNIPER (L+) 18 Juniperus sabina 'Tamariscifolia'

Tree Trunk Root Ball Emitter-12" o.c.

Netafim Spiral Detai

1. ROOTBALL SHALL BE PLACED ON UNDISTURBED SOIL

Ph. (505) 898-9690 WHICH THE TREE SHOULD BE INSTALLED; THAT LEVEL MAY Fax (505) 898-7737 cm i@hilltoplandscaping.com 3. PRIOR TO BACKFILLLING TREE, ALL WIRE, ROPE AND property of The Hilltop Landscape Architects and SYNTHETIC MATERIALS SHALL BE REMOVED FROM THE ontractors and are protected by copyright laws. This is an original design and must not be released or copie

4. PRIOR TO BACKFILLING ALL BURLAP SHALL BE CUT AWAY EXCEPT FROM BOTTOM OF THE ROOTBALL.

CONSTRUCTION NOTES:

A. TREE

B. BACKFILL WITH EXISTING SOIL. C. 3" DEPTH OF GRAVEL MULCH



LANDSCAPE CALCULATIONS

REQUIRED GROUNDCOVER COVERAGE 12579

130416

18605

111811

15%

16772

30229

12037

75%

9027

4031

75%

Shade trees required under the City Of Albuquerque

PARKING LOT TREE REQUIREMENTS

1 Shade tree per 10 spaces

STREET TREE REQUIREMENTS

Name of Street: Comanche

NOTE TO CLIENT

Street Tree Ordinance are as follows:

Required # 9 Existing # 2 Provided # 7

Required #3 Existing #1 Provided #2

Should The Hilltop not receive a Grading and

on-site grades differ from the Grading and

than 2-4" cobblestone will not stay on a slope

vegetative material shall remain per plan.

Drainage plan during the design process or the

Drainage plan received, The Hilltop reserves the

right to apply slope stabilization materials where the

greater than 3:1. If the grades are greater than what

was originally designed, we will request an infield

change-order to lay cobblestone or rip-rap, in lieu

of the specified gravel, to stabilize the slope. All

specified gravel will not be suitable. Gravel smaller

Name of Street: Mountainside Parkway parking

Parking Lot Tree Ordinance are as follows:

Required # 15 Existing # 5 Provided # 10

3023

square feet

14235 (47%) square feet

9085 (75%) square feet

3936 (95%) square feet

TOTAL LOT AREA

NET LOT AREA

TOTAL BUILDINGS AREA

REQUIRED LANDSCAPE

AND EXISTING)

NEW LANDSCAPING

LANDSCAPE BED PROVIDED

GROUNDCOVER PROVIDED

EXISTING LANDSCAPING

LANDSCAPE BED PROVIDED

GROUNDCOVER PROVIDED

REQUIRED GROUNDCOVERAGE

REQUIRED GROUNDCOVER PERCENT

REQUIRED GROUNDCOVERAGE

EXISTING SOD

PAVERS

LANDSCAPE REQUIREMENT

TOTAL GROUNDCOVER PROVIDED

PROVIDED LANDSCAPING (NEW

(max. 20% of landscape required)

REQUIRED GROUNDCOVER PERCENT

CONSTRUCTION, INC

GENERAL CONTRACTOR


ARCHITECT



architectu interio landscap plannin engineerin

7601 Jefferson NE Suite 100 Albuquerque, NM 87109 505 761-9700 fax 761-4222

dps@dpsdesign.org

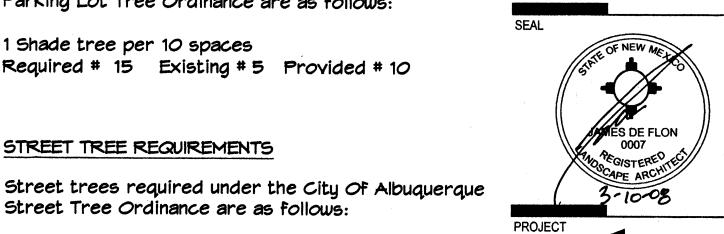

 ∞ anch NM 8 Mo J 500

Albuquerq S **REVISIONS** 10 3-10-08

DRAWN BY REVIEWED BY 8/23/07 PROJECT NO. 07060 DRAWING NAME

SHEET NO.

_001

1 OF 1

1 MAINLINE FITTING CMU BLOCK GALVANIZED NIPPLE 24" TO 36" GALVANIZED NIPPLE LATERAL PIPE REDUCER BUSHING

GALVANIZED NIPPLE

(10) GALVANIZED ELBOW

AUTOMATIC VALVE (SEE LEGEND)

WATERPROOF WIRE CONNECTOR WIRE EXPANSION LOOPS VALVE BOX FINISH GRADE GALVANIZED STREET FILE TOE NIPPLE OR MALE ADAPTER

GALVANIZED NIPPLE - 18" TO 24" LENG ATMOSPHERIC VACUUM BREAKER


AUTOMATIC VALVE W/ ATMOSPHERIC

C. EARTH BERM AROUND WATER RETENTION BASIN. D. 3" DEPTH OF GRAVEL MULCH.

SHRUB PLANTING DETAIL

A. SHRUB. B. BACKFILL WITH EXISTING SOIL

E. FINISH GRADE.

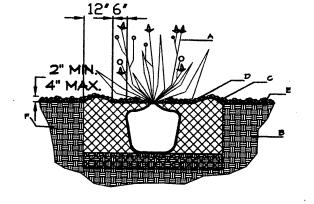

GENERAL NOTES:

BASIN SHALL BE TWICE THE DIAMETER OF THE SHRUB PLANTING PIT.

F. UNDISTURBED SOIL.

1. THE OUTSIDE DIAMETER OF THE WATER RETENTION

CONSTRUCTION NOTES:

TREE PLANTING DETAIL GENERAL NOTES:

TO PREVENT TREE FROM SETTLING. 2. TOP OF ROOTBALL INDICATED LEVEL AT WHICH TREE WAS GROWN AND DUG; THIS REPRESENTS THE LEVEL AT BE EXCEEDED BY ONLY A ONE INCH LAYER OF SOIL.

TREE AND THE PLANTING PIT.

D. UNDISTRUBED SOIL.

SCALE: 1"=30'

Cont. Lic. #26458

All creative ideas contained Herein remains the

inless applicable fees have been paid or job order

7909 Edith N.E.

including both existing and new landscape areas. Water and Power source shall be the responsibility of the Developer/Builder. 3/4" Crushed Grey Gravel over Filter Fabric to a minimum depth of 3" shall be placed in all landscape areas which are not designated to receive native seed.

controller.

Property Owner. The Property Owner shall maintain street

trees in a living, healthy, and attractive condition.

Water Waste Ordinance.

design and installation.

It is the intent of this plan to comply with the City Of

Albuquerque Water Conservation Landscaping and Water

Maste Ordinance planting restriction approach. Approval of

this plan does not constitute or imply exemption from water

Water management is the sole responsibility of the Property

Owner. All landscaping will be in conformance with the City of

environmentally sound landscape principles will be followed in


Albuquerque Zoning Code, Street Tree Ordinance, Pollen


Waste Ordinance. In general, water conservative,


Ordinance, and Water Conservation Landscaping and Water

Plant beds shall achieve 75% live ground cover at maturity


waste provisions of the Water Conservation Landscaping and

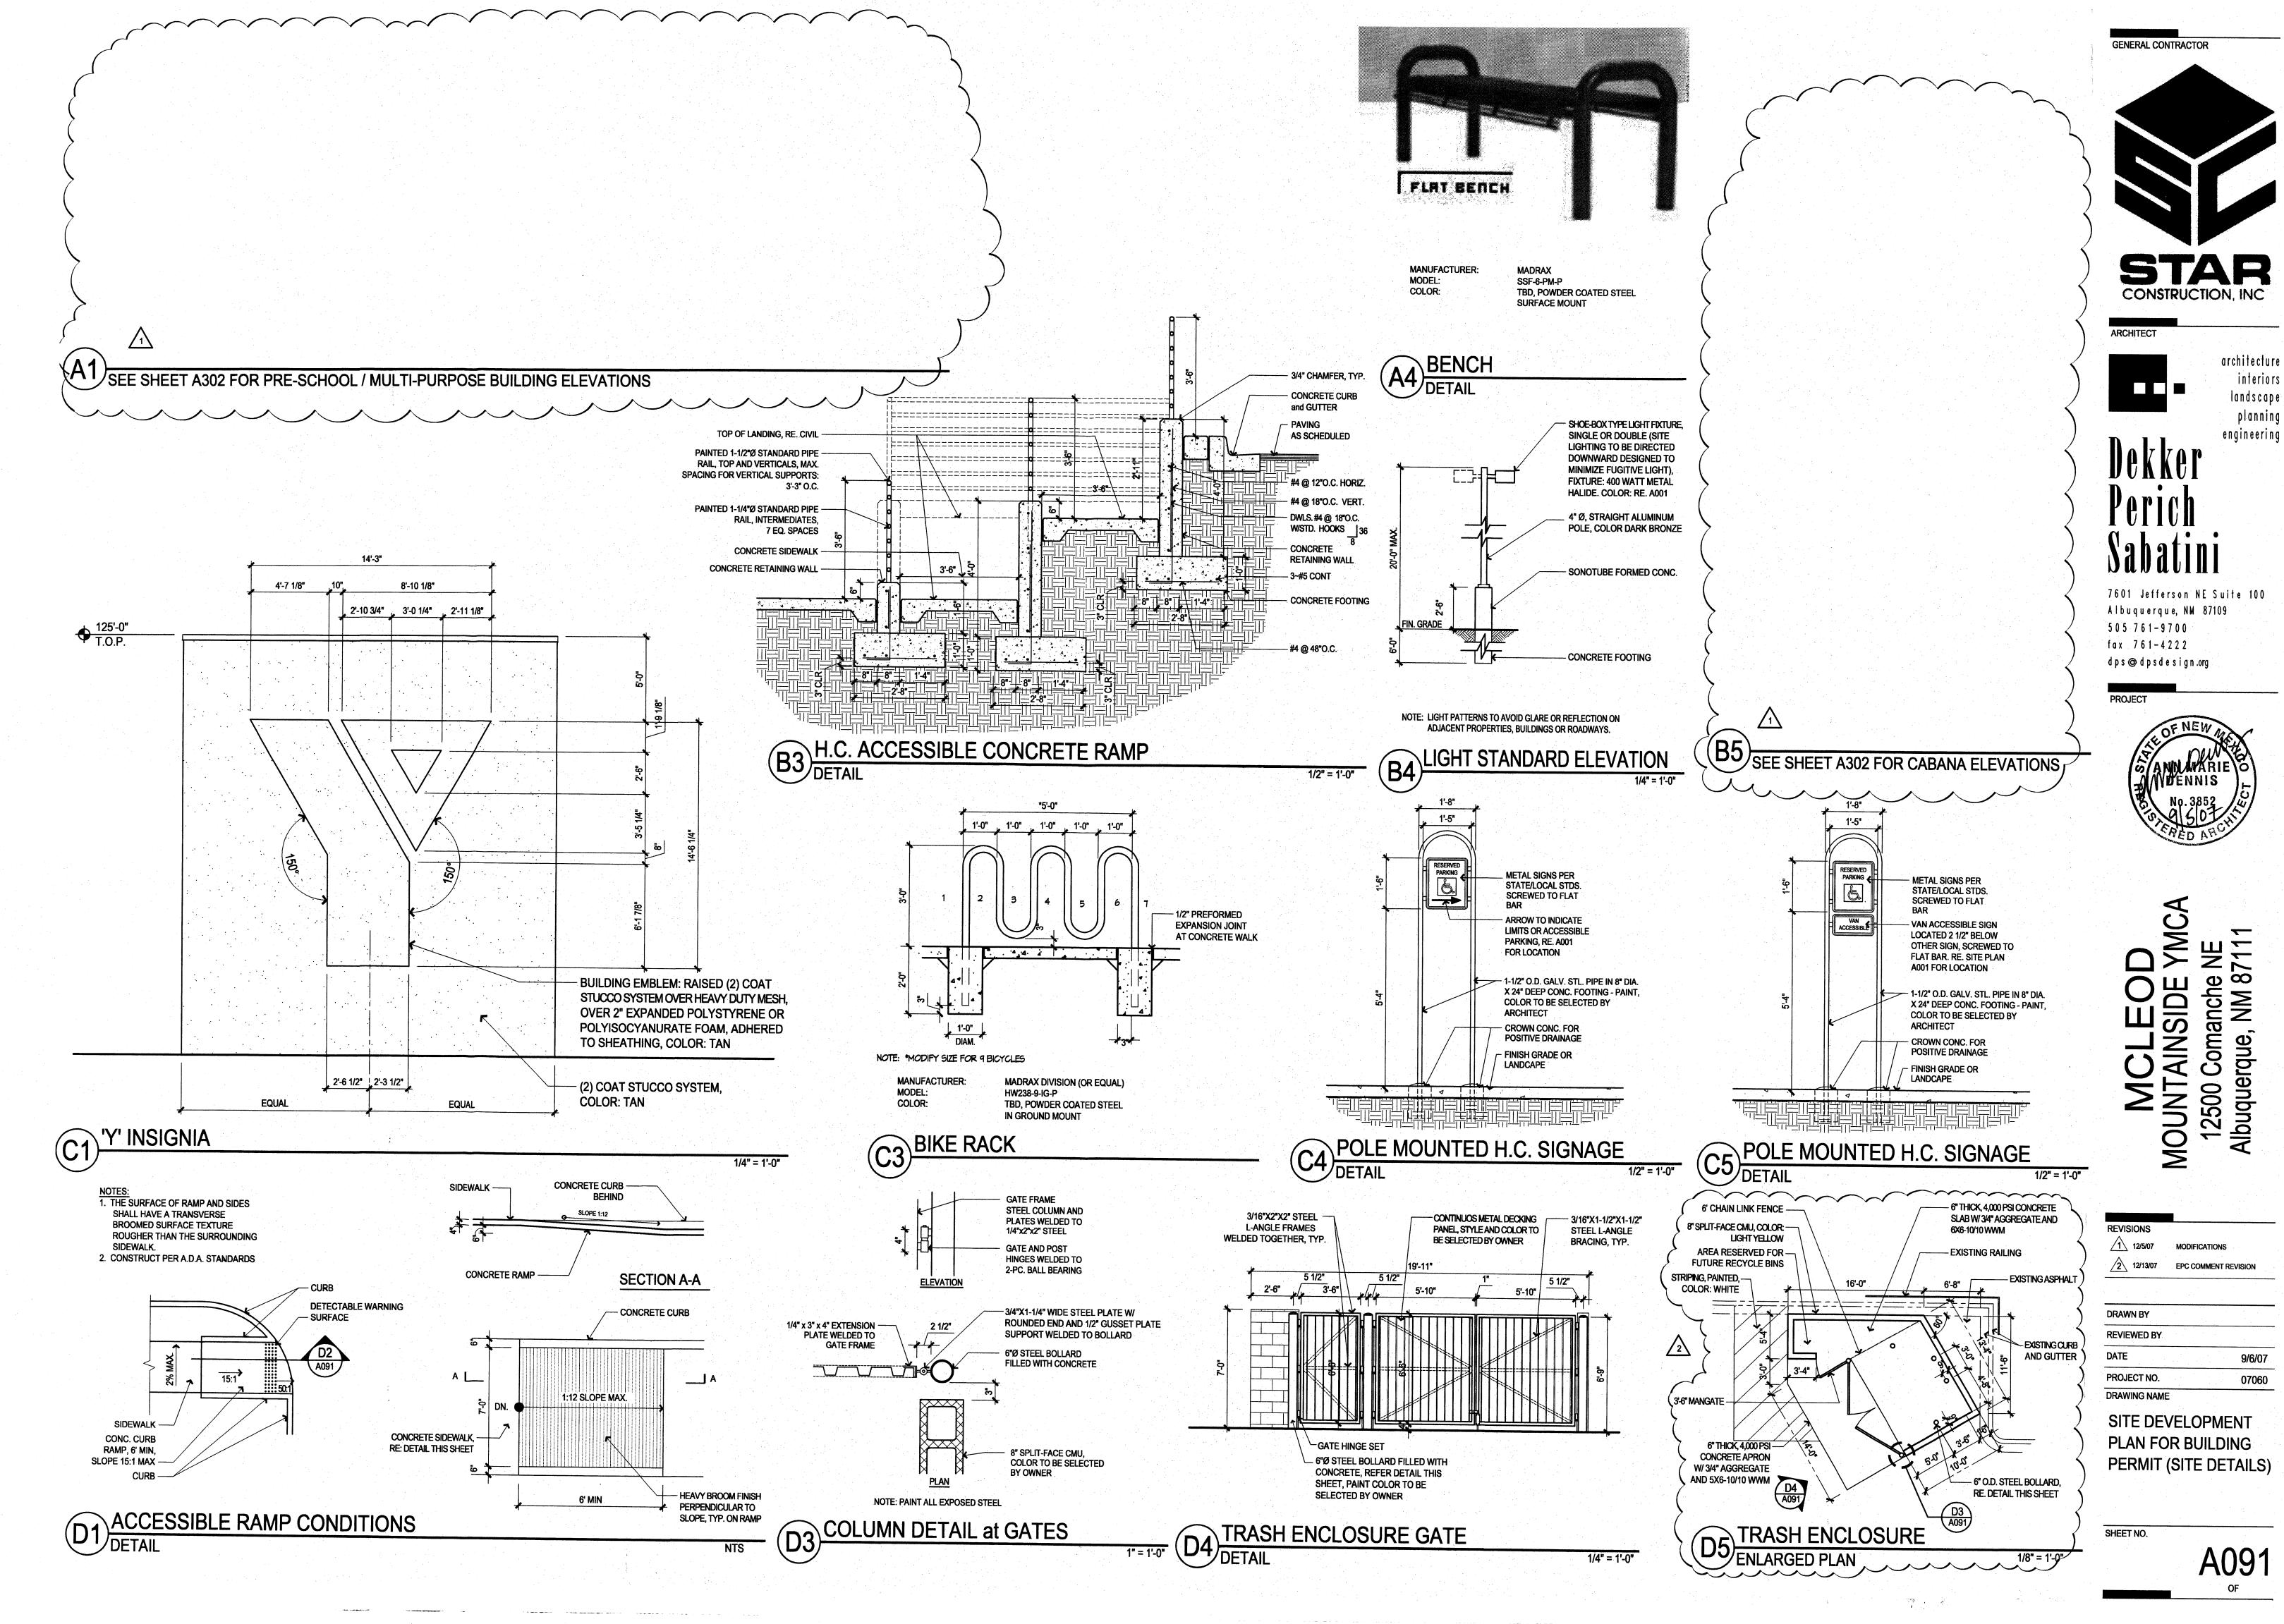

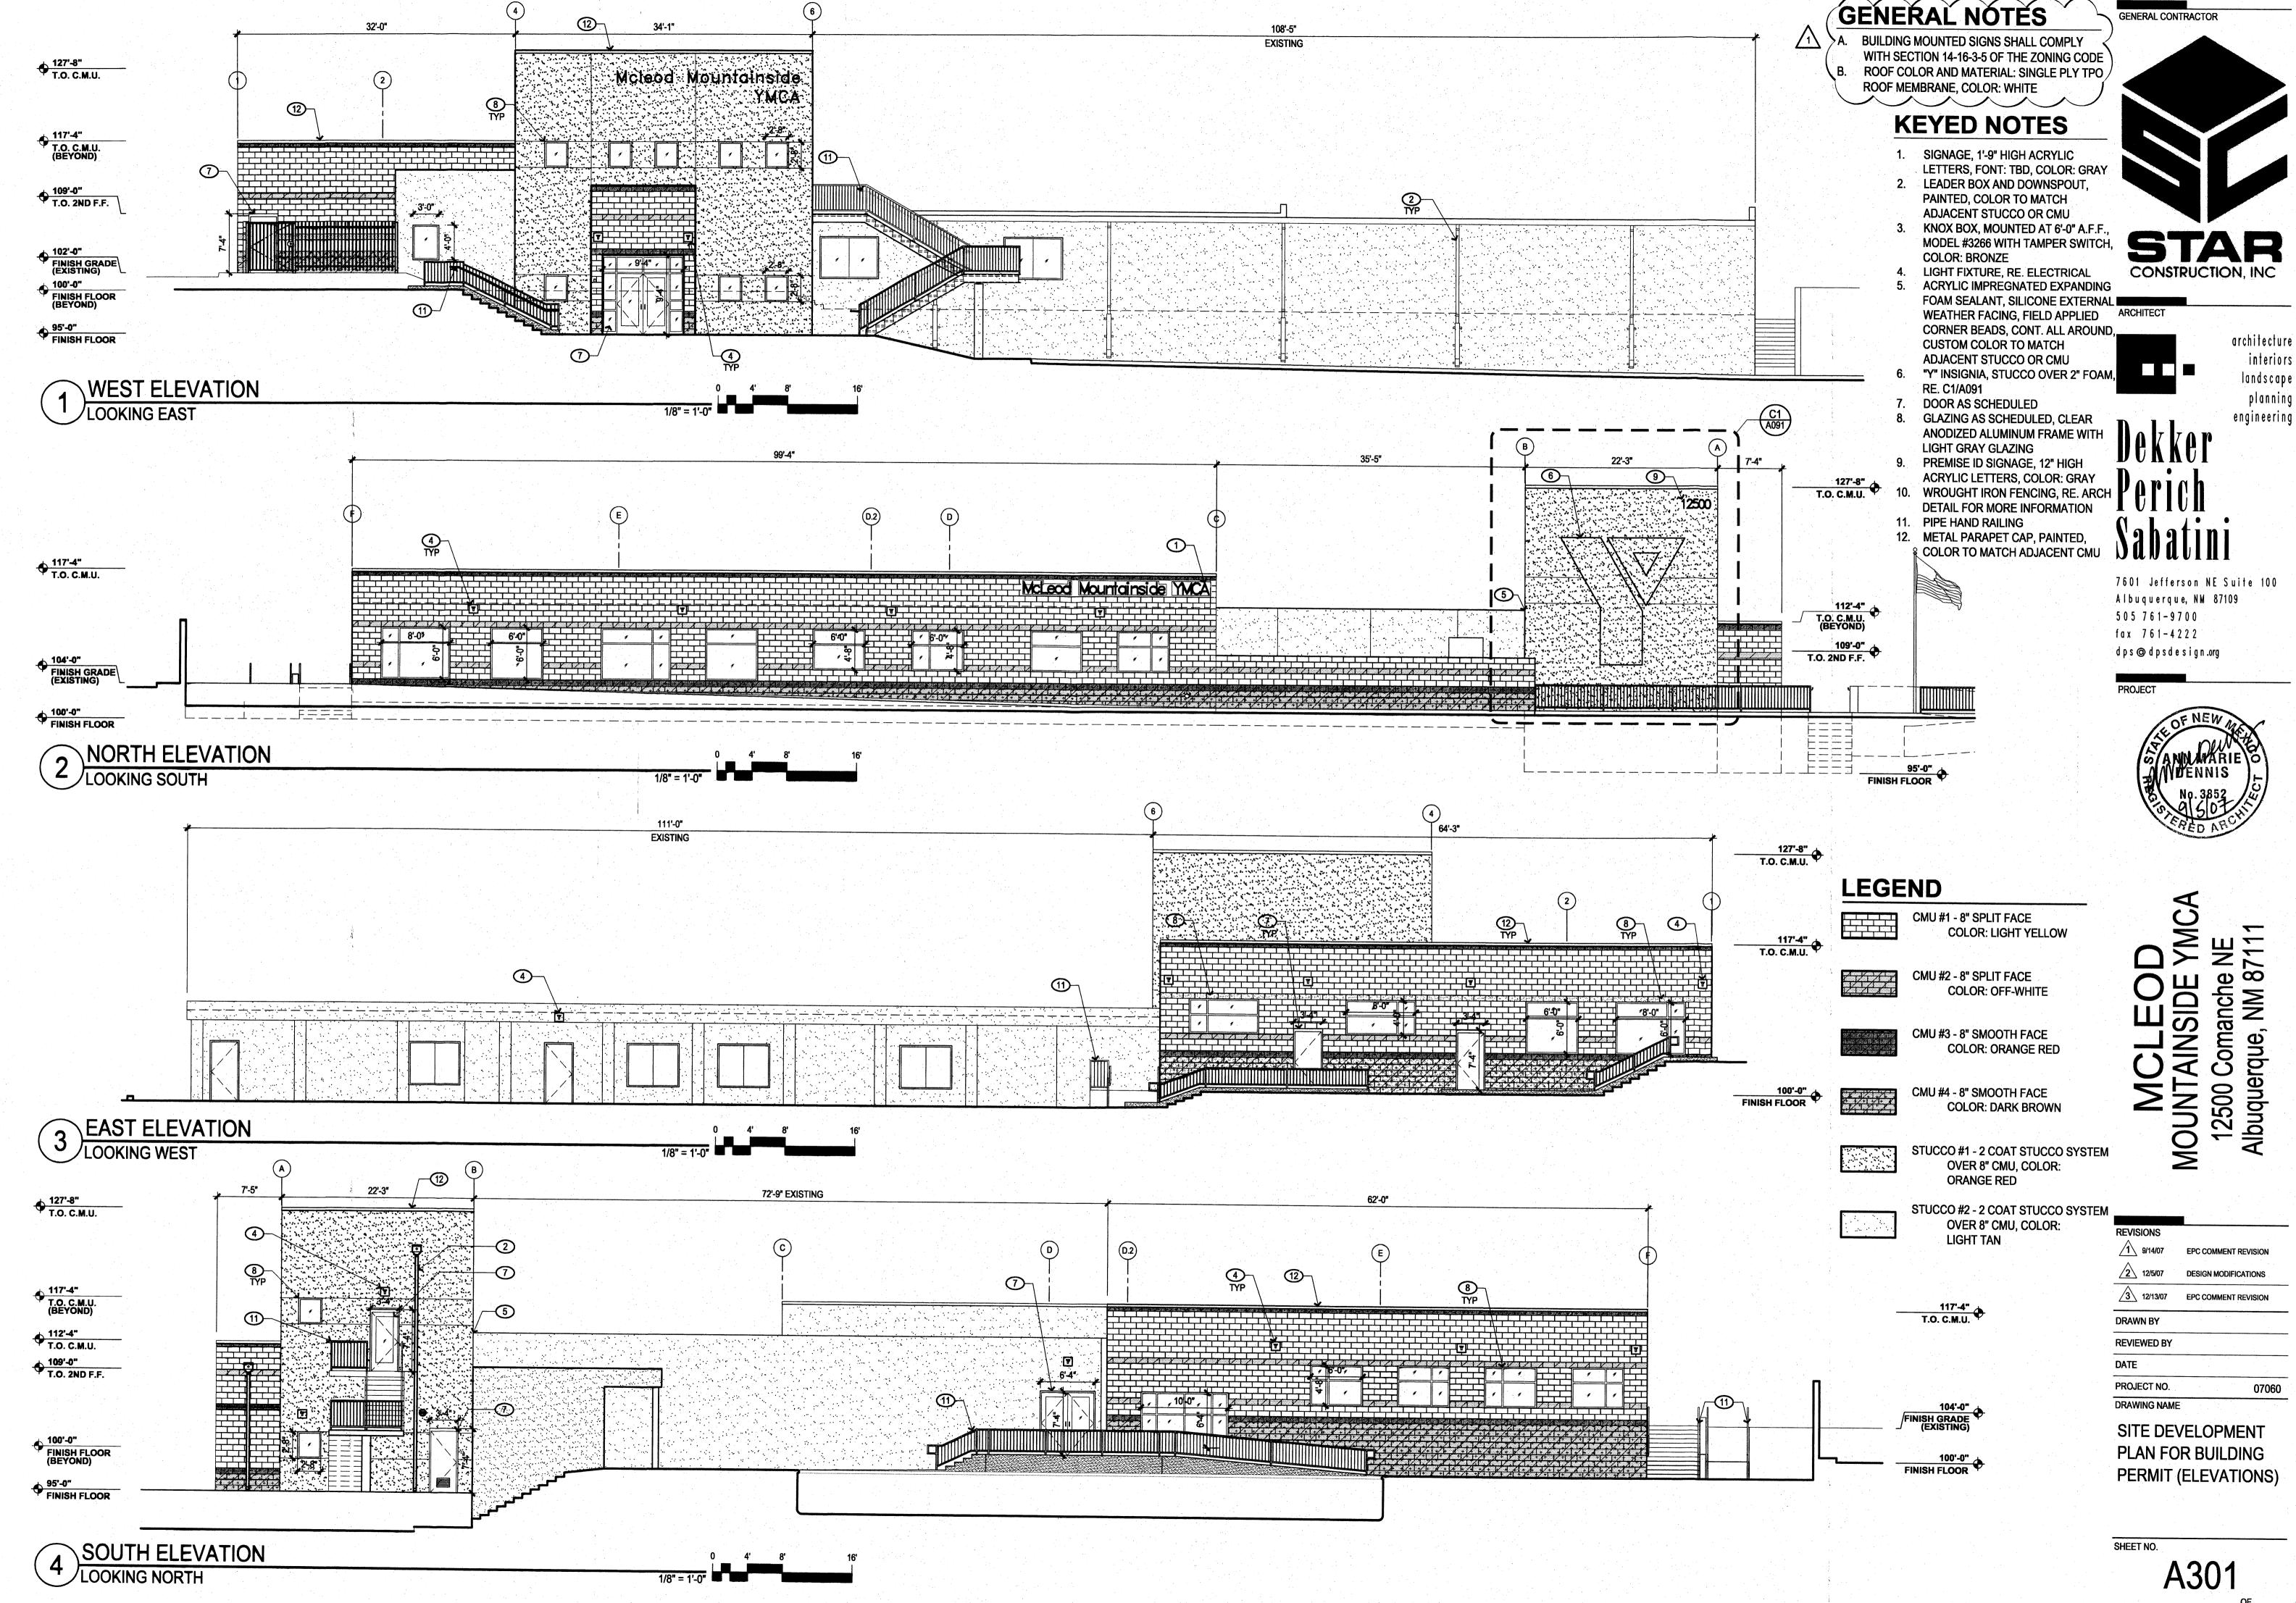


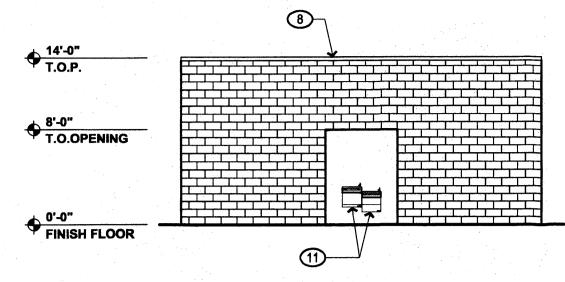

WEST ELEVATION - CABANA LOOKING EAST 1/8" = 1'-0"

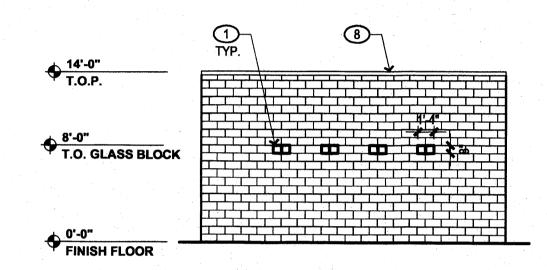


NORTH ELEVATION - CABANA LOOKING SOUTH 1/8" = 1'-0"

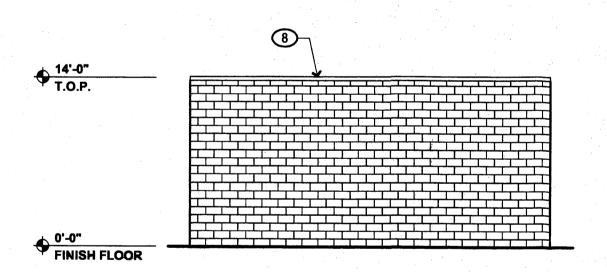


1/8" = 1'-0"

1/8" = 1'-0"

EAST ELEVATION - CABANA LOOKING WEST

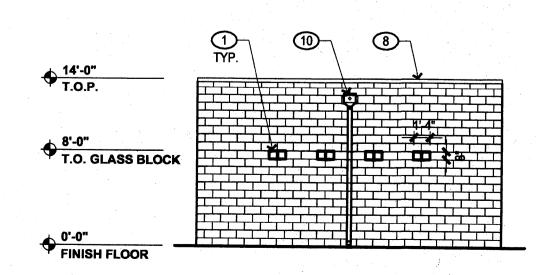

SOUTH ELEVATION - CABANA LOOKING NORTH

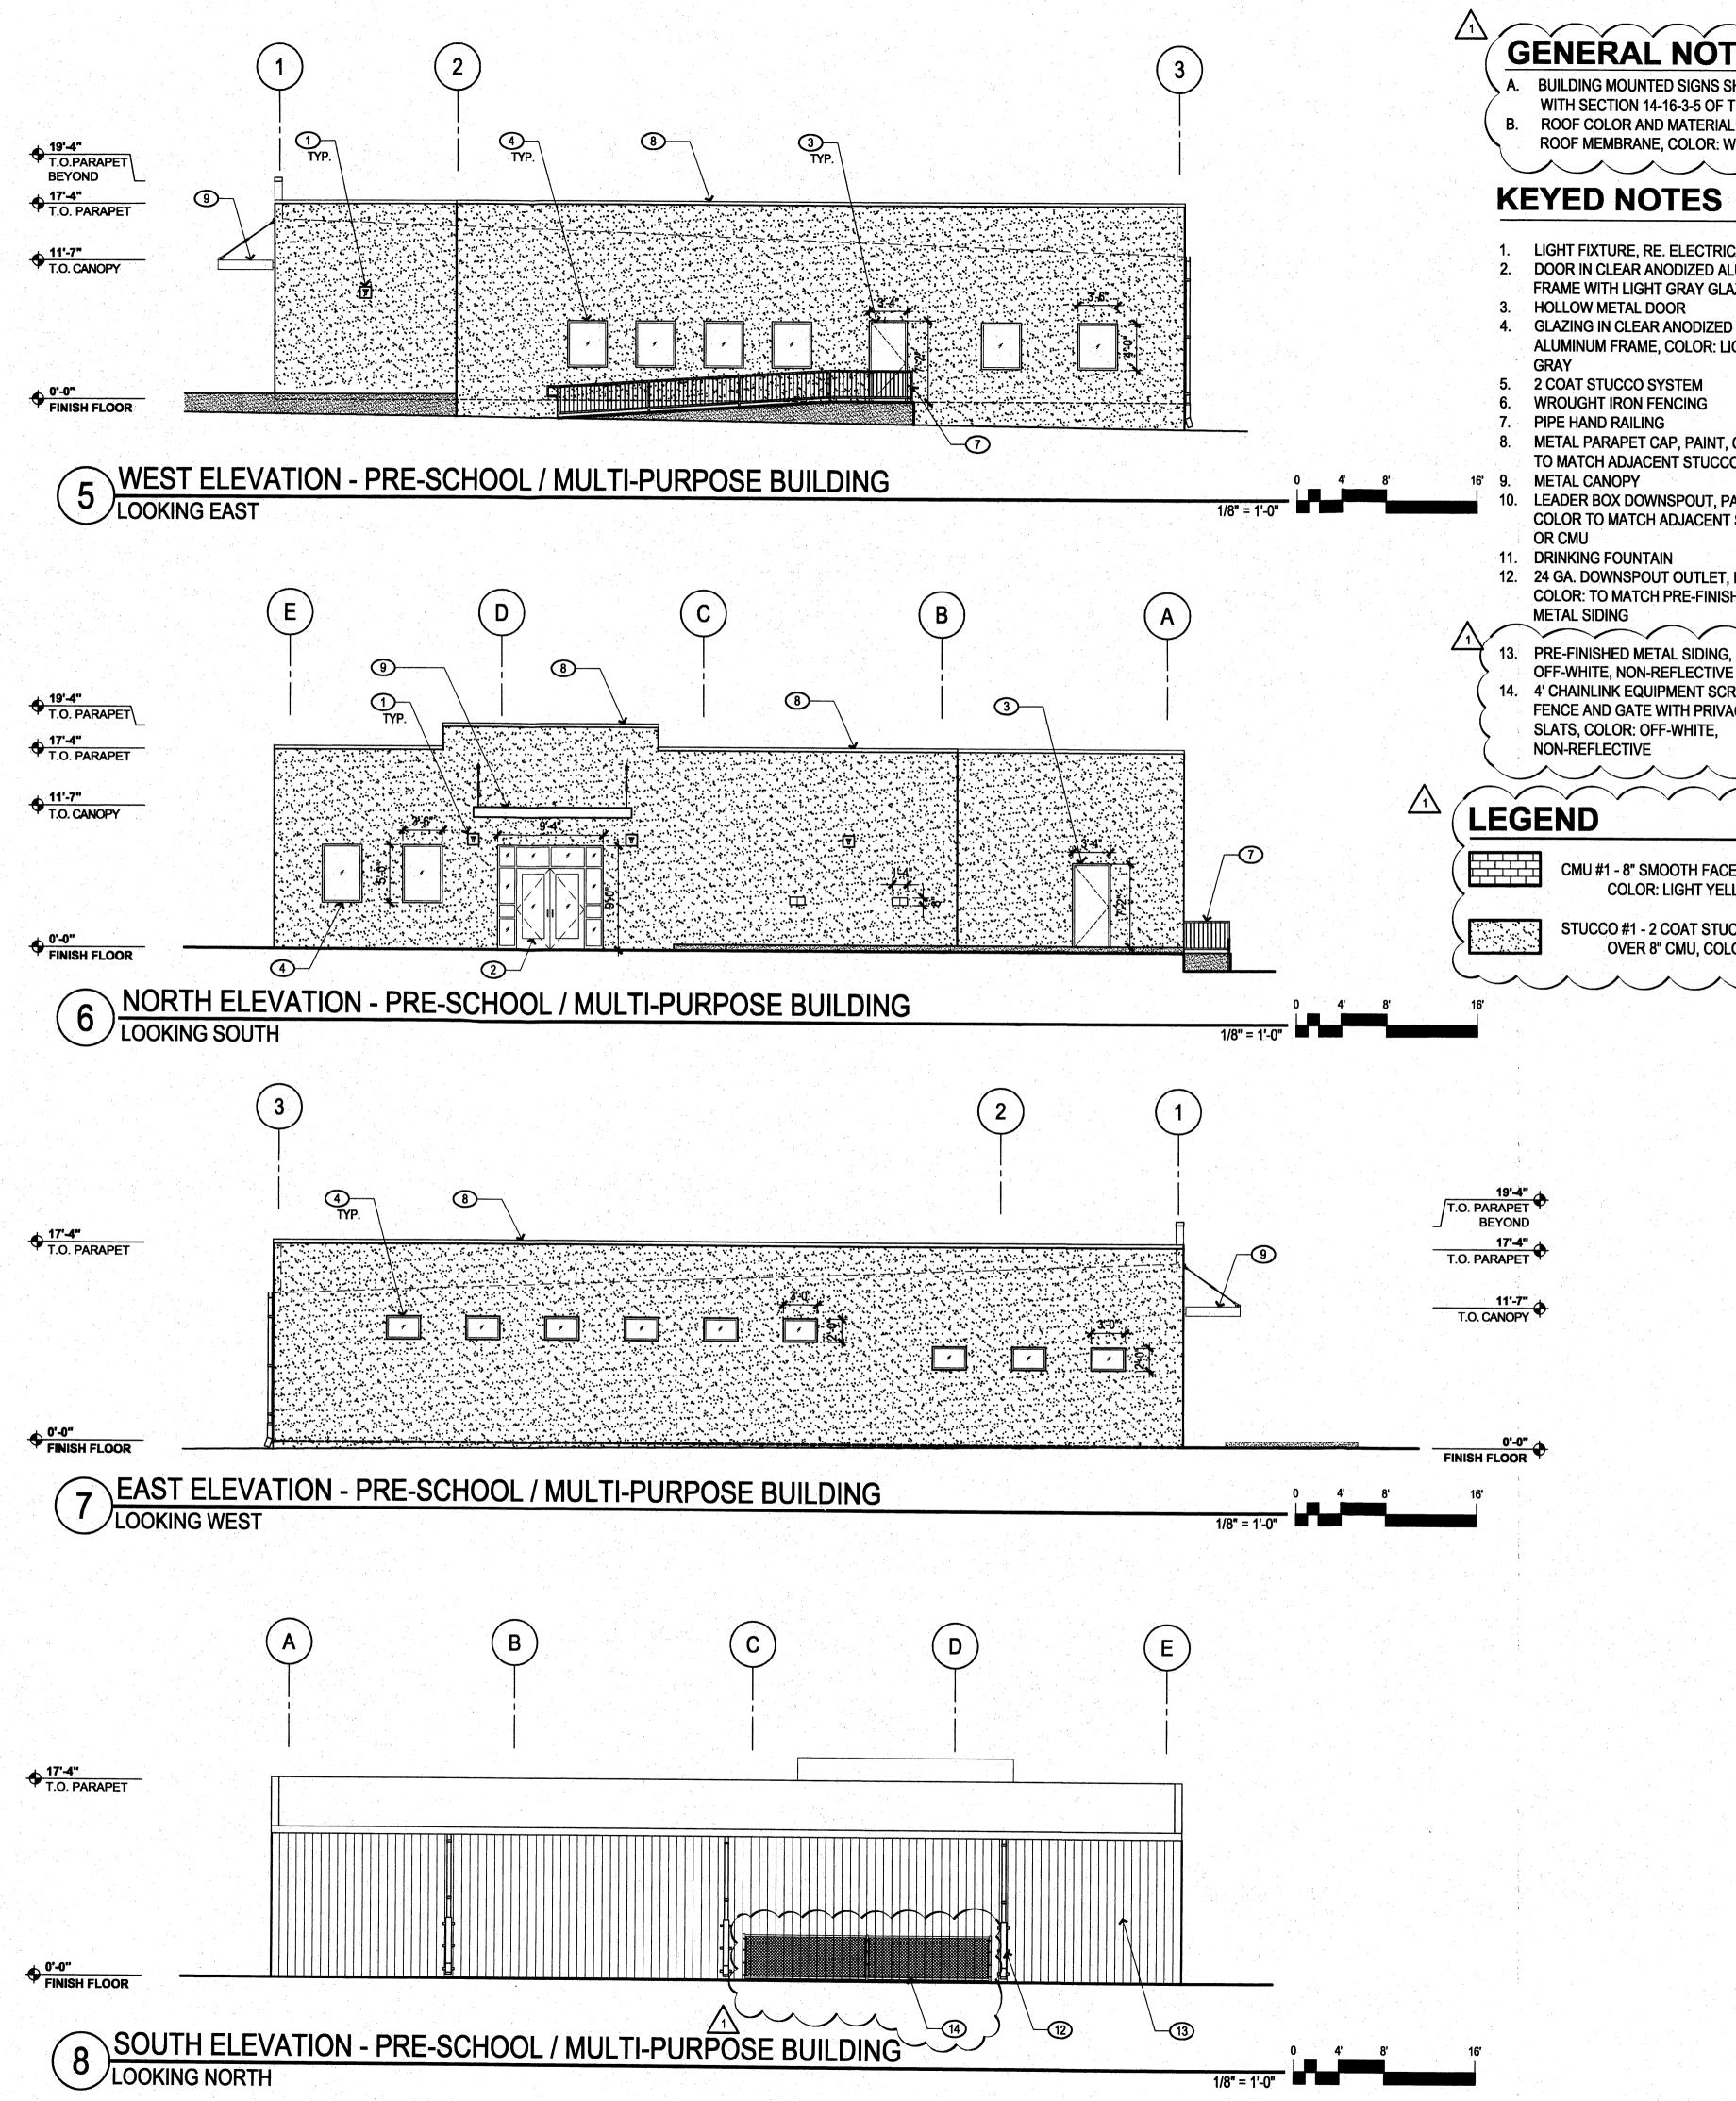

GENERAL NOTES

A. BUILDING MOUNTED SIGNS SHALL COMPLY WITH SECTION 14-16-3-5 OF THE ZONING CODE B. ROOF COLOR AND MATERIAL: SINGLE PLY TPO ROOF MEMBRANE, COLOR: WHITE

KEYED NOTES

- LIGHT FIXTURE, RE. ELECTRICAL DOOR IN CLEAR ANODIZED ALUMINUM FRAME WITH LIGHT GRAY GLAZING
- **ALUMINUM FRAME, COLOR: LIGHT**
- 2 COAT STUCCO SYSTEM
- WROUGHT IRON FENCING
- METAL PARAPET CAP, PAINT, COLOR: TO MATCH ADJACENT STUCCO OR CMU
- LEADER BOX DOWNSPOUT, PAINTED, COLOR TO MATCH ADJACENT STUCCO
- 12. 24 GA. DOWNSPOUT OUTLET, PAINT, COLOR: TO MATCH PRE-FINISHED
- PRE-FINISHED METAL SIDING, COLOR: OFF-WHITE, NON-REFLECTIVE
- 14. 4' CHAINLINK EQUIPMENT SCREEN FENCE AND GATE WITH PRIVACY SLATS, COLOR: OFF-WHITE, NON-REFLECTIVE

CMU #1 - 8" SMOOTH FACE **COLOR: LIGHT YELLOW**

STUCCO #1 - 2 COAT STUCCO SYSTEM
OVER 8" CMU, COLOR: ORANGE RED

PROJECT

7601 Jefferson NE Suite 100

Albuquerque, NM 87109

505761-9700

fax 761-4222

dps @ dpsdesign.org

GENERAL CONTRACTOR

ARCHITECT

architecture

interiors

landscape

planning

engineering


MCLEOD
MOUNTAINSIDE YM
12500 Comanche NE
Albuquerque, NM 87111


12/13/07	EPC COMMENT REVISION
DRAWN BY	
REVIEWED BY	
DATE	12/5/0
PROJECT NO.	0706
DRAWING NAME	

PLAN FOR BUILDING PERMIT (ELEVATIONS)

SHEET NO.

A302

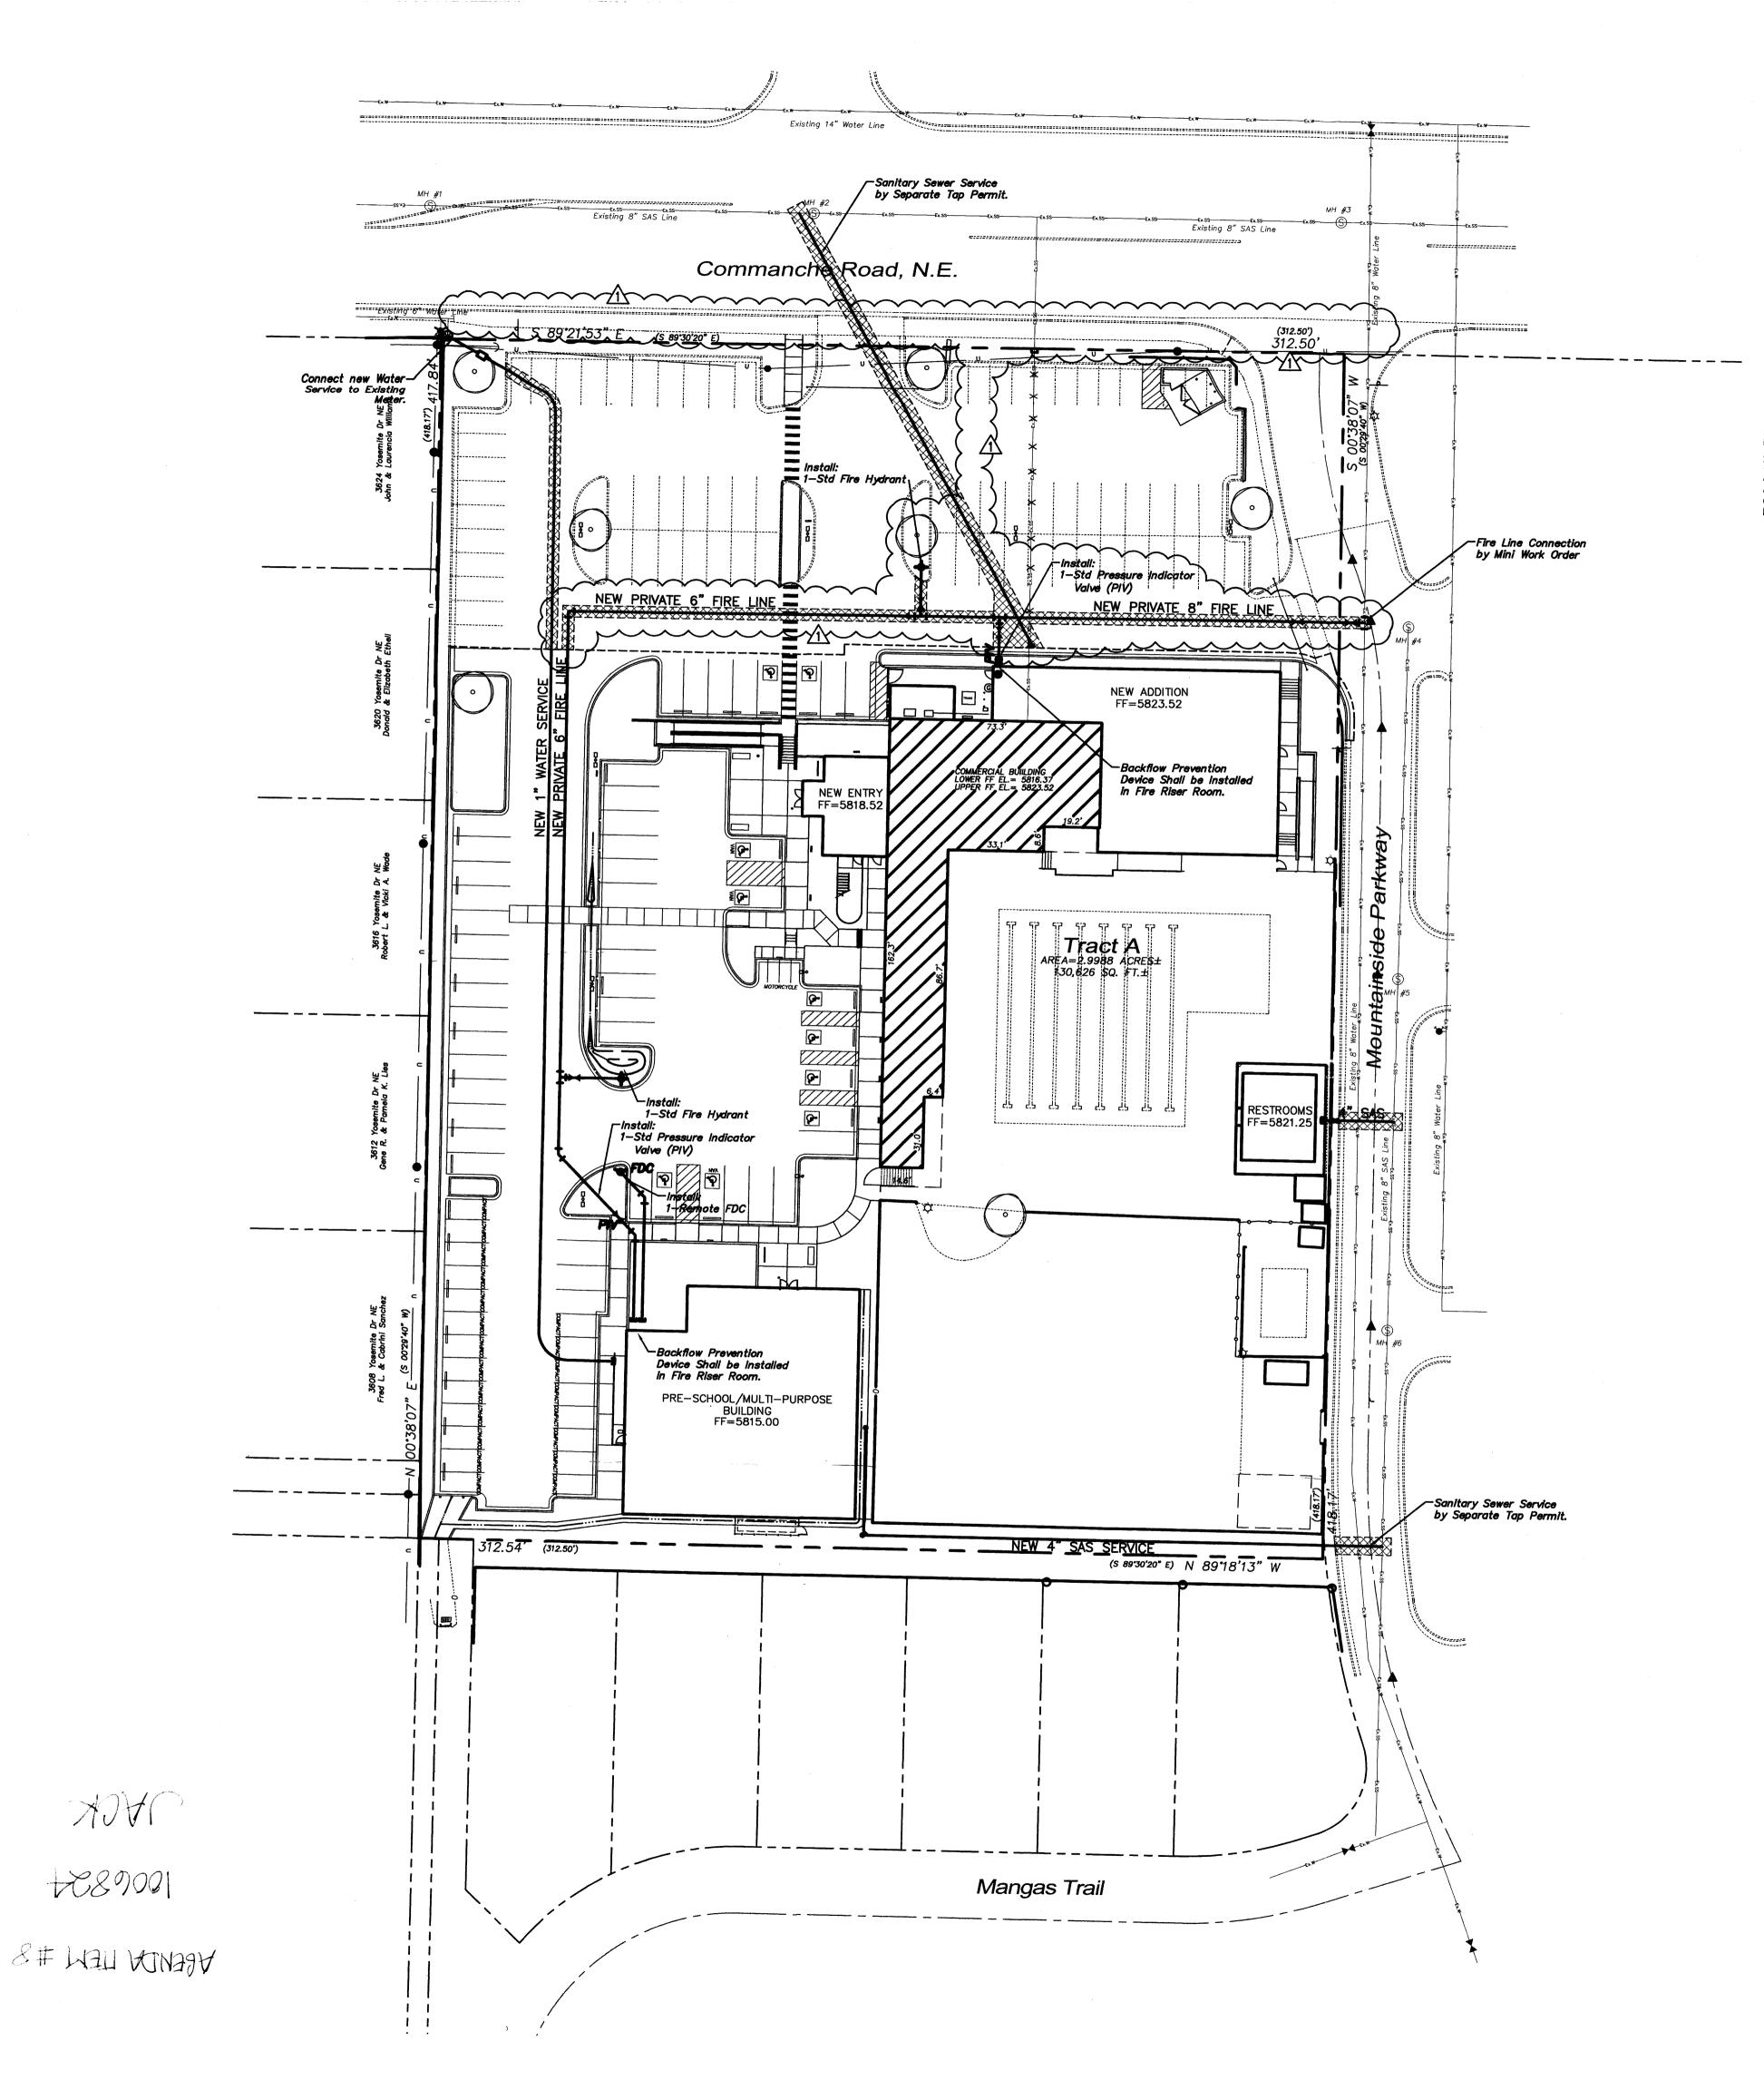

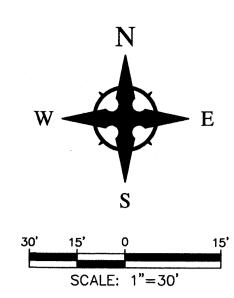

CAUTION - NOTICE TO CONTRACTOR

THE CONTRACTOR IS SPECIFICALLY CAUTIONED THAT THE LOCATION AND/OR ELEVATION OF EXISTING UTILITIES AS SHOWN ON THESE PLANS IS BASED ON RECORDS OF THE VARIOUS UTILITY COMPANIES AND, WHERE POSSIBLE, MEASUREMENTS TAKEN IN THE FIELD. THE INFORMATION IS NOT TO BE RELIED ON AS BEING EXACT OR COMPLETE. THE CONTRACTOR MUST CALL THE APPROPRIATE UTILITY COMPANY AT LEAST 48 HOURS BEFORE ANY EXCAVATION TO REQUEST EXACT FIELD LOCATION OF UTILITIES. IT SHALL BE THE RESPONSIBILITY OF THE CONTRACTOR TO RELOCATE ALL EXISTING UTILITIES WHICH CONFLICT WITH THE PROPOSED IMPROVEMENTS SHOWN ON THE PLANS.

UTILITY NOTES

1. THE CONTRACTOR SHALL BE RESPONSIBLE FOR THE COMPLETE INSTALLATION OF ALL WORK RELATED TO MECHANICAL UTILITIES AS SHOWN ON THIS PLAN INCLUDING: TRENCHING, BACKFILL, SUPPORTS, CLEANOUT PADS, SERVICE STOPS AND BOXES, SERVICE LINES, TESTING, CLEANING, AND STERILIZING. ANY WORK NOT ACCEPTED BY THE ARCHITECT OR ENGINEER DUE TO IMPROPER WORKMANSHIP OR LACK OF PROPER COORDINATION SHALL BE REMOVED AND CORRECTLY INSTALLED AT THE CONTRACTOR'S EXPENSE, AS DIRECTED.

2. MINIMUM DEPTHS OF COVER SHALL BE: 36" FOR WATERLINES AND 48" FOR SEWER, EXCEPT AT BUILDING CONNECTION.

3. ALL WORK DETAILED ON THESE PLANS TO BE PERFORMED UNDER CONTRACT SHALL, EXCEPT AS OTHERWISE STATED OR PROVIDED OF HEREON, BE CONSTRUCTED IN ACCORDANCE WITH THE IAPMO UNIFORM PLUMBING CODE, LATEST EDITION.

4. UTILITY LINES SHALL BE INSTALLED PRIOR TO PAVEMENT, CURB AND CUTTER, AND/OR SIDEWALK, AS APPLICABLE.

5. ROUGH GRADING OF SITE (±0.5") SHALL BE COMPLETED PRIOR TO INSTALLATION OF UTILITY LINES.

6. CONTRACTOR WILL BE RESPONSIBLE FOR CONNECTIONS TO BUILDING DRAIN LINES AND ALL NECESSARY FITTINGS.


7. ALL VALVES SHALL BE ANCHORED PER COA STANDARD DWG. 2333.

8. FIRE LINES SHALL USE PIPE MATERIALS UNDERWRITERS LABORATORIES LISTED AND APPROVED FOR FIRE SERVICE.


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10. CONTRACTOR SHALL VERIFY INVERTS AND LOCATIONS OF EXISTING WATER/SAS LINES PRIOR TO BEGINNING WORK. ALL CONFLICTS SHALL BE BROUGHT TO ATTENTION OF THE ENGINEER AND RESOLVED PRIOR TO BEGINNING WARDS.

11. CONTRACTOR SHALL PREPARE ALL SUBMITTAL MATERIALS & PAY APPLICABLE FEES REQUIRED TO OBTAIN THE "MINI WORK ORDER" REQUIRED FOR CONNECTION TO THE EXISTING CITY WATER MAIN AND OTHER 'PUBLIC' WATER LINE CONSTRUCTION.

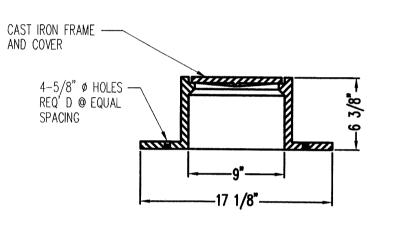


CLEANOUT
FRAME & COVER
N.T.S.

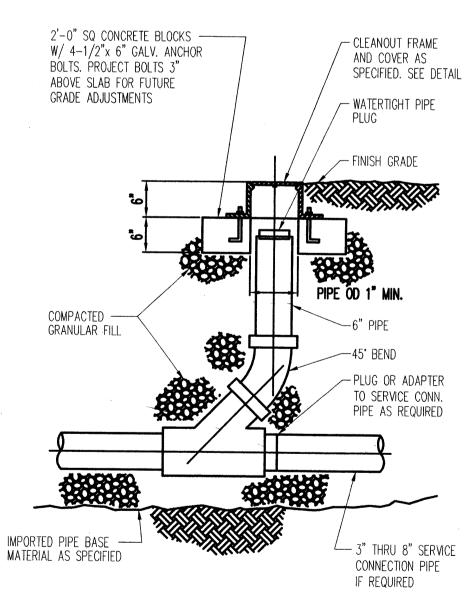

CLEANOUT DETAIL

Wooten Engineering

5017 Sanbusco Dr NE, Rio Rancho, NM 87144
Ph: 505.771.4200 Fax: 505.771.8905

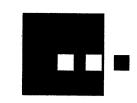

interiors landscape planning engineering

architecture

Dekker Perich Sabatini

7601 Jefferson NE Suite 100 Albuquerque, NM 87109 505 761-9700 fax 761-4222 dps @dpsdesign.org

ARCHITECT

ENGINEER

NOT FOR CONSTRUCTION

PROJECT

CLECU FAINSIDE YMCA O Comanche NE lerque, NM 87111

REVISIONS

1. REVISE FIRE LINES TO BE PRIVATE.

AWN BY

DRAWN BY

REVIEWED BY

DATE

09/06/07

PROJECT NO.


07060

UTILITY PLAN

DRAWING NAME

OUETA

. _C002

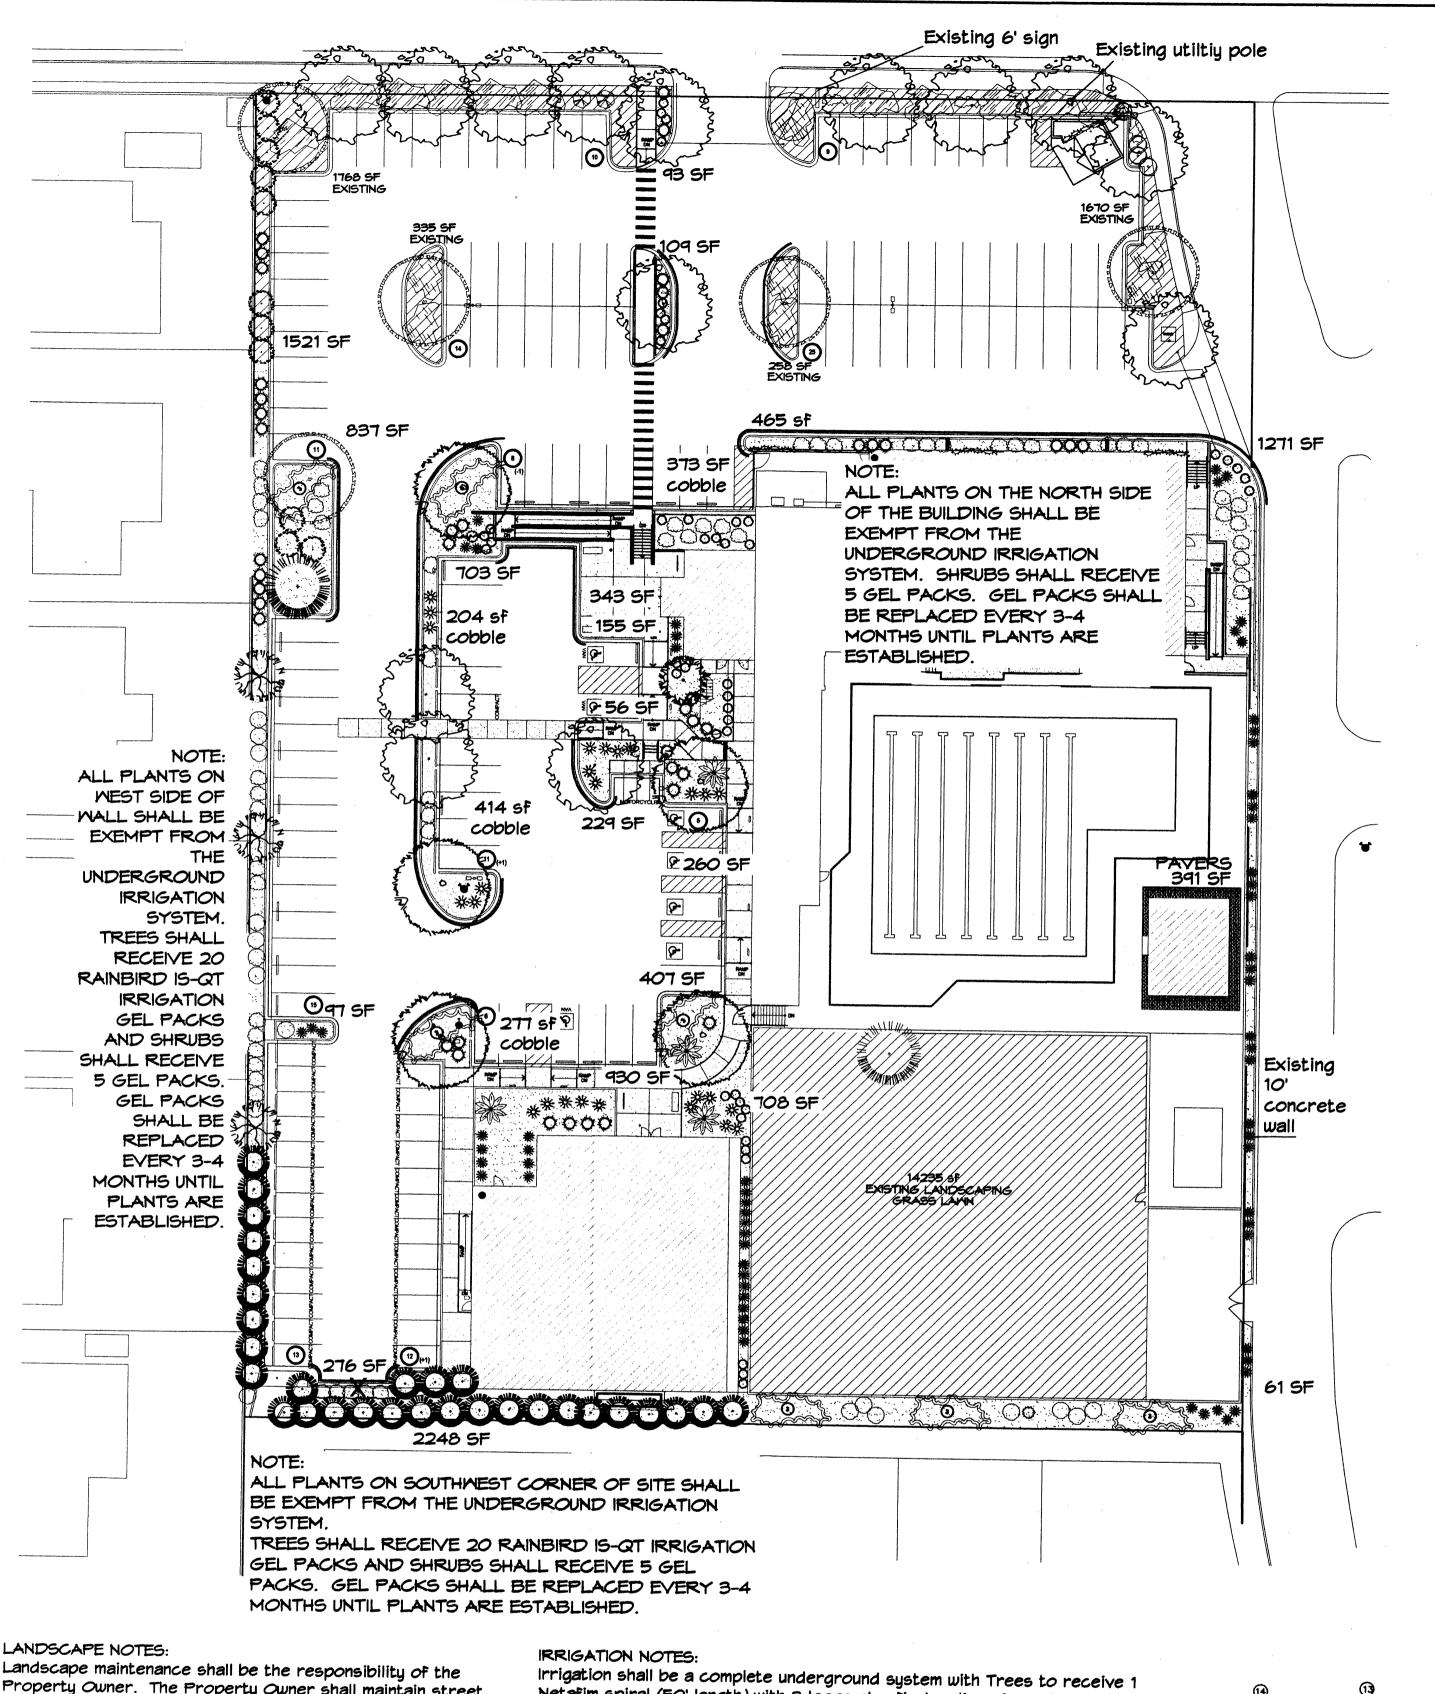

Landscape maintenance shall be the responsibility of the Property Owner. The Property Owner shall maintain street trees in a living, healthy, and attractive condition.

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Mater management is the sole responsibility of the Property Owner. All landscaping will be in conformance with the City of Albuquerque Zoning Code, Street Tree Ordinance, Pollen Ordinance, and Water Conservation Landscaping and Water Waste Ordinance. In general, water conservative, environmentally sound landscape principles will be followed in design and installation.

Plant beds shall achieve 75% live ground cover at maturity including both existing and new landscape areas.

3/4" Crushed Grey Gravel over Filter Fabric to a minimum depth of 3" shall be placed in all landscape areas which are not designated to receive native seed.

Netafim spiral (50' length) with 3 loops at a final radius of 4.5' from tree trunk, pinned in place. Netafim shall have emitters 12" o.c. with a flow of .6 gph. Shrubs to receive (2) 1.0 GPH Drip Emitters. Drip and Bubbler systems to be tied to 1/2" polypipe with flush caps at each end. Trees and shrubs shall be on separate valves.

Run time per each shrub drip valve will be approximately 15 minutes per day. Tree drip valve shall run 1.5 hours, 3 times per week. Run time will be adjusted according to the season.

Point of connection for irrigation system is unknown at current time and will be coordinated in the field. Irrigation will be operated by automatic

Location of controller to be field determined and power source for controller to be provided by others.

Irrigation maintenance shall be the responsibility of the Property Owner.

Mater and Power source shall be the responsibility of the Developer/Builder.

PLANT PALETTE

CHINESE PISTACHE (M) 14 Pistacia chinensis 2" Cal.

SHUMARD OAK (M) 5 Quercus shumardii

* AUSTRIAN PINE (M) 1 Pinus nigra

> NEW MEXICO OLIVE (L) 3 Forestiera neomexicana 15 Gal. 225 sf AMUR MAPLE (M) 1

Acer ainnala Multi-trunk B&B (2" Cal.) * CURLLEAF MTN MAHOGANY(L+) 30

Cercocarpus ledifolius

DESERT ACCENTS

* BLUE SOTOL (L) 2 Dasulirion wheeleri 5 Gal. 9sf

5 Gal. 225 sf

HARDSCAPES

3/4" GRAY GRAVEL WITH FILTER FABRIC TO A MINIMUM DEPTH OF 3"

COBBLE WITH FILTER FABRIC TO A MINIMUM DEPTH OF 3"

* DENOTES EVERGREEN MATERIAL

EXISTING

EXISTING LANDSCAPING TO REMAIN

PAVERS

SHRUBS/ORNAMENTAL GRASSES FIVE GAL.

MOCK ORANGE (M) 4 Philadelphus cultivars 5 Gal. 100sf

* PHOTINIA (M+) 11 Photinia fraseri 5 Gal. 64sf

> * APACHE PLUME (L) 17 Falluqia paradoxa 5 Gal. 25sf

* LENA'S BROOM (M) 42 Cytisus scoparius 5 Gal. 16sf

ONE GAL

* PONIS CASTLE SAGE (L+) 54 Artemisia X Powis Castle 1 Gal. 25sf

DEER GRASS (M) 26 Muhlenbergia rigens 1 Gal. 165f

CATMINT (M) 45 Nepeta mussini 1 Gal. 4sf

BLUE AVENA/OAT GRASS (M) 67 Helictotrichon sempervirens

GROUNDCOVERS

GREYLEAF COTONEASTER (M) 21 Cotoneaster buxifolius Sumbol indicates 3 plants

ENGLISH MY (M) 4 Hedera helix

PLANT PALETTE

ASH (M) 5 Fraxinus spp.

> FLOWERING PEAR (M+) 1 Pyrus calleryana



RUSSIAN SAGE (M) 4 Perovskia atriplicifolia INDIAN HAWTHORN (M) 2

Raphiolepis indica

BLUE CHIP JUNIPER (L+) 3 Juniperus horizontalis 'Blue Chip'

TAM JUNIPER (L+) 18 Juniperus sabina 'Tamariscifolia'

Tree Trunk Root Ball Emitter-12" o.c.

Netafim Spiral Detail

SHRUB PLANTING DETAIL NTS

GENERAL NOTES:

1. THE OUTSIDE DIAMETER OF THE WATER RETENTION BASIN SHALL BE TWICE THE DIAMETER OF THE SHRUB PLANTING PIT.

CONSTRUCTION NOTES:

A. SHRUB.

WIRE EXPANSION LOOPS

GALVANIZED STREET ELL

GALVANIZED NIPPLE - 18" TO 24" LENGTH

ATMOSPHERIC VACUUM BREAKER

TOE NIPPLE OR MALE ADAPTER

VALVE BOX

AUTOMATIC VALVE W/ ATMOSPHERIC

FINISH GRADE

MAINLINE FITTING

GALVANIZED NIPPLE

REDUCER BUSHING

) GALVANIZED NIPPLE

O) GALVANIZED ELBOW

24" TO 36" GALVANIZED NIPPLE

AUTOMATIC VALVE (SEE LEGEND)

VACUUM BREAKER

CMU BLOCK

LATERAL PIPE

B. BACKFILL WITH EXISTING SOIL.

C. EARTH BERM AROUND WATER RETENTION BASIN. D. 3" DEPTH OF GRAVEL MULCH.

E. FINISH GRADE.

F. UNDISTURBED SOIL.

LANDSCAPE CALCULATIONS

TOTAL LOT AREA	130416	- square feet
TOTAL BUILDINGS AREA	18605	square feet
NET LOT AREA	111811	square feet
LANDSCAPE REQUIREMENT	15%	•
REQUIRED LANDSCAPE	16772	square feet
REQUIRED GROUNDCOVER COVERAGE	12579	square feet
TOTAL GROUNDCOVER PROVIDED	14959	square feet
PROVIDED LANDSCAPING (NEW	30229	square feet
EXISTING SOD	14235 (47%)) square feet
(max. 20% of landscape required)		•

NEW LANDSCAPING LANDSCAPE BED PROVIDED 12037 square feet REQUIRED GROUNDCOVER PERCENT 75% square feet REQUIRED GROUNDCOVERAGE 9027 square feet GROUNDCOVER PROVIDED 9085 (75%) square feet

PAVERS 391 square feet

EXISTING LANDSCAPING	a.	
LANDSCAPE BED PROVIDED	4031	square feet
REQUIRED GROUNDCOVER PERCENT_	75%	square feet
REQUIRED GROUNDCOVERAGE	3023	square feet
GROUNDCOVER PROVIDED	3936 (95%)	square feet

PARKING LOT TREE REQUIREMENTS

Shade trees required under the City Of Albuquerque Parking Lot Tree Ordinance are as follows:

1 Shade tree per 10 spaces Required # 15 Existing # 5 Provided # 10

STREET TREE REQUIREMENTS

Street trees required under the City Of Albuquerque Street Tree Ordinance are as follows:

Name of Street: Comanche Required # 9 Existing # 2 Provided # 7

Name of Street: Mountainside Parkway parking Required #3 Existing #1 Provided #2

NOTE TO CLIENT:

Should The Hilltop not receive a Grading and Drainage plan during the design process or the on-site grades differ from the Grading and Drainage plan received, The Hilltop reserves the right to apply slope stabilization materials where the specified gravel will not be suitable. Gravel smaller than 2-4" cobblestone will not stay on a slope greater than 3:1. If the grades are greater than what was originally designed, we will request an infield change-order to lay cobblestone or rip-rap, in lieu of the specified gravel, to stabilize the slope. All vegetative material shall remain per plan.

TREE PLANTING DETAIL

GENERAL NOTES:

1. ROOTBALL SHALL BE PLACED ON UNDISTURBED SOIL TO PREVENT TREE FROM SETTLING.

2. TOP OF ROOTBALL INDICATED LEVEL AT WHICH TREE WAS GROWN AND DUG; THIS REPRESENTS THE LEVEL AT WHICH THE TREE SHOULD BE INSTALLED; THAT LEVEL MAY Fax (505) 898-7737 BE EXCEEDED BY ONLY A ONE INCH LAYER OF SOIL. 3. PRIOR TO BACKFILLLING TREE, ALL MIRE, ROPE AND SYNTHETIC MATERIALS SHALL BE REMOVED FROM THE

TREE AND THE PLANTING PIT. 4. PRIOR TO BACKFILLING ALL BURLAP SHALL BE CUT AWAY EXCEPT FROM BOTTOM OF THE ROOTBALL.

CONSTRUCTION NOTES:

D. UNDISTRUBED SOIL.

A. TREE

B. BACKFILL WITH EXISTING SOIL. C. 3" DEPTH OF GRAVEL MULCH.


7909 Edith N.E. Albuquerque, NM 87184 (505) 898-9690 cm i@hilltoplandscaping.com

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ARCHITECT




interior

plannir

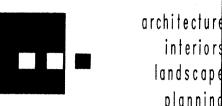engineerin

7601 Jefferson NE Suite 100 Albuquerque, NM 87109 505 761-9700 fax 761-4222

dps @ dpsdesign.org

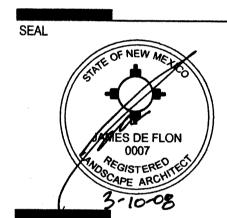

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REVISIONS 10 3-10-08 Site Revision - cmi DRAWN BY


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REVIEWED BY 8/23/07 PROJECT NO.

DRAWING NAME

SHEET NO.



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DESERT ACCENTS
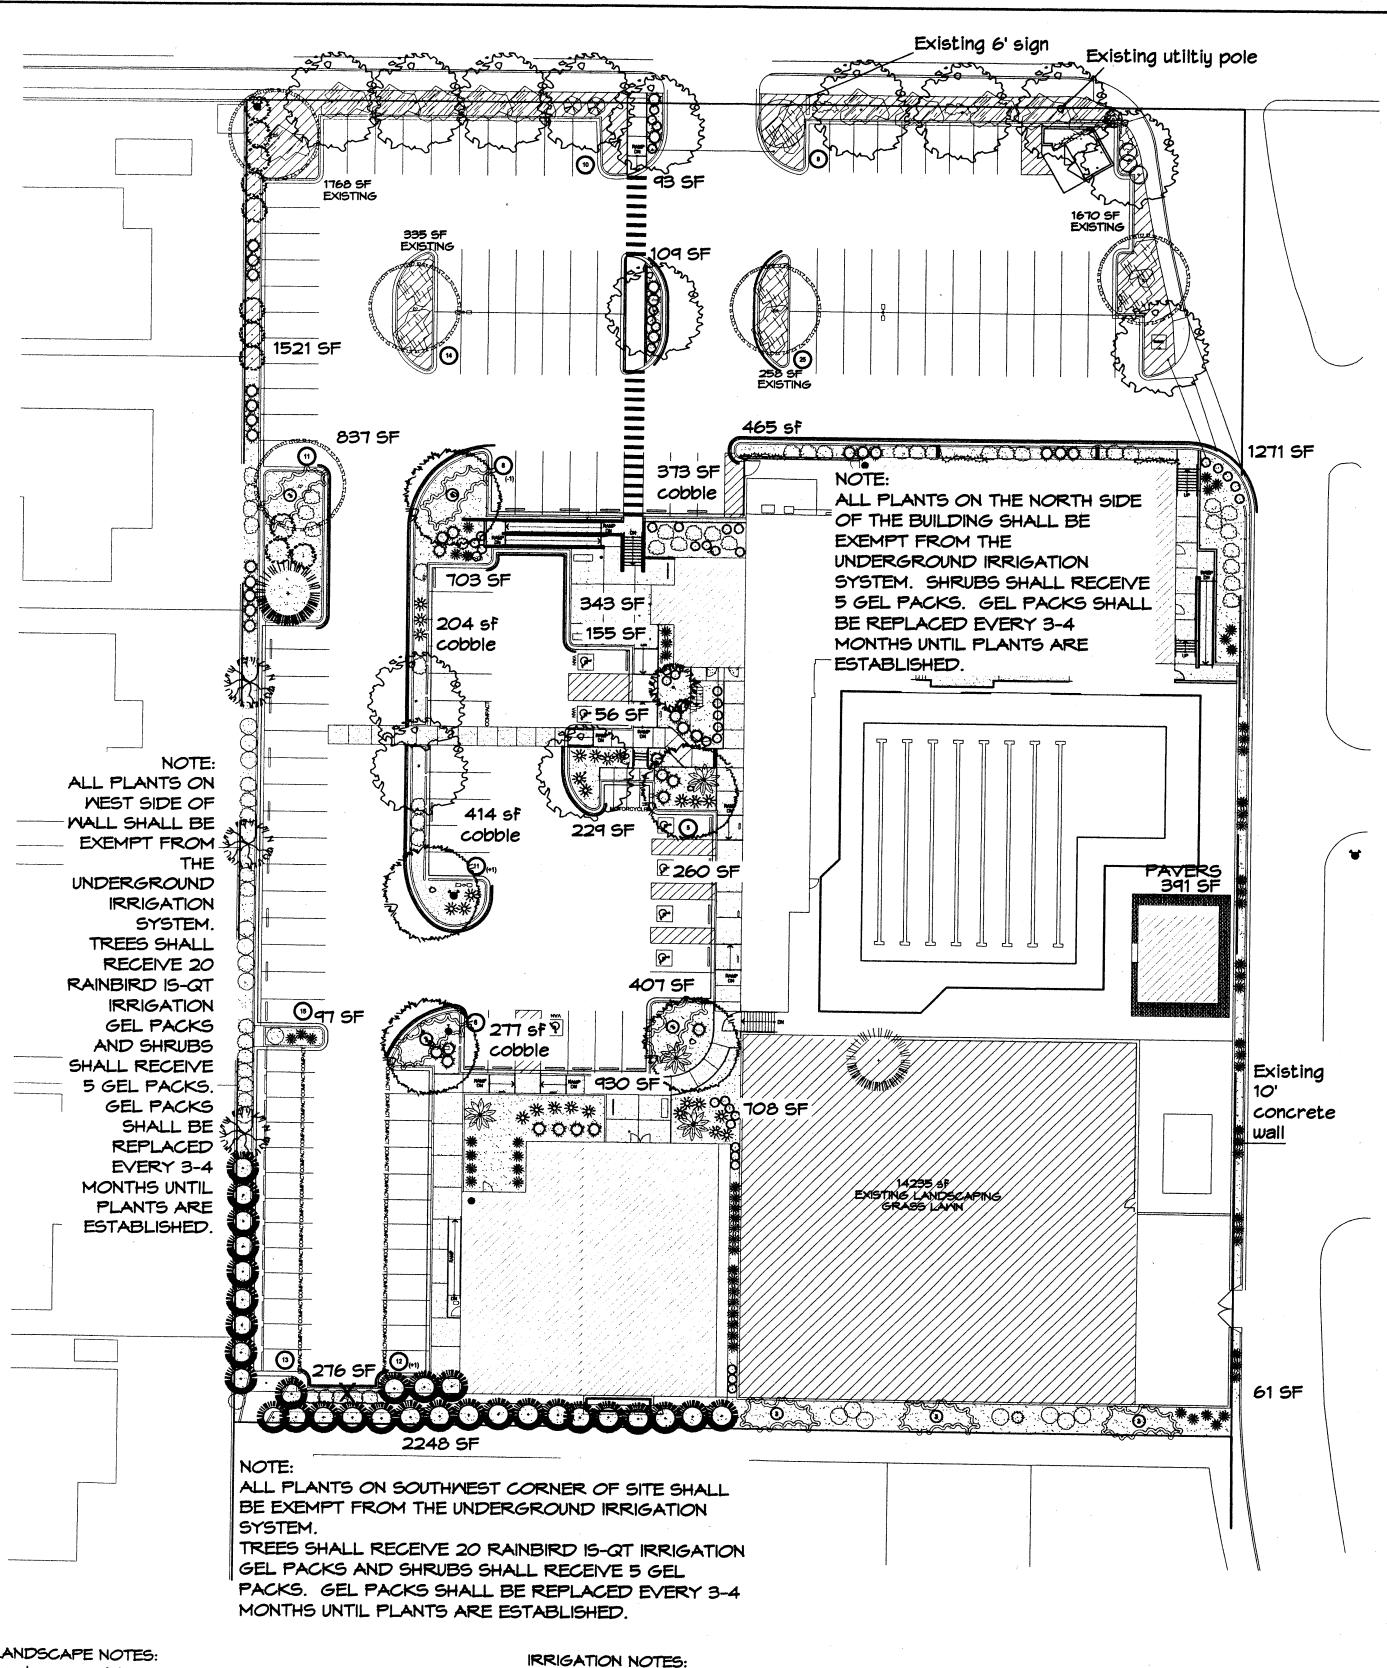
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GROUNDCOVERS

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ENGLISH IVY (M) 4 Hedera helix 1 Gal.

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PAVERS

PLANT PALETTE EXISTING

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FLOWERING PEAR (M+) 1 Pyrus calleryana

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Raphiolepis indica

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Tree Trunk Root Ball Emitter-12" o.c.

Netafim Spiral Detai

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A. TREE B. BACKFILL WITH EXISTING SOIL C. 3" DEPTH OF GRAVEL MULCH.

D. UNDISTRUBED SOIL.



LANDSCAPE CALCULATIONS

REQUIRED GROUNDCOVER COVERAGE 12579

18605

square feet

9085 (75%) square feet

3936 (95%) square feet

111811

15%

16772

14959

12037

75%

9027

391

4031

75%

Shade trees required under the City Of Albuquerque

Street trees required under the City Of Albuquerque

PARKING LOT TREE REQUIREMENTS

1 Shade tree per 10 spaces

STREET TREE REQUIREMENTS

Name of Street: Comanche

NOTE TO CLIENT:

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Required # 9 Existing # 2 Provided # 7

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of the specified gravel, to stabilize the slope. All

vegetative material shall remain per plan.

change-order to lay cobblestone or rip-rap, in lieu

Name of Street: Mountainside Parkway parking

Parking Lot Tree Ordinance are as Follows:

Required # 15 Existing # 5 Provided # 10

3023

30229

TOTAL LOT AREA

NET LOT AREA

TOTAL BUILDINGS AREA

REQUIRED LANDSCAPE

AND EXISTING)

NEW LANDSCAPING

EXISTING SOD

PAVERS

LANDSCAPE REQUIREMENT

TOTAL GROUNDCOVER PROVIDED

PROVIDED LANDSCAPING (NEW

(max. 20% of landscape required)

REQUIRED GROUNDCOVER PERCENT

LANDSCAPE BED PROVIDED

REQUIRED GROUNDCOVERAGE

GROUNDCOVER PROVIDED

EXISTING LANDSCAPING

LANDSCAPE BED PROVIDED

REQUIRED GROUNDCOVERAGE


GROUNDCOVER PROVIDED

REQUIRED GROUNDCOVER PERCENT

Cont. Lic. #26458 7909 Edith N.E. Albuquerque, NM 87184 Ph. (505) 898-9690 Fax (505) 898-7737 cm i@hilltoplandscaping.com

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SCALE: 1"=30"

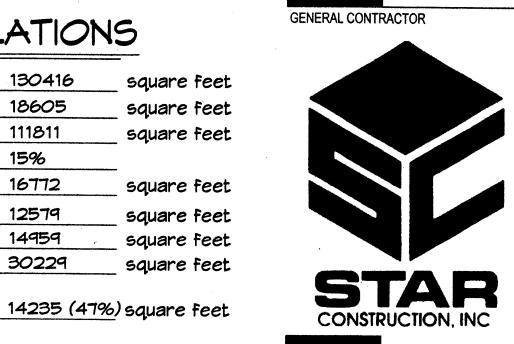

ARCHITECT




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7601 Jefferson NE Suite 100 Albuquerque, NM 87109 505 761-9700 fax 761-4222

dps@dpsdesign.org



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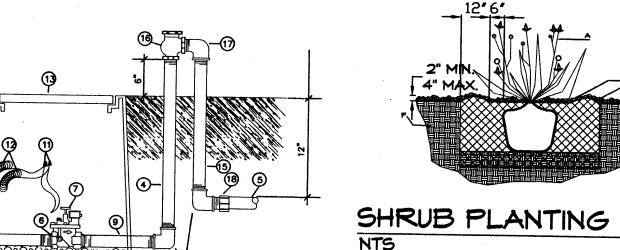
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REVISIONS Site Revision - cmj DRAWN BY **REVIEWED BY** 8/23/07 PROJECT NO. 07060

DATE DRAWING NAME

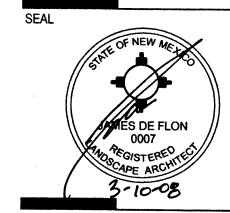SHEET NO.

L001



MAINLINE FITTING CMU BLOCK

GALVANIZED NIPPLE

LATERAL PIPE

GRAVEL

REDUCER BUSHING

GALVANIZED NIPPLE

24" TO 36" GALVANIZED NIPPLE

AUTOMATIC VALVE (SEE LEGEND)

WATERPROOF WIRE CONNECTOR WIRE EXPANSION LOOPS VALVE BOX FINISH GRADE ATMOSPHERIC VACUUM BREAKER GALVANIZED STREET ELL TOE NIPPLE OR MALE ADAPTER

GALVANIZED NIPPLE - 18" TO 24" LENGTI

AUTOMATIC VALVE W/ ATMOSPHERIC VACUUM BREAKER



SHRUB PLANTING DETAIL

GENERAL NOTES:

1. THE OUTSIDE DIAMETER OF THE WATER RETENTION BASIN SHALL BE TWICE THE DIAMETER OF THE SHRUB PLANTING PIT.

CONSTRUCTION NOTES:


A. SHRUB. B. BACKFILL WITH EXISTING SOIL. C. EARTH BERM AROUND WATER RETENTION BASIN. D. 3" DEPTH OF GRAVEL MULCH.

E. FINISH GRADE. F. UNDISTURBED SOIL.

TREE PLANTING DETAIL


BE EXCEEDED BY ONLY A ONE INCH LAYER OF SOIL. 3. PRIOR TO BACKFILLLING TREE, ALL WIRE, ROPE AND SYNTHETIC MATERIALS SHALL BE REMOVED FROM THE TREE AND THE PLANTING PIT.

CONSTRUCTION NOTES:

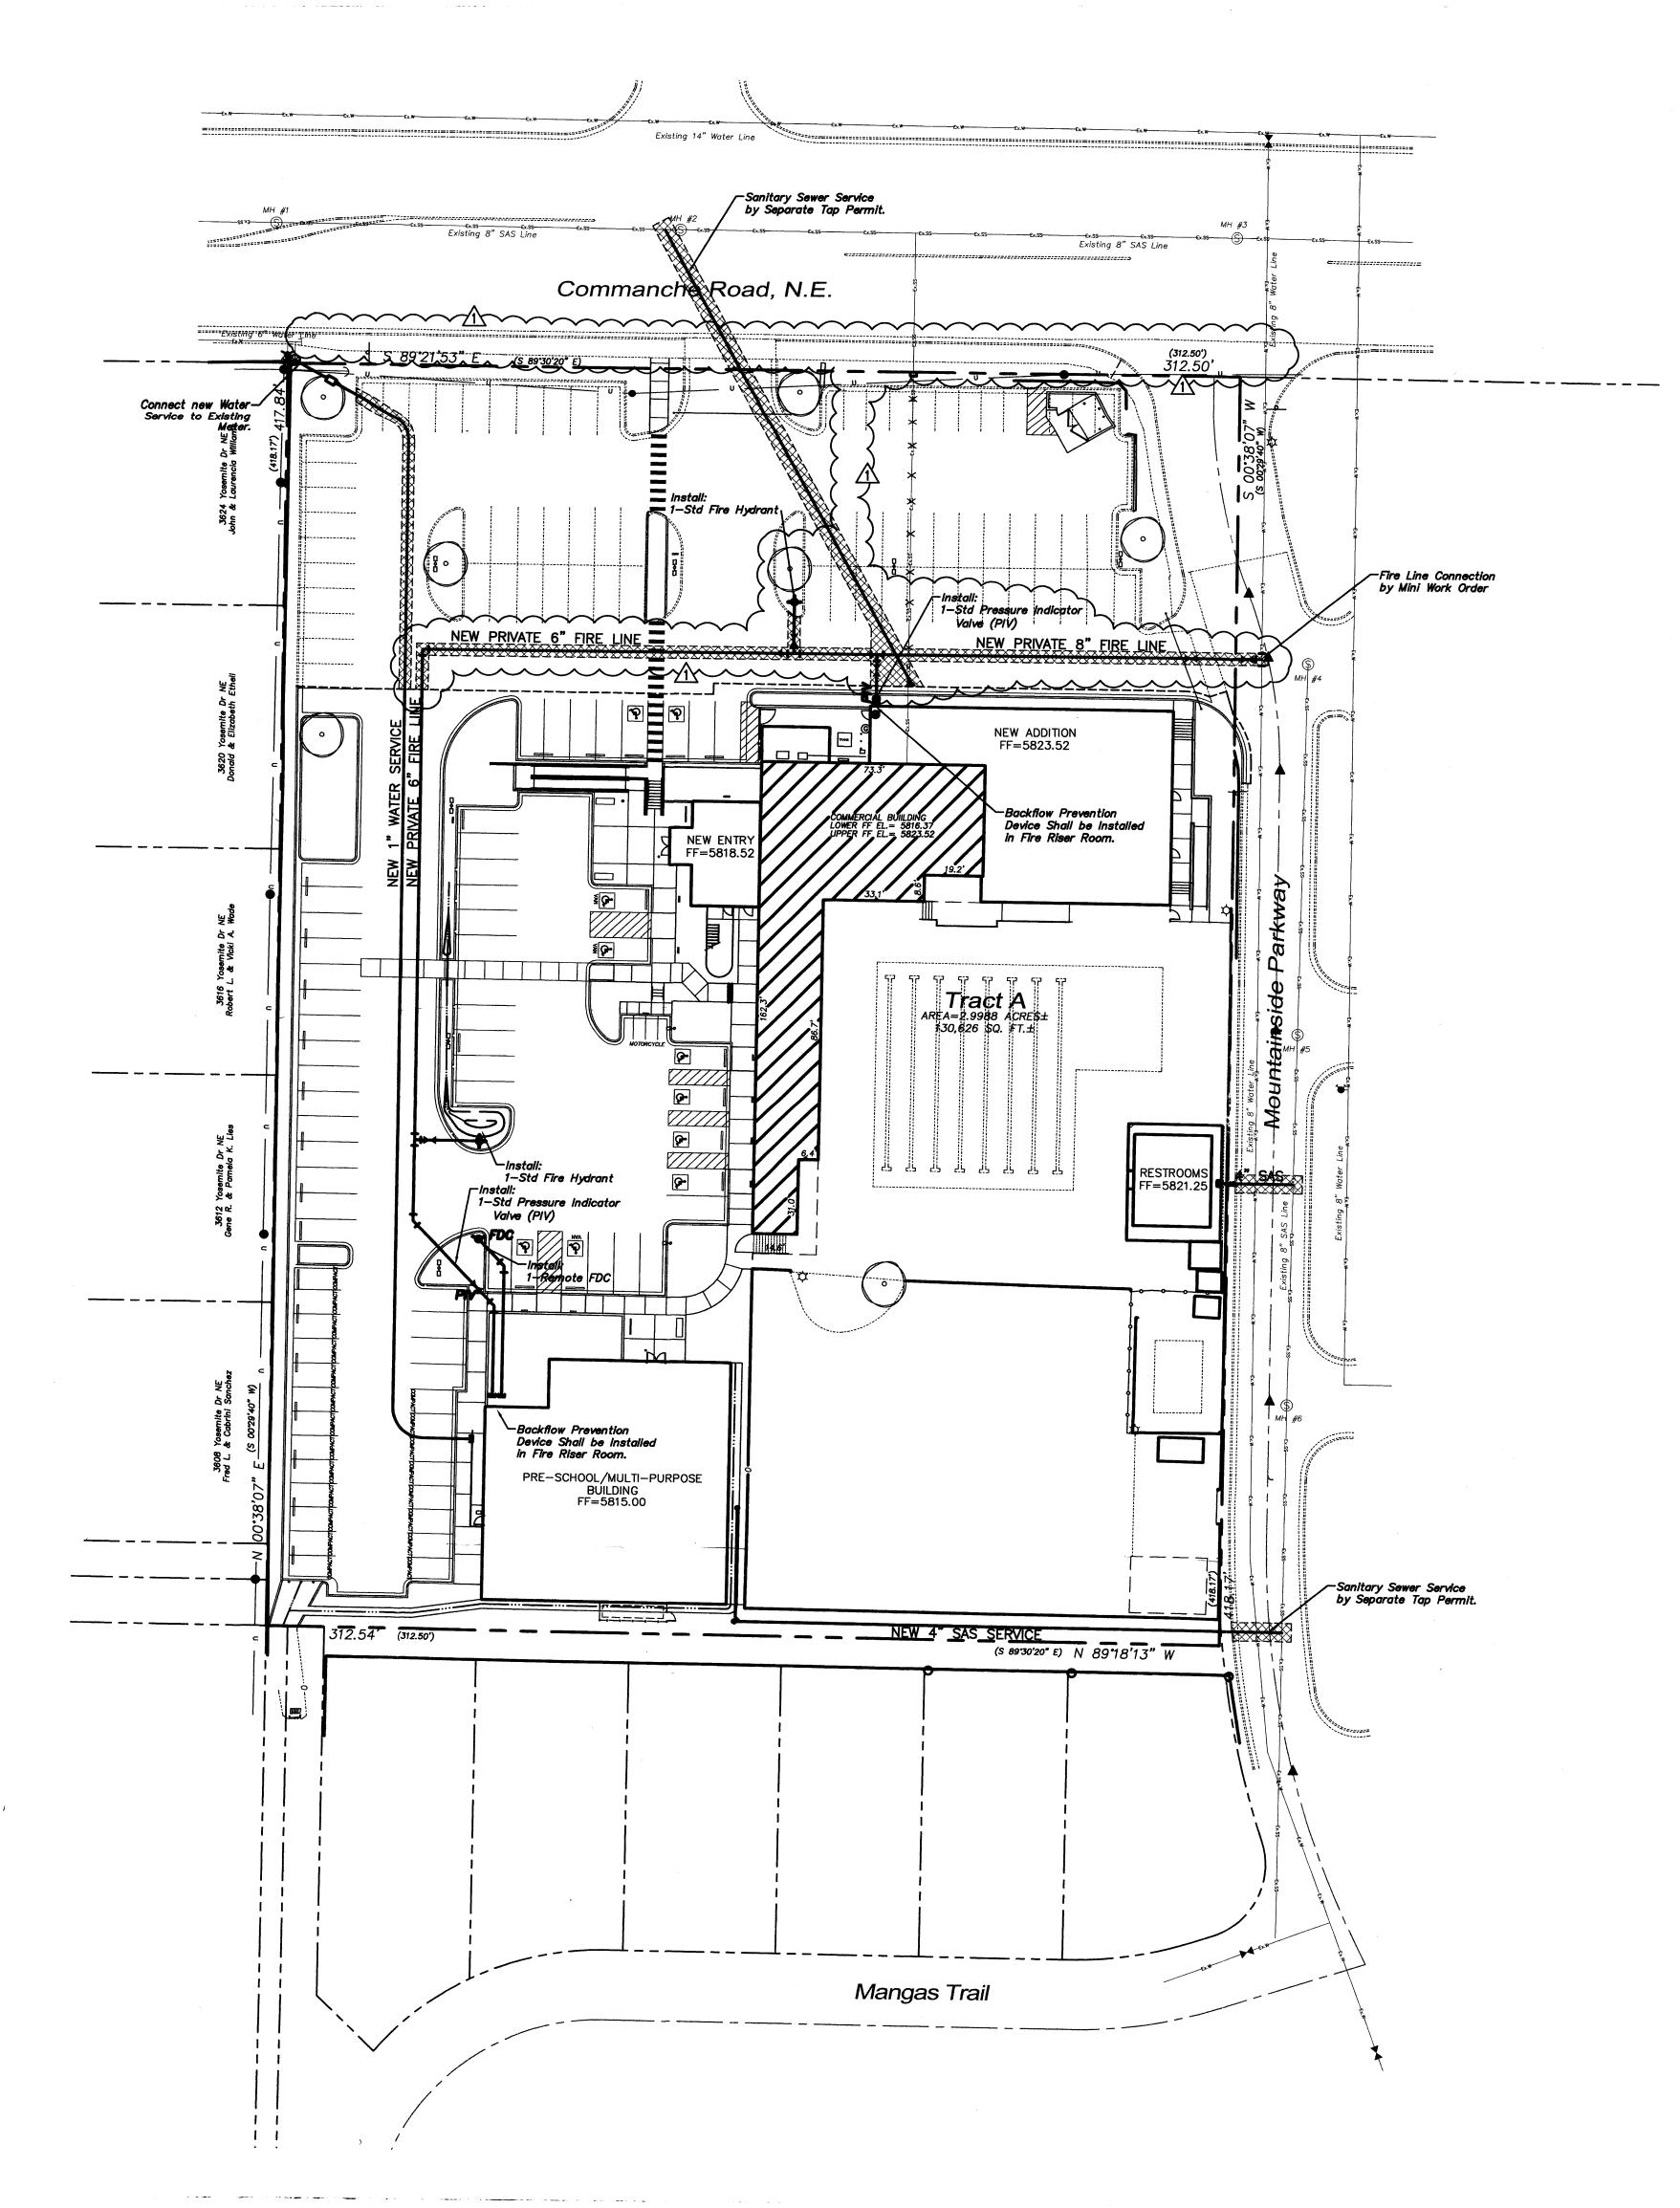

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CAUTION - NOTICE TO CONTRACTOR


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UTILITY NOTES

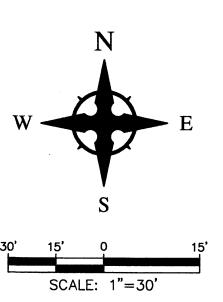
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INSTALLATION OF UTILITY LINES.

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CLEANOUT FRAME & COVER



CLEANOUT DETAIL

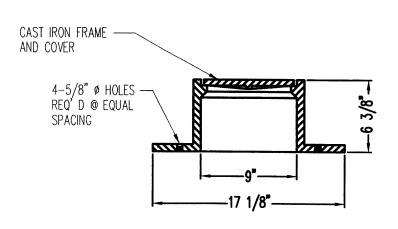Wooten Engineering

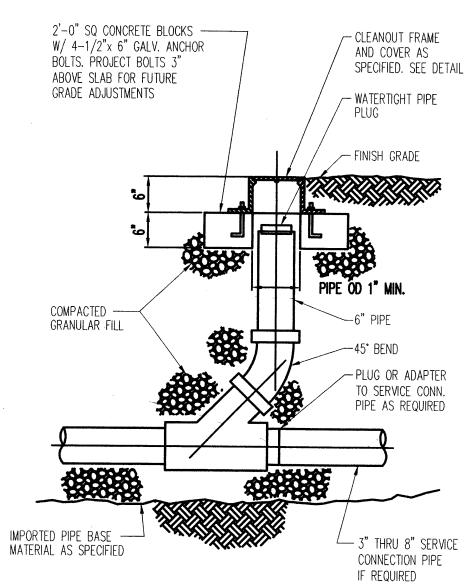5017 Sanbusco Dr NE, Rio Rancho, NM 87144
Ph: 505.771.4200 Fax: 505.771.8905

landscape planning engineering

architecture

Dekker Perich Sabatin

7601 Jefferson NE Suite 100 Albuquerque, NM 87109 505 761-9700 fax 761-4222 dps@dpsdesign.org

ARCHITECT

ENGINEER

NOT FOR CONSTRUCTION

PROJECT

MCLEOD
MOUNTAINSIDE YMCA
12500 Comanche NE
Albuquerque, NM 87111

REVISIONS

1. REVISE FIRE LINES TO BE PRIVATE.

DRAWN BY

REVIEWED BY

DATE


09/06/07

PROJECT NO.


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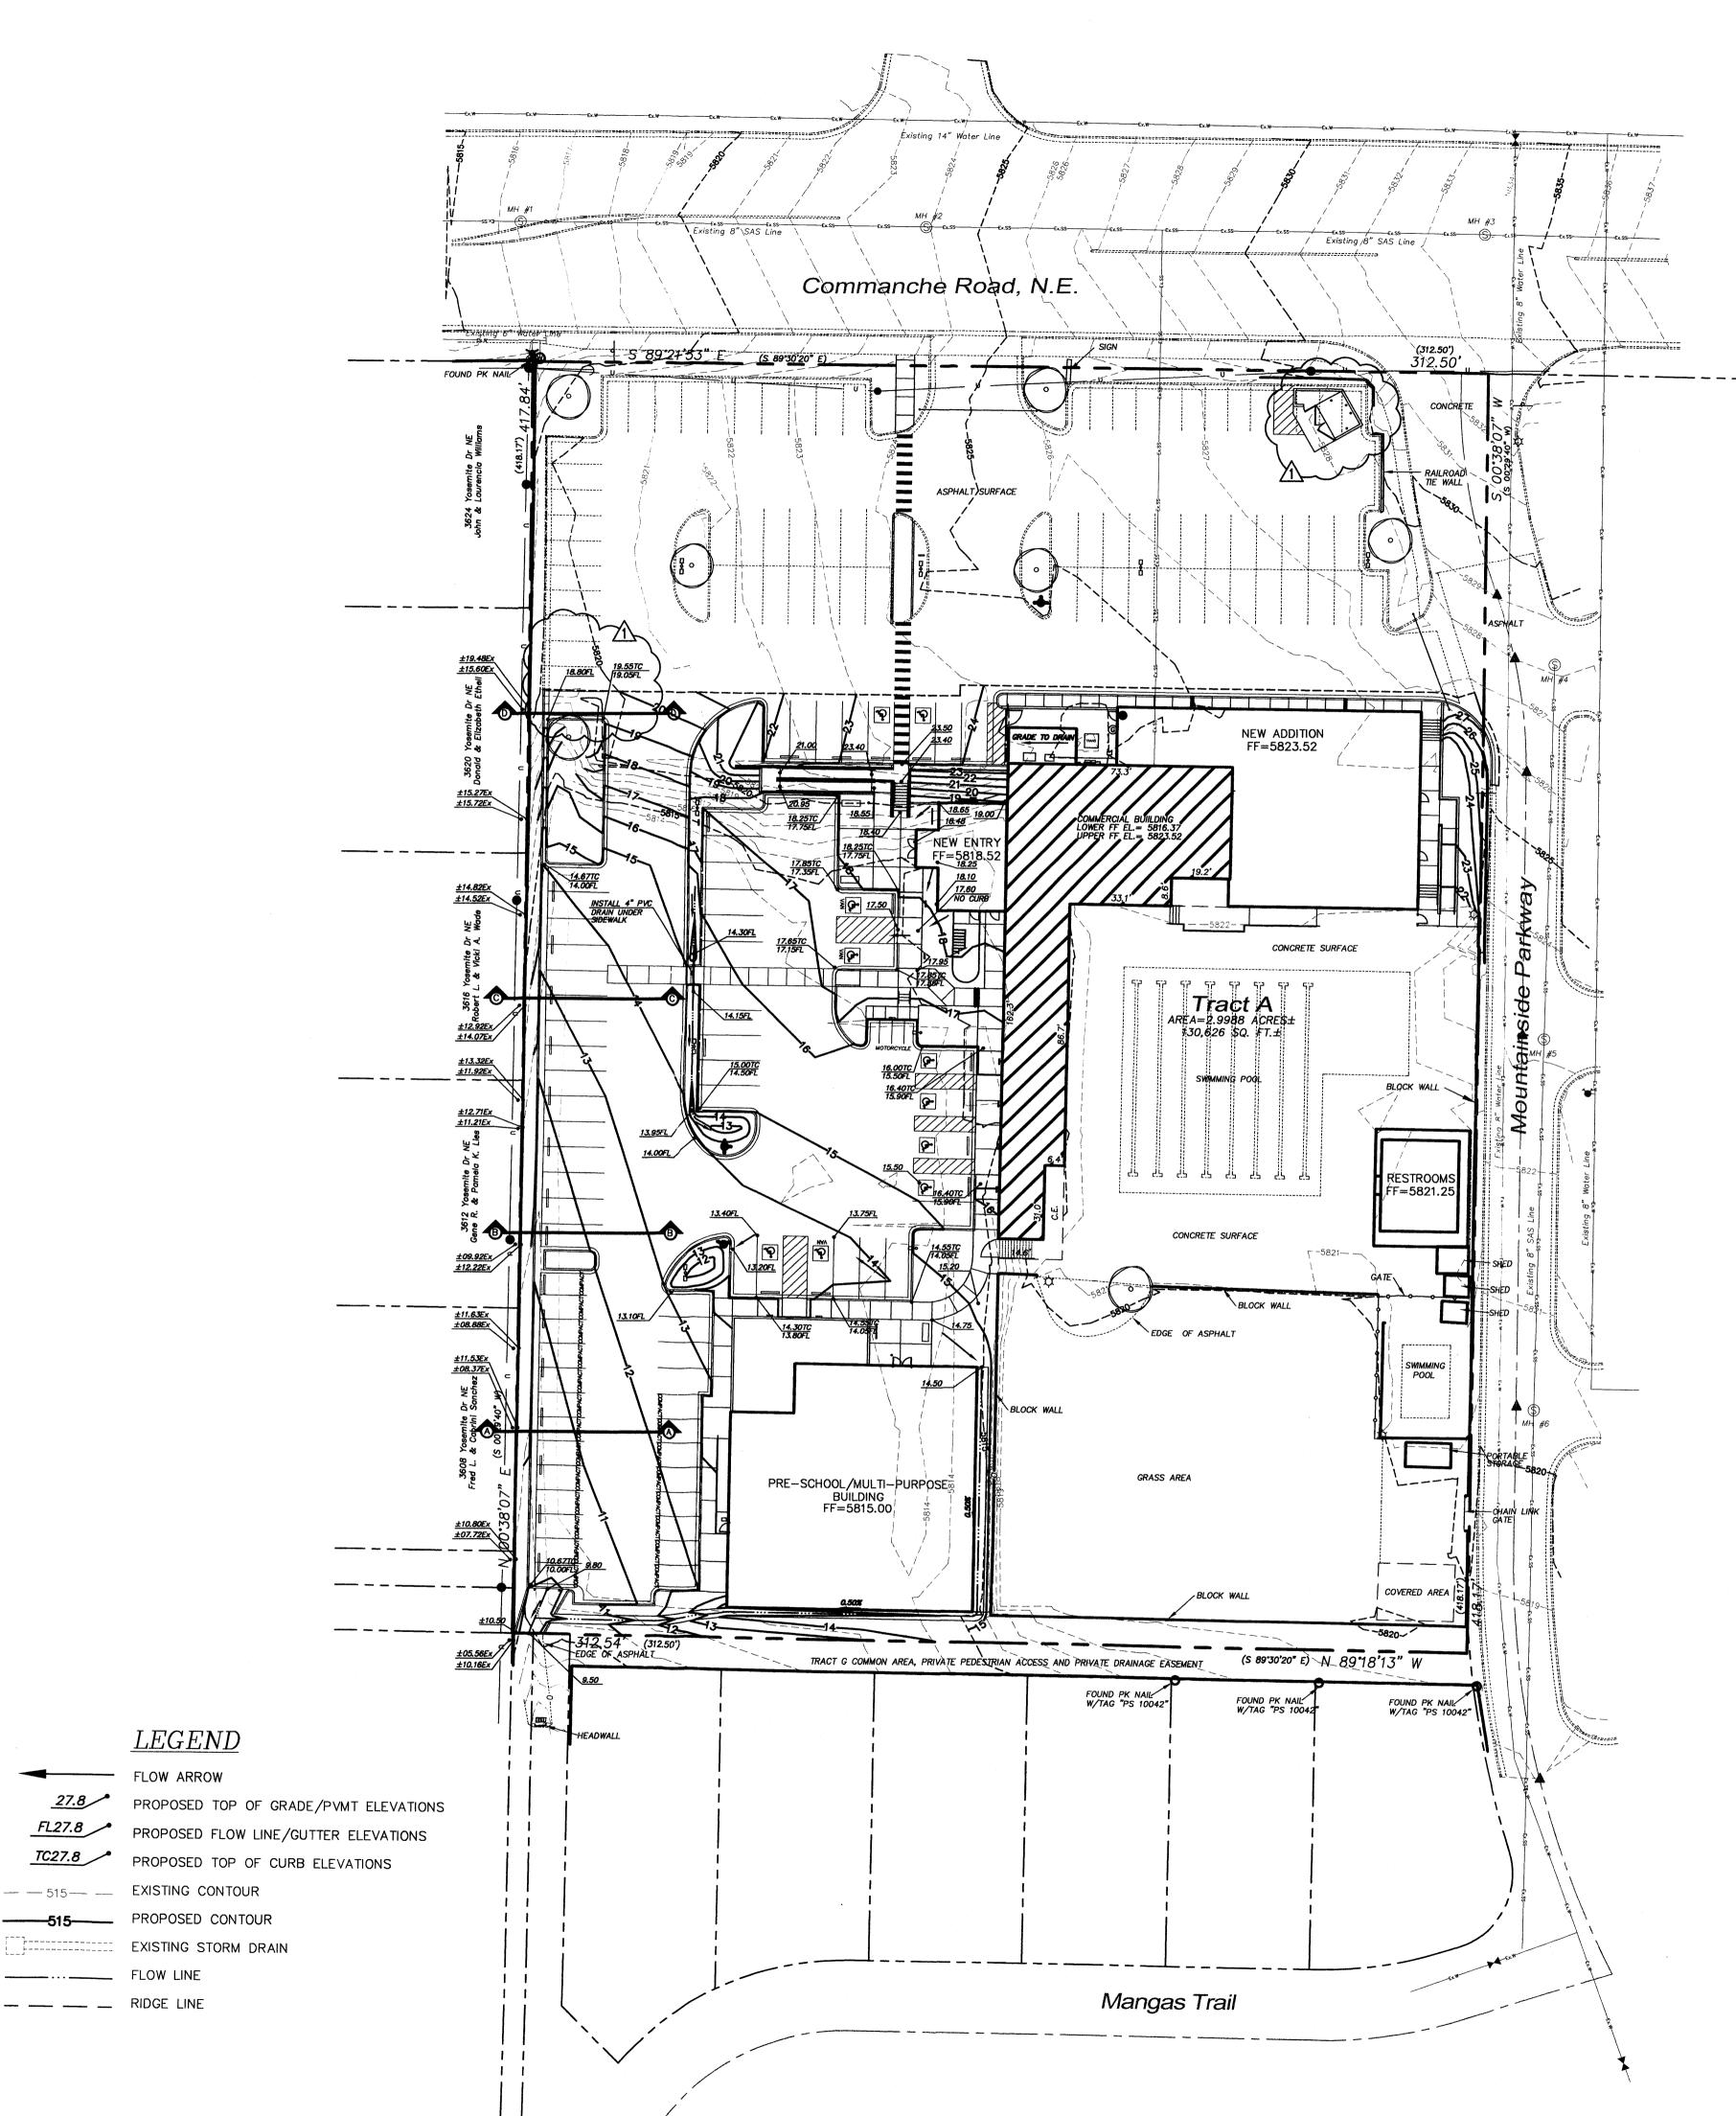
DRAWING NAME
UTILITY
PLAN

SHEET NO.

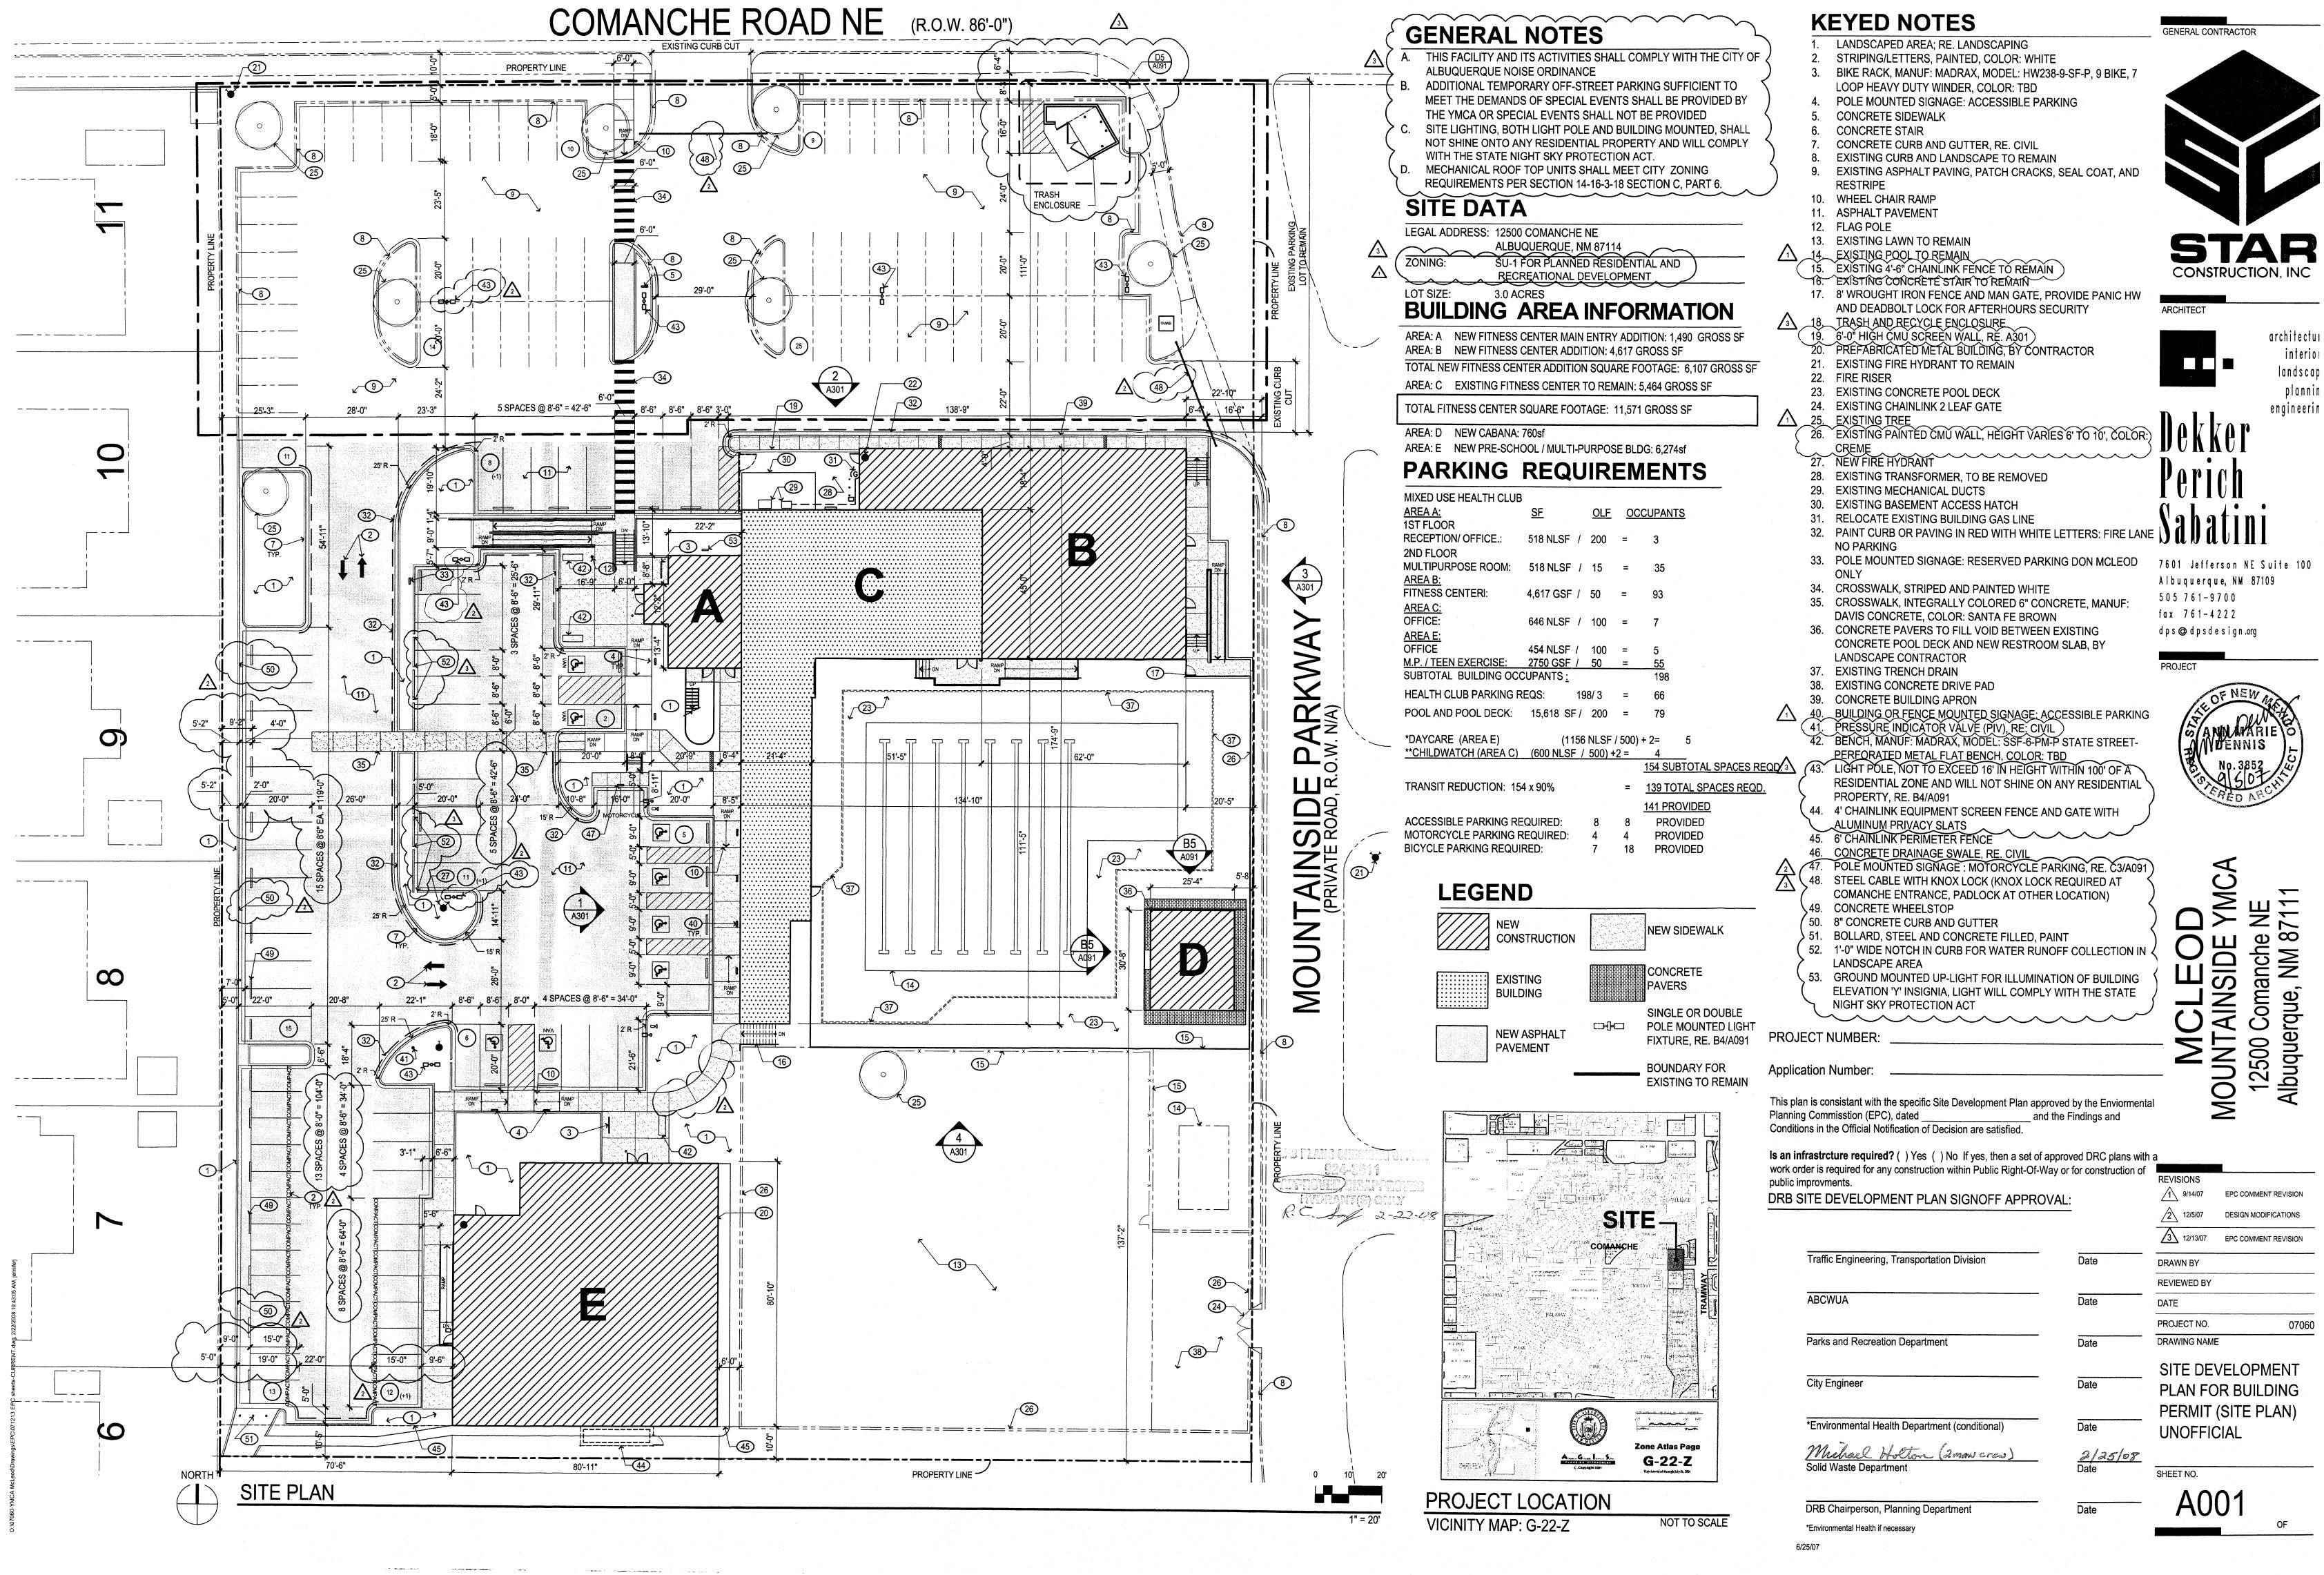

interio landscap plannin engineerin



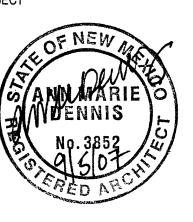

LEGEND

---- FLOW ARROW


— — 515— — EXISTING CONTOUR

----- FLOW LINE

- RIDGE LINE

FL27.8

TC27.8

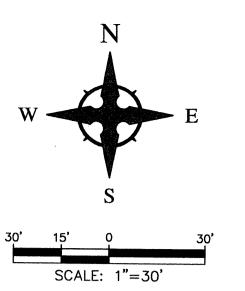

CAUTION - NOTICE TO CONTRACTOR

THE CONTRACTOR IS SPECIFICALLY CAUTIONED THAT THE LOCATION AND/OR ELEVATION OF EXISTING UTILITIES AS SHOWN ON THESE PLANS IS BASED ON RECORDS OF THE VARIOUS UTILITY COMPANIES AND, WHERE POSSIBLE, MEASUREMENTS TAKEN IN THE FIELD. THE INFORMATION IS NOT TO BE RELIED ON AS BEING EXACT OR COMPLETE. THE CONTRACTOR MUST CALL THE APPROPRIATE UTILITY COMPANY AT LEAST 48 HOURS BEFORE ANY EXCAVATION TO REQUEST EXACT FIELD LOCATION OF UTILITIES. IT SHALL BE THE RESPONSIBILITY OF THE CONTRACTOR TO RELOCATE ALL EXISTING UTILITIES WHICH CONFLICT WITH THE PROPOSED IMPROVEMENTS SHOWN ON THE PLANS.

DRAINAGE MANAGEMENT PLAN

The purpose of this submittal is to provide a conceptual drainage management plan for the proposed additions to the McLeod YMCA, which includes the demolition of existing buildings and paved surfaces; and the installation of new buildings and parking areas. The site is located at the 12500 Comanche NE in Albuquerque, NM, which is the southwest corner Comanche and Moutainside Parkway. The site contains approximately

EXISTING HYDROLOGIC CONDITIONS

According to the latest approved Drainage Management Plan by Tierra West (COA Hydrology File G22Z-D16), dated September 8, 1997, the runoff from the site is as

Basin 'R' (Total of Basins 'A' and 'B'): 15.05 cfs using 90% Type 'D' and 10% Type 'B' land treatments.

When the improvements were done in +/-1997, most of the drainage from the site was diverted away from Comanche to a drainage swale/inlet located at the southwest corner of the property.

PROPOSED HYDROLOGIC CONDITIONS

The calculations for the developed site (see Table below) show the 100-year runoff rate to be 15.04 cfs, which is 0.01 cfs lower than the calculations prepared by Tierra West in 1997. Seeing that there is a slight decrease in runoff for the proposed condition, there will not be any negative impacts downstream of the site.

The below calculations are for the new asphalt Triangular Channel outlet located at the southwest corner of the site. The section used is the smallest/most critical section of the

Given Data: Q (actual) = 15.04 cfs


Left Side Slope: +/-. 5:1 (5' long) Right Side Slope: +/- 4.7:1 (4.7' long) Depth: +/- 1' Manning's 'n' coefficient: 0.017

Channel Area: 4.85 Square Feet Wetted Perimeter: 9.9 R: 0.49 Channel Slope: +/- 1.88%

Using Manning's Equation and the above data, the capacity of the Channel is 36.10 cfs which is well over the required flow rate of 15.04 cfs.

CONCLUSION

This drainage management plan provides for grading and drainage elements which are capable of safely passing the 100 year storm and which meets city requirements. According to the previous approved Drainage Management Plan by Tierra West dated September 8, 1997, the site is allowed to discharge developed flows directly to the southwest corner of the site, without causing a negative impact. With this submittal, we are requesting conceptual grading and drainage plan approval for Site Plan for Building

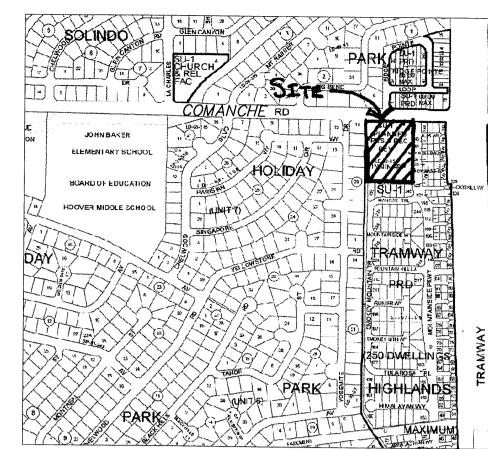

GRADING NOTES

1. EXCEPT AS PROVIDED HEREIN, GRADING SHALL BE PERFORMED AT THE ELEVATIONS AND IN ACCORDANCE WITH THE DETAILS SHOWN ON THIS PLAN. 2. THE COST FOR REQUIRED CONSTRUCTION DUST AND EROSION CONTROL MEASURES SHALL BE INCIDENTAL TO THE PROJECT COST.

3. ALL WORK RELATIVE TO FOUNDATION CONSTRUCTION, SITE PREPARATION. AND PAVEMENT INSTALLATION, AS SHOWN ON THIS PLAN, SHALL BE CONSTRUCTED IN ACCORDANCE WITH THE "GEOTECHNICAL INVESTIGATION," AS PROVIDED BY THE ARCHITECT OR OWNER. ALL OTHER WORK SHALL, UNLESS OTHERWISE STATED OR PROVIDED FOR HEREON, BE CONSTRUCTED IN ACCORDANCE WITH THE PROJECT, (FIRST PRIORITY) SPECIFICATIONS, AND/OR THE CITY OF ALBUQUERQUE (COA) STANDARD SPECIFICATIONS FOR PUBLIC WORKS (SECOND PRIORITY).

4. EARTH SLOPES SHALL NOT EXCEED 3 HORIZONTAL TO 1 VERTICAL UNLESS SHOWN OTHERWISE.

5. IT IS THE INTENT OF THESE PLANS THAT THIS CONTRACTOR SHALL NOT PERFORM ANY WORK OUTSIDE OF THE PROPERTY BOUNDARIES EXCEPT AS REQUIRED BY THIS PLAN.


6. THE CONTRACTOR IS TO ENSURE THAT NO SOIL ERODES FROM THE SITE ONTO ADJACENT PROPERTY OR PUBLIC RIGHT-OF-WAY. THIS SHOULD BE ACHIEVED BY CONSTRUCTING TEMPORARY BERMS OR SILT FENCE AT THE PROPERTY LINES AND WETTING THE SOIL TO PROTECT IT FROM WIND

7. A DISPOSAL SITE FOR ANY & ALL EXCESS EXCAVATION MATERIAL, AND UNSUITABLE MATERIAL AND/OR A BORROW SITE CONTAINING ACCEPTABLE FILL MATERIAL SHALL BE OBTAINED BY THE CONTRACTOR IN COMPLIANCE WITH APPLICABLE ENVIRONMENTAL REGULATIONS AND APPROVED BY THE OBSERVER. ALL COSTS INCURRED IN OBTAINING A DISPOSAL OR BORROW SITE AND HAUL TO OR FROM SHALL BE CONSIDERED INCIDENTAL TO THE PROJECT AND NO SEPARATE MEASUREMENT OR PAYMENT SHALL BE MADE.

8. PAVING AND ROADWAY GRADES SHALL BE +/- 0.05' FROM PLAN ELEVATIONS. PAD ELEVATION SHALL BE +/- 0.05' FROM BUILDING PLAN

9. ALL PROPOSED CONTOURS REFLECT TOP OF PAVEMENT ELEVATIONS IN THE PARKING AREA AND MUST BE ADJUSTED FOR MEDIANS AND ISLANDS. 10. VERIFY ALL ELEVATIONS SHOWN ON PLAN FROM BASIS OF ELEVATION CONTROL STATION PRIOR TO BEGINNING CONSTRUCTION.

11. THE CONTRACTOR SHALL PROVIDE THE SWPPP DOCUMENT (IF NECESSARY) AND SHALL ABIDE BY ALL LOCAL, STATE, AND FEDERAL LAWS, RULES AND REGULATIONS WHICH APPLY TO THE CONSTRUCTION OF THESE IMPROVEMENTS, INCLUDING EPA REQUIREMENTS WITH RESPECT TO STORM

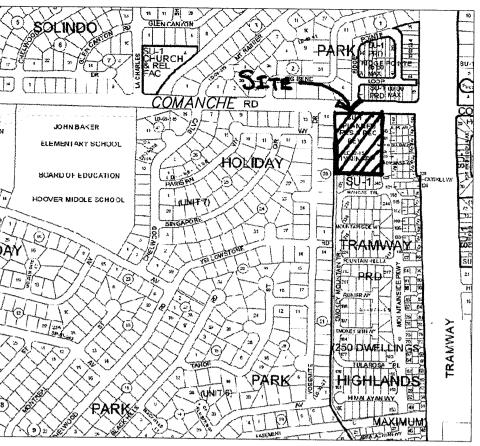



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ARCHITECT

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architecture

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landscape


planning engineering

MOUNTAINSID

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BASIN	Area	Area	Land Treatment Percentages				Q(100)	Q(100)	WTE	V(100) ₃₆₀	V(100) ₁₄₄₀	V(100)40
	(SQ. FT)	(AC.)	A	В	С	D	(cfs/ac.)	(CFS)	(inches)	(CF)	(CF)	(CF)
Basin 'R'		3.00	0.0%	10.0%	0.0%	90.0%	5.02	15.05	n/a	n/a	n/a	n/a
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BASIN	Area	Area	Lan	Land Treatment Percentages				Q(100)	WTE	V(100) ₃₆₀	V(100) ₁₄₄₀	V(100)40
	(SQ. FT)	(AC.)	Α	В	С	D	(cfs/ac.)	(CFS)	(inches)	(CF)	(CF)	(CF)
Basin 'R'	130626	3.00	0.0%	10.0%	0.0%	90.0%	5.02	15.04	2.48	27040	35269	44456





Ph: 505.771.4200 Fax: 505.771.8905

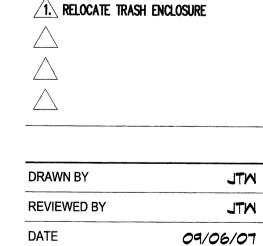

PROJECT NO. 07060 DRAWING NAME GRADING & DRAINAGE PLAN

SHEET NO.

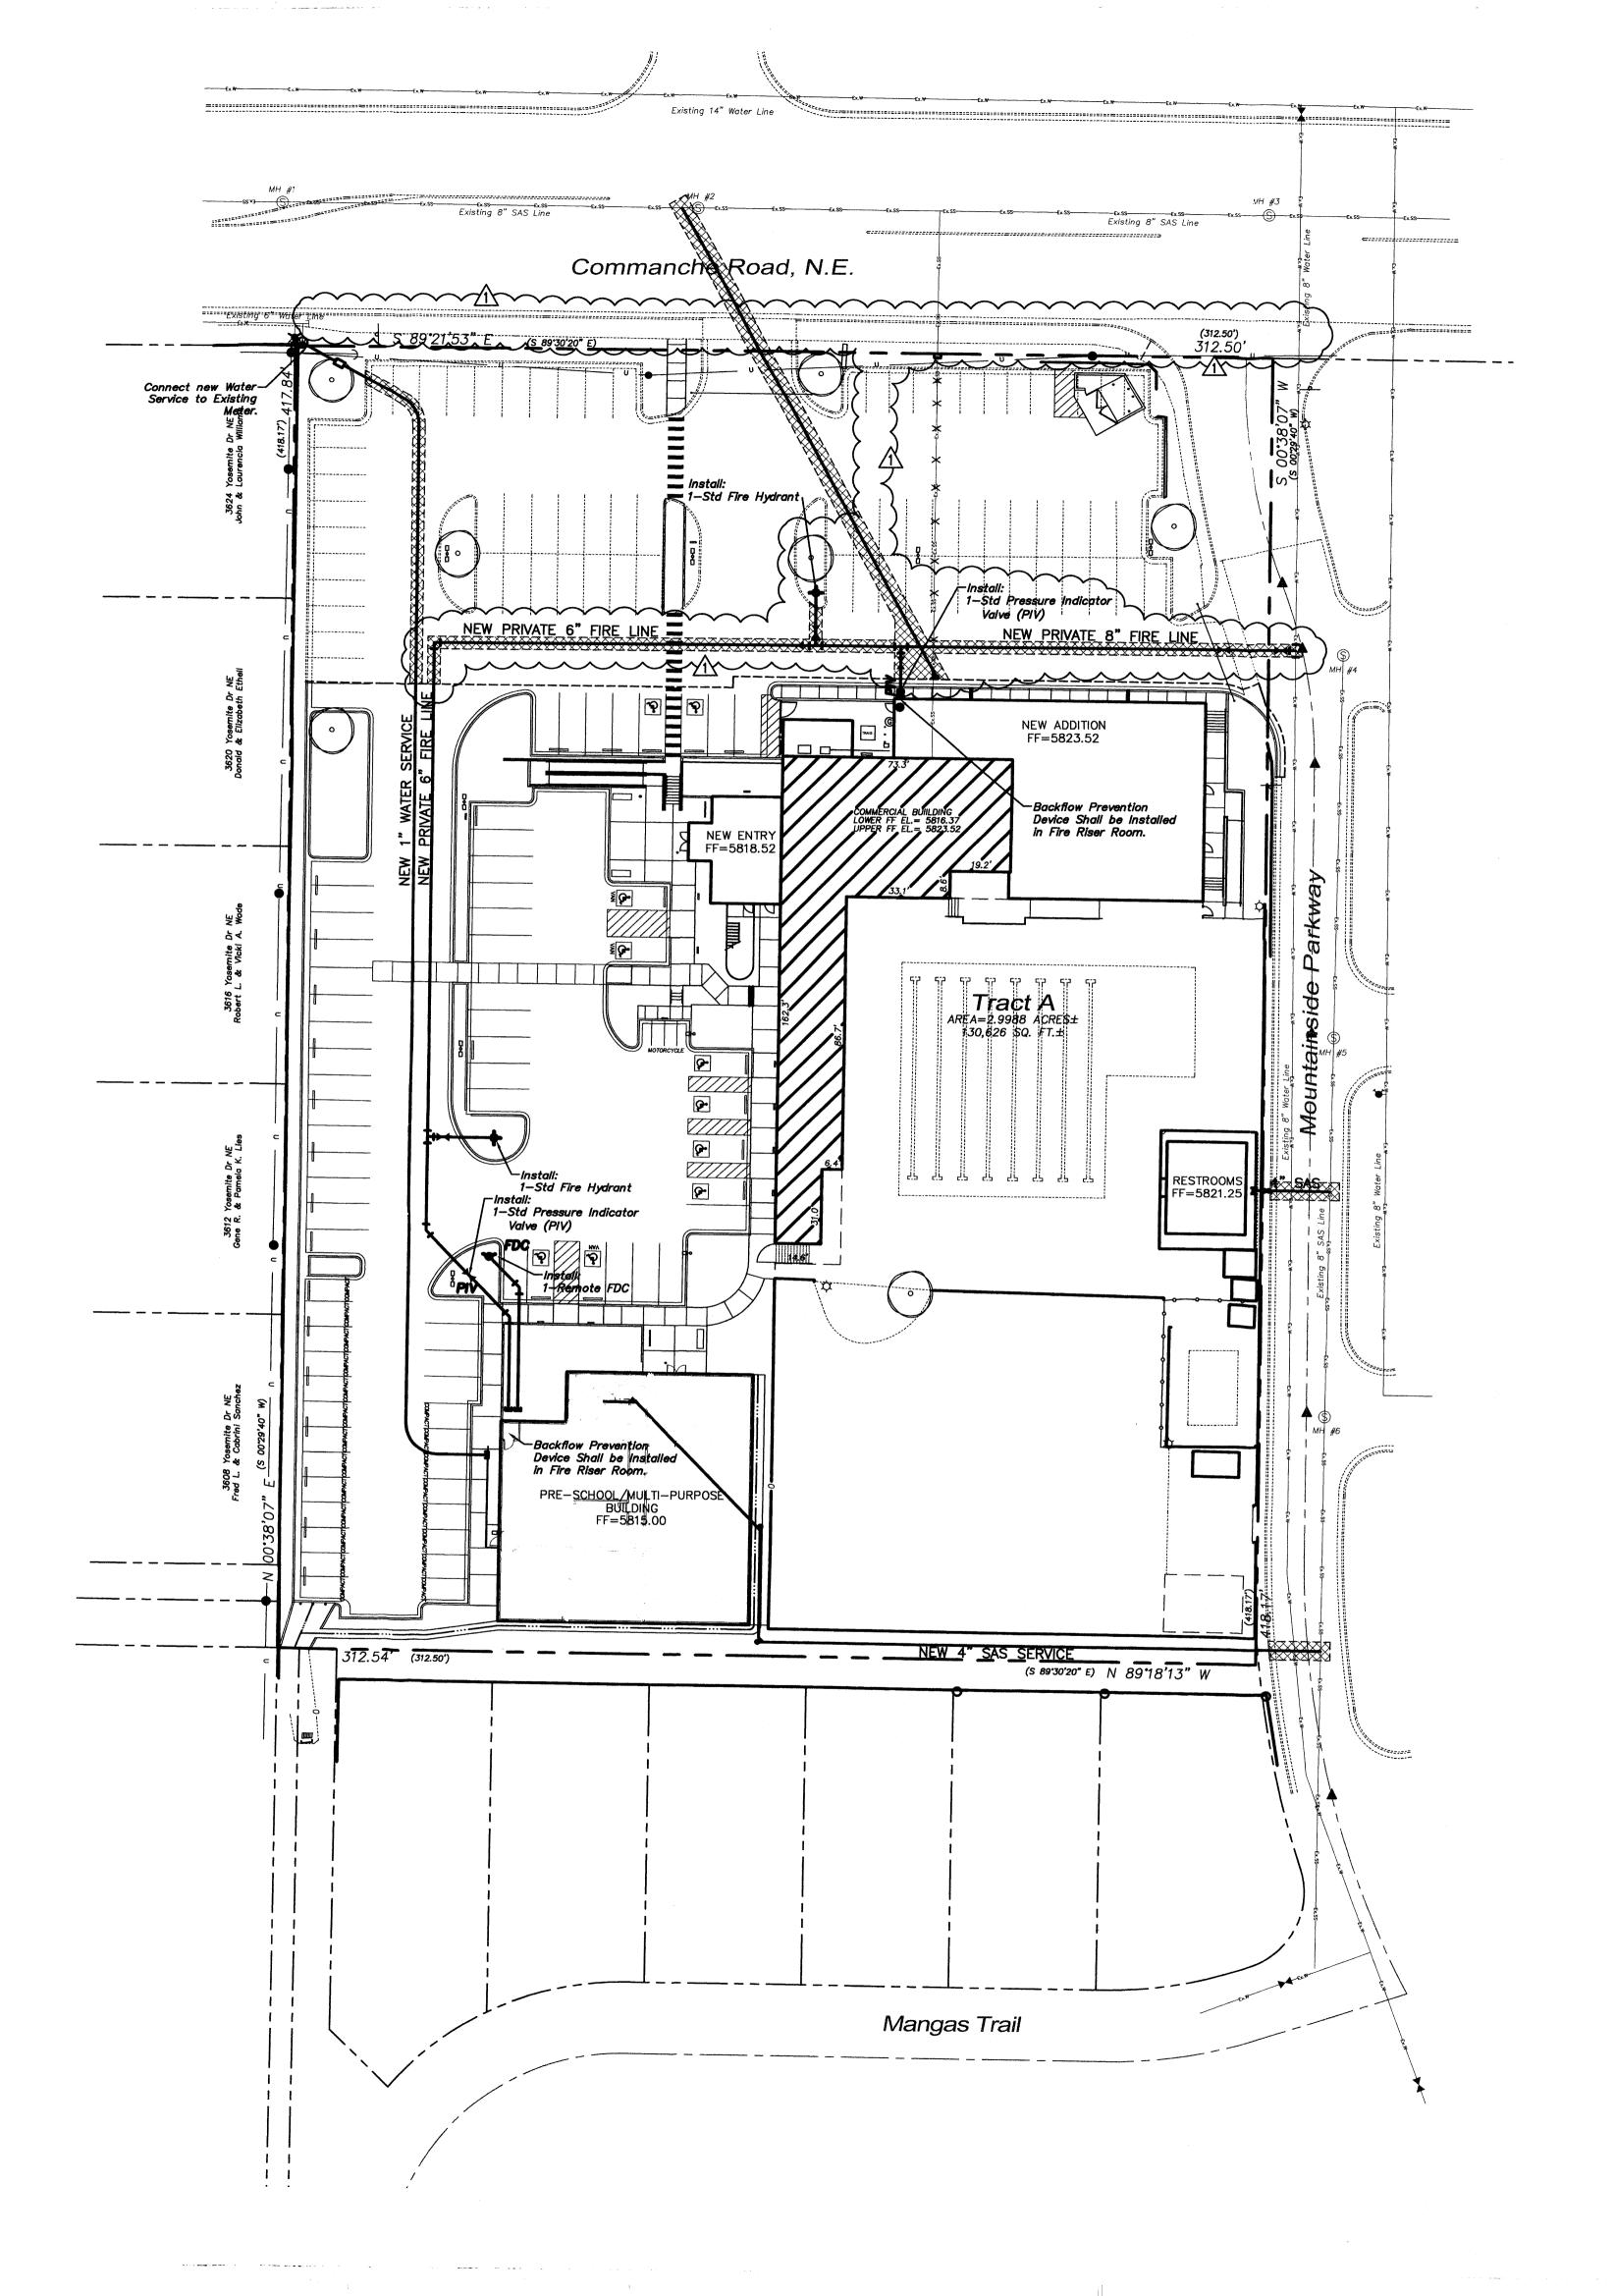


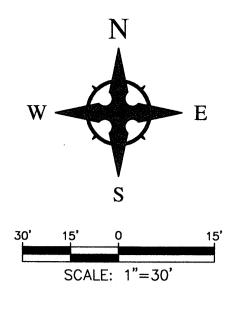


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- NOT ACCEPTED BY THE ARCHITECT OR ENGINEER DUE TO IMPROPER
- 2. MINIMUM DEPTHS OF COVER SHALL BE: 36" FOR WATERLINES AND 48" FOR SEWER, EXCEPT AT BUILDING CONNECTION.
- 4. UTILITY LINES SHALL BE INSTALLED PRIOR TO PAVEMENT, CURB AND
- 5. ROUGH GRADING OF SITE (±0.5') SHALL BE COMPLETED PRIOR TO installation of utility lines.
- 6. CONTRACTOR WILL BE RESPONSIBLE FOR CONNECTIONS TO BUILDING DRAIN
- 7. ALL VALVES SHALL BE ANCHORED PER COA STANDARD DWG. 2333.
- 8. FIRE LINES SHALL USE PIPE MATERIALS UNDERWRITERS LABORATORIES LISTED AND APPROVED FOR FIRE SERVICE.
- 9. CONTRACTOR SHALL BE RESPONSIBLE FOR ALL WATER METER, FIRE LINE, AND SEWER HOOKUP FEES FOR INSTALLATIONS. CONTRACTOR SHALL BE ASSESSMENTS.
- 10. CONTRACTOR SHALL VERIFY INVERTS AND LOCATIONS OF EXISTING WATER/SAS LINES PRIOR TO BEGINNING WORK. ALL CONFLICTS SHALL BE BROUGHT TO ATTENTION OF THE ENGINEER AND RESOLVED PRIOR TO BEGINNING
- 11. CONTRACTOR SHALL PREPARE ALL SUBMITTAL MATERIALS & PAY APPLICABLE FEES REQUIRED TO OBTAIN THE "MINI WORK ORDER" REQUIRED FOR CONNECTION TO THE EXISTING CITY WATER MAIN AND OTHER 'PUBLIC' WATER LINE CONSTRUCTION.



FRAME & COVER N.T.S.

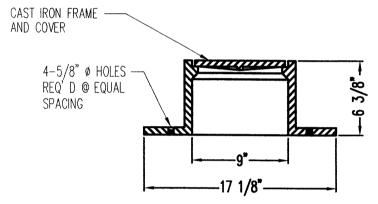


CLEANOUT DETAIL

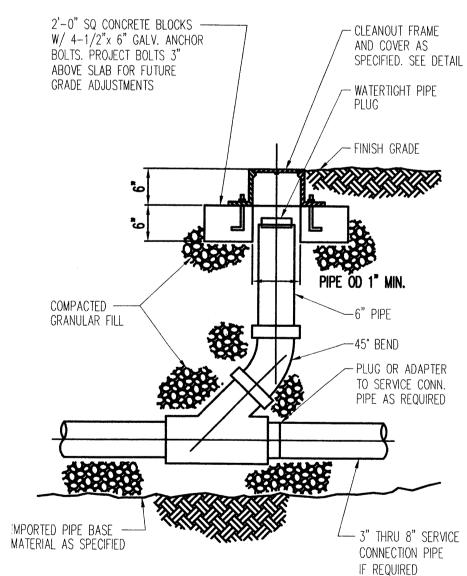5017 Sanbusco Dr NE, Rio Rancho, NM 87144 Ph: 505.771.4200 Fax: 505.771.8905


UTILITY NOTES

1. THE CONTRACTOR SHALL BE RESPONSIBLE FOR THE COMPLETE INSTALLATION OF ALL WORK RELATED TO MECHANICAL UTILITIES AS SHOWN ON THIS PLAN INCLUDING: TRENCHING, BACKFILL, SUPPORTS, CLEANOUT PADS, SERVICE STOPS AND BOXES, SERVICE LINES, TESTING, CLEANING, AND STERILIZING. ANY WORK WORKMANSHIP OR LACK OF PROPER COORDINATION SHALL BE REMOVED AND CORRECTLY INSTALLED AT THE CONTRACTOR'S EXPENSE, AS DIRECTED.

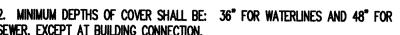


- 3. ALL WORK DETAILED ON THESE PLANS TO BE PERFORMED UNDER CONTRACT SHALL, EXCEPT AS OTHERWISE STATED OR PROVIDED OF HEREON, BE CONSTRUCTED IN ACCORDANCE WITH THE IAPMO UNIFORM PLUMBING CODE, LATEST EDITION.
- GUTTER, AND/OR SIDEWALK, AS APPLICABLE.
- LINES AND ALL NECESSARY FITTINGS.

- RESPONSIBLE FOR UTILITY EXPANSION CHARGES, PRORATA AND OTHER SPECIAL

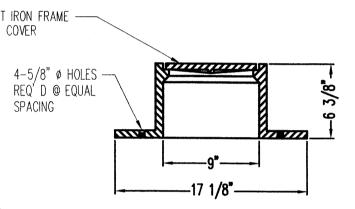

CLEANOUT

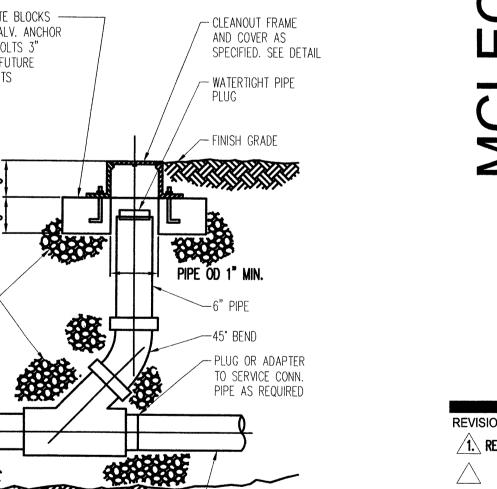

1. REVISE FIRE LINES TO BE PRIVATE.

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interiors

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engineering

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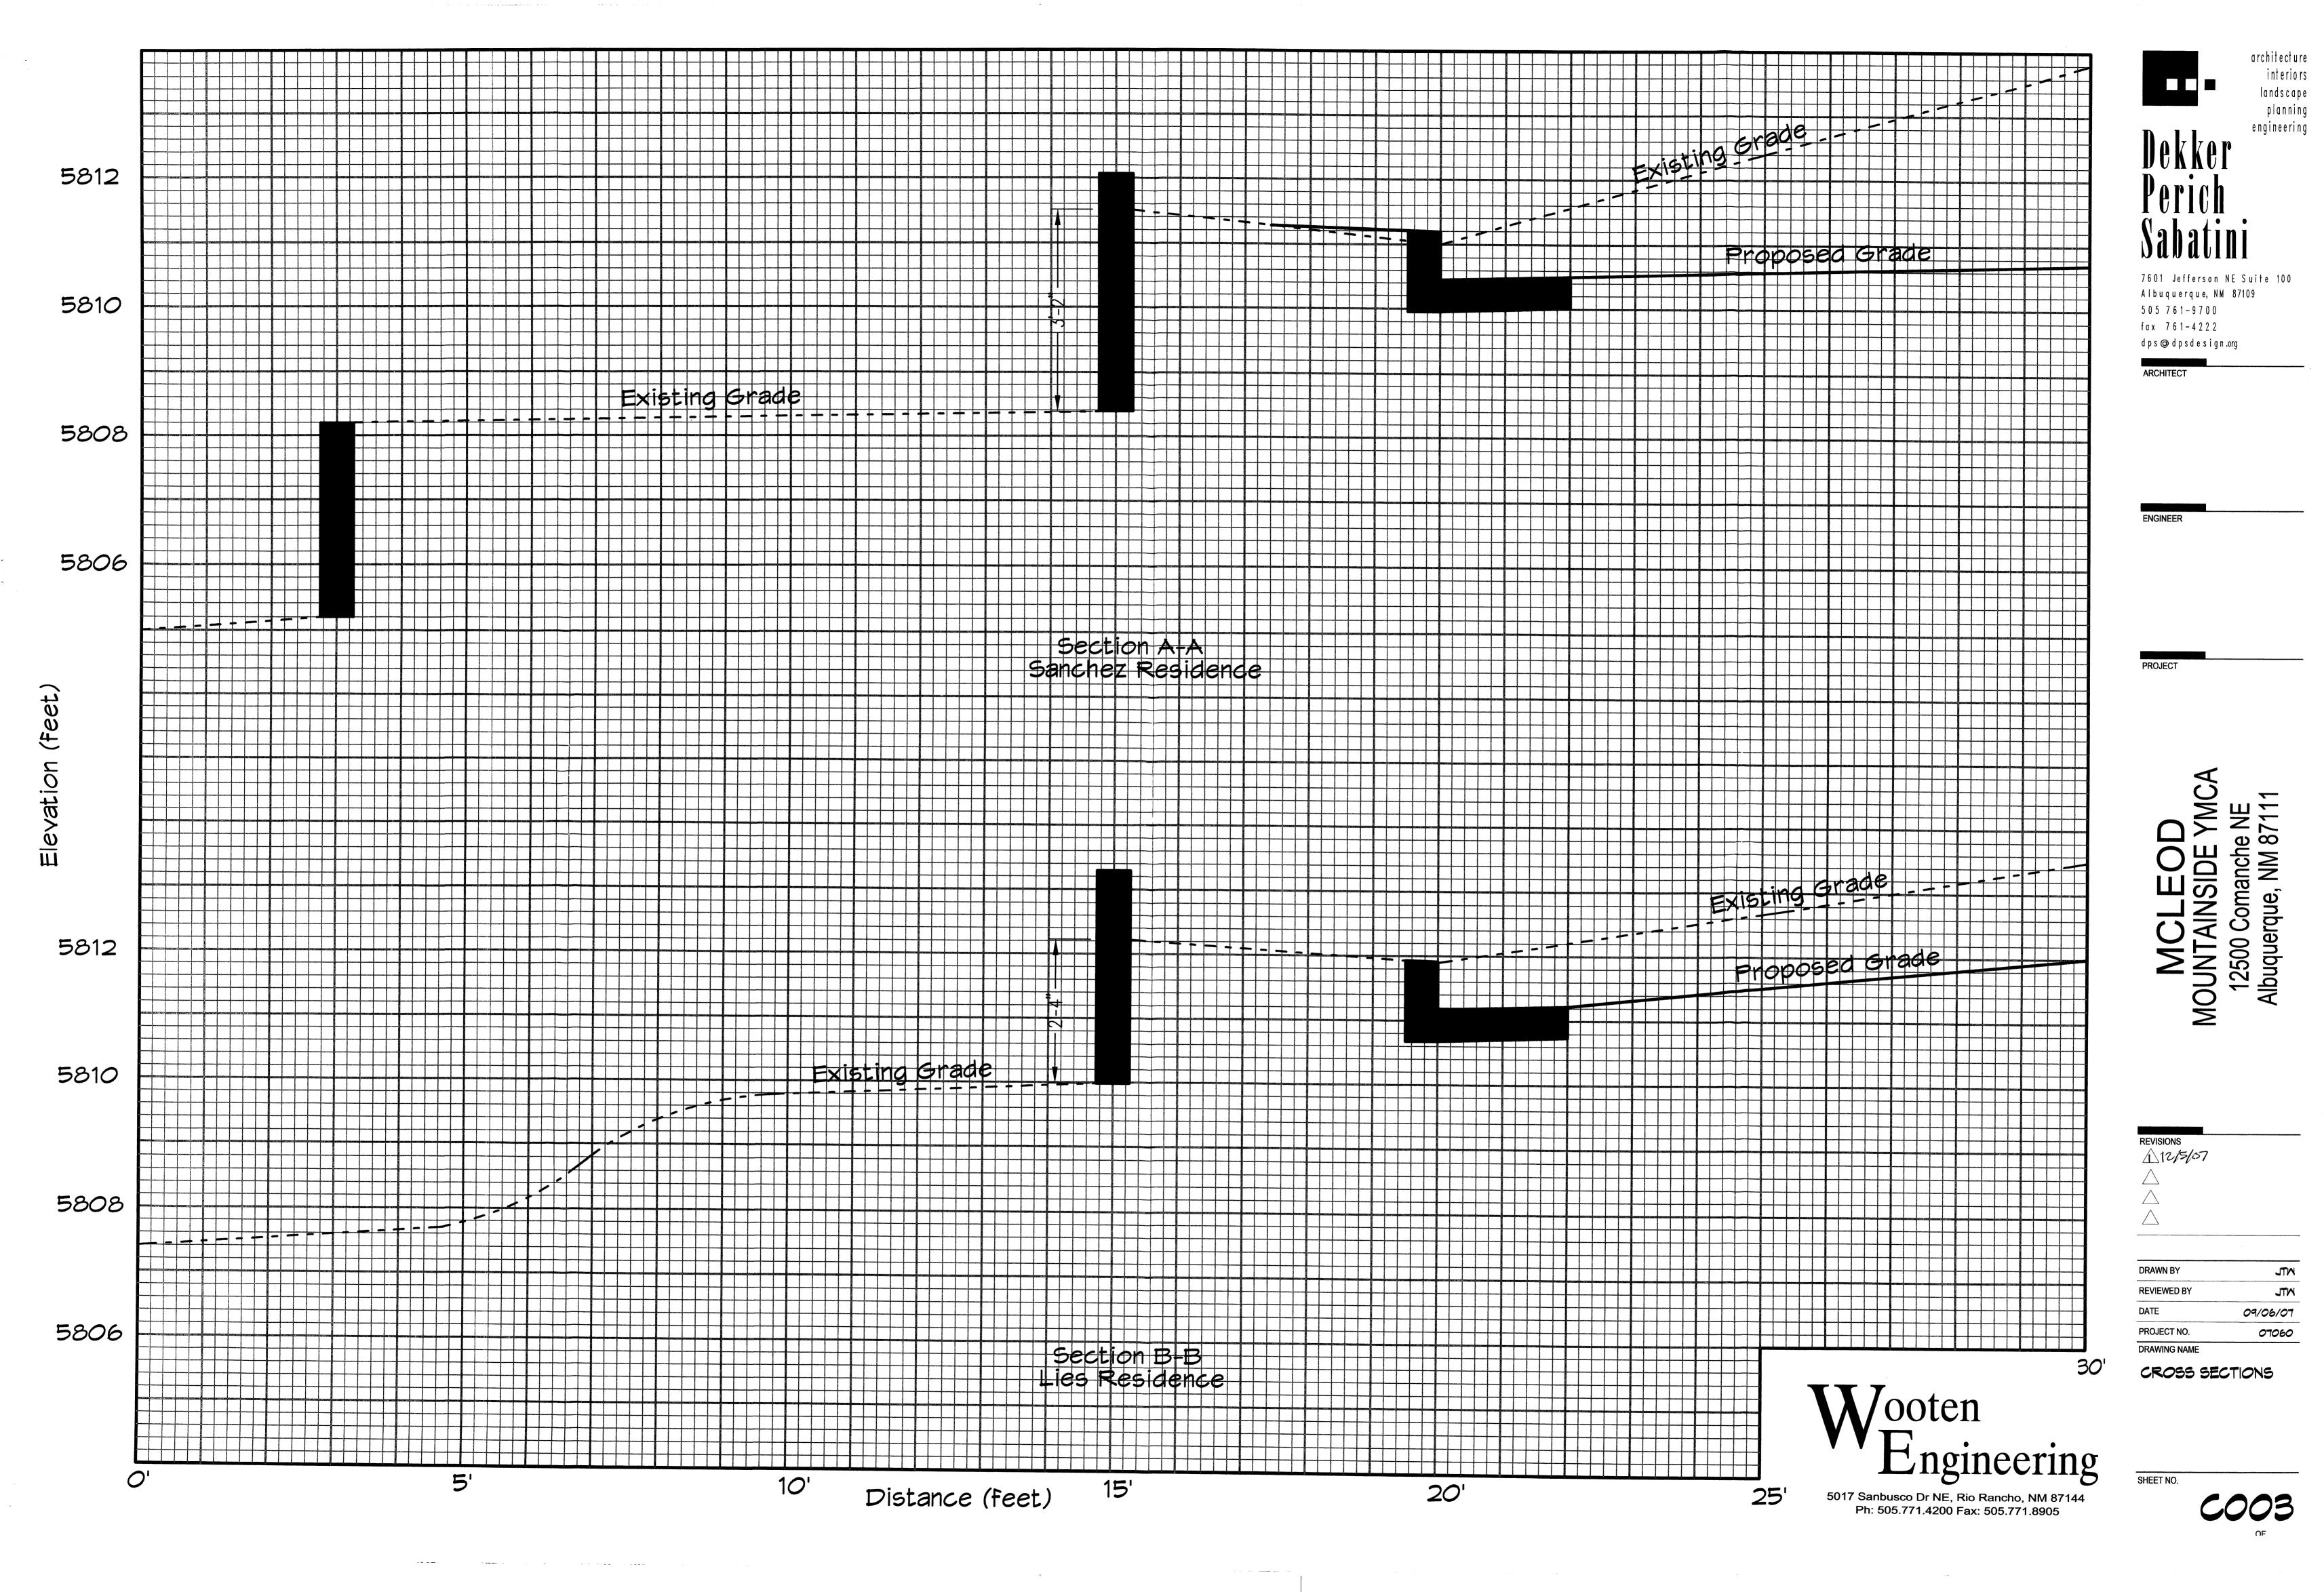
ARCHITECT


dps@dpsdesign.org


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UTILITY PLAN







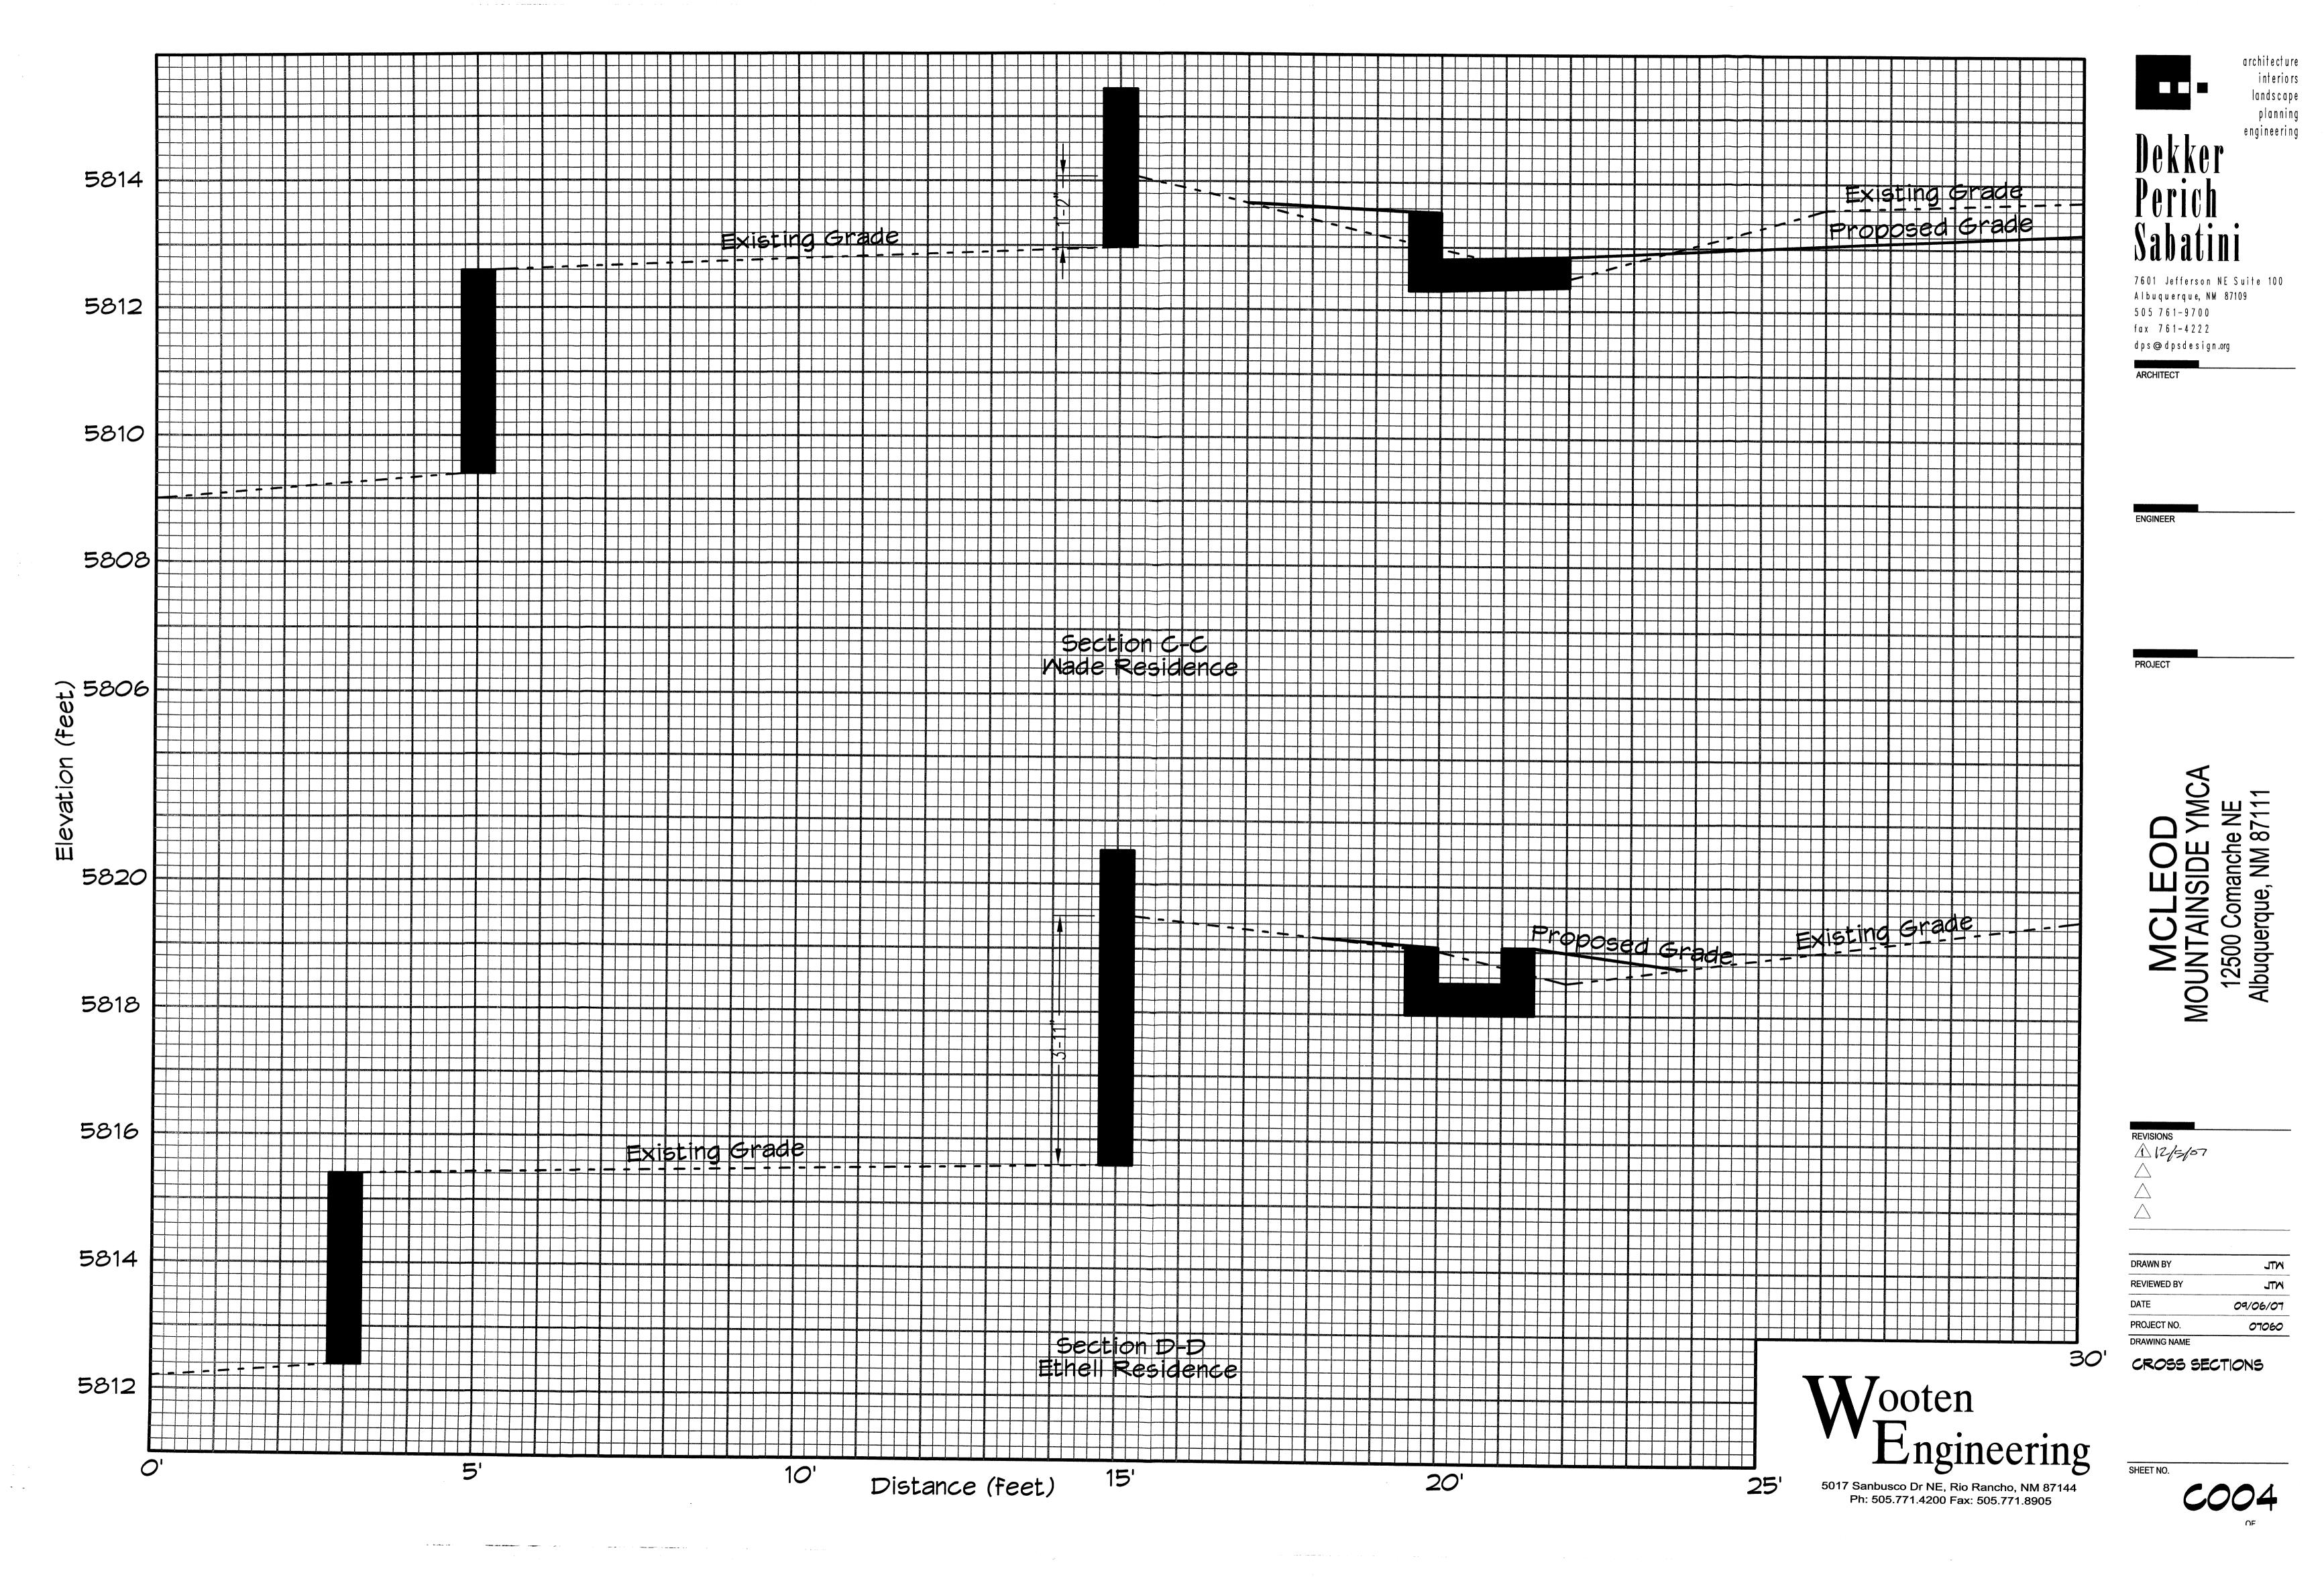

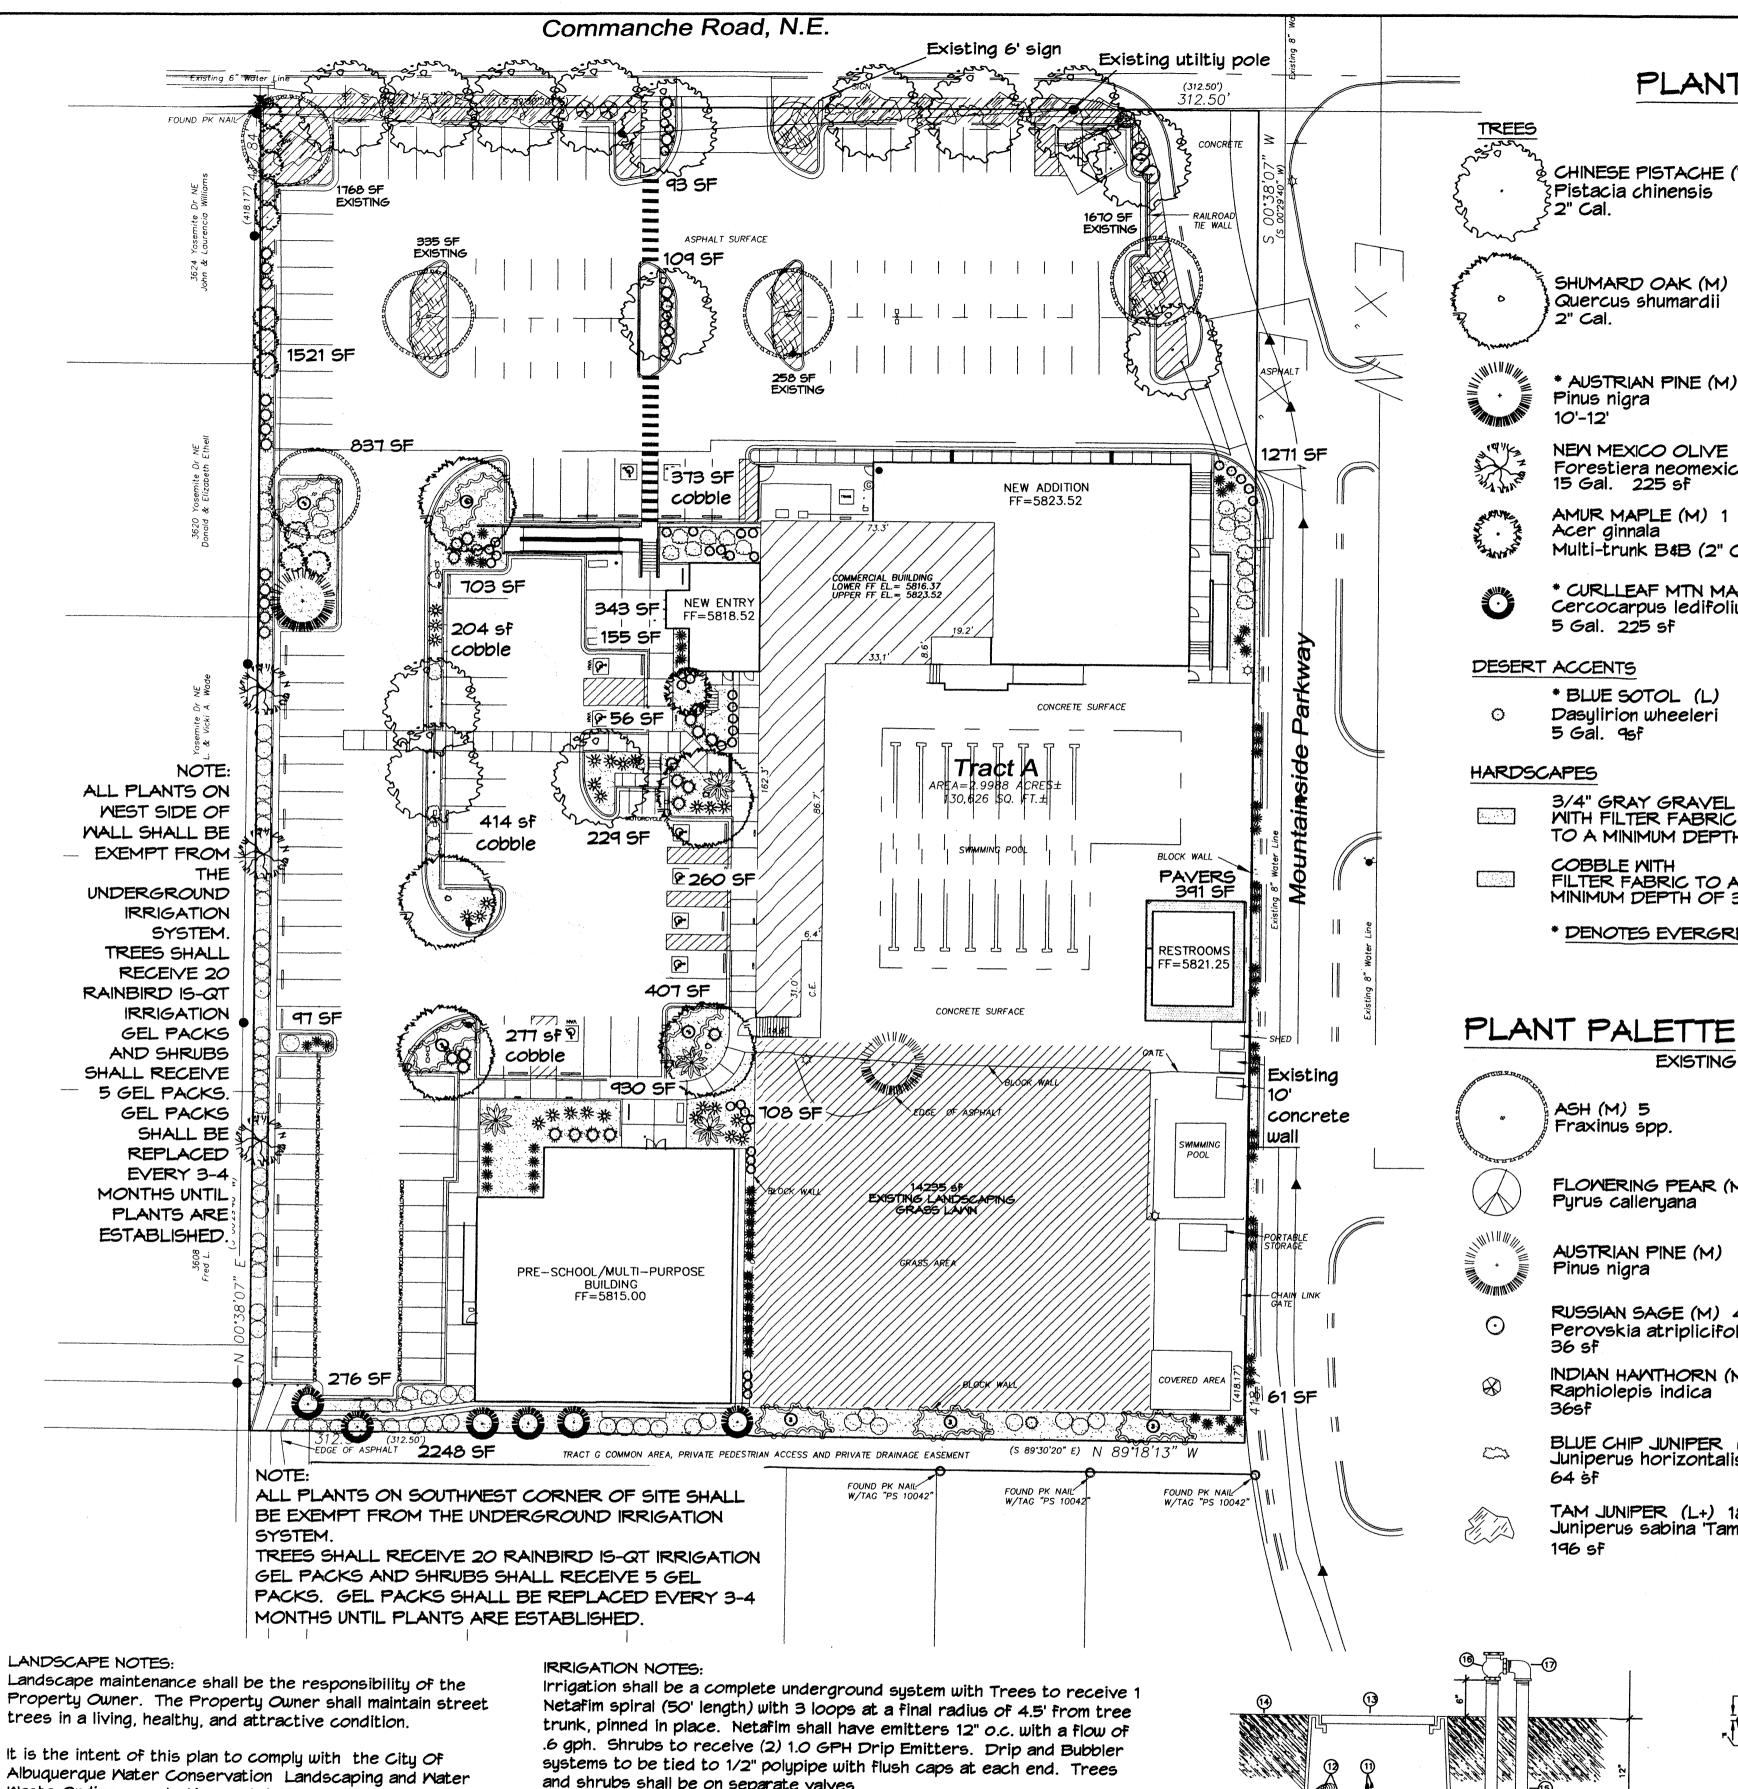Landscape maintenance shall be the responsibility of the Property Owner. The Property Owner shall maintain street trees in a living, healthy, and attractive condition.

Albuquerque Water Conservation Landscaping and Water Maste Ordinance planting restriction approach. Approval of this plan does not constitute or imply exemption from water waste provisions of the Water Conservation Landscaping and Water Waste Ordinance.

Mater management is the sole responsibility of the Property Owner. All landscaping will be in conformance with the City of Albuquerque Zoning Code, Street Tree Ordinance, Pollen Ordinance, and Water Conservation Landscaping and Water Maste Ordinance. In general, water conservative, environmentally sound landscape principles will be followed in design and installation.

Plant beds shall achieve 75% live ground cover at maturity including both existing and new landscape areas.

3/4" Crushed Grey Gravel over Filter Fabric to a minimum depth of 3" shall be placed in all landscape areas which are not designated to receive native seed.

and shrubs shall be on separate valves.

Run time per each shrub drip valve will be approximately 15 minutes per day. Tree drip valve shall run 1.5 hours, 3 times per week. Run time will be adjusted according to the season.

Point of connection for irrigation system is unknown at current time and will be coordinated in the field. Irrigation will be operated by automatic controller.

Location of controller to be field determined and power source for controller to be provided by others.

Irrigation maintenance shall be the responsibility of the Property Owner.

Mater and Power source shall be the responsibility of the Developer/Builder.

AUSTRIAN PINE (M) 1 Pinus nigra RUSSIAN SAGE (M) 4 Perovskia atriplicifolia INDIAN HAWTHORN (M) 2 Raphiolepis indica

WATERPROOF WIRE CONNECTOR

ATMOSPHERIC VACUUM BREAKER

WIRE EXPANSION LOOPS

GALVANIZED STREET ELL

TOE NIPPLE OR MALE ADAPTER

VALVE BOX

FINISH GRADE

AUTOMATIC VALVE W/ ATMOSPHERIC

MAINLINE FITTING

GALVANIZED NIPPLE

24" TO 36" GALVANIZED NIPPLE

AUTOMATIC VALVE (SEE LEGEND)

CMU BLOCK

LATERAL PIPE

GRAVEL


REDUCER BUSHING

) GALVANIZED NIPPLE

(10) GALVANIZED ELBOW

BLUE CHIP JUNIPER (L+) 3 Juniperus horizontalis 'Blue Chip'

TAM JUNIPER (L+) 18 Juniperus sabina 'Tamariscifolia'

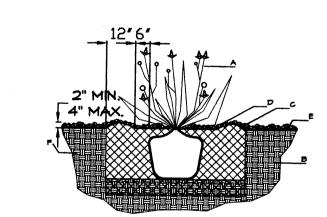

SHRUB PLANTING DETAIL NTS

GENERAL NOTES:

1. THE OUTSIDE DIAMETER OF THE WATER RETENTION BASIN SHALL BE TWICE THE DIAMETER OF THE SHRUB PLANTING PIT.

CONSTRUCTION NOTES

GALVANIZED NIPPLE - 18" TO 24" LENGTH A. SHRUB.

- B. BACKFILL WITH EXISTING SOIL.
- C. EARTH BERM AROUND WATER RETENTION BASIN. D. 3" DEPTH OF GRAVEL MULCH.
- E. FINISH GRADE.

F. UNDISTURBED SOIL.

LANDSCAPE CALCULATIONS

TOTAL LOT AREA square feet TOTAL BUILDINGS AREA 18605 square feet NET LOT AREA 111811 square feet LANDSCAPE REQUIREMENT 15% REQUIRED LANDSCAPE 16772 square feet REQUIRED GROUNDCOVER COVERAGE 12579 square feet TOTAL GROUNDCOVER PROVIDED square feet PROVIDED LANDSCAPING (NEW 30229 square feet AND EXISTING) EXISTING SOD 14235 (47%) square feet (max. 20% of landscape required)

NEW LANDSCAPING

LANDSCAPE BED PROVIDED 11572 square feet REQUIRED GROUNDCOVER PERCENT 75% square feet REQUIRED GROUNDCOVERAGE 8679 square feet GROUNDCOVER PROVIDED 8689 (75%) square feet

PAVERS square feet

CATMINT (M) 45 EXISTING LANDSCAPING Nepeta mussini 1 Gal. 45f LANDSCAPE BED PROVIDED 4031 square feet REQUIRED GROUNDCOVER PERCENT 75% BLUE AVENA/OAT GRASS (M) 67 square feet Helictotrichon sempervirens REQUIRED GROUNDCOVERAGE 3023 square feet 1 *Gal*. 3936 (95%) square feet GROUNDCOVER PROVIDED

GROUNDCOVERS

PLANT PALETTE

CHINESE PISTACHE (M) 14

Pistacia chinensis

SHUMARD OAK (M) 5

* AUSTRIAN PINE (M) 1

NEW MEXICO OLIVE (L) 3

Forestiera neomexicana

Multi-trunk B&B (2" Cal.)

Cercocarpus ledifolius

* BLUE SOTOL (L) 2

Dasylirion wheeleri

3/4" GRAY GRAVEL

MITH FILTER FABRIC

COBBLE WITH FILTER FABRIC TO A

MINIMUM DEPTH OF 3"

TO A MINIMUM DEPTH OF 3"

* DENOTES EVERGREEN MATERIAL

EXISTING

FLOWERING PEAR (M+) 1

5 Gal. 9sf

ASH (M) 5

Fraxinus spp.

Pyrus calleryana

* CURLLEAF MTN MAHOGANY(L+)

Quercus shumardii

2" Cal.

2" Cal.

Pinus nigra

15 Gal. 225 sf

Acer ginnala

5 Gal. 225 sf

AMUR MAPLE (M) 1

GREYLEAF COTONEASTER (M) 21 Cotoneaster buxifolius 5 Gal. 81sf Symbol indicates 3 plants

ENGLISH IVY (M) 1 Hedera helix

EXISTING LANDSCAPING TO REMAIN

Netafim Spiral Detai

SHRUBS/ORNAMENTAL GRASSES

5 Gal. 100sf

Photinia fraser

5 Gal. 64sf

5 Gal. 25sf

5 Gal. 16sf

1 Gal. 165f

Fallugia paradoxa

Cytisus scoparius

MOCK ORANGE (M) 4

* APACHE PLUME (L) 31

* LENA'S BROOM (M) 36

Artemisia X Powis Castle

DEER GRASS (M) 26 Muhlenbergia rigens

* PONIS CASTLE SAGE (L+) 52

Philadelphus cultivars

* PHOTINIA (M+) 11

FIVE GAL.

ONE GAL

PAVERS

PARKING LOT TREE REQUIREMENTS

Shade trees required under the City Of Albuquerque Parking Lot Tree Ordinance are as follows:

1 Shade tree per 10 spaces Required # 15 Existing # 5 Provided # 10

STREET TREE REQUIREMENTS

Street trees required under the City Of Albuquerque Street Tree Ordinance are as follows:

Name of Street: Comanche Required # 9 Existing # 2 Provided # 7

Name of Street: Mountainside Parkway parking Required #3 Existing #1 Provided #2

NOTE TO CLIENT:

Should The Hilltop not receive a Grading and Drainage plan during the design process or the on-site grades differ from the Grading and Drainage plan received, The Hilltop reserves the right to apply slope stabilization materials where the specified gravel will not be suitable. Gravel smaller than 2-4" cobblestone will not stay on a slope greater than 3:1. If the grades are greater than what was originally designed, we will request an infield change-order to lay cobblestone or rip-rap, in lieu of the specified gravel, to stabilize the slope. All vegetative material shall remain per plan.

TREE PLANTING DETAIL

GENERAL NOTES:

Tree Trunk

Emitter-12" o.c.

Root Ball

1. ROOTBALL SHALL BE PLACED ON UNDISTURBED SOIL TO PREVENT TREE FROM SETTLING.

2. TOP OF ROOTBALL INDICATED LEVEL AT WHICH TREE WAS GROWN AND DUG; THIS REPRESENTS THE LEVEL AT WHICH THE TREE SHOULD BE INSTALLED; THAT LEVEL MAY Fax (505) 898-7737 BE EXCEEDED BY ONLY A ONE INCH LAYER OF SOIL. 3. PRIOR TO BACKFILLLING TREE, ALL WIRE, ROPE AND SYNTHETIC MATERIALS SHALL BE REMOVED FROM THE TREE AND THE PLANTING PIT.

4. PRIOR TO BACKFILLING ALL BURLAP SHALL BE CUT AWAY EXCEPT FROM BOTTOM OF THE ROOTBALL.

CONSTRUCTION NOTES:

A. TREE B. BACKFILL WITH EXISTING SOIL

C. 3" DEPTH OF GRAVEL MULCH. D. UNDISTRUBED SOIL.




Cont. Lic. #26458 7909 Edith N.E. Albuquerque, NM 87184 Ph. (505) 898-9690 cm j@hilltoplandscaping.com All creative ideas contained Herein remains the property of The Hilltop Landscape Architects and

Contractors and are protected by copyright laws. This is an original design and must not be released or copies unless applicable fees have been paid or job order






ARCHITECT

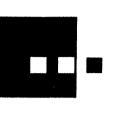

architectu interio landsca plannir engineeri

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PROJECT

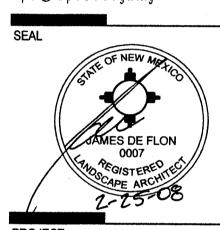NM NM Om ゴ 0 **W** 500 bng S 1

REVISIONS 3 9-19-07 mm

mm epc &client comments 5 10-10-07 mm add ex. landscaping

6 12/04/07 rmm site revision

7 2-11-08 mm site rev and comments

8 2-21-08 cmj water harvesting curb cuts 9 2-25-08 cmj/rm comments

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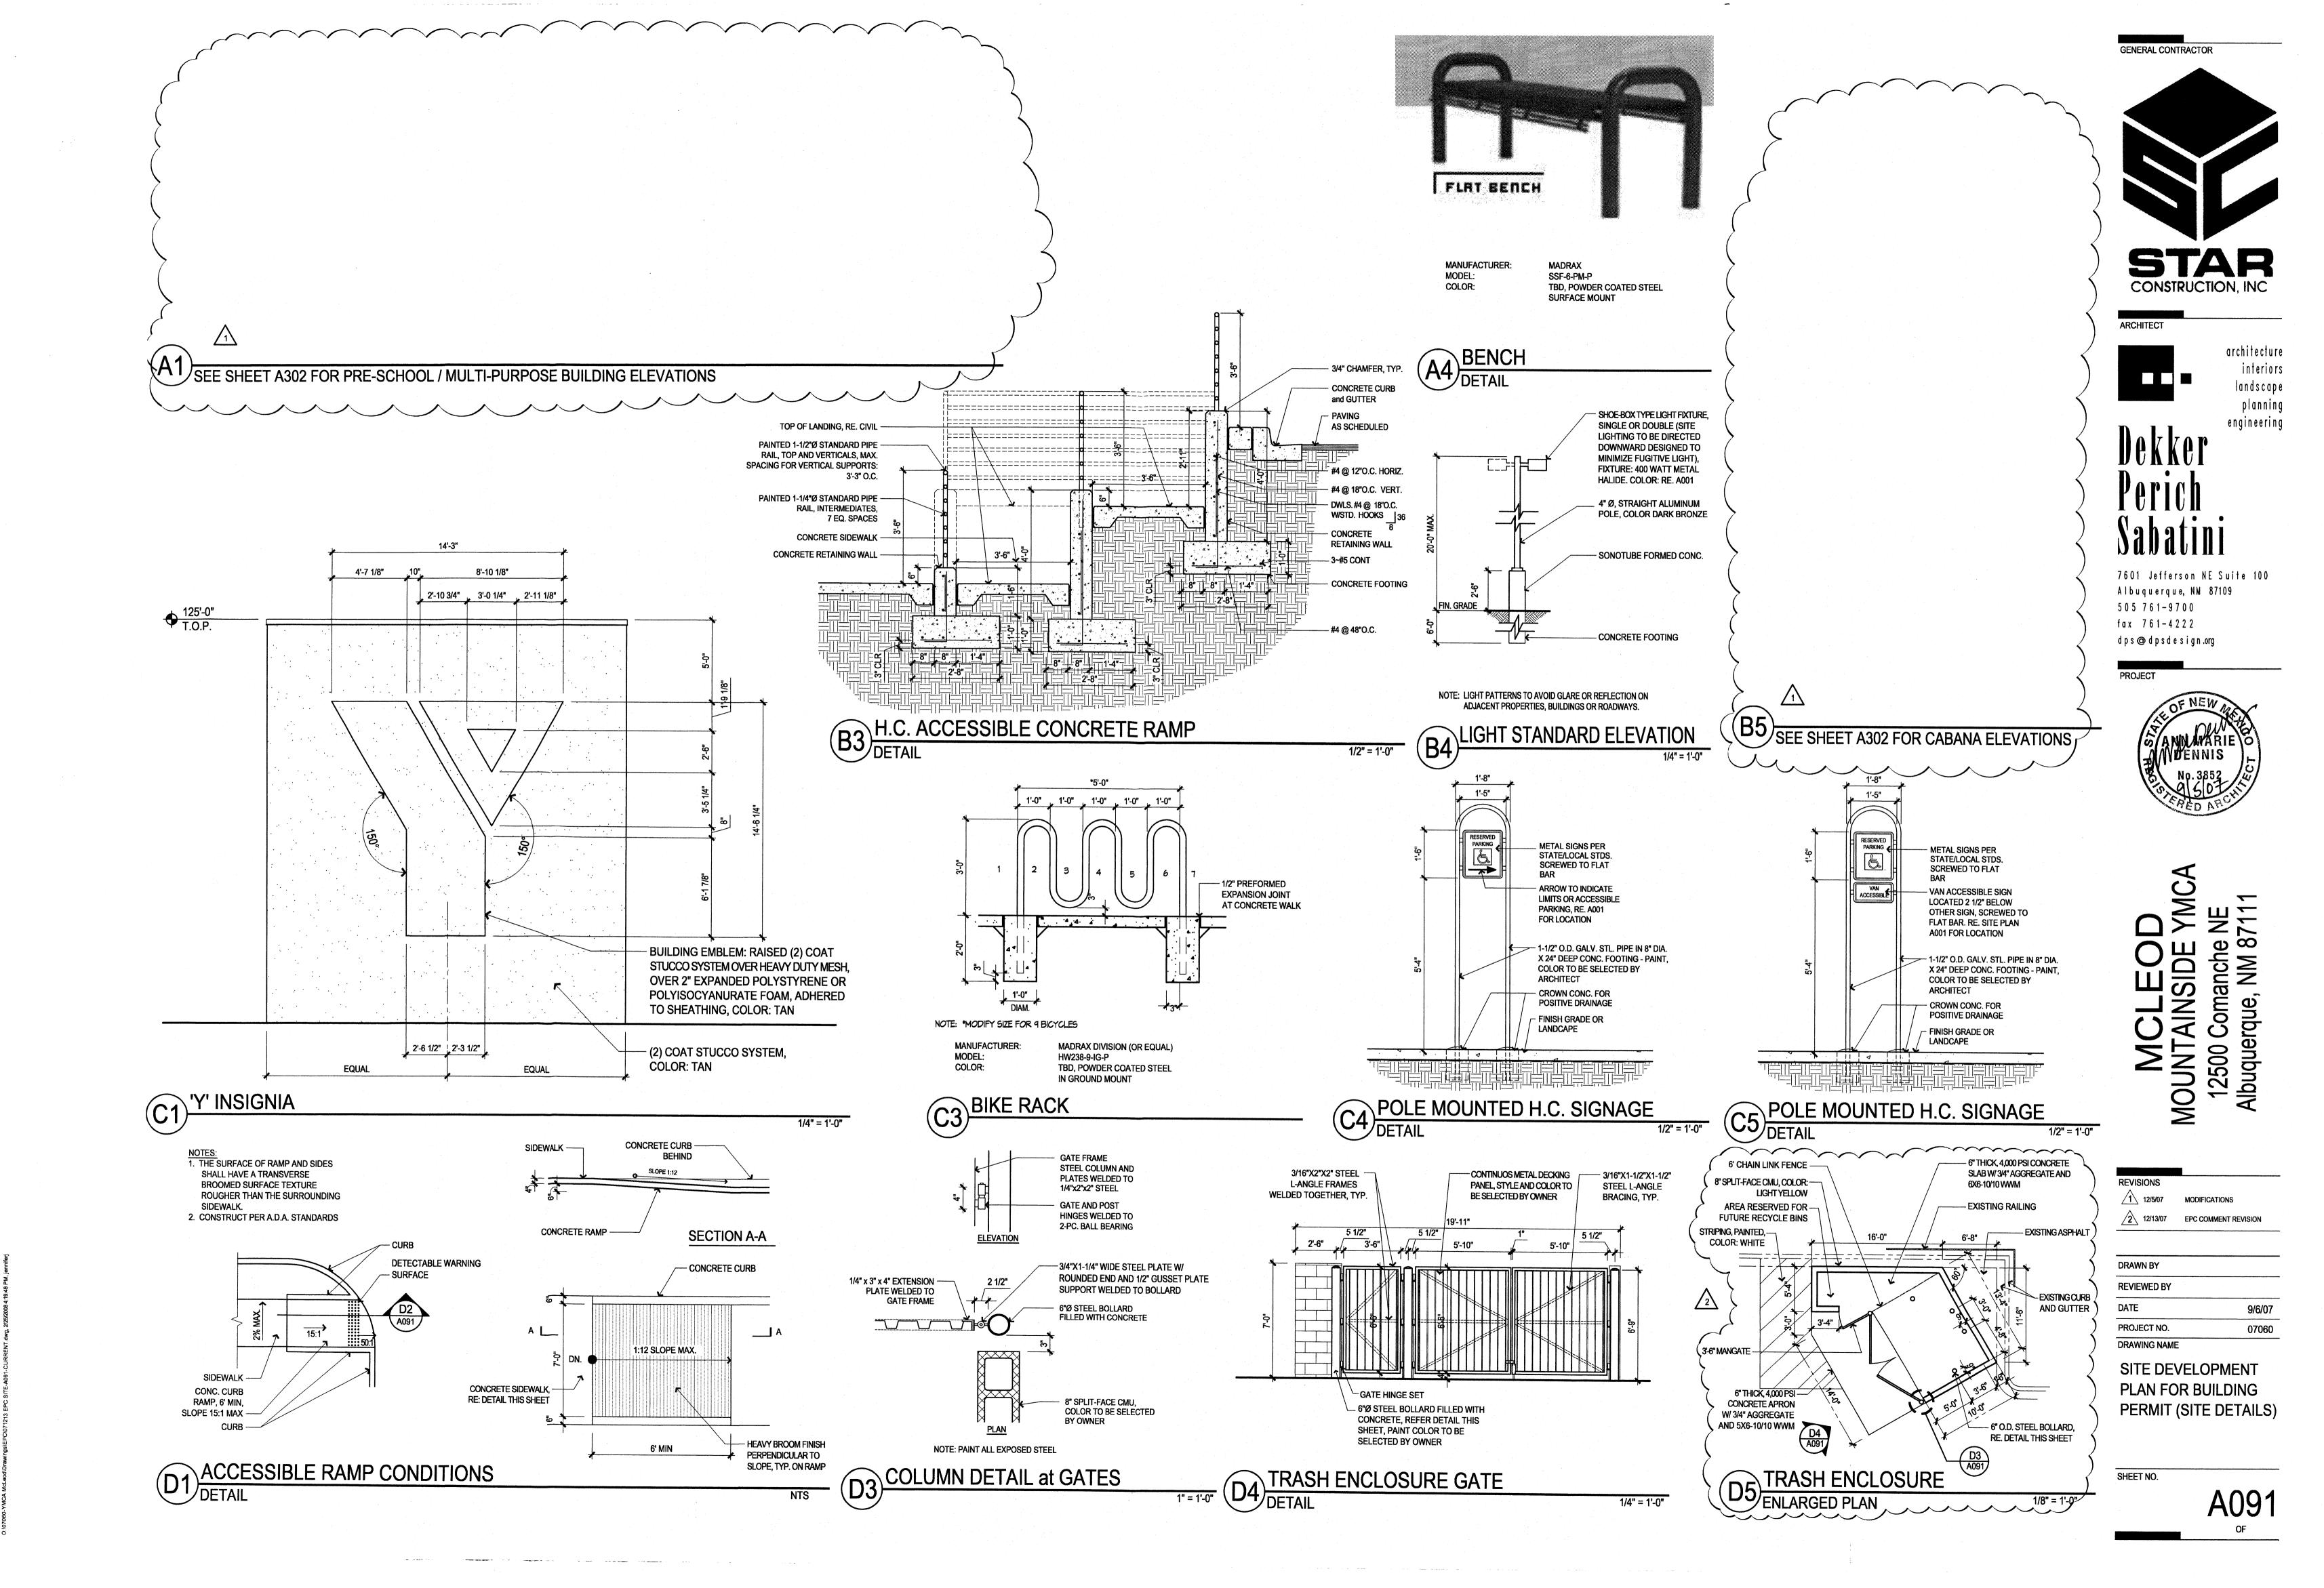
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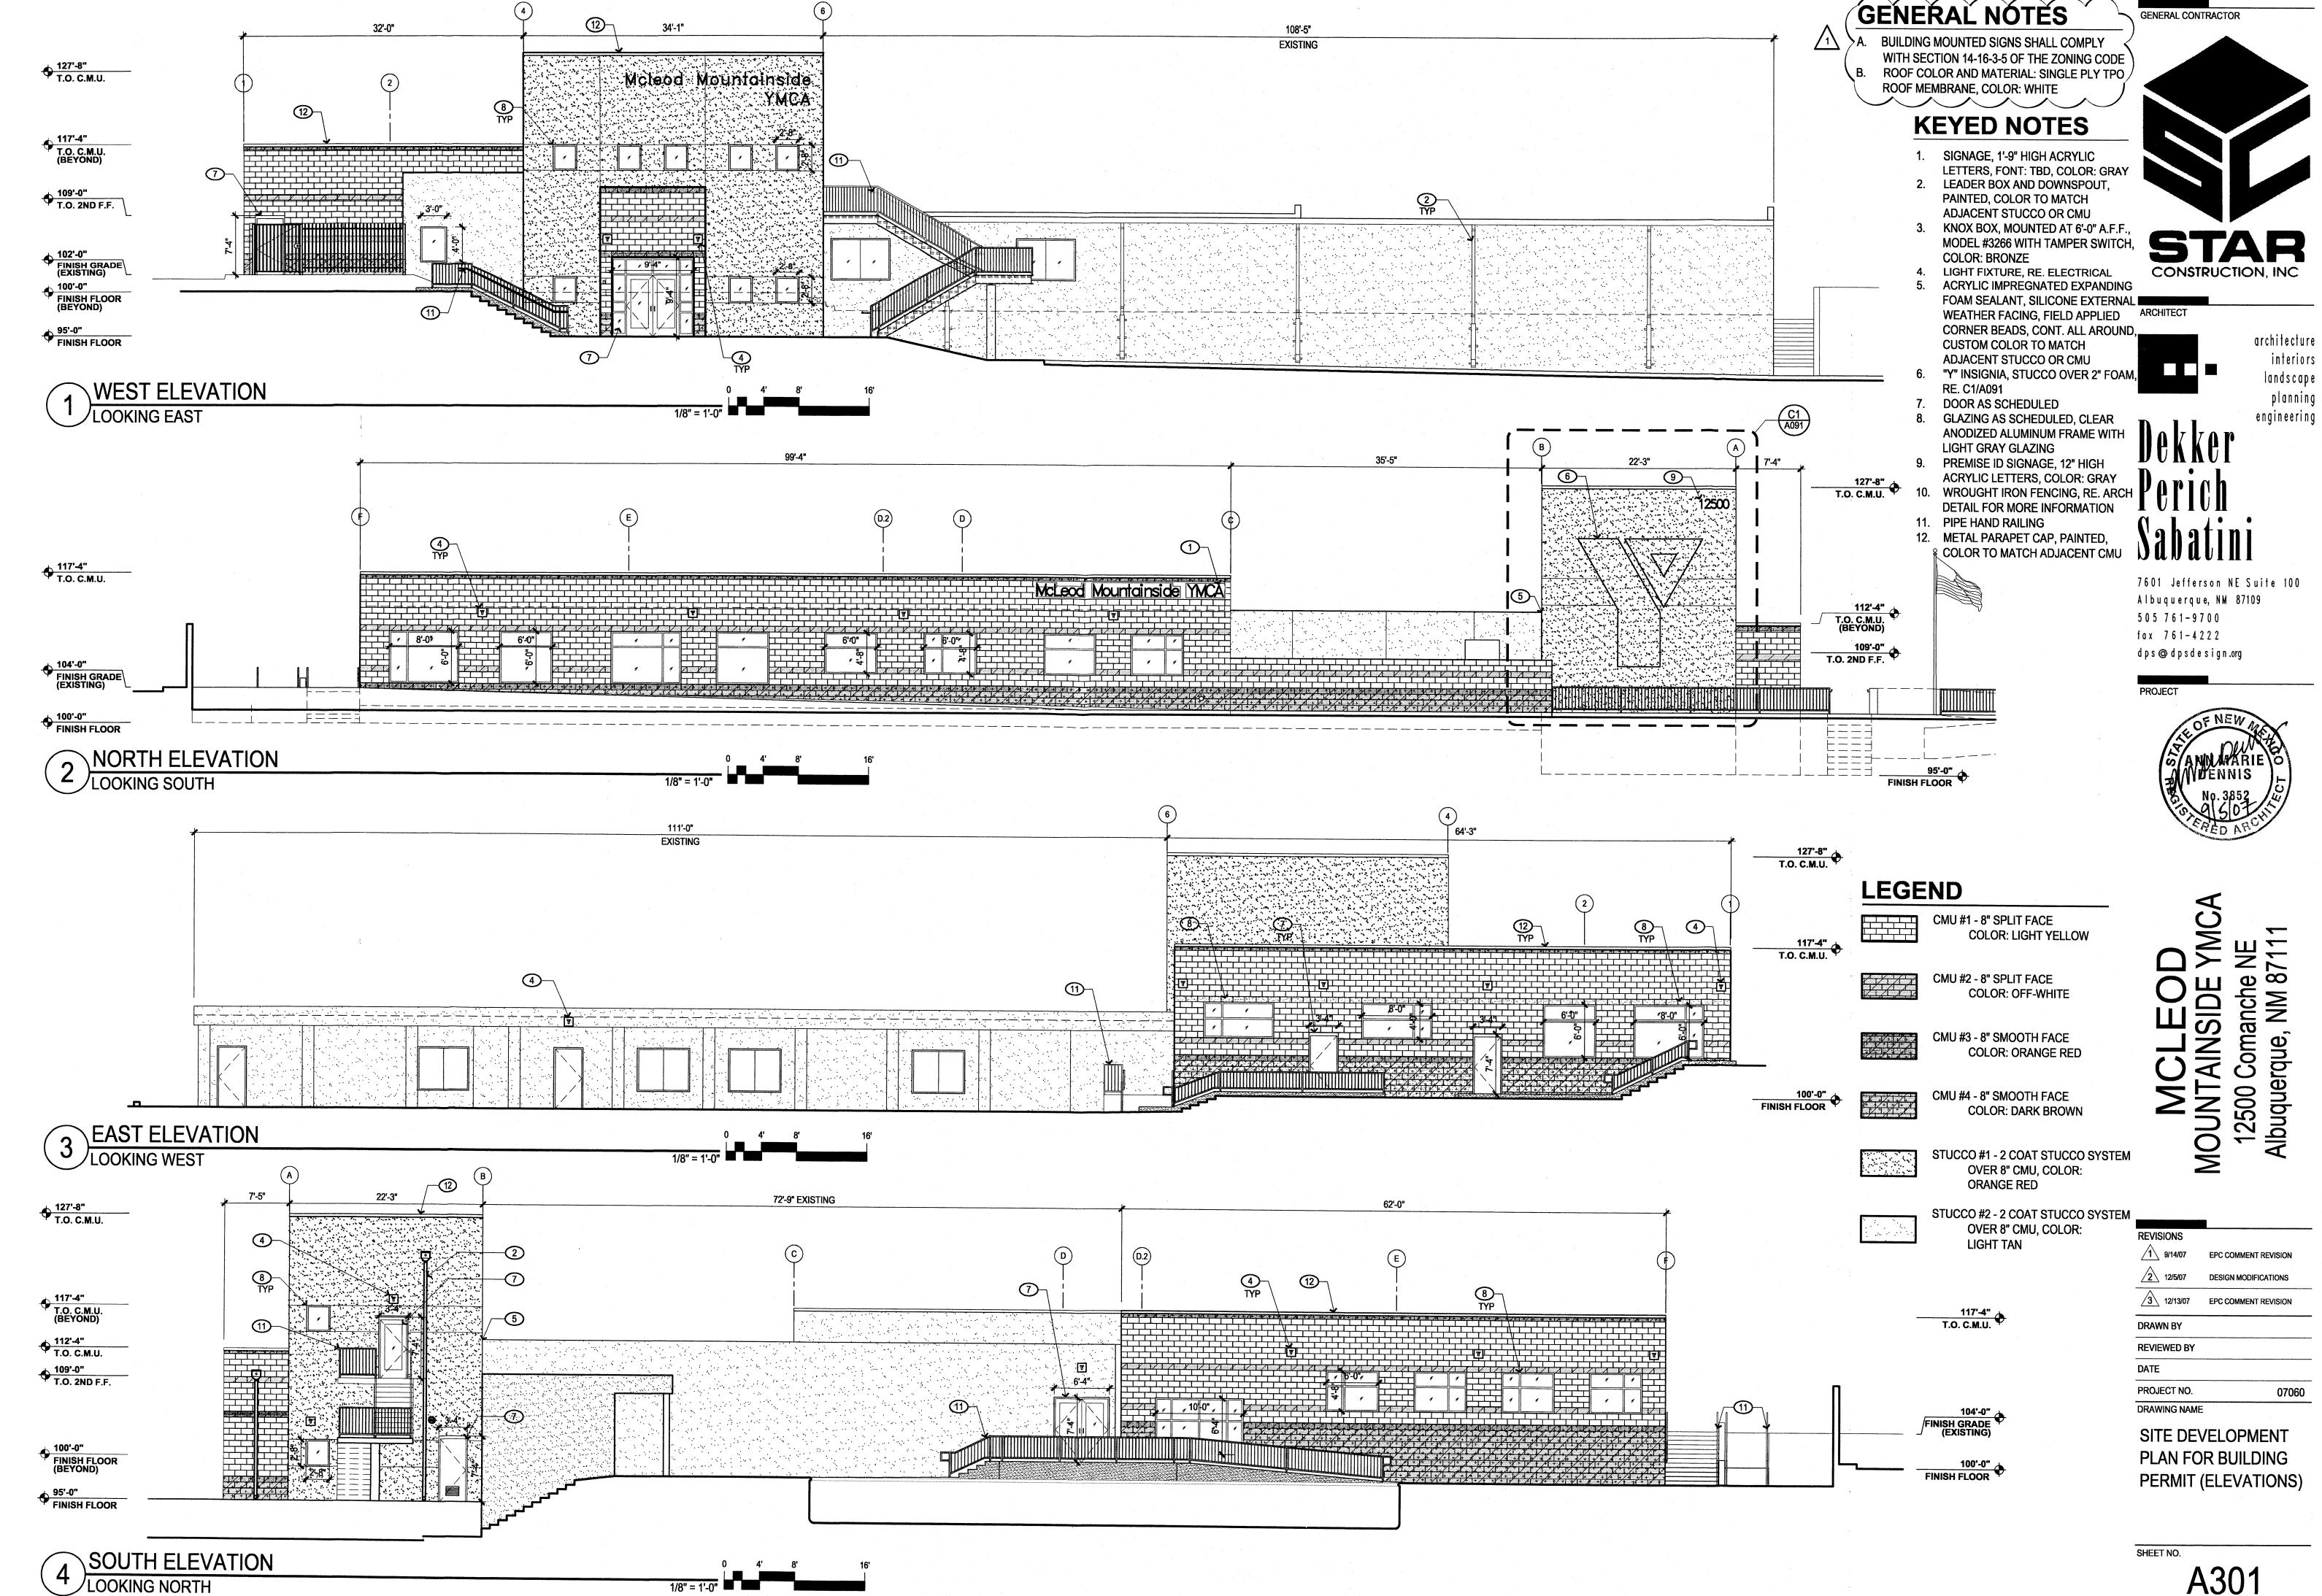
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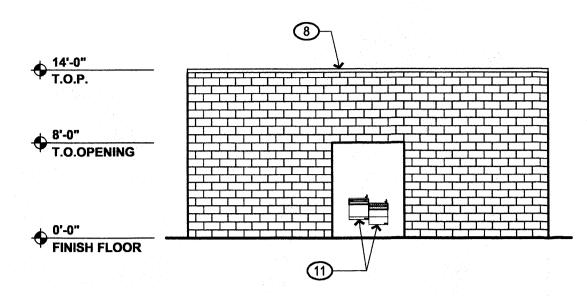
LANDSCAPING PLAN

SHEET NO.


_001








WEST ELEVATION - CABANA 1/8" = 1'-0" **LOOKING EAST**

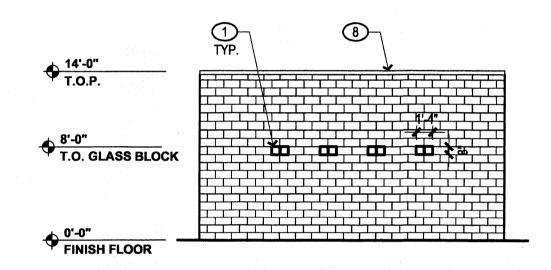


NORTH ELEVATION - CABANA LOOKING SOUTH

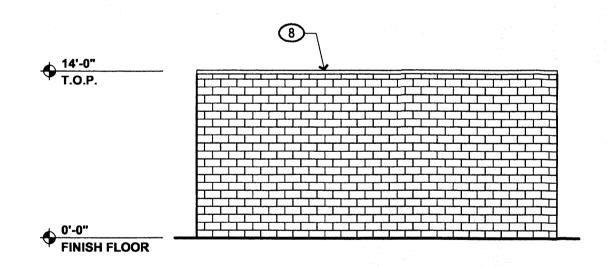


1/8" = 1'-0"

1/8" = 1'-0"

EAST ELEVATION - CABANA LOOKING WEST 1/8" = 1'-0"

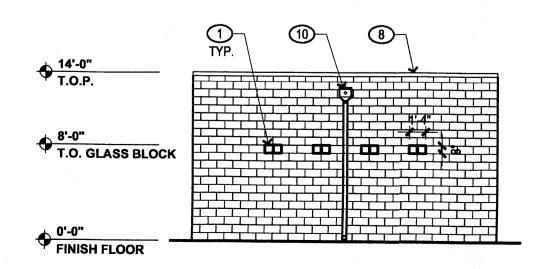

SOUTH ELEVATION - CABANA LOOKING NORTH

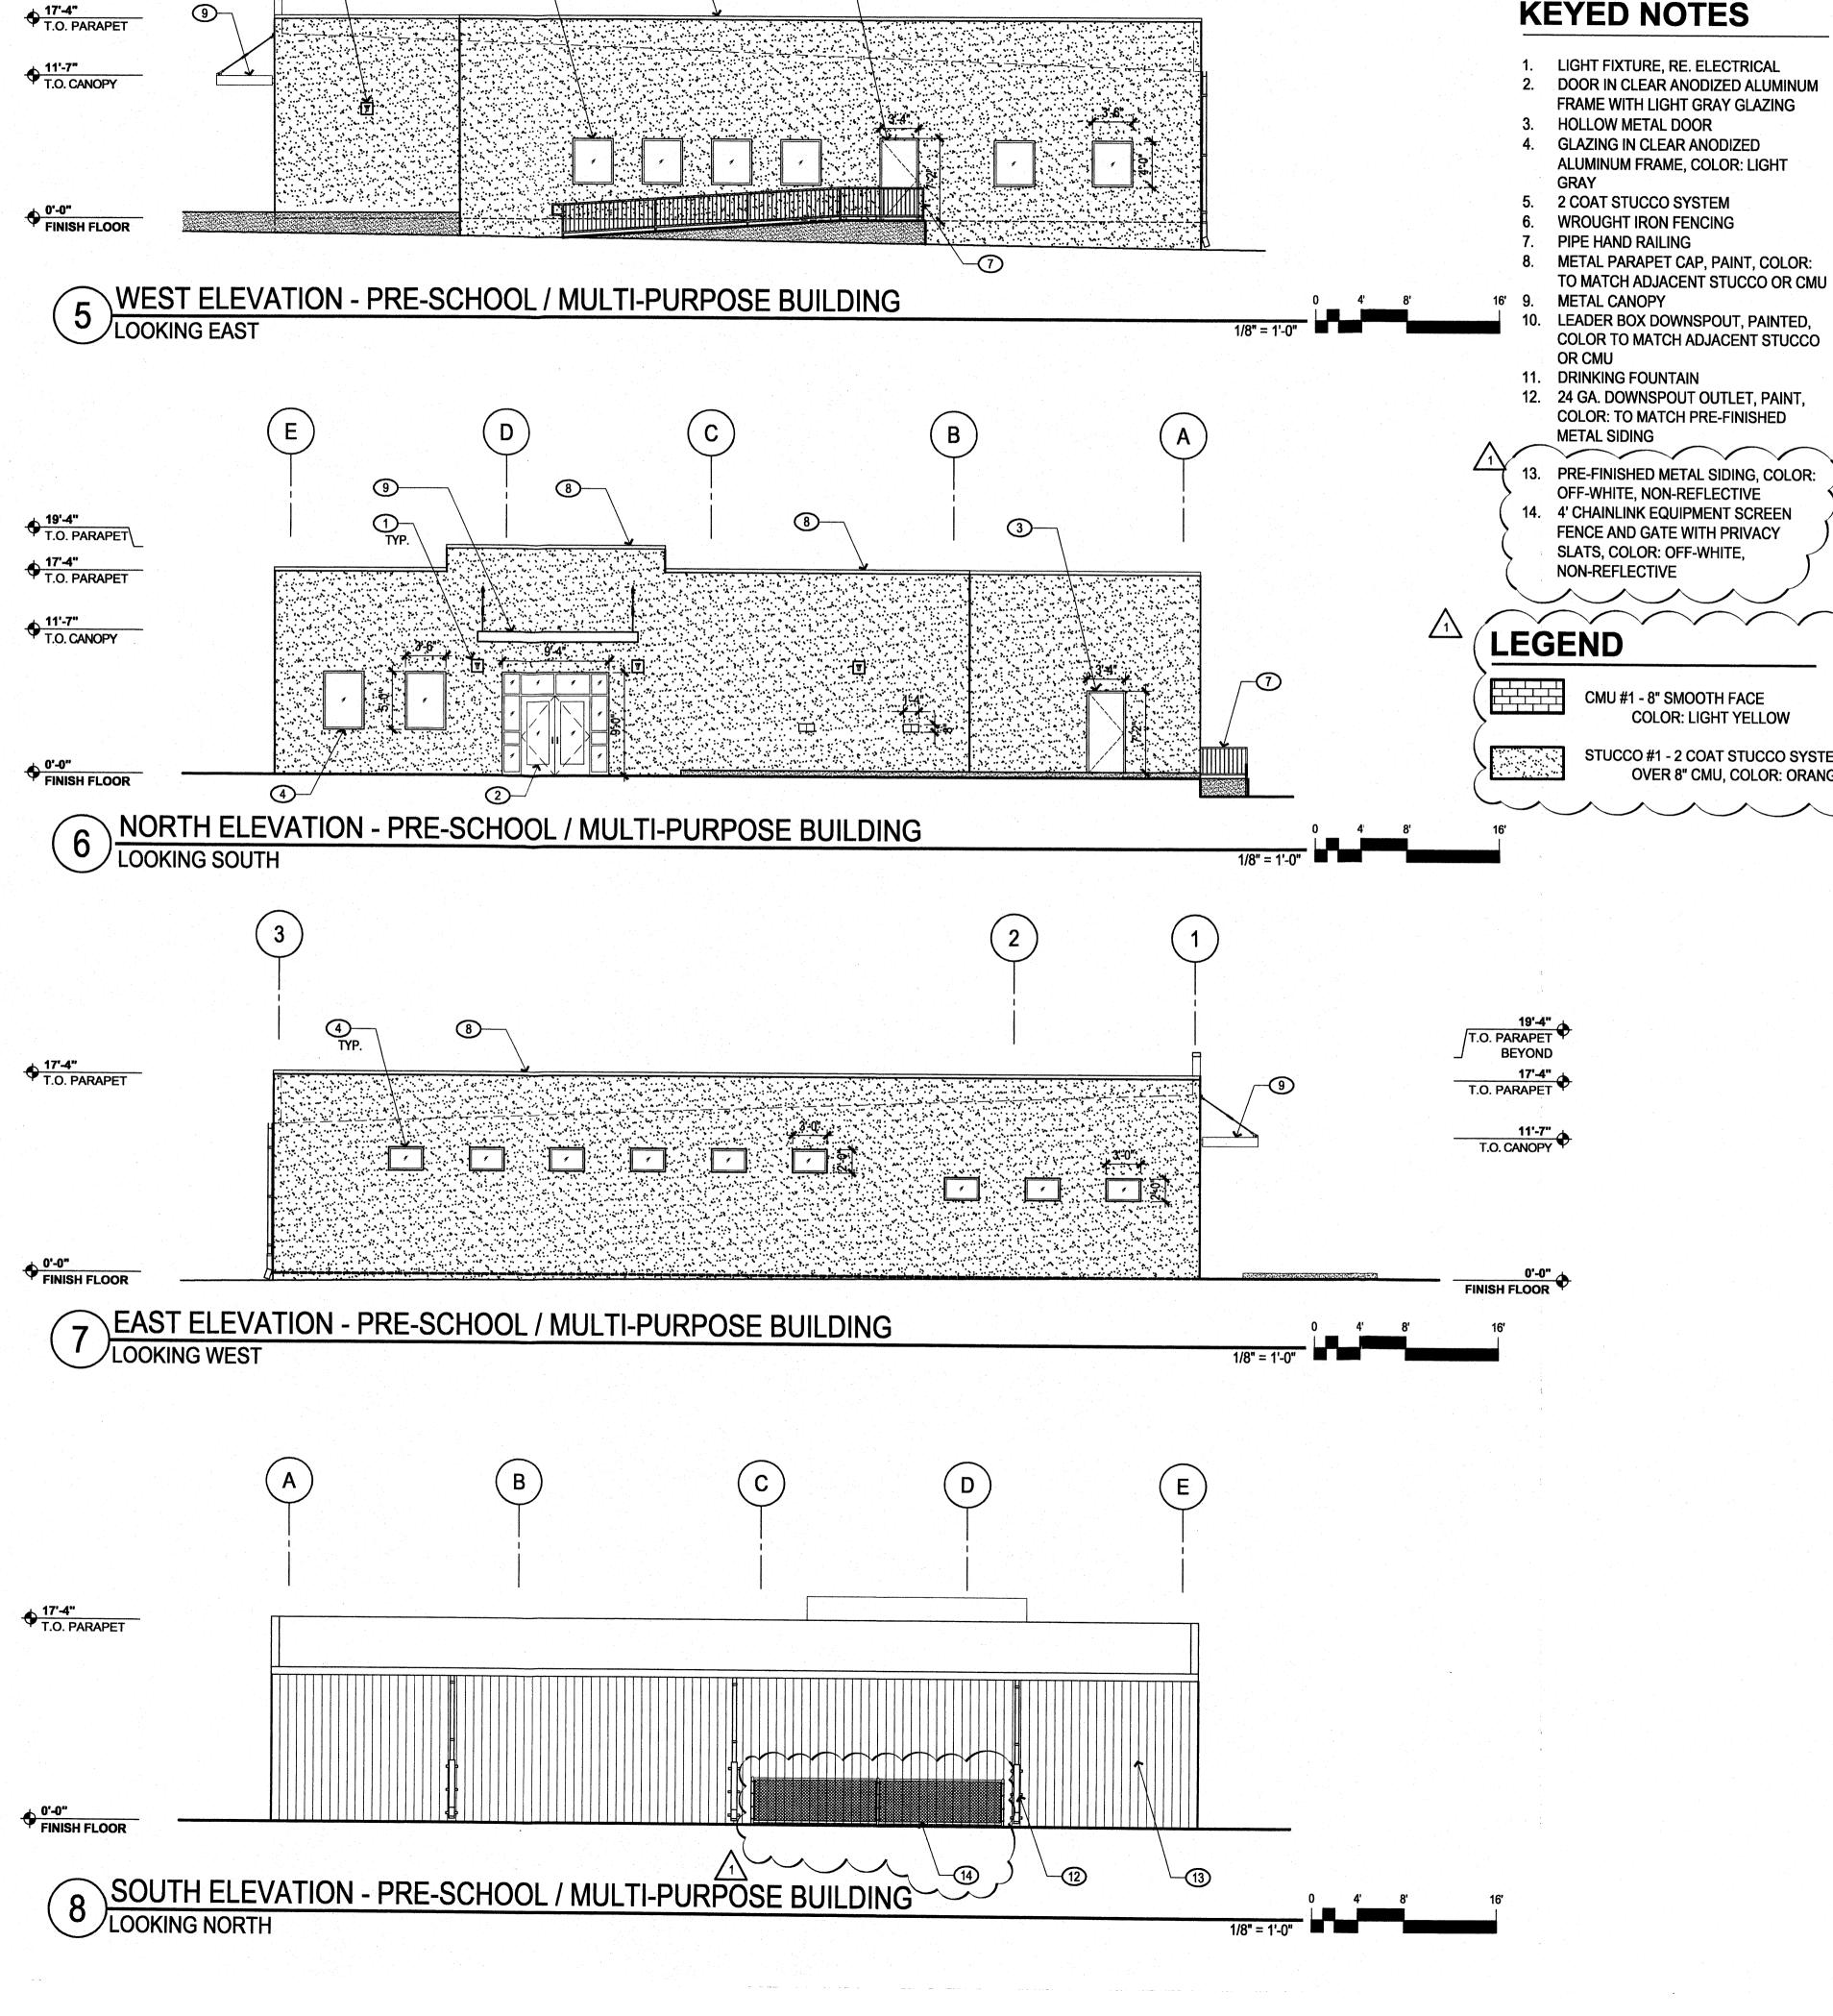

4)— TYP

19'-4"
T.O.PARAPET\
BEYOND

GENERAL NOTES

A. BUILDING MOUNTED SIGNS SHALL COMPLY WITH SECTION 14-16-3-5 OF THE ZONING CODE ROOF COLOR AND MATERIAL: SINGLE PLY TPO ROOF MEMBRANE, COLOR: WHITE

KEYED NOTES


3

- LIGHT FIXTURE, RE. ELECTRICAL DOOR IN CLEAR ANODIZED ALUMINUM FRAME WITH LIGHT GRAY GLAZING
- **HOLLOW METAL DOOR** GLAZING IN CLEAR ANODIZED ALUMINUM FRAME, COLOR: LIGHT
- 5. 2 COAT STUCCO SYSTEM WROUGHT IRON FENCING
- PIPE HAND RAILING METAL PARAPET CAP, PAINT, COLOR:
- METAL CANOPY LEADER BOX DOWNSPOUT, PAINTED,
- COLOR TO MATCH ADJACENT STUCCO **DRINKING FOUNTAIN**
- 12. 24 GA. DOWNSPOUT OUTLET, PAINT, COLOR: TO MATCH PRE-FINISHED METAL SIDING
- 13. PRE-FINISHED METAL SIDING, COLOR: OFF-WHITE, NON-REFLECTIVE 14. 4' CHAINLINK EQUIPMENT SCREEN

FENCE AND GATE WITH PRIVACY SLATS, COLOR: OFF-WHITE,

CMU #1 - 8" SMOOTH FACE COLOR: LIGHT YELLOW

STUCCO #1 - 2 COAT STUCCO SYSTEM
OVER 8" CMU, COLOR: ORANGE RED

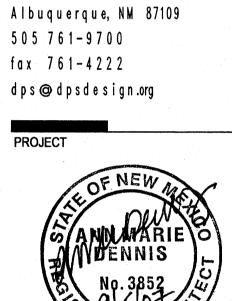

7601 Jefferson NE Suite 100

Perich

architecture

interiors

landscape

planning

engineering

GENERAL CONTRACTOR

Albuquerque, NM 87

DRAWN BY **REVIEWED BY** PROJECT NO.

SITE DEVELOPMENT PLAN FOR BUILDING PERMIT (ELEVATIONS)

SHEET NO.

DRAWING NAME