Acity of lbuquerque



DEVELOPMENT/ PLAN REVIEW APPLICATION

Updated 4/16/15

	Supplemental		
SUBDIVISION Major subdivision action	S	z zonii	NG & PLANNING Annexation
Minor subdivision action			Alliendadii
Vacation Variance (Non-Zoning)	V		Zone Map Amendment (Establish or Change Zoning, includes Zoning within Sector
SITE DEVELOPMENT PLAN	Р		Development Plans) Adoption of Rank 2 or 3 Plan or similar
for Subdivision _X for Building Permit			Text Amendment to Adopted Rank 1, 2 or 3 Plan(s), Zoning Code, or Subd. Regulations
Administrative Amendme			Plan(s), Zoning Code, or Subd. Regulations
Administrative Approval (IP Master Development F	Plan D		Street Name Change (Local & Collector)
Cert. of Appropriateness	: L	A APPE	AL / PROTEST of
STORM DRAINAGE (Form D) Storm Drainage Cost Allo			Decision by: DRB, EPC, LUCC, Planning Director, ZEO, ZHE, Board of Appeals, other
PRINT OR TYPE IN BLACK INK ONL Planning Department Development Ser Fees must be paid at the time of application information:	Y. The applicant or ac vices Center, 600 2 ^{nd s} <u>ation.</u> Refer to suppler	gent must sub Street NW, Alb nental forms f	mit the completed application in person to the ouquerque, NM 87102. or submittal requirements.
Professional/Agent (if any): Tierra We	st, LLC		PHONE: 505-858-3100
ADDRESS: 5571 Midway Park Place	• NW		FAX:
CITY: Albuquerque	STATE NM		E-MAIL: rrb@tierrawestllc.com
APPLICANT: ABQ Comache Retail,	LLC		PHONE: <u>214-561-6515</u>
ADDRESS: 8350 N. Central Expy.			FAX:
CITY:Dallas	STATE <u>TX</u>	_ ZIP_75206	E-MAIL: hollier@paliopartners.com
Proprietary interest in site: Owner	List	: <u>all</u> owners:	
DESCRIPTION OF REQUEST: Site Plan	n for Building Permit		
Subdiv/Addn/TBKA:SRCC_Albuquere Existing Zoning:M-1 Zone Atlas page(s): _G-15-Z	que Carpenters Trainin Proposed zor	g Center ning: M-1	Block: Unit: MRGCD Map No 101606018334720664
CASE HISTORY: List any current or prior case number that a 1006865, Z	•	lication (Proj., Ap	p., DRB-, AX_,Z_, V_, S_, etc.):
CASE INFORMATION:			
Within city limits? <u>x</u> Yes	Within 1000FT of a landfill?	N/A	
_			ite area (acres): 2.6023 +/-
LOCATION OF PROPERTY BY STREETS	: On or Near:Inters	tate - 25	
			e Rd. NE
			riew Team(PRT) □. Review Date:
SIGNATURE			DATE 2.16.2018
(Print Name) Ronald R. Boha	nnan		Applicant: □ Agent: ☒
FOR OFFICIAL USE ONLY			Revised: 11/2014
☐ INTERNAL ROUTING	Application case numb	ers	Revised: 11/2014 Action S.F. Fees
☐ INTERNAL ROUTING☐ All checklists are complete	Application case numb	ers	Action S.F. Fees \$
☐ INTERNAL ROUTING			Action S.F. Fees \$ \$
 □ INTERNAL ROUTING □ All checklists are complete □ All fees have been collected □ All case #s are assigned □ AGIS copy has been sent 			Action S.F. Fees \$ \$ \$
☐ INTERNAL ROUTING ☐ All checklists are complete ☐ All fees have been collected ☐ All case #s are assigned ☐ AGIS copy has been sent ☐ Case history #s are listed			Action S.F. Fees \$ \$ \$ \$
☐ INTERNAL ROUTING ☐ All checklists are complete ☐ All fees have been collected ☐ All case #s are assigned ☐ AGIS copy has been sent ☐ Case history #s are listed			Action S.F. Fees \$ \$ \$

Project #

FORM P(2): SITE PLAN REVIEW - D.R.B. PUBLIC HEARING

	5 Acres or more & zone Scaled site plan and rel Zone Atlas map with the Letter briefly describing Letter of authorization fi Copy of the document of Office of Community & I Sign Posting Agreemen Completed Site Plan for 6 copies of the Infrastru TIS/AQIA Traffic Impact Fee (see schedule) List any original and/or	ated drawings (folded to fit into e entire property(ies) clearly on explaining, and justifying the rom the property owner if applielegating approval authority to Neighborhood Coordination in to the Subdivision Checklist cure List, if relevant to the site Study form with required significant significant states and the content of the content of the content of the site of the si	pping Center: Certificate of No E o an 8.5" by 14" pocket) 24 cop utlined request ication is submitted by an agent o the DRB quiry response, notifying letter, a	ies
	SITE DEVELOPMENT P x 36"	LAN FOR BUILDING PER	MIT (DRB14)	Maximum Size: 24"
	X Site Plan and related draw Site Plan for Subdivision by 14" pocket.) 24 of Solid Waste Managemer Zone Atlas map with the Letter briefly describing, Letter of authorization from Copy of the document of Sign Posting Agreement Completed Site Plan for N/A 6 copies of the Infrastructure Copy of Site Plan with Face (see schedule) List any original and/or results in the Sign Posting Agreement Sign Posting Agreemen	awings (folded to fit into an 8.5 n, if applicable, previously appropies for DRB public hearings and Department signature on Se entire property(ies) precisely explaining, and justifying the om the property owner if applielegating approval authority to Neighborhood Coordination in to Building Permit Checklist cure List, if relevant to the site Study form with required signific Marshal's stamp	roved or simultaneously submitted in the Plan and clearly outlined and crossh request ideation is submitted by an agent to the DRB quiry response, notifying letter, one plan that items is the plan in the plan i	ted. (Folded to fit into an 8.5" atched (to be photocopied) certified mail receipts
	Proposed amended Site DRB signed Site Plan be DRB signed Site Plan for Zone Atlas map with the Letter briefly describing, Letter of authorization fr Office of Community & N Sign Posting Agreement Completed Site Plan for 6 copies of the Infrastruct TIS/AQIA Traffic Impact Fee (see schedule) List any original and/or r	er BUILDING PERMIT (DR Plan (folded to fit into an 8.5' eing amended (folded to fit into a Subdivision, if applicable (referential property) entire property (ies) clearly out explaining, and justifying the om the property owner if application in the property owner is application. The property owner is application in the property owner is application in the property owner is application.	by 14" pocket) 24 copies o an 8.5" by 14" pocket) 24 copies o an 8.5" by 14" pocket) 24 copies outlined when amending SDP for attituded to the submitted by an agent quiry response, notifying letter, outlined to the submitted by an agent attired for amendment of SD e plan attire	Building Permit) 24 copies certified mail receipts P for Subdivision)
info with	he applicant, acknowledge ormation required but not so this application will likely erral of actions.	ubmitted	Ronald R. Bohannar Applicant r Applicant sign	name (print) 2 · Iu · 2018 ature / date
	Checklists complete Fees collected	Application case numbers		
	Case #s assigned Related #s listed		Project #	Planner signature / date

SIGN POSTING REQUIREMENTS

POSTING SIGNS ANNOUNCING PUBLIC HEARINGS

All persons making application to the City under the requirements and procedures established by the City Zoning Code or subdivision Ordinance are responsible for the posting and maintaining of one or more signs on the property, which the application describes. Vacations of public rights-of-way (if the way has been in use) also require signs. Waterproofed signs will be provided at the time of application. If the application is mailed, you must still stop at the Planning Division to pick up the sign.

The applicant is responsible for ensuring that the signs remain posted throughout the 15-day period prior to public hearing. Failure to maintain the signs during this entire period may be cause for deferral or denial of the application. Replacement signs for those lost or damaged are available from the Planning Division at a charge of \$3.00 each.

1. LOCATION

- A. The sign shall be conspicuously located. It shall be located within twenty feet of the public sidewalk (or edge of public street). Staff may indicate a specific location.
- B. The face of the sign shall be parallel to the street, and the bottom of the sign shall be two to seven feet from the ground.
 - C. No barrier shall prevent a person from coming within five feet of the sign in order to read it.

2. NUMBER

4. TIME

Rev. 11/8/90

- A. One sign shall be posted on each paved street frontage. Signs maybe required on unpaved street frontages.
- B. If the land does not abut a public street, then in addition to a sign placed on the property a sign shall be placed on and at the edge of the public right-of-way of the nearest paved City street. Such a sign must direct readers toward the subject property by an arrow and an indication of distance.

3. PHYSICAL POSTING

- A. A heavy stake with two crossbars or full plywood backing works best to keep the sign in place, especially during high winds.
- B. Large headed nails or staples are best for attaching signs to a post or backing; the sign tears out less easily.

5.	MOVAL	
	The sign is not to be removed before the initial hearing on the request.The sign should be removed within five (5) days after the initial hearing.	
obl	ead this sheet and discussed it with the Planning Division staff. I understand (A) my on to keep the sign(s) posted for fifteen (15) days and (B) where the sign(s) are to be locating given a copy of this sheet.	ıted
	(Applicant or Agent) (Date)	
lis	signs for this application,,	

(Date)

APPLICATION NUMBER:

(Staff Member)

Signs must be posted from To

970N

TIERRA WEST, LLC

February 16, 2018

Ms. Kym Dicome, Chair Development Review Board City of Albuquerque P.O. Box 1293 Albuquerque, NM 87103

RE: SITE DEVELOPMENT PLAN FOR BUILDING PERMIT

LOT3 PLAT OF LTS 1, 2, 3 & 4 SRCC

ALBUQUERQUE CARPENTERS TRAINING CENTER

ZONE ATLAS PAGE G-16-Z

Dear Chairwoman Dicome:

Tierra West, LLC, on behalf ABQ Comanche Retail, LLC, requests approval of a Site Development Plan for Building Permit for Lot 3, SRCC Albuquerque Carpenters Training Center for a new entertainment facility development on a currently vacant property.

Site Location and History

The project site is located on Pan American Freeway at the southwest corner of Vassar Drive NE. This application requests approval for the entertainment/restaurant portion containing approximately 2.6023 +/- acres. We believe this proposed project is in substantial compliance with the approved Site Plan for Subdivision previously approved by an Administrative Amendment.

Site Orientation

The site is currently one parcel and will remain so for this project. Access will be via a private road between Pan American Freeway and Vassar Drive. This request is only for the development of Lot 3.

The 35,040 square foot building will house jumping facilities like trampolines, games and a dining area. A patio will be located near the front entrance facing north and the loading area will be on the south side of the building.

An internal roadway provides vehicular, pedestrian and bicycle connections between the parcels and to the adjoining streets. A trip generation analysis was completed comparing the original office and commercial uses with this use showing a reduction in trips for this property.

Elevations and Signage

The building is designed primarily with textured concrete panels accented with integral color split face block. To break up the building massing vertically and horizontally, different shades of grey and tan colored painted concrete with colored texture panels accented with lights are used to accentuate wall plane articulations. An entryway on the main façade accentuates the building entrance and colored lighting is used on the main front and side facades for visual interest. Matching grey screen walls will be used for the trash compactor area.

Signage for the project will be limited to the building. Existing joint tenant signs may be used as well. Colored renderings of the building and the signage are enclosed with this submittal.

Drainage and Landscaping

The drainage for the property is part of an overall grading and drainage plan completed for the Carpenter's Training Center and complies with that plan. Ultimately the storm water from this site is conveyed to the existing regional Griegos Pond located west of Interstate 25. The project will utilize Low Impact Development (LID) to improve water quality prior to discharging from the site.

Landscaping

The landscape design was developed to meet the design guideline requirements set forth in the approved Site Development Plan for Subdivision and compliments the existing landscaping around the Carpenters Training Center.

Conclusion

The request conforms to the existing development guidelines outlined in the Site Plan for Subdivision approved with the Carpenters Training Center project as well as to the DPM requirements and standards. We ask the proposed action be approved.

If you have any questions or need additional information regarding this matter, please do not hesitate to contact me.

Sincerely.

Ronald R. Bohannan, P. E.

Enclosure/s

cc: Brendon Hollier

JN: 2017042 RRB/JN/jg



City of Albuquerque P.O. Box 1293 Albuquerque, New Mexico 87103

Planning Department

Deborah Stover, Director

Richard J. Berry, Mayor Robert J. Perry, CAO

May 9, 2014	
SUBJECT: ALBUQUI	ERQUE ARCHAEOLOGICAL ORDINANCE—Compliance
Documentation	
Project Number(s):	1006865
	DRB-98-294, DRB-98-299
Agent:	Tierra West, LLC
Applicant:	Southwest Regional Council of Carpenters
Legal Description:	TR A-1-A Plat of TR A-1-A Comanche Business Park
Zoning:	M-1
Acreage:	15.63
Zone Ätlas Page:	G-16-Z
CERTIFICATE OF NO	EFFECT: YesX_ No
CERTIFICATE OF AF	PPROVAL: Yes No
TREATMENT PLAN	REVIEW:
DISCOVERY:	
SUPPORTING DOCU	MENTATION:
	tural Resources Inventory of 13.34 Acres for a Proposed Industrial

RECOMMENDATION(S):

CERTIFICATE OF NO EFFECT IS ISSUED (ref 0-07-72 Section 4B(1)-- no significant sites in project area)


Park on Vassar Drive, Albuquerque, Bernalillo County, New Mexico by Douglas H.M. Boggess

(Lone Mountain Archaeological Services, Inc. October 22, 2007)

SUBMITTED:

Matthew Schmader, PhD Superintendent, Open Space Division City Archaeologist

Address: 3930 Pan American Freeway NE Albuquerque NM 87107

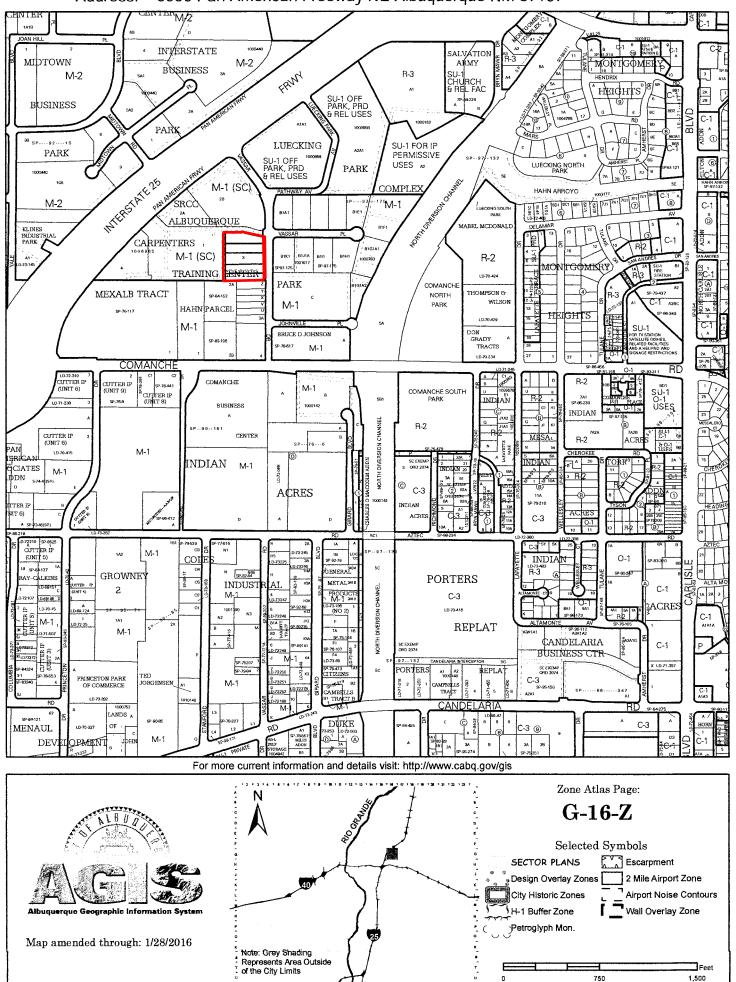

Jaimie Garcia

From: Quevedo, Vicente M. <vquevedo@cabq.gov>

Sent: Thursday, February 08, 2018 1:33 PM

To: Jaimie Garcia

Subject: Notification Inquiry_3930 Pan American Freeway_DRB

Attachments: Page_G-16-Z.PDF

Jaimie,

Good afternoon. The purpose of this email is to confirm that as of today's date <u>Thursday, February 8, 2018</u> there are no affected neighborhood associations to notify related to your upcoming DRB submittal. Thank you.

Respectfully,

Vicente M. Quevedo, MCRP

Neighborhood Liaison, Office of Neighborhood Coordination City of Albuquerque – City Council (505) 768-3332 cabq.gov/neighborhoods

Follow us;



Confidentiality Notice: This e-mail, including all attachments is for the sole use of the intended recipient(s) and may contain confidential and privileged information. Any unauthorized review, use, disclosure or distribution is prohibited unless specifically provided under the New Mexico Inspection of Public Records Act. If you are not the intended recipient, please contact the sender and destroy all copies of this message.

From: webmaster=cabq.gov@mailgun.org [mailto:webmaster=cabq.gov@mailgun.org] On Behalf Of

webmaster@cabq.gov

Sent: Wednesday, February 07, 2018 9:27 AM

To: Office of Neighborhood Coordination <onc@cabq.gov>

Subject: Notification Inquiry Sheet Submission

Notification Inquiry For:

Development Review Board Submittal

If you selected "Other" in the question above, please describe what you are seeking a Notification Inquiry for below:

Contact Name

Jaimie Garcia

Company Name

Tierra West, LLC

Address

5571 Midway Park Place NE

City

SITE DEVELOPMENT PLAN FOR BUILDING PERMIT CHECKLIST

This checklist will be used to verify the completeness of site plans submitted for review by the Environmental Planning Commission and Development Review Board. Because development proposals vary in type and scale, there may be submittal requirements that are not specified here. More details and/or minor changes may be necessary as the project progresses through DRB and building permit reviews. Certification of completeness as specified below is required.

I CERTIFY THAT THE SUBMITTED SITE DEVELOPMENT PLAN IS COMPLETE AND ACCURATE, AND THAT ALL APPLICABLE INFORMATION AS SPECIFIED IN THIS CHECKLIST IS PROVIDED. I ACKNOWLEDGE THAT MORE DETAILS AND/OR MINOR CHANGES MAY BE NECESSARY AS THE PROJECT PROGRESSES THROUGH THE REVIEW PROCESSES. FURTHER, I UNDERSTAND THAT THIS APPLICATION IS BEING ACCEPTED PROVISIONALLY AND THAT INACCURATE AND/OR INCOMPLETE INFORMATION MAY RESULT IN THE SUBSEQUENT REJECTION OR DEFERRAL OF THE APPLICATION.

Applicant or Agent Signature / Date

NOTE: MAXIMUM SIZE FOR SUBMITTAL IS 24" X 36", or as pre-approved by Planning Staff

Site development plan packets shall be composed of the following plan sheets (unless otherwise approved in writing):

- 1. Site Plan (including easements with recording information)
- 2. Landscaping Plan
- 3. Conceptual Grading and Drainage Plan (a separate Grading Plan sheet is required for sites > 1 acre)
- 4. Conceptual Utility Plan (for sites less than one acre, Utility Plan may be shown on Site Plan)
- 5. Building and Structure Elevations
- 6. Previously approved Development Plan (if applicable)

Submitted plan packets must be organized in the above manner. The following checklist describes the minimum information necessary for each plan element. Please refer to the City's DPM, Zoning Code and any applicable Sector Development Plan and Master Development Plan for specific design requirements for the elements listed below. The Applicant must include all checklist items on their site plan drawings and confirm inclusion by checking off the items below. Non-applicable items must be labeled "N/A." Each non-applicable designation must be explained by notation on the Checklist.

Accompanying Material

A. 8-1/2" x 11" reduction for each plan sheet & electronic copy (pdf) of Site Development Plan

B. Written project summary. Each application must include a brief narrative description of the proposed project, its primary features and how compatibility with the surrounding context has been achieved.

SHEET #1 - SITE PLAN

A. General Information

	Date of drawing and/or last revision	
<u></u>	Scale:	
	1.0 acre or less 1" = 10'	Over 5 acres 1" = 50'
	1.0 - 5.0 acres 1" = 20'	Over 20 acres 1" = 100'
1	[other scales, if approved by staff]	
3.	Bar scale	
4.	North arrow	
<u>/</u> 5.	Vicinity map	
<u>/</u> 6.	[other scales, if approved by staff] Bar scale North arrow Vicinity map Signature Block (for DRB site dev. plai Property lines (clearly identify)	ns)
7. 8.		•
<u> </u>	Existing easements on the site and wit	hin 20 ft. of the site with recording information;
	proposed easements on the site	•
<u> MA</u> 9.	Phases of development including locat	ion and square footages of structures, circulation,
/	parking and landscaping	
<u>1</u> 10.	Indicate existing structures and easem	ents (with recording information) within 20 ft. of the site
		, , , , , , , , , , , , , , , , , , , ,

SITE DEVELOPMENT PLAN FOR BUILDING PERMIT CHECKLIST

B. Proposed Development

		•	
1.	Structura	al	
	1. 2. 3. 4. N/45. 6. 7. 8.	Location of existing & proposed structures on the site (distinguish between existing & proposed, include phasing) Dimensions and square footage of each structure Proposed use of each structure Walls, fences, and screening: indicate height, length, color and materials Loading facilities Conceptual site lighting (indicate general location & maximum height) Location of refuse container and enclosure Site amenities including patios, benches, tables (indicating square footage of patios/ plazas)	
2.	Parking a	and Circulation	
	A.	Parking layout with spaces numbered per aisle and totaled.	
		1. Location and typical dimensions, including handicapped spaces 2. Calculations: spaces required: 125 provided: 126	
		Handicapped spaces (included in required total) required: 8 provided: Provided: 1 provided	
	B.	Bicycle parking & facilities	
		1. Bicycle racks, spaces required: provided: 5 N/42. Bikeways and other bicycle facilities, if applicable	
	<u>и/4</u> с.	Public Transit1. Bus facilities, including routes, bays and shelters existing or required	
	✓ D.	Pedestrian Circulation	
		 Location and dimensions of all sidewalks and pedestrian paths Location and dimension of drive aisle crossings, including paving treatment Location of proposed and existing public sidewalk; define distance from back of curb to sidewalk 	
	<u>√</u> E.	Vehicular Circulation (Refer to Chapter 23 of DPM for design requirements)	
		1. Ingress and egress locations, including width and curve radii dimensions 2. Drive aisle locations, including width and curve radii dimensions 3. End aisle locations, including width and curve radii dimensions 4. Location & orientation of refuse enclosure, with dimensions 6. Curb cut locations and dimensions 6. Existing and proposed street widths, right-of-way widths and curve radii Identify existing and proposed turn lanes, deceleration lanes and similar features related to the functioning of the proposal, with dimensions 1. Location of traffic signs and signals related to the functioning of the proposal Identify existing and proposed medians and median cuts	

3. Phasing – This is required information if phasing of project is anticipated

Proposed phasing of improvements and provision for interim facilities. Indicate phasing plan, including location and square footage of structures and associated improvements including circulation, parking and landscaping.

SITE DEVELOPMENT PLAN FOR BUILDING PERMIT CHECKLIST

SHEET #2 - LANDSCAPING PLAN

Landscaping may be shown on sheet #1 with written approval from Planning Department staff

<u>/</u> 1.	Scale - must be same as scale on sheet #1 - Site Plan
2.	Bar Scale
3.	North Arrow
4. 5. 6.	Property Lines
<u>√</u> 5.	Existing and proposed easements
✓ 6.✓ 7.✓ 8.✓ 9.	Statement of Landscaping Responsibility for Maintenance (Landscape Agreement will be required for landscape in public right-of-way prior to Building Permit)
<u>√</u> 7.	Statement of compliance with Water Conservation Ordinance, see §6-1-1
<u>~</u> 8.	Statement of compliance with §14-16-3-10, General Landscaping Regulations
	 A. Type, location and size of trees (common and/or botanical names) B. Type and location of all ground cover material (organic/inorganic) C. Existing vegetation, indicating whether it is to be preserved or removed D. Ponding areas either for drainage or landscaping/recreational use E. Turf area – only 20% of landscaped area can be high water-use turf
/	 Landscape calculation table: A. Required and Provided Landscape Area – square footage and percent B. Required and Provided Trees (street, parking lot, screening, etc.)
11.	Street Tree Plan as defined in the Street Tree Ordinance (see 86.6.2)
12.	Verification of adequate sight distance
<u>/</u> 13.	Provide a plant list of shrubs, grasses, and perennials

SHEET #3 - CONCEPTUAL GRADING and DRAINAGE PLAN

The Conceptual Grading and Drainage Plan provides the Planning Commission and DRB with an understanding of site topography and how it relates to adjacent property. The City Engineer or her/his designee may waive or allow adjustments to the Conceptual Grading and Drainage Plan requirements for sites that are already developed or are small, relatively flat and have no existing or proposed extraordinary drainage facilities. Waivers must be obtained in writing from the City Engineer prior to application submittal.

A. General Information

1.	Scale - must be same as Sheet #1 - Site Plan
<u>~</u> 2.	Bar Scale
3.	North Arrow
4.	Property Lines
5.	Building footprints
<u>414</u> 6.	Location of Retaining walls

B. Grading Information

	Provide a narrative description of existing site topography, proposed grading improvements,
/	mood zone status, and topography within 20 feet of the site
<u>~</u> 2.	Show existing and proposed contours, retaining wall heights, approximate street (drive
,	entrance/parking ion siones
<u>~</u> 3.	Identify whether ponding is required
<u>√</u> 4.	Indicate Finished Floor Elevation and provide spot elevations for all corners of the site
	(existing and proposed) and points of maximum cut or fill exceeding 1 foot

SITE DEVELOPMENT PLAN FOR BUILDING PERMIT CHECKLIST 5. Cross Sections Provide cross section for all perimeter property lines where the grade change is greater than 4 feet at the point of the greatest grade change. 6. In addition to the above, the following must be provided for DRB applications: A. Conceptual onsite drainage system B. For sites 5 acres or greater or for sites where drainage infrastructure is required, a Drainage Report is required. SHEET #4 - UTILITY PLAN If site is Jess than one acre, the Utility Plan may be shown on sheet #1 1. Fire hydrant locations, existing and proposed. 2. Distribution lines 3. Right-of-Way and easements, existing and proposed, on the property and adjacent to the boundaries, with identification of types and dimensions. boundaries, with identification of types and differences. 4. Existing water, sewer, storm drainage facilities (public and/or private). 5. Proposed water, sewer, storm drainage facilities (public and/or private) SHEET #5 BUILDING AND STRUCTURE ELEVATIONS A. General Information 1. Scale (minimum of 1/8" or as approved by Planning Staff) 2. Bar Scale 3. Detailed Building Elevations for each facade a. Identify facade orientation (north, south, east, & west) b. Facade dimensions including overall height and width of building and major building articulation elements such as doors and windows (to determine compliance with zoning or other regulations) c. Materials and colors of principle building elements – façade, roof, windows, doors, etc. d. 8½" x 11" color renderings or similar illustrations (2 for DRB and 10 for EPC) zoning or other regulations) 4. Dimensions, colors and materials of Refuse Enclosure 5. Site Development Plans for single family residential projects with multiple units may require submittal of specific information on building features in lieu of elevation drawings for each building. Applicants are advised to discuss submittal requirements with Planning Department staff.

B. Signage

<u></u>	Site location(s)
<u>/</u> 2.	Sign elevations to scale
<u>/</u> 3.	Dimensions, including height and width
4.	Sign face area - dimensions and square footage clearly indicated
5.	Lighting
<u></u> 6.	Materials and colors for sign face and structural elements
<u></u>	Verification of adequate sight distance

February 7, 2018

Ms. Kym Dicome Development Review Board City of Albuquerque P.O. Box 1293 Albuquerque, NM 87103

RE: SITE DEVELOPMENT PLAN FOR BUILDING PERMIT LOT 3 PLAT OF LTS 1, 2, 3, & 4 SRCC ALBUQUERQUE CARPENTERS TRAINING CENTER

ZONE ATLAS PAGE G-15-Z

Dear Chairwoman Dicome:

The purpose of this letter is to authorize Tierra West LLC to act as agent on behalf of ABQ Comanche Retail, LLC pertaining to any and all submittals made to the City of Albuquerque for the above-referenced site.

Print Name

Signature


Title


Date


CITY OF ALBUQUERQUE


TRAFFIC IMPACT STUDY (TIS) FORM

APPLICANT: ABQ Comanche Retail, LLC DA	TE OF REQUEST: 02/16/18 ZONE ATLAS PAGE(S): G-15-Z
CURRENT:	LEGAL DESCRIPTION:
ZONING M-1	LOT OR TRACT # BLOCK #
20111110	—— COROLA November Corporators Training Co
PARCEL SIZE (AC/SQ. FT.)	SUBDIVISION NAME_SRCC Albuquerque Carpenters Training Co
REQUESTED CITY ACTION(S):	
ANNEXATION []	SITE DEVELOPMENT PLAN:
ZONE CHANGE []: FromTo	SUBDIVISION* [] AMENDMENT []
SECTOR, AREA, FAC, COMP PLAN []	BUILDING PERMIT [X] ACCESS PERMIT []
AMENDMENT (Map/Text) []	BUILDING PURPOSES [] OTHER []
	*includes platting actions
PROPOSED DEVELOPMENT:	GENERAL DESCRIPTION OF
	ACTION:
NO CONSTRUCTION/DEVELOPMENT []	# OF UNITS:
NEW CONSTRUCTION [X]	BUILDING SIZE:(sq. ft.)
EXPANSION OF EXISTING DEVELOPMENT []	
	of processing by the Traffic Engineer)
Planning Department, Development & Building Services 2 ND Floor West, 600 2 nd St. NW, Plaza del Sol Building, City	
TRAFFIC IMPACT STUDY (TIS) REQUIRED: YES [] NO	D[X] BORDERLINE[]
THRESHOLDS MET? YES [] NO [X] MITIGATING	REASONS FOR NOT REQUIRING TIS: PREVIOUSLY STUDIED: [V]
Notes: TIS was previously submitted o	n the site end this proposed permit is All recommendations from the previous study
within the premoisty projected trips.	All recommendations know the previous study
2re- in 0/2-2	
If a TIS is required: a scoping meeting (as outlined in the d needed and the parameters of the study. Any subsequent update or new TIS.	evelopment process manual) must be held to define the level of analysis changes to the development proposal identified above may require an
8-6	2/16/18
TRAFFIC ENGINEER DATE	E
Required TIS <u>must be completed prior to applying to the</u> variance to this procedure is requested and noted on this for arrangements are not complied with.	e EPC and/or the DRB. Arrangements must be made prior to submittal if a orm, otherwise the application may not be accepted or deferred if the
T10	-SUBMITTED/
TIS	TRAFFIC ENGINEER
-FINALIZED/	DATE

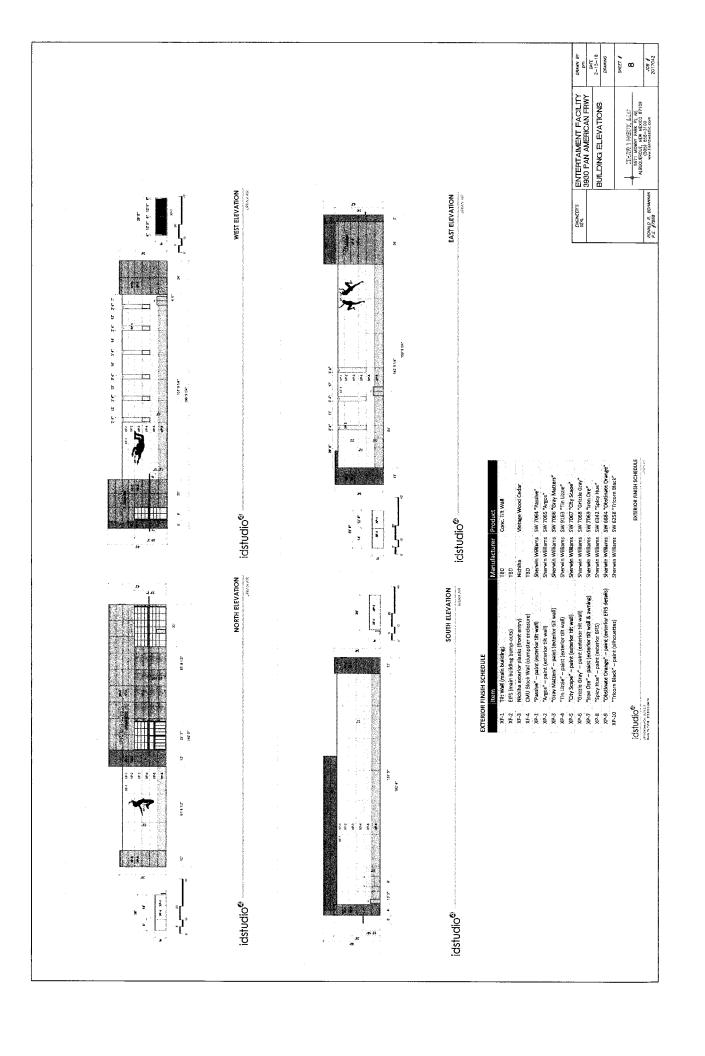


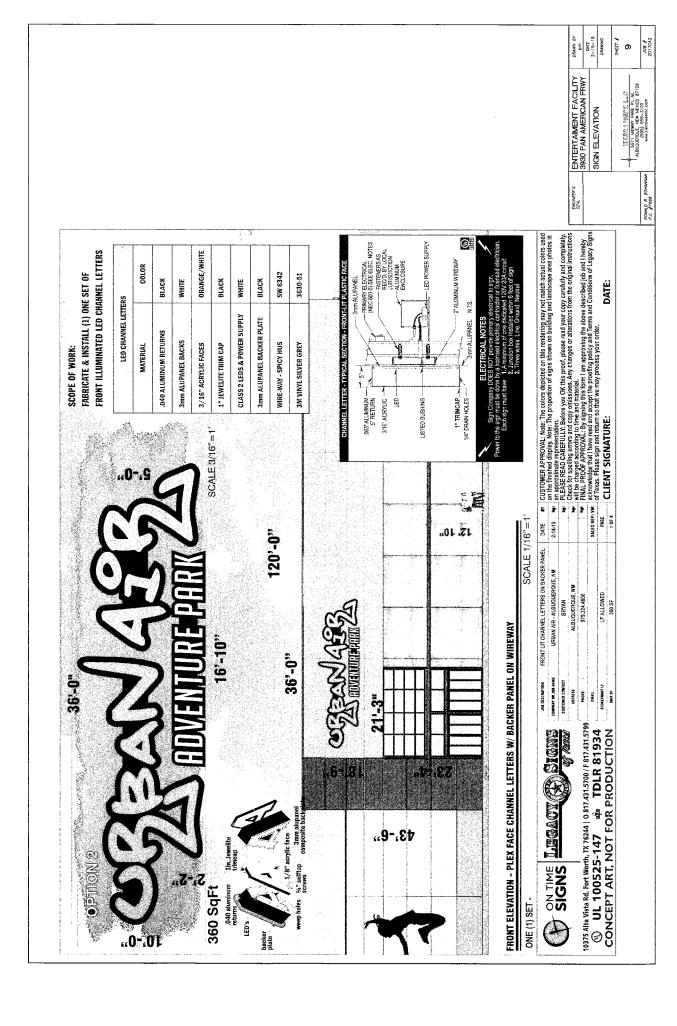


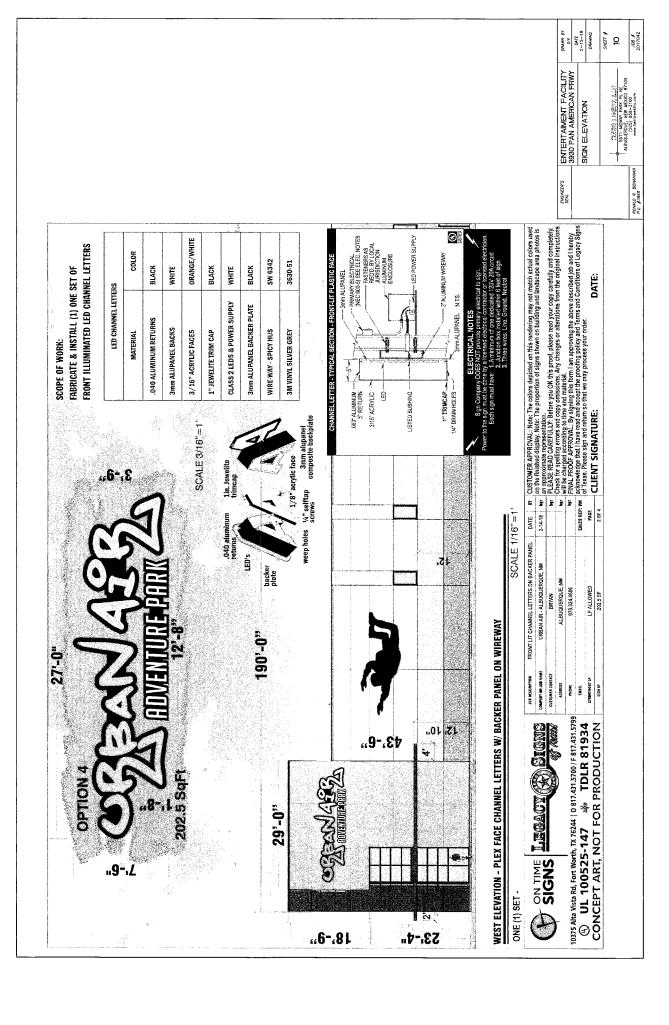

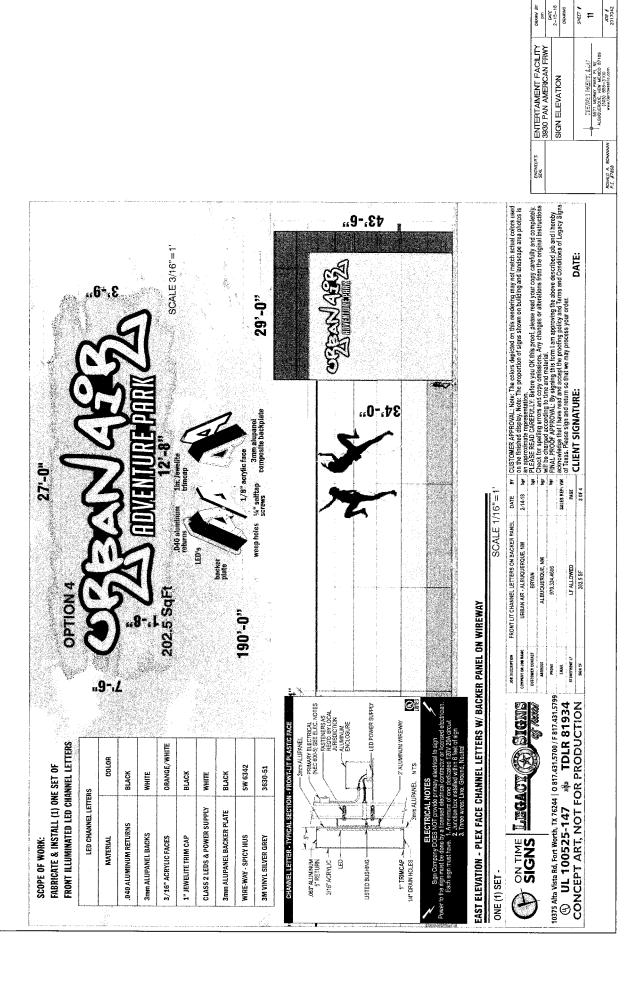

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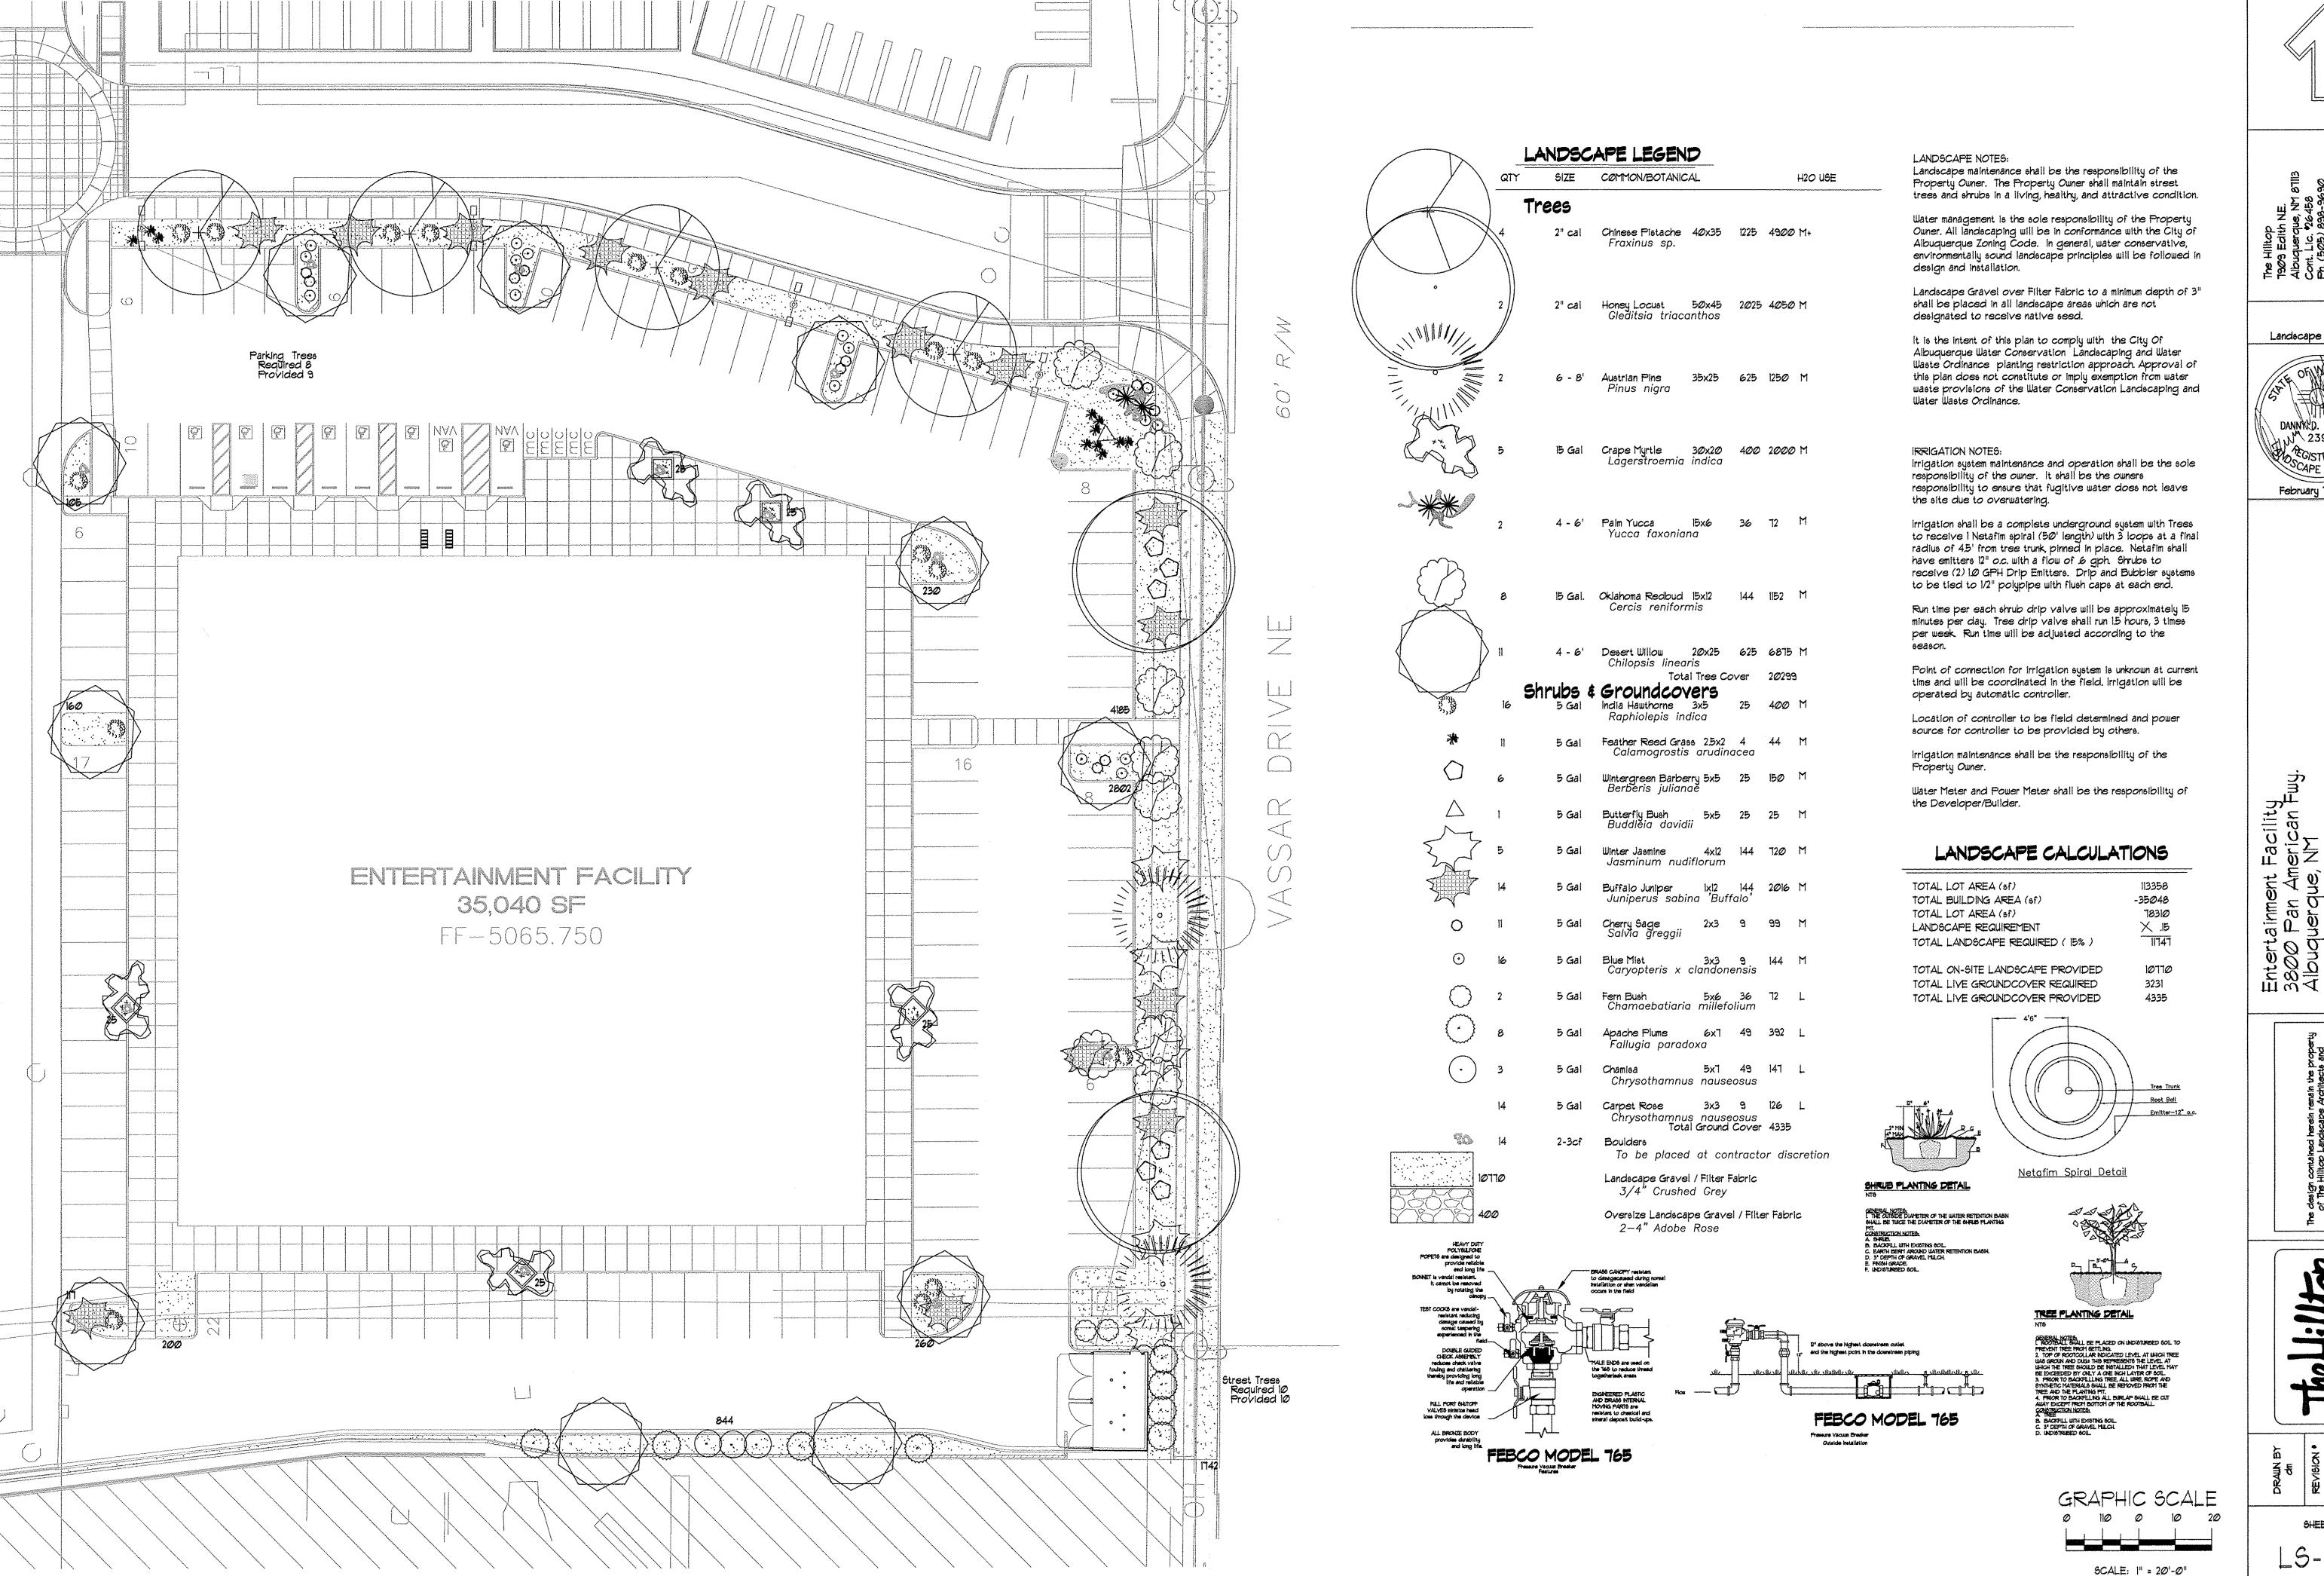


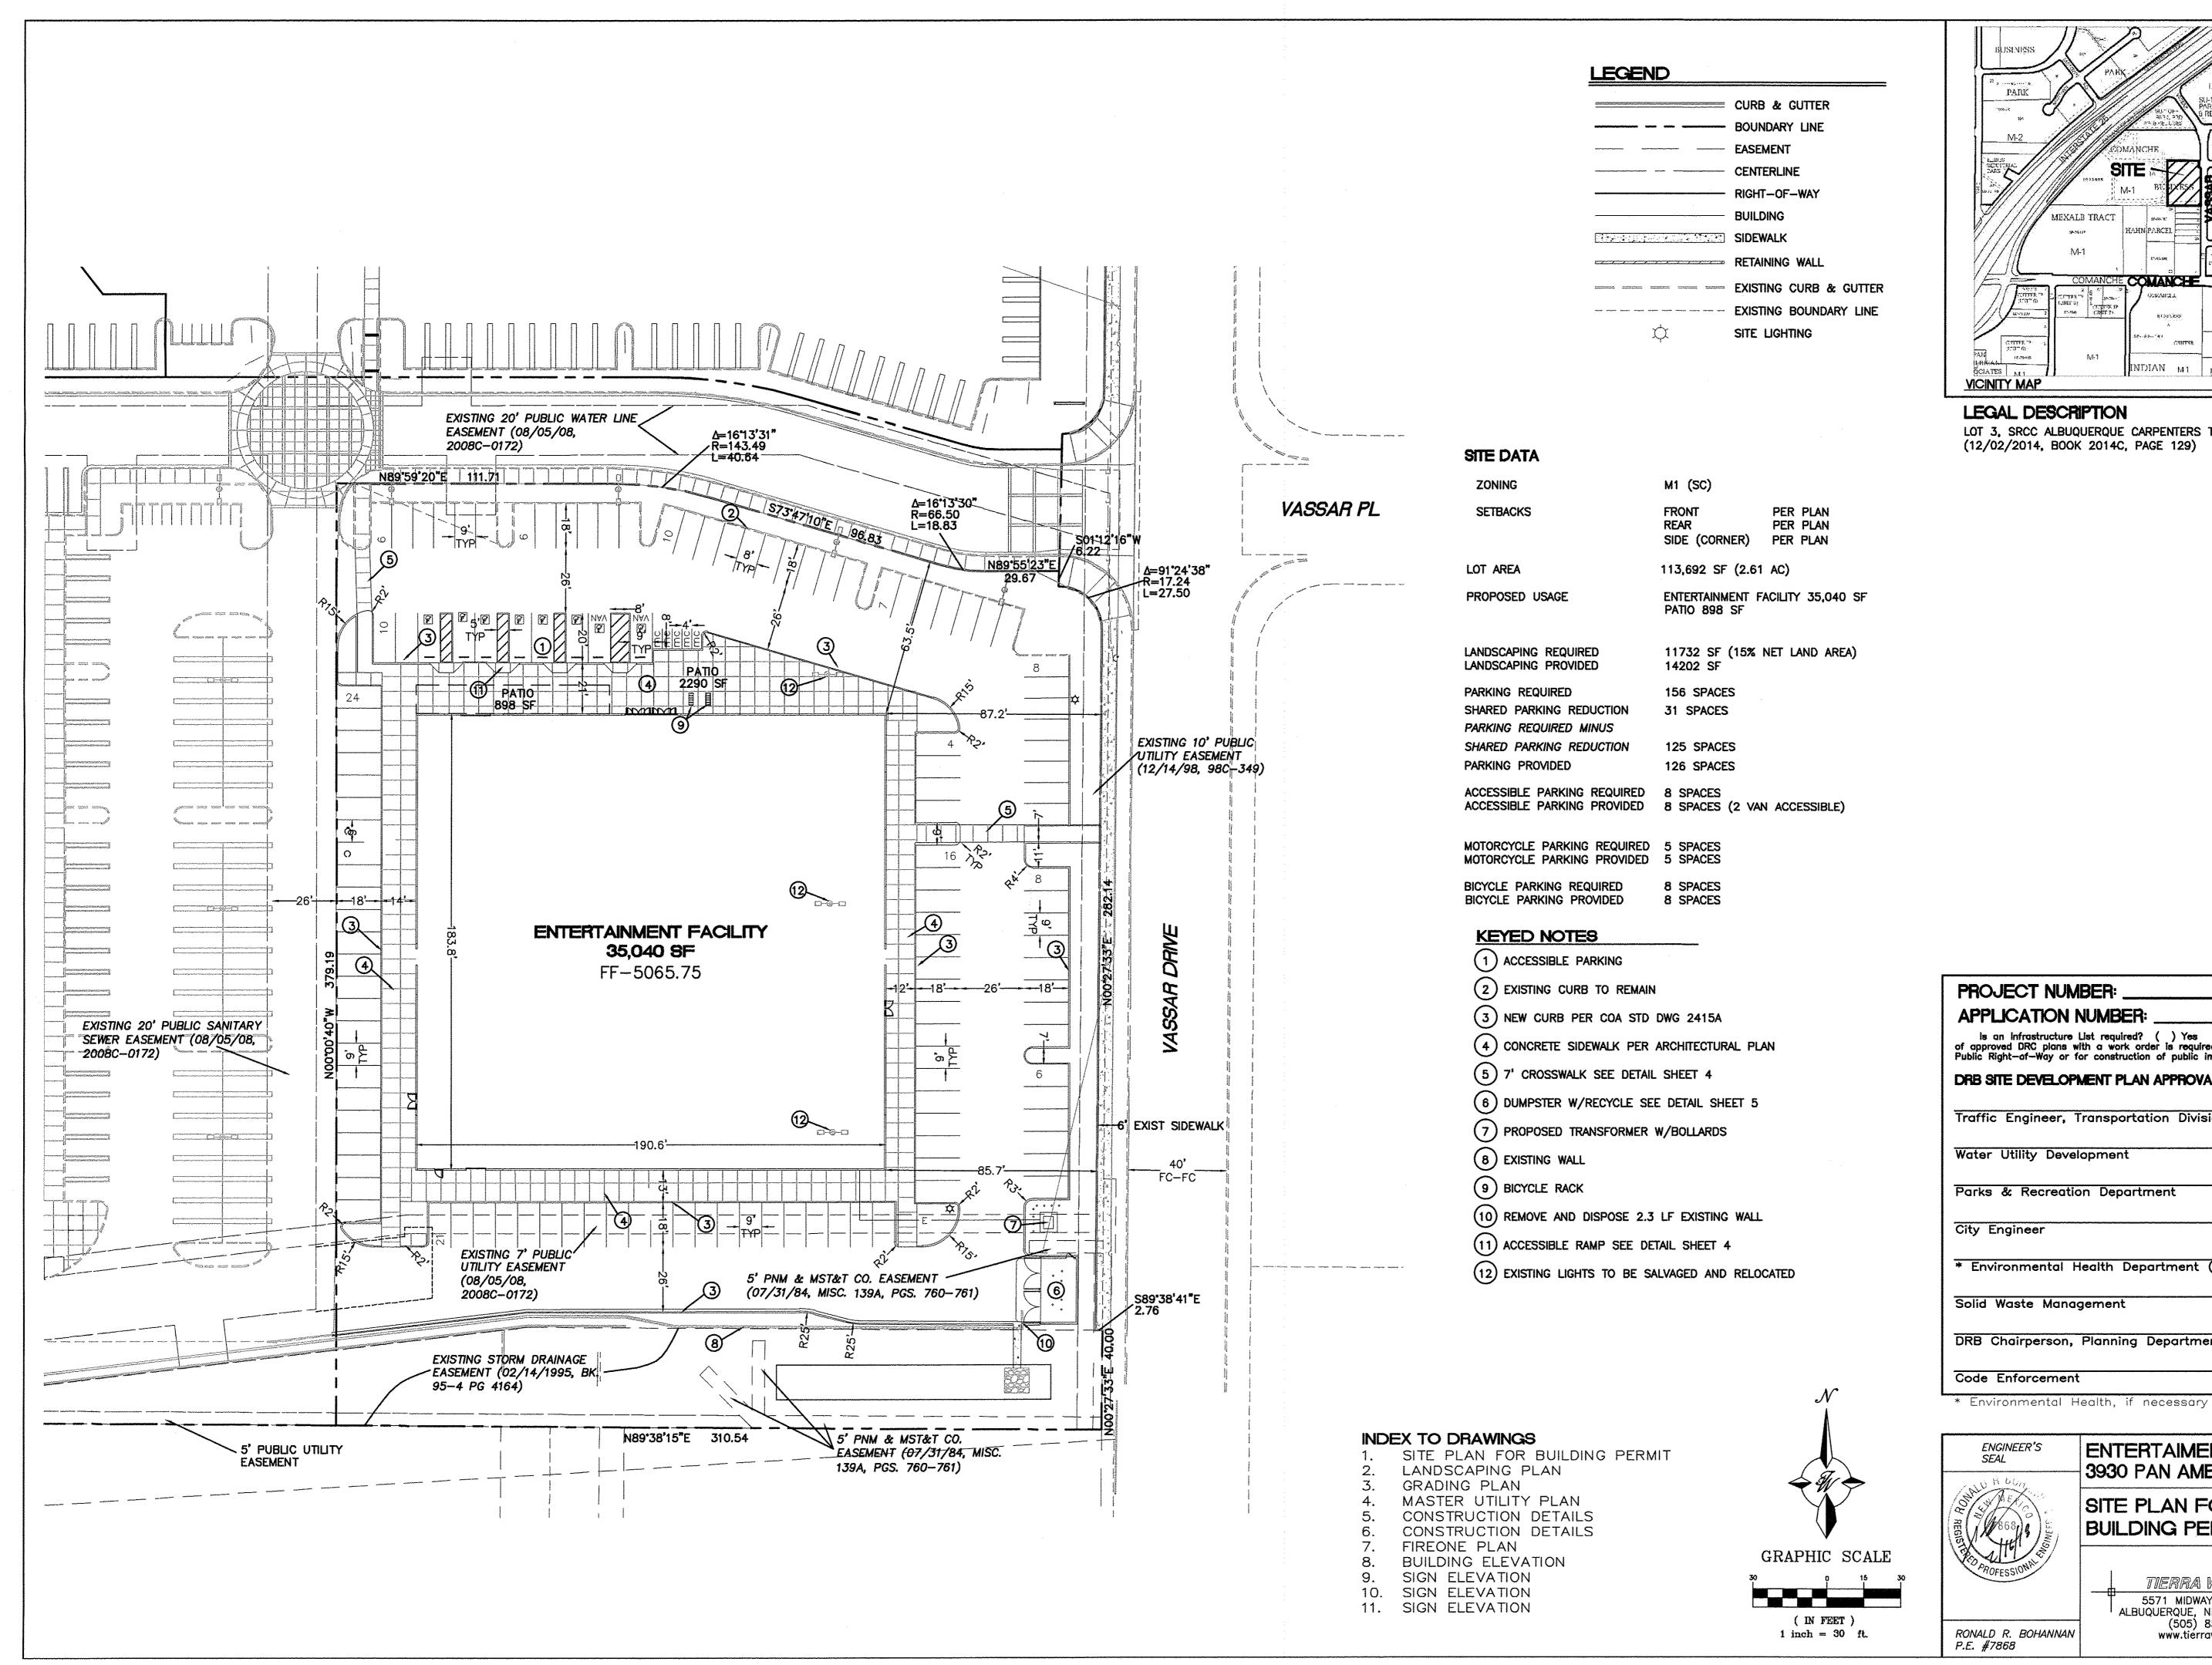
LEGAL DESCRIPTION

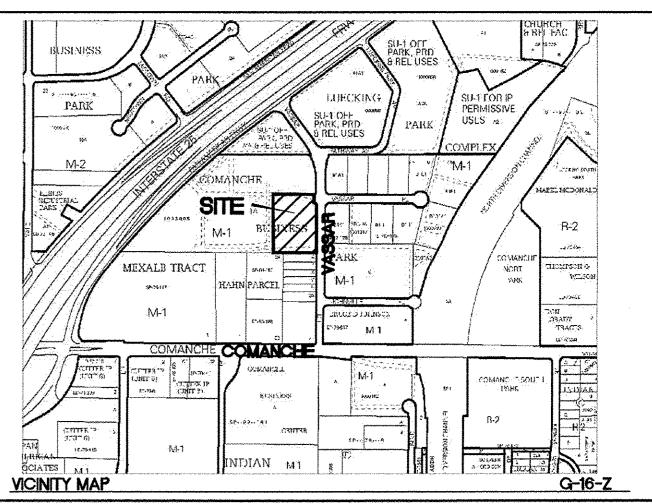LOT 3, SRCC ALBUQUERQUE CARPENTERS TRAINING CENTER (12/02/2014, BOOK 2014C, PAGE 129)

PROJECT NUMBER:	
APPLICATION NUMBER:	
Is an infrastructure List required? () Yes () No If Y of approved DRC plans with a work order is required for any construction of public improvements.	es, then a set ruction within
DRB SITE DEVELOPMENT PLAN APPROVAL:	
Traffic Engineer, Transportation Division	Date
Water Utility Development	Date
Parks & Recreation Department	Date
City Engineer	Date
* Environmental Health Department (conditional)	Date
Solid Waste Management	Date
DRB Chairperson, Planning Department	Date
Code Enforcement	Date





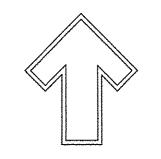


Landscape Architect



February 7, 2018

The Hillsop

SHEET . LS-101

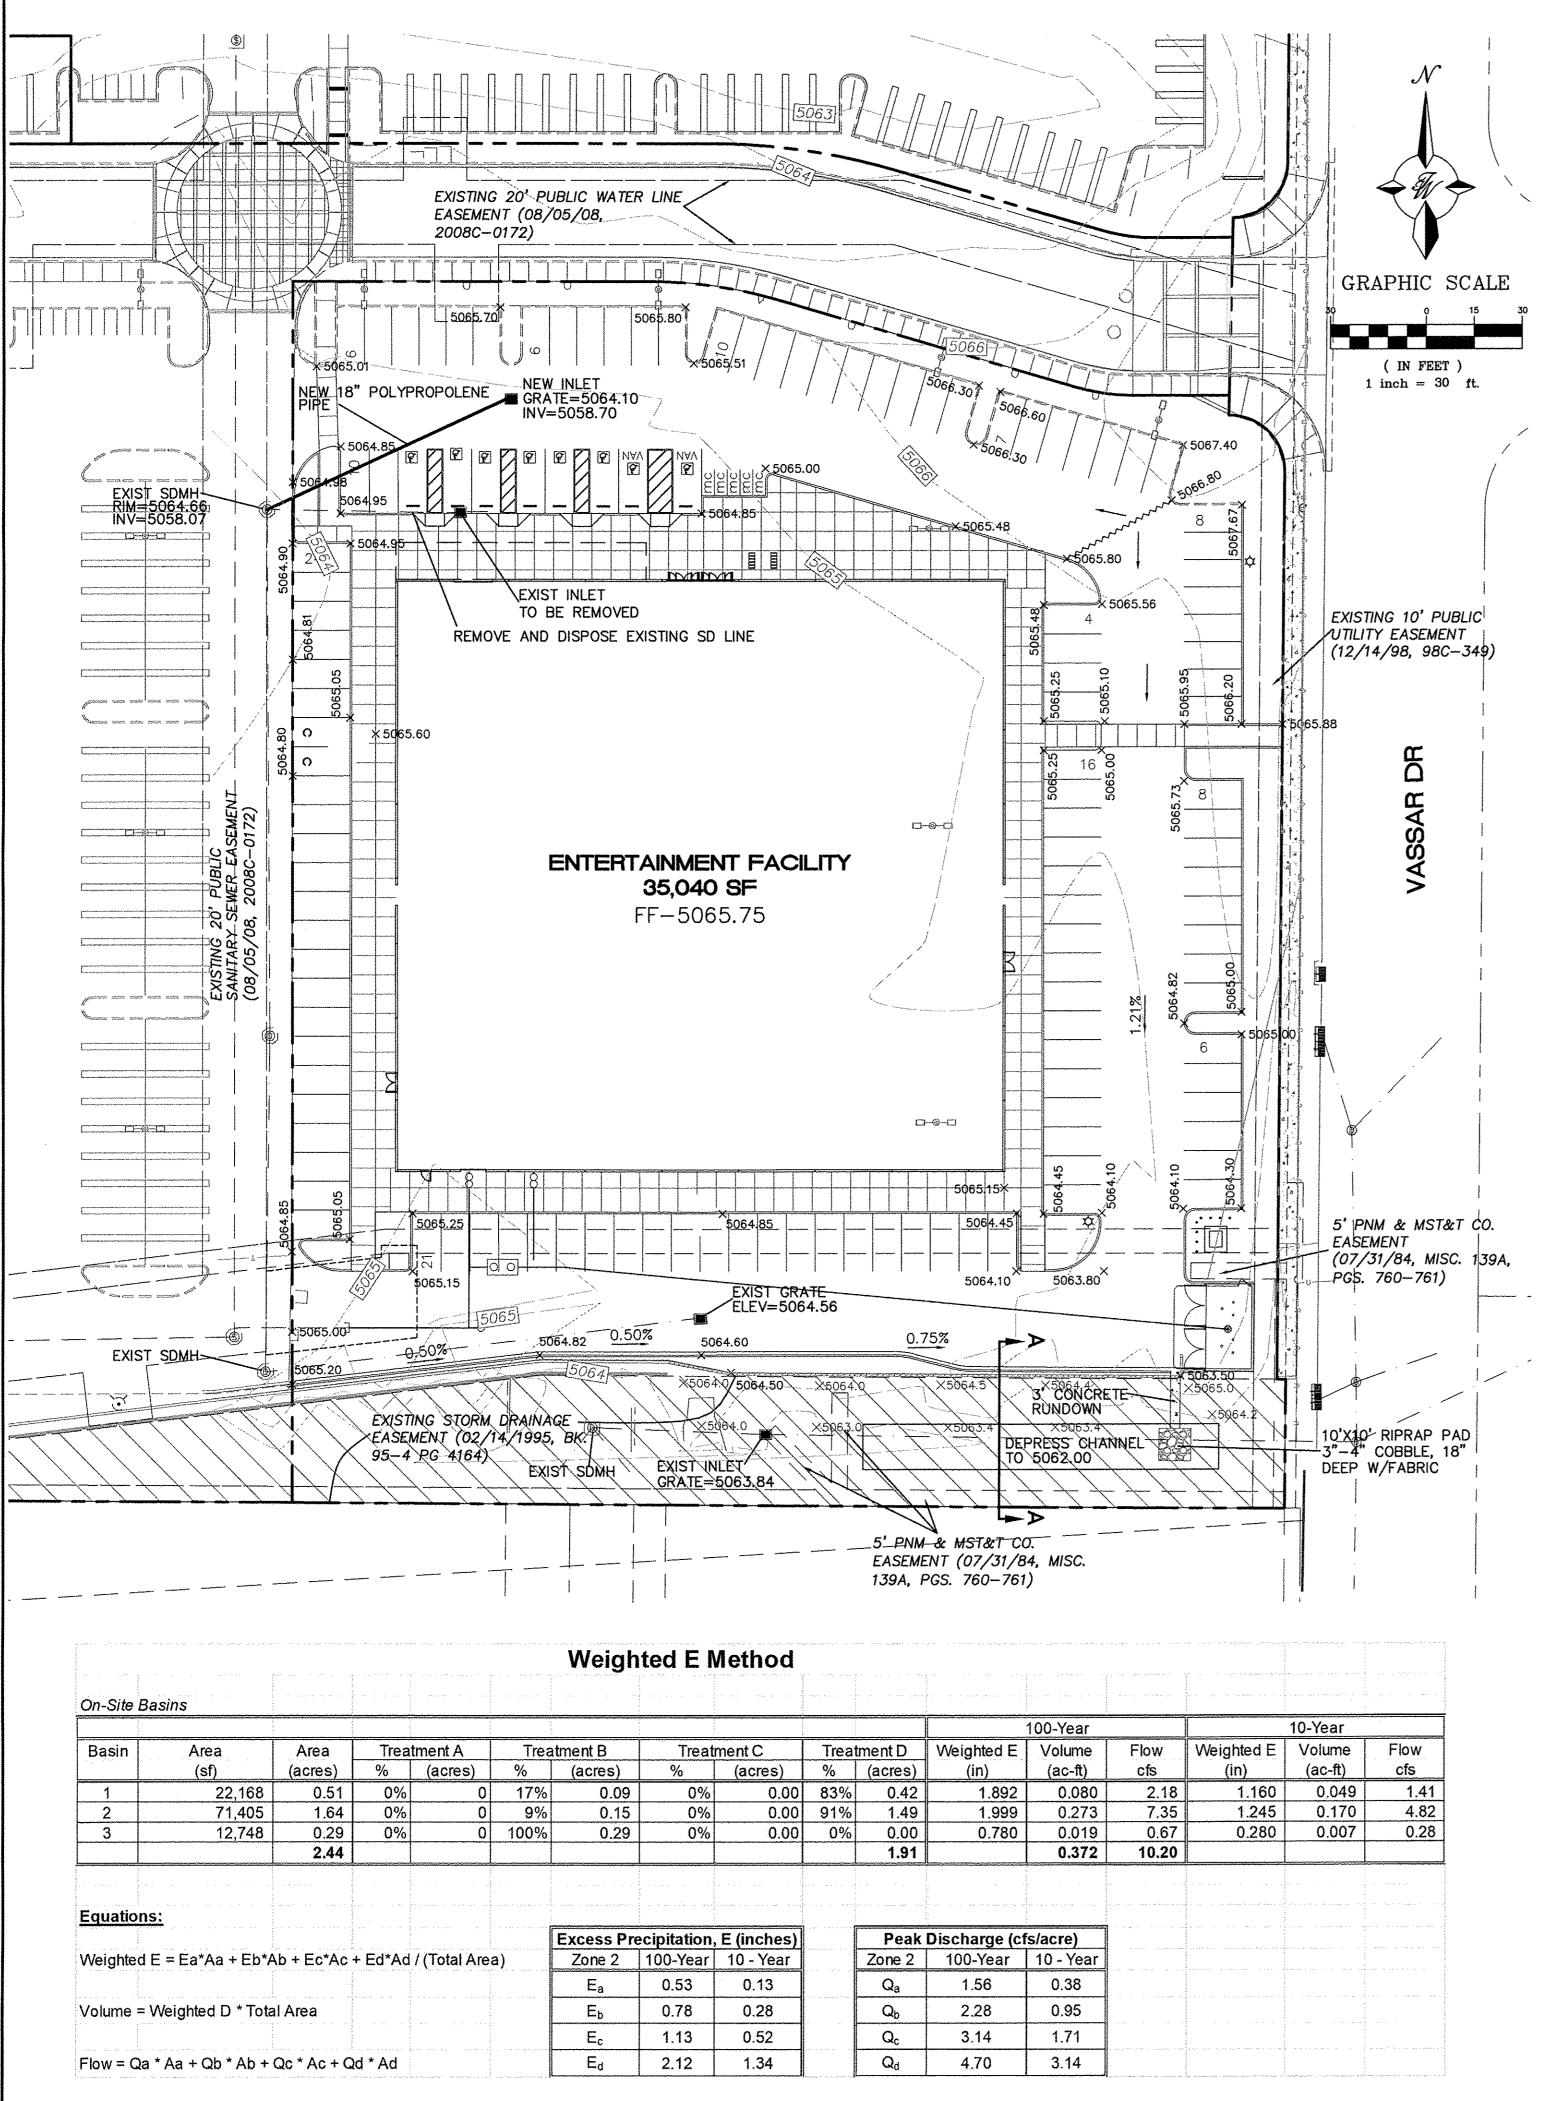

EROSION CONTROL NOTES:

- CONTRACTOR IS RESPONSIBLE FOR OBTAINING A TOPSOIL DISTURBANCE PERMIT PRIOR TO BEGINNING WORK.
- CONTRACTOR IS RESPONSIBLE FOR MAINTAINING RUN-OFF ON SITE DURING CONSTRUCTION.
- CONTRACTOR IS RESPONSIBLE FOR CLEANING ALL SEDIMENT THAT GETS INTO EXISTING RIGHT-OF-WAY.
- 4. REPAIR OF DAMAGED FACILITIES AND CLEANUP OF SEDIMENT ACCUMULATIONS ON ADJACENT PROPERTIES AND IN PUBLIC FACILITIES IS THE RESPONSIBILITY OF THE CONTRACTOR.
- ALL EXPOSED EARTH SURFACES MUST BE PROTECTED FROM WIND AND WATER EROSION PRIOR TO FINAL (CITY) ACCEPTANCE OF ANY PROJECT.

NOTICE TO CONTRACTORS

- 1. AN EXCAVATION/CONSTRUCTION PERMIT WILL BE REQUIRED BEFORE BEGINNING ANY WORK WITHIN CITY RIGHT-OF-WAY.
- 2. ALL WORK DETAILED ON THESE PLANS TO BE PERFORMED, EXCEPT AS OTHERWISE STATED OR PROVIDED HERON, SHALL BE CONSTRUCTED IN ACCORDANCE WITH CITY OF ALBUQUERQUE INTERIM STANDARD SPECIFICATIONS FOR PUBLIC WORKS CONSTRUCTION, 1985.
- 3. TWO WORKING DAYS PRIOR TO ANY EXCAVATION, CONTRACTOR MUST CONTACT LINE LOCATING SERVICE, 765-1234, FOR LOCATION OF EXISTING UTILITIES.
- 4. PRIOR TO CONSTRUCTION, THE CONTRACTOR SHALL EXCAVATE AND VERIFY THE HORIZONTAL AND VERTICAL LOCATIONS OF ALL CONNECTIONS. SHOULD A CONFLICT EXIST, THE CONTRACTOR SHALL NOTIFY THE ENGINEER SO THAT THE CONFLICT CAN BE RESOLVED WITH A MINIMUM AMOUNT OF DELAY.
- 5. BACKFILL COMPACTION SHALL BE ACCORDING TO TRAFFIC/STREET USE.
- 6. MAINTENANCE OF THESE FACILITIES SHALL BE THE RESPONSIBILITY OF THE OWNER OF THE PROPERTY SERVED.
- 7. WORK ON ARTERIAL STREETS SHALL BE PERFORMED ON A 24-HOUR BASIS.

EXISTING SITE DRAINAGE:

THE 2.60 ACRE SITE IS LOCATED AT THE SOUTHEAST CORNER OF PAN AMERICAN FREEWAY AND VASSAR DRIVE NE. THE SITE IS BOUNDED ON THE NORTH AND WEST BY COMMERCIAL DEVELOPMENT, ON THE EAST BY VASSAR DRIVE NE AND ON THE SOUTH BY AN INDUSTRIAL/MANUFACTURING DEVELOPMENT.

LEGEND

CURB & GUTTER

- - BOUNDARY LINE

-- CENTERLINE

-5010 CONTOUR MAJOR

---- EXISTING BOUNDARY LINE

---- EXISTING CONTOUR MINOR

SIDEWALK

x 5048.25

x 5048.25

RETAINING WALL

EASEMENT

BUILDING

RIGHT-OF-WAY

CONTOUR MINOR

SPOT ELEVATION

EXISTING CURB & GUTTER

EXISTING CONTOUR MAJOR

EXISTING SPOT ELEVATION

FLOW ARROW

THE SITE IS CURRENTLY VACANT DRAINS TO TWO EXISTING STORM SEWER INLETS WHERE THE WATER IS THEN CONVEYED BY STORM SEWER AND OPEN CHANNEL TO THE GRIEGOS POND THAT WAS CONSTRUCTED WITH SAD 216.

THERE ARE OFF-SITE FLOWS ENTERING A DRAINAGE EASEMENT ALONG THE SOUTH PROPERTY LINE WHERE A STORM SEWER AND OVERFLOW CHANNEL ARE LOCATED. THIS SITE IS LOCATED IN ZONE "X" AS SHOWN ON FIRM MAP #35001C0138H.

BASED ON THE APPROVED DRAINAGE REPORT FOR THE CARPENTERS TRAINING CENTER (G16/D145) THIS PROJECT MAY DISCHARGE A TOTAL OF 9.89 CFS. THE INFORMATION PERTAINING TO THE AMOUNT OF DISCHARGE ALLOWED FROM THIS PARCEL IS DETAILED ON PAGE 12 OF THE CARPENTERS TRAINING CENTER REPORT. ALL OF THE FLOWS PASS THROUGH AN EXISTING 48" RCP UNDER INTERSTATE 25 WHICH HAS A CAPACITY FOR 161 CFS. THIS PIPE DAYLIGHTS INTO A PONDING AREA WEST OF THE INTERSTATE AND EVENTUALLY DRAINS INTO THE GRIEGOS POND.

PROPOSED SITE DRAINAGE:


THIS SITE WILL BE DEVELOPED WITH A ENTERTAINMENT BUILDING ON THE PAD ALONG VASSAR DRIVE. THE SITE WILL UTILIZE LOW IMPACT DEVELOPMENT (LID) WHERE POSSIBLE ALLOWING SURFACE STORM WATER TO FLOW THROUGH LANDSCAPED AREAS PRIOR TO DISCHARGING TO THE STORM SEWER. THERE ARE THREE PROPOSED BASINS AS SHOWN ON THE PROPOSED BASIN MAP ON THIS SHEET.

BASIN 1 CONSISTS OF THE FRONT PARKING LOT AND DRAINS TO AN EXISTING DROP INLET. THE CARPENTER'S DRAINAGE PLAN WAS DEVELOPED BEFORE THE FIRST FLUSH REQUIREMENT SO THIS BASIN WAS MINIMIZED AS MUCH AS POSSIBLE SO THE FLOWS COULD BE REDIRECTED TO A FIRST FLUSH POND. THE FLOWS THAT ENTER THE EXISTING INLET EVENTUALLY DRAIN TO THE GRIEGOS POND SO ARE ESSENTIALLY DISCONNECTED FROM THE RIO GRADE.


BASIN 2 CONSISTS OF THE BUILDING AND THE SOUTH AND WEST PARKING LOTS AND WILL SURFACE DRAIN TO THE EXISTING DRAINAGE CHANNEL ALONG THE SOUTH PROPERTY LINE. THE CHANNEL IS AN OVERFLOW AREA FOR AN EXISTING STORM SEWER. THE CHANNEL BOTTOM WILL BE DEPRESSED ONE FOOT TO ACCOMMODATE THE FIRST FLUSH VOLUME OF 0.057 AC-FT. EXCESS FLOW CAN BLEED OFF INTO AN EXISTING INLET LOCATED AT THE WEST END OF THE CHANNEL AS IF THE STORM SEWER OVERFLOWED. THE EXISTING DROP INLET IN THE DRIVE AISLE WILL ONLY ACT AS AN OVERFLOW SHOULD THERE BE A LARGE AMOUNT OF WATER THAT FALLS ON THE PARKING LOT

BASIN 3 CONSISTS OF THE EXISTING CHANNEL ITSELF AS WELL AS THE FIRST FLUSH POND. ALL OF THE FLOWS FROM THIS PROJECT ARE THE SAME AS APPROVED IN THE CARPENTER'S TRAINING CENTER REPORT OF 9.90 CFS AND ARE EVENTUALLY STORED IN THE GRIEGOS POND.

THE PARKING AREA WEST OF THE BUILDING IS LOCATED IN A DRAINAGE BASIN THAT WAS INCLUDED AS PART OF THE ORIGINAL CARPENTER'S DRAINAGE PLAN AND DRAINS TO AN EXISTING DROP INLET IN THE CARPENTER'S PARKING LOT.

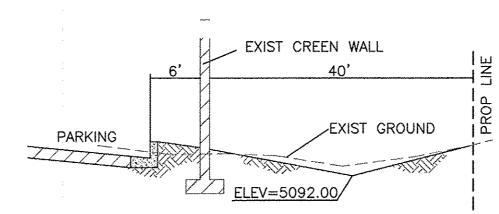



SECTION A-A

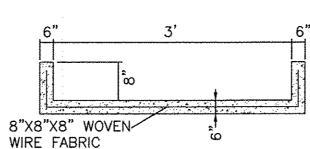


CONCRETE RUNDOWN DETAIL

ALL EXISTING UTILITIES SHOWN WERE OBTAINED FROM TO DETERMINE THE ACTUAL LOCATION OF UTILITIES AND AND APPROVED BY THE ENGINEER.

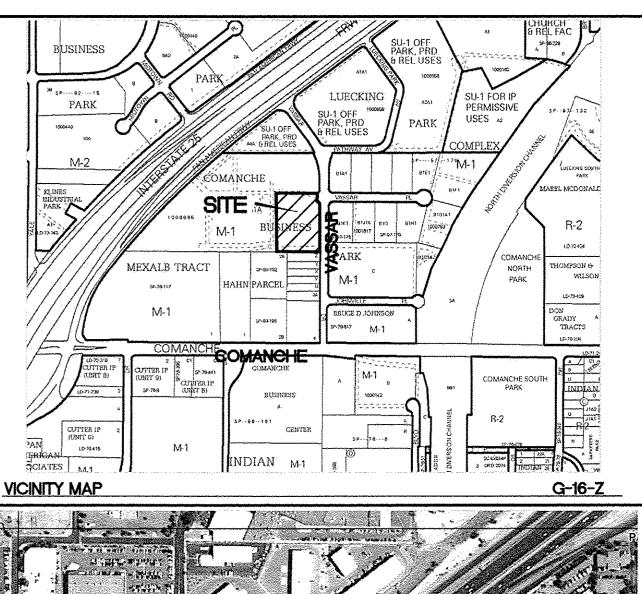

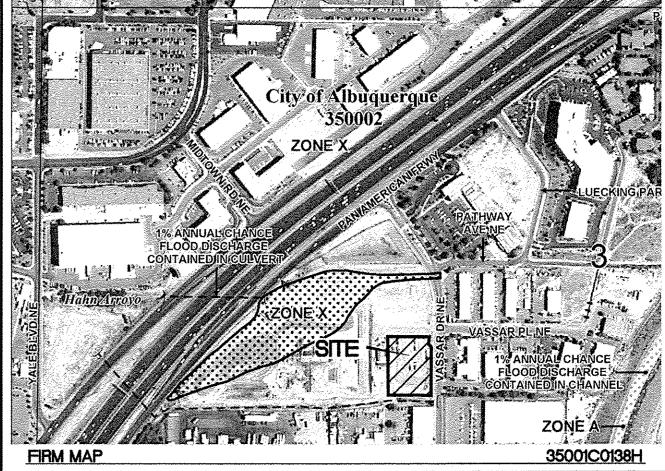

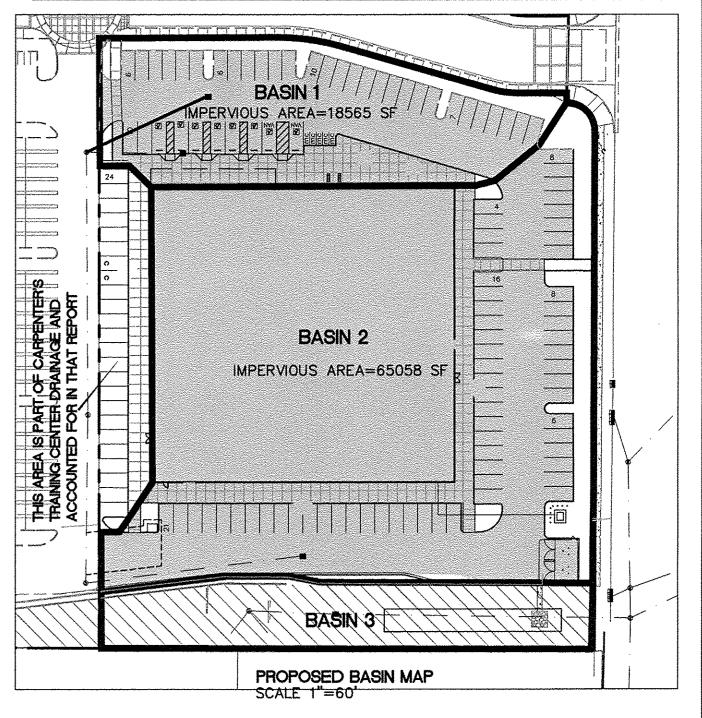


FIRST FLUSH CALCULATION BASIN 1: 18385 SF X 0.34"/12"=521 CF=0.012 AC-FT BASIN 2: 65058 SF X 0.34"/12"=1843 CF=0.042 AC-FT

ENGINEER'S SEAL	ENTERTAIMENT FACILITY 3930 PAN AMERICAN FRWY	<i>DRAWN BY</i> pm
R BOHANAM HERISTER TO THE STREET TO THE STRE	3930 I AN AMERICAN I TIVI	DATE
	GRADING PLAN	2-15-18
	GIADING I LAN	DRAWING
		SHEET #
PROFESSIONAL	TIERRA WEST, LLC 5571 MIDWAY PARK PL NE ALBUQUERQUE, NEW MEXICO 87109	3
RONALD R. BOHANNAN P.E. #7868	(505) 858-3100 www.tierrawestllc.com	<i>JOB #</i> 2017042

CAUTION:

RESEARCH, AS-BUILTS, SURVEYS OR INFORMATION PROVIDED BY OTHERS. IT SHALL BE THE SOLE RESPONSIBILITY OF THE CONTRACTOR TO CONDUCT ALL NECESSARY FIELD INVESTIGATIONS PRIOR TO AND INCLUDING ANY EXCAVATION. OTHER IMPROVEMENTS, PRIOR TO STARTING THE WORK. ANY CHANGES FROM THIS PLAN SHALL BE COORDINATED WITH

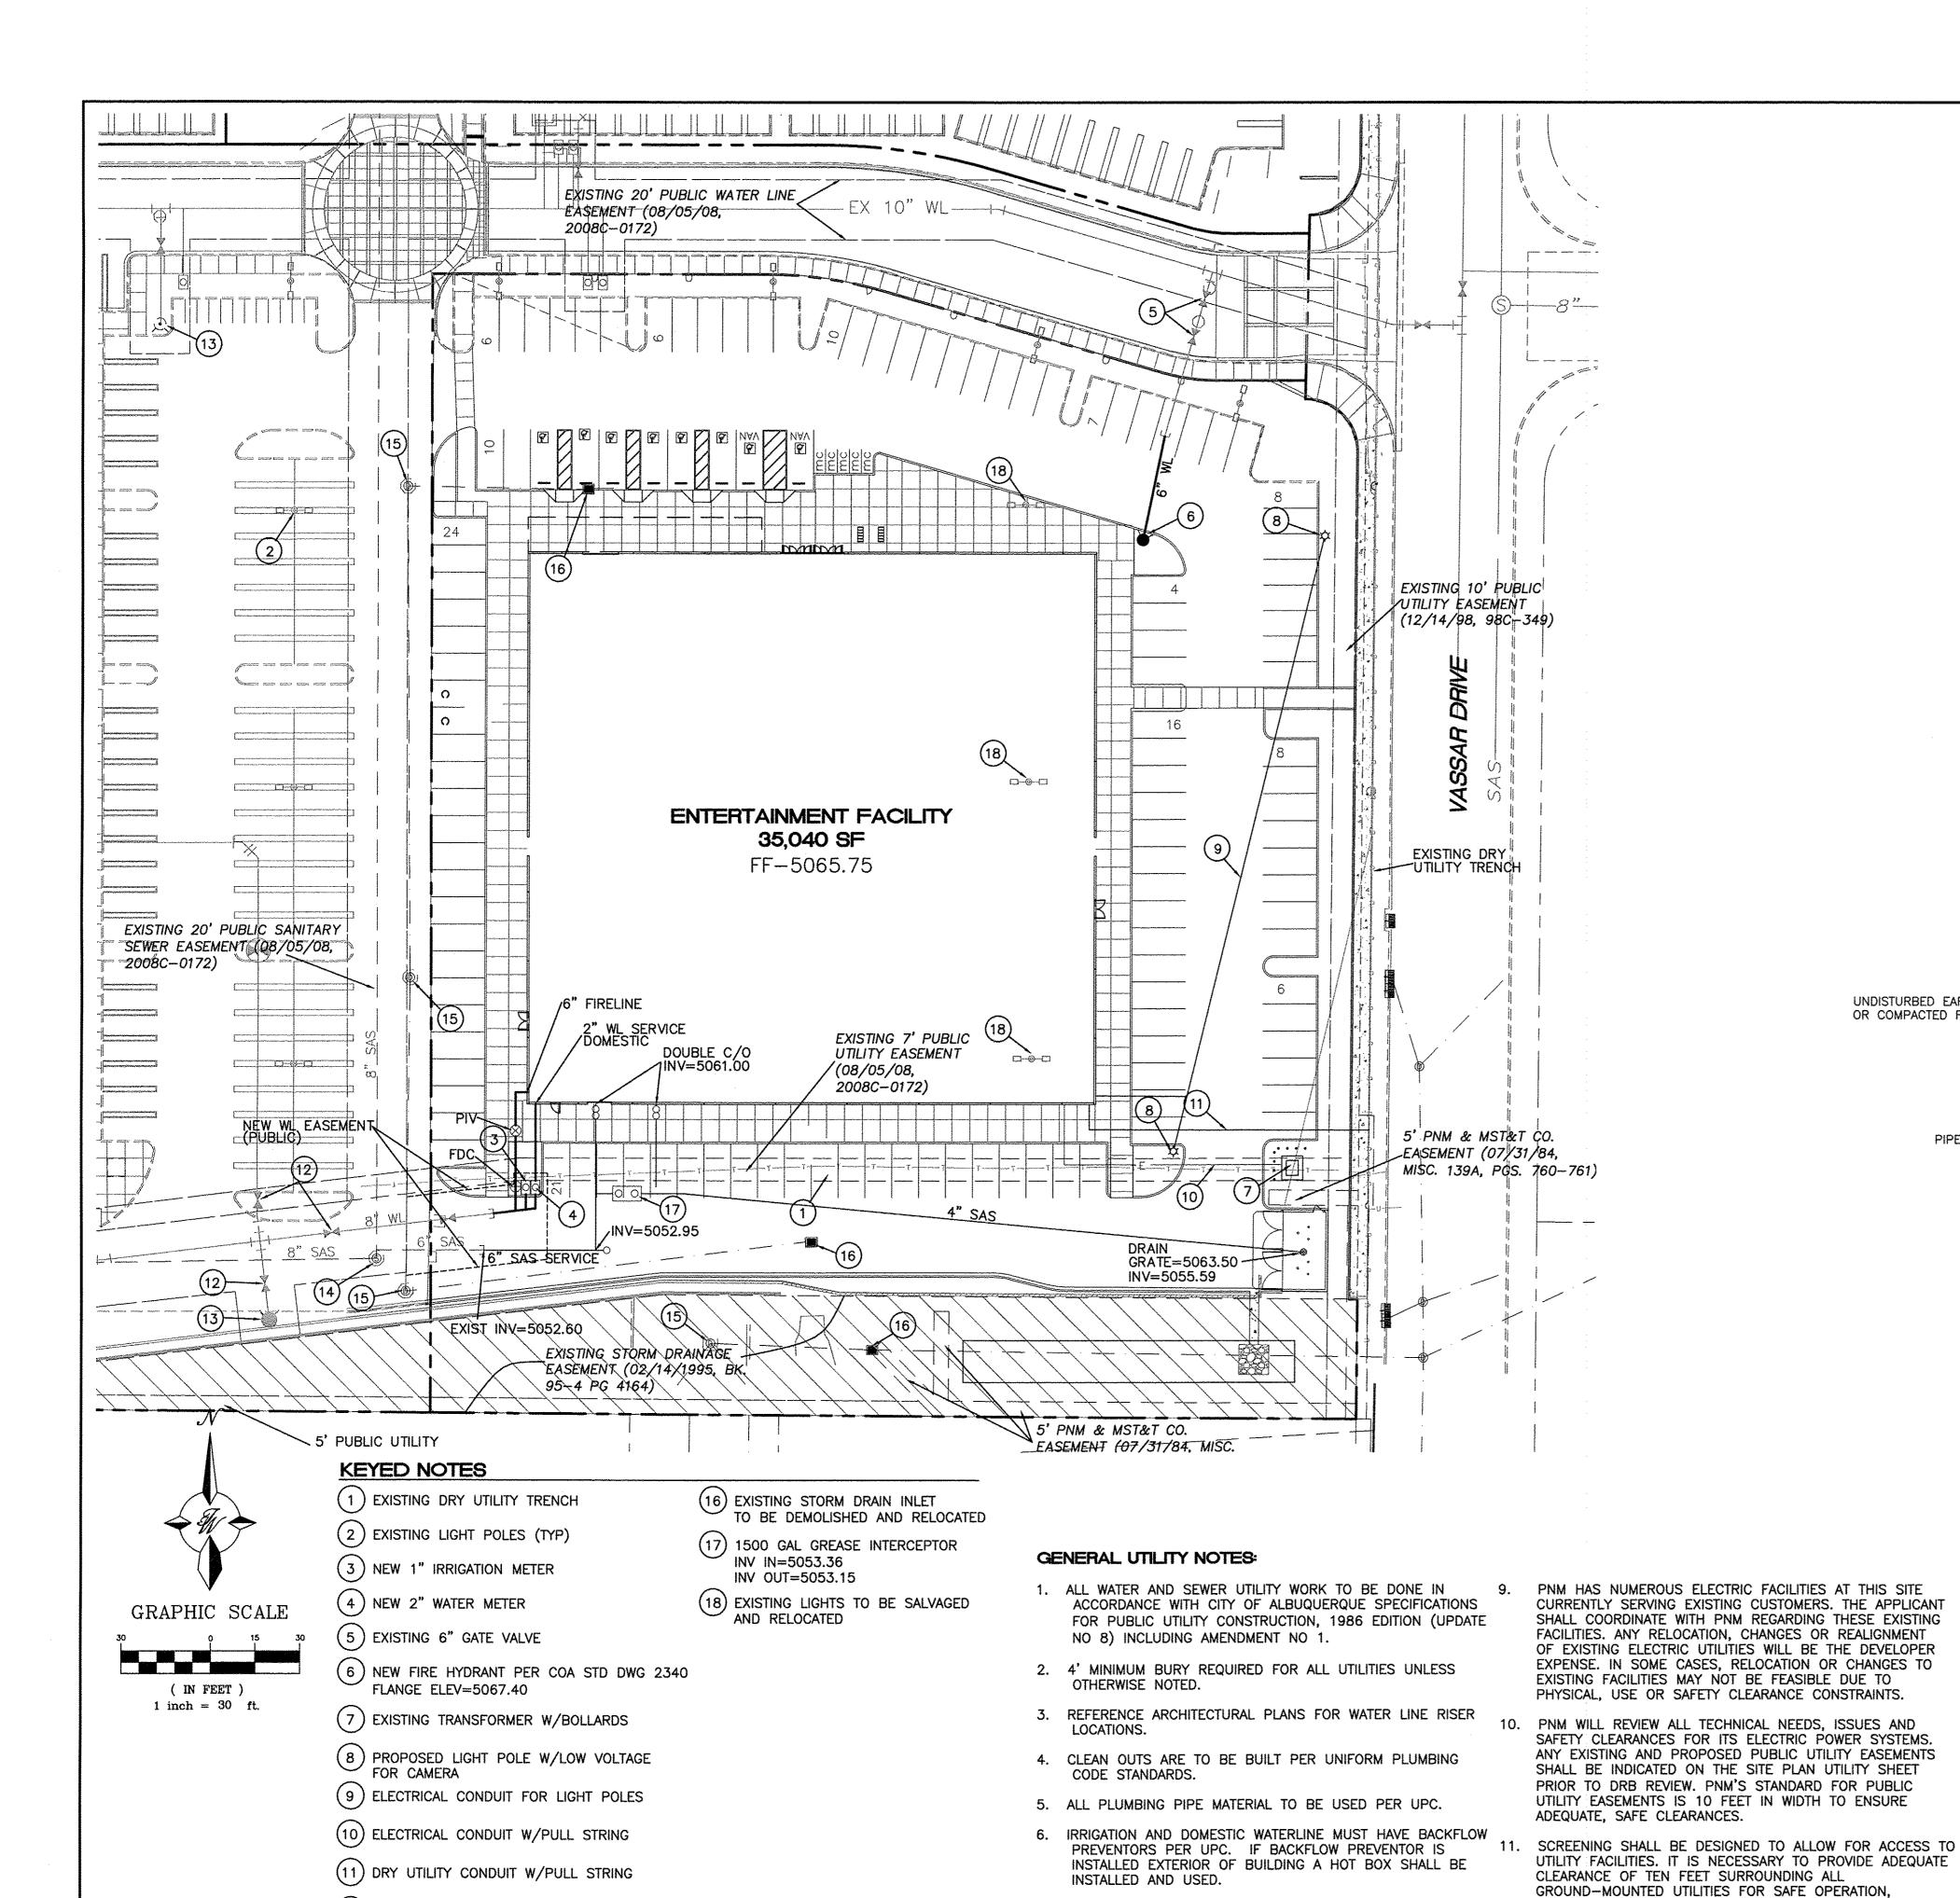

(12) EXISTING GATE VALVE

(13) EXISTING FIRE HYDRANT

(15) EXISTING STORM DRAIN MH

(14) EXISTING SAS MH

LEGEND

CURB & GUTTER BOUNDARY LINE EASEMENT BUILDING EXISTING SCREEN WALL EXISTING CURB & GUTTER ---- EXISTING BOUNDARY LINE SINGLE CLEAN OUT DOUBLE CLEAN OUT EXISTING SD MANHOLE EXISTING SAS MANHOLE EXISTING FIRE HYDRANT EXISTING WATER METER EXISTING POWER POLE EXISTING GAS VALVE - - OH- - EXISTING OVERHEAD UTILITIES --- EX. 8" SAS- -- EXISTING SANITARY SEWER LINE ----EX. WL---- EXISTING WATER LINE


--- EX. RCP--- EXISTING STORM SEWER LINE

PROPOSED ELECTRIC LINE

WATER SHUTOFF NOTES

THE CONTRACTOR SHALL COORDINATE WITH THE WATER AUTHORITY SEVEN (7) DAYS IN ADVANCE OF PERFORMING WORK THAT WILL AFFECT THE PUBLIC WATER OR SANITARY SEWER INFRASTRUCTURE. WORK REQUIRING SHUTOFF OF WELL COLLECTORS, TRANSMISSION LINES OR FACILITIES DESIGNATED AS MASTER PLAN FACILITIES MUST BE COORDINATED WITH THE WATER AUTHORITY 14 DAYS IN ADVANCE OF PERFORMING SUCH WORK. ONLY WATER AUTHORITY CREWS ARE AUTHORIZED TO OPERATE PUBLIC VALVES. SHUTOFF REQUESTS MUST BE MADE HTTP://WWW.ABCWUA.ORG/WATER_SHUT_OFF_AND_TURN_ON_PROCEDURES.ASPX

12"MIN. 0.D. | 12"MIN 18" MAX 118" MAX UNDISTURBED EARTH-OR COMPACTED FILL INITIAL BACKFILL PIPE SPRING HAUNCHING 4" BEDDING (MIN.)

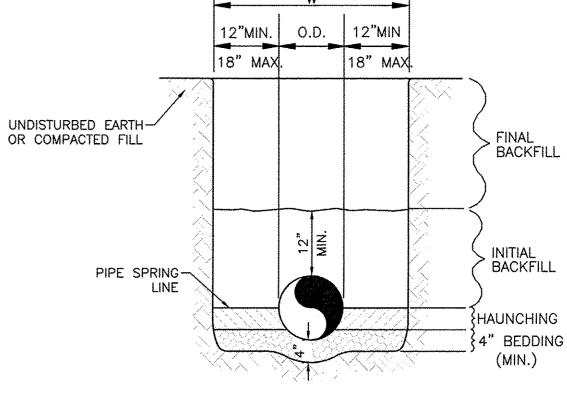

WATER LINE

GENERAL NOTES

- BEDDING SHALL BE CLASS I-A WORKED BY HAND. IF GROUNDWATER IS ANTICIPATED, THEN BEDDING SHALL BE CLASS I-B COMPACTED TO 85% STANDARD PROCTOR. (SEE SPECIFICATIONS FOR GRADATION)
- 2. HAUNCHING SHALL BE WORKED AROUND THE PIPE BY HAND TO ELIMINATE VOIDS AND SHALL BE CLASS I-A OR CLASS I-B OR CLASS II COMPACTED TO 85% PROCTOR.
- 3. INITIAL BACKFILL SHALL BE CLASS I-A WORKED BY HAND, OR CLASS I-B OR CLASS II COMPACTED TO 85% STANDARD PROCTOR.
- 4. INITIAL BACKFILL NOT UNDER PAVED AREAS CAN BE COMPACTED TO 90% STANDARD PROCTOR.
- FINAL BACKFILL SHALL BE CLASS I, OR II COMPACTED AS NOTED IN NOTES 3. AND 4.

FINAL BACKFILL NOT UNDER PAVED AREAS CAN BE TYPE II COMPACTED TO 95% STANDARD PROCTOR.

SANITARY SEWER

- 7. ALL MATERIALS ARE CLASSIFIED IN ACCORDANCE WITH ASTM D 2321-89.
- 8. ALL MATERIALS SHALL BE INSTALLED IN MAXIMUM 8" LOOSE LIFTS IN ACCORDANCE WITH ASTM D 698.
- 9. FILL SALVAGED FROM EXCAVATION SHALL BE FREE OF DEBRIS, ORGANICS AND ROCKS LARGER THAN 3".
- 10. ALL TRENCH EXCAVATIONS SHALL BE SLOPED, SHORED, SHEETED, BRACED, OR OTHERWISE SUPPORTED IN COMPLIANCE WITH OSHA REGULATIONS AND LOCAL ORDINANCES. (SEE SPECIFICATIONS)

UTILITY TRENCH AND BEDDING DETAIL

ALL EXISTING UTILITIES SHOWN WERE OBTAINED FROM RESEARCH, AS-BUILTS, SURVEYS OR INFORMATION PROVIDED BY OTHERS. IT SHALL BE THE SOLE RESPONSIBILITY OF THE CONTRACTOR TO CONDUCT ALL NECESSARY FIELD INVESTIGATIONS PRIOR TO AND INCLUDING ANY EXCAVATION, TO DETERMINE THE ACTUAL LOCATION OF UTILITIES AND OTHER IMPROVEMENTS, PRIOR TO STARTING THE WORK. ANY CHANGES FROM THIS PLAN SHALL BE COORDINATED WITH AND APPROVED BY THE ENGINEER.

ENGINEER'S SEAL
R BOHANNA REGISTREES PROFESSIONAL
RONALD R. BOHANNAN

P.E. #7868

	ENTERTAIMENT FACILITY 3930 PAN AMERICAN FRWY	<i>DRAWN BY</i> pm
	MASTER UTILITY	<i>DATE</i> 2-15-18
	PLAN	DRAWING
		SHEET #
	TIERRA WEST, LLC 5571 MIDWAY PARK PL NE ALBUQUERQUE, NEW MEXICO 87109	4
VAN	(505) 858-3100 www.tierrawestllc.com	<i>JOB #</i> 2017042

CAUTION:

MAINTENANCE AND REPAIR PURPOSES.

"SAFETY ORANGE"


ALL ONSITE FIRE HYDRANTS ARE PRIVATE AND PAINTED

7. ALL EXCAVATION, TRENCHING AND SHORING ACTIVITIES


CFR 1926.650 SUBPART P.

MUST BE CARRIED-OUT IN ACCORDANCE WITH OSHA 29

8. ALL UTILITY DISTANCES SHOWN ARE FOR REFERENCE ONLY.

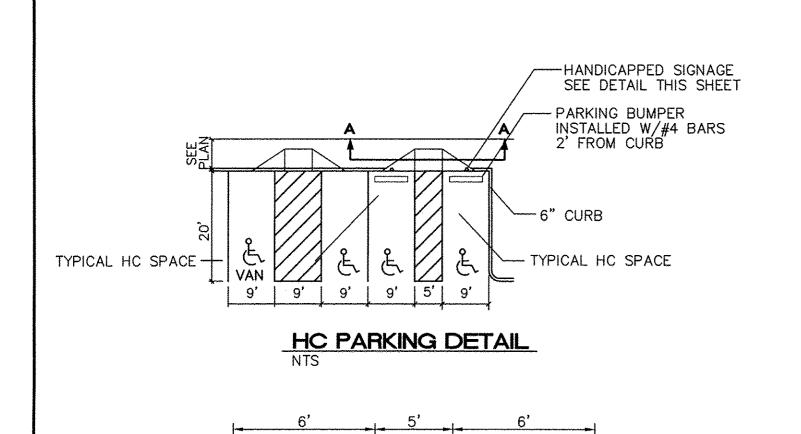


HC PARKING DETAIL SECTION A-A

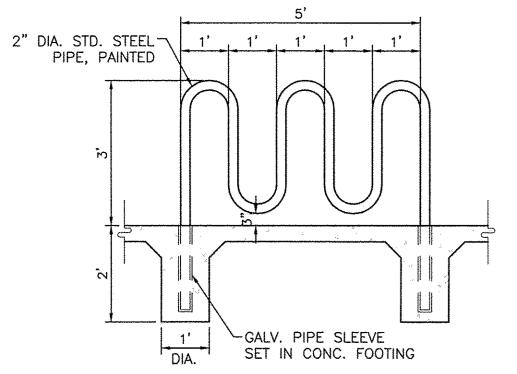

BIKE RACK DETAIL

SCALE: 1/2"=1'

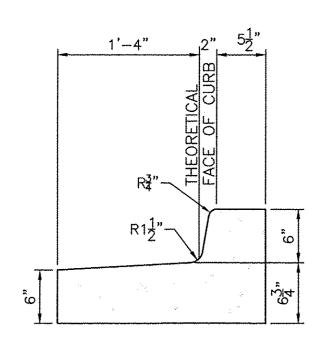

CURB GENERAL NOTES:

1. ALL CURBS TO BE CONSTRUCTED OF PORTLAND
CEMENT CONCRETE, PER WAL—MART SPECIFICATIONS.


2. PROVIDE CONTRACTION JTS. 12' MAX., SPACING, 1/2"
EXP. JTS. AT CURB RETURNS AND AT A MAX. SPACING
OF 120' BETWEEN CURB RETURNS AND EACH SIDE OF
SEPARATELY CONSTRUCTED DRIVEWAYS. CONTRACTION JTS.,
SHALL BE EITHER SAWED OR TOOLED A MINIMUM OF 1"
DEEP AT FINISHED FACES.

3. ALL EDGES SHALL BE EDGED WITH A 3/8" RADUIS
EDGING TOOL.

EDGING TOOL.

4. 1/4" ISOLATION JOINT SHALL BE PLACED BETWEEN SIDEWALK AND CURB WHEN CAST ADJACENT TO EACH OTHER.

STANDARD CURB / GUTTER

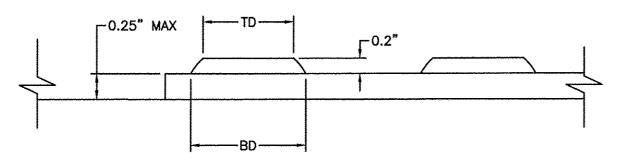



DOME SECTION

BD - BASE DIAMETER 0.9" MIN

TD - TOP DIAMETER 50% OF BD MIN TO

65% OF BD MAX

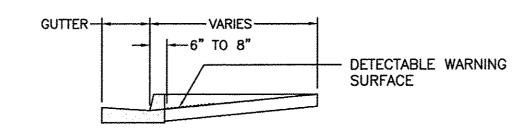

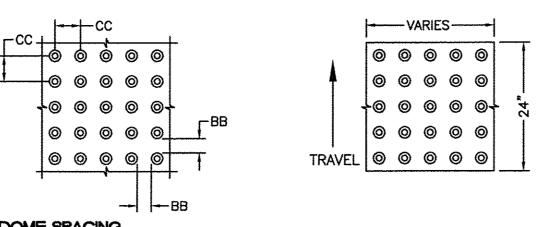



DOME SPACING

CC - CENTER TO CENTER SPACING
2.35"


BB - BASE TO BASE SPACING
1.48" MIN

DETECTABLE WARNING SURFACE NOT TO SCALE

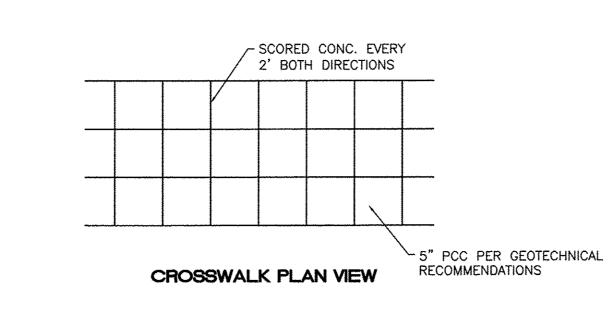


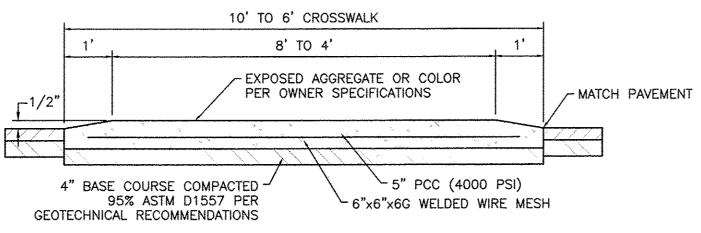


RAISED CROSSWALK

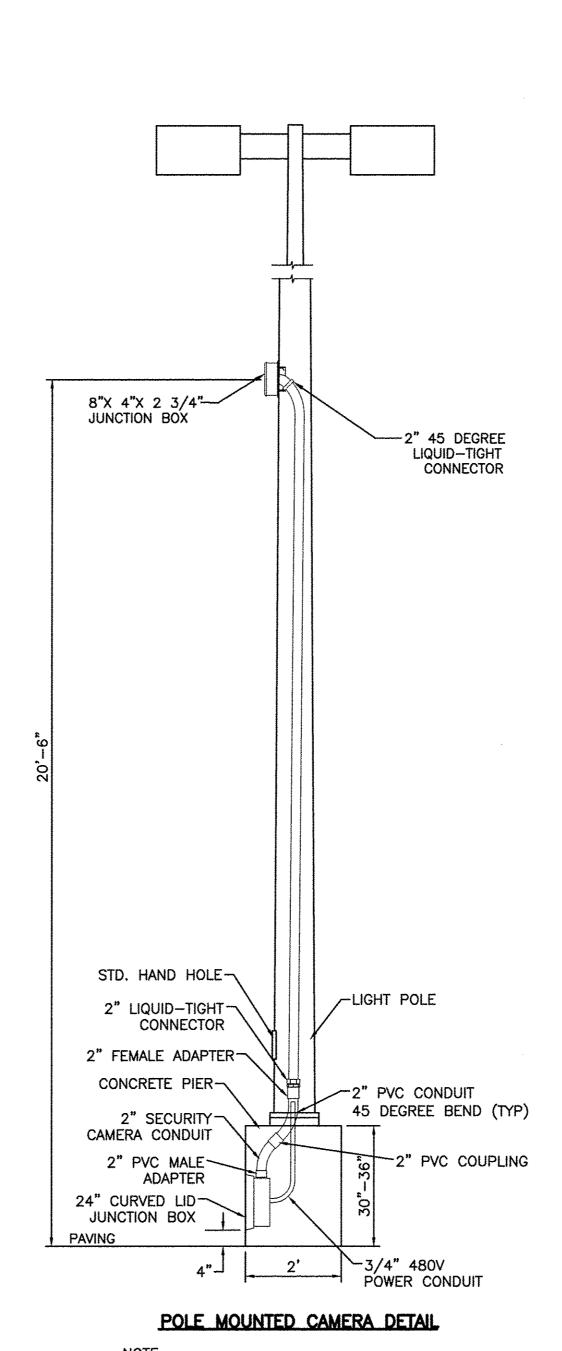


NOTE:
ONLY FOR POLE LOCATIONS DESIGNATED WITH
"CAM" SUFFIX ONLY, I.E. BV—CAM. CAMERAS AND
WIRING BY OTHERS.

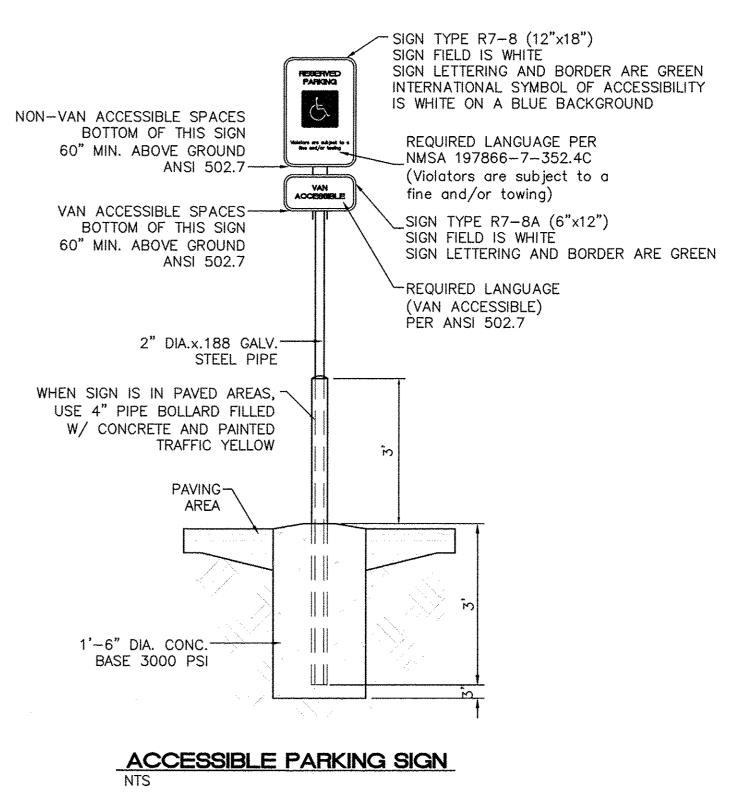


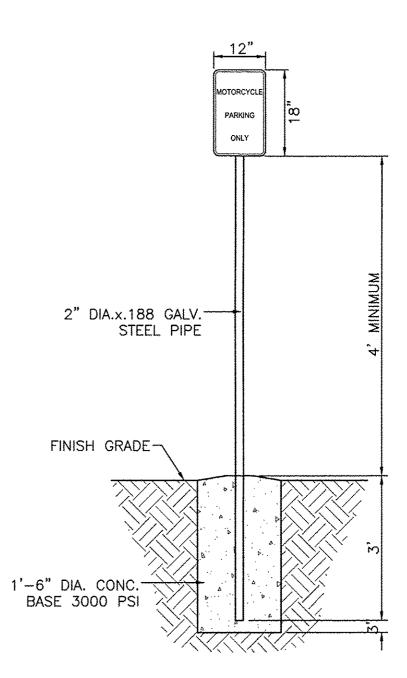



MOTORCYCLE PARKING SIGN

ENGINEER'S SEAL	ENTERTAIMENT FACILITY 3930 PAN AMERICAN FRWY	<i>DRAWN BY</i> pm
	330 FAN AMENICAN FRINT	DATE
IN BOW	CONSTRUCTION DETAILS	2-15-18
SHAN WEY		DRAWING
CONTRACTOR OF THE PARTY OF THE		SHEET #
PROFESSIONALES	TIERRA WEST, LLC 5571 MIDWAY PARK PL NE ALBUQUERQUE, NEW MEXICO 87109	5
RONALD R. BOHANNAN P.E. #7868	(505) 858-3100 www.tierrawestllc.com	<i>JOB #</i> 2017042

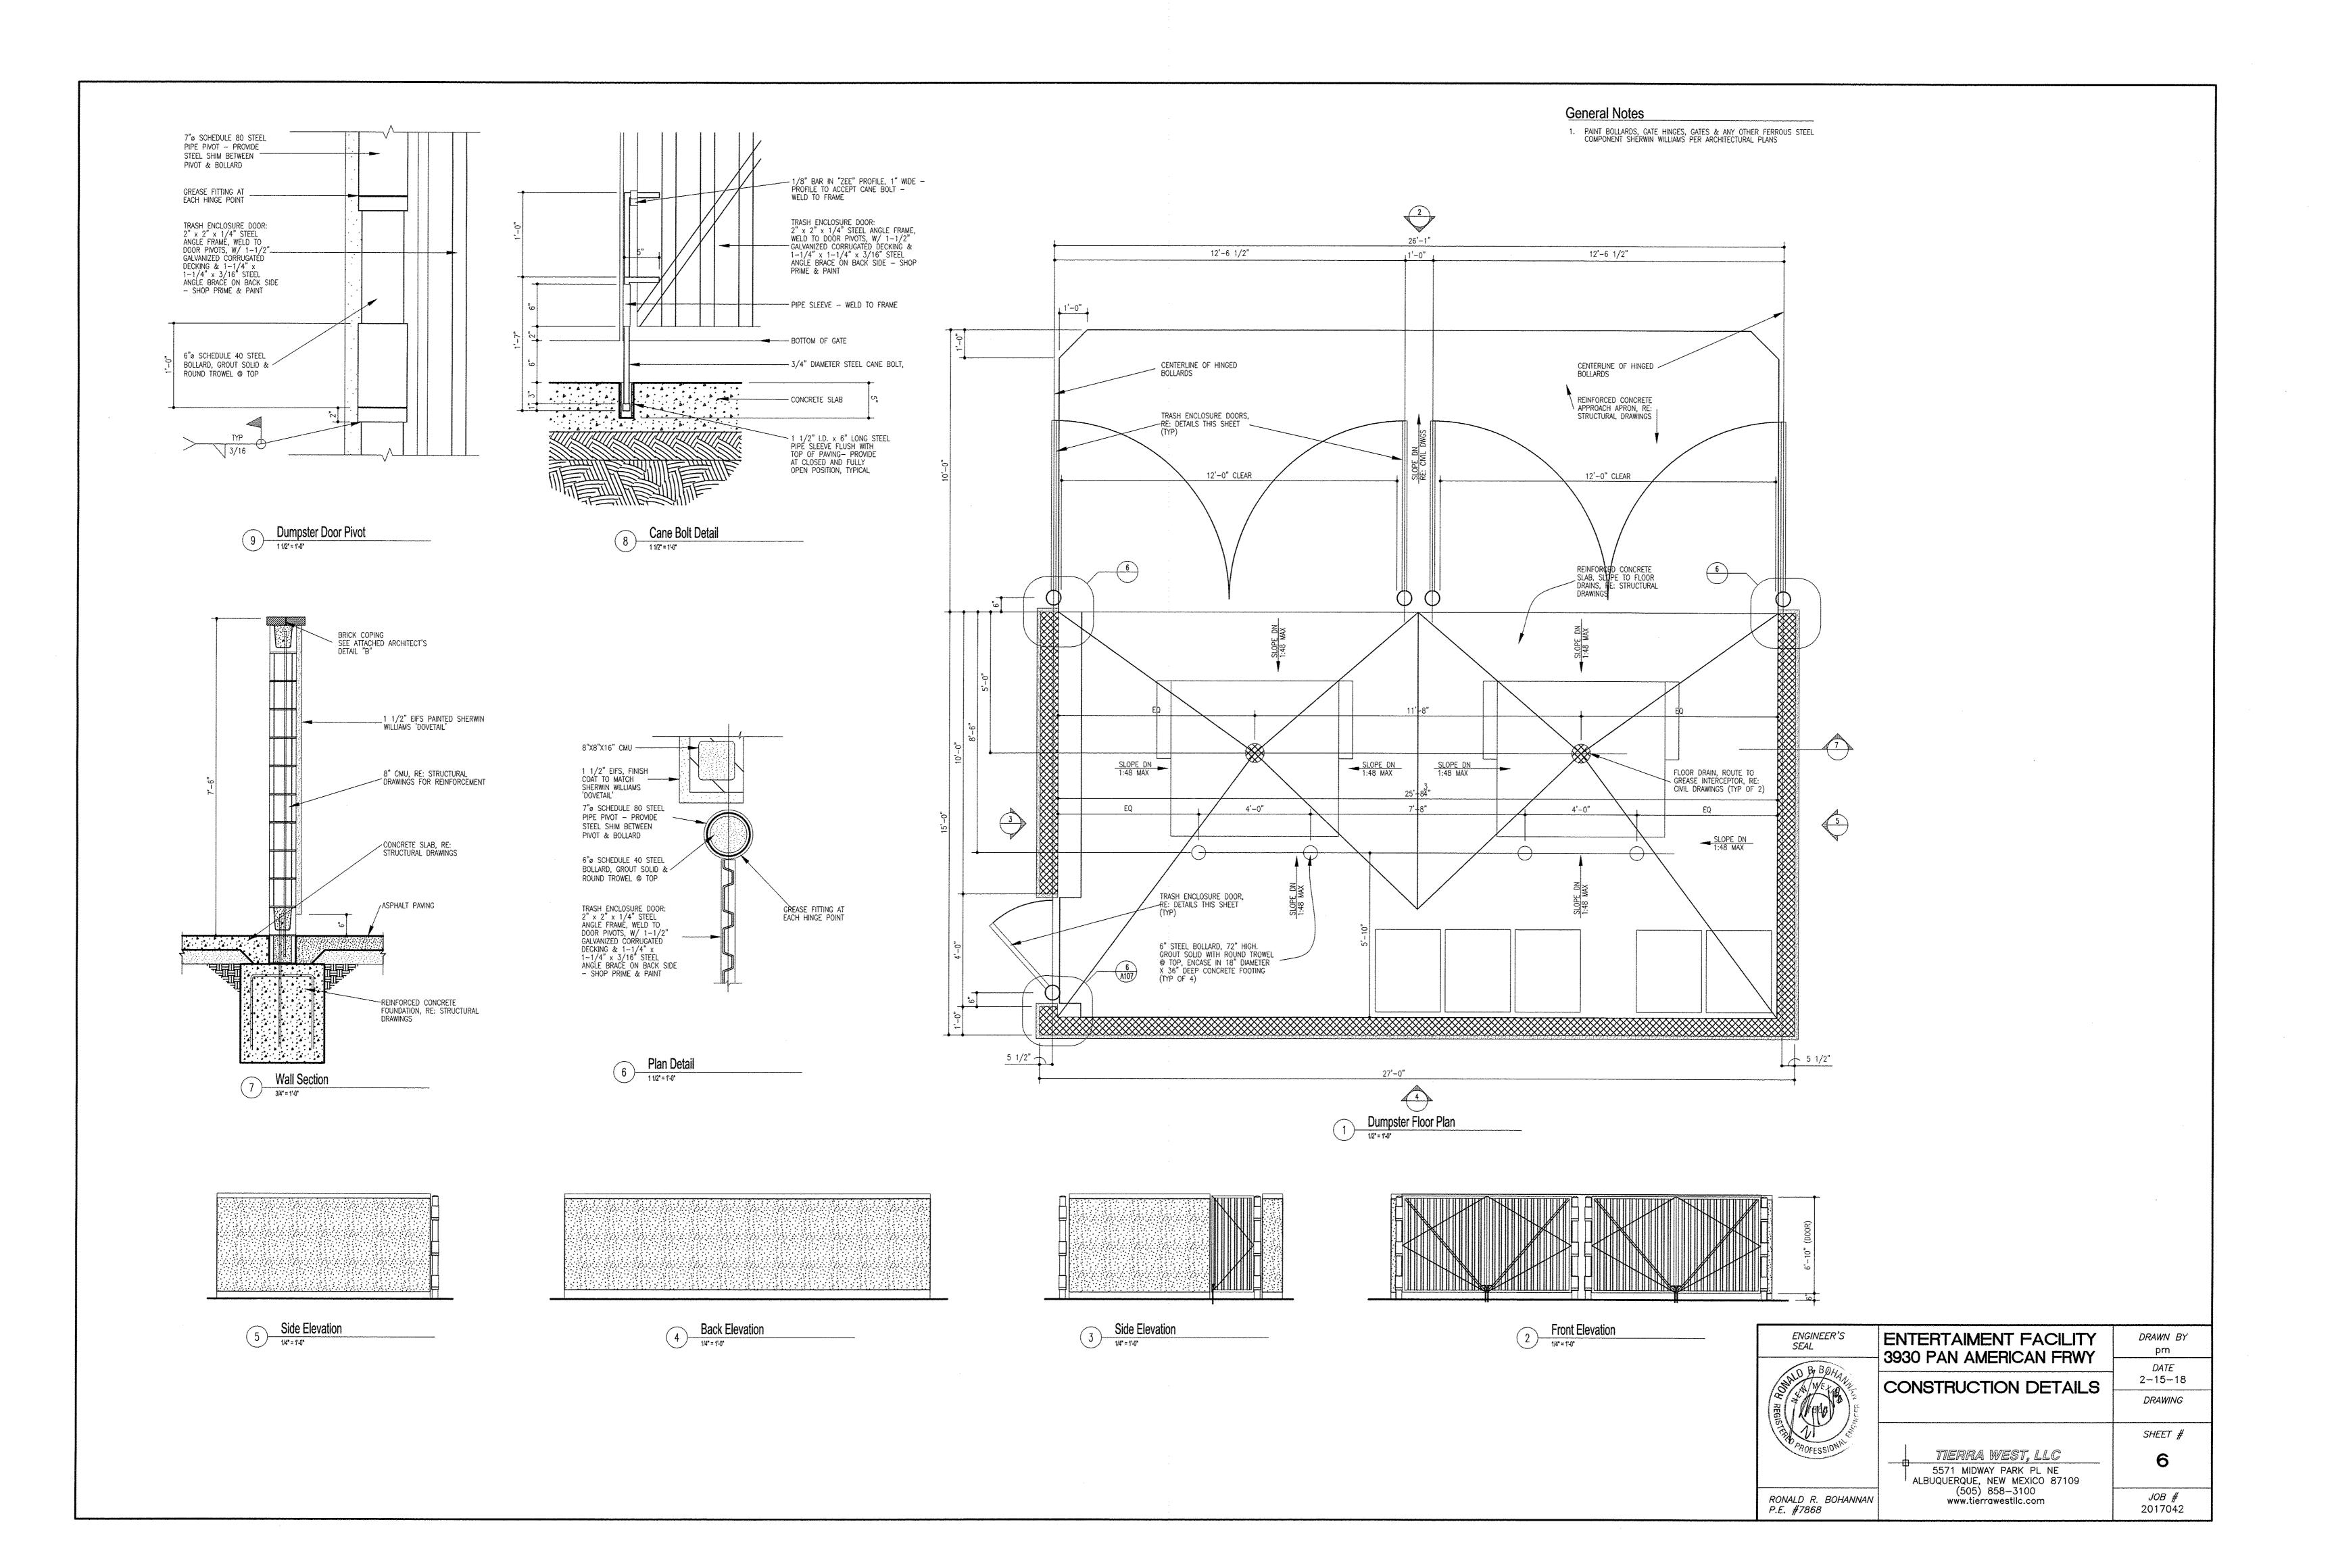

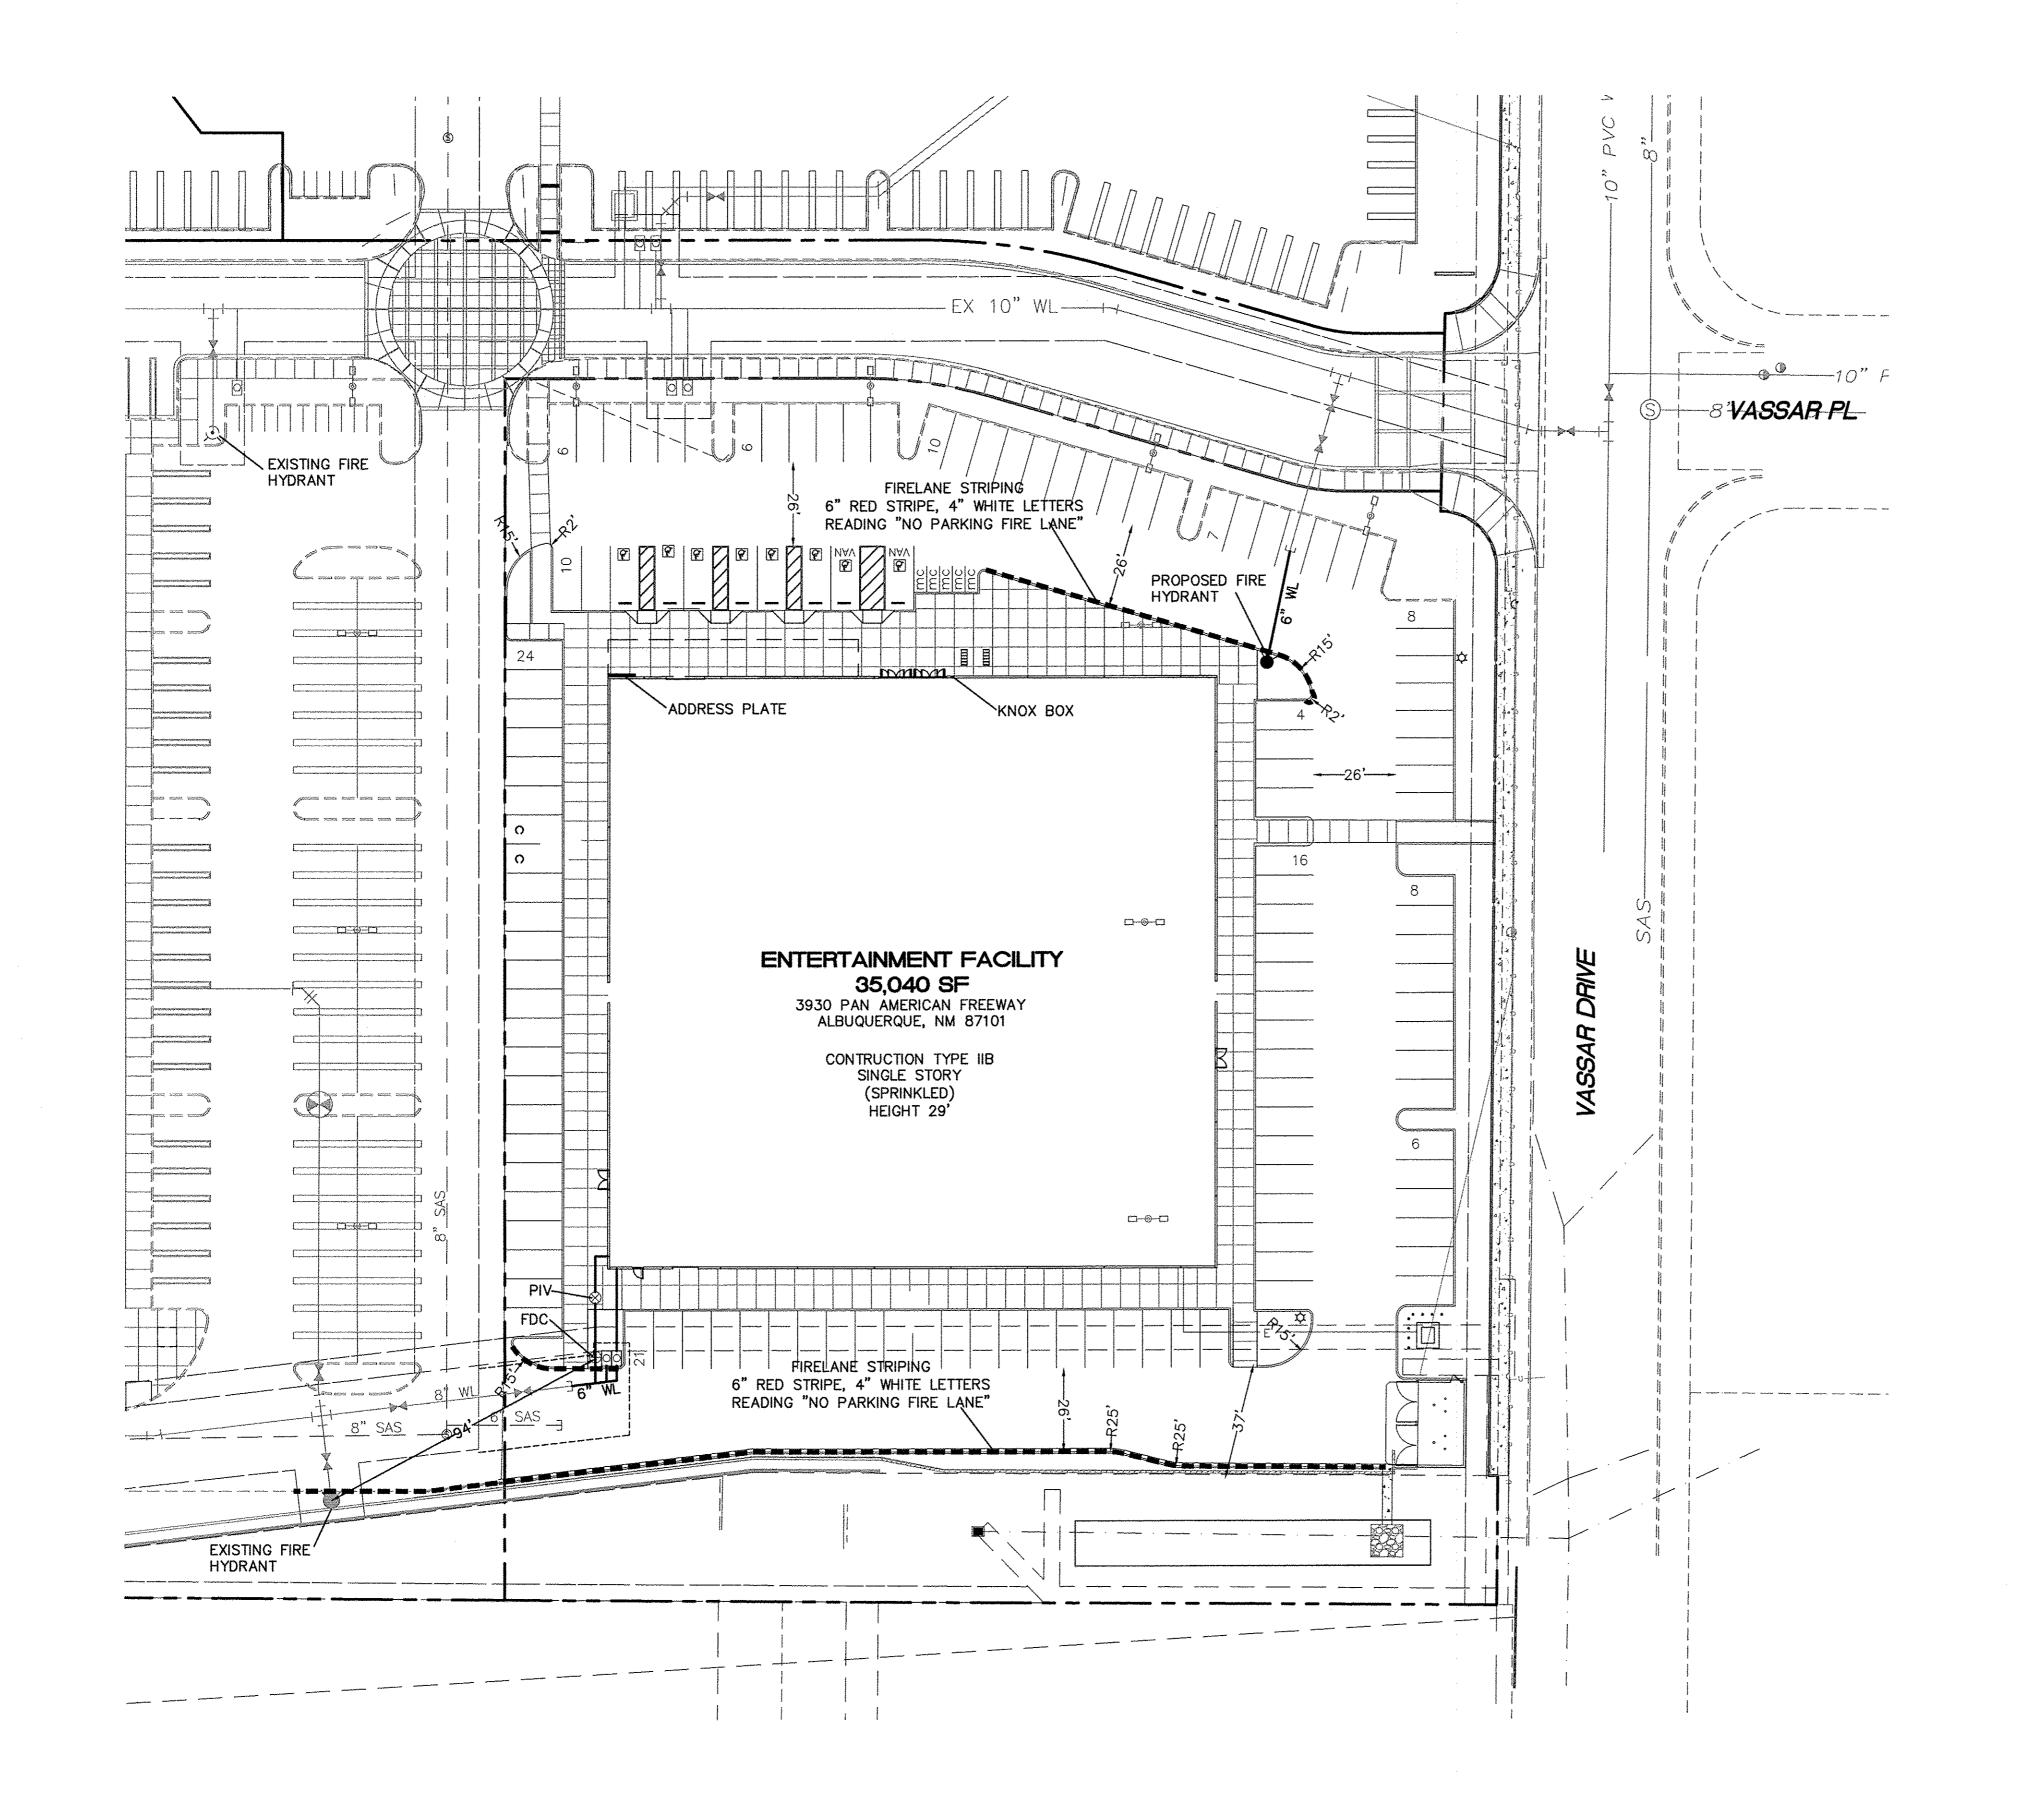

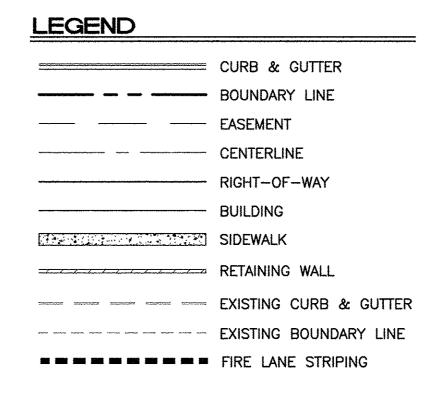

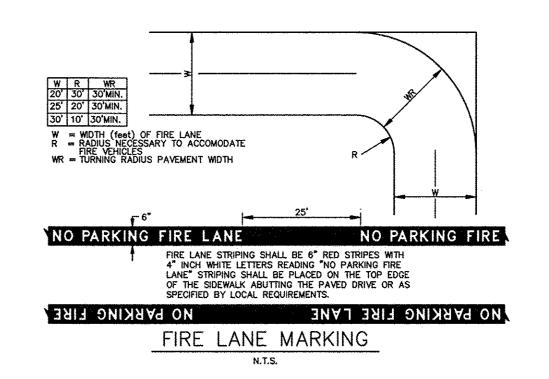

NOTES


- 1. ALL DRIVING SURFACES WILL BE ASPHALT AND ABLE TO SUPORT AT LEAST 75000 LBS OF FIRE EQUIPMENT
- 2. THIS SITE NO FIRE ACCESS LANES THAT EXCEED 10% SLOPE



(IN FEET) 1 inch = 30 ft.

ENGINEER'S SEAL
R BOHANNA HEAR OF THE STORY OF
RONALD R. BOHANNAN

ENGINEER'S SEAL	ENTERTAIMENT FACILITY 3930 PAN AMERICAN FRWY	<i>DRAWN BY</i> pm
BOHAND REGISTER HOLD REGISTER AND REGISTER A		<i>DATE</i> 2-15-18
	FIREONE PLAN	DRAWING
		SHEET #
PROFESSIONAL	TIERRA WEST, LLC 5571 MIDWAY PARK PL NE ALBUQUERQUE, NEW MEXICO 87109	7
RONALD R. BOHANNAN P.E. #7868	(505) 858-3100 www.tierrawestllc.com	<i>JOB #</i> 2017042

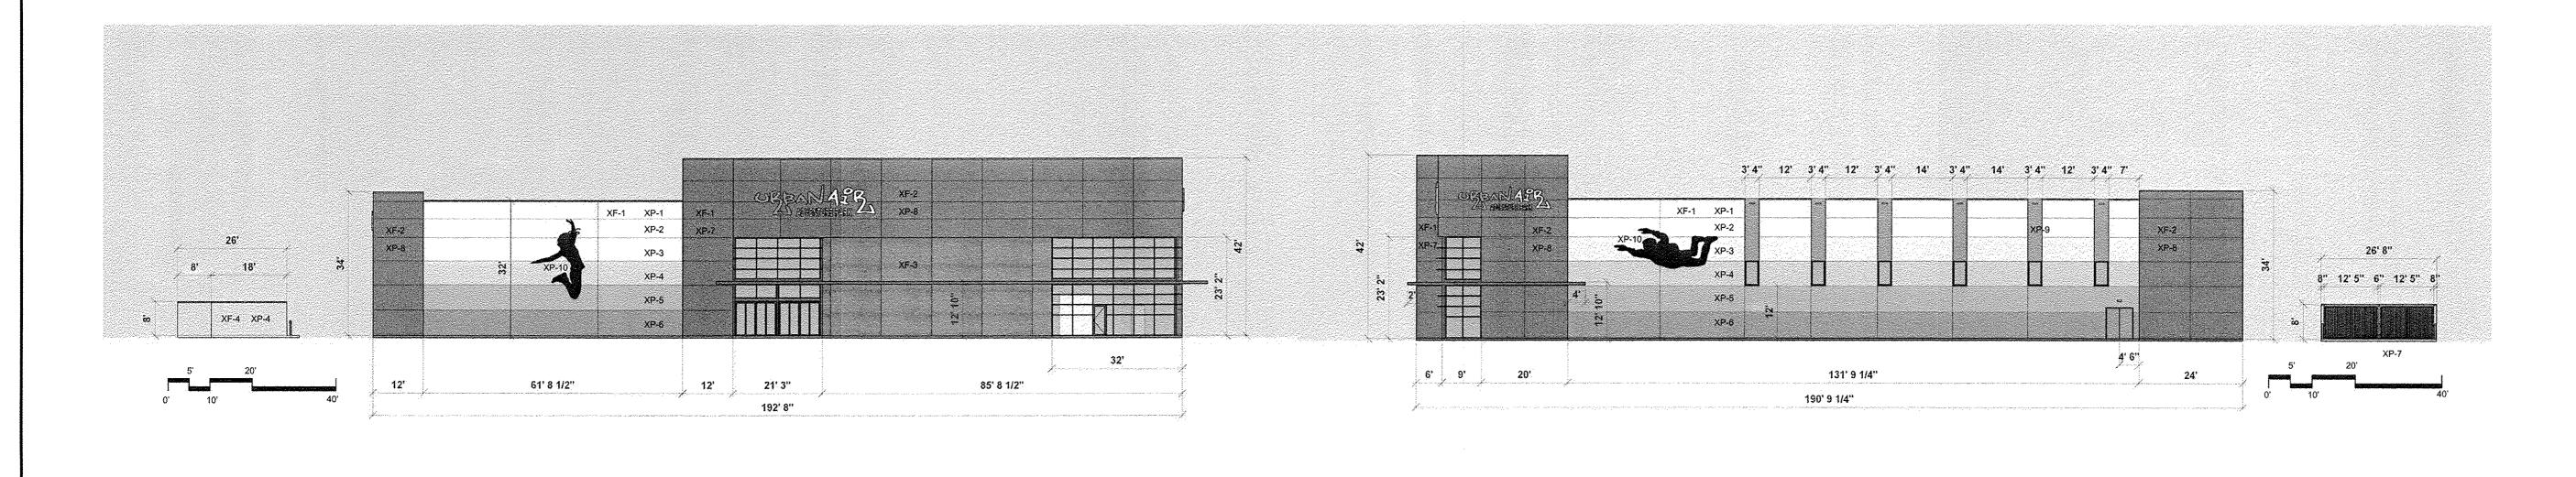


NORTH ELEVATION


Idstudio

URBAN AIR

WEST ELEVATION

URBAN AIR

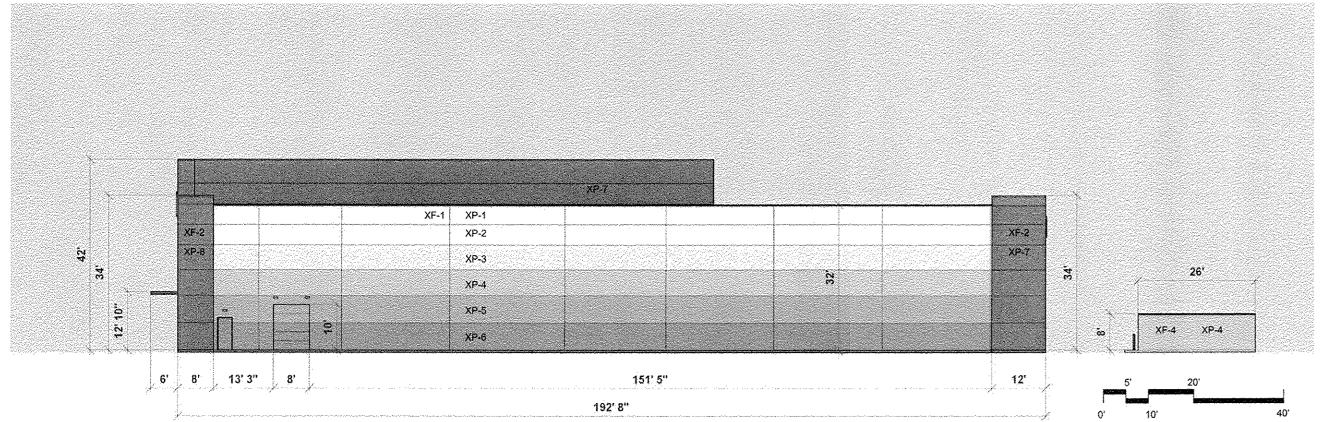

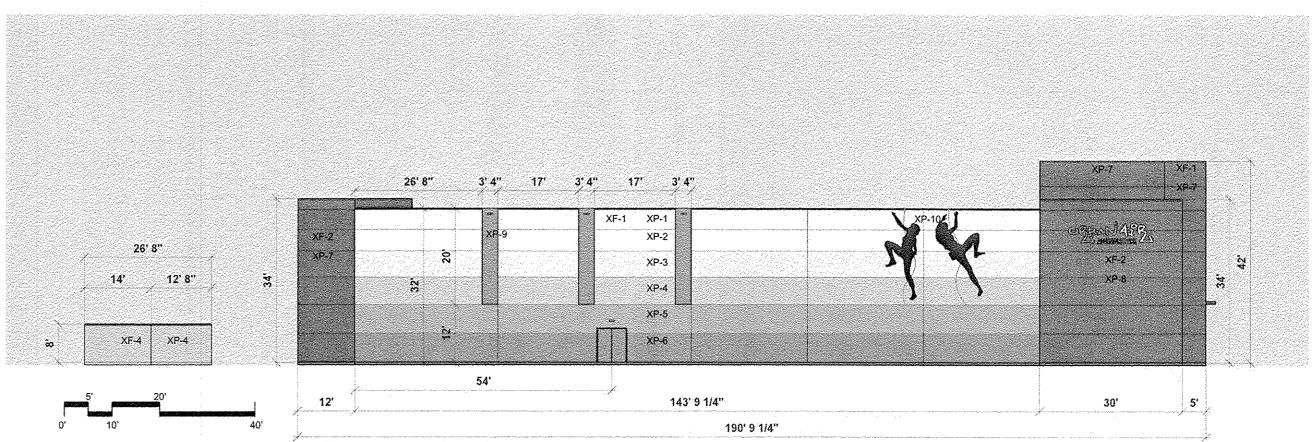

idstudio URBAN AIR

SOUTH ELEVATION

URBAN AIR

Idstudio URBAN AIR

EXTERIOR FINSIH SCHEDULE


	Item	Manufacturer	Product
XF-1	Tilt Wall (main building)	TBD	Conc. Tilt Wall
XF-2	EIFS (main building bump-outs)	TBD	
XF-3	Nichiha exterior planks (front entry)	Nichiha	Vintage Wood Cedar
XF-4	CMU Block Wall (dumpster enclosure)	TBD	
XP-1	"Passive" – paint (exterior tilt wall)	Sherwin Williams	SW 7064 "Passive"
XP-2	"Argos" – paint (exterior tilt wall)	Sherwin Williams	SW 7065 "Argos"
XP-3	"Gray Matters" – paint (exterior tilt wall)	Sherwin Williams	SW 7066 "Gray Matters"
XP-4	"Tin Lizzie" – paint (exterior tilt wall)	Sherwin Williams	SW 9163 "Tin Lizzie"
XP-5	"City Scape" – paint (exterior tilt wall)	Sherwin Williams	SW 7067 "City Scape"
XP-6	"Grizzle Gray" – paint (exterior tilt wall)	Sherwin Williams	SW 7068 "Grizzle Gray"
XP-7	"Iron Ore" – paint (exterior tilt wall & awning)	Sherwin Williams	SW 7069 "Iron Ore"
XP-8	"Spicy Hue" – paint (exterior EFIS)	Sherwin Williams	SW 6342 "Spicy Hue"
XP-9	"Obstinate Orange" – paint (exterior EFIS details)	Sherwin Williams	SW 6884 "Obstinate Orange
XP-10	"Tricorn Black" – paint (silhouettes)	Sherwin Williams	SW 6258 "Tricorn Black"

Idstudio

EXTERIOR FINISH SCHEDULE

1431 GREENWAY DR. SLITE 510
IRVING, TX 75038 972.870.1288 0#

ENGINEER'S SEAL	ENTERTAIMENT FACILITY 3930 PAN AMERICAN FRWY	<i>DRAWN BY</i> pm
REGISTER O PROFESSIONAL BESISTER OF PROFESSION	0900 I AN AMELICAN I IIVI	DATE
	BUILDING ELEVATIONS	2-15-18
		DRAWING
		SHEET #
PROFESSION	5571 MIDWAY PARK PL NE ALBUQUERQUE, NEW MEXICO 87109	8
RONALD R. BOHANNAN P.E. #7868	(505) 858-3100 WWW.tierrawestllc.com	<i>JOB #</i> 2017042

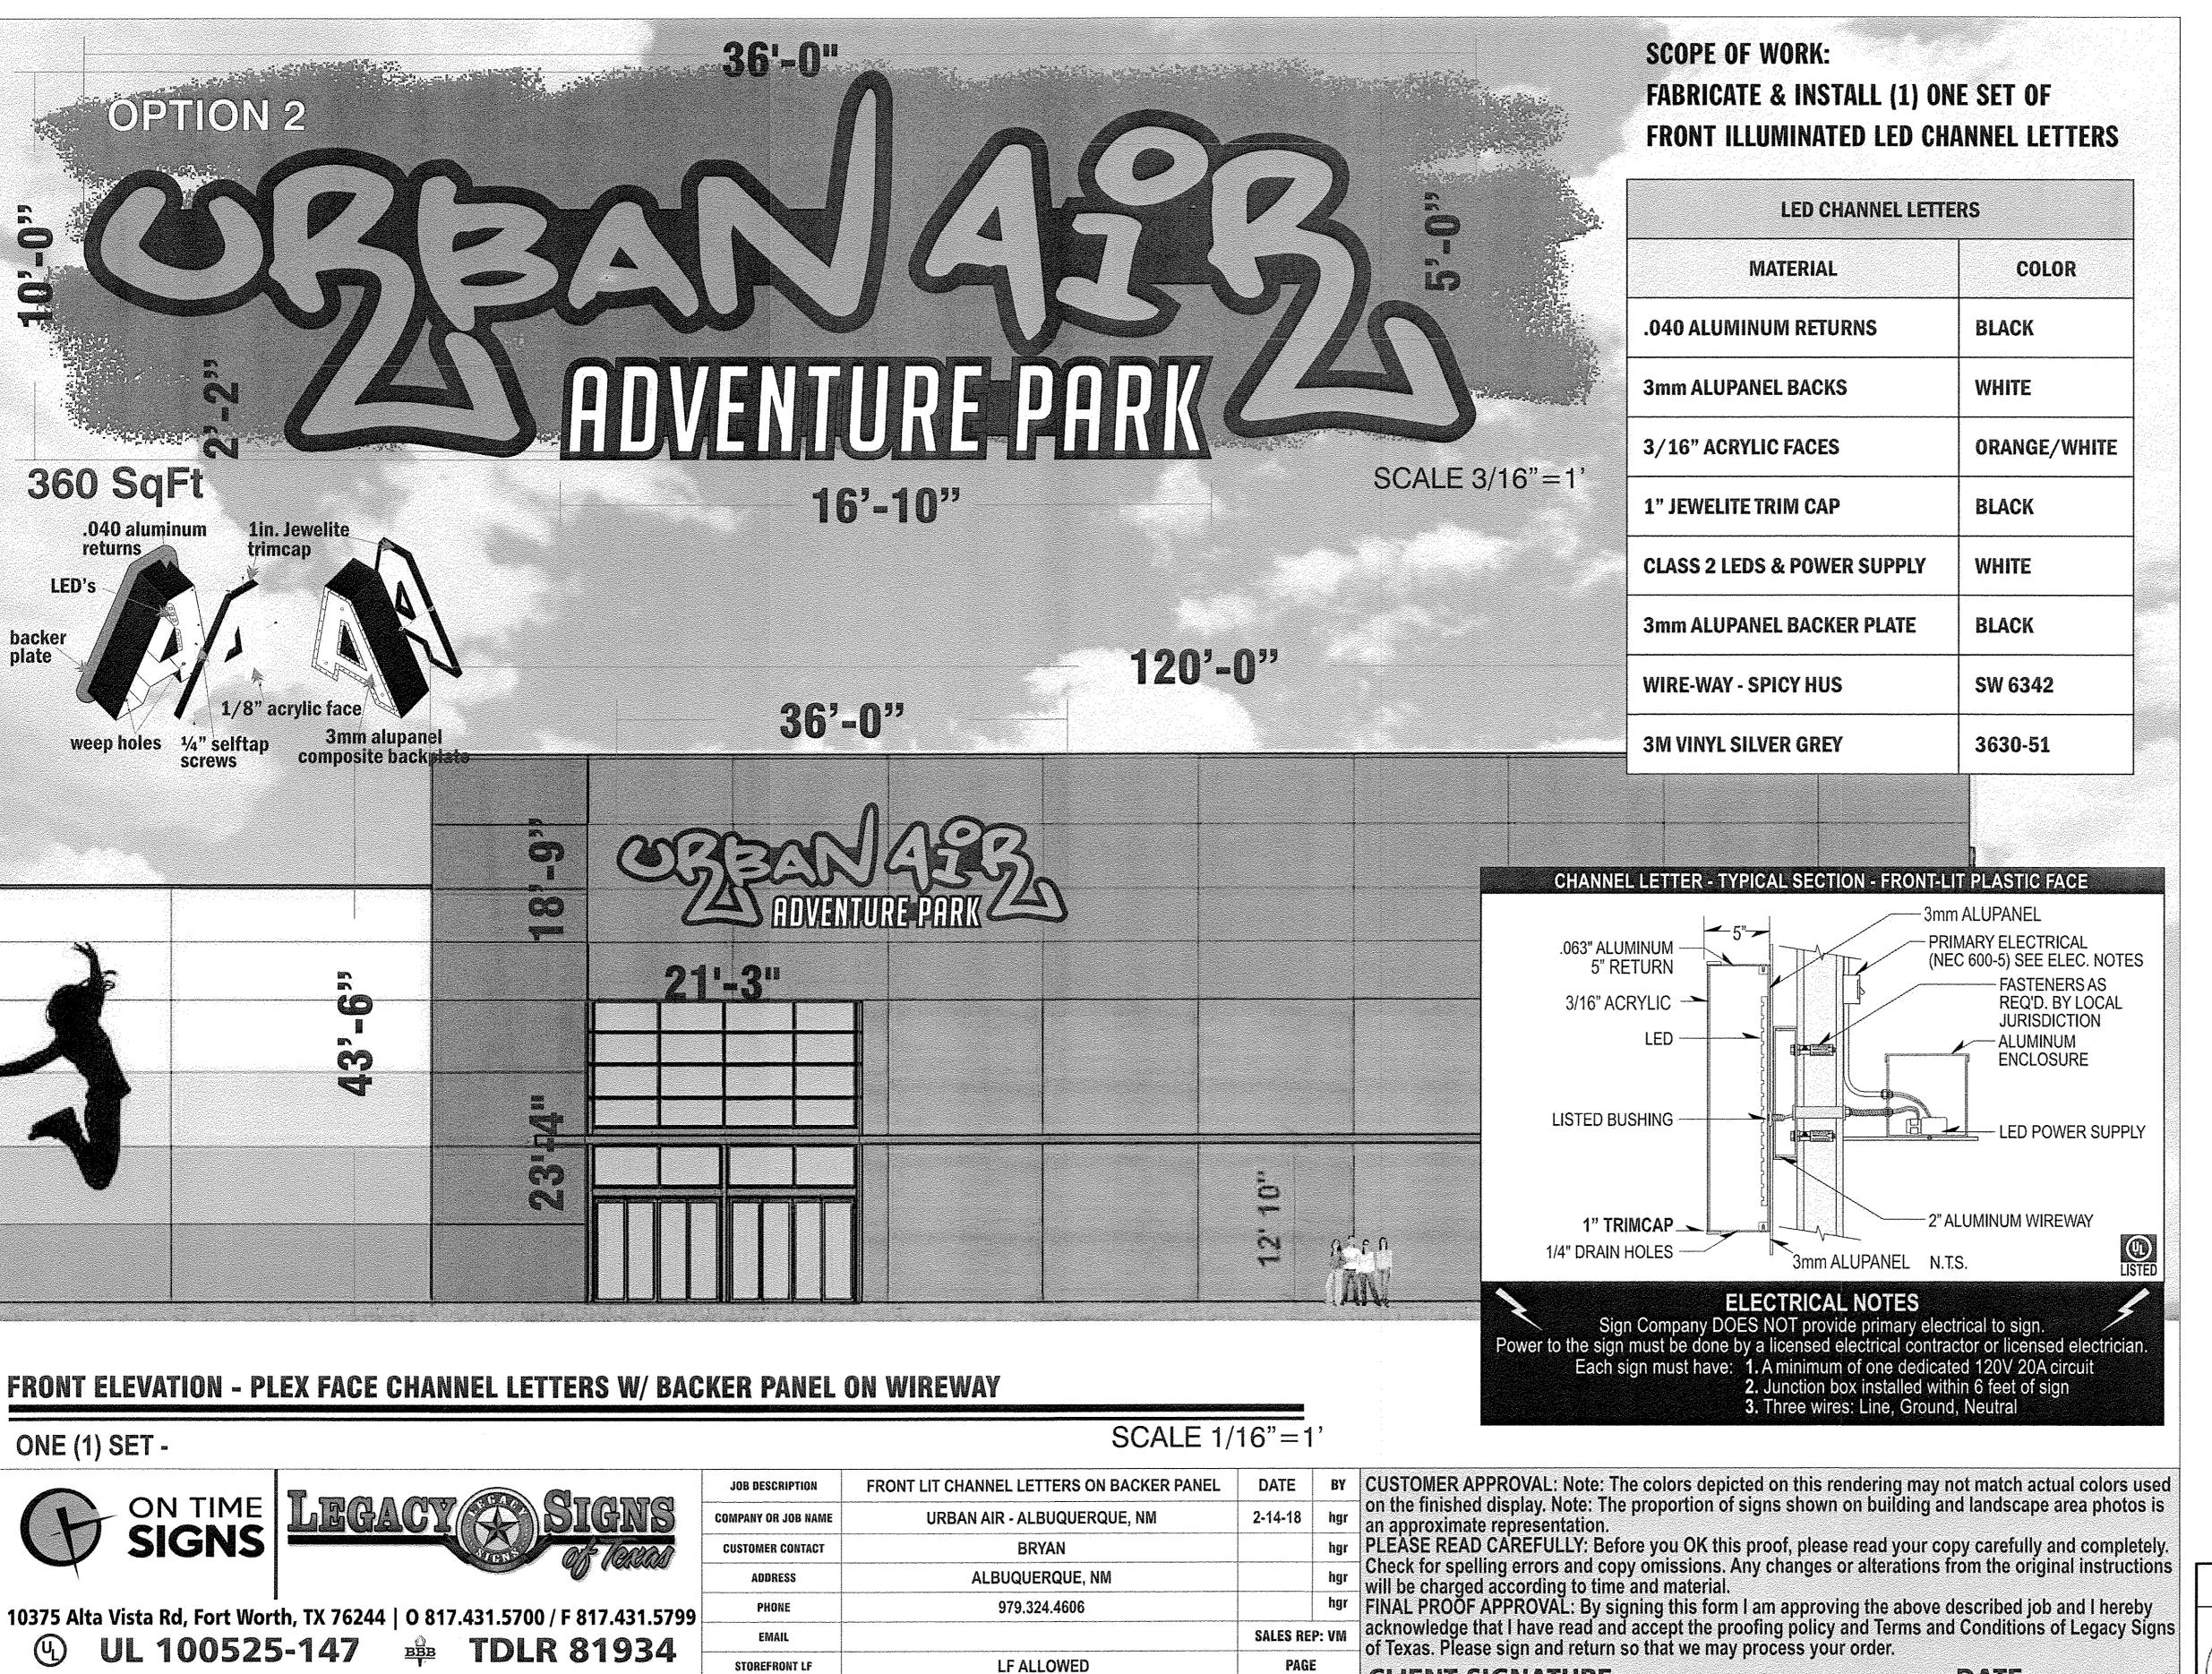

LF ALLOWED

360 SF

CLIENT SIGNATURE:

1 OF 4

DATE:


EMAIL

STOREFRONT LF

UL 100525-147 📫 TDLR 81934

CONCEPT ART, NOT FOR PRODUCTION

ENGINEER'S SEAL	ENTERTAIMENT FACILITY 3930 PAN AMERICAN FRWY	<i>DRAWN BY</i> pm
0 R 80 MS	3930 FAN AMERICAN PRIVI	DATE
	SIGN ELEVATION	2-15-18
	OIGIT LLLYATION	DRAWING
		SHEET #
POFESSIONE	TIERRA WEST, LLC 5571 MIDWAY PARK PL NE ALBUQUERQUE, NEW MEXICO 87109	9
RONALD R. BOHANNAN P.E. #7868	(505) 858-3100 www.tierrawestllc.com	<i>JOB #</i> 2017042

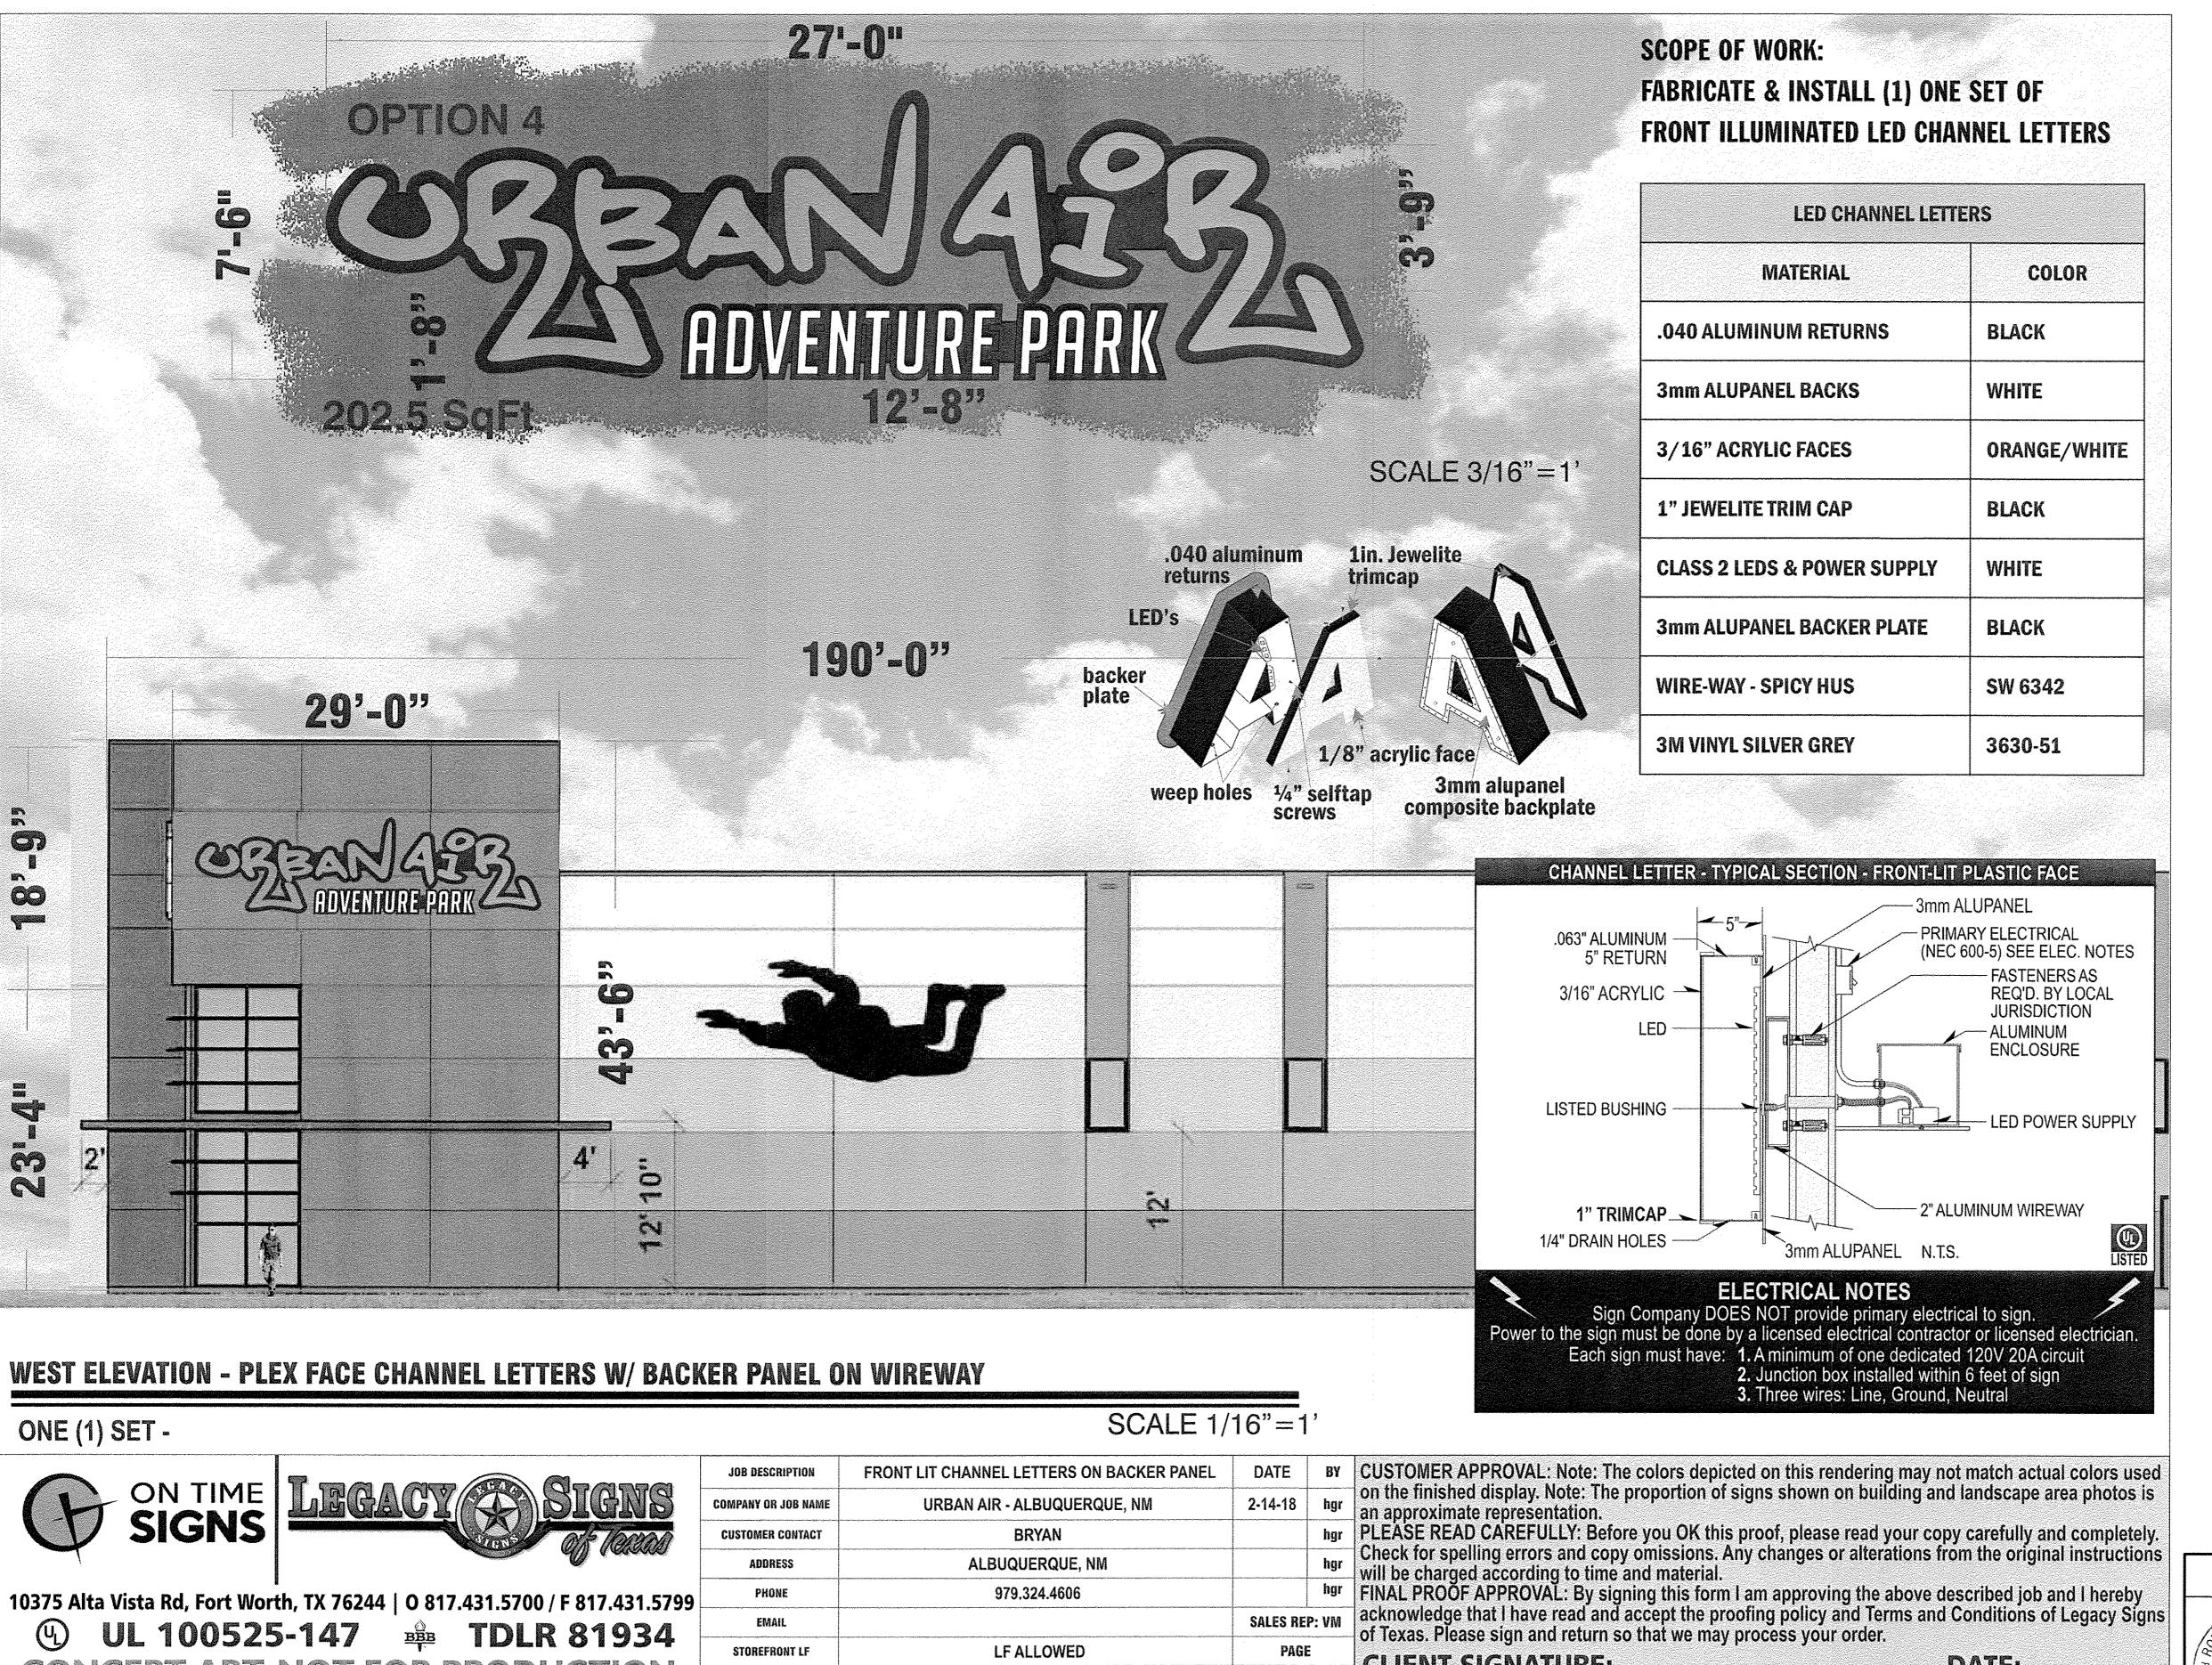

979.324.4606

LF ALLOWED

202.5 SF

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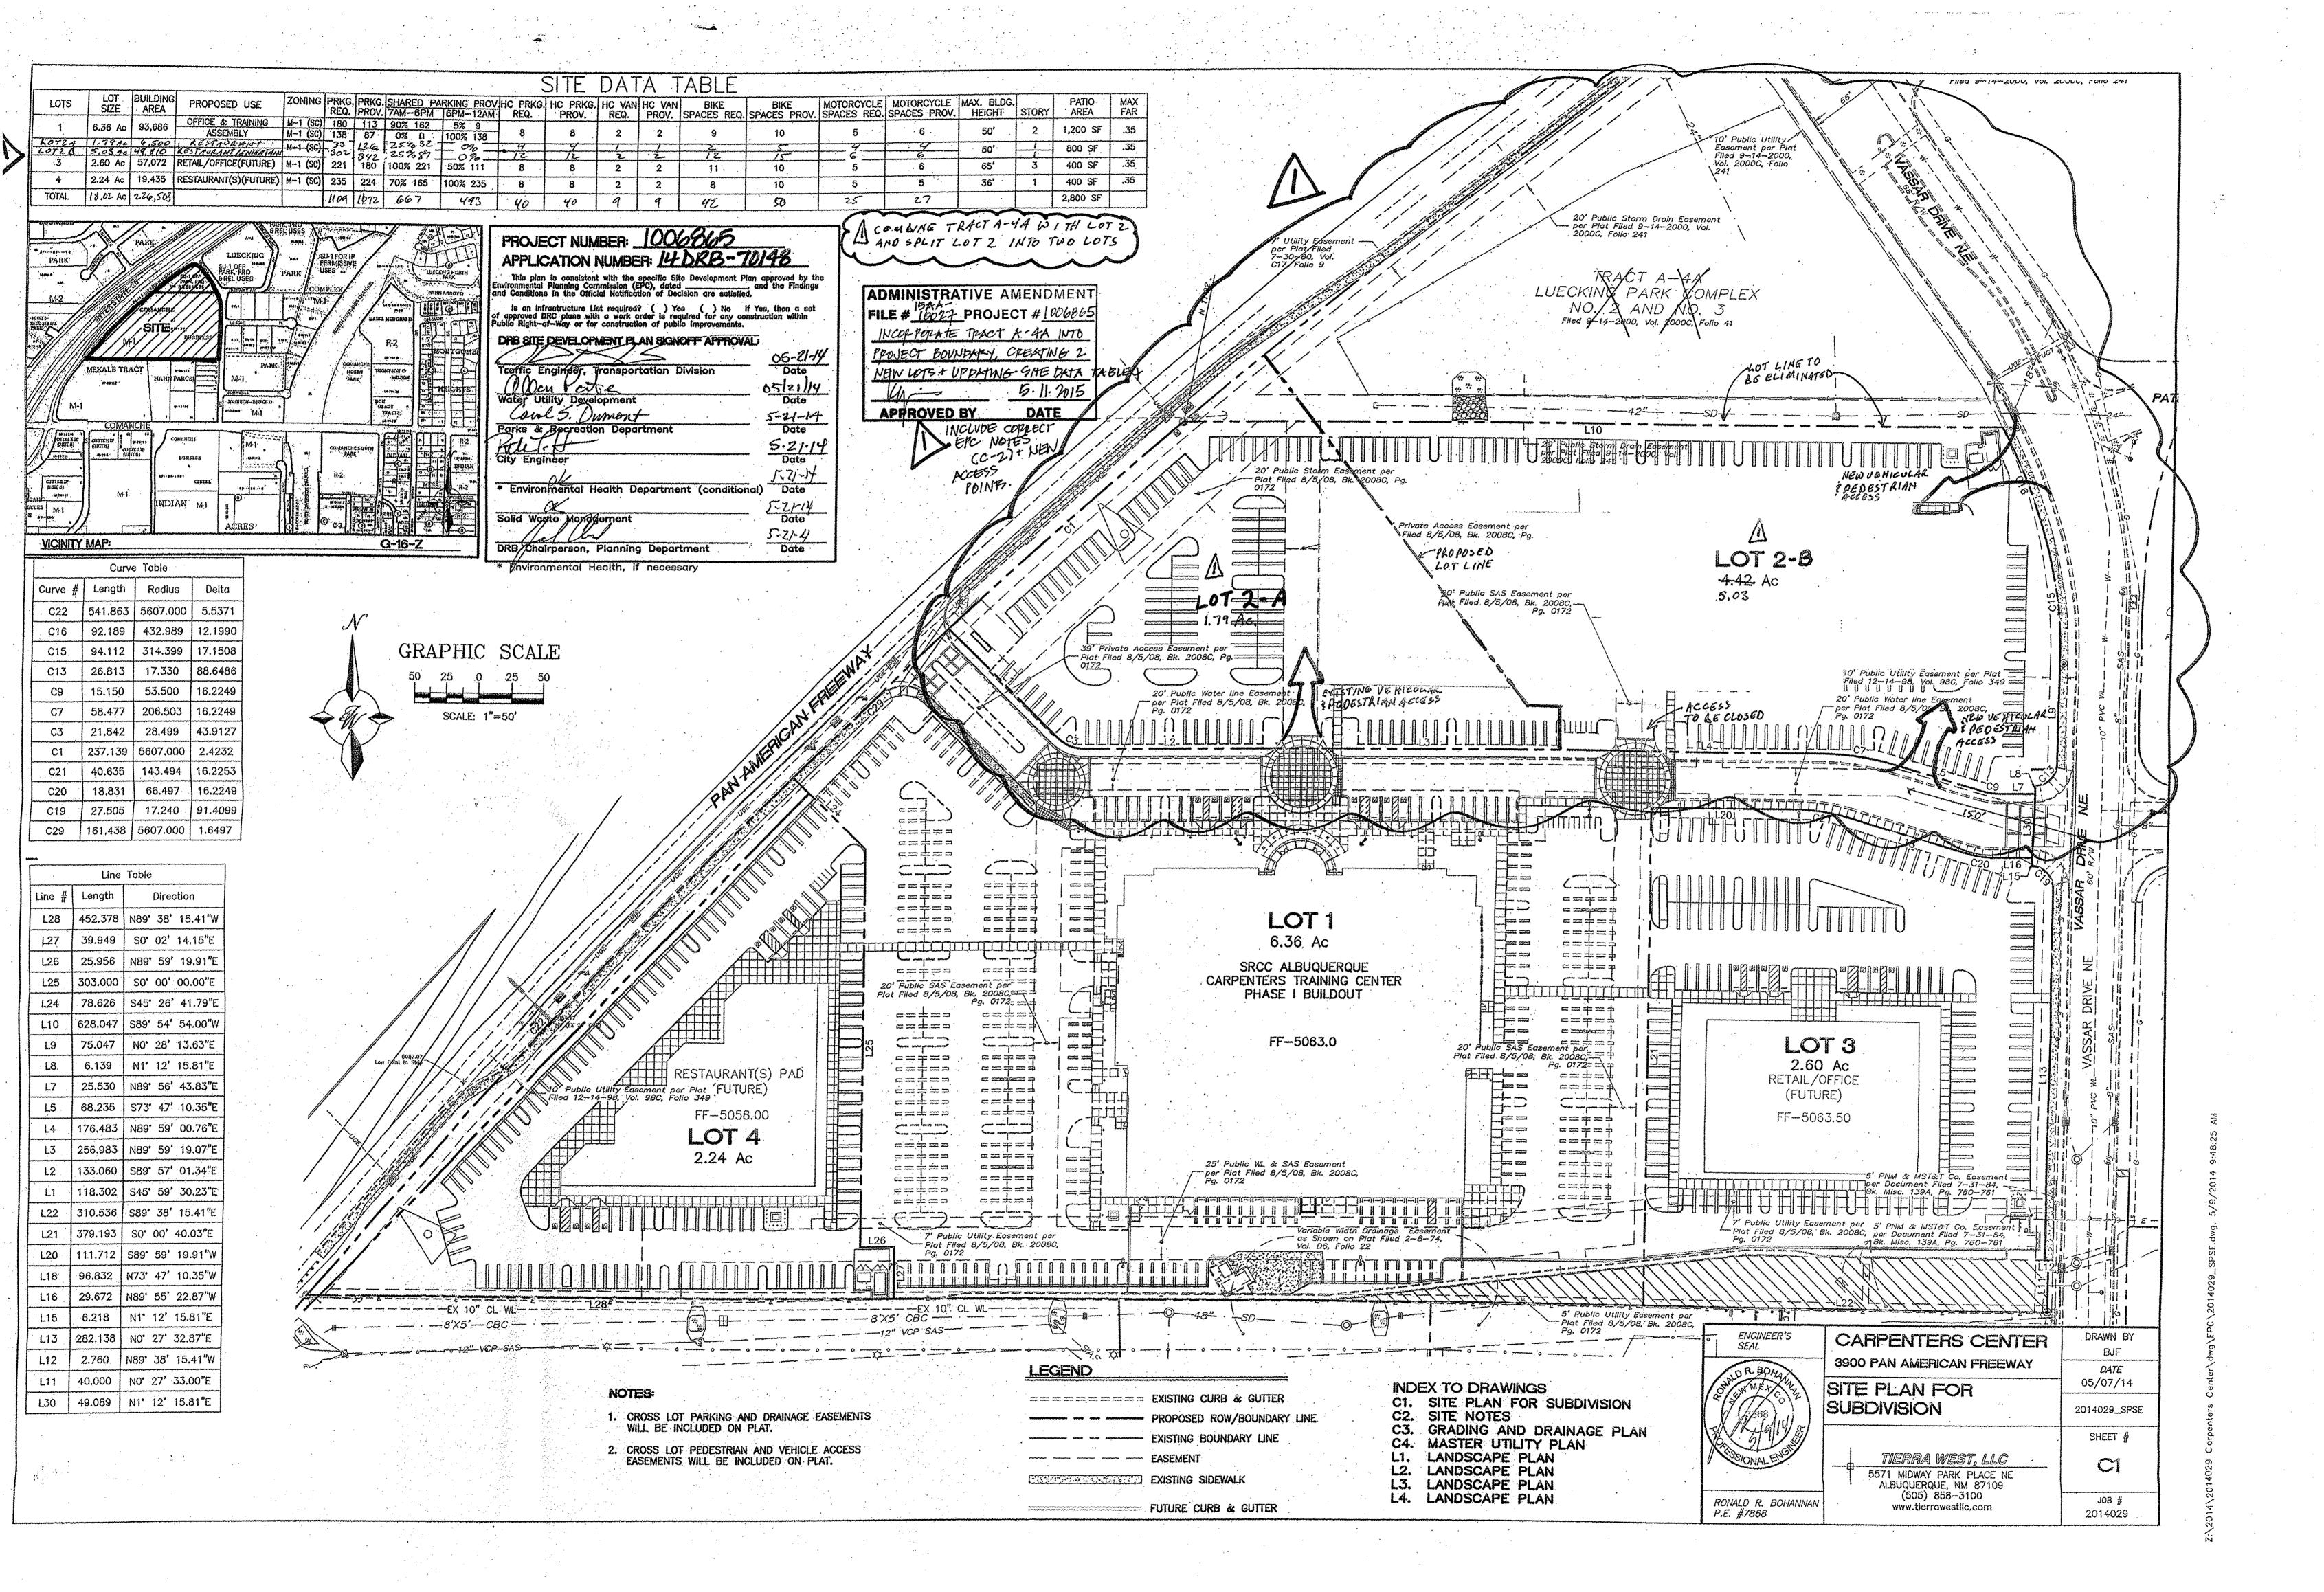
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CONCEPT ART, NOT FOR PRODUCTION

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ENGINEER'S SEAL	ENTERTAIMENT FACILITY 3930 PAN AMERICAN FRWY	DRAWN BY
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PROFESSIONAL EN	TIERRA WEST, LLC 5571 MIDWAY PARK PL NE ALBUQUERQUE, NEW MEXICO 87109	10
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PROPOSED DESIGN GUIDELINES: THE PAD SITES FOR THIS DEVELOPMENT WILL BE DEVELOPED SEPARATELY FROM THE INITIAL BUILDING THAT IS DESCRIBED HEREIN. TO PROVIDE CONSISTENCY IN QUALITY ACROSS THE ENTIRE SITE, THE FOLLOWING DESIGN STANDARDS SHALL BE APPLIED TO THE FUTURE DEVELOPMENT OF THE PAD SITES. THESE STANDARDS SHALL BE ENFORCEABLE BY THE DEVELOPMENT REVIEW BOARD. THE CREATION OF A QUALITY ARCHITECTURAL ENVIRONMENT IS A PRIMARY GOAL OF THESE DESIGN STANDARDS.

- 1. PAD DEVELOPMENT SHALL CONFORM TO THE REQUIREMENTS STATED IN THE CITY OF ALBUQUERQUE ZONING CODE.
- 2. THE COLOR, MATERIALS AND ARCHITECTURE OF BUILDINGS IN PHASE II SHALL MATCH, OR ACHIEVE A CONTINUITY OF DESIGN WITH, BUILDING A IN PHASE I. THEY SHALL HAVE SIMILAR DETAILING OF WALL SURFACES, CANOPIES AND FENESTRATION.
- 3. ACCENT COLORS FOR TRIM SHALL MATCH, OR BE COMPATIBLE WITH, THOSE OF BUILDING A IN PHASE I.
- 4. BUILDINGS SHALL HAVE EQUAL ARCHITECTURAL EMPHASIS ON ALL SIDES, INCLUDING
- 5. SERVICE AREAS SHALL BE SCREENED WITH WALLS HAVING THE SAME DESIGN ELEMENTS AND MATERIALS AS THE BUILDINGS. ALL REFUSE CONTAINERS SHALL BE SCREENED WITHIN A MINIMUM OF A SIX FOOT TALL ENCLOSURE THAT IS LARGE ENOUGH TO CONTAIN ALL REFUSE GENERATED BETWEEN COLLECTIONS AND IS COMPATIBLE WITH THE ARCHITECTURAL THEME OF THE SITE.
- 6. ENTRANCE AREAS SHALL BE SHADED BY AWNINGS OR PORTALS TO PROVIDE SHELTER FOR PATRONS ENTERING THE BUILDINGS.
- 7. RESTAURANTS SHALL PROVIDE PLAZAS OR OUTDOOR DINING AREAS WITH A MINIMUM DIMENSION OF 15' AND A MINIMUM AREA OF 300 SQUARE FEET. THESE AREAS SHALL BE SHADED BY BUILDINGS ELEMENTS OR SHADE TREES, AND SHALL HAVE SEATING IN THE FORM OF BENCHES OR OUTDOOR DINING FURNITURE.
- 8. CONSISTENCY IN LIGHTING DESIGN IS A PRIMARY GOAL OF THESE DESIGN STANDARDS. IN ORDER TO ENHANCE SECURITY AND VISUAL AESTHETICS, CAREFUL CONSIDERATION OF SITE LIGHTING DESIGN IS REQUIRED TO MAXIMIZE PUBLIC SAFETY WHILE MINIMIZING GLARE BOTH ON SITE AND ON ADJACENT PROPERTIES. AREA LIGHTING SHALL BE SUPPLEMENTED BY PEDESTRIAN-SCALE AND/OR BUILDING-MOUNTED LIGHTING, WHERE NECESSARY TO ILLUMINATE WALKWAYS, BUILDING ENTRANCES AND COMMON AREA. FIXTURES SHALL BE COMPATIBLE WITH AREA LIGHTING AND BUILDING ARCHITECTURE. LIGHT POLE LOCATIONS SHOWN ON PLAN ARE FOR REFERENCE ONLY. FINAL LOCATIONS SHALL BE BASED ON A PHOTOMETRIC ILLUMINATION STUDY AND SUBMITTED DURING PLAN CHECK FOR FINAL APPROVAL

LIGHTING DESIGN SHALL COMPLY WITH THE CITY OF ALBUQUERQUE ZONING CODE, SECTION 14-16-3-9, AREA LIGHTING REGULATIONS, AND THE STATE STATUTE ON DARK SKIES. PARKING AREA LIGHTING SHALL BE PROVIDED WITH FIXTURES OF A SIMILAR DESIGN, COLOR AND HEIGHT FOR ALL TRACTS WITHIN THE DEVELOPMENT. AREA LIGHT FIXTURES SHALL BE FULL CUT-OFF DESIGN WITH NO VISIBLE LIGHT SOURCE ABOVE A HORIZONTAL LINE PROJECTED FROM THE BOTTOM OF THE FIXTURE HOUSING. LIGHT POLES SHALL BE A MAXIMUM HEIGHT OF 28' (25' POLE ON A 3' CONCRETE BASE). LIGHT POLES WITHIN 100' OF RESIDENTIAL ZONING SHALL BE LIMITED TO 16' HIGH.

9. SIGNAGE: THE GOAL IS TO PROVIDE CONSISTENCY IN APPEARANCE AND QUALITY AND COMPLIMENT THE VISUAL CHARACTER OF THE DEVELOPMENT. ALL SIGNS SHALL COMPLY WITH SECTION 14-16-3-5 GENERAL SIGN REGULATIONS OF THE COMPREHENSIVE ZONING CODE. BUILDING MOUNTED SIGNS SHALL NOT EXCEED SIX PERCENT OF THE FACADE AREA ON WHICH THEY ARE MOUNTED. SIGN AREA FOR A FREE-STANDING OR PROJECTING SIGN SHALL NOT EXCEED 100 SQUARE FEET PER SIGN FACE, EXCEPT THAT ONE FREE-STANDING PYLON SIGN IS ALLOWED WITH A MAXIMUM OF 150 SQUARE FEET PER SIGN FACE. THE HEIGHT OF A FREESTANDING SIGN SHALL NOT EXCEED 26 FEET.


THE COLOR & STYLE OF FREESTANDING SIGNAGE SHALL BE COMPATIBLE WITH THE ARCHITECTURAL THEME OF THE SITE. MONUMENT & PYLON SIGNS SHALL BE PLACED AT THE BACK OF THE PUBLIC RIGHT-OF-WAY LINE. NO SIGN SHOULD OVERHANG IN THE PUBLIC RIGHT-OF-WAY. THE USE OF NEON IN SIGNS & AS ARCHITECTURAL DECORATION ON THE BUILDINGS IS ENCOURAGED. THERE SHALL BE NO ILLUMINATED PLASTIC BANDING ON SIGNAGE.

- 10. VEHICULAR/PEDESTRIAN CONFLICTS WILL BE MINIMIZED WITHIN THE SITE BY PROVIDING AN ORGANIZED AND INTERCONNECTED SYSTEM OF INTERNAL ROADWAYS AND PEDESTRIAN CONNECTIONS. A DIFFERENCE IN PAVING MATERIAL, COLOR, OR PATTERN SHALL BE PROVIDED AT CROSSWALKS TO BRING ATTENTION VISUALLY FOR SAFE PEDESTRIAN CROSSING.
- 11. SAFE AND CONVENIENT PEDESTRIAN, BICYCLE AND TRANSIT ACCESS TO THE MAIN ENTRANCE OF THE BUSINESSES FROM THE SURROUNDING STREETS AND NEIGHBORHOODS WILL BE PROVIDED. PEDESTRIAN LINKS BETWEEN PARKING AREAS AND BUILDINGS SHALL BE CLEARLY VISIBLE AND HIGHLIGHTED WITH ENHANCED PAVING. A SIX FOOT SIDEWALK SHALL BE PROVIDED ALONG VASSAR DRIVE.
- 12. PATIO AREAS SHALL BE PROVIDED AT ALL BUILDINGS ON THE SITE. THEY SHALL BE CONNECTED TO THE PEDESTRIAN CIRCULATION SYSTEM. THERE MAY BE INTERNAL PATIO AREAS NOT DIRECTLY CONNECTED TO PEDESTRIAN WAYS AT RESTAURANTS. MINIMUM SIZE TO BE 400 SQUARE FEET WITH 25% OF THE AREA COVERED. TREES W/TREE GRATES TUMBRELLAS,
- 13. BIKE PARKING SPACES SHALL BE PROVIDED AT A RATE OF ONE BIKE SPACE PER 20 PARKING SPACES AS CONSISTENT WITH THE CITY ZONING CODE. FOR MAJOR EMPLOYERS (GREATER THAN 50 EMPLOYEES). SECURE, LONG-TERM BIKE PARKING SHALL BE PROVIDED FOR EMPLOYEES AND SHALL BE IN A WELL LIT VISIBLE LOCATION.
- 14. WHERE WALLS ARE PROVIDED, THEY SHALL BE CONSISTENT WITH THE ADOPTED CITY OF ALBUQUERQUE'S WALL DESIGN STANDARDS. WALLS TO BE PAINTED SPLIT FACE CONCRETE BLOCK. ALL PERIMETER WALLS FACING THE PUBLIC RIGHT-OF-WAY SHALL HAVE AN OPENING IN ORDER TO ALLOW PEDESTRIAN ACCESS TO THE SITE.
- 15. DIMENSIONS OF ALL PARKING SPACES SHALL COMPLY WITH ZONING REGULATIONS (SECTIONS 14-16-1-5 AND 14-16-3-1).
- 16. THE PROJECT INCORPORATES EXTERIOR LIGHT SHELVES & SUNSHADES (ITEM 9, SHEET A-3) TO SHADE EXCESS SUNLIGHT FROM LOWER WINDOWS WHILE REDIRECTING SUNLIGHT DEEPER INTO THE INTERIOR SPACES, TO REDUCE THE NEED FOR ARTIFICIAL ILLUMINATION. ADDITIONALLY, THE CARPENTER'S ALBUQUERQUE TRAINING CENTER WILL FURTHER THE CITY'S GOAL OF IMPROVING ENERGY MANAGEMENT AWARENESS & CONSERVING NATURAL RESOURCES BY THE INCLUSION OF ONGOING CARPENTER TRAINING PROGRAMS THAT TEACH THE STUDENTS THE LATEST METHODOLOGIES FOR THE INSTALLATION OF 'GREEN' PRODUCTS & SYSTEMS. RECYCLING OF BUILDING MATERIALS AND AWARENESS OF LEED STANDARDS & CONSTRUCTION MEANS & METHODS TO ACHIEVE BUILDING CERTIFICATION.
- DESIGN STANDARDS: 1. COMMON PARKING, STORM DRAINAGE, PEDESTRIAN, UTILITY, AND VEHICULAR ACCESS ACROSS NEW TRACTS IS GRANTED BY THIS SITE PLAN AND WILL BE GRANTED ON THE REPLAT.
- 2. APPROVAL OF THIS PLAN DOES NOT CONSTITUTE OR IMPLY EXEMPTION FROM WATER WASTE PROVISIONS OF THE WATER CONSERVATION LANDSCAPING AND WATER WASTE ORDINANCE. WATER WASTE MANAGEMENT IS THE SOLE RESPONSIBILITY OF THE PROPERTY OWNER.
- 3. MINIMUM LANDSCAPE SHALL BE 15% OF THE TOTAL LOT AREA LESS BUILDING AREA.
- 4. ROOF EQUIPMENT SHALL BE BELOW PARAPET HEIGHT AND SCREENED FROM VIEW FROM THE PROPERTY LINES OF THIS SITE. ALL GROUND MOUNTED EQUIPMENT SHALL BE SCREENED BY SCREEN WALLS WITH TOP OF EQUIPMENT BELOW TOP OF SCREEN WALL.
- 5. THERE SHALL BE NO BACKLIT, PLASTIC, OR VINYL AWNINGS.

6. SETBACKS: THE FRONT SETBACK SHALL REMAIN FREE OF BUILDINGS AND PERMANENT STRUCTURES OTHER THAN ON PREMISE SIGNS. NO BUILDINGS OR STRUCTURES, OTHER THAN WALLS OR FENCES SHALL BE PERMITTED IN THE SIDE OR REAR YARD SETBACK, IF THERE ARE NO SOUD WALLS OR FENCES ALONG THE REAR PROPERTY LINE, A 5 FT LANDSCAPE BUFFER IS REQUIRED. THERE SHALL BE A FRONT AND CORNER SIDE YARD SETBACK OF NOT LESS THAN 5 FEET AND A SETBACK OF 11 FT FROM THE JUNCTION OF A DRIVEWAY OR ALLEY AND A PUBLIC SIDEWALK OR PLANNED PUBLIC SIDEWALK LOCATION.

- 7. BUILDINGS CANNOT EXCEED THE HEIGHTS AS SPECIFIED BY THE M-1 (SC) CITY ZONING
- 8. THE HEIGHTS OF STRUCTURES SHALL COMPLY WITH THE REQUIREMENTS OF THE ZONING
- 9. SITE PLAN FOR BUILDING PERMIT FOR FUTURE BUILDINGS TO BE DELEGATED DOWN TO
- 10. ALL FUTURE TRACTS WILL REQUIRE A SITE DEVELOPMENT PLAN FOR BUILDING PERMIT THRU A PUBLIC HEARING AT DRB.

PROJECT NOTES

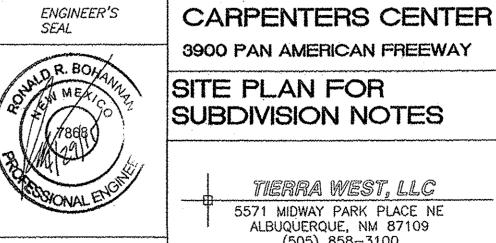

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3900 PAN AMERICAN FREEWAY SITE PLAN FOR SUBDIVISION NOTES

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JOB# 2014029

DRAWN BY

BJF

DATE 05/07/14

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