


OVERALL SITE PLAN

25' 12.5' 0 50' 100'
BAR SCALE (IN FEET)

SHEET NUMBER

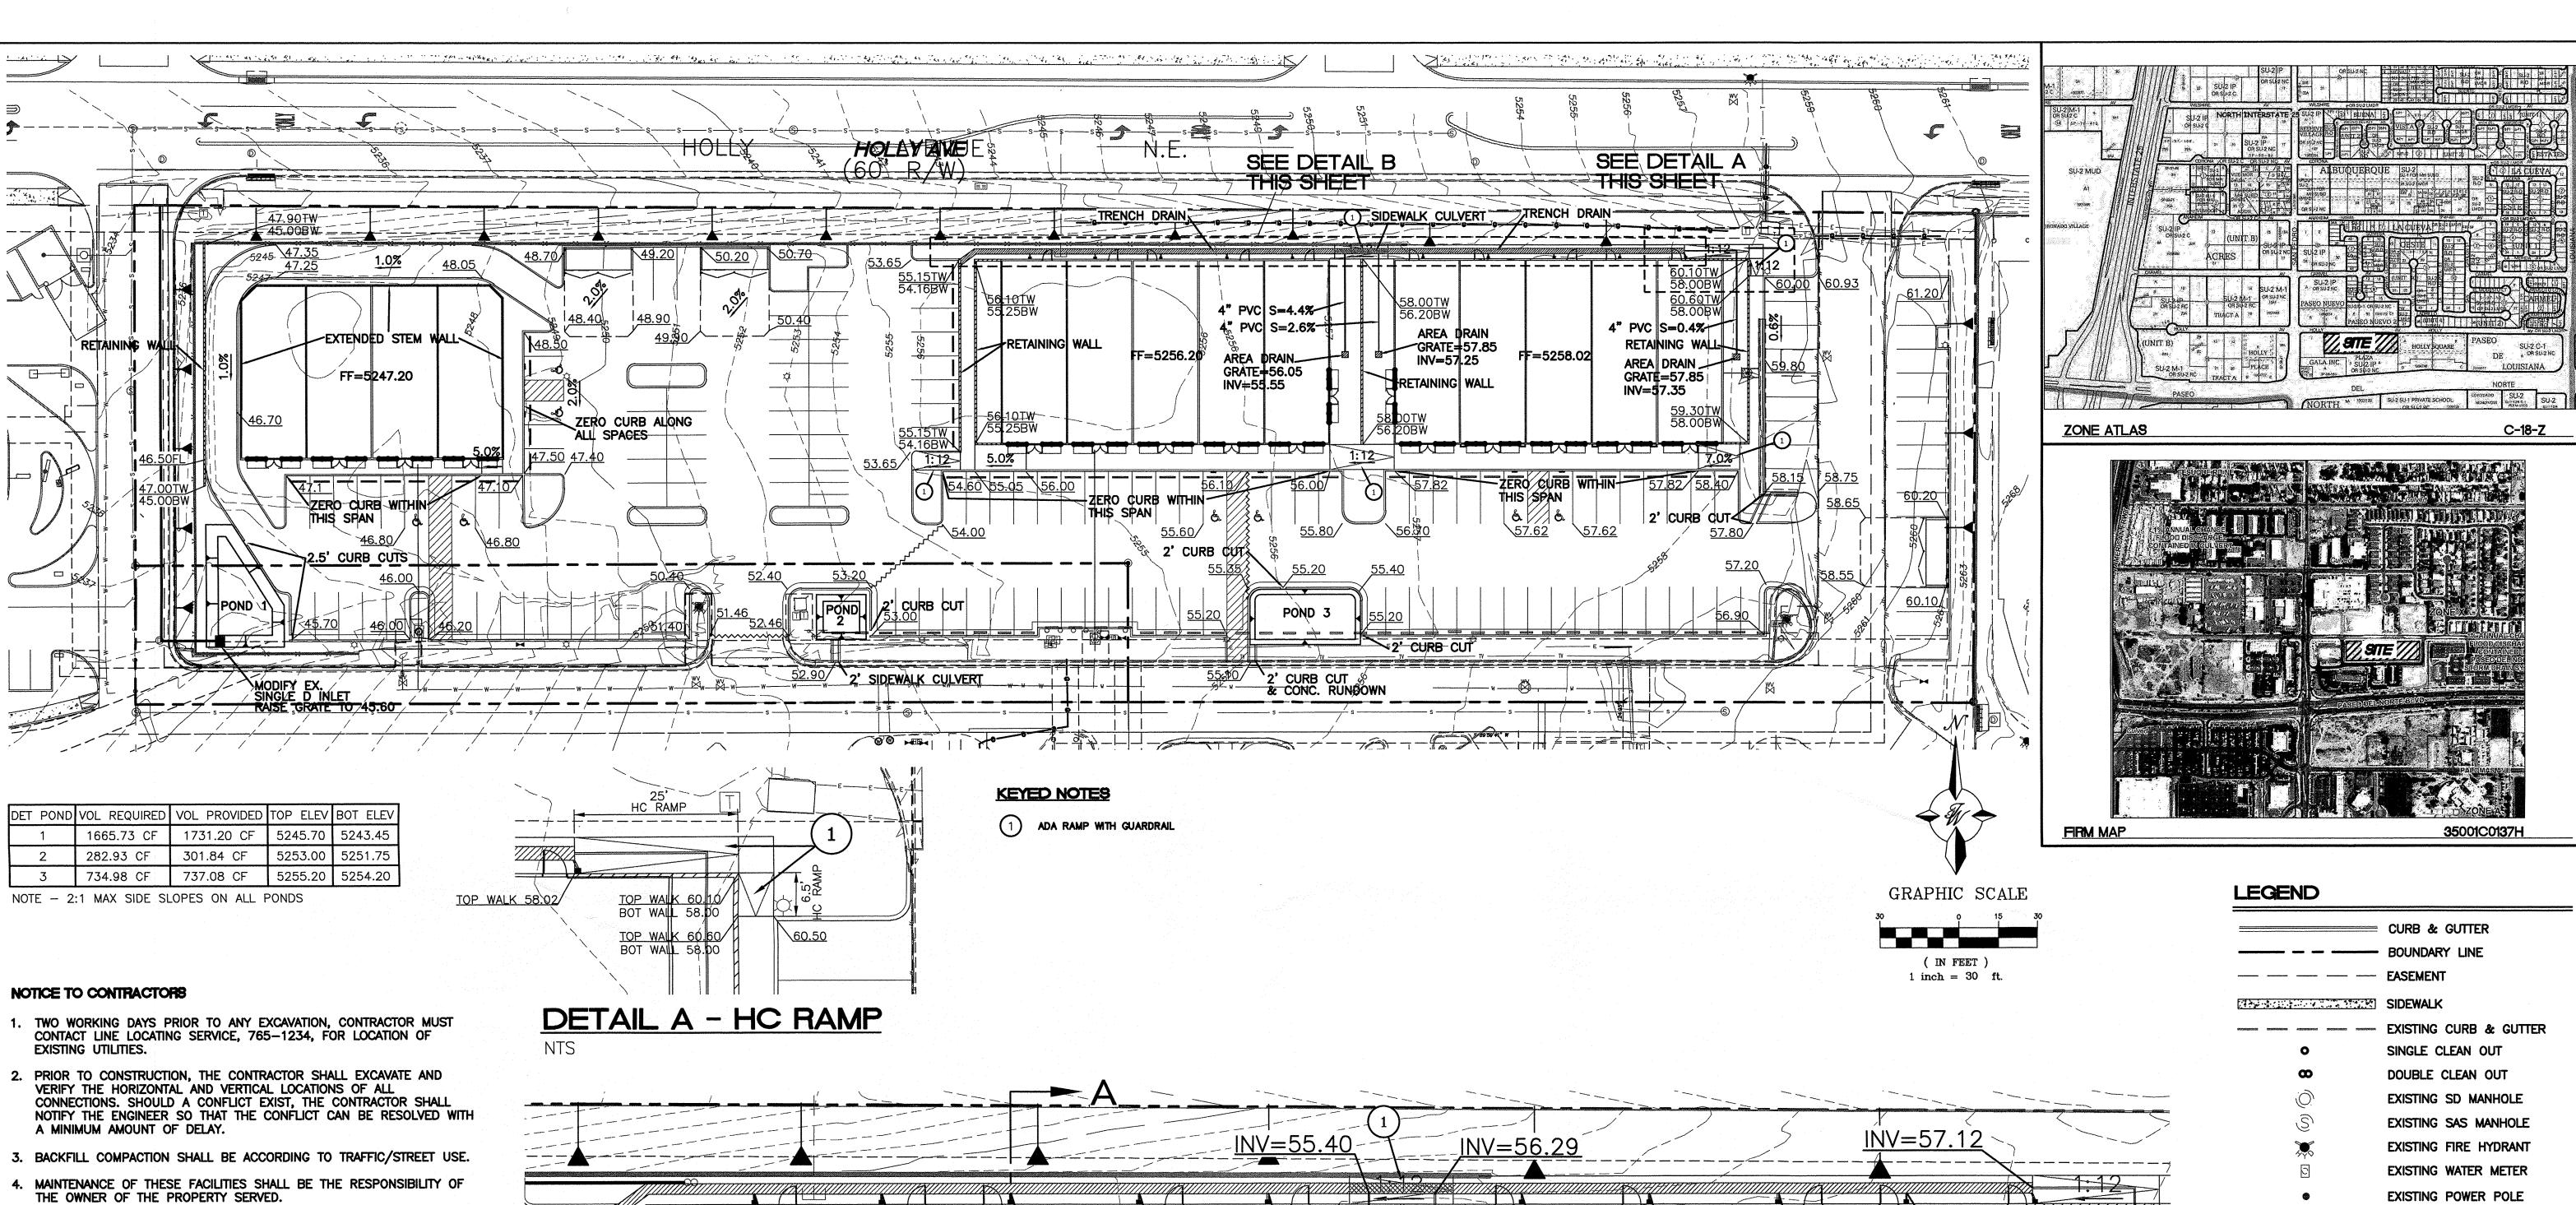


5. SOURCE OF TOPO IS ALTA/ACSM LAND TITLE SURVEY OF LOT 2 HARMS INDUSTRIAL PARK PREPARED BY PRECISION SURVEYS, INC DATED JUNE,

### EROSION CONTROL NOTES


- 1. CONTRACTOR IS RESPONSIBLE FOR OBTAINING A TOPSOIL DISTURBANCE PERMIT PRIOR TO BEGINNING WORK.
- 2. CONTRACTOR IS RESPONSIBLE FOR MAINTAINING RUN-OFF ON SITE DURING CONSTRUCTION.
- 3. CONTRACTOR IS RESPONSIBLE FOR CLEANING ALL SEDIMENT THAT GETS INTO EXISTING RIGHT-OF-WAY.
- 4. REPAIR OF DAMAGED FACILITIES AND CLEANUP OF SEDIMENT ACCUMULATIONS ON ADJACENT PROPERTIES AND IN PUBLIC FACILITIES IS THE RESPONSIBILITY OF THE CONTRACTOR.
- 5. ALL EXPOSED EARTH SURFACES MUST BE PROTECTED FROM WIND AND WATER EROSION PRIOR TO FINAL ACCEPTANCE OF ANY PROJECT.

### CAUTION

ALL EXISTING UTILITIES SHOWN WERE OBTAINED FROM RESEARCH, AS-BUILTS, SURVEYS OR INFORMATION PROVIDED BY OTHERS. IT SHALL BE THE SOLE RESPONSIBILITY OF THE CONTRACTOR TO CONDUCT ALL NECESSARY FIELD INVESTIGATIONS PRIOR TO AND INCLUDING ANY EXCAVATION, TO DETERMINE THE ACTUAL LOCATION OF UTILITIES AND OTHER IMPROVEMENTS, PRIOR TO STARTING THE WORK. ANY CHANGES FROM THIS PLAN SHALL BE COORDINATED WITH AND APPROVED BY THE ENGINEER.

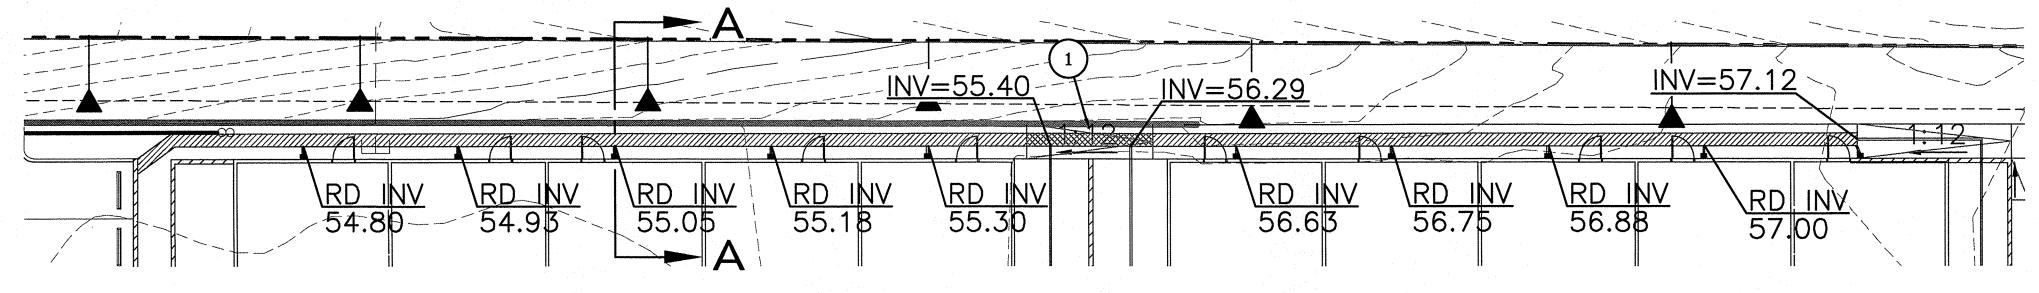

# DETAIL B - TRENCH DRAIN DETAIL

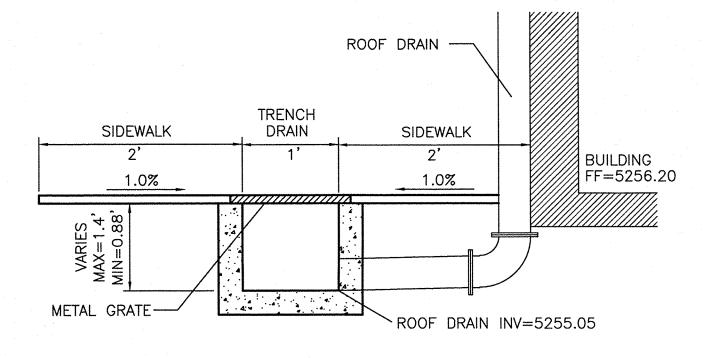

SECTION A-A

## NOTICE TO CONTRACTORS

- 1. AN EXCAVATION/CONSTRUCTION PERMIT WILL BE REQUIRED BEFORE BEGINNING ANY WORK WITHIN CITY RIGHT-OF-WAY.
- 2. ALL WORK DETAILED ON THESE PLANS TO BE PERFORMED, EXCEPT AS OTHERWISE STATED OR PROVIDED HERON, SHALL BE CONSTRUCTED IN ACCORDANCE WITH CITY OF ALBUQUERQUE INTERIM STANDARD SPECIFICATIONS FOR PUBLIC WORKS CONSTRUCTION, 1985.
- 3. TWO WORKING DAYS PRIOR TO ANY EXCAVATION, CONTRACTOR MUST CONTACT LINE LOCATING SERVICE, 765-1234, FOR LOCATION OF EXISTING UTILITIES.
- 4. PRIOR TO CONSTRUCTION, THE CONTRACTOR SHALL EXCAVATE AND VERIFY THE HORIZONTAL AND VERTICAL LOCATIONS OF ALL CONSTRUCTIONS. SHOULD A CONFLICT EXIST, THE CONTRACTOR SHALL NOTIFY THE ENGINEER SO THAT THE CONFLICT CAN BE RESOLVED WITH A MINIMUM AMOUNT OF DELAY.
- 5. BACKFILL COMPACTION SHALL BE ACCORDING TO TRAFFIC/STREET USE.
- 6. MAINTENANCE OF THESE FACILITIES SHALL BE THE RESPONSIBILITY OF THE OWNER OF THE PROPERTY SERVED.
- 7. WORK ON ARTERIAL STREETS SHALL BE PERFORMED ON A 24-HOUR BASIS.


APPROVAL	NAME	DATE
INSPECTOR		


	CURB & GUTTER
	BOUNDARY LINE
	EASEMENT
	SIDEWALK
CONSTRUCTION CONTRACTOR AND	EXISTING CURB & GUTTER
•	SINGLE CLEAN OUT
œ	DOUBLE CLEAN OUT
<u>(0)</u>	EXISTING SD MANHOLE
S	EXISTING SAS MANHOLE
***	EXISTING FIRE HYDRANT
<u> </u>	EXISTING WATER METER
•	EXISTING POWER POLE
<b>€</b>	EXISTING GAS VALVE
U	EXISTING OVERHEAD UTILITIES
G	EXISTING GAS
——————————————————————————————————————	EXISTING SANITARY SEWER LINE
— — — — EX. WL— — — —	EXISTING WATER LINE
——————————————————————————————————————	EXISTING STORM SEWER LINE
4900	EXISTING INDEX CONTOUR
widen plantes tratain whiter during former statem whether exhibits here.	EXISTING CONTOUR
	WATER BLOCK

DATE


ROUGH GRADING APPROVAL


ENGINEER'S SEAL	LOT 2 DEL NORTE PLAZA ALBUQUERQUE, NM	<i>DRAWN BY</i> pm
	GRADING AND DRAINAGE	<i>DATE</i> 3–14–16
	PLAN	<i>DRAWING</i> 2015064-GR
		SHEET #
	TIERRA WEST, LLC  5571 MIDWAY PARK PL NE ALBUQUERQUE, NEW MEXICO 87109	GR-1
RONALD R. BOHANNAN P.E. #7868	(505) 858—3100 www.tierrawestllc.com	<i>JOB #</i> 2015064

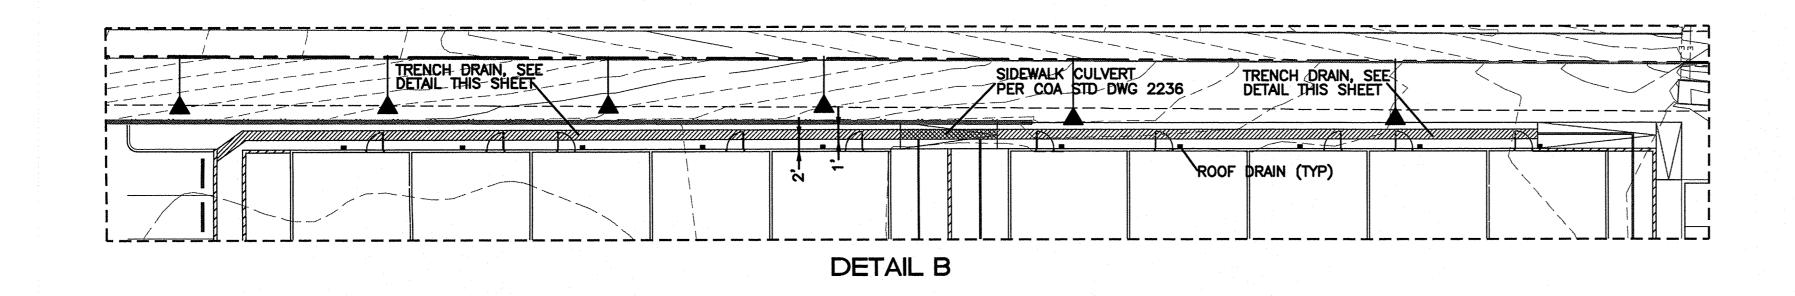

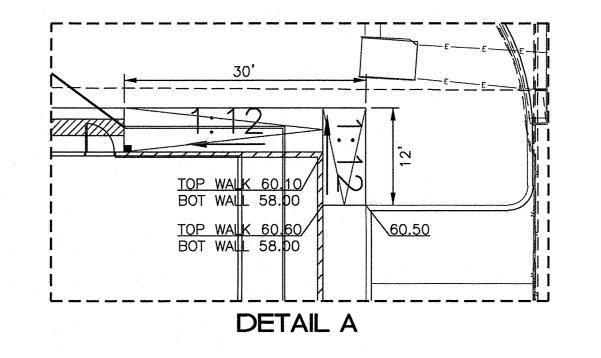


# DEVELOPED DRAINAGE BASIN MAP

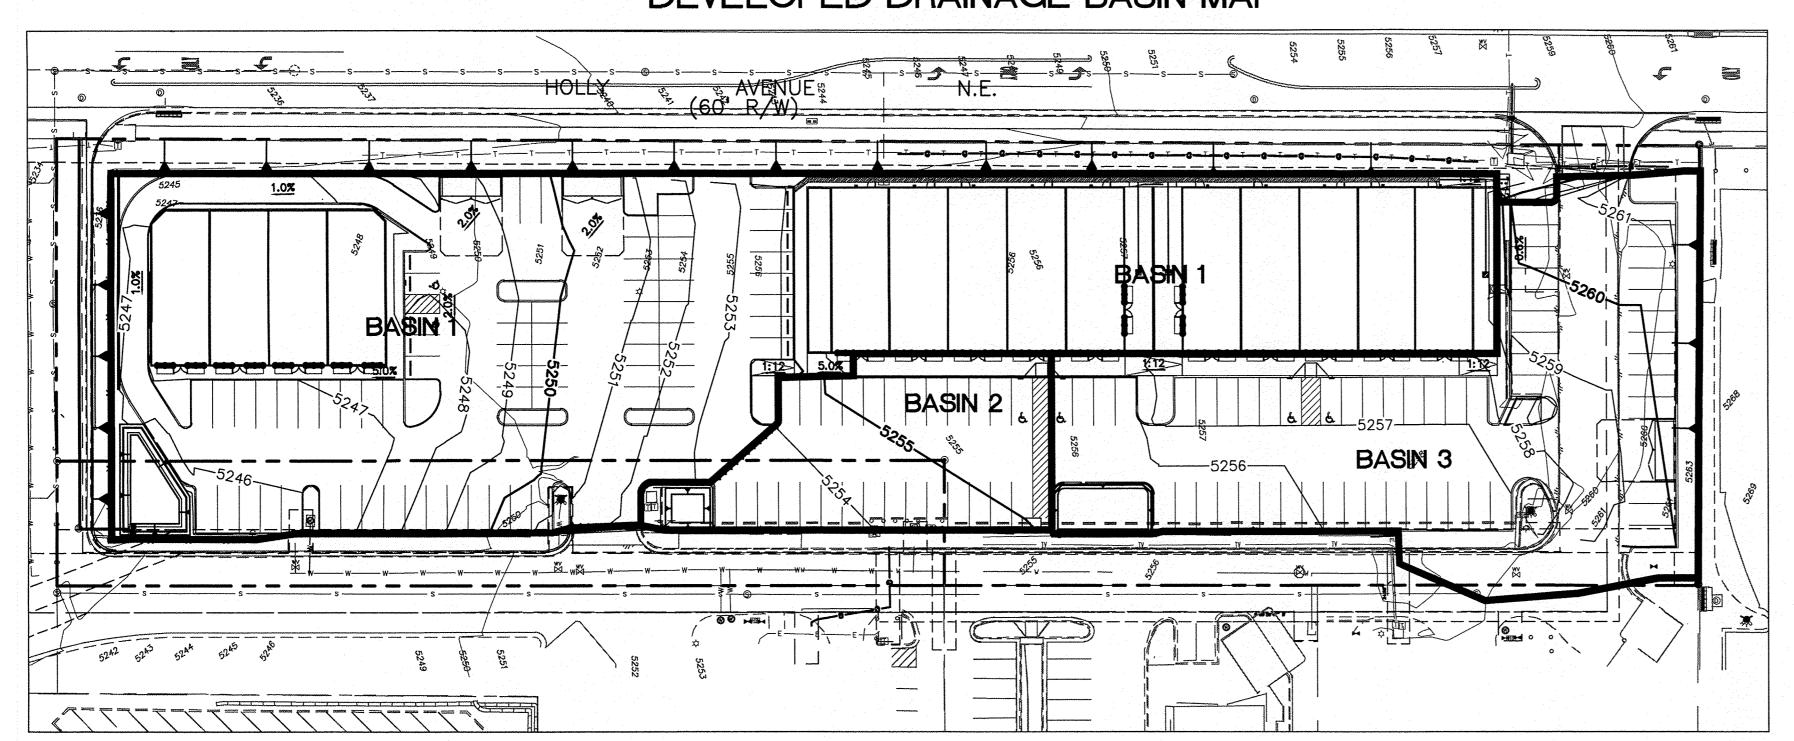

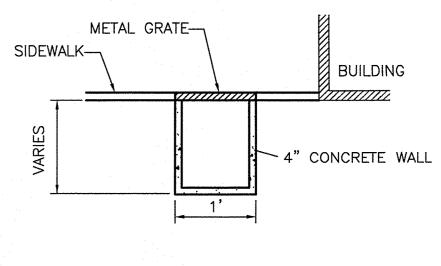

TRENCH DRAIN DETAIL
NTS

	ENGINEER'S SEAL	LOT 2 DEL NORTE PLAZA ALBUQUERQUE, NM	<i>DRAWN BY</i> pm
		ALBOQUENCOE, MIVI	DATE
		GRADING AND DRAINAGE DETAILS	1-20-16
			<i>DRAWING</i> 2015064-GR
			SHEET #
		TIERRA WEST, LLC  5571 MIDWAY PARK PL NE ALBUQUERQUE, NEW MEXICO 87109	GR-2
	RONALD R. BOHANNAN P.E. #7868	(505) 858-3100 www.tierrawestllc.com	<i>JOB #</i> 2015064

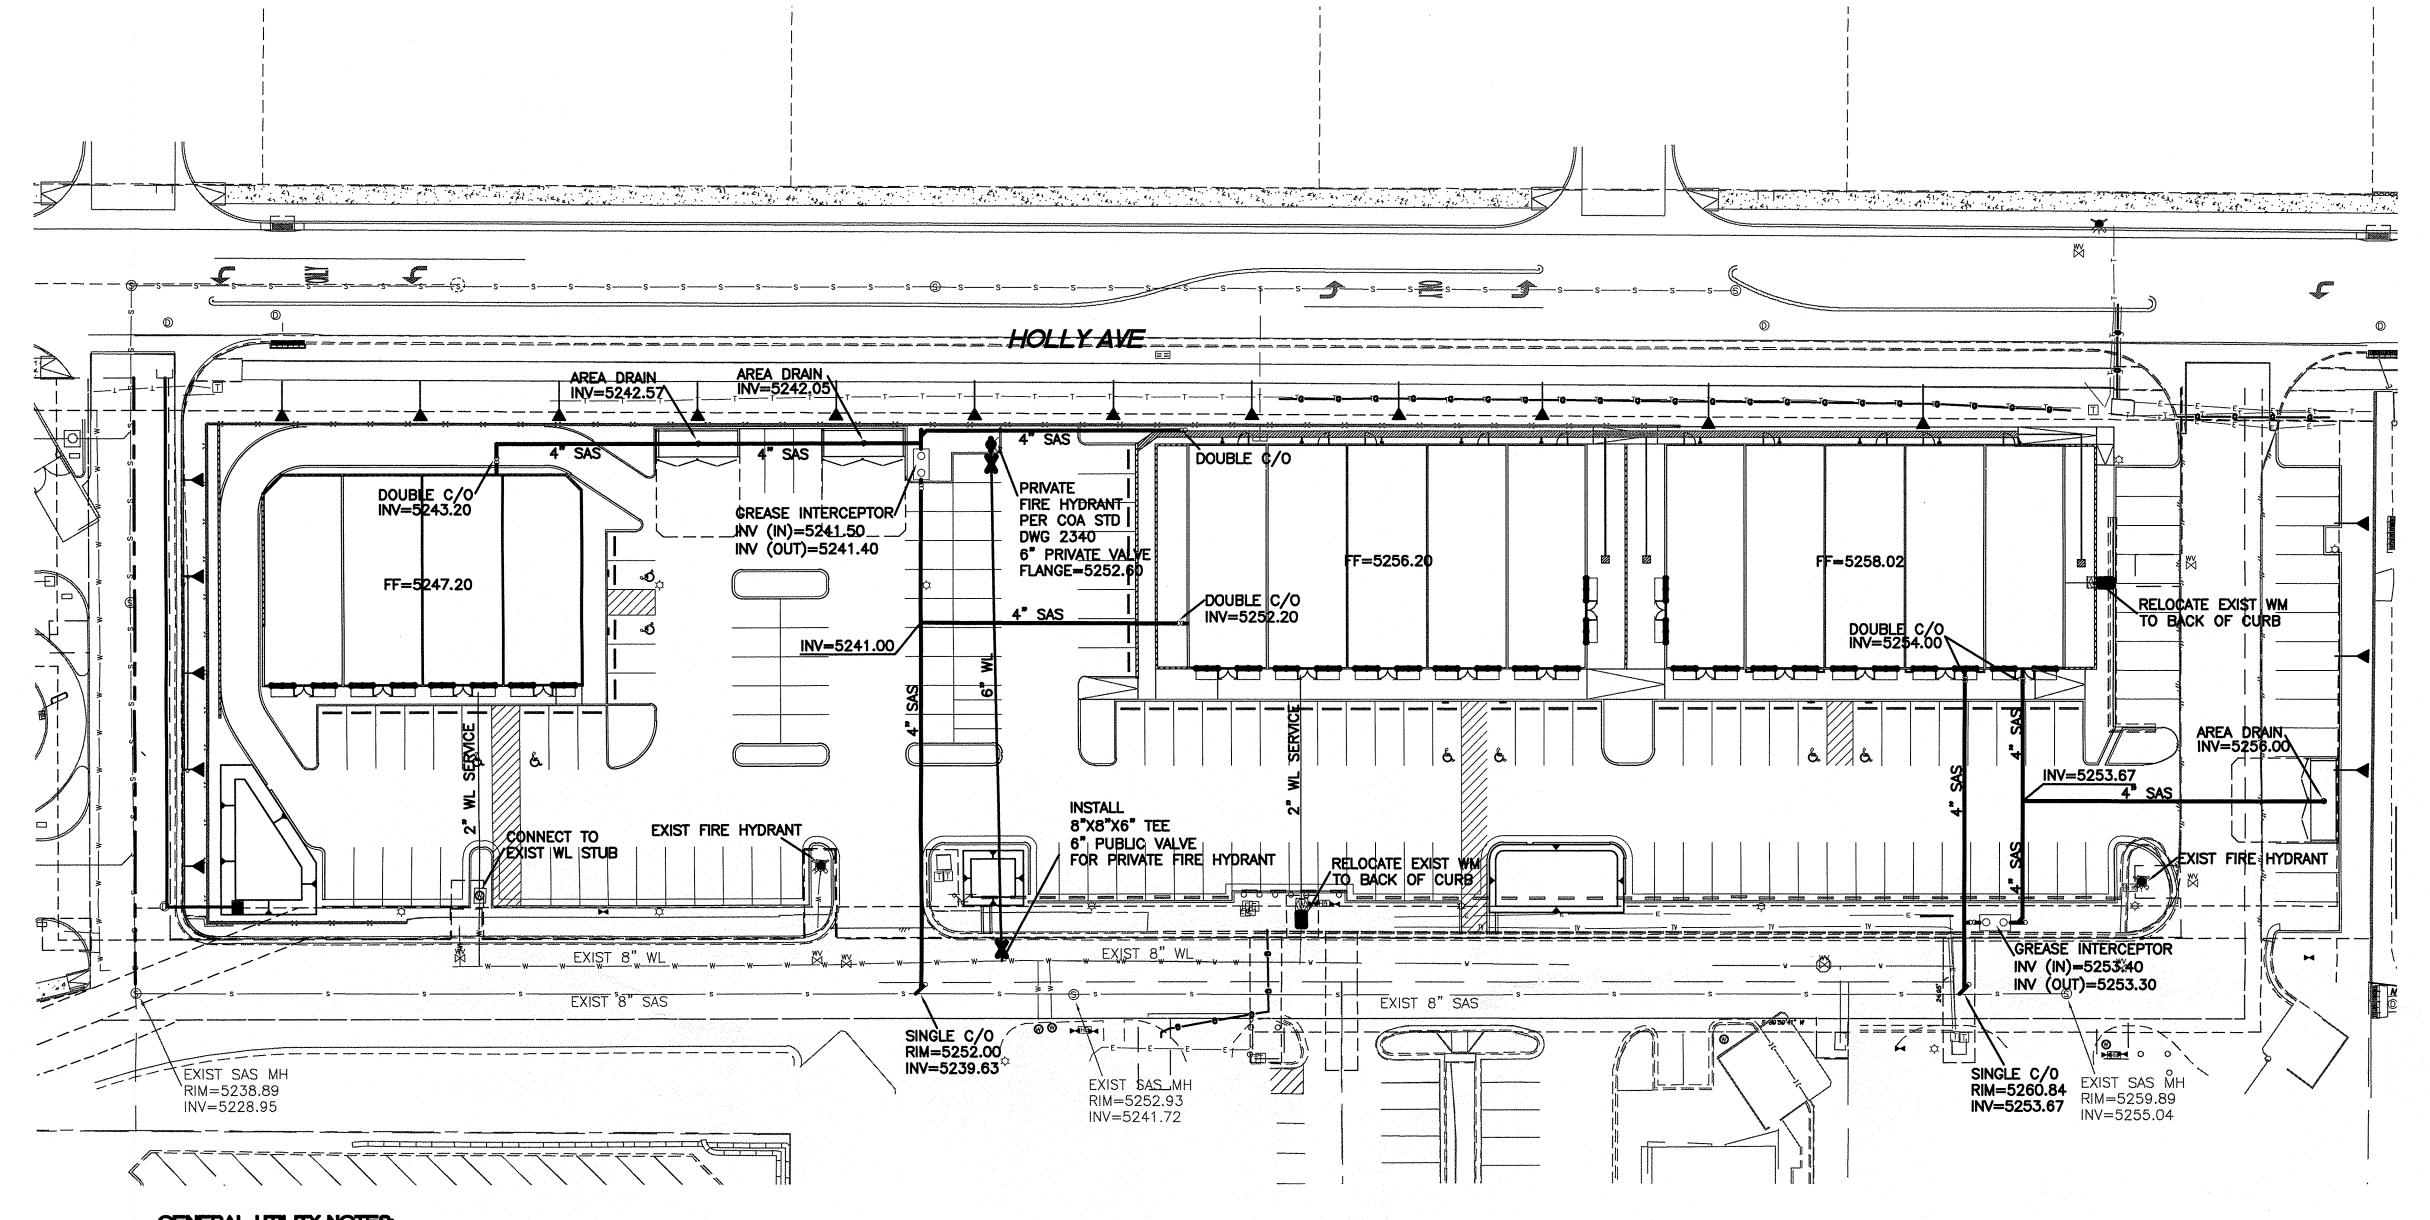

= CURB & GUTTER - BOUNDARY LINE SIDEWALK - EXISTING CURB & GUTTER SINGLE CLEAN OUT DOUBLE CLEAN OUT EXISTING SD MANHOLE EXISTING SAS MANHOLE EXISTING FIRE HYDRANT EXISTING WATER METER EXISTING POWER POLE EXISTING GAS VALVE EXISTING OVERHEAD UTILITIES EXISTING GAS " sas---- **existing sanitary sewer line** ----EX. WL---- EXISTING WATER LINE 4900 — EXISTING INDEX CONTOUR ---- EXISTING CONTOUR


LEGEND

P.E. #7868


ALL PROPOSED UTILITIES AND APPURTENANCES ARE PRIVATE

### **GENERAL UTILITY NOTES**


- 1. ALL WATER AND SEWER UTILITY WORK TO BE DONE IN ACCORDANCE WITH CITY OF ALBUQUERQUE SPECIFICATIONS FOR PUBLIC UTILITY CONSTRUCTION, 1986 EDITION (UPDATE NO 8) INCLUDING AMEANDMENT NO 1...
- 2. 4' MINIMUM BURY REQUIRED FOR ALL UTILITIES UNLESS OTHERWISE NOTED.
- 3. REFERENCE ARCHITECTURAL PLANS FOR WATER LINE RISER LOCATIONS.
- 4. CLEAN OUTS ARE TO BE BUILT PER UNIFORM PLUMBING CODE STANDARDS.
- 5. ALL PLUMBING PIPE MATERIAL TO BE USED PER UPC.
- 6. IRRIGATION AND DOMESTIC WATERLINE MUST HAVE BACKFLOW PREVENTORS PER UPC. IF BACKFLOW PREVENTOR IS INSTALLED EXTERIOR OF BUILDING A HOT BOX SHALL BE INSTALLED AND USED.
- 7. ALL EXCAVATION, TRENCHING AND SHORING ACTIVITIES MUST BE CARRIED-OUT IN ACCORDANCE WITH OSHA 29 CFR 1926.650 SUBPART P.
- 8. ALL UTILITY DISTANCES SHOWN ARE FOR REFERENCE ONLY.
- 9. PNM HAS NUMEROUS ELECTRIC FACILITIES AT THIS SITE CURRENTLY SERVING EXISTING CUSTOMERS. THE APPLICANT SHALL COORDINATE WITH PNM REGARDING THESE EXISTING FACILITIES. ANY RELOCATION, CHANGES OR REALIGNMENT OF EXISTING ELECTRIC UTILITIES WILL BE THE DEVELOPER EXPENSE. IN SOME CASES, RELOCATION OR CHANGES TO EXISTING FACILITIES MAY NOT BE FEASIBLE DUE TO PHYSICAL, USE OR SAFETY CLEARANCE CONSTRAINTS.
- 10. PNM WILL REVIEW ALL TECHNICAL NEEDS, ISSUES AND SAFETY CLEARANCES FOR ITS ELECTRIC POWER SYSTEMS. ANY EXISTING AND PROPOSED PUBLIC UTILITY EASEMENTS SHALL BE INDICATED ON THE SITE PLAN UTILITY SHEET PRIOR TO DRB REVIEW. PNM'S STANDARD FOR PUBLIC UTILITY EASEMENTS IS 10 FEET IN WIDTH TO ENSURE ADEQUATE. SAFE CLEARANCES.
- 11. SCREENING SHALL BE DESIGNED TO ALLOW FOR ACCESS TO UTILITY FACILITIES. IT IS NECESSARY TO PROVIDE ADEQUATE CLEARANCE OF TEN FEET SURROUNDING ALL GROUND-MOUNTED UTILITIES FOR SAFE OPERATION, MAINTENANCE AND REPAIR PURPOSES.

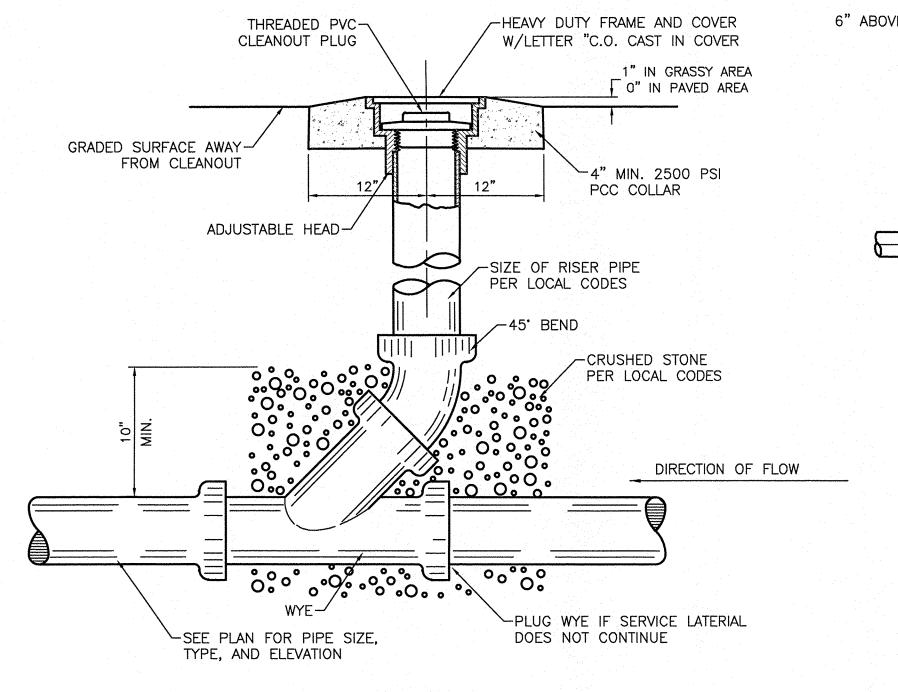

SANITARY SEWER CLEAN-OUT

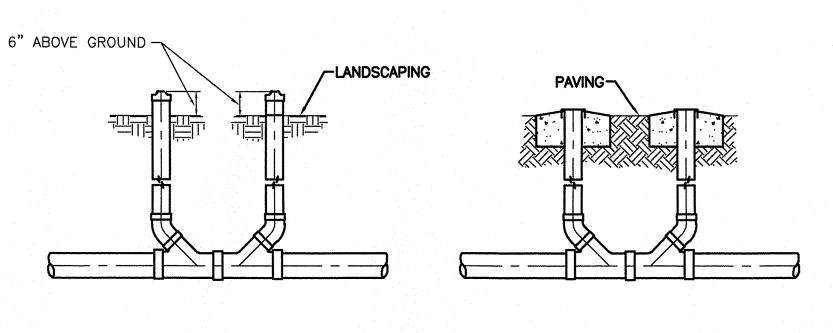

SANITARY SEWER DOUBLE CLEAN-OUTS

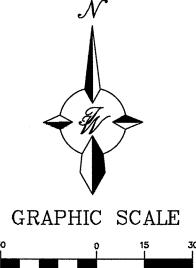

( IN FEET )

1 inch = 30 ft.


2015064

ENGINEER'S SEAL	LOT 2 DEL NORTE PLAZA ALBUQUERQUE, NM	<i>DRAWN BY</i> pm
	ALBOQUENGOL, INVI	DATE
	MASTER UTILITY	3–17–16
	PLAN	<i>DRAWING</i> 2015064GR
		SHEET #
	TIERRA WEST, LLC 5571 MIDWAY PARK PL NE ALBUQUERQUE, NEW MEXICO 87109	MU-1
RONALD R. BOHANNAN	(505) 858-3100 www.tierrawestllc.com	JOB #

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AND APPROVED BY THE ENGINEER.



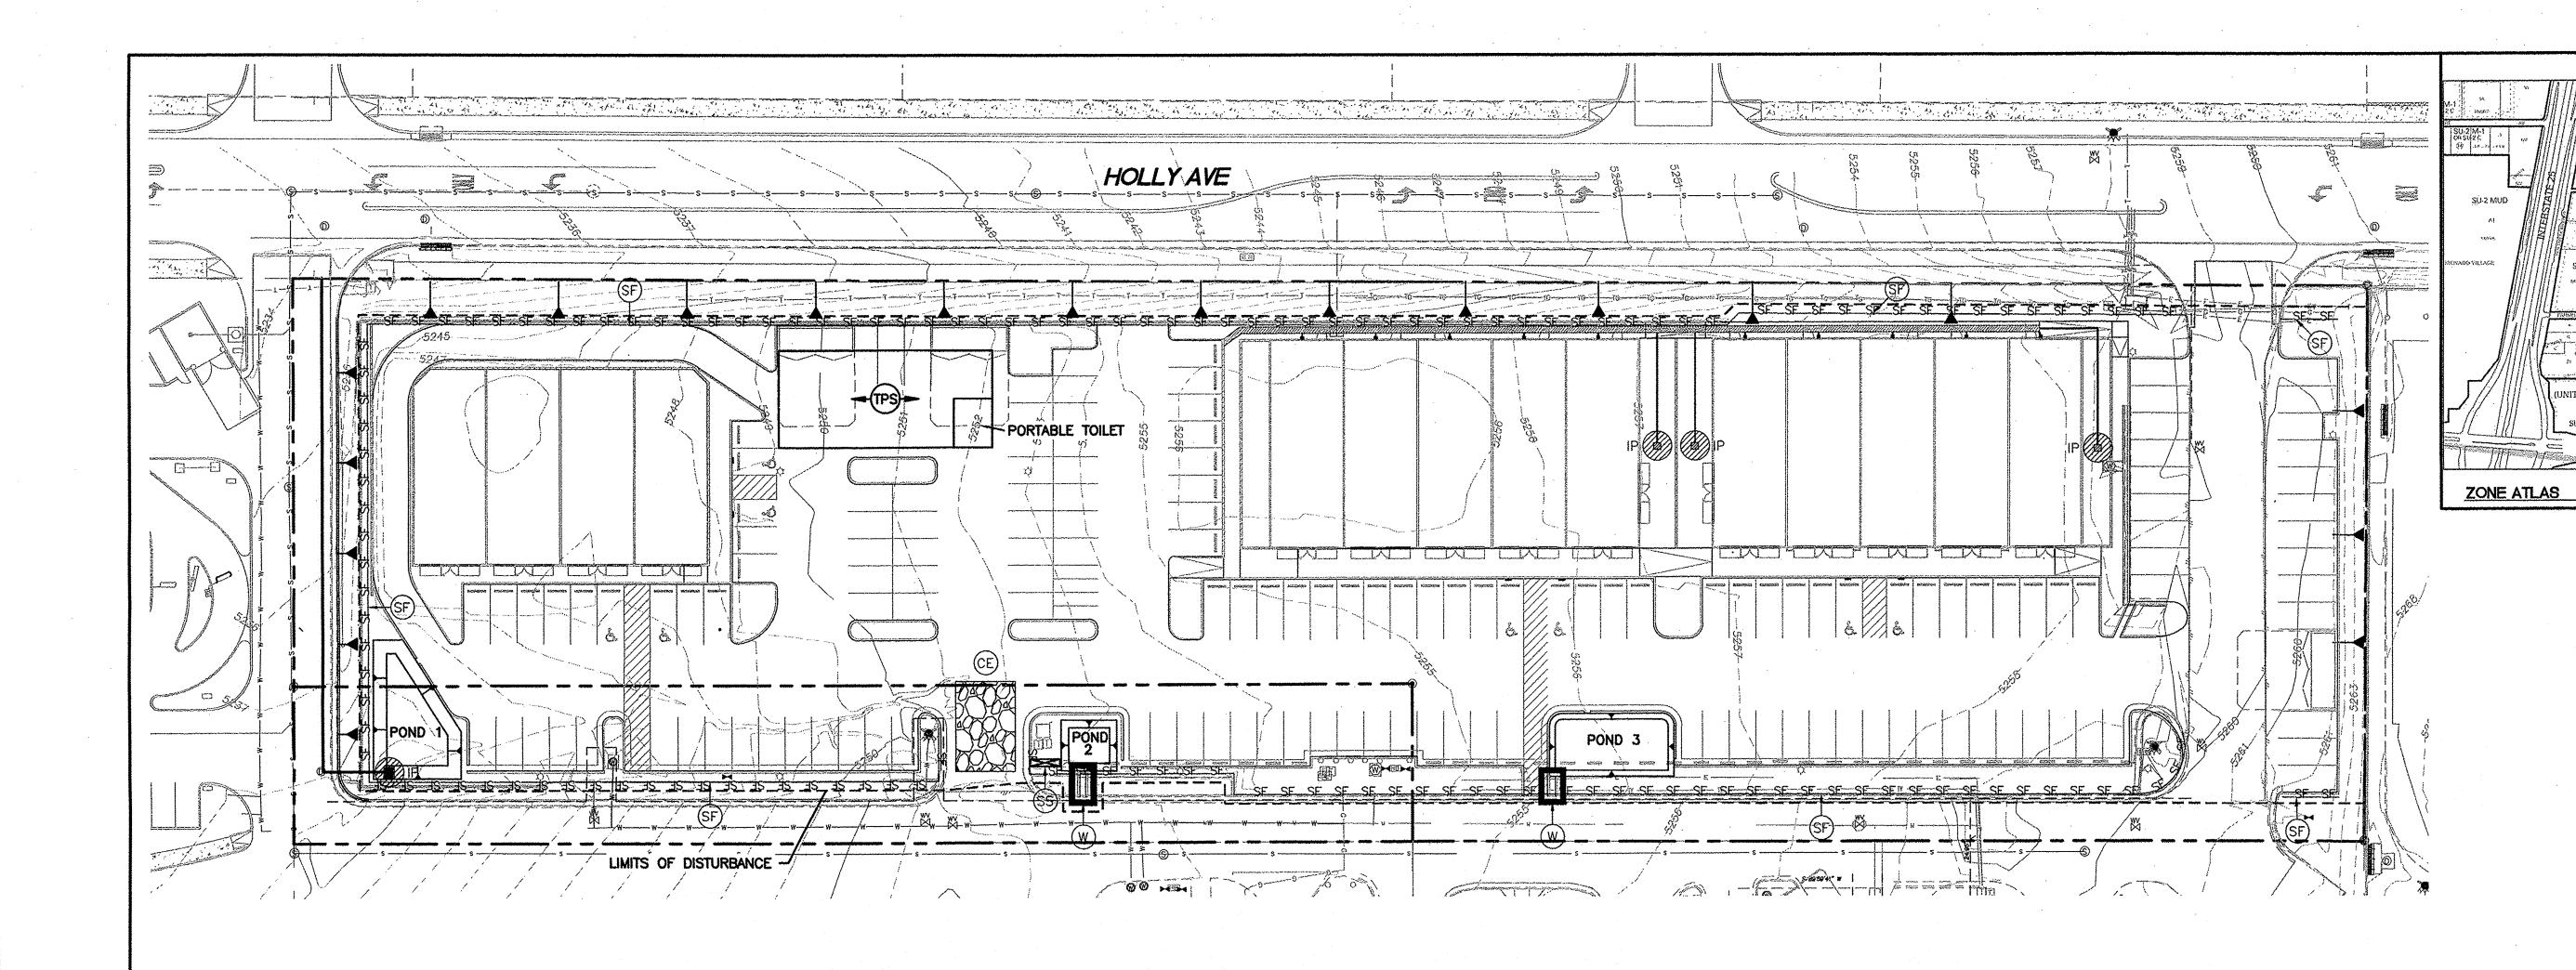

- A. THE STORMWATER POLLUTION PREVENTION PLAN (SWPPP) IS COMPRISED OF THIS DRAWING ("SITE MAP"), THE STANDARD DETAILS, THE PLAN NARRATIVE, PLUS THE PERMIT AND ALL SUBSEQUENT REPORTS AND RELATED DOCUMENTS.
- B. ALL CONTRACTORS AND SUBCONTRACTORS INVOLVED WITH STORM WATER POLLUTION PREVENTION SHALL OBTAIN A COPY OF THE STORM WATER POLLUTION PREVENTION PLAN AND THE STATE OF NEW MEXICO NATIONAL POLLUTANT DISCHARGE ELIMINATION SYSTEM GENERAL PERMIT (NPDES PERMIT) AND BECOME FAMILIAR WITH THEIR CONTENTS.
- C. CONTRACTOR SHALL IMPLEMENT BEST MANAGEMENT PRACTICES AS REQUIRED BY THE SWPPP. ADDITIONAL BEST MANAGEMENT PRACTICES SHALL BE IMPLEMENTED AS DICTATED BY CONDITIONS AT NO ADDITIONAL COST TO OWNER THROUGHOUT ALL PHASES OF CONSTRUCTION.
- D. BEST MANAGEMENT PRACTICES (BMP'S) AND CONTROLS SHALL CONFORM TO FEDERAL, STATE, OR LOCAL REQUIREMENTS OR MANUAL OF PRACTICE, AS APPLICABLE CONTRACTOR SHALL IMPLEMENT ADDITIONAL CONTROLS AS DIRECTED BY PERMITTING AGENCY OR OWNER.
- E. SITE MAP MUST CLEARLY DELINEATE ALL STATE WATERS. PERMITS FOR ANY CONSTRUCTION ACTIVITY IMPACTING STATE WATERS OR REGULATED WETLANDS MUST BE MAINTAINED ON SITE AT ALL TIMES.
- F. CONTRACTOR SHALL MINIMIZE CLEARING TO THE MAXIMUM EXTENT PRACTICAL OR AS REQUIRED BY THE GENERAL PERMIT.
- G. GENERAL CONTRACTOR SHALL DENOTE ON PLAN THE TEMPORARY PARKING AND STORAGE AREA WHICH SHALL ALSO BE USED AS THE EQUIPMENT MAINTENANCE AND CLEANING AREA, EMPLOYEE PARKING AREA, AND AREA FOR LOCATING PORTABLE FACILITIES, OFFICE TRAILERS, AND TOILET FACILITIES.
- H. ALL WASH WATER (CONCRETE TRUCKS, VEHICLE CLEANING, EQUIPMENT CLEANING, ETC.) SHALL BE DETAINED AND PROPERLY TREATED OR DISPOSED.
- I. SUFFICIENT OIL AND GREASE ABSORBING MATERIALS AND FLOTATION BOOMS SHALL BE MAINTAINED ON SITE OR READLY AVAILABLE TO CONTAIN AND CLEAN-UP FUEL OR CHEMICAL SPILLS AND LEAKS.
- J. DUST ON THE SITE SHALL BE CONTROLLED THE USE OF MOTOR OILS AND OTHER PETROLEUM BASED OR TOXIC LIQUIDS FOR DUST SUPPRESSION OPERATIONS IS PROHIBITED.
- K. RUBBISH, TRASH, GARBAGE, LITTER, OR OTHER SUCH MATERIALS SHALL BE DEPOSITED INTO SEALED CONTAINERS. MATERIALS SHALL BE PREVENTED FROM LEAVING THE PREMISES THROUGH THE ACTION OF WIND OR STORMWATER DISCHARGE INTO DRAINAGE DITCHES OR WATERS OF THE STATE.

- L. ALL STORM WATER POLLUTION PREVENTION MEASURES PRESENTED ON THIS PLAN, AND IN THE STORM WATER POLLUTION PREVENTION PLAN, SHALL BE INITIATED AS SOON AS PRACTICABLE.
- M. DISTURBED PORTIONS OF THE SITE WHERE CONSTRUCTION ACTIVITY HAS STOPPED FOR AT LEAST 21 DAYS, SHALL BE TEMPORARILY SEEDED. THESE AREAS SHALL BE SEEDED NO LATER THAN 14 DAYS FROM THE LAST CONSTRUCTION ACTIVITY OCCUR-ING THESE AREAS. PROVIDE ADEQUATE TEMPORARY IRRIGATION FOR GERMINATION.
- N. DISTURBED PORTIONS OF THE SITE WHERE CONSTRUCTION ACTIVITY HAS PERMANENTLY STOPPED SHALL BE PERMANENTLY SEEDED. THESE AREAS SHALL BE SEEDED NO LATER THAN 14 DAYS AFTER THE LAST CONSTRUCTION ACTIVITY OCCURRING IN THESE AREAS. REFER TO THE GRADING PLAN AND/OR LANDSCAPE PLAN.
- O. IF THE ACTION OF VEHICLES TRAVELING OVER THE GRAVEL CONSTRUCTION ENTRANCES IS NOT SUFFICIENT TO REMOVE THE MAJORITY OF DIRT OR MUD, THEN THE TIRES MUST BE WASHED BEFORE THE VEHICLES ENTER A PUBLIC ROAD. IF WASHING IS USED, PROVISIONS MUST BE MADE TO INTERCEPT THE WASH WATER AND TRAP THE SEDIMENT BEFORE IT IS CARRIED OFF THE SITE.
- P. ALL MATERIALS SPILLED, DROPPED, WASHED, OR TRACKED FROM VEHICLES ONTO ROADWAYS OR INTO STORM DRAINS MUST BE REMOVED IMMEDIATELY.
- Q. CONTRACTORS OR SUBCONTRACTORS WILL BE RESPONSIBLE FOR REMOVING SEDIMENT IN THE DETENTION POND AND ANY SEDIMENT THAT MAY HAVE COLLECTED IN THE STORM SEWER DRAINAGE SYSTEMS IN CONJUNCTION WITH THE STABILIZATION OF THE SITE.
- R. ON-SITE & OFFSITE SOIL STOCKPILE AND BORROW AREAS SHALL BE PROTECTED FROM EROSION AND SEDIMENTATION THROUGH IMPLEMENTATION OF BEST MANAGEMENT PRACTICES. AS REQUIRED PER THE CONSTRUCTION GENERAL PERMIT. STOCKPILE AND BORROW AREA LOCATIONS SHALL BE NOTED ON THE SITE MAP AND PERMITTED IN ACCORDANCE WITH GENERAL PERMIT REQUIREMENTS.
- S. SLOPES SHALL BE LEFT IN A ROUGHENED CONDITION DURING THE GRADING PHASE TO REDUCE RUNOFF VELOCITIES AND EROSION.
- T. DUE TO THE GRADE CHANGES DURING THE DEVELOPMENT OF THE PROJECT, THE CONTRACTOR SHALL BE RESPONSIBLE FOR ADJUSTING THE EROSION CONTROL MEASURES (SILT FENCES, STRAW BALES, ETC.) TO PREVENT EROSION.
- U. ALL CONSTRUCTION SHALL BE STABILIZED AT THE END OF EACH WORKING DAY, THIS INCLUDES BACKFILLING OF TRENCHES FOR UTILITY CONSTRUCTION AND PLACEMENT OF GRAVEL OR BITUMINOUS PAVING FOR ROAD CONSTRUCTION.

MAINTAINED IN FULLY FUNCTIONAL CONDITION UNTIL NO LONGER REQUIRED FOR A COMPLETED PHASE OF WORK OR FINAL STABILIZATION OF THE SITE. ALL EROSION AND SEDIMENTATION CONTROL MEASURES SHALL BE CHECKED BY A QUALIFIED PERSON AT LEAST ONCE EVERY SEVEN CALENDAR DAYS AND WITHIN 24 HOURS OF THE END OF A 0.5" RAINFALL EVENT, AND CLEANED AND REPAIRED IN ACCORDANCE WITH THE FOLLOWING:

- 1. INLET PROTECTION DEVICES AND BARRIERS SHALL BE REPAIRED
- 2. ALL SEEDED AREAS SHALL BE CHECKED REGULARLY TO SEE THAT A AND RESEEDED AS NEEDED.
- 3. SILT FENCES SHALL BE REPAIRED TO THEIR ORIGINAL CONDITIONS IF DAMAGED. SEDIMENT SHALL BE REMOVED FROM THE SILT FENCES WHEN IT REACHES ONE-HALF THE HEIGHT OF THE SILT FENCE.
- WHICH WILL PREVENT TRACKING OR FLOW OF MUD ONTO PUBLIC CONSTRUCTION ENTRANCES AS CONDITIONS DEMAND.
- 5. ANY TEMPORARY PARKING AND STORAGE AREAS SHALL BE KEPT IN CONDITIONS DEMAND. ONCE IDENTIFIED, NOTE ON THE SWPPP PLAN.
- 6. OUTLET STRUCTURES IN THE SEDIMENTATION BASINS SHALL BE DESIGN CAPACITY HAS BEEN REDUCED BY 50%.

### CAUTION

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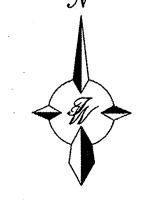
ALL MEASURES STATED ON THIS EROSION AND SEDIMENT CONTROL PLAN, AND IN THE STORM WATER POLLUTION PREVENTION PLAN, SHALL BE

- OR REPLACED IF THEY SHOW SIGNS OF UNDERMINING, OR DETERIORATION.
- GOOD STAND IS MAINTAINED. AREAS SHOULD BE FERTILIZED, WATERED,
- 4. THE CONSTRUCTION ENTRANCES SHALL BE MAINTAINED IN A CONDITION RIGHTS-OF-WAY. THIS MAY REQUIRE PERIODIC TOP DRESSING OF THE
- GOOD CONDITION (SUITABLE FOR PARKING AND STORAGE). THIS MAY REQUIRE PERIODIC TOP DRESSING OF THE TEMPORARY PARKING AS
- MAINTAINED IN OPERATIONAL CONDITIONS AT ALL TIMES. SEDIMENT SHALL BE REMOVED FROM SEDIMENT BASINS OR TRAPS WHEN THE

GRAPHIC SCALE

( IN FEET )

1 inch = 30 ft.



SEAL

# LOT 2 DEL NORTE PLAZA ALBUQUERQUE, NM

O EROSION NOTES

O EROSION DETAILS

INSTALL STABILIZED CONSTRUCTION ENTRANCE.

5. CONSTRUCT POND #2 & #3 WITH OVERFLOW OR WADDLE. 6. INSTALL AREA DRAIN PROTECTION UPON INSTALLATION.

3. INSTALL PERIMETER SILT FENCES ON THE SITE. 4. CONSTRUCT POND #1 WITH INLET PROTECTION

1. CONTRACTOR IS RESPONSIBLE FOR OBTAINING A TOPSOIL

2. CONTRACTOR IS RESPONSIBLE FOR MAINTAINING RUN-OFF

3. CONTRACTOR IS RESPONSIBLE FOR CLEANING ALL SEDIMENT

4. REPAIR OF DAMAGED FACILITIES AND CLEANUP OF SEDIMENT

FACILITIES IS THE RESPONSIBILITY OF THE CONTRACTOR.

5. ALL EXPOSED EARTH SURFACES MUST BE PROTECTED FROM

ACCUMULATIONS ON ADJACENT PROPERTIES AND IN PUBLIC

WIND AND WATER EROSION PRIOR TO FINAL (CITY) ACCEPTANCE

DISTURBANCE PERMIT PRIOR TO BEGINNING WORK.

INSTALL SWPPP BOARD.

EROSION CONTROL NOTES

ON SITE DURING CONSTRUCTION.

THAT GETS INTO EXISTING RIGHT-OF-WAY.

7. COMPLETE FINAL STABILIZATION.

H (TPS) TPS TEMPORARY PARKING AND STORAGE

TEMPORARY EROSION CONTROL AND SEDIMENTATION PLAN

JOB # 2015064

DRAWN BY

3-17-16

DRAWING


2015064-SWPPP


SHEET #

C-18-Z

RONALD R. BOHANNAN P.E. #7868

TIERRA WEST, LLC 5571 MIDWAY PARK PL NE ALBUQUERQUE, NEW MEXICO 87109 (505) 858-3100 www.tierrawestllc.com

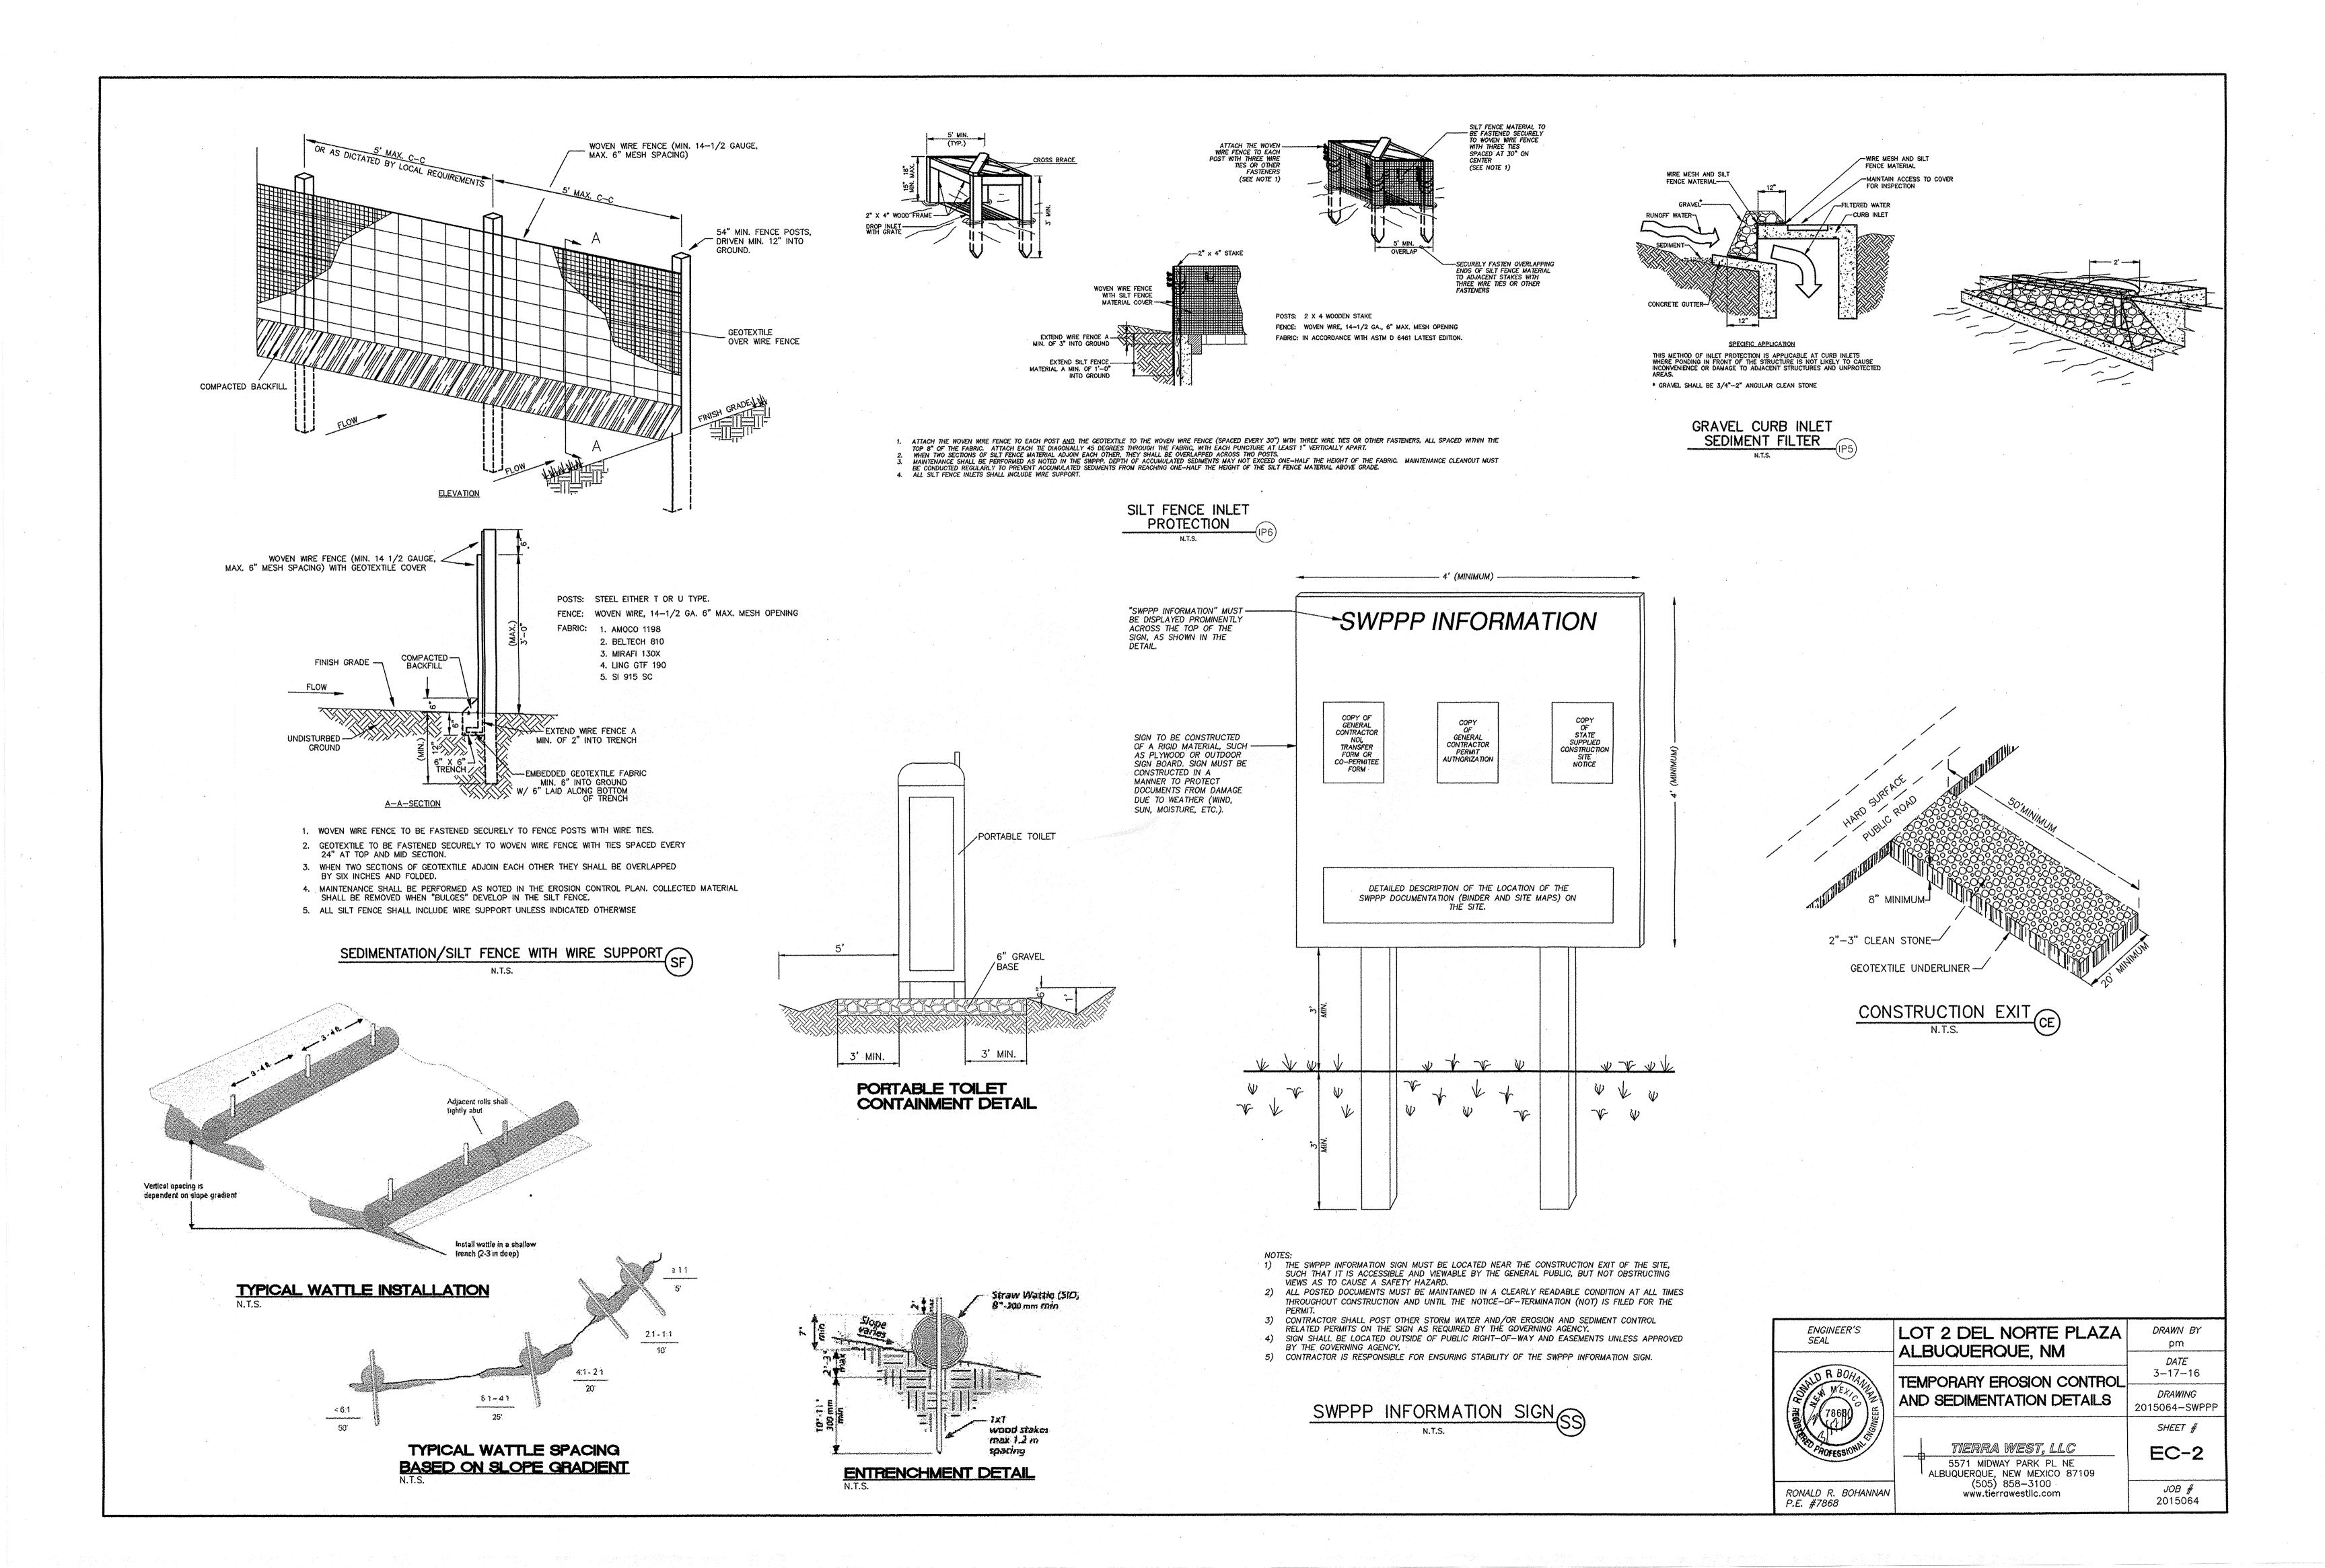

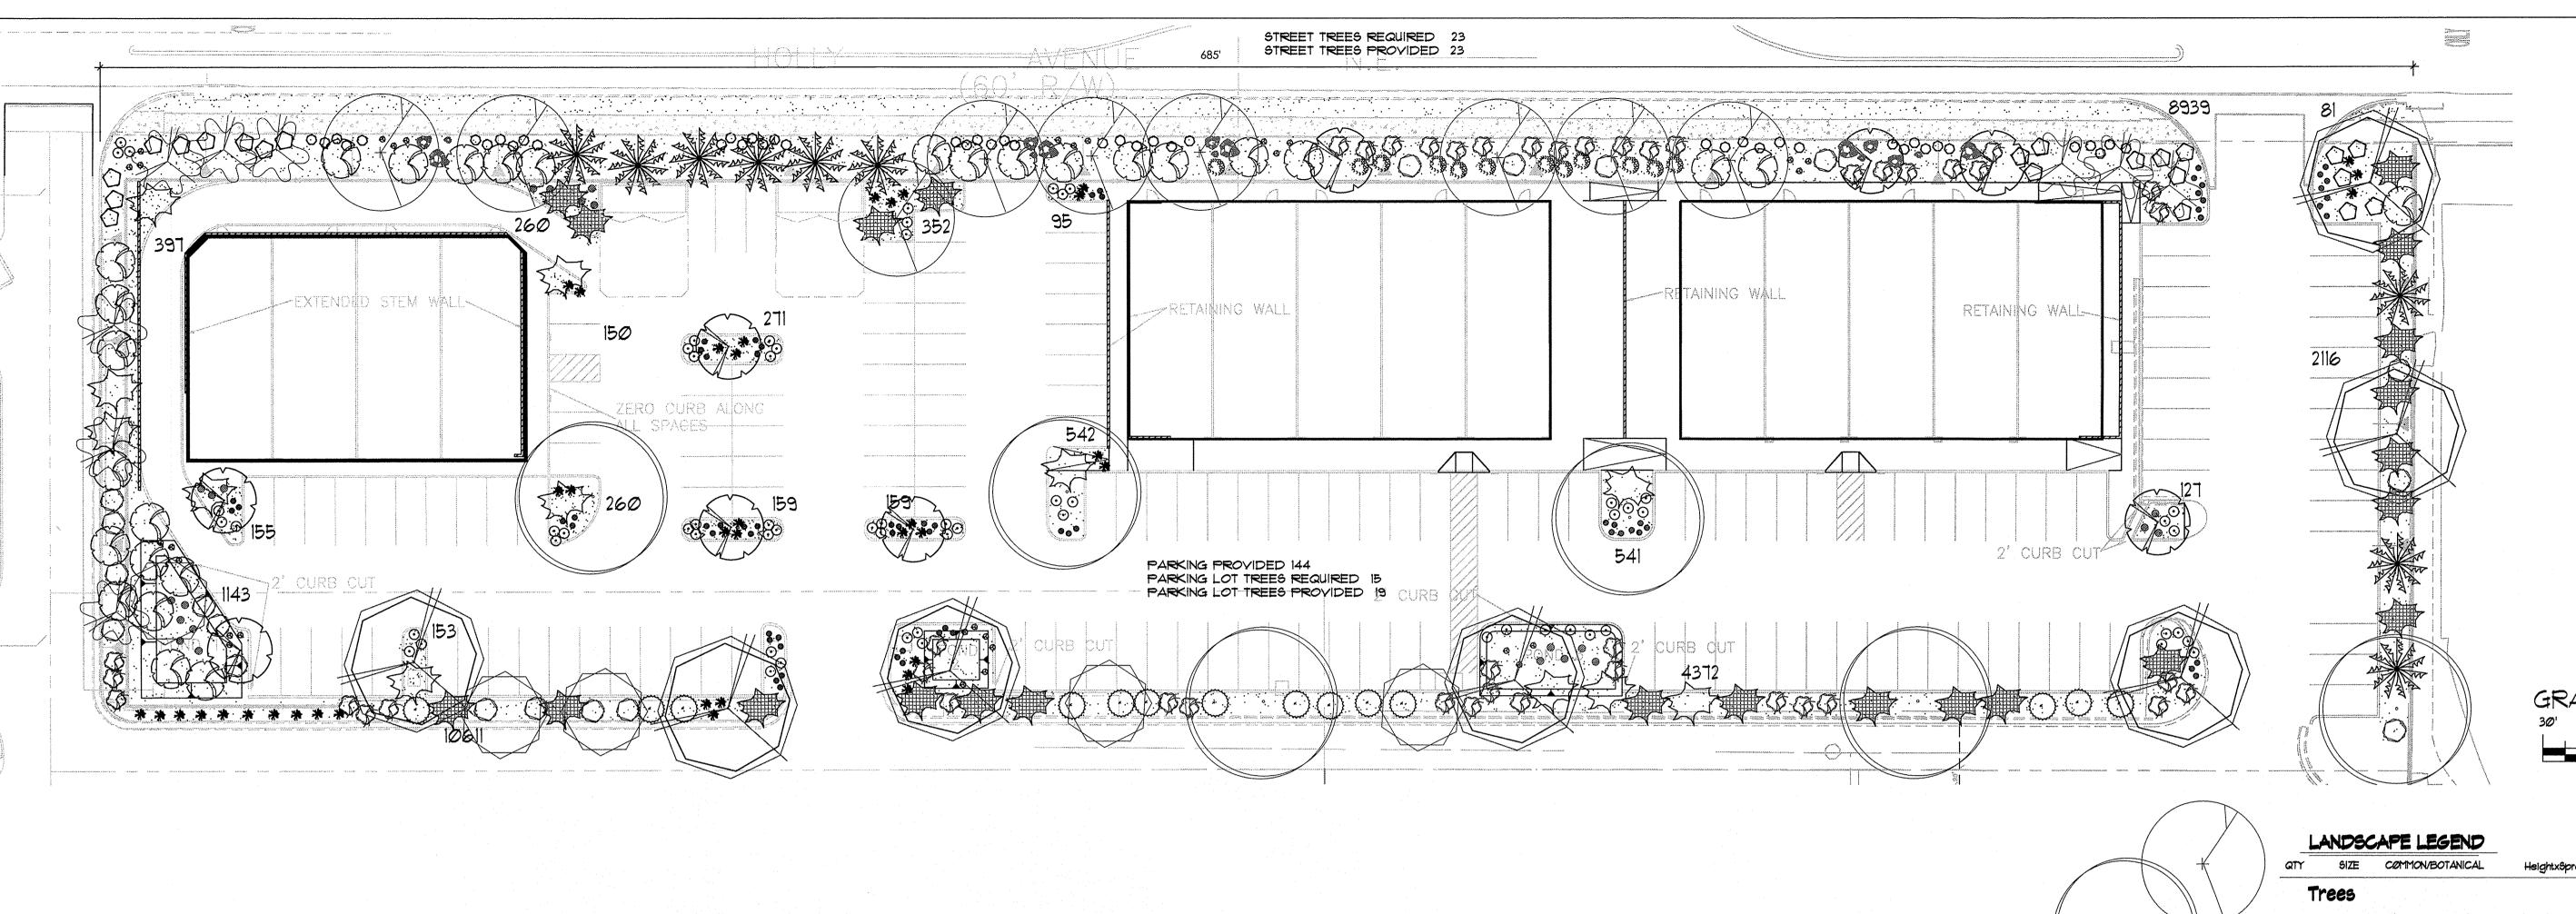

LANDSCAPE NOTES:

Landscape maintenance shall be the responsibility of the Property Owner. The Property Owner shall maintain street trees and shrubs in a living, healthy, and attractive condition.

Water management is the sole responsibility of the Property Owner. All landscaping will be in conformance with the City of Albuquerque Zoning Code. In general, water conservative, environmentally sound landscape principles will be followed in design and installation.

Gravel over Filter Fabric to a minimum depth of 3" shall be placed in all landscape areas.

IRRIGATION NOTES:

Irrigation system maintenance and operation shall be the sole responsibility of the owner. It shall be the owners responsibility to ensure that fugitive water does not leave the site due to overwatering.

Irrigation shall be a complete underground system with Trees to receive 1 Netafim spiral (50' length) with 3 loops at a final radius of 45' from tree trunk, pinned in place. Netafim shall have emitters 12" o.c. with a flow of 6 gph. Shrubs to receive (2) 1.0 GPH Drip Emitters. Drip and Bubbler systems to be tied to 1/2" polypipe with flush caps at each end.

Run time per each shrub drip valve will be approximately 15 minutes per day. Tree drip valve shall run 1.5 hours, 3 times per week. Run time will be adjusted according to the season.


Point of connection for irrigation system is unknown at current time and will be coordinated in the field. Irrigation will be operated by automatic

Location of controller to be field determined and power source for controller to be provided by others. Irrigation maintenance shall be the responsibility of the Property Owner. Water and Power source shall be the responsibility of the Developer/Builder.

## LANDSCAPE CALCULATIONS

TOTAL LOT AREA (sf) 24050 TOTAL BUILDING AREA PHASE ONE 86463 NET LOT AREA PHASE ONE 15% 12969 30883 TOTAL REQUIRED LANDSCAPE AREA TOTAL REQUIRED LANDSCAPE TOTAL PROVIDED LANDSCAPE AREA

TOTAL REQUIRED LIVE GROUNDCOVER 15% TOTAL PROVIDED LIVE GROUNDCOVER TOTAL PROVIDED LIVE PLANT MATERIAL

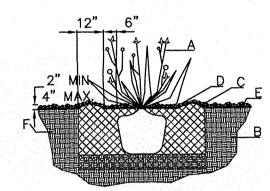

SHRUB PLANTING DETAIL


GENERAL NOTES:

1. THE OUTSIDE DIAMETER OF THE WATER RETENTION BASIN SHALL BE TWICE THE DIAMETER OF THE SHRUB PLANTING PIT.

**CONSTRUCTION NOTES:** 

A. SHRUB. B. BACKFILL WITH EXISTING SOIL. C. EARTH BERM AROUND WATER RETENTION BASIN. D. 3" DEPTH OF GRAVEL MULCH.

FINISH GRADE. F. UNDISTURBED SOIL.

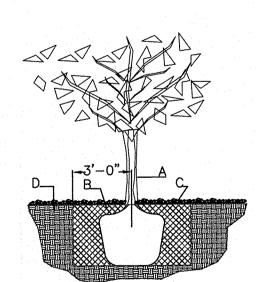

## TREE PLANTING DETAIL

NTS GENERAL NOTES:


1. ROOTBALL SHALL BE PLACED ON UNDISTURBED SOIL TO PREVENT TREE FROM SETTLING. 2. TOP OF ROOTCOLLAR INDICATED LEVEL AT WHICH TREE WAS GROWN AND DUG; THIS REPRESENTS THE

LEVEL AT WHICH THE TREE SHOULD BE INSTALLED; THAT LEVEL MAY BE EXCEEDED BY ONLY A ONE INCH LAYER OF SOIL. 3. PRIOR TO BACKFILLLING TREE, ALL WIRE, ROPE AND SYNTHETIC MATERIALS SHALL BE REMOVED FROM THE


TREE AND THE PLANTING PIT. 4. PRIOR TO BACKFILLING ALL BURLAP SHALL BE CUT AWAY EXCEPT FROM BOTTOM OF THE ROOTBALL. CONSTRUCTION NOTES:

B. BACKFILL WITH EXISTING SOIL. C. 3" DEPTH OF GRAVEL MULCH.

D. UNDISTRUBED SOIL.

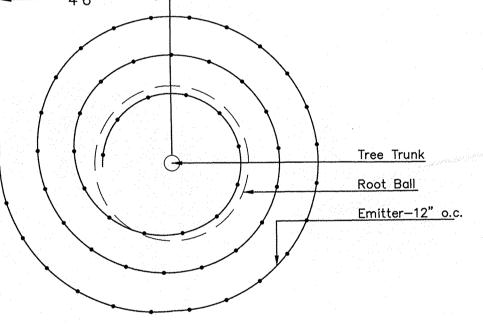


Netafim Spiral Detail

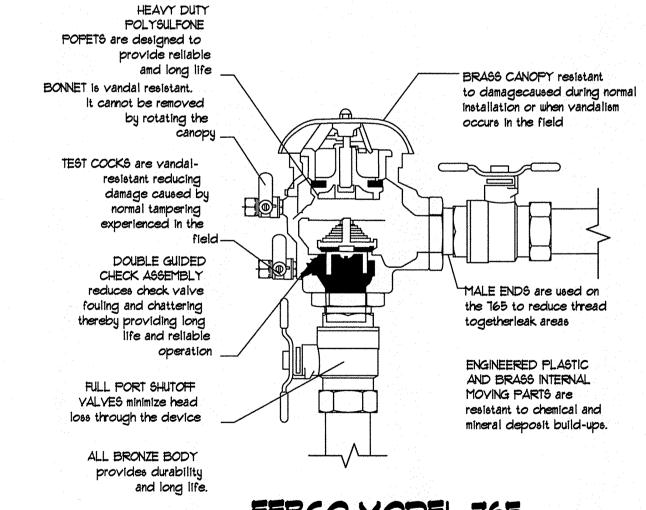

Pressure Vacuum Breaker Features Stainless Backflow Cover w/ Frost Protection 12" above the highest downstream outlet and the highest point in the downstream piping 

FEBCO MODEL 765

Pressure Vacuum Breaker Outside Installation

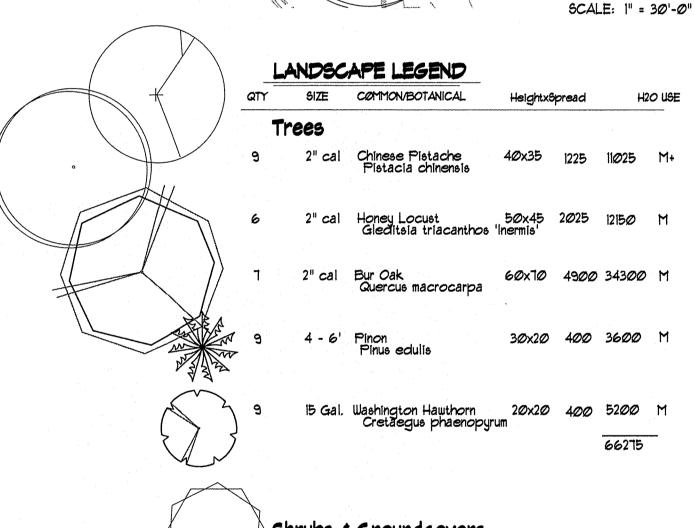

Shrubs & Groundcovers 15 Gal Desert Willow 20x25 625 3125 M Multi-Trunk Chilopeie linearie 15 Gal Vitex 20 Multi-Trunkitex agnus-castus 5 Gai India Hawthorne 3x5 25 300 M Raphiolepis Indica 5 Gal Purple Leaf Sand Cherry Prunus cistena 6x6 36 648 M Low Grow Sumac 6x6 36 1512 L Rhus aromatica 5 Gal Rock Cotoneaster 2x7 49 1078 M Karl Foerster Grass 2,5x3 9 351 M Calamogrostis arudinacea 5 Gal Winter Jasmine Jasminum nudiflorum 4x12 144 1728 M 5 Gal Buffalo Juniper ixl2 144 3312 M Juniperus sabina 'Buffalo' Halls Honeysuckle vine 12x12 144 4032 L Lonicera japonice Halliana Blue Mist 3x3 9 576 M Caryopteris x clandonensis Abache Plume 6x7 49 686 L Fallugia paradoxa 2x3 9 423 M Cherry Sage

Salvia greggii Day Lilly 15x15 3 228 L Hemerocallis 'Stella d'Oro' I Gal Maiden Hair Grass 3x2 4 84 Miscanthus sinensus 'gracillimus' 1 Gal Shenandoah Switch Grass 5x3 9 117 L

Live Ground Cover 23807

2-3cf Boulders To be placed at contractor discretion Landscape Gravel / Filter Fabric 3/4" Crushed Gray/Filter Fabric

Panicum virgatum 'Shenandoah'

Live Yeg. Cover 73258

Landscape Architect DANNY D. MITCHELL

December 30, 2015

HOPPE SAN Que, N

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SHEET \*


REVISION DATE

RBA ARCHITECTUR

A-2





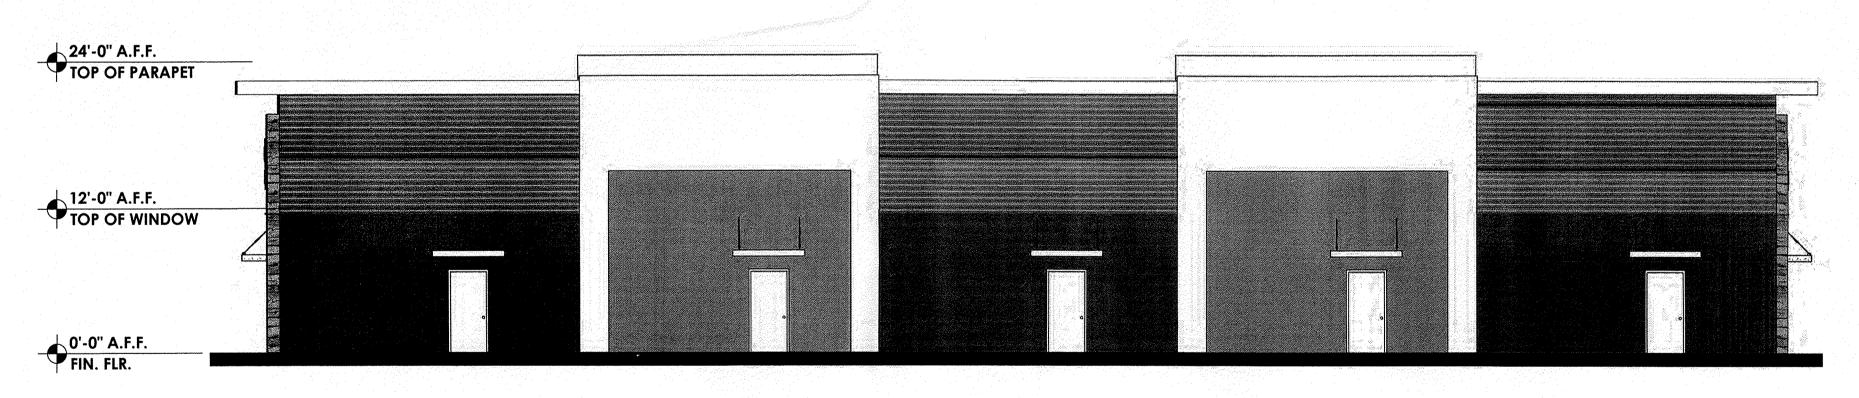

NORTH ELEVATION

1/8" = 1'-0"

