

SITE INFORMATION

LEGAL DESCRIPTION

LOT 3A 1-B, BLOCK A UNIT II, INTERSTATE INDUSTRIAL TRACT, ALBUQUERQUE, NEW MEXICO, RECORDED OCTOBER 2007

GROSS BUILDING AREA (GBA):

BUILDING (1-STORY) = 6336 SF

TOTAL SITE AREA 32,567 SF = .75 ACRES GROSS F.A.R. (GBA/SITE AREA) = .2

PARKING INFORMATION

TOTAL PARKING REQUIRED = 32 PARKING SPACES 10% TRANSIT REDUCTION - 3 SPACES PARKING REQUIRED WITH TRANSIT REDUCTION: 29 SPACES PARKING PROVIDED = 29 PARKING SPACES

HANDICAP PARKING STALLS REQUIRED

1-25 PARKING STALLS: 2 HC STALLS REQUIRED


HC PARKING PROVIDED = 2 HC STALLS, VAN ACCESSIBLE

BICYCLE PARKING REQUIRED = 1:20 AUTOS TOTAL = 2 SPACES

PROVIDED = 2 SPACES

MOTORCYCLE PARKING REQUIRED:


1-25 PARKING STALLS = 2 MOTORCYCLE SPACES REQUIRED TOTAL = 2 SPACES PROVIDED

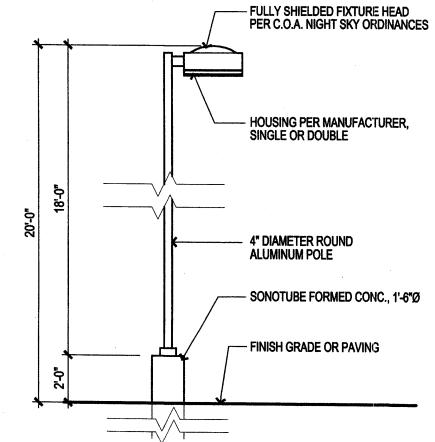

(D1) LIGHT POLE ELEVATION

METAL ROOFING; MATCH COLOR **USED ON ADJACENT BUILDING** TUBE STEEL BEAM; -PAINT TO MATCH ADJACENT BUILDING - STEEL COLUMN; PAINT TO MATCH ADJACENT BUILDING -ASPHALTIC PAVEMENT

1/4" = 1'-0"

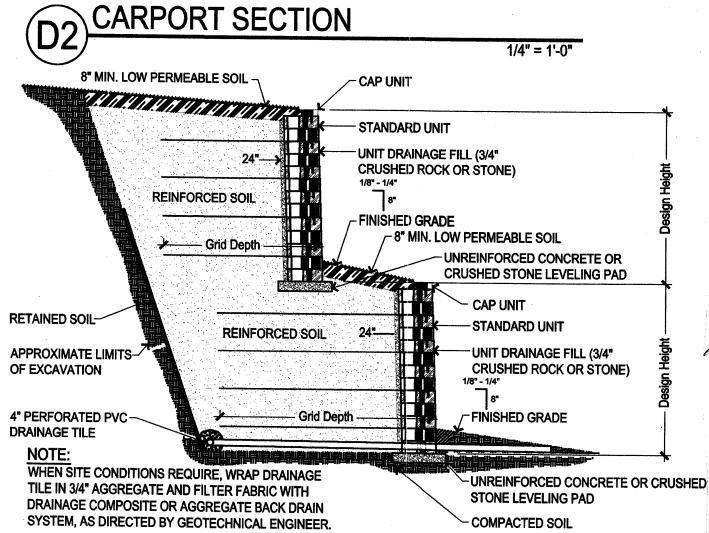

REINFORCED TIERED WALL SECTION

GENERAL NOTES

STANDARDS.

UTILITY INFORMATION.

- A. PARKING AREA SHALL BE DESIGNED & BUILT TO CURRENT DPM
- B. SEE CIVIL PLANS FOR ADDITIONAL GRADING, DRAINAGE AND
- C. DIMENSIONS ARE TO FACE OF CURB, OR WALL, OR EDGE OF PAVEMENT UNLESS OTHERWISE NOTED.
- D. ALL CURBS AND ACCESSIBLE RAMPS WILL BE DESIGNED AND BUILT ACCORDING TO THE CITY OF ALBUQUERQUE
- E. ALL FIXTURES AND DESIGN SHALL COMPLY WITH THE NEW MEXICO NIGHT SKY PROTECTION ACT AND THE CITY OF ALBUQUERQUE ZONING CODE, SECTION 14-16-3-9 AREA LIGHTING REGULATIONS.
- F. LIGHTING WITHIN THE PUBLIC RIGHT-OF-WAY SHALL BE SUBJECT TO THE STANDARDS AND REVIEW OF PNM, UNLESS MAINTENANCE FOR RIGHT-OF-WAY LIGHTING IS THE FULL RESPONSIBILITY OF OTHER PARTIES.
- G. LIGHTING DESIGN FOR PARKING AREAS SHALL BE LIGHTED TO PROVIDE FUNCTIONAL, ATTRACTIVE, AND UNIFIED LIGHTING THROUGHOUT THE LOT AND BE EXTINGUISHED ONE HOUR AFTER THE CLOSE OF BUSINESS, EXCEPT AS NEEDED TO PROVIDE FOR MINIMUM SECURITY LEVELS.

LEGEND

EXISTING UTILITIES

EXISTING FIRE HYDRANT NEW LIGHT FIXTURE

LANDSCAPE AREA

SITE FURNISHINGS LEGEND

2 BIKE - BIKE RACK, QUANTITY: 1 Manufacturer: Madrax, Model: CIR-2-IG, In-Ground Mount, Galvanized Finish, Color: Steel. Contact: 800-448-7931

KEYED NOTES \bigcirc

1. TYPICAL PARKING SPACE: 8'-6"x 20'-0" 2. TYPICAL ACCESSIBLE PARKING SPACE; 8'-6"x20'-0" 3. LANDSCAPED AREA, REFER TO LANDSCAPE PLAN

4. TYPICAL MOTORCYCLE PARKING SPACE: 4'-0"x8'-0" 5. GARDEN TERRACING, SEE D3/A001. 6. BUILDING SETBACK LINE 7. UTILITY EASEMENT. SEE PLAN FOR WIDTH

8. CONCRETE SIDEWALK, SEE COA STD. DWG # 2720 9. CONCRETE WHEEL STOP 10. CONCRETE PATIO

11. 2'-0" WIDE CONCRETE CHANNEL 12. TYPICAL COMPACT PARKING SPACE; 8'-0"x15'-0" 13. ASPHALT PAVING

14. PROPERTY LINE 15. ACCESSIBLE RAMP, SLOPE 1:12 MAXIMUM; SEE COA STD. DWG # 2440 16. CONCRETE CURB AND GUTTER, SEE COA STD. DWG # 2415B

17. BIKE RACK, SEE SITE FURNISHINGS LEGEND. 18. PAINTED A.D.A PAVEMENT SIGNAGE 19. SIDEWALK CULVERT, REFER TO GRADING AND DRAINAGE PLANS

20. EXISTING UTILITIES TO REMAIN 21. CONCRETE STAIRS WITH STEEL HANDRAILS. 22. HEADER CURB, SEE COA STD. DWG # 2415

23. POLE MOUNTED LIGHT FIXTURE, SEE DETAIL D1 / A001. 24. EXISTING FIRE HYDRANT

25. CUT EXISTING CURB FOR NEW DRIVEPAD 26. BUS ROUTE 27. STL. CANOPY CARPORT - (9) SPACES; SEE D2/A001

28. CONCRETE DRIVEPAD, SEE COA STD. DWG #2425. 29. TYP. PARALLEL PARKING SPACE; 8'-6"x22'-0".

30. CUT EXISTING CONCRETE CURB FOR NEW PARKING SPACES.

PROJECT NUMBER: __1007076 APPLICATION NUMBER: 08DRB-70042

Is an Infrastructure List Required? () Yes (x) No If yes, then a set of approved DRC plans with a work order is required for any construction within Public Right-of-Way or for construction of public

6-11-08 TRAFFIC ENGINEER, TRANSPORTATION DIVISION DATE 6-11-08 DATE PARKS AND RECREATION DEPARTMENT DATE

Cento a. chem 6-4-08 CITY ENGINEER

Michael Holton (see attached letter, 6/27/08 DRP CHAIRPERSON, PLANNING DEPARTMENT

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ARCHITECT

dps@dpsdesign.org

DRB **SUBMITTAL**

PROJECT

suna

1buquerque 3880 O


REVISIONS 1 5/07/08 DRAWN BY REVIEWED BY DATE

Jan. 22, 2008 PROJECT NO. 07-0092

DRAWING NAME

SITE PLAN

SHEET NO.

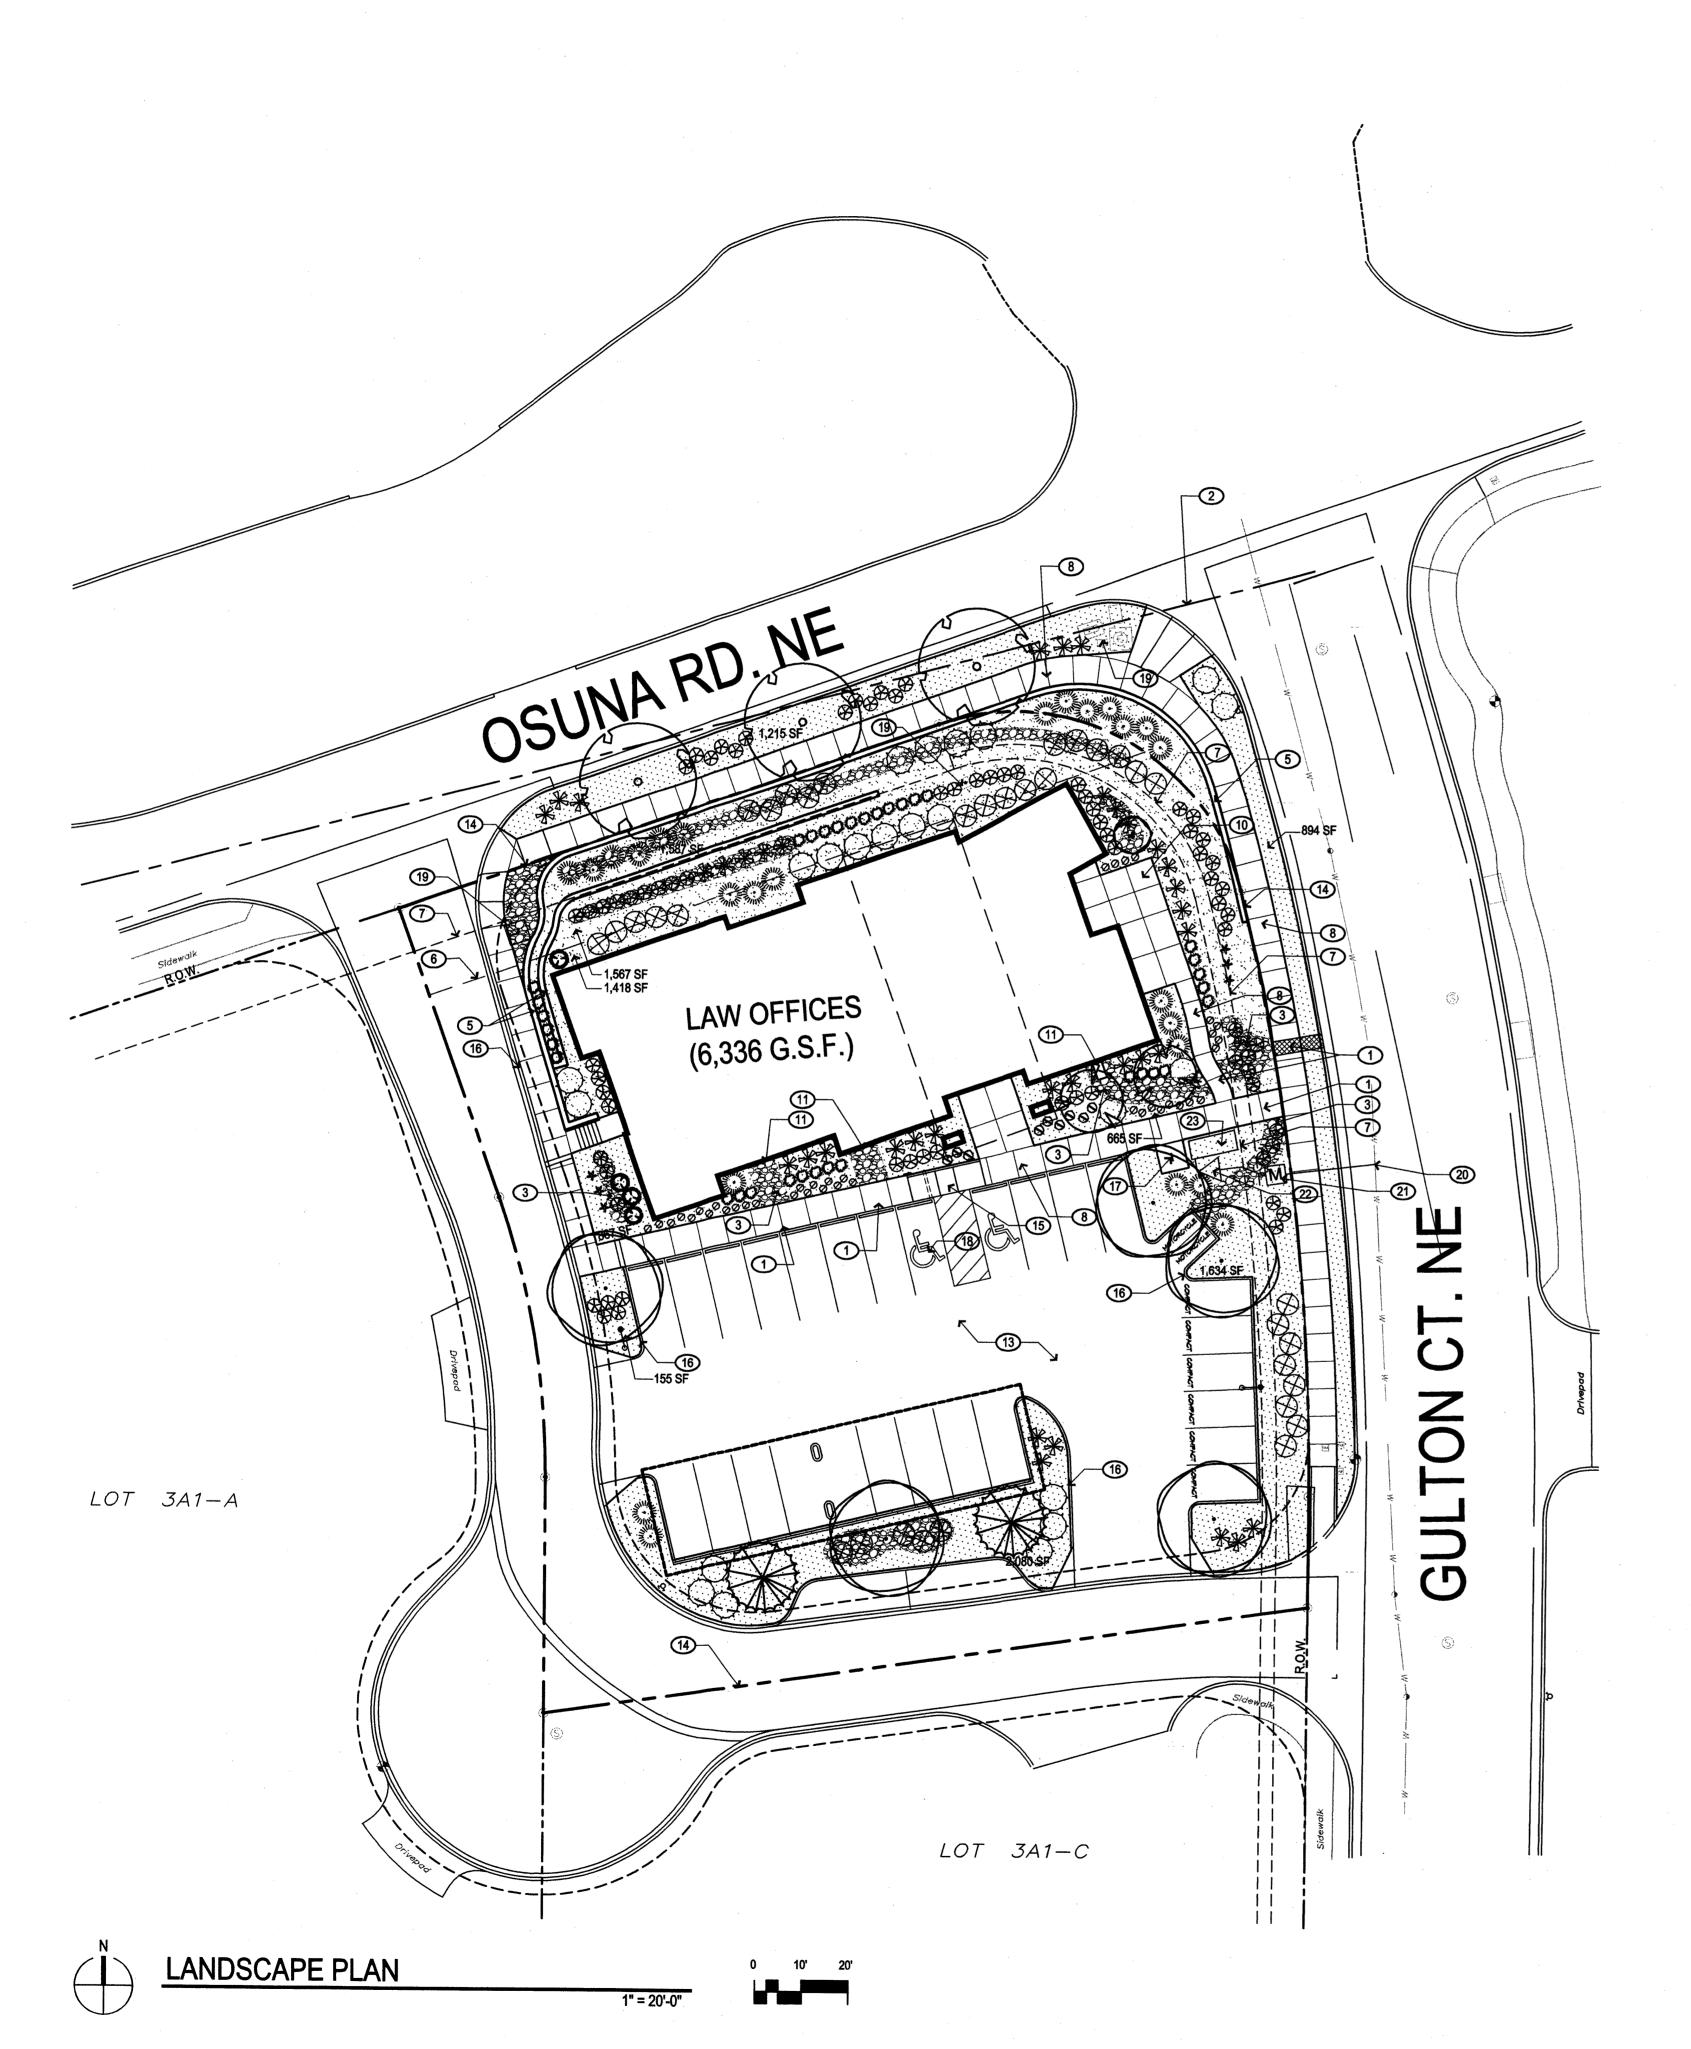

PLANTING NOTES

1. INSTALLATION AND MAINTENANCE OF LANDSCAPING AND IRRIGATION 9. WATER USE DESCRIPTION: SHALL BE THE RESPONSIBILITY OF THE PROPERTY OWNER.

2. THE LANDSCAPE DESIGN SHALL COMPLY WITH THE INTENT OF THE CITY OF ALBUQUERQUE WATER CONSERVATION, LANDSCAPING AND WATER WASTE ORDINANCE.

3. THE USE OF HIGH WATER USE PLANT MATERIALS SHALL BE LIMITED. THERE IS NO HIGH WATER USE TURF USED ON THIS PROJECT.

4. MINIMUM INSTALLATION SIZES FOR PLANT MATERIAL VARY BY SPECIES. SEE PLANT LEGEND.

5. LANDSCAPE AREAS SHALL BE COVERED WITH MULCH AND FILTER FABRIC, SEE PLAN FOR MATERIAL.

6. TREE AND SHRUB PITS TO BE 3 TO 5 TIMES THE ROOT BALL DIAMETER. 7. SOIL PREPARATION AND AERATION WITHIN ROW IS REQUIRED TO

DE-COMPACT LANDSCAPE ZONE PRIOR TO PLANTING.

8. PASSIVE WATER HARVESTING, SUCH AS HARVESTING OF STORM WATER SURFACE RUNOFF AND ROOF RUNOFF, SHALL BE UTILIZED WHERE FEASIBLE AND CAPTURED IN COBBLE SWALES, SEE DETAIL

LANDSCAPE CALCULATIONS

SITE AREA: 32,296 SF = .74 ACRES

TOTAL BUILDING FOOTPRINT: 6,336 SF NET SITE AREA: 25,960 SF REQUIRED LANDSCAPE AREA: 3.894 SF (15% OF NET LOT AREA) PROVIDED LANDSCAPE AREA: 11,757 SF 45% OF NET LOT AREA) (36% OF TOTAL LOT AREA)

PLANT MATERIALS HAVE BEEN CHOSEN FOR THEIR XERIC QUALITIES IN ADDITION TO THEIR AESTHETIC AND HABITAT VALUES. NO TURF IS USED IN THIS DESIGN.

10. SEE CONCEPTUAL GRADING AND DRAINAGE PLAN FOR ADDITIONAL INFORMATION ON WALLS AND SIDEWALK CULVERTS.

11. SOIL AMENDMENT PRODUCTS: SOIL BIOLOGY AMENDMENTS BY SOIL SECRETS (505-550-3246) SHALL BE APPLIED OVER PLANTING PITS DURING THE LANDSCAPE INSTALLATION AND AGAIN TOWARD THE END OF THE WARRANTY PERIOD. TERRA-PRO COMMERCIAL AND PROTEIN CRUMBLIES ARE TO BE APPLIED OVER PLANT PITS FOLLOWING INSTALLATION AND PRIOR TO MULCH. BETTER GREEN IS TO BE APPLIED TOWARD THE END OF THE WARRANTY PERIOD DIRECTLY OVER PLANTS, INCLUDING MULCH WHERE PRESENT. SEE SPECIFICATIONS AND PLANTING LEGEND.

12. SOIL AMENDMENT QUANTITIES: SEE PLANTING LEGEND. THE ESTIMATED TOTAL QUANTITY OF SOIL AMENDMENT IS BASED TWO APPLICATIONS AND THE FOLLOWING ASSUMPTIONS OF APPLICATION AREA; PER PLANT/PER INSTALLATION ARE AS FOLLOWS: EACH TREE: 78.5 SF

EACH 5 GALLON PLANT: 28 SF EACH 1 GALLON PLANT: 12 SF

IRRIGATION NOTES

THE LANDSCAPE DESIGN REQUIRES A PERMANENT, FULLY AUTOMATIC IRRIGATION SYSTEM TO SUPPORT THE PLANT MATERIAL.

THE CONTRACTOR SHALL CREATE AN IRRIGATION PLAN TO PERMANENTLY IRRIGATE THE PROPOSED PLANTINGS, AND SHALL SUBMIT THIS TO THE ARCHITECT FOR REVIEW AND APPROVAL. THE PLAN SHALL INCLUDE A PIPING AND EMITTER LAYOUT WITH SIZING, VALVE SCHEDULE AND CONSTRUCTION DETAILS. SEE DETAILS C1/C2 L201 FOR EMITTER PLACEMENT AND POLYTUBE CONNECTIONS.

CONTROLLER: THE IRRIGATION SYSTEM SHALL BE RUN WITH FULLY AUTOMATED IRRIGATION CONTROLLER. RUN TIME WILL BE ADJUSTED ACCORDING TO PLANT MATURITY, SEASON, LOCATION, AND PLANT PERFORMANCE.

DRIP EMITTERS SHALL BE USED FOR ALL PLANT MATERIAL.

KEYED NOTES

- 1. SEE GRADING AND DRAINAGE PLANS FOR CULVERTS AND EROSION PROTECTION REQUIREMENTS
- 2. CLEAR SIGHT TRIANGLE
- 3. SWALE FOR WATER HARVESTING 4. NOT USED
- 5. RETAINING WALL; REFER TO DETAILS 3/A001 AND 4/A001 6. BUILDING SETBACK LINE
- 7. 10' UTILITY EASEMENT
- 8. CONCRETE SIDEWALK NOT USED
- 10. CONCRETE PATIO 11. 2'-0" WIDE CONCRETE DRAINAGE CHANNEL
- 12. NOT USED
- 13. ASPHALT PAVING 14. PROPERTY LINE
- 15. HANDICAP RAMP
- 16. CONCRETE CURB AND GUTTER, SEE COA STD. DWG # 2415B 17. BIKE RACK, SEE SITE FURNISHINGS LEGEND A001.
- 18. PAINTED A.D.A PAVEMENT SIGNAGE
- 19. EXISTING UTILITIES, DO NOT DISTURB 20. SUGGESTED LOCATION FOR IRRIGATION P.O.C. AS PER COA
- STD. DWGS 21. SUGGESTED LOCATION OF WATER METER AS PER COA STD.
- 22. SUGGESTED LOCATION OF BACKFLOW PREVENTER, SEE COA
- DWG # 2703

rees: See De	etail: A1&A2/L201							
SYMBOL	EST. QTY.	INSTALLED SIZE	COMMON NAME	Botanical name	Height	Width	Water requirements	Emitter requirements
	2	5-Gal @ 2'x18"	DEODAR CEDAR	Cedrus deodara (female only)	35.00	15.00	Medium Water Use	3-2 GPH
	3	4"-Cal	CHINESE PISTACHE	Pistacia chinensis	35.00	30.00	Low Water Use	2-2 GPH
X	\int_{-2}^{2}	15-Gal @ 6'x2'	MEXICAN REDBUD	Cercis mexicana	15.00	15.00	Medium Water Use	2-2 GPH
	5	15-Gal @ 7'x1'	EMORY OAK	Quercus emoryi	40.00	30.00	Medium Water Use	3-2 GPH
) 4	7-Gal @ 5'x1'	SKYROCKET JUNIPER	Juniperus virginiana 'Skyrocket'	15.00	3.00	Medium Water Use	2-2 GPH
<u> </u>	1	5-Gal @ 18"x1'	MEXICAN BUCKEYE	Ugnadia speciosa	12.00	8.00	Medium Water Use	2-2 GPH
hrubs: See D)etail: B1&B2/L201							
SYMBOL	EST. QTY.	INSTALLED SIZE	COMMON NAME	Botanical name	Height	Width	Water requirements	Water requirements
O	25	1-Gal @ 1'x6"	BLUE MIST SPIREA	Caryopteris X clandonensis	5.00	5.00	Medium Water Use	2-2 GPH
⊕	34	1-Gal @ 6"x6"	POWIS CASTLE SAGE	Artemesia X Powis Castle	3.00	5.00	Low Water Use	2-2 GPH
Q.	22	5-Gal @ 1'x15"	ROCK COTONEASTER	Cotoneaster horizontalis	3.00	10.00	Medium Water Use	2-2 GPH
erennials: Se	e Detail: B1&B2/L2	01					***************************************	
SYMBOL	EST. QTY.	INSTALLED SIZE	COMMON NAME	Botanical name	Height	Width	Water requirements	2-2 GPH
Ø	38	2" Pots @ 2"x2"	BLUE SELECT CATMINT	Nepeta x faassenii 'Blue Select'	0.75	1.50	Low Water Use	2-2 GPH
0	9	1-Gal @ 4"x6"	MOONSHINE YARROW	Achillea filipendulina 'Moonshine'	1.50	2.00	Low Water Use	2-2 GPH
ucculents: Se	ee Detail: A3/L201							
SYMBOL	EST. QTY.	INSTALLED SIZE	COMMON NAME	Botanical name	Height	Width	Water requirements	Water requirements
×	6	5-Gal @ 8"x8"	PARRY'S AGAVE	Agave parryi	2.00	2.00	Low Water Use	2-2 GPH
*	36	15-Gal @ 30"x2"	RED HESPERALOE	Hesperaloe parviflora	4.00	4.00	Low Water Use	2-2 GPH
rass: See De	tail: B1&B2/L201							
SYMBOL	EST. QTY.	INSTALLED SIZE	COMMON NAME	Botanical name	Height	Width	Water requirements	Water requirements
Ø	76	4.0-1.0-01-01						Trator requirements

For use over plant pits in all landscape areas

and one during warranty period.

Total includes two applications, one at installation

Rate: One .6 Cubic foot bag/1,000 SF One .6 Cubic foot bag/2,000 SF Soil Biology Amendment Terra-Pro Commercial Protein Crumblies Mulch: 3" Depth Color: Santa Fe Brown Mulch: 3" Depth Color: Santa Fe Brown Mulch: 4" Depth Color: Santa Ana Tan

DWARF FOUNTAIN GRASS

1-Gal @ 9"x6"

engineering

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ARCHITECT

Osuna Roac Shane 3880


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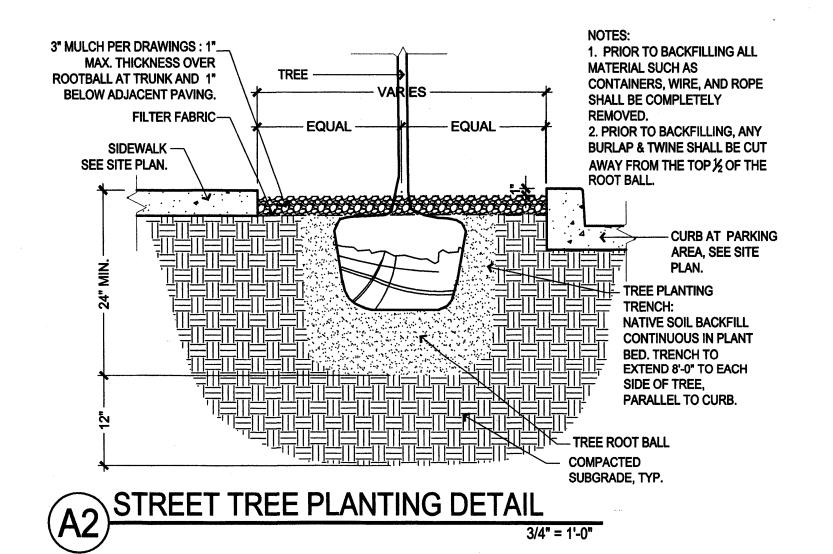
2 6/11/08 DRB Comments


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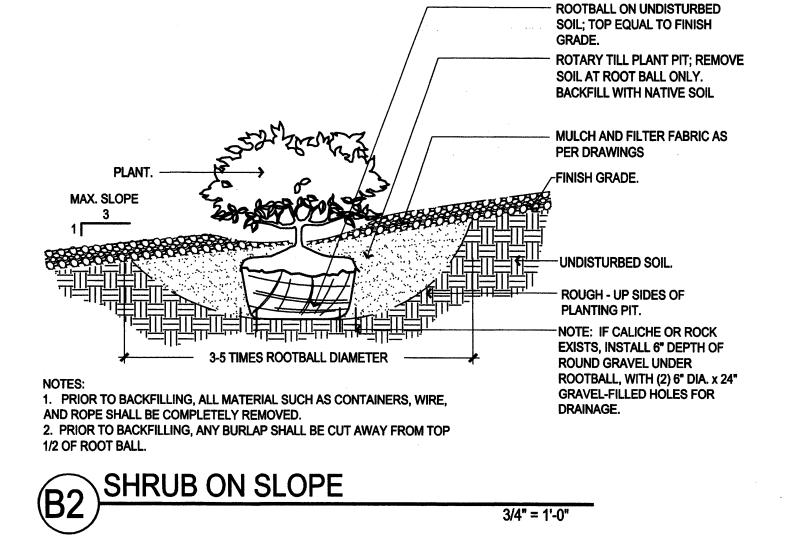
LANDSCAPE PLAN


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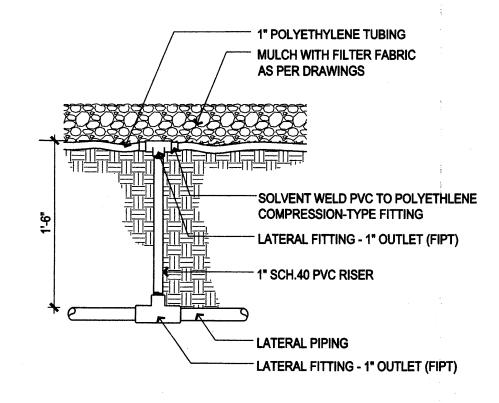








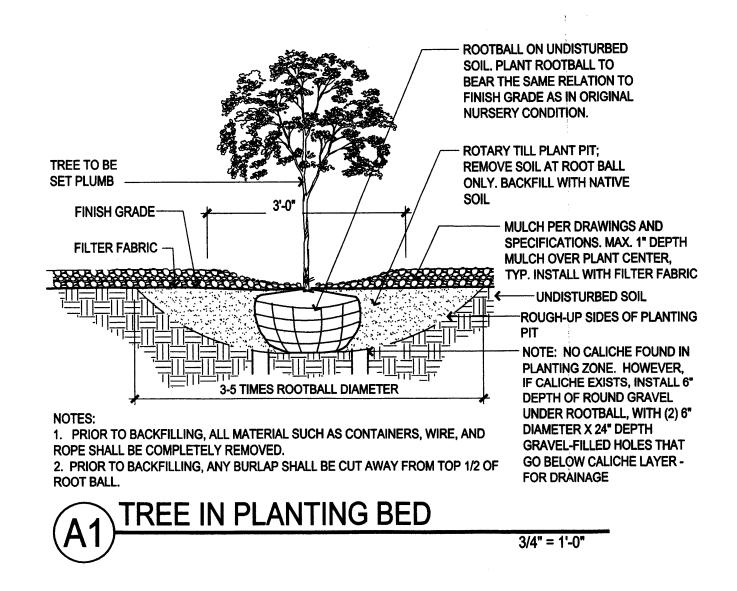

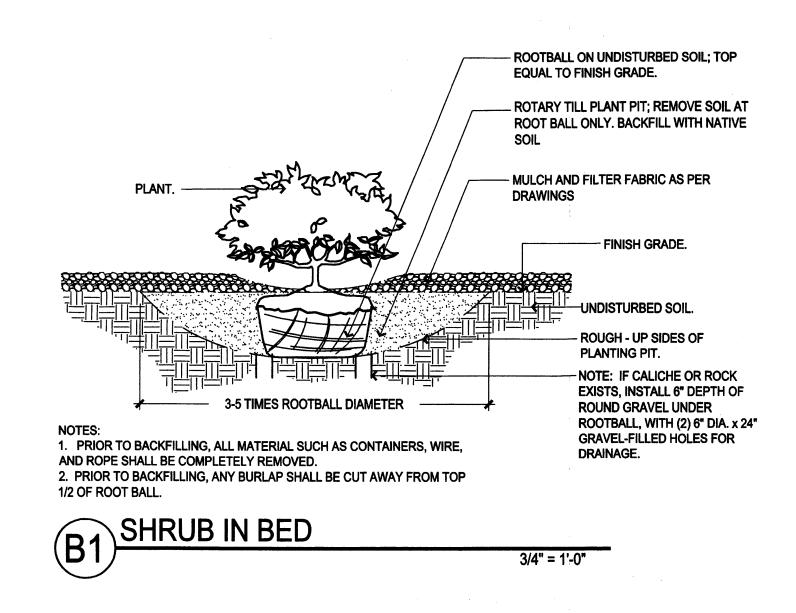

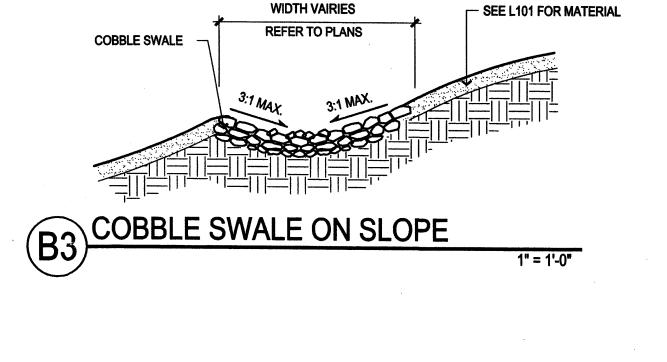

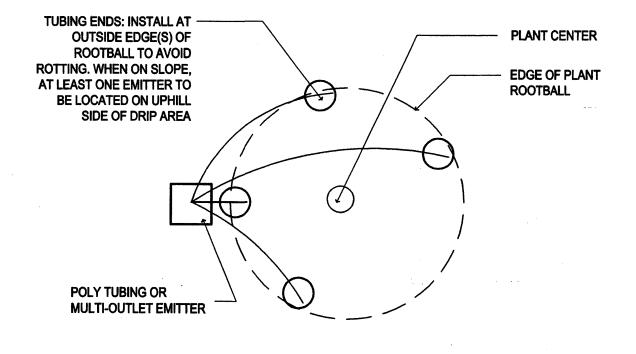

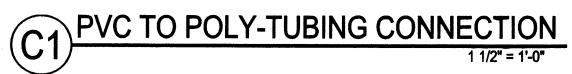



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Dekker Perich Sabatini

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Riley & Shane Law Offices 3880 Osuna Road Albuquerque, New Mexico

REVISIONS


5/6/08 DRB Comments

DRAWN BY KP
REVIEWED BY MB
DATE Feb. 15, 2008
PROJECT NO. 07-0092
DRAWING NAME

LANDSCAPE DETAILS

SHEET NO

L20'

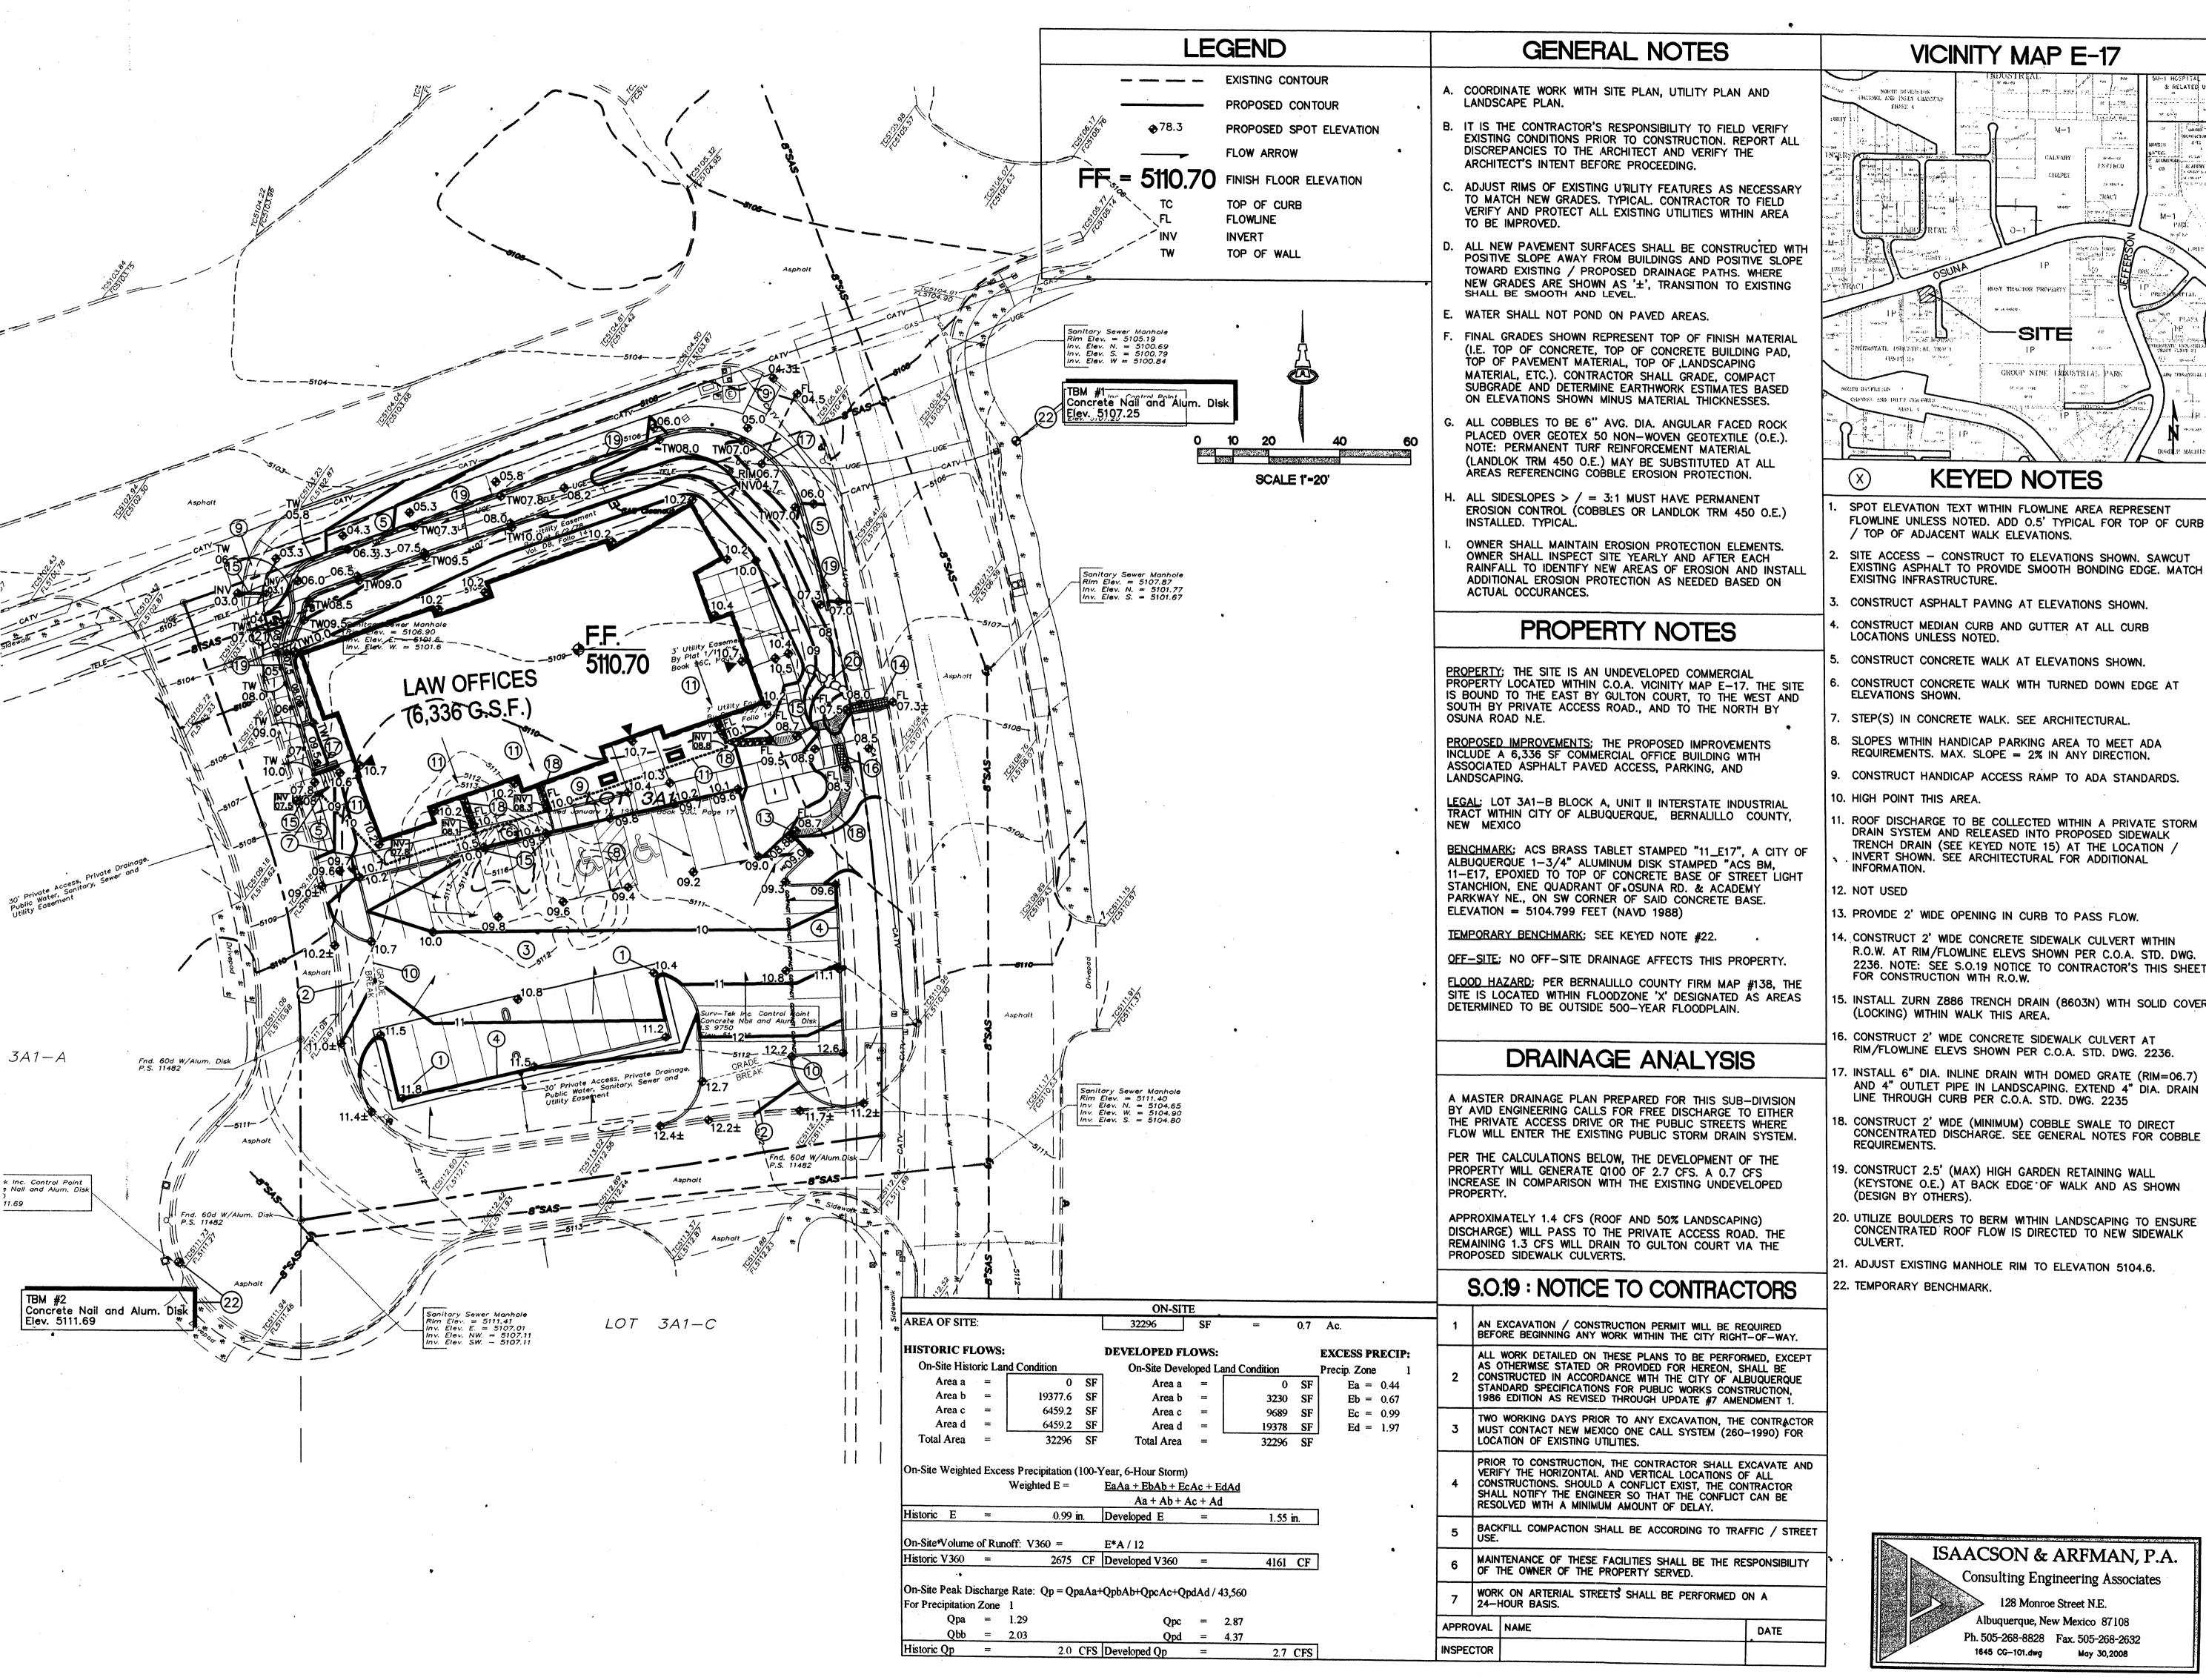

VICINITY MAP E-17

GROUP NINE LABOUSTRIAL PARK


KEYED NOTES

architecture landscape planning engineering

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ARCHITECT

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PROJECT

ROOF DISCHARGE TO BE COLLECTED WITHIN A PRIVATE STORM DRAIN SYSTEM AND RELEASED INTO PROPOSED SIDEWALK TRENCH DRAIN (SEE KEYED NOTE 15) AT THE LOCATION / INVERT SHOWN. SEE ARCHITECTURAL FOR ADDITIONAL

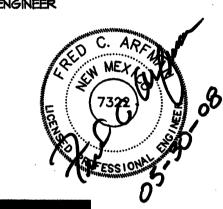14. CONSTRUCT 2' WIDE CONCRETE SIDEWALK CULVERT WITHIN R.O.W. AT RIM/FLOWLINE ELEVS SHOWN PER C.O.A. STD. DWG. 2236. NOTE: SEE S.O.19 NOTICE TO CONTRACTOR'S THIS SHEET

FOR CONSTRUCTION WITH R.O.W. 5. INSTALL ZURN Z886 TRENCH DRAIN (8603N) WITH SOLID COVER

(LOCKING) WITHIN WALK THIS AREA.

16. CONSTRUCT 2' WIDE CONCRETE SIDEWALK CULVERT AT RIM/FLOWLINE ELEVS SHOWN PER C.O.A. STD. DWG. 2236.

7. INSTALL 6" DIA. INLINE DRAIN WITH DOMED GRATE (RIM=06.7) AND 4" OUTLET PIPE IN LANDSCAPING. EXTEND 4" DIA. DRAIN LINE THROUGH CURB PER C.O.A. STD. DWG. 2235

18. CONSTRUCT 2' WIDE (MINIMUM) COBBLE SWALE TO DIRECT CONCENTRATED DISCHARGE. SEE GENERAL NOTES FOR COBBLE REQUIREMENTS.

19. CONSTRUCT 2.5' (MAX) HIGH GARDEN RETAINING WALL (KEYSTONE O.E.) AT BACK EDGE OF WALK AND AS SHOWN (DESIGN BY OTHERS).

20. UTILIZE BOULDERS TO BERM WITHIN LANDSCAPING TO ENSURE CONCENTRATED ROOF FLOW IS DIRECTED TO NEW SIDEWALK

21. ADJUST EXISTING MANHOLE RIM TO ELEVATION 5104.6.

22. TEMPORARY BENCHMARK.

DRAWN BY REVIEWED BY DATE May 30, 2008

REVISIONS


PROJECT NO. 07-0092 DRAWING NAME DRAINAGE AND **GRADING PLAN**

ISAACSON & ARFMAN, P.A. Consulting Engineering Associates 128 Monroe Street N.E. Albuquerque, New Mexico 87108 Ph. 505-268-8828 Fax. 505-268-2632 1645 CG-101.dwg May 30,2008

SHEET NO.

BJB

FCA

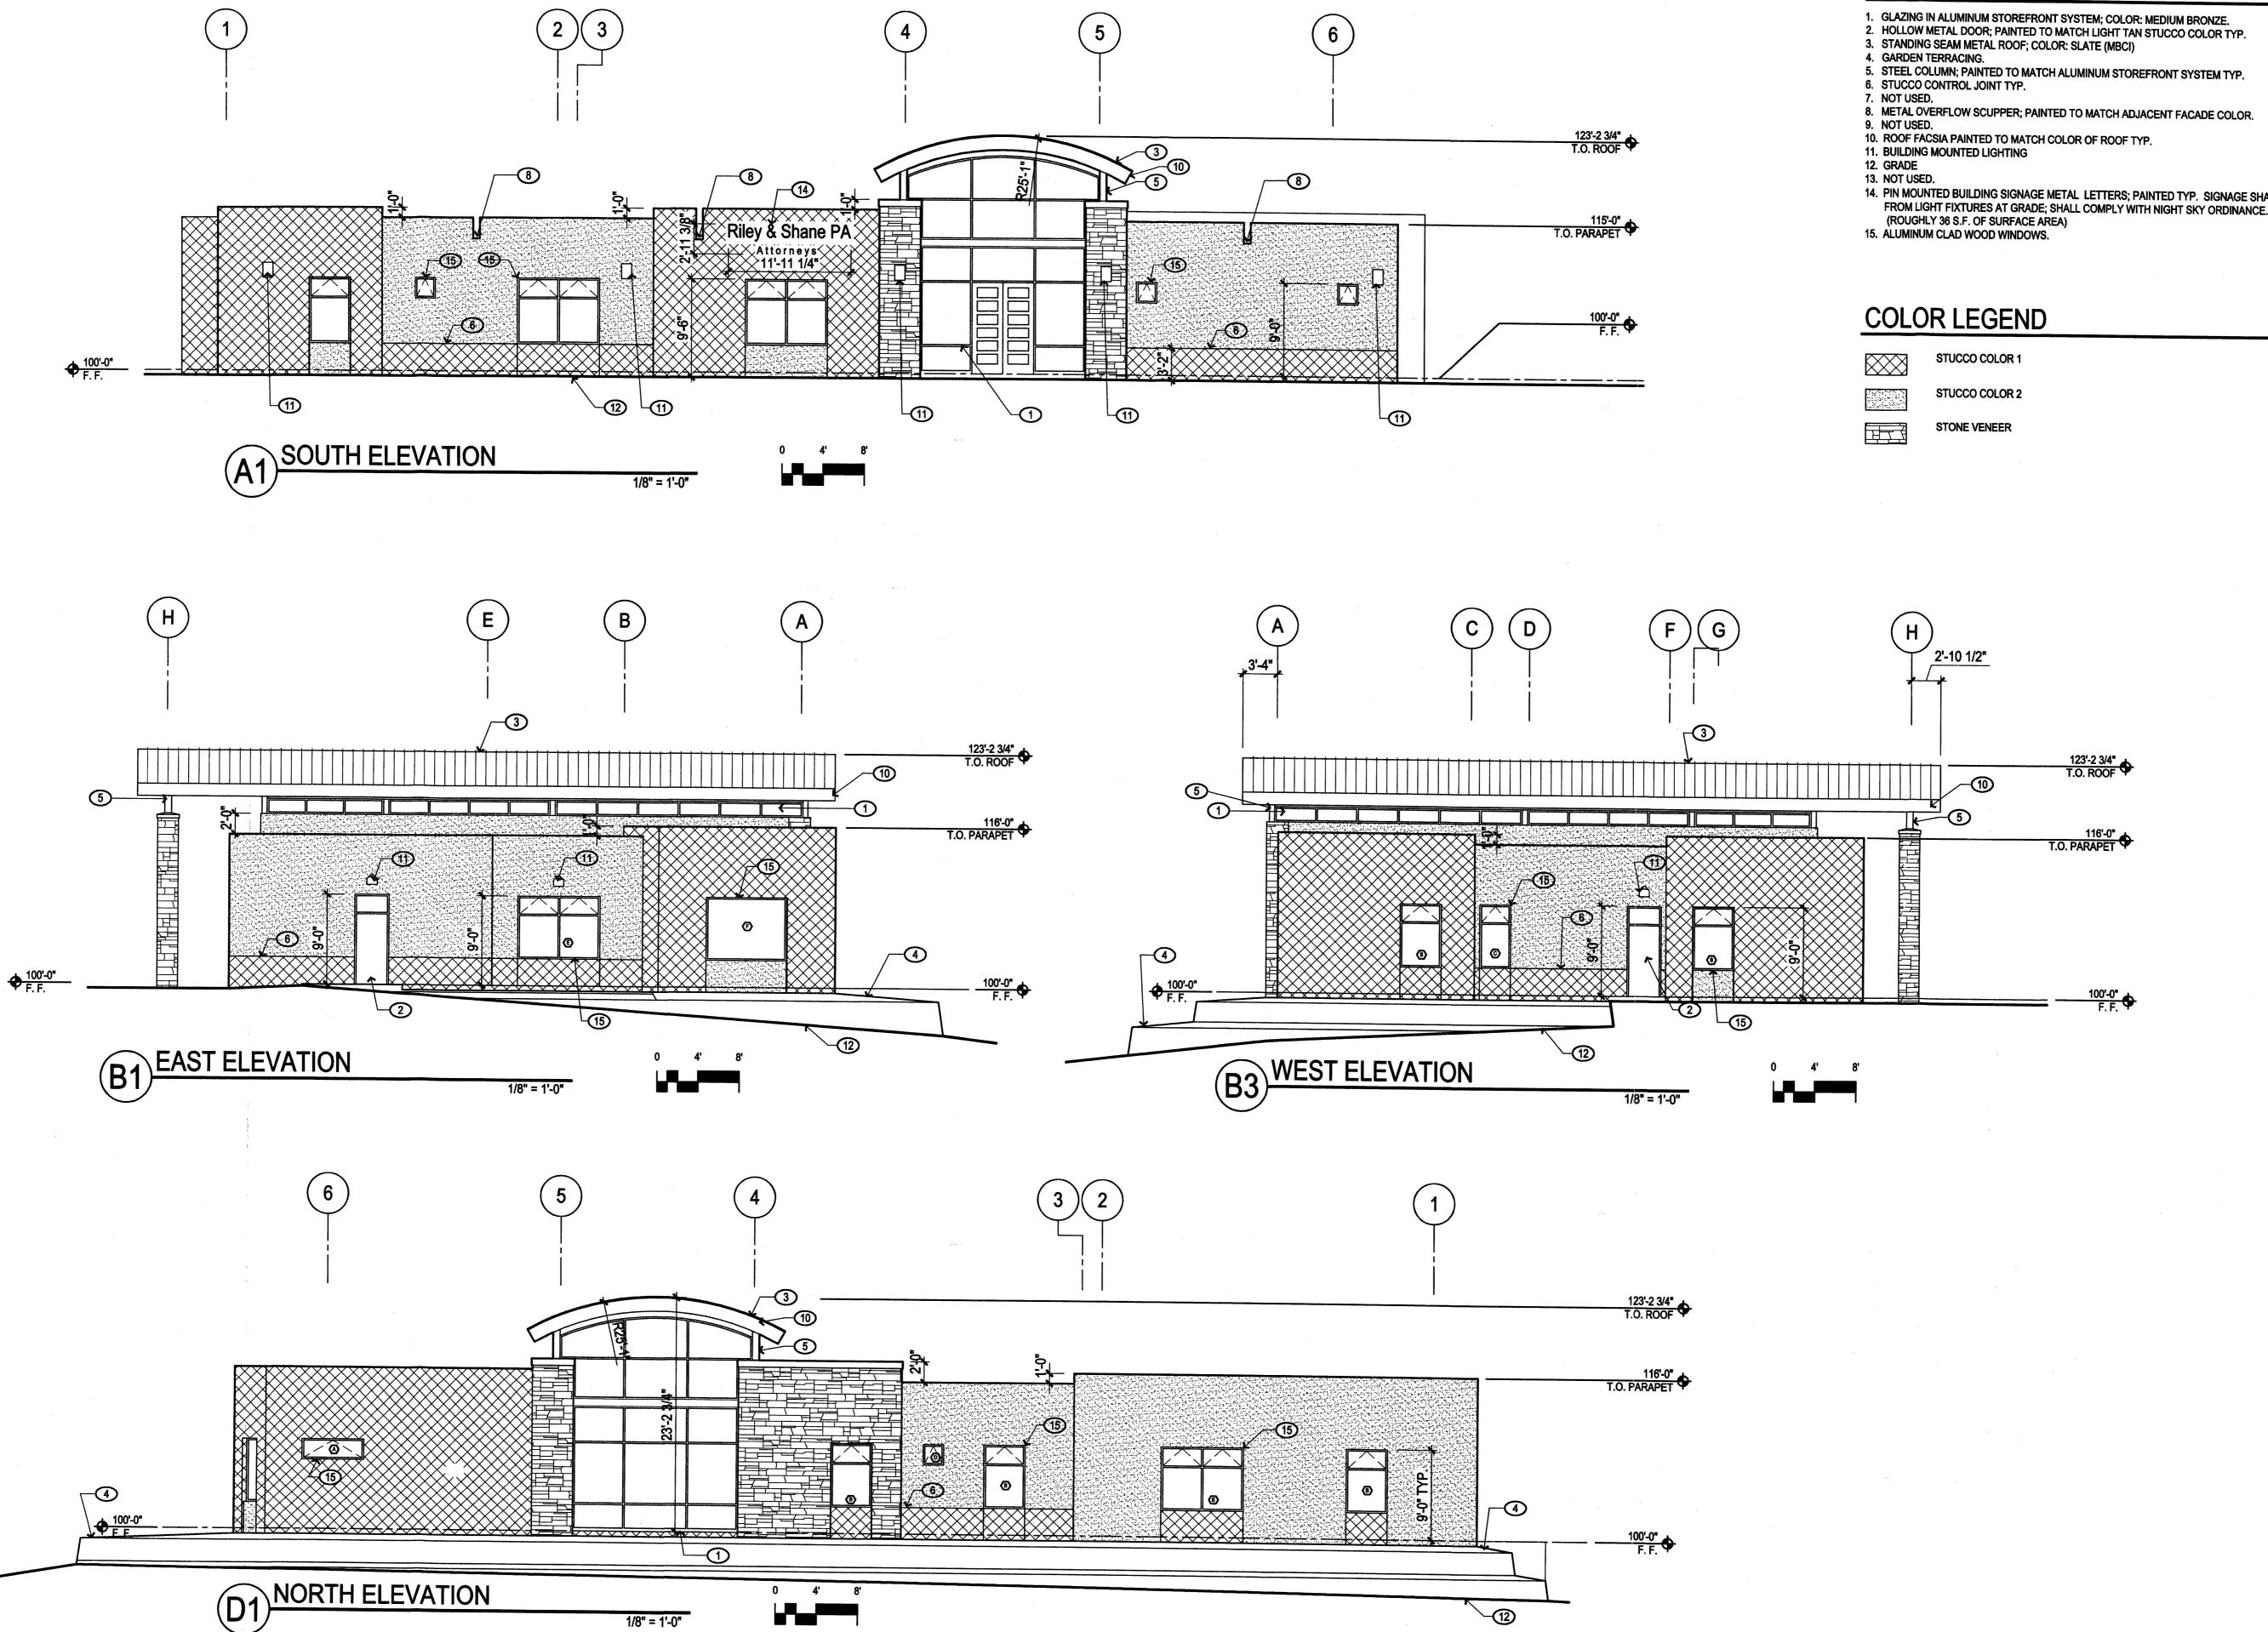

1/8" = 1'-0"

KEYED NOTES O

14. PIN MOUNTED BUILDING SIGNAGE METAL LETTERS; PAINTED TYP. SIGNAGE SHALL BE LIT FROM LIGHT FIXTURES AT GRADE; SHALL COMPLY WITH NIGHT SKY ORDINANCE.

> DRB SUBMITTAL

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ARCHITECT

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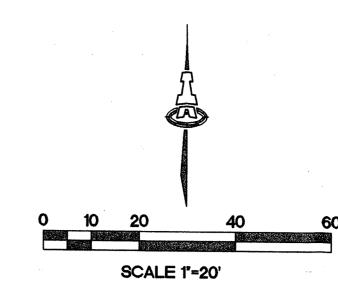
Riley

REVISIONS	
5/07/2608	BEBENDUMANS.
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DRAWN BY	CRG, KK, NS
REVIEWED BY	CRG
DATE	Jan. 22, 2008
PROJECT NO.	07-0092
DRAWING NAME	

EXTERIOR ELEVATIONS

A301



KEYED NOTES

- 1. CONTRACTOR TO FIELD VERIFY LOCATION OF EXISTING GAS LINE.
- 2. ¾" WATER METER PER COA STD DWG #2361.
- 1½" WATER SERVICE LINE FROM PRIVATE SIDE OF METER TO BUILDING.
- GAS SERVICE LINE. COORDINATE WITH PNM & GAS. NEW SERVICE FOR LINE SIZE.
- CONSTRUCT 4" SAS SERVICE LINE FROM EXISTING SAS CLEANOUT TO BUILDING.
- 6. REMOVE AND REPLACE 2 SY ASPHALTIC PAVING AT WATER SERVICE CONNECTION.



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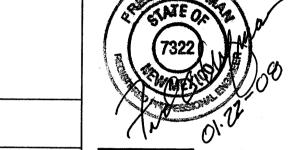
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ENGINEER

PROJECT

GENERAL NOTES

- CONSTRUCT SAS SERVICES PER COA STD DWG
- 2. CONSTRUCT ALL SINGLE & DOUBLE WATER SERVICES PER COA STD DWG #2361, #2362, &
- 3. SEE SHEET # FOR WATER SHUT-OFF PLAN.
- 4. SEE SHEET # FOR RESTRAINED JOINT LENGTHS FOR WATER LINE FITTINGS.
- CONSTRUCT FIRE HYDRANTS PER DESIGNATED DEPTHS & LENGTHS PER COA STD DWG #2340.
- SEE COA STD DWG #2328 FOR VALVE RING & COVER DETAIL. SEE COA STD DWG #2326 FOR VALVE BOX DETAIL.

LEGEND

- SINGLE WATER METER & BOX GATE VALVE W/ VALVE BOX
- FIRE HYDRANT
- SAS MANHOLE (EXISTING) WATER LINE W/ FITTING
- EXISTING CABLE T.V. LINE
 - EXISTING UNDERGROUND ELECTRIC LINE(S)
- G · · G- EXISTING GAS LINE

ONSITE RETAINING WALL

REVISIONS \triangle

> DRAWN BY REVIEWED BY DATE

3880 Osuna Ros Albuquerque, New N

Shane

PROJECT NO. DRAWING NAME

UTILITY PLAN

SHEET NO.

C002

07-0092

ISAACSON & ARFMAN, P.A. Consulting Engineering Associates 128 Monroe Street N.E. Albuquerque, New Mexico 87108 Ph. 505-268-8828 Fax. 505-268-2632 1645 CU-101.dwg Jan 22,2008