CONSTRUCTION NOTES

- 1. CONSTRUCT NEW PAVEMENT PER DETAIL 11, SHEET C-501.
- 2. CONSTRUCT 4' CURB OPENING.
- 3. CONSTRUCT CONCRETE DOLLY PAD PER DETAIL 10, SHEET C-501.
- 4. CONSTRUCT TRASH ENCLOSURE PER DETAIL 1 SHEET A1-1.
- 5. CONSTRUCT BOLLARDS PER DETAIL 4, SHEET A1-1.
- 6. INSTALL HEADER CURB PER DETAIL 6, SHEET C-501.
- 7. CONSTRUCT 12'x 84' CONCRETE PAD PER DETAIL 10, SHEET C-501.
- 8. INSTALL VAN ACCESSIBLE ADA PARKING PER DETAILS 1, 2 & 3, SHEET C-501.
- 9. INSTALL PARKING STRIPING PER DETAILS 2 & 4, SHEET C-501.
- 10. INSTALL PRECAST BUMPER BLOCKS PER DETAIL 5, SHEET C-501.
- 11. INSTALL NEW CHAIN LINK SWING GATES.
- 12. LANDSCAPE AREA SEE LANDSCAPE PLANS.

LEGEND

EXISTING COMMUNICATION PEDESTAL EXISTING NTUA GAS WARNING SIGN EXISTING FOUND 5/8" REBAR W/O CAP
EXISTING FOUND PK MAG, CONCRETE NAIL
EXISTING UTILITY POLE
EXISTING TRANSMISSION LINE POLE

EXISTING WATER VALVE

EXISTING FIRE HYDRANT S EXISTING SEWER MANHOLE EXISTING TELEPHONE BURIED CABLE WARNING SIGN


 EXISTING STORM DRAINAGE MANHOLE EXISTING LIGHT POLE

PROPOSED ASPHALT PROPOSED CONCRETE


PARKING CALCULATIONS

PARKING REQUIRED: = 7 SPACES OFFICE 1,326 SF/200 WAREHOUSE 6,056 SF/2000 = 4 SPACES TOTAL REQUIRED = 11 SPACES

PARKING PROVIDED = 16 SPACES INCLUDING 1 VAN ACCESSIBLE SPACE

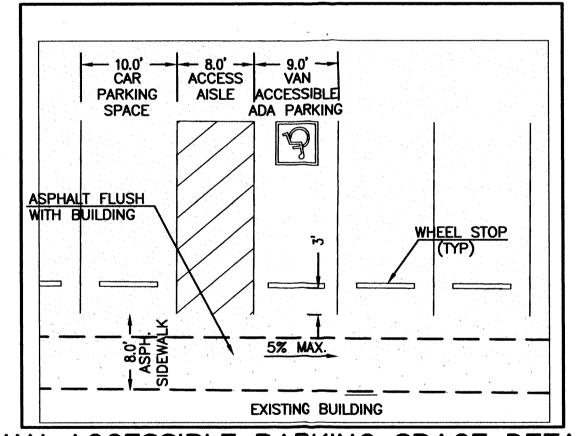

VAN ACCESSIBLE PARKING SPACE DETAIL

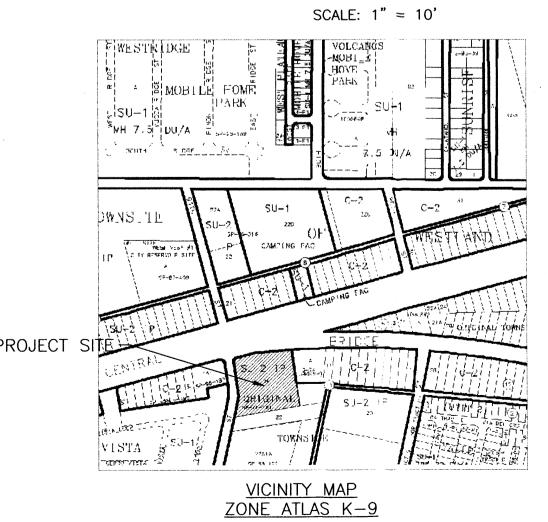

CITY OF ALBUQUERQUE "SOLID WASTE"

MANAGEMENT DEPARTMENT

APPROVED




0 15' 30'

SCALE: 1" = 30

SHEET NUMBER

C-101

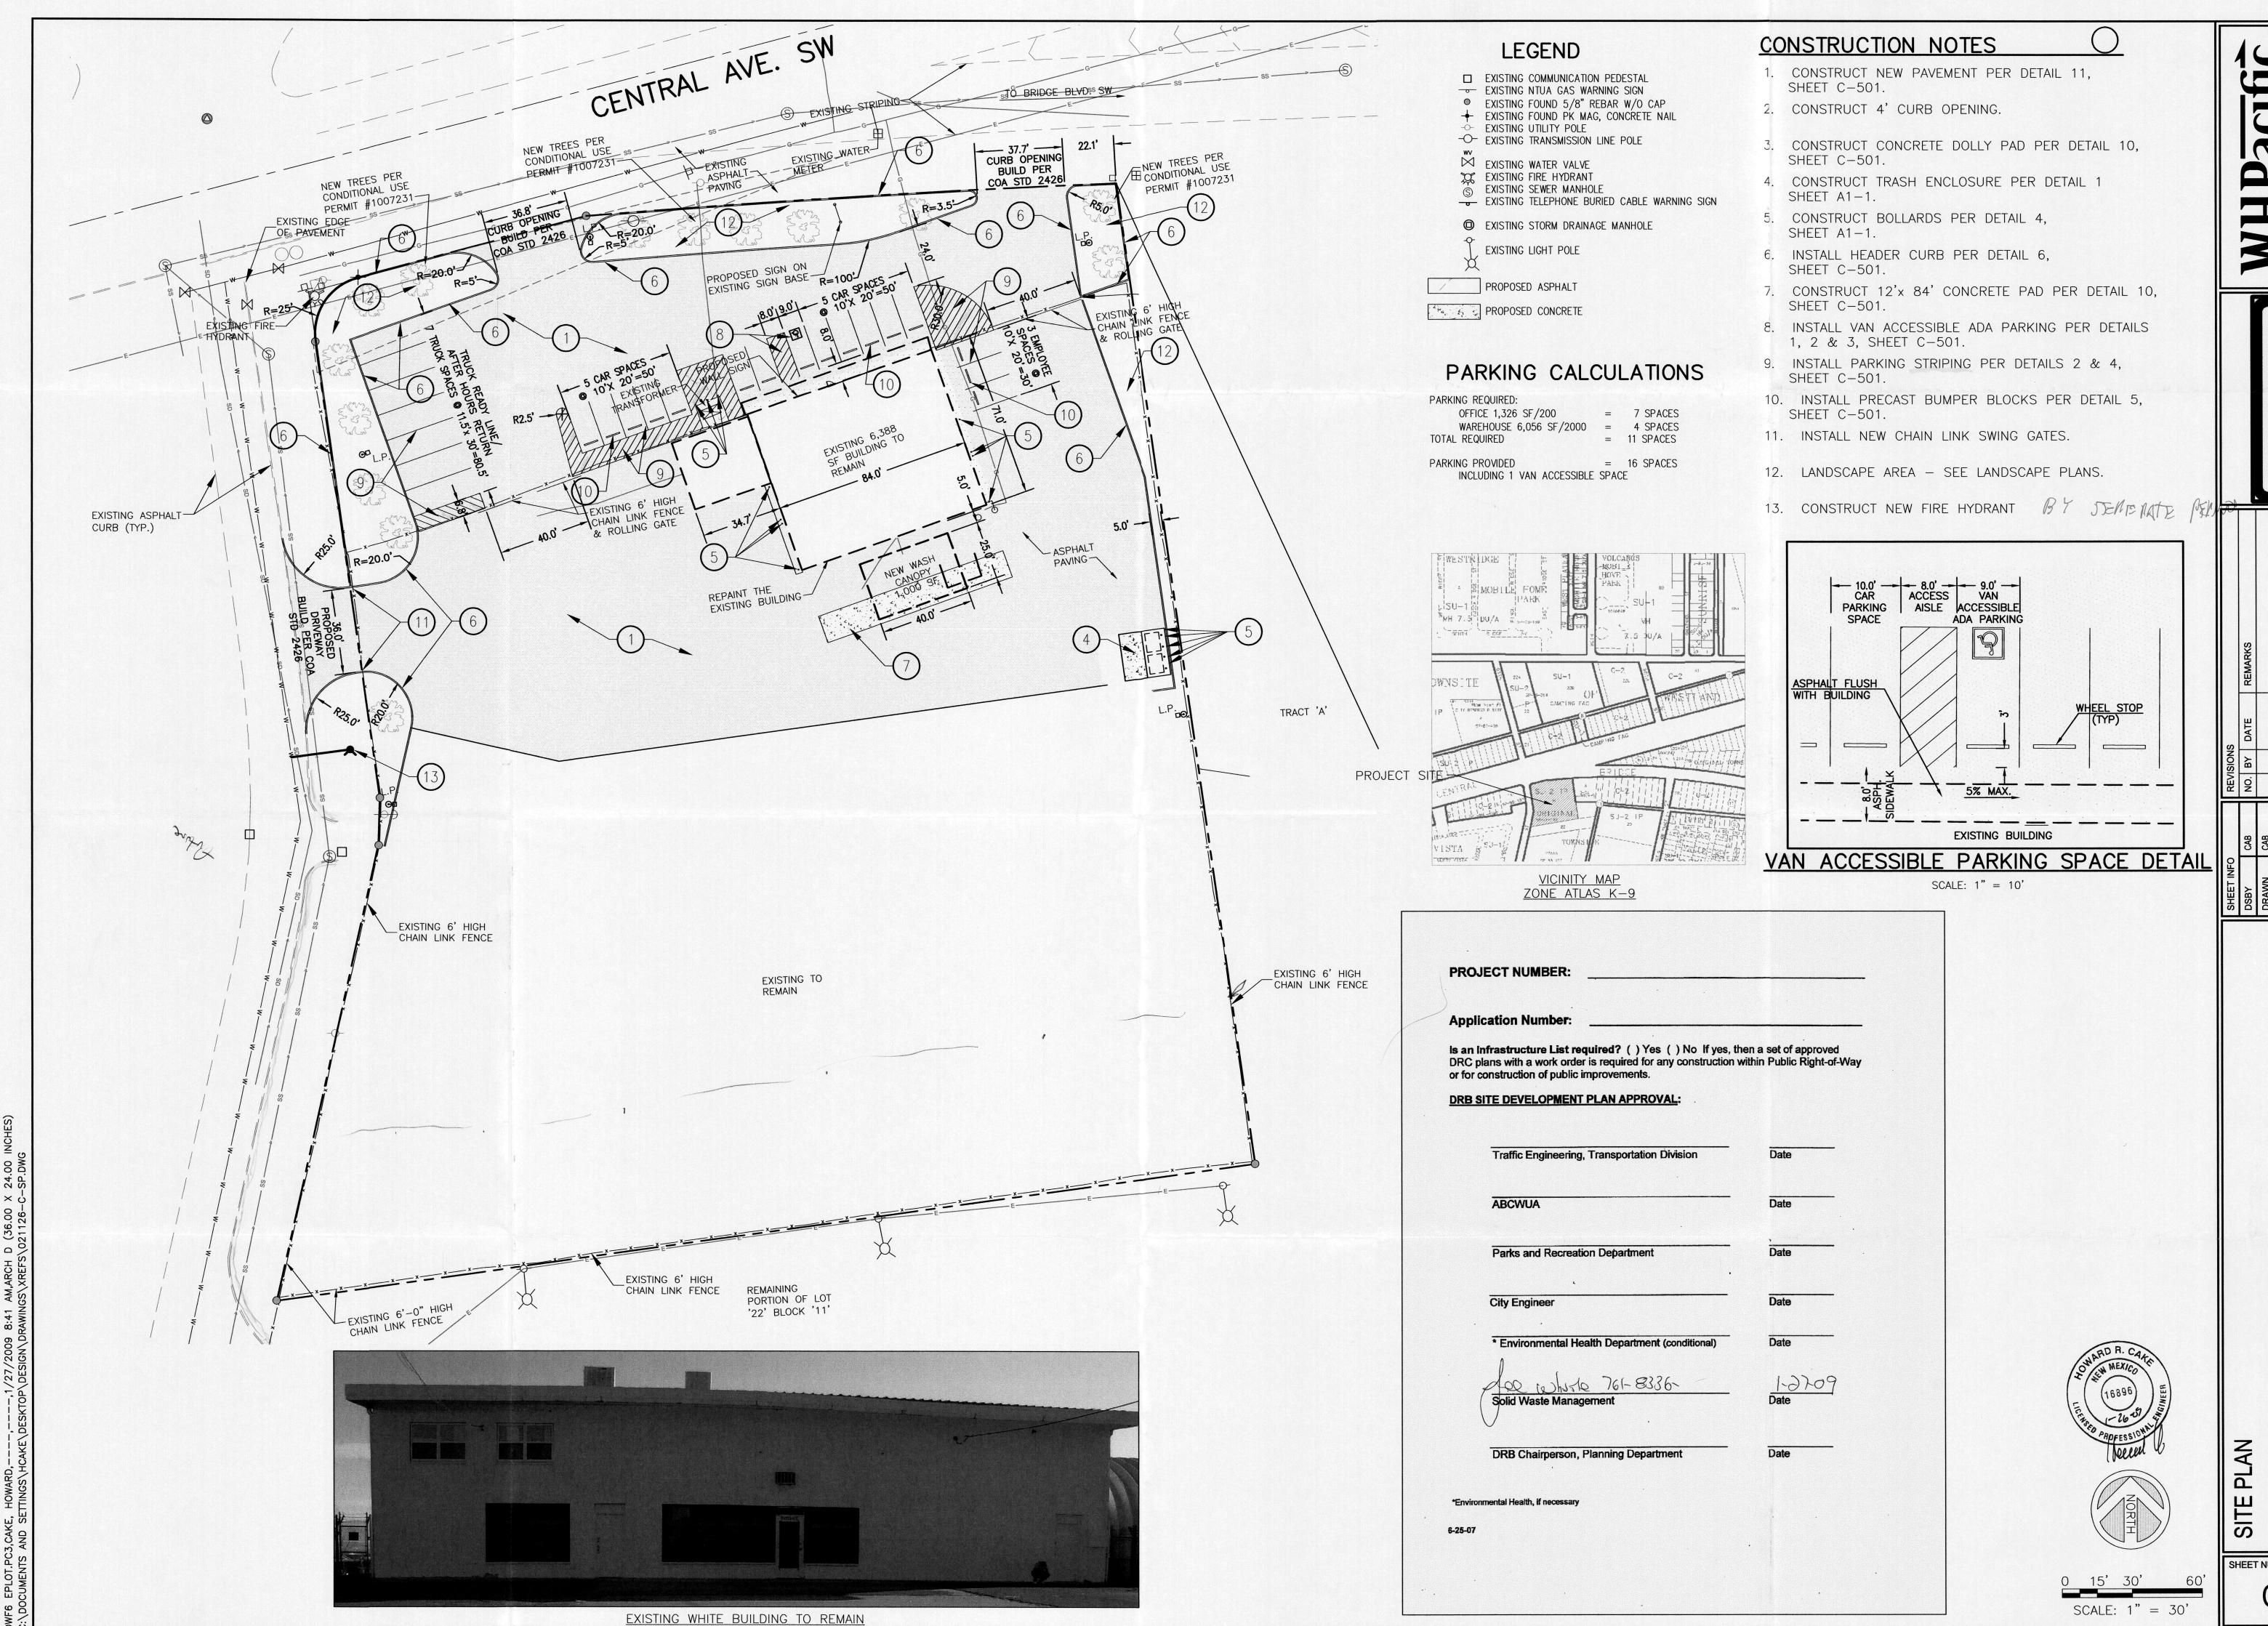

6501 Americas Pkwy NE , Suite 400 Albuquerque, NM 87110 505-247-0294 Fax 505-242-4845 www.whpacific.com

PENSKE

 DSBY
 CAB
 NO. BY
 DATE
 REMARKS

 DRAWN
 CAB
 CHECKED
 HC
 H

SCALE 1" = 30'


E TRUCK LEASING

JPGRADES FOR PENS ENTRAL S.W. RQUE, NM

FACILITY UPGRADES 9200 W. CENTRAL S.\ ALBUQUERQUE, NM

T NUMBER

C-101

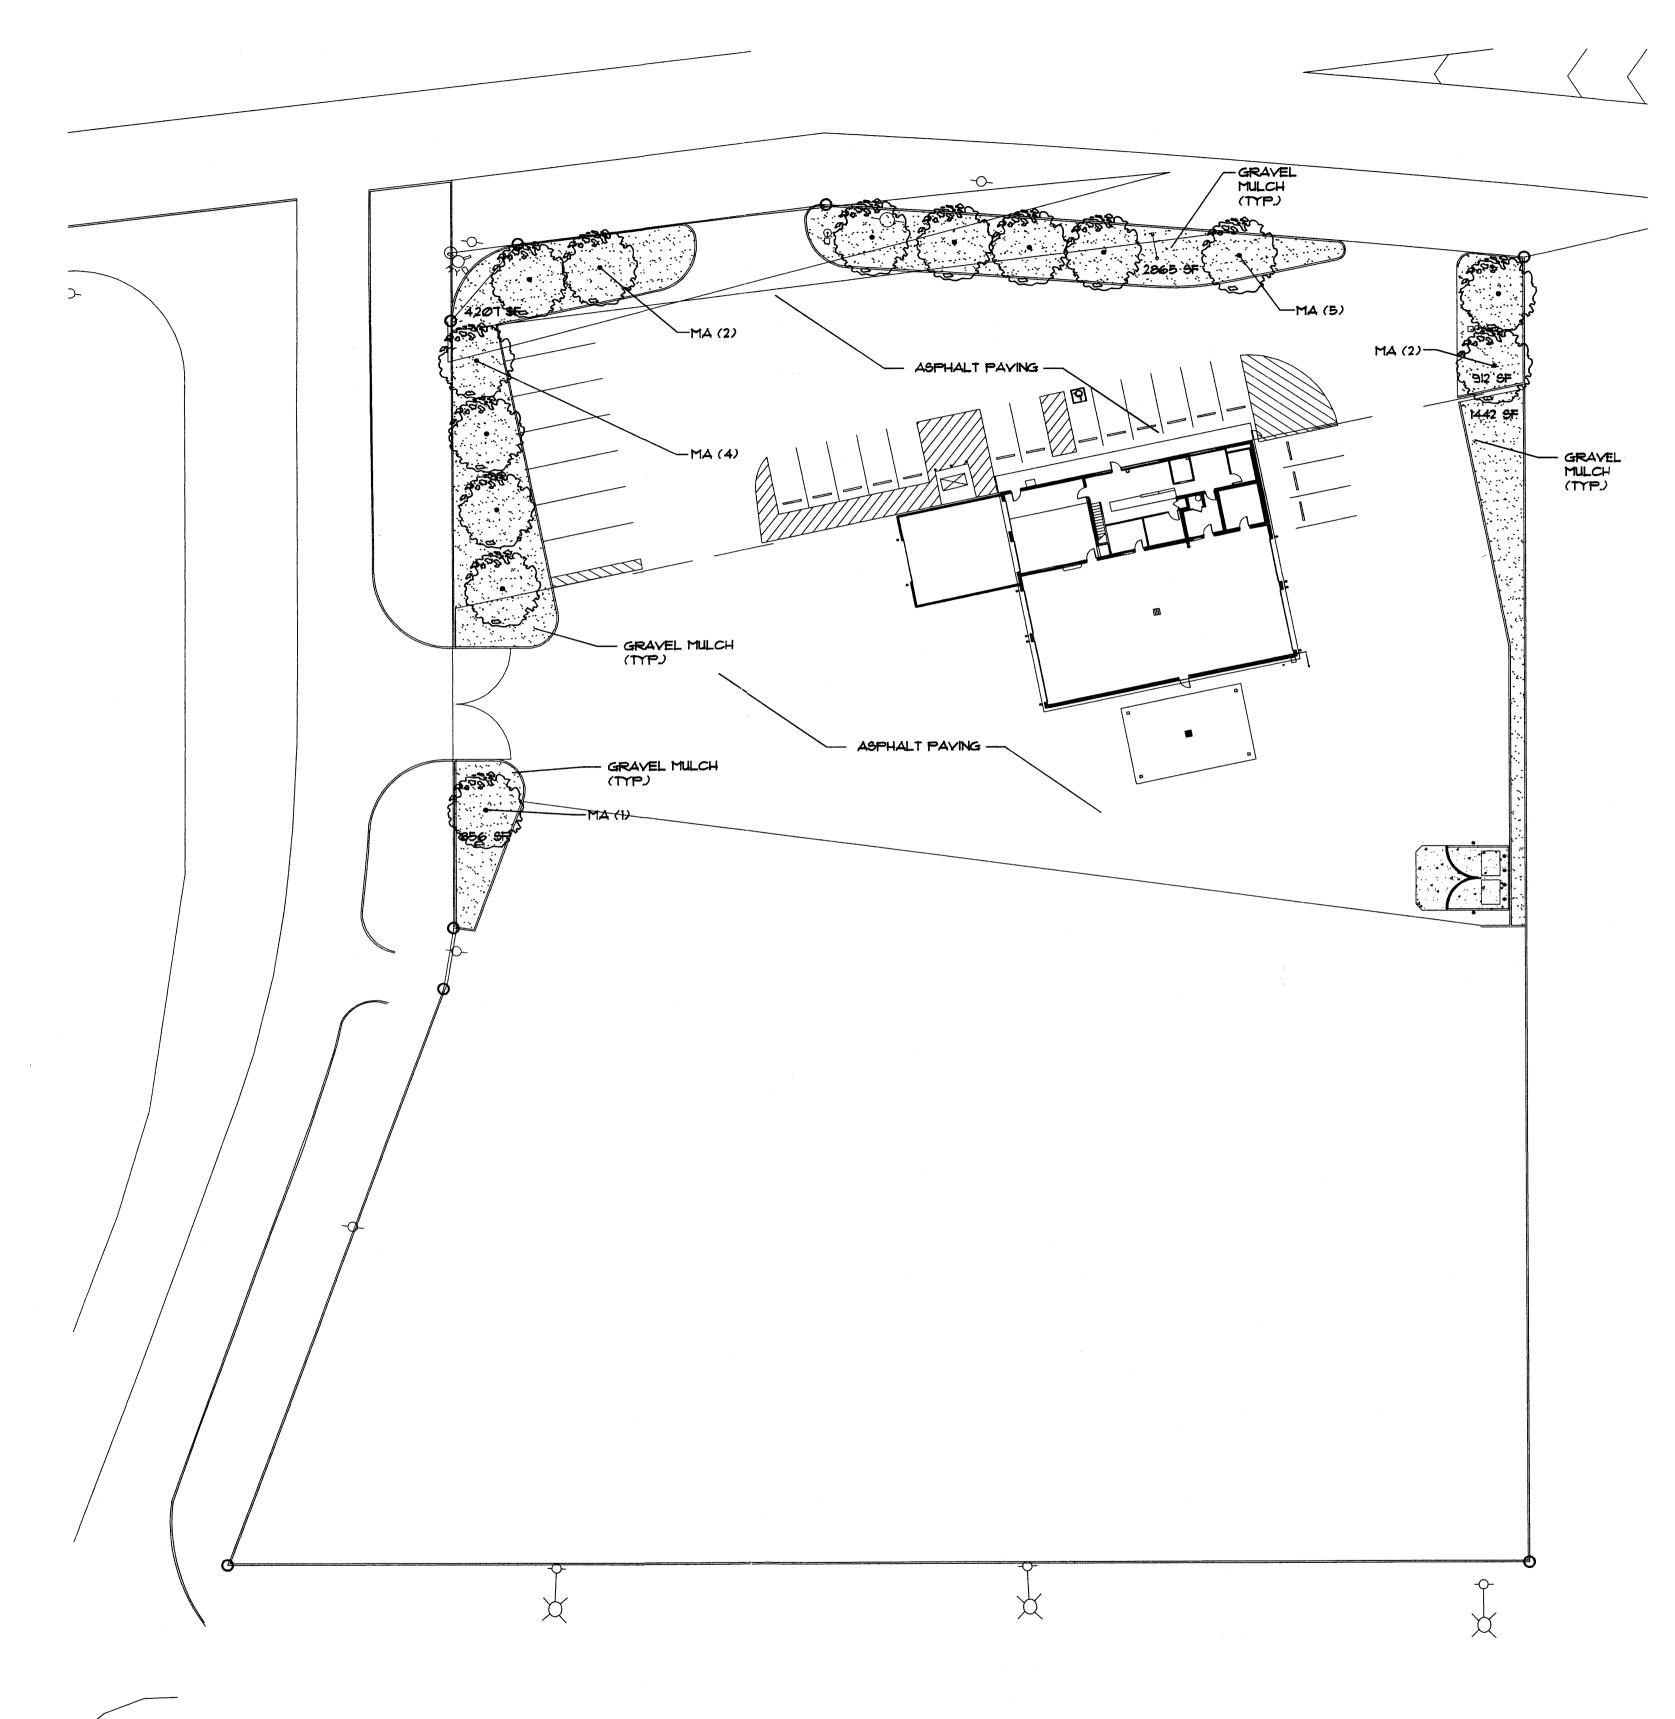

PLANT SCHEDULE					
KEY	COMMON NAME	BOTANICAL NAME	QUANTITY	SIZE	REMARKS
TREES					
MA	Modesto Ash	Fraxinus velutina 'Modesto'	14	2" cal., 12'-14' ht.	30" Box

PLANTING NOTES

- IN CASE OF DISCREPANCY IN PLANT QUANTITIES SHOWN ON THE PLANT LIST AND THOSE SHOWN ON THE PLANTING PLAN, THE QUANTITIES SHOWN ON THE PLAN SHALL GOVERN. CONTRACTOR SHALL VERIFY ALL QUANTITIES PRIOR TO BID AND INSTALLATION. NO ADDITIONAL PAYMENT WILL BE MADE FOR ANY DISCREPANCIES IN QUANTITIES BETWEEN THE PLANTING PLAN AND THE PLANT
- GRAVEL MULCH SHALL BE A 3" DEPTH OF 3/4" "SANTA FE BROWN," OR EQUAL GRAVEL MULCH WITH FILTER FABRIC UNDER GRAVEL MULCH SHALL BE INSTALLED THROUGHOUT PLANTING BEDS AND PERIMETER AREAS AS SHOWN ON PLAN. FILTER FABRIC SHALL BE MIN. 4 OZ. WOYEN NEEDLE PUNCHED POLYPROPLYENE (DEWITT OR EQUIVALENT). OVERLAP ENDS 3", TURN DOWN EDGES 6".
- THE CONTRACTOR SHALL PRUNE LOWER BRANCHES OF DECIDUOUS TREES TO 6 FEET ABOVE FINISH GRADE.
- IF THERE IS A DISCREPANCY IN THE FIELD OR NURSERY BETWEEN THE CONTAINER SIZE CALLED OUT UNDER "REMARKS" AND HEIGHT & SPREAD CALLED OUT UNDER "SIZE", THE SPECIFIED PLANT MUST MEET HEIGHT & SPREAD REQUIREMENTS SPECIFIED UNDER "SIZE", EVEN IF THE LARGER CONTAINER SIZE IS REQUIRED TO MEET THESE SPECIFICATIONS, AT NO ADDITIONAL COST TO THE
- 5. TREES SHALL BE PLANTED PER DETAIL A/L3.

LANDSCAPE REQUIREMENTS

PER SECTION 14-16-3-10 (E) OF THE CITY OF ALBUQUERQUE LANDSCAPE REGULATIONS, NOT LESS THAN 15% OF THE NET LOT AREA SHALL BE LANDSCAPE. NET LOT SIZE = 64817 SQUARE FEET. IANDSCAPE REQUIREMENT, THEREFORE, IS 9723 SQUARE FEET.

10287 SQUARE FEET OF LANDSCAPING ARE PROVIDED IN THIS PLAN.


SUITE 102 SCOTTSDALE, ARIZONA 85260 (480) 443-3705 - TEL. DRAWN BY: CHECKED BY

PROJECT NO:

7585 E. REDFIELD RD.




PENSKE TRUCK LEAS 9200 W. CENTRAL AVE ALBUQUERQUE, NI FACILITY UPGR

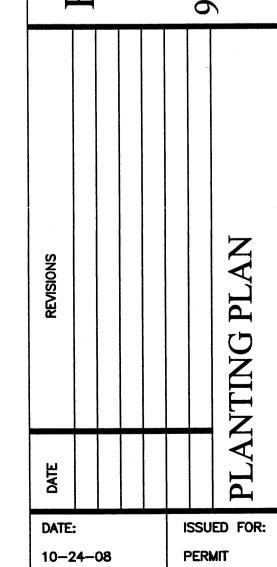

10-24-08

SHEET NO:

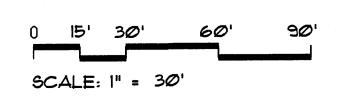






N.T.S.

N.T.S.

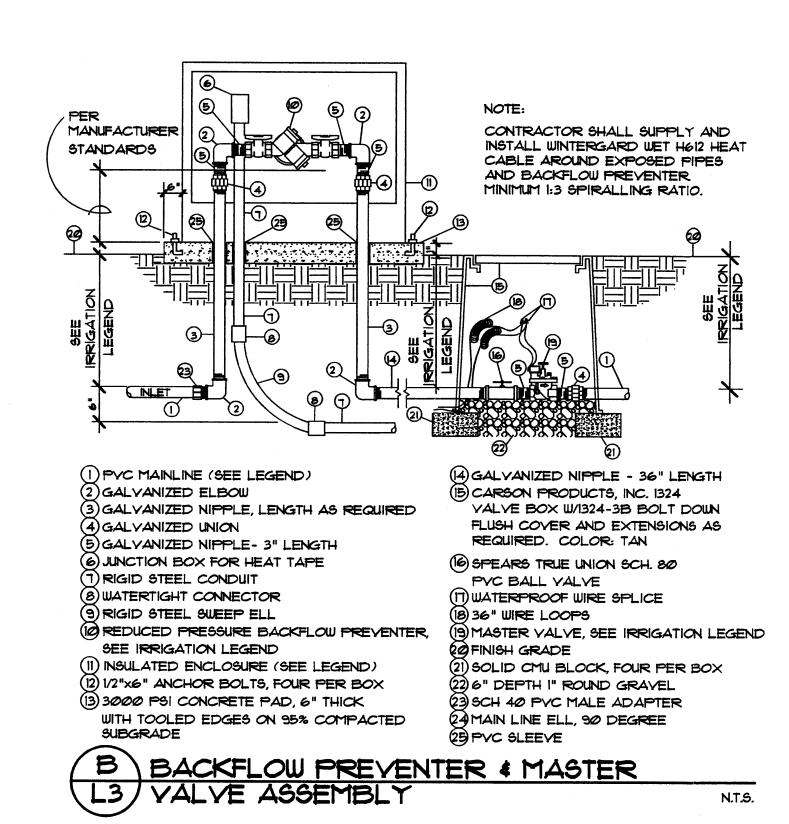

2-1

PRESSURE COMPENSATING BUBBLER (SEE LEGEND)

1/2" SCH. 80 PYC THREADED NIPPLE, LENGTH AS REQUIRED LASCO 1/2" UNITIZED SWIVEL JOINT #T522-212

PVC LATERAL PIPING.

N.T.S.

TOP OF MULCH, SEE PLANTING NOTES FOR DEPTH OF MULCH

GENERAL NOTES:

BUBBLER SHALL BE LOCATED AS NOTED ON IRRIGATION PLAN. BUBBLER SHOULD BE NO FURTHUR THAN 12" FROM ROOT BALL OF TREE AND 6" FROM ROOT BALL OF SHRUB.

BUBBLER ASSEMBLY MCD-0008

(1) MANUAL VALVE (SEE LEGEND) SCH. 80 PVC THREADED NIPPLE - 3" LENGTH (8) CARSON 1730-18 VALVE BOX SPEARS SCH. 80 PVC THREADED UNION SCH. 40 PVC MALE ADAPTER MAINLINE PIPE (SEE LEGEND) 6 CMU BLOCK - 4 PER VALVE BOX

(1) 6" DEPTH I" ROUND GRAVEL W/ BOLT DOWN COVER AND 8" EXTENSIONS AS REQUIRED. VALVE BOX SHALL BE INSTALLED FLUSH WITH TOP OF GRAVEL MULCH. (9) TOP OF GRAVEL MULCH

C GATE VALVE ASSEMBLY MCD-0053 092303

N.T.S.

AUTOMATIC CONTROLLER (SEE LEGEND) EYE LEVEL

120 YOLT WIRE CONDUIT 24 YOLT WIRE CONDUIT

CONTROLLER SHALL BE MOUNTED SECURELY TO WALL USING APPROPRIATE FASTENERS FOR WALL TYPE. ALL EXPOSED CONDUIT SHALL BE EM.T. OR EQUAL AND APPROVED BY LOCAL CODES.
ALL CONDUIT CONNECTIONS SHALL BE MADE USING WATERTIGHT CONNECTORS.

WALL MOUNT AUTOMATIC CONTROLLER







7585 E. REDFIELD RD.

(480) 443-3705 - TEL.

SCOTTSDALE, ARIZONA 85260

SUITE 102

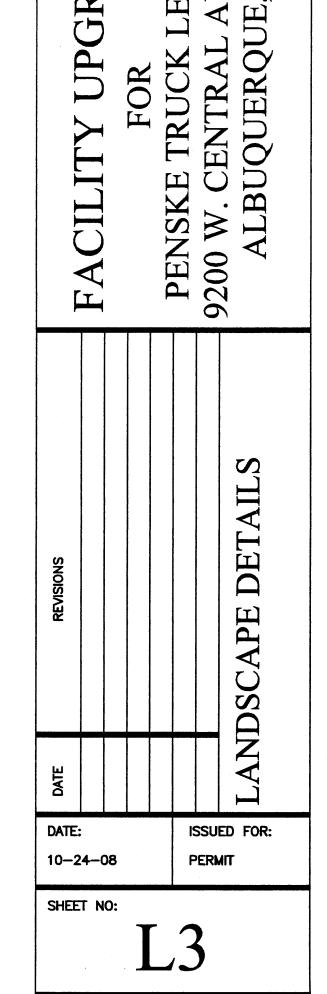

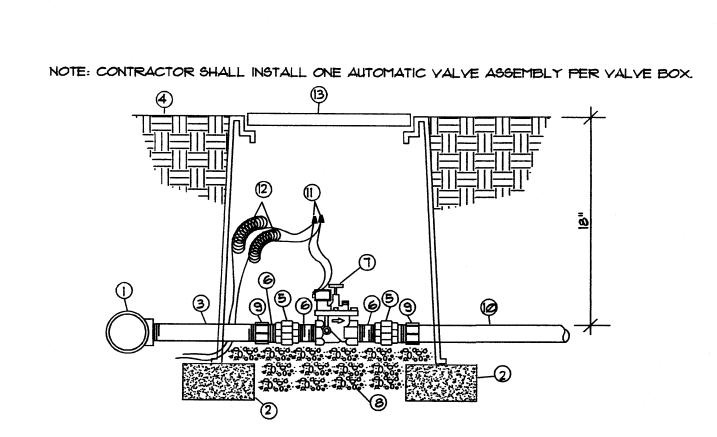

1 MAINLINE SERVICE TEE (LATERAL PIPING (SEE LEGEND) 2) SOLID CMU BLOCK (FOUR PER BOX) (II) WATERPROOF WIRE CONNECTOR (3) SCH. 80 PVC NIPPLE,


LENGTH AS REQUIRED (4) TOP OF GRAVEL MULCH

MCD-0002 110795

(5) SPEARS SCH. 80 PVC UNION 6) SCH. 80 PVC NIPPLE - 3" LENGTH AUTOMATIC VALVE (SEE LEGEND) 8 6" DEPTH I" ROUND GRAVEL 9 SCH. 40 PVC MALE ADAPTER

36" WIRE EXPANSION LOOPS (13) CARSON 1730-18 VALVE BOX YALVE BOX W/ BOLT DOWN FLUSH COVER W/ ONE 8" EXTENSION. VALVE BOX SHALL BE INSTALLED FLUSH WITH TOP OF GRAVEL.

AUTOMATIC VALVE ASSEMBLY MCD-0013

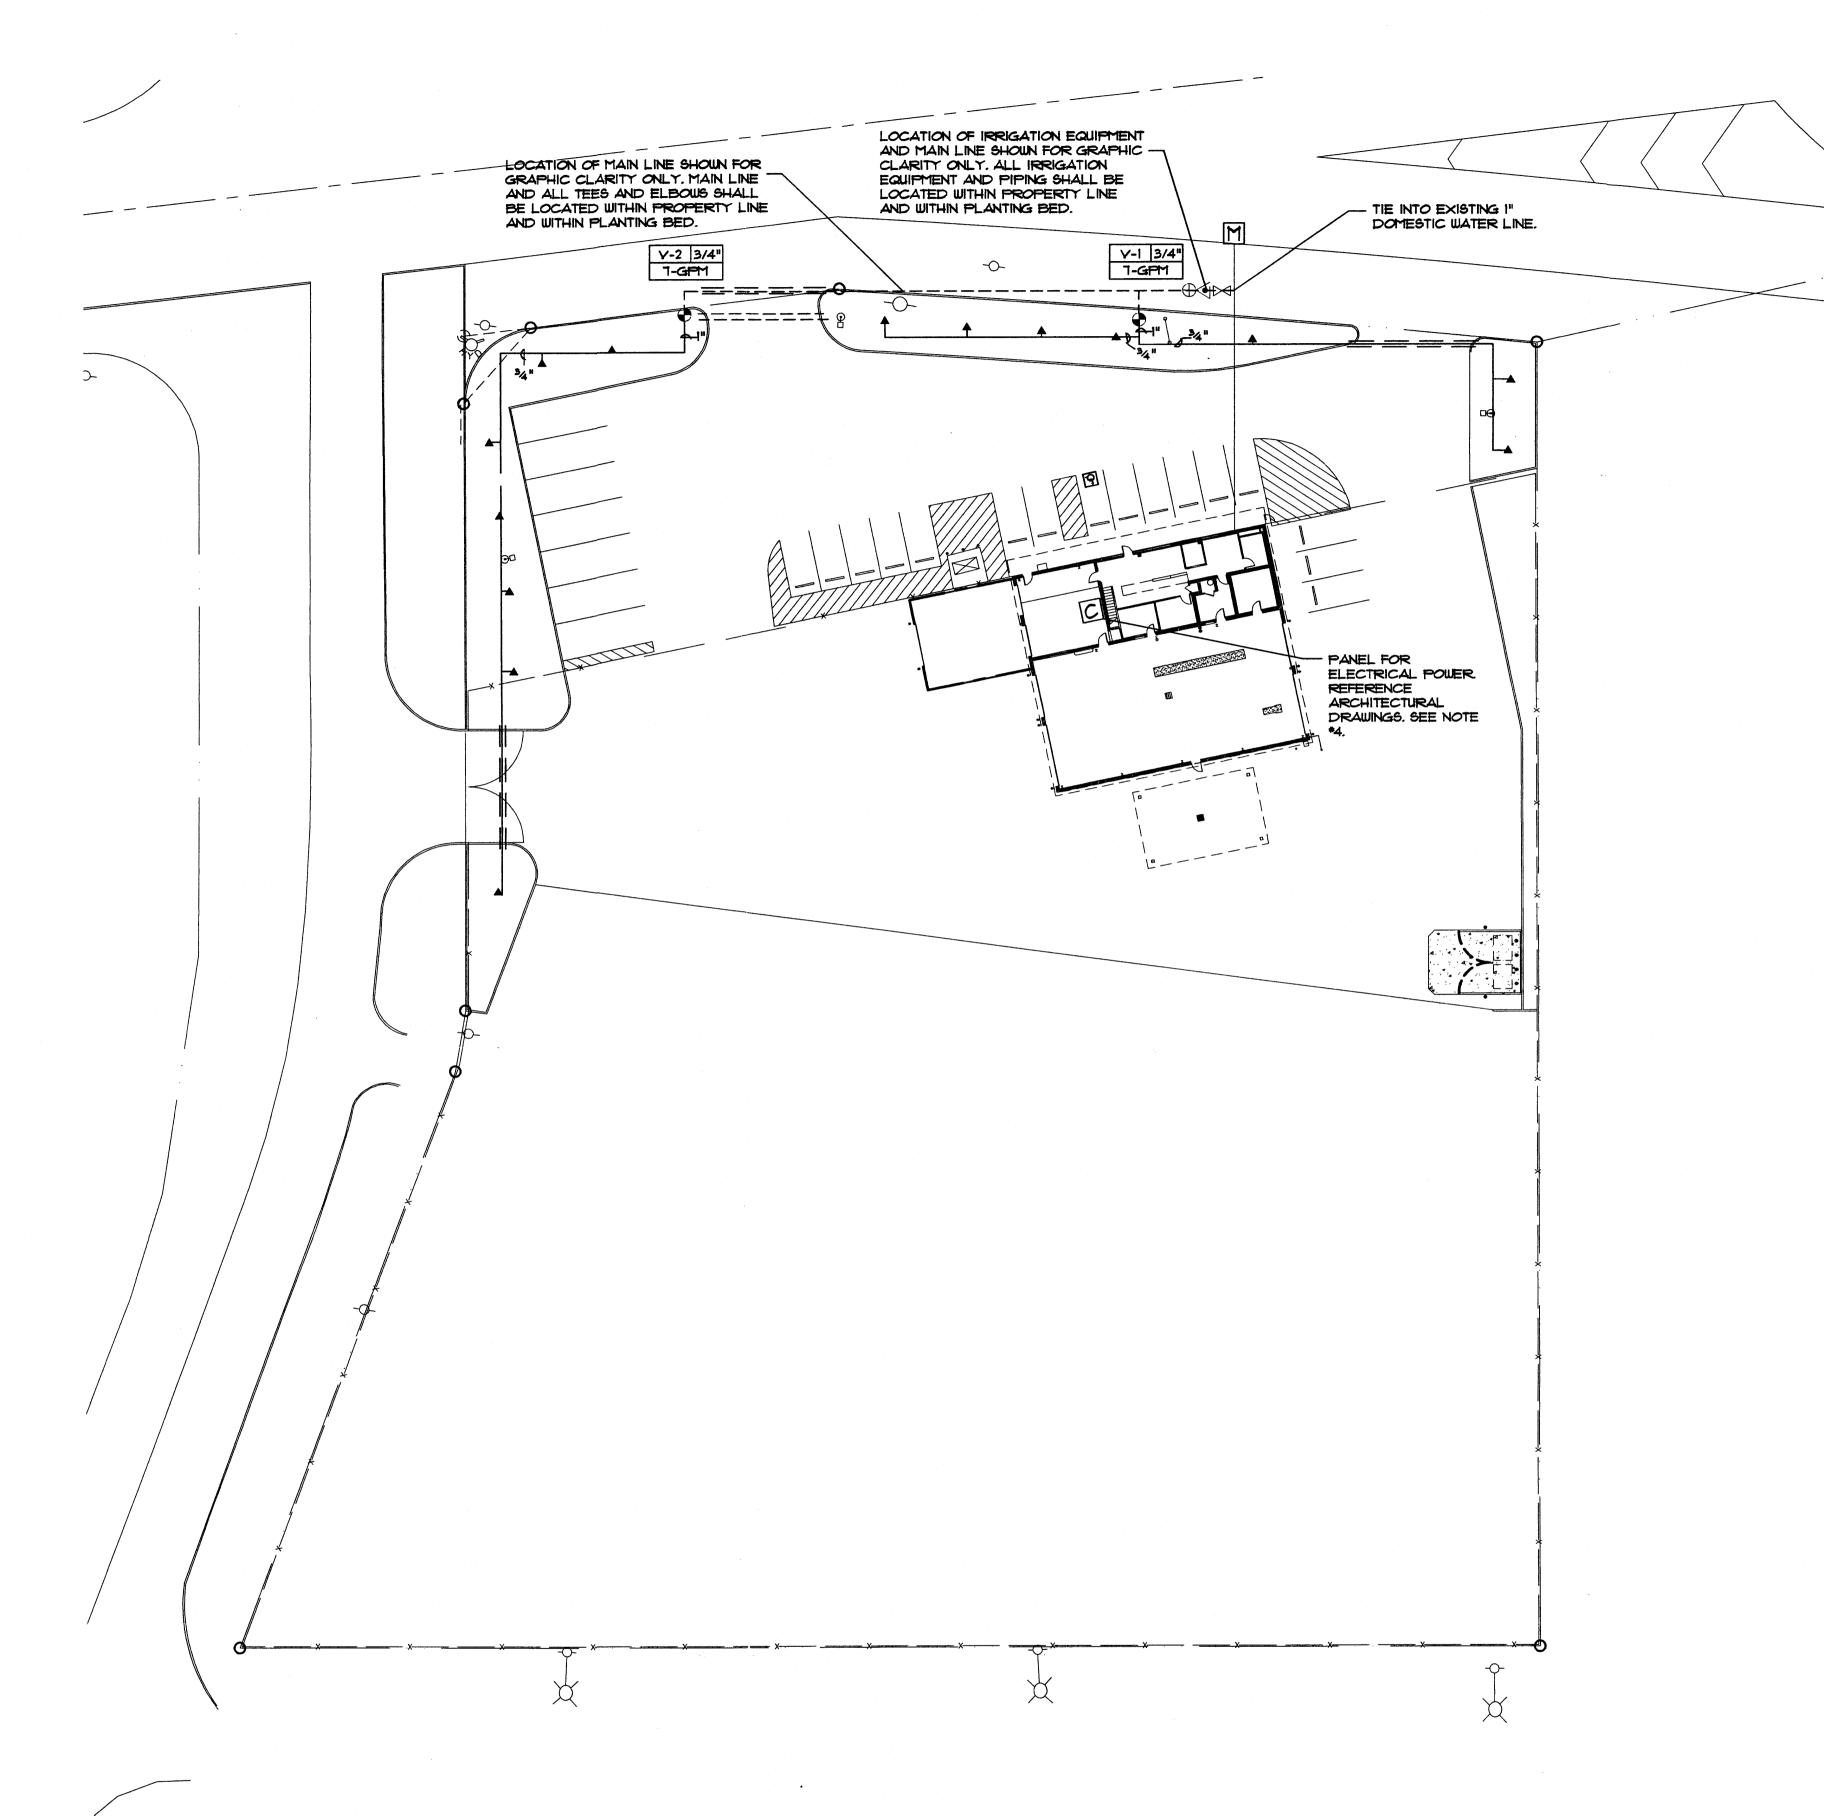

IRRIGATION LEGEND

- EXISTING WATER METER. LOCATION IS SCHEMATIC, CONTRACTOR SHALL VERIFY LOCATION. SEE SITE UTILITY PLANS FOR RELATED INFORMATION.
- MAIN LINE AND LATERAL SLEEVE PIPING, CLASS 200, SDR-21, BELL-END, SOLVENT WELD PYC, SEE NOTE NO. 2 BELOW.
- $\pm \pm \pm \pm = 24$ -volt irrigation wire sleeve piping, class 200, SDR-21, Bell-end, solvent WELD PVC, SEE NOTE NO. 2 BELOW.
 - EXISTING I" DOMESTIC WATER LINE TO BUILDING. LOCATION IS APPROXIMATE. CONTRACTOR SHALL VERIFY LOCATION AND SIZE.
- ---- IRRIGATION MAIN LINE, SCH. 40, BELL-END, SOLVENT WELD PVC, SIZE 1". DEPTH OF BURY: 28" FOR CONTINUOUS PRESSURE IRRIGATION MAIN AND 18" FOR NON-CONTINUOUS. --- LATERAL PIPING, SCH. 40, BELL END, SOLVENT WELD PVC. SIZE AS SHOWN ON PLAN. DEPTH OF BURY, 18". PIPE CONVEYING LESS THAN 5 GPM SHALL BE 34".
 - M POINT OF CONNECTION, SPEARS SCH. 80 PVC BALL VALVE WITH UNIONS, SIZE 1". SEE DETAIL C/L3.
 - BACKFLOW PREVENTER AND MASTER VALVE ASSEMBLY, FEBCO 860U, I" REDUCED PRESSURE PRINCIPLE BACKFLOW PREVENTER WITH BALL VALVES IN HOT BOX MODEL NO. 2 HEATED AND INSULATED BACKFLOW ENCLOSURE AND WEATHERMATIC 11024-FCR PLASTIC BODY 24-VOLT MASTER VALVE, SIZE 1". SEE DETAIL B/L3.
 - REMOTE CONTROL VALVE ASSEMBLY, WEATHERMATIC 11024-FCR PLASTIC BODY 24-YOLT AUTOMATIC VALVE, SIZE AS SHOWN ON PLAN. SEE DETAIL D/L3.
 - PRESSURE COMPENSATING BUBBLER ASSEMBLIES, RAIN BIRD 1400 SERIES, AS FOLLOWS: SEE DETAIL E/L3

 - IRRIGATION CONTROLLER, RAINBIRD ESP-8MC, EIGHT STATION WALL MOUNT CONTROLLER SEE DETAIL F/L3.

IRRIGATION NOTES

- CONTRACTOR SHALL FURNISH ALL LABOR, MATERIALS AND EQUIPMENT NECESSARY TO CONSTRUCT PROPOSED IRRIGATION SYSTEM IN ACCORDANCE WITH PLANS, WRITTEN SPECIFICATIONS AND DETAILS.
- THE CONTRACTOR SHALL COORDINATE THE INSTALLATION OF SLEEVE PIPING WITH ALL TRADES TO INSURE THAT SLEEVES ARE INSTALLED PROPERLY PRIOR TO INSTALLATION OF CURB AND GUTTER, ASPHALT PAYING, SIDEWALKS, CONCRETE PADS, ETC.
- THIS SYSTEM WAS DESIGNED AT A MINIMUM STATIC FRESSURE OF 80 PSI AT THE POINT OF CONNECTION. CONTRACTOR SHALL VERIFY ACTUAL PSI AND DELIVER RESULTS TO LANDSCAPE ARCHITECT PRIOR TO CONSTRUCTION. IN THE EVENT THE ACTUAL PSI IS LESS THAN 80 PSI THE CONTRACTOR SHALL RECEIVE DIRECTION FROM LANDSCAPE ARCHITECT REGARDING DESIGN MODIFICATIONS IF NECESSARY.
- 4. THE CONTRACTOR SHALL PROVIDE TWO 120-VOLT, 20 AMP CIRCUITS FROM ELECTRICAL PANEL TO IRRIGATION CONTROLLER AND BACKFLOW PREVENTER ENCLOSURE (ONE TO EACH). ALL WORK AND MATERIALS SHALL MEET LOCAL CODES AND THE NATIONAL ELECTRIC CODE (NE.C.).

-VALVE GALLONS PER MINUTE

YALYE ID LEGEND VALVE ID -/ VALVE SIZE **∀-1** | 1" 23-GPM

COMPLIANCE


THIS IRRIGATION SYSTEM HAS BEEN DESIGNED TO BE IN COMPLIANCE WITH THE WATER CONSERVATION LANDSCAPING AND WASTE WATER ORDINANCE (ORDINANCE 18-1995) ENACTED BY THE CITY OF ALBUQUERQUE.



7585 E. REDFIELD RD. SUITE 102 SCOTTSDALE, ARIZONA 85260 (480) 443-3705 - TEL.


DRAWN BY:

CHECKED BY:

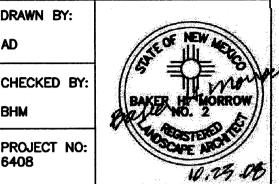



SING E. S.W PENSKE TRUCK LEAS 9200 W. CENTRAL AVE ALBUQUERQUE, N UPGR CILITY

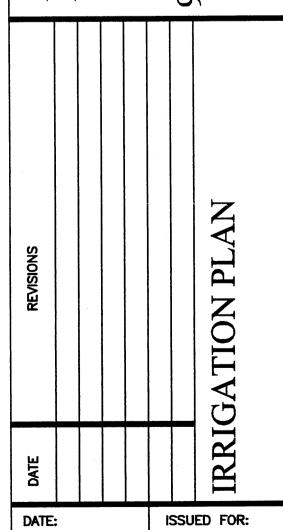


PERMIT


10-24-08

SHEET NO:

MORROW REARDON
WILKINSON MILLER, LTD.,
LANDSCAPE ARCHITECTS

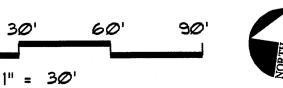



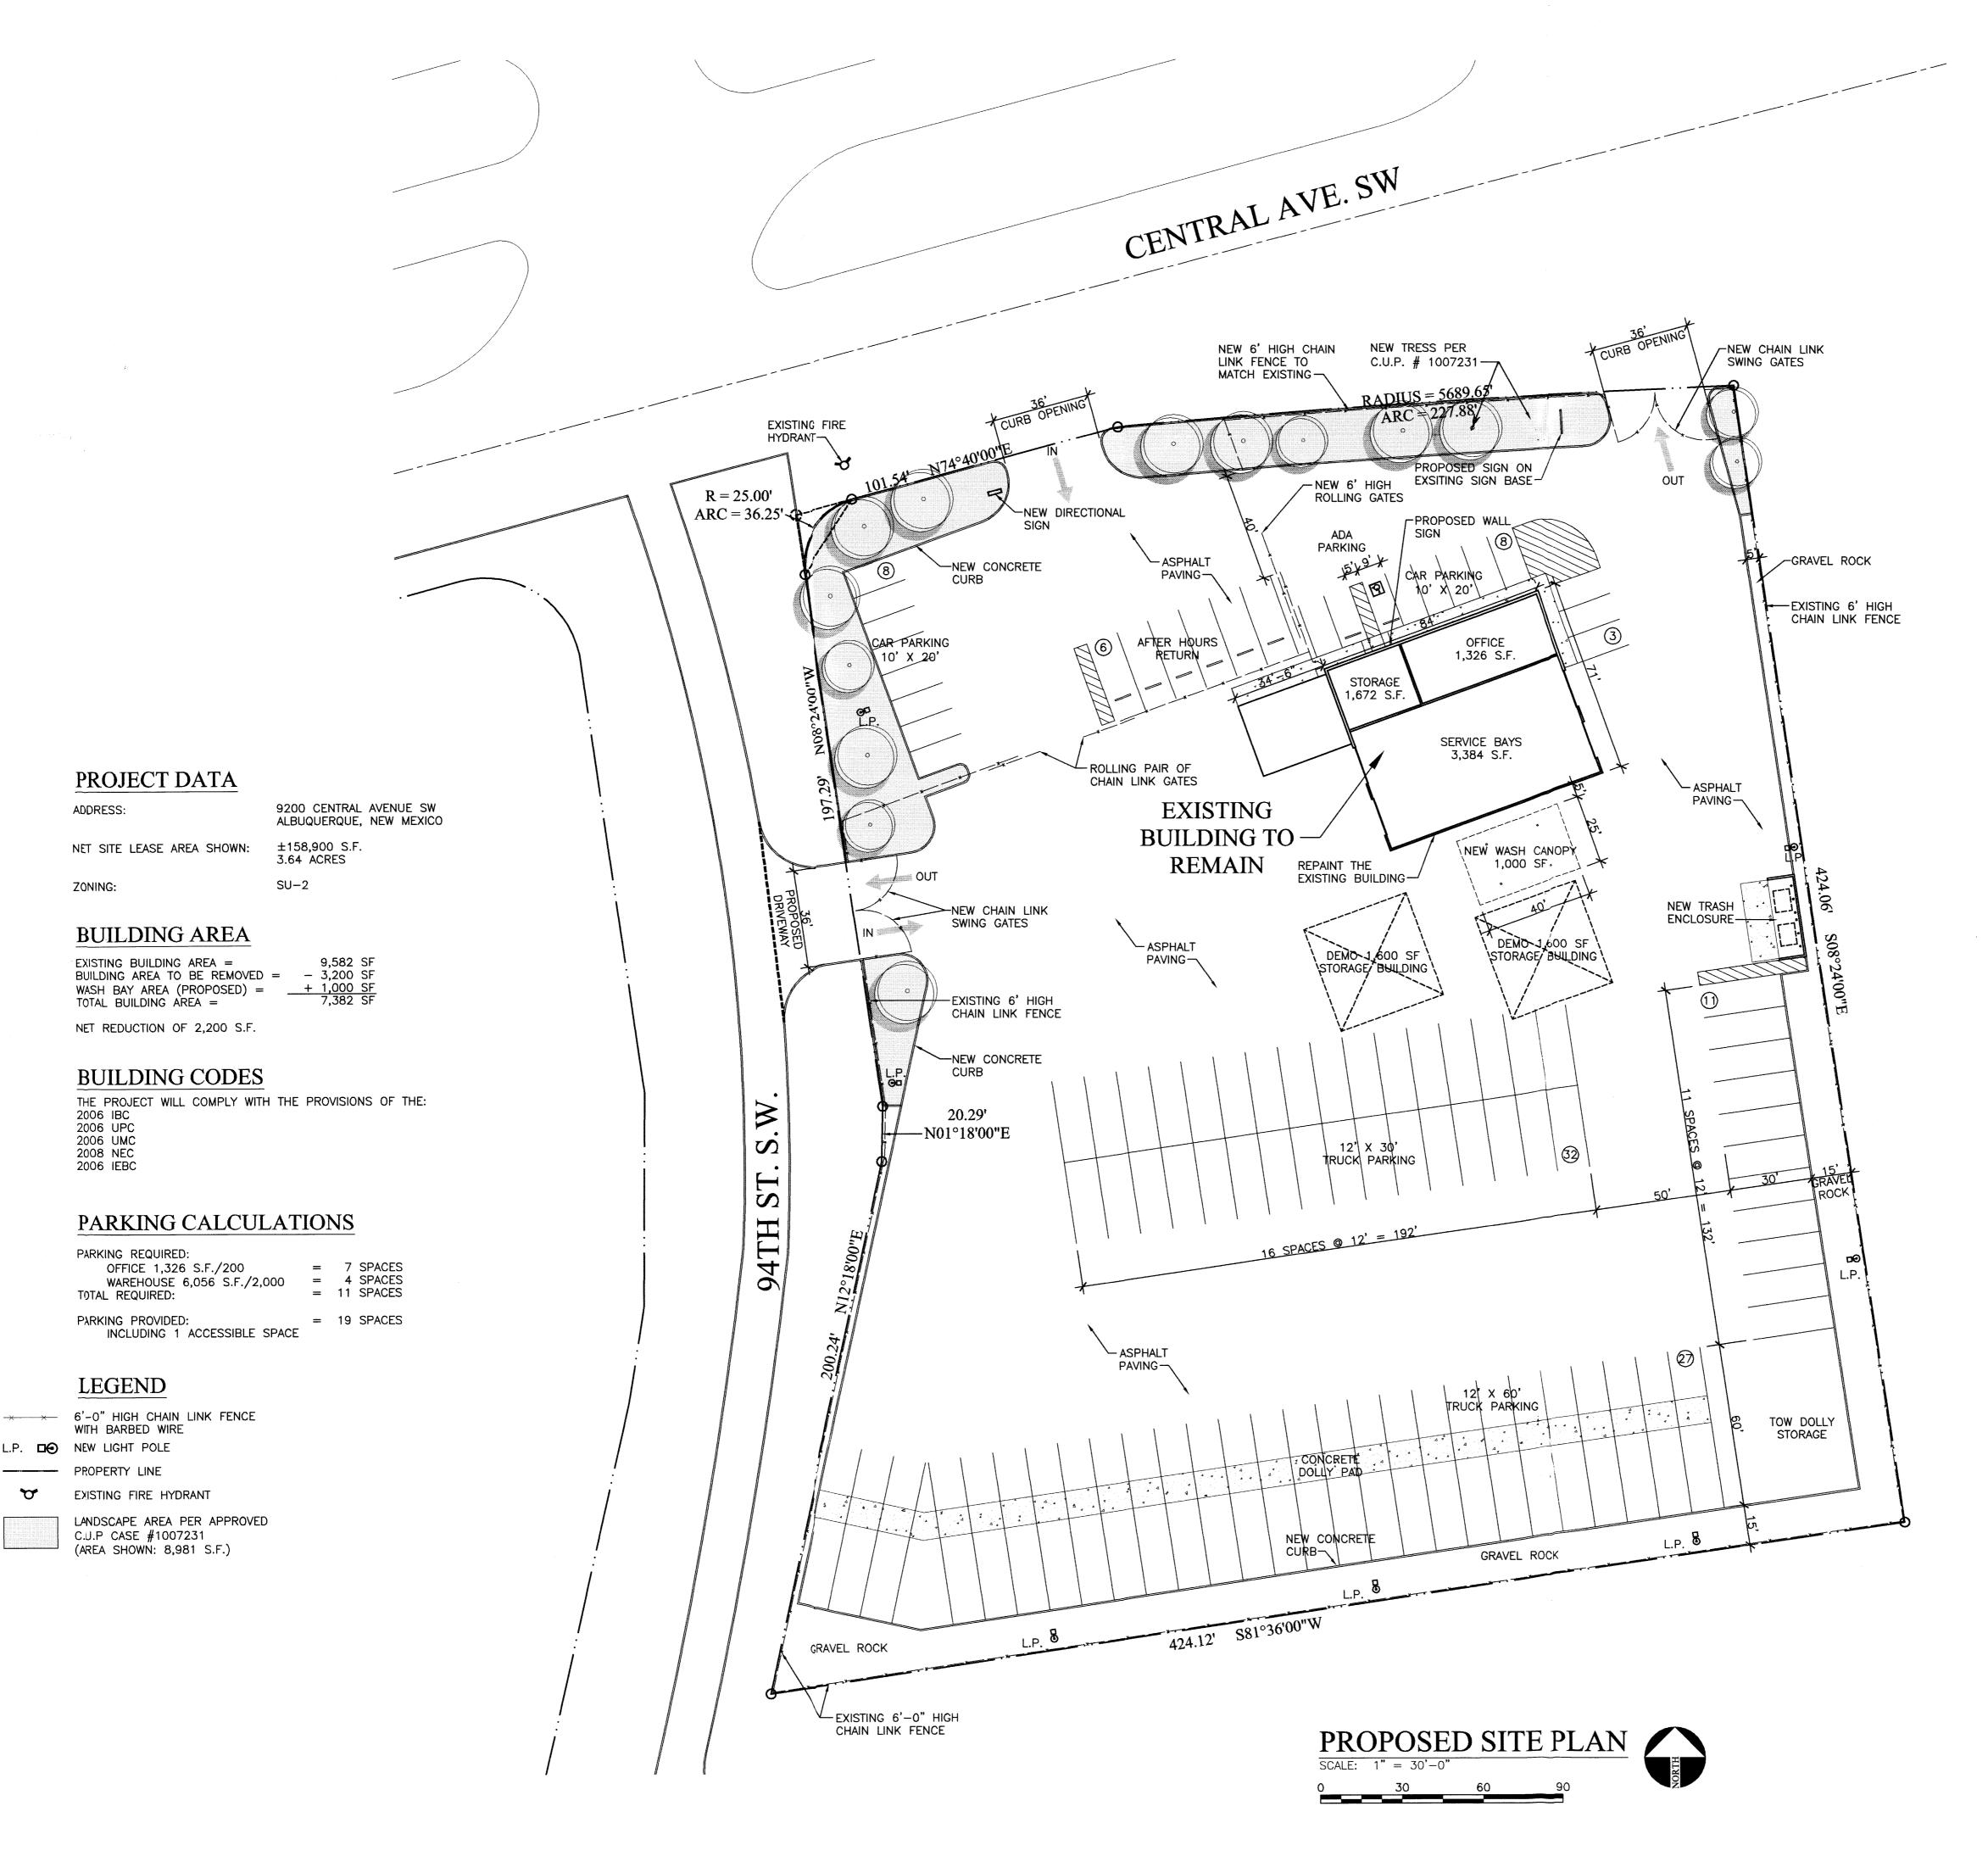

K/G
ARCHITECTS

7585 E. REDFIELD RD.
SUITE 102

SUITE 102 SCOTTSDALE, ARIZONA 85260 (480) 443-3705 - TEL. DRAWN BY:

CHECKED BY:

PROJECT NO: 08113

PENSKE

FACILITY UPGRADES

FOR
PENSKE TRUCK LEASING
9200 W. CENTRAL S.W.
ALBUQUERQUE, NM

DATE: ISSUED FOR: REVIEW

B-22-08

REVIEW

SHEET NO:

A1-(