



DRAWING INDEX

COVER SHEET SITE DEVELOPMENT PLAN

SITE DETAILS SITE DETAILS

LANDSCAPE PLAN CONCEPTUAL GRADING & DRAINAGE PLAN

UTILITY PLAN EXTERIOR ELEVATIONS

EXTERIOR ELEVATIONS (COLOR) RENDERINGS

## SITE DEVELOPMENT PLAN FOR BUILDING PERMIT DRB SUBMITTAL 1.29.2016

# UPTOWN SHOPS - TARGET @ UPTOWN

PROJECT TEAM

**OWNER** JOHN SEDBERRY 4700 MONTGOMERY BLVD. NE ALBUQUERQUE, NM 87109 TEL: 505.855.7565


**ARCHITECT** DEKKER/PERICH/SABATINI 7601 JEFFERSON NE, SUITE 100 ALBUQUERQUE, NM 87109 TEL: 505.761.9700 FAX: 505.761.4222

NOTE: THIS IMAGE IS CONCEPTUAL IN NATURE AND MAY NOT REFLECT THE REQUIREMENTS OF THESE DOCUMENTS.


LANDSCAPE ARCHITECT DEKKER/PERICH/SABATINI

7601 JEFFERSON NE, SUITE 100 ALBUQUERQUE, NM 87109 TEL: 505.761.9700 FAX: 505.761.4222

**CIVIL ENGINEER** ISAACSON & ARFMAN 128 MONROE ST. NE ALBUQUERQUE, NM 87108 TEL: 505.268.8828

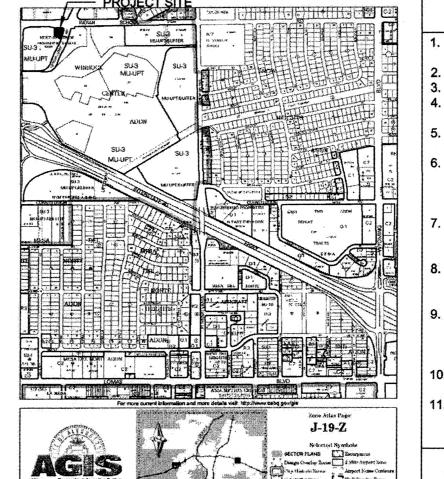

## **VICINITY MAP**

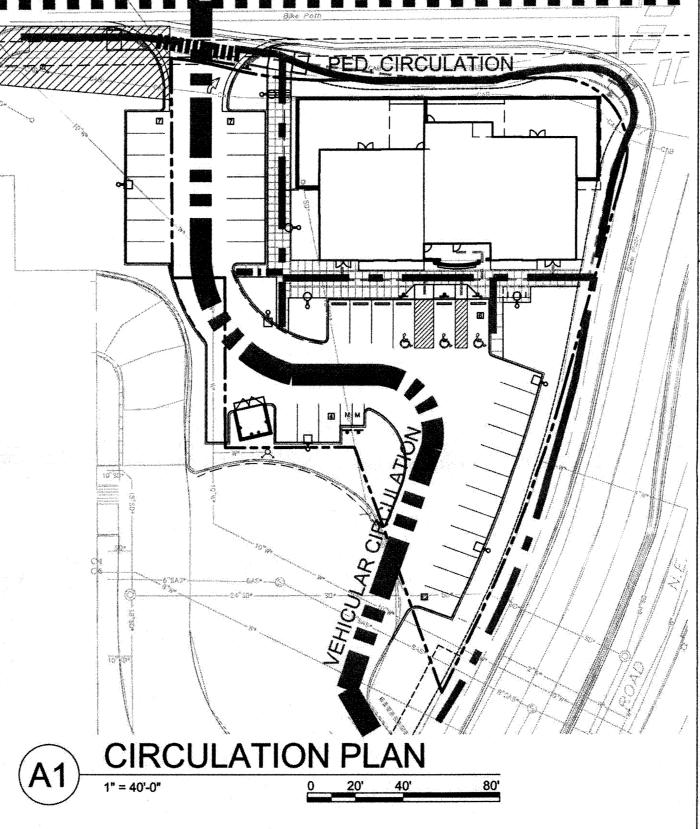

PROJECT NUMBER: \_\_

APPLICATION NUMBER: DRB Site Development Plan-Building Permit

Is an Infrastructure List Required? (x) Yes () No If yes, then a set of approved DRC plans with a work order is required for any construction within Public Right-of-Way or for construction of public improvements.

DRB SITE DEVELOPMENT PLAN APPROVAL:

DATE UTILITIES DIVISION DATE PARKS AND RECREATION DEPARTMENT DATE 1-27-16 DATE SOLID WASTE MANAGEMENT DATE FIRE/MARSHALL

GENERAL SHEET NOTES

PARKING AREA SHALL BE DESIGNED & BUILT TO CURRENT DPM STANDARDS AND COA SEE CIVIL PLANS FOR ADDITIONAL GRADING, DRAINAGE AND UTILITY INFORMATION.

CURBS WILL ALSO BE DESIGNED TO ALLOW WATER HARVESTING IN LANDSCAPE

ATTRACTIVE, AND UNIFIED LIGHTING THROUGHOUT THE LOT AND BE EXTINGUISHED

SIGNS, WALLS, TREES, AND SHRUBBERY BETWEEN 3 AND 8 FEET TALL WILL NOT BE ACCEPTABLE IN THIS AREA.

#### SITE INFORMATION

LEGAL DESCRIPTION TRACT: A-1-B, HUNT - SPECTRUM DEVELOPMENT SITE ZONING: SU-3 for MU-UPT

GROSS BUILDING AREA (GBA):
ORIGINALLY APPROVED SDP (2013)

BUILDING AREA- RETAIL: 6,200SF21,600 SF BUILDING AREA- HOUSING: 21,600SF (3 FLOORS @ 7,200SF, 18DU)

TOTAL SITE AREA: 27,870 SF = .6398 ACRES GROSS F.A.R. (GBA/SITE AREA) = 0.18

BUILDING INFORMATION:
TYPE IIB CONSTRUCTION

5000 SF BUILDING **BUILDING SPRINKLER** 

**BUILDING HEIGHT: 21'-0"** PROVIDE 10" HIGH NUMERALS WITH 2" STROKE PREMISE ID @ STREET OF

#### SHEET KEYED NOTES

PAINTED PARKING STRIPING (4-INCH WIDE), COLOR: WHITE

PAINTED HANDICAP PARKING STRIPING, COLOR: BLUE, PAINTED A.D.A. PARKING SPACE PAVEMENT SIGNAGE, RE: C3/ 02 OF 11

CONCRETE ACCESSIBLE RAMP TYPE B WITH 1:12 MAXIMUM SLOPE AT RAMP AND 1:12

6" CONCRETE CURB AND GUTTER, RE: CIVIL AND MDP & DG CONCRETE SIDEWALK, RE: B3,B4,B5/02 OF 11

CONCRETE SEATWALL, RE: ARCHITECTURAL ELEVATIONS AND A2/03 OF 11 EXTERIOR BOLLARD - 6-INCH DIAMETER, RE: C2/02 OF 11

0. CONCRETE PAVING 1. EXISTING LANDSCAPE AREA, RE: LANDSCAPE PLAN

12. CONCRETE BUILDING APRON, RE: B5/02 OF 11 13. REFUSE ENCLOSURE, CMU WALL WITH STUCCO SYSTEM, COLOR: GREY, RE:A2. A3 &

14. PATIO ENCLOSURE, CMU WALL WITH STONE VENEER 4'T HT. RE: ARCHITECTURAL ELEVATIONS AND A1/03 OF 11

15. STOP SIGN, RE: C4/02 OF 11 16. PROPERTY LINE

17. EXISTING CURB AND GUTTER TO REMAIN 18. EXISTING RETAINING WALL TO REMAIN

19. EXISTING FIRE HYDRANT 20. EXISTING SITE LIGHTING TO REMAIN

21. ROADWAY ARROW, RE: D2/02 OF 11 22. ROADWAY STOP LINE, RE: D2/02 OF 11

23. PAINTED CROSSWALK, RE: D1/02 OF 11

24. BIKE RACK, RE: D4/ 02 OF 11 25. MOTORCYCLE PARKING

26. EXISTING SIDEWALK 27. ADA ACCESS AISLES SHALL BE LABELED, "NO PARKING" IN CAPITAL LETTERS, 1'-0"

TALL AND 2" WIDE PLACED AT THE REAR OF THE SPACE. 28. EXISTING ACCESS RAMP

29. ACCESSIBLE RAMP, TYPE A, WITH 1:12 MAXIMUM SLOPE AT RAMP, HEAVY BROOM FINISH PERPENDICULAR TO SLOPE TYPICAL ON RAMP.

30. EXISTING STORM DRAIN INLET TO REMAIN 31. CONCRETE STAIRS, RE: A3/ 02 OF 11

32. 6" CHARCOAL GRAY DECORATIVE BORDER TO MATCH EXISTING AT TARGET

33. EXISTING DRIVE PAD 34. CLEAR SIGHT TRIANGLE

35. EXISTING CURB AND GUTTER TO REMOVE

36. EXISTING WALL 37. EASEMENT

38. FIRE LANE STRIPING, NO PARKING FIRE LANE 39. DRAIN, SEE MECHANICAL

#### LEGEND

DATE

DATE

 $\Leftrightarrow$ TRAFFIC ARROWS, RE: D5/03 OF 11  $\Rightarrow$  $\bigcirc$ 16' LIGHT POLE, RE: A3/ 03 OF 11 ₽ 20' LIGHT POLE, RE:A4/ 03 OF 11 **EXISTING FIRE HYDRANT** PROPERTY LINE SETBACK OR EASEMENT CONCRETE SIDEWALK ----EXISTING SITE

ADA ACCESSIBLE PEDESTRIAN PATHWAY

#### PARKING INFORMATION

REQUIRED 5,000 SF BUILDING

2:1000 SF (5000/1000= 5\*2) = 10 SPACES 36-50 PARKING SPACES = 3 HANDICAPPED SPACE (1 VAN) 26-50 PARKING SPACES = 2 MOTORCYCLE 1:20 AUTOMOBILE, (36/20) = 2 BICYCLE

> 2 MOTORCYCLE 5 BICYCLE

APPROVED SDP (2013)
SPACES PROVIDED: 41 SPACES (11 SURFACE, 30 BELOW) (2 ACCESSIBLE)

0 MOTORCYCLE 0 BICYCLE PROVIDED

SPACES PROVIDED: 36 SPACES (3 ACCESSIBLE)

DEKKER PERICH SABATINI

ARCHITECTURE / DESIGN / INSPIRATION

7601 JEFFERSON NE, SUITE 100 ALBUQUERQUE, NM 87109

505.761.9700 / DPSDESIGN.ORG

HYDRANT AND FIRE ACCES ALBUQUERQUE FIRE MARSHAL'S OFFIC PLANS CHECKING DIVISION

PROJECT

**URT REVIEW** 


REVISIONS

DRAWN BY LI, AC REVIEWED BY 11/19/2015 DATE PROJECT NO 15-0102

DRAWING NAME

SITE DEVELOPMENT **PLAN** FIRE 1

SHEET NO

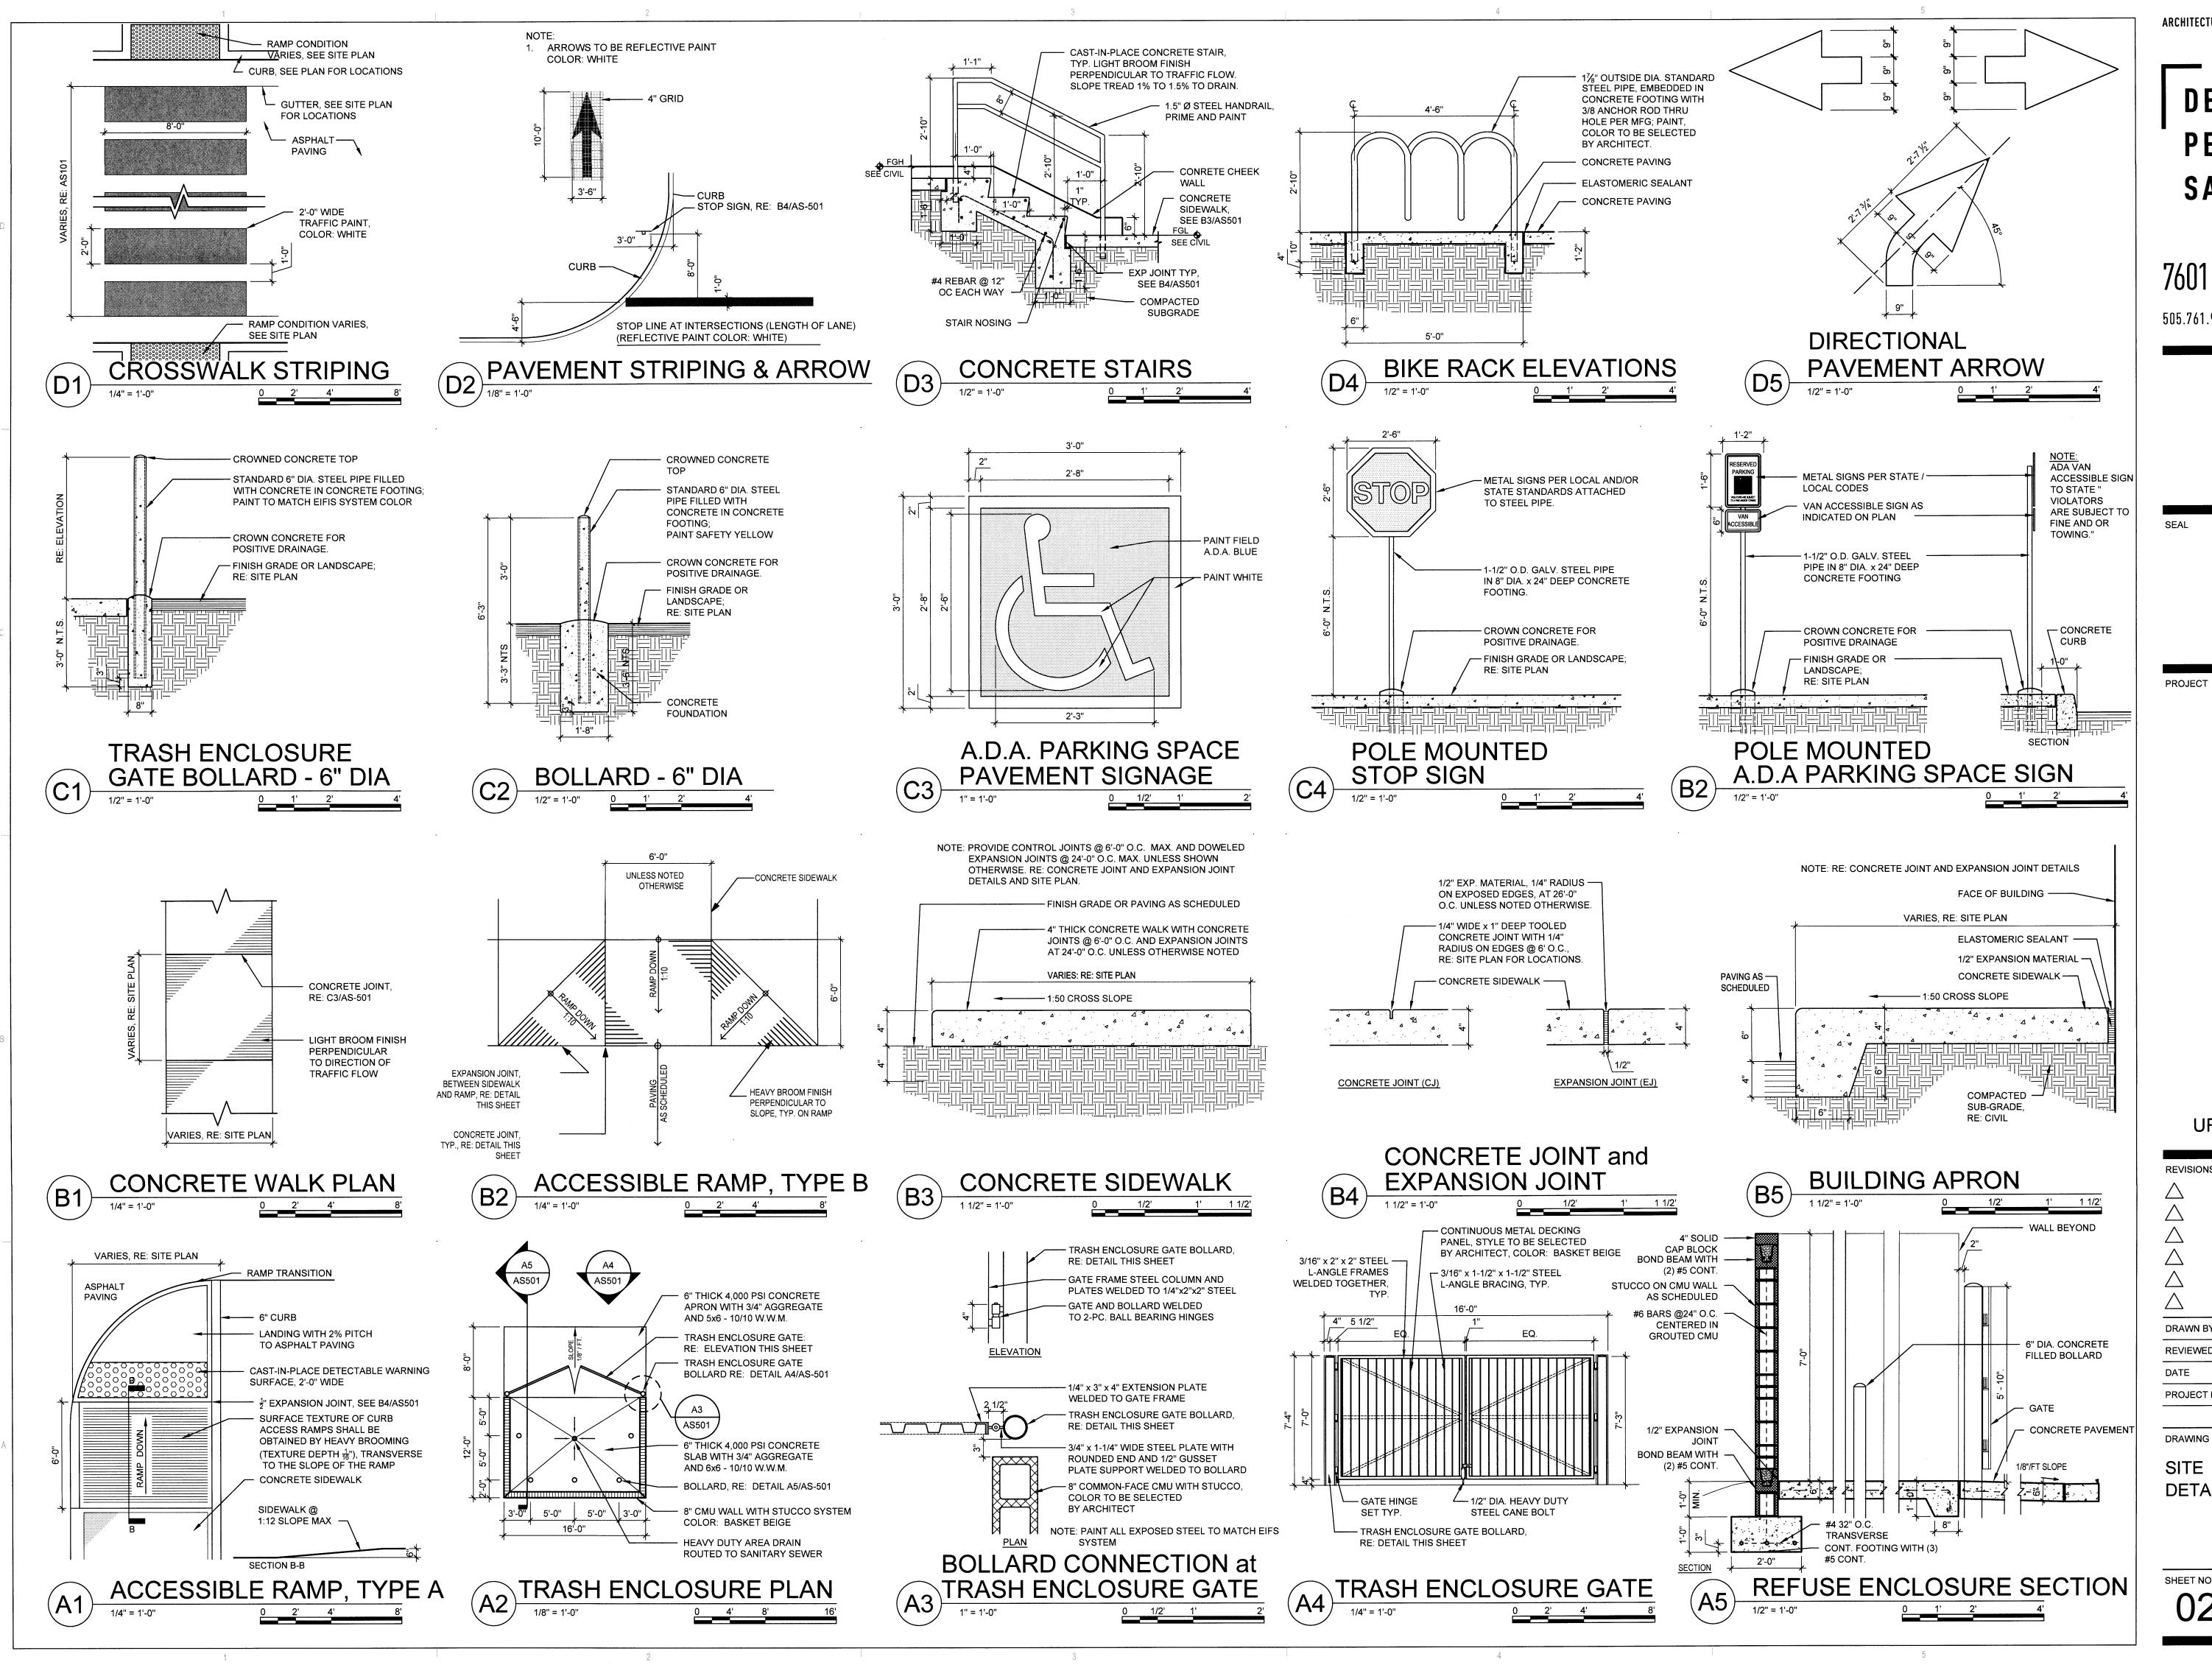

ARCHITECTURE / DESIGN / INSPIRATION

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**URT REVIEW** 

**REVISIONS** DRAWN BY **REVIEWED BY** 11/19/2015 PROJECT NO 15-0102

DRAWING NAME

**DETAILS** 

SHEET NO 02 OF 11

KIM LIGHTING P.O. BOX 60080 CITY OF INDUSTRY, CA 91745-1788 1-626-968-5666 www.kimlighting.com


NOTES:

1. INSTALLATION TO BE COMPLETED IN ACCORDANCE WITH MANUFACTURER'S SPECIFICATIONS.


2. DO NOT SCALE DRAWINGS.

3. CONTRACTORS NOTE: FOR PRODUCT AND COMPANY INFORMATION VISIT www.CADdetails.com/inforeference number 433-103. COA NOTE: WATTAGE WILL NOT EXCEED 75 WATTS TO COMPLY W/ NEW MEXICO NIGHT SKY ORDINANCE


LANDSCAPE UPLIGHT

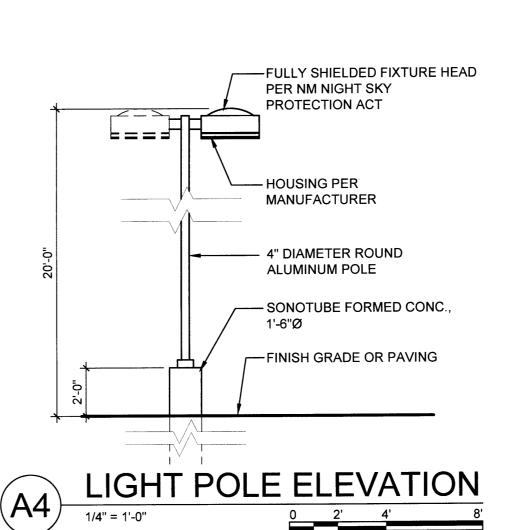

1/2" = 1'-0"

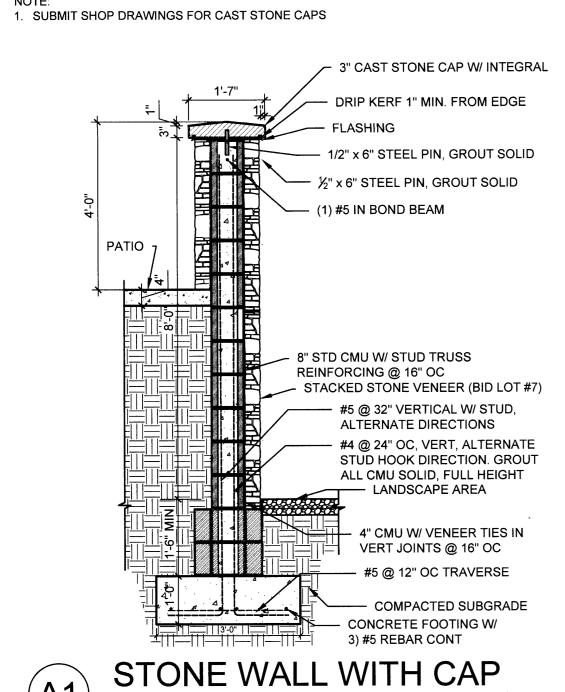

1. SUBMIT SHOP DRAWINGS FOR CAST STONE CAPS

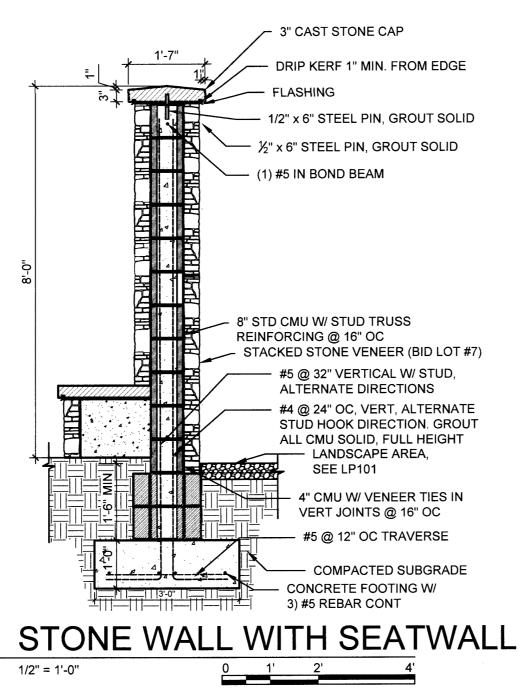

PROTECTION ACT - HOUSING PER MANUFACTURER \_\_\_\_ 4" DIAMETER ROUND ALUMINUM POLE — SONOTUBE FORMED CONC., 1'-6"Ø FINISH GRADE OR PAVING

-FULLY SHIELDED FIXTURE HEAD

PER NM NIGHT SKY

**DETAILS** 

LI, AC

CG

11/19/2015

15-0102

**URT REVIEW** 

REVISIONS

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DATE

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PROJECT NO

DRAWING NAME

SITE

ARCHITECTURE / DESIGN / INSPIRATION

DEKKER

PERICH


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**PROJECT** 

SHEET NO 03 OF 11



#### PLANTING LEGEND

	TREES				
	SYM	QTY	BOTANICAL NAME/ COMMON NAME	INSTALLATION SIZE	MATURE SIZE (HXW)/ WATER USE
_	and Market	13	Pistacia chinensis/ CHINESE PISTACHE	3" Cal.	35'x30'/ Medium
<	$\mathcal{Z}$	14	Cercis reniformis/ WESTERN REDBUD	2.5" Cal./B&B Multi-trunked	25'x18'/ Medium
	$(\)$	28	Chilopsis linearis 'Art's Seedless/ DESERT WILLOW	48" Box/ Multi-trunked	25'x35'/ Low
		3	Populous deltoides wislizenii RIO GRANDE VALLEY COTTONV	2.5" Cal./B&B WOOD	60'x60'/ High
		21	Quercus buckleyi/ TEXAS RED OAK	2.5" Cal./B&B	25'x25'/ Medium
		15	Quercus muhlenbergia/ CHINQUAPIN OAK	2.5" Cal./B&B	30'x30'/ Medium
		10	Tilia cordata LITTLELEAF LINDEN	2.5" Cal./B&B	35'x25'/ Medium
		19	Juniperus chinensis 'Spartan' SPARTAN JUNIPER	6' High/B&B	15'x8'/ Low
		23	Pinus strobiformis/ SOUTHWESTERN WHITE PINE	og	60'x20'/ Low

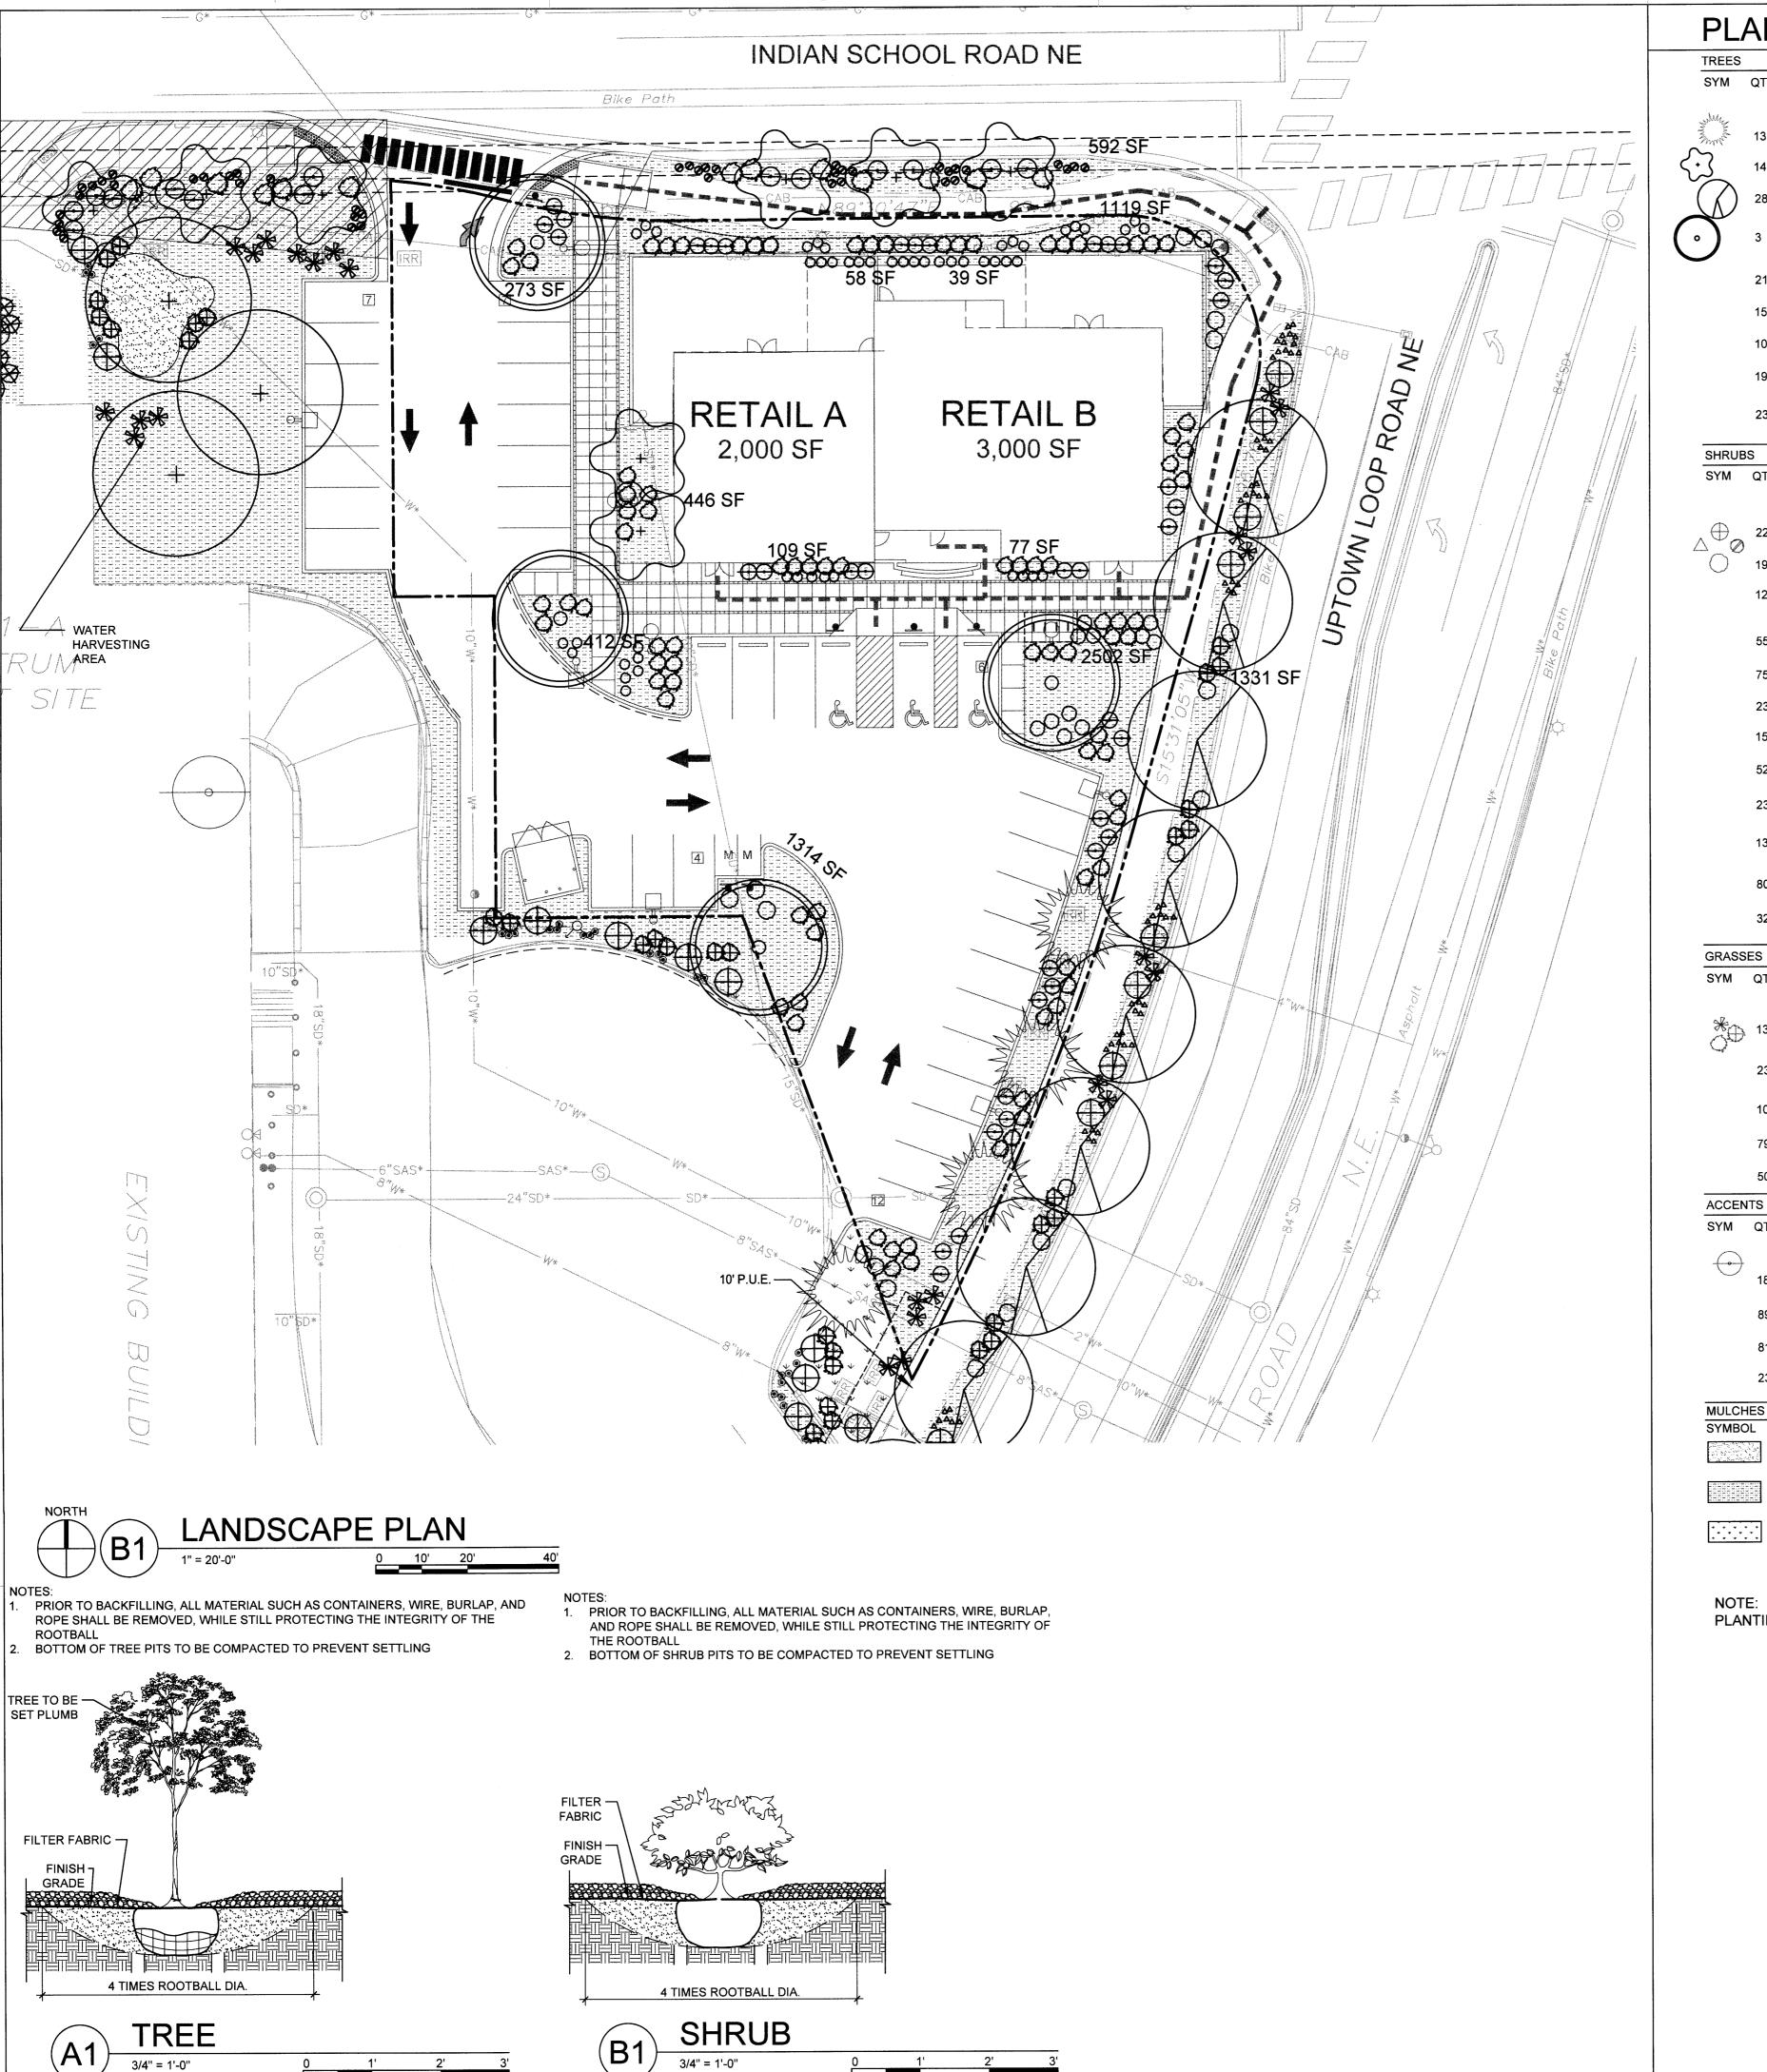		SOUTHWESTERN WHITE PINE	L	ow
HRUBS	S			
ΥM	QTY	BOTANICAL NAME/ COMMON NAME	INSTALLATION SIZE	MATURE SIZE (HXW)/ WATER USE
Da	22	Ericameria laricifolia/ TURPENTINE BUSH	1 Gal. Cont.	36"x36"/ Low
)	191	Baccharis x "Starn"/ THOMPSON BROOM	1 Gal. Cont.	36"x42"/ Low
	12	Caryopteris clandonensis "Dark KInght"/ DARK NIGHT BLUE MIST SPIREA	1 Gal. Cont.	48"x48"/ Medium
	55	Mahonia aquifolia "Compactum"/ COMPACT MAHONIA	1 Gal. Cont.	24"x48"/ Medium
	75	Rhus aromatica "Gro-low"/ GRO-LO FRAGRANT SUMAC	1 Gal. Cont.	24"x72"/ Medium
	23	Salvia 'Red Velvet'/ RED VELVET SAGE	1 Gal. Cont.	30"x36"/ Low
	153	Callirhoe involucrata/ WINECUPS	1 Gal. Cont.	18"x18"/ Low
	52	Ceratostigma plumbaginoides/ DWARF PLUMBAGO	1 Gal. Cont.	12"x18"/ Medium
	232	Hymenoxys acaulis/ ANGELITA DAISY	1 Gal. Cont.	12"x12"/ Low
	131	Lavandula angustifolia "Hidcote Superior"/ HIDCOTE SUPERIOR LAVENDER	1 Gal. Cont.	16"x18"/ Medium
	80	Mirabilis multiflora/ DESERT FOUR-O'CLOCK	1 Gal. Cont.	18"x30"/ Medium
	32	Teucrium chamaedrys/ TRAILING GERMANDER	1 Gal. Cont.	12"x24"/ Medium
RASSI				

SIZE (H)	TURE SIZE (W)/ ATER USE
	x15"/ dium
	'x42"/ dium
	'x48"/ dium
	'x48"/ dium
	'x48"/ dium
G	

		MAIDEN GRASS		meaium
CCEN	TS			
YM	QTY	BOTANICAL NAME/ COMMON NAME	INSTALLATION SIZE	MATURE SIZE (HXW)/ WATER USE
U	18	Dasylirion wheeleri/ SOTOL		48"x60"/ Low
	89	Hesperaloe parviflora/ RED HESPERALOE	1 Gal. Cont.	48"x48"/ Medium
	81	Opuntia basilaris/ BEAVERTAIL PRICKLY PEAR	1 Gal. Cont.	12"x48"/ Low
	23	Yucca glauca/ Soapweed	1 Gal. Cont.	36"x60"/ Low
	EC			

 $\frac{7}{16}$ " SANTA FE BROWN ROCK MULCH. INSTALL AT 3" DEPTH OVER BROWN FILTER FABRIC.

ORGANIC PECAN SHELL MULCH. INSTALL AT 3" DEPTH OVER BROWN FILTER FABRIC

IRRIGATED NATIVE SEED. PIONEER'S PRIDE SEED MIX FROM CURTIS AND CURTIS, INC. RATE: 1 POUND PER 1000 SF.

PLANTING PLAN PER APPROVED LANDSCAPE PLAN PHASE II (2011)

### LANDSCAPE NOTES

- A. ALL LANDSCAPE IS EXISTING PER APPROVED BUILDING PERMIT
- UNLESS NOTED OTHERWISE. B. PLANTING AND IRRIGATION MAINTENANCE ON SITE AND WITHIN RIGHT OF WAY SHALL BE THE RESPONSIBILITY OF THE PROPERTY
- C. DESIGN: THE EXISTING PLANTING DESIGN INCLUDES A DIVERSE PALETTE OF DESERT AND HIGH DESERT PLANTS THAT WILL COMPLEMENT THE ARCHITECTURE OF THE PROJECT. THE INTENT IS TO LANDSCAPE THIS MIXED-USE, URBAN ENVIRONMENT WITH DESERT AND HIGH DESERT PLANTS THAT REINFORCE A SENSE OF PLACE AND ARE APPROPRIATE TO ALBUQUERQUE'S CLIMATE.
- C.A. GRASSES AND ACCENT PLANTS SUCH AS YUCCA, SOTOL AND PRICKLY PEAR CACTUS WILL BE USED IN HIGHLY VISIBLE AND APPROPRIATE LOCATIONS. THE USE OF REGIONALLY NATIVE TREES FOR STREET TREES, WHILE UNORTHODOX, WILL REINFORCE THE SENSE OF PLACE, BUFFER PEDESTRIANS FROM VEHICULAR AREAS AND PROVIDE A COMFORTABLE PEDESTRIAN SCALE TO THE STREETS.
- D. PLANTING AND IRRIGATION INSTALLATION DETAILS MET CITY OF ALBUQUERQUE REQUIREMENTS AND THE USDP REQUIREMENTS. EACH TREE SHALL HAVE A MINIMUM OF 36 SQUARE FEET OF PLANTING SPACE.
- E. THE EXISTING IRRIGATION SYSTEM SHALL BE RUN WITH A FULLY AUTOMATED IRRIGATION CONTROLLER. THE RUN TIME FOR THE VARIOUS ZONES SHALL BE APPROXIMATELY 45 MINUTES FOR THE DRIP ZONES. RUN TIME WILL BE ADJUSTED ACCORDING TO SEASON, LOCATION, AND PLANT PERFORMANCE. DRIP EMITTERS SHALL BE USED FOR ALL PLANT MATERIAL.
- MULCH: ALL PLANTING BEDS SHALL BE COVERED WITH MULCH. GRAVEL, BARK AND PECAN SHELL MULCHES WILL BE USED APPROPRIATELY TO ADD VISUAL INTEREST AND PROTECT SOIL MOISTURE. CONTRACTOR TO VERIFY EXISTING MULCH MEETS THE DESIGN REQUIREMENTS. ADDITIONAL MULCH TO BE ADDED WHEN REQUIRED. G. THERE IS NO HIGH WATER USE TURF USED ON THIS PROJECT.
- H. THE LANDSCAPE DESIGN SHALL COMPLY WITH THE INTENT OF THE CITY OF ALBUQUERQUE WATER CONSERVATION , LANDSCAPING AND WATER WASTE ORDINANCE.
- SOIL PREPARATION AND AERATION WITHIN ROW IS REQUIRED TO DE-COMPACT LANDSCAPE ZONE PRIOR TO PLANTING.

J. PASSIVE WATER HARVESTING, SUCH AS HARVESTING OF STORM

- WATER SURFACE RUNOFF AND ROOF RUNOFF, SHALL BE UTILIZED WHERE FEASIBLE AND CAPTURED IN SWALES. K. THE EXISTING LANDSCAPE DESIGN REQUIRED A PERMANENT, FULLY
- AUTOMATIC IRRIGATION SYSTEM TO SUPPORT THE PLANT MATERIAL L. THE EXISTING IRRIGATION SYSTEM WAS INSTALLED TO CONNECTED TO CITY WATER. THE POINT OF CONNECTION CONSISTED OF A WATER METER, BACKFLOW PREVENTER AND MASTERVALVE. M. THE EXISTING IRRIGATION SYSTEM WAS DESIGNED TO RUN WITH
- FULLY AUTOMATED IRRIGATION CONTROLLER. RUN TIME WILL BE ADJUSTED ACCORDING TO PLANT MATURITY, SEASON, LOCATION, AND PLANT PERFORMANCE. N. REMOVE SPRAY IRRIGATION FOR PLANTS BEING REMOVED.
- O. CONTRACTOR TO RECONFIGURE AND SEPARATE IRRIGATION SYSTEM FROM EXISTING TARGET PROPERTY.
- P. LANDSCAPE AND SIGNAGE WILL NOT INTERFERE WITH CLEAR SIGHT REQUIREMENTS.

## LANDSCAPE CALCULATIONS

	ENTIRE SITE	PROPOSED SITE
SITE AREA (AFTER R.O.W. DEDICATION):	7.3572 AC	0.6398 AC
OPEN SPACE REQUIREMENT (10% OF THE		
SITE):	32,048 SF	2,787 SF
OPEN SPACE PROVIDED:	41,036 SF	4,429 SF
LANDSCAPE REQUIREMENT (40% OF OPEN	,	,
	16,414 SF	1,772 SF
LANDSCAPE AREA PROVIDED:		4,182 SF
*NET LOT AREA WAS NOT USED IN THESE	, -	•
CALCULATIONS		

TOTAL SHADE TREES (% OF TREES): 79 TOTAL SIGNATURE TREES (1/3 OF TREES): 38

OPEN SPACE CALCULATIONS DO NOT INCLUDE REQUIRED LANDSCAPE STRIPS ALONG THE STREET OR WALKWAYS EXCEPT ANY PORTION OF A


WALKWAY THAT IS WIDER THAN 10 FEET. A MINIMUM OF 75% OF LANDSCAPE AREAS AND 60%-75% OF PLANTING

STRIPS ARE COVERED WITH LIVE VEGETATIVE MATERIALS.

A MINIMUM OF 10% OF LANDSCAPE AREAS HAVE FLOWERING PLANTS OR

ROCK MULCH HAS BEEN LIMITED TO LESS THAN 5% OF ANY OPEN SPACE AREA AND USED ONLY WHERE NECESSARY AROUND DRAINAGE INLETS. ALL OTHER MULCH AREAS UTILIZE ORGANIC PECAN SHELL MULCH.

#### **KEYPLAN**

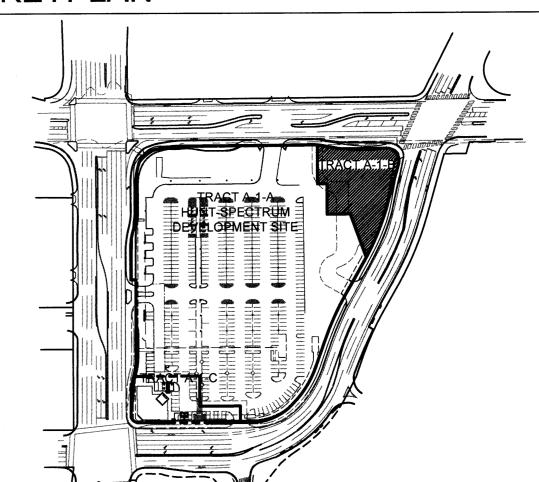

DEKKER PERICH

SABATINI

ARCHITECTURE / DESIGN / INSPIRATION

7601 JEFFERSON NE, SUITE 100 ALBUQUERQUE, NM 87109

505.761.9700 / DPSDESIGN.ORG

PROJECT


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11/19/2015 PROJECT NO 15-0102

DRAWING NAME

LANDSCAPE PLAN



ARCHITECTURE / DESIGN / INSPIRATION
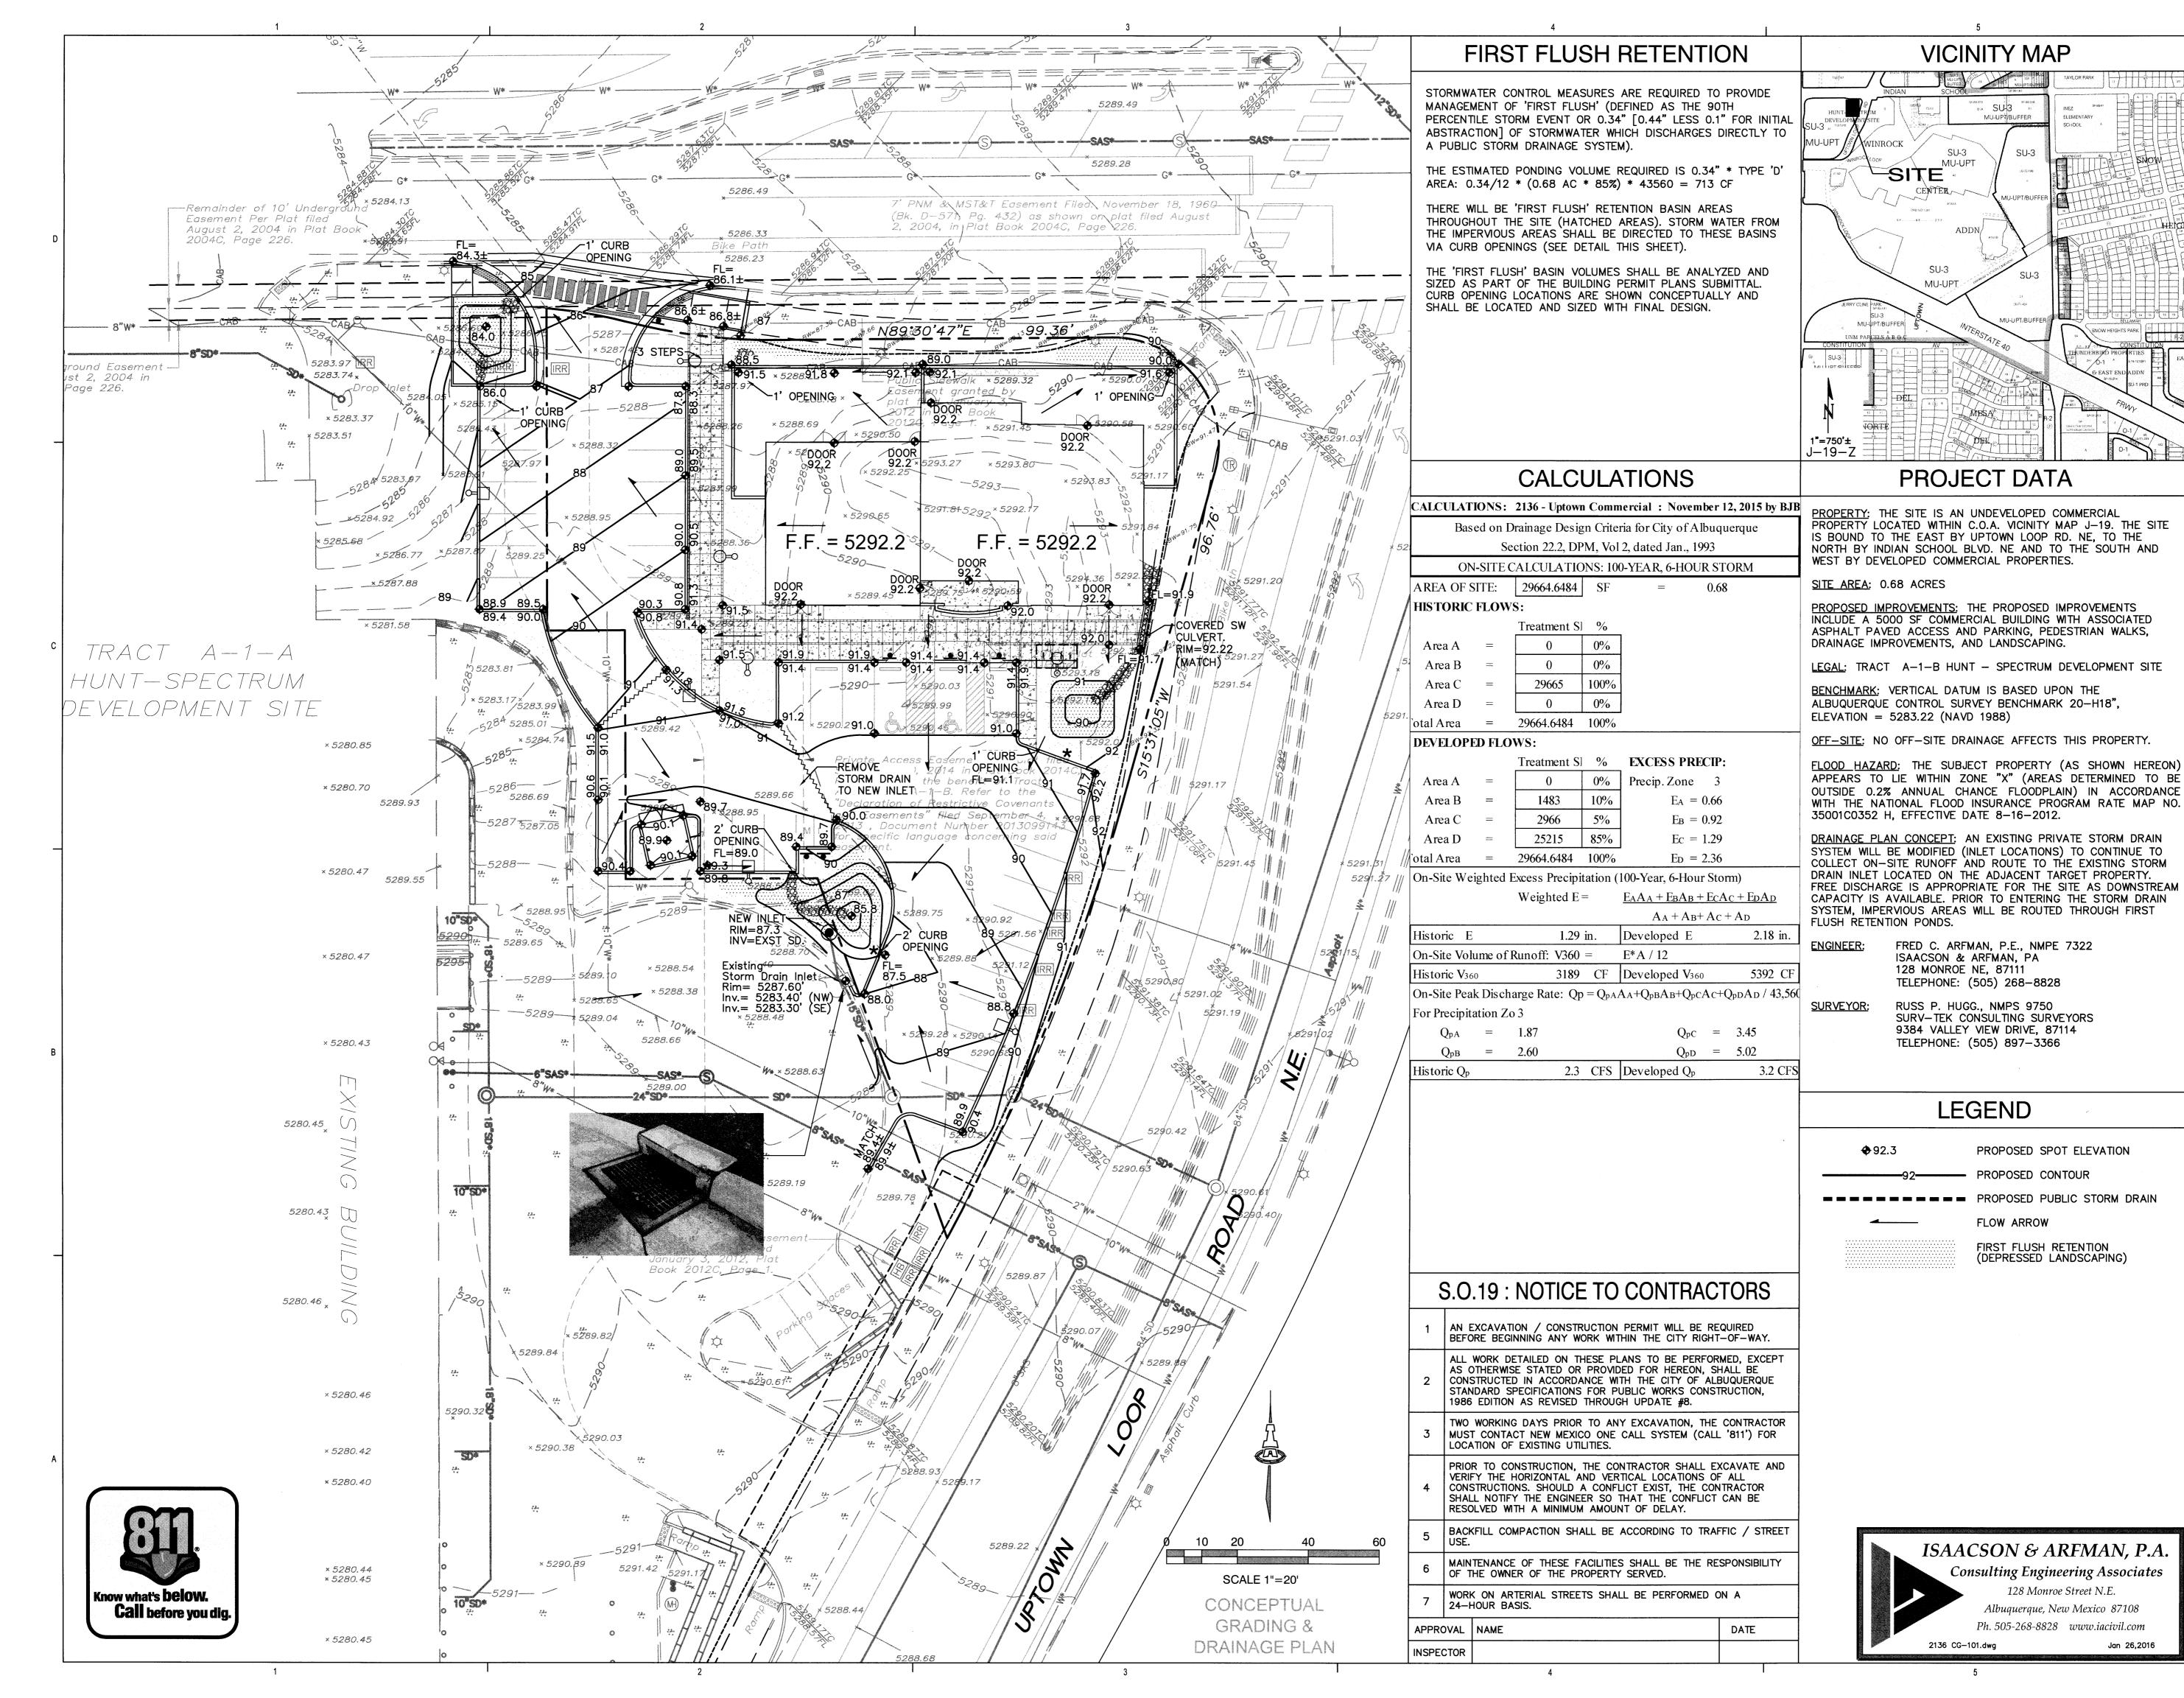
## **DEKKER** PERICH SABATINI

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PROJECT

O ≥ SH QUE, UPTOWN ALBUQUERG

## **URT REVIEW**

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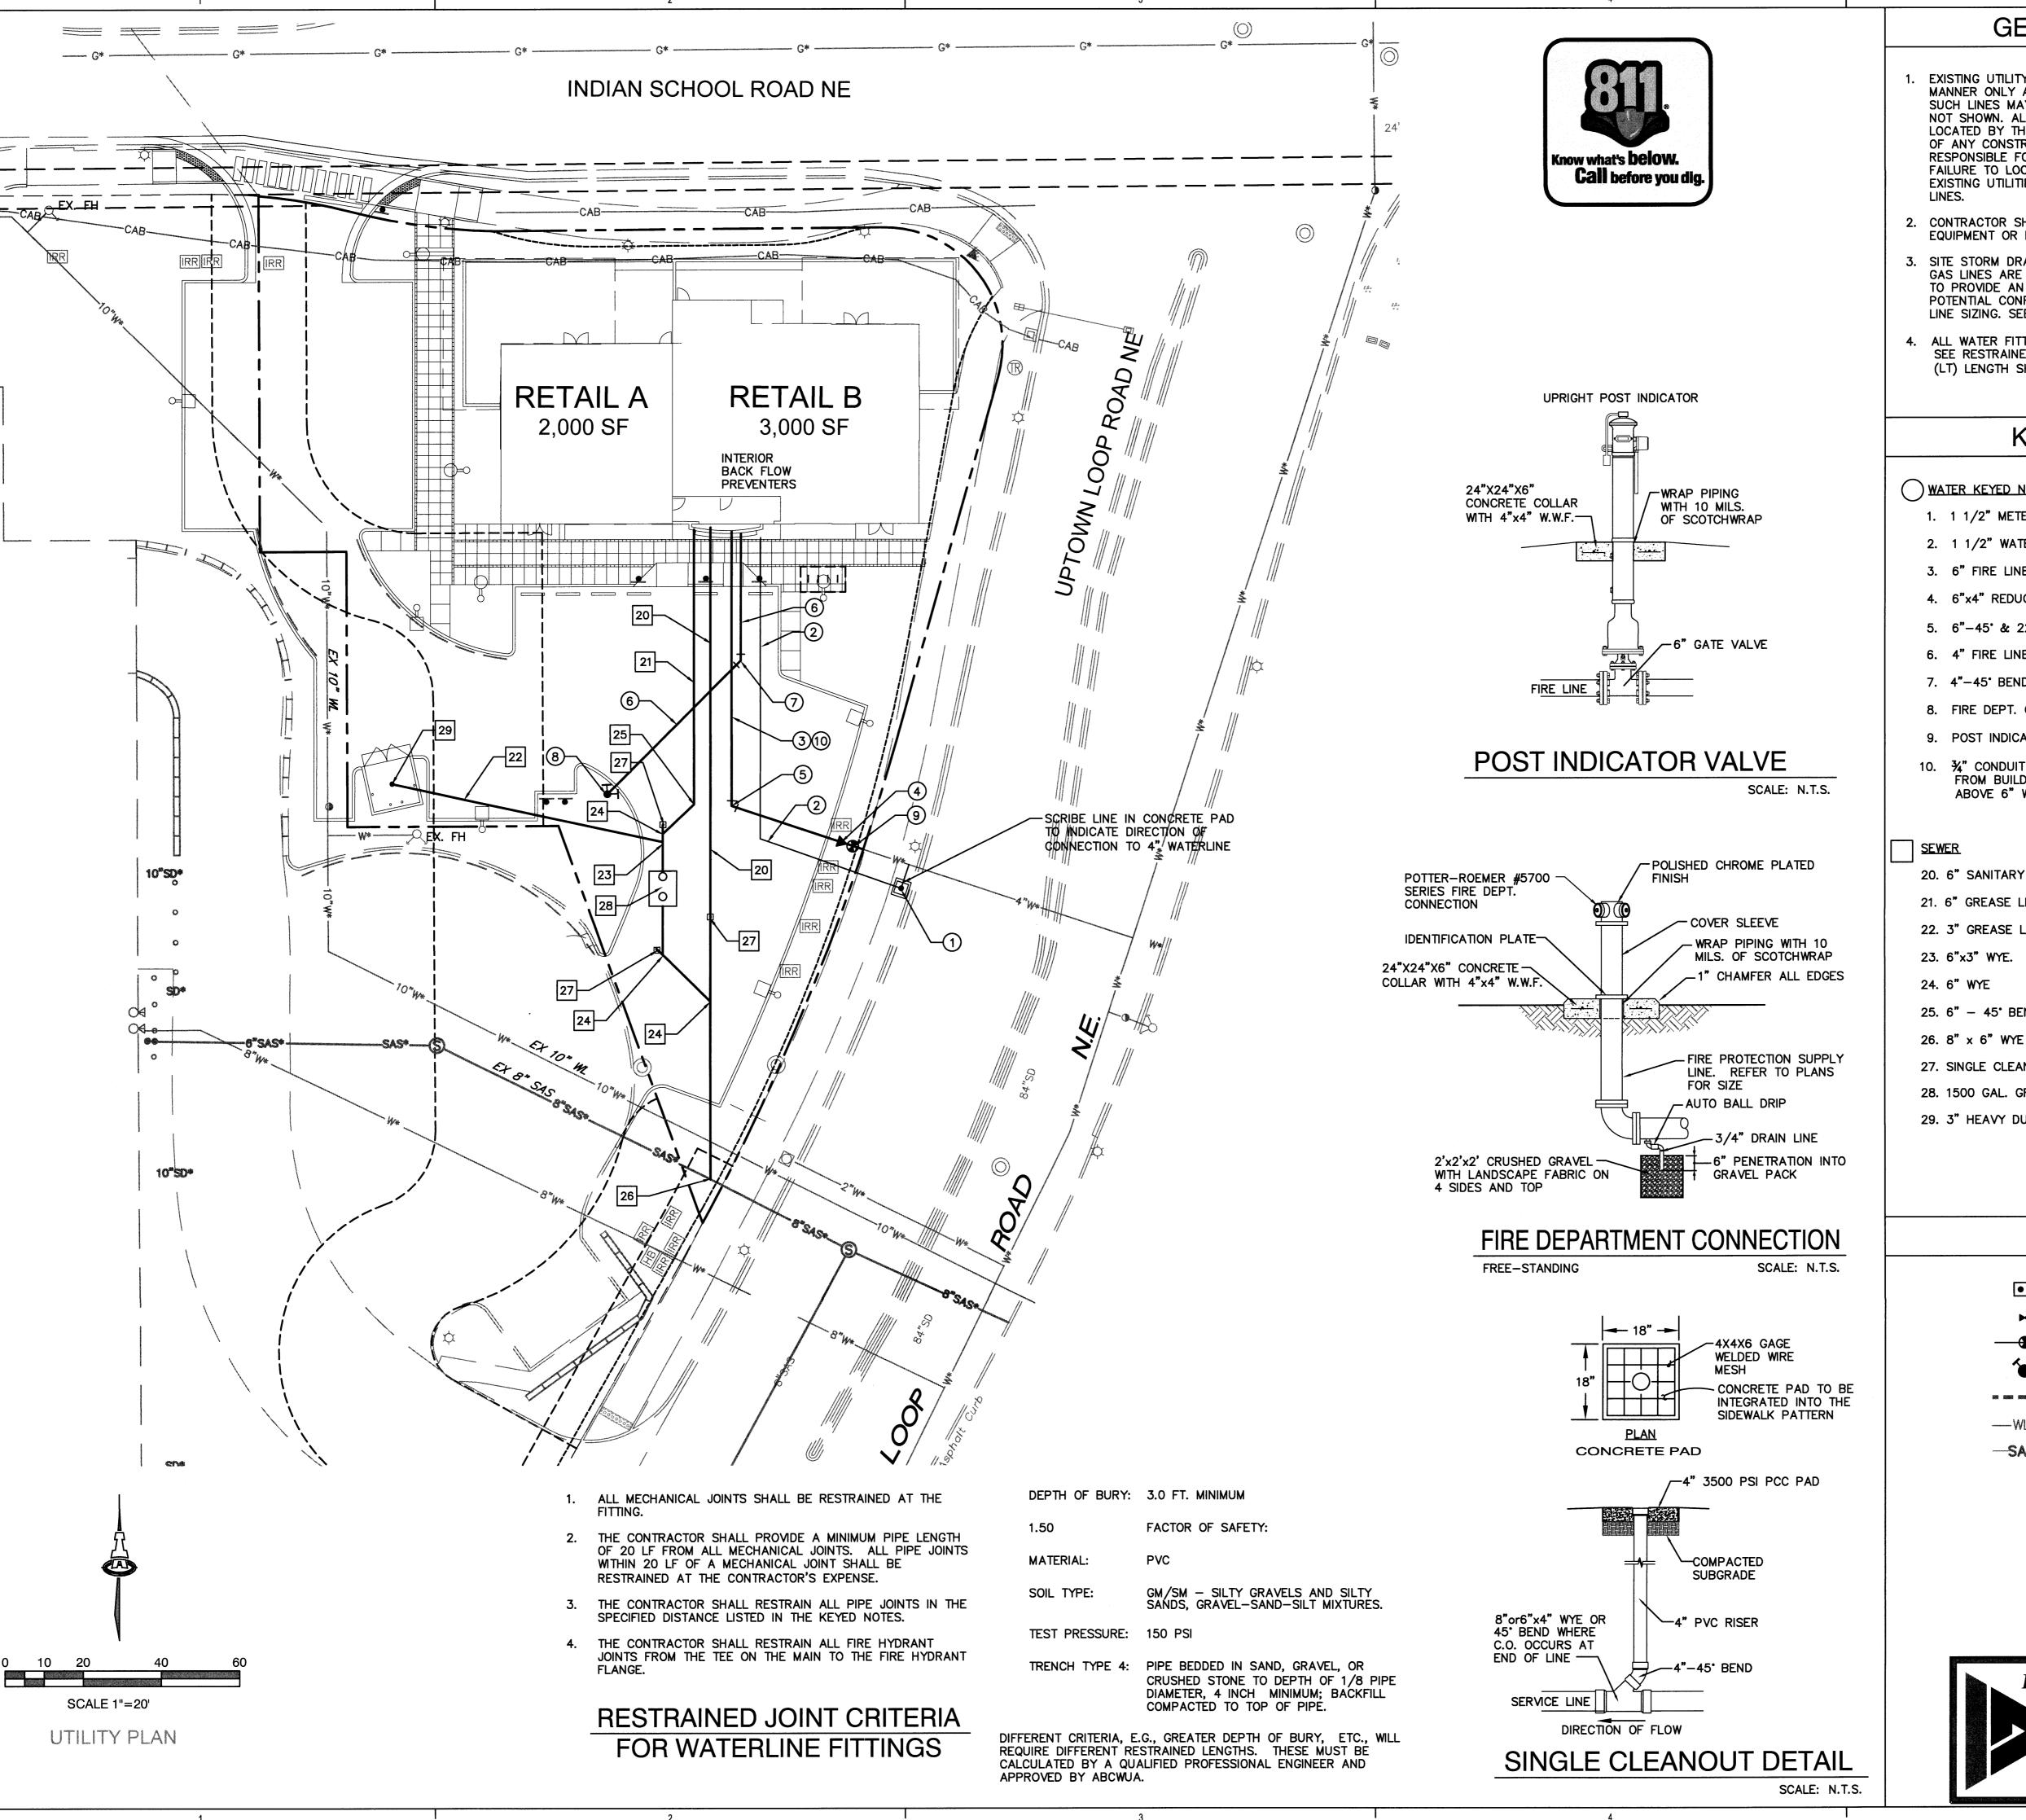
REVIEWED BY FCA 11/13/2015 DATE PROJECT NO

15-0102

DRAWING NAME

CONCEPTUAL GRADING & DRAINAGE PLAN

SHEET NO



#### **GENERAL NOTES**

- 1. EXISTING UTILITY LINES ARE SHOWN IN AN APPROXIMATE MANNER ONLY AND MAY BE INCOMPLETE OR OBSOLETE. SUCH LINES MAY OR MAY NOT EXIST WHERE SHOWN OR NOT SHOWN. ALL UTILITIES SHOULD BE FIELD VERIFIED AND LOCATED BY THE CONTRACTOR PRIOR TO COMMENCEMENT OF ANY CONSTRUCTION. THE CONTRACTOR IS FULLY RESPONSIBLE FOR ANY AND ALL DAMAGE CAUSED BY ITS FAILURE TO LOCATE, IDENTIFY AND PRESERVE ANY AND ALL EXISTING UTILITIES, PIPELINES, AND UNDERGROUND UTILITY
- 2. CONTRACTOR SHALL NOT USE VIBRATORY COMPACTION EQUIPMENT OR HEAVY VEHICLES OVER EXISTING UTILITIES.
- 3. SITE STORM DRAIN, ELECTRIC LINES & TRANSFORMERS AND GAS LINES ARE SHOWN FOR GENERAL INFORMATION ONLY TO PROVIDE AN OVERVIEW OF SITE UTILITIES AND POTENTIAL CONFLICTS. SEE MECHANICAL PLANS FOR GAS LINE SIZING. SEE CG-101 FOR STORM DRAIN DESIGN.
- 4. ALL WATER FITTINGS SHALL HAVE JOINT RESTRAINTS (LT). SEE RESTRAINED JOINT CRITERIA NOTES THIS SHEET. (LT) LENGTH SHOWN ON KEYED NOTES.

#### **KEYED NOTES**

#### WATER KEYED NOTES

- 1. 1 1/2" METER PER COA STD DWG 2363.
- 2. 1 1/2" WATER SERVICE LINE.
- 3. 6" FIRE LINE.
- 4. 6"x4" REDUCER. (LT=29')
- 5. 6"-45" & 22½" BENDS. (LT=13')
- 6. 4" FIRE LINE (FDC)
- 7. 4"-45° BEND. (LT=6')
- 8. FIRE DEPT. CONNECTION (FDC). (LT=46')
- 9. POST INDICATOR VALVE. (PIV) (LT=46')
- 10. 34" CONDUIT W/ PULL CORD FOR PIV SENSOR WIRE FROM BUILDING TO PIV PLACED IN SAME TRENCH ABOVE 6" WATERLINE.

#### SEWER

- 20. 6" SANITARY SEWER SERVICE LINE AT 2% MIN. SLOPE.
- 21. 6" GREASE LINE AT 2% MIN. SLOPE.
- 22. 3" GREASE LINE AT 2% MIN. SLOPE.
- 23. 6"x3" WYE.
- 24. 6" WYE
- 25. 6" 45° BEND.
- 27. SINGLE CLEANOUT.
- 28. 1500 GAL. GREASE INTERCEPTOR.
- 29. 3" HEAVY DUTY CAST IRON FLOOR DRAIN W/ P-TRAP.

#### **LEGEND**

SAS SINGLE CLEANOUT

GATE VALVE W/ BOX

POST INDICATOR VALVE

FIRE DEPARTMENT CONNECTION

PROPOSED STORM DRAIN

SAS EXISTING SEWER LINE

ISAACSON & ARFMAN, P.A. Consulting Engineering Associates 128 Monroe Street N.E. Albuquerque, New Mexico 87108 Ph. 505-268-8828 www.iacivil.com Jan 28,2016

DEKKER PERICH SABATINI

ARCHITECTURE / DESIGN / INSPIRATION

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505.761.9700 / DPSDESIGN.ORG

PROJECT

O N N N SH QUE, UPTOWN

**URT REVIEW** 

**REVISIONS** 


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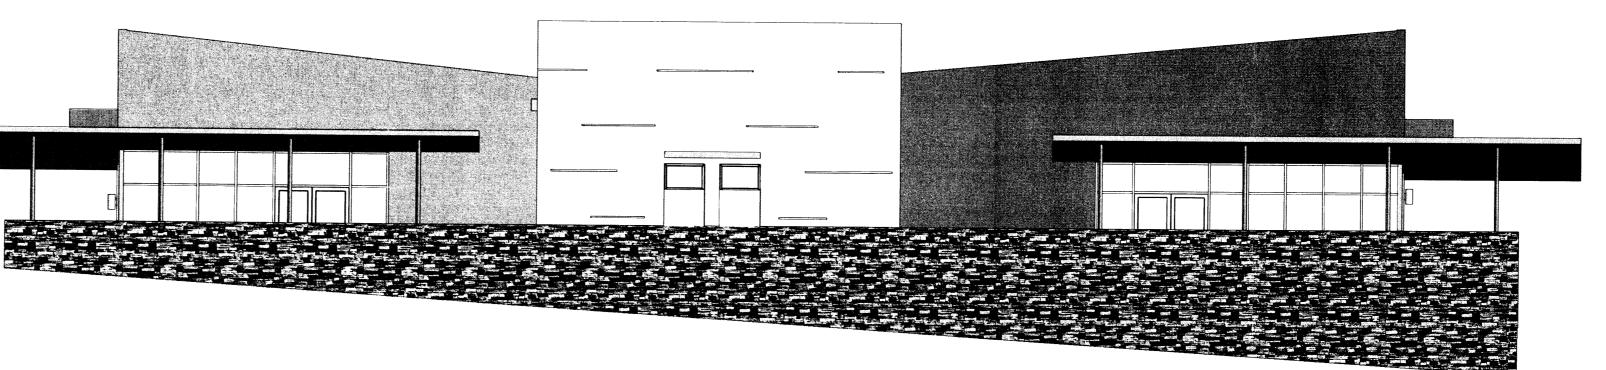
UTILITY PLAN

SHEET NO





07 of 11

15-0102

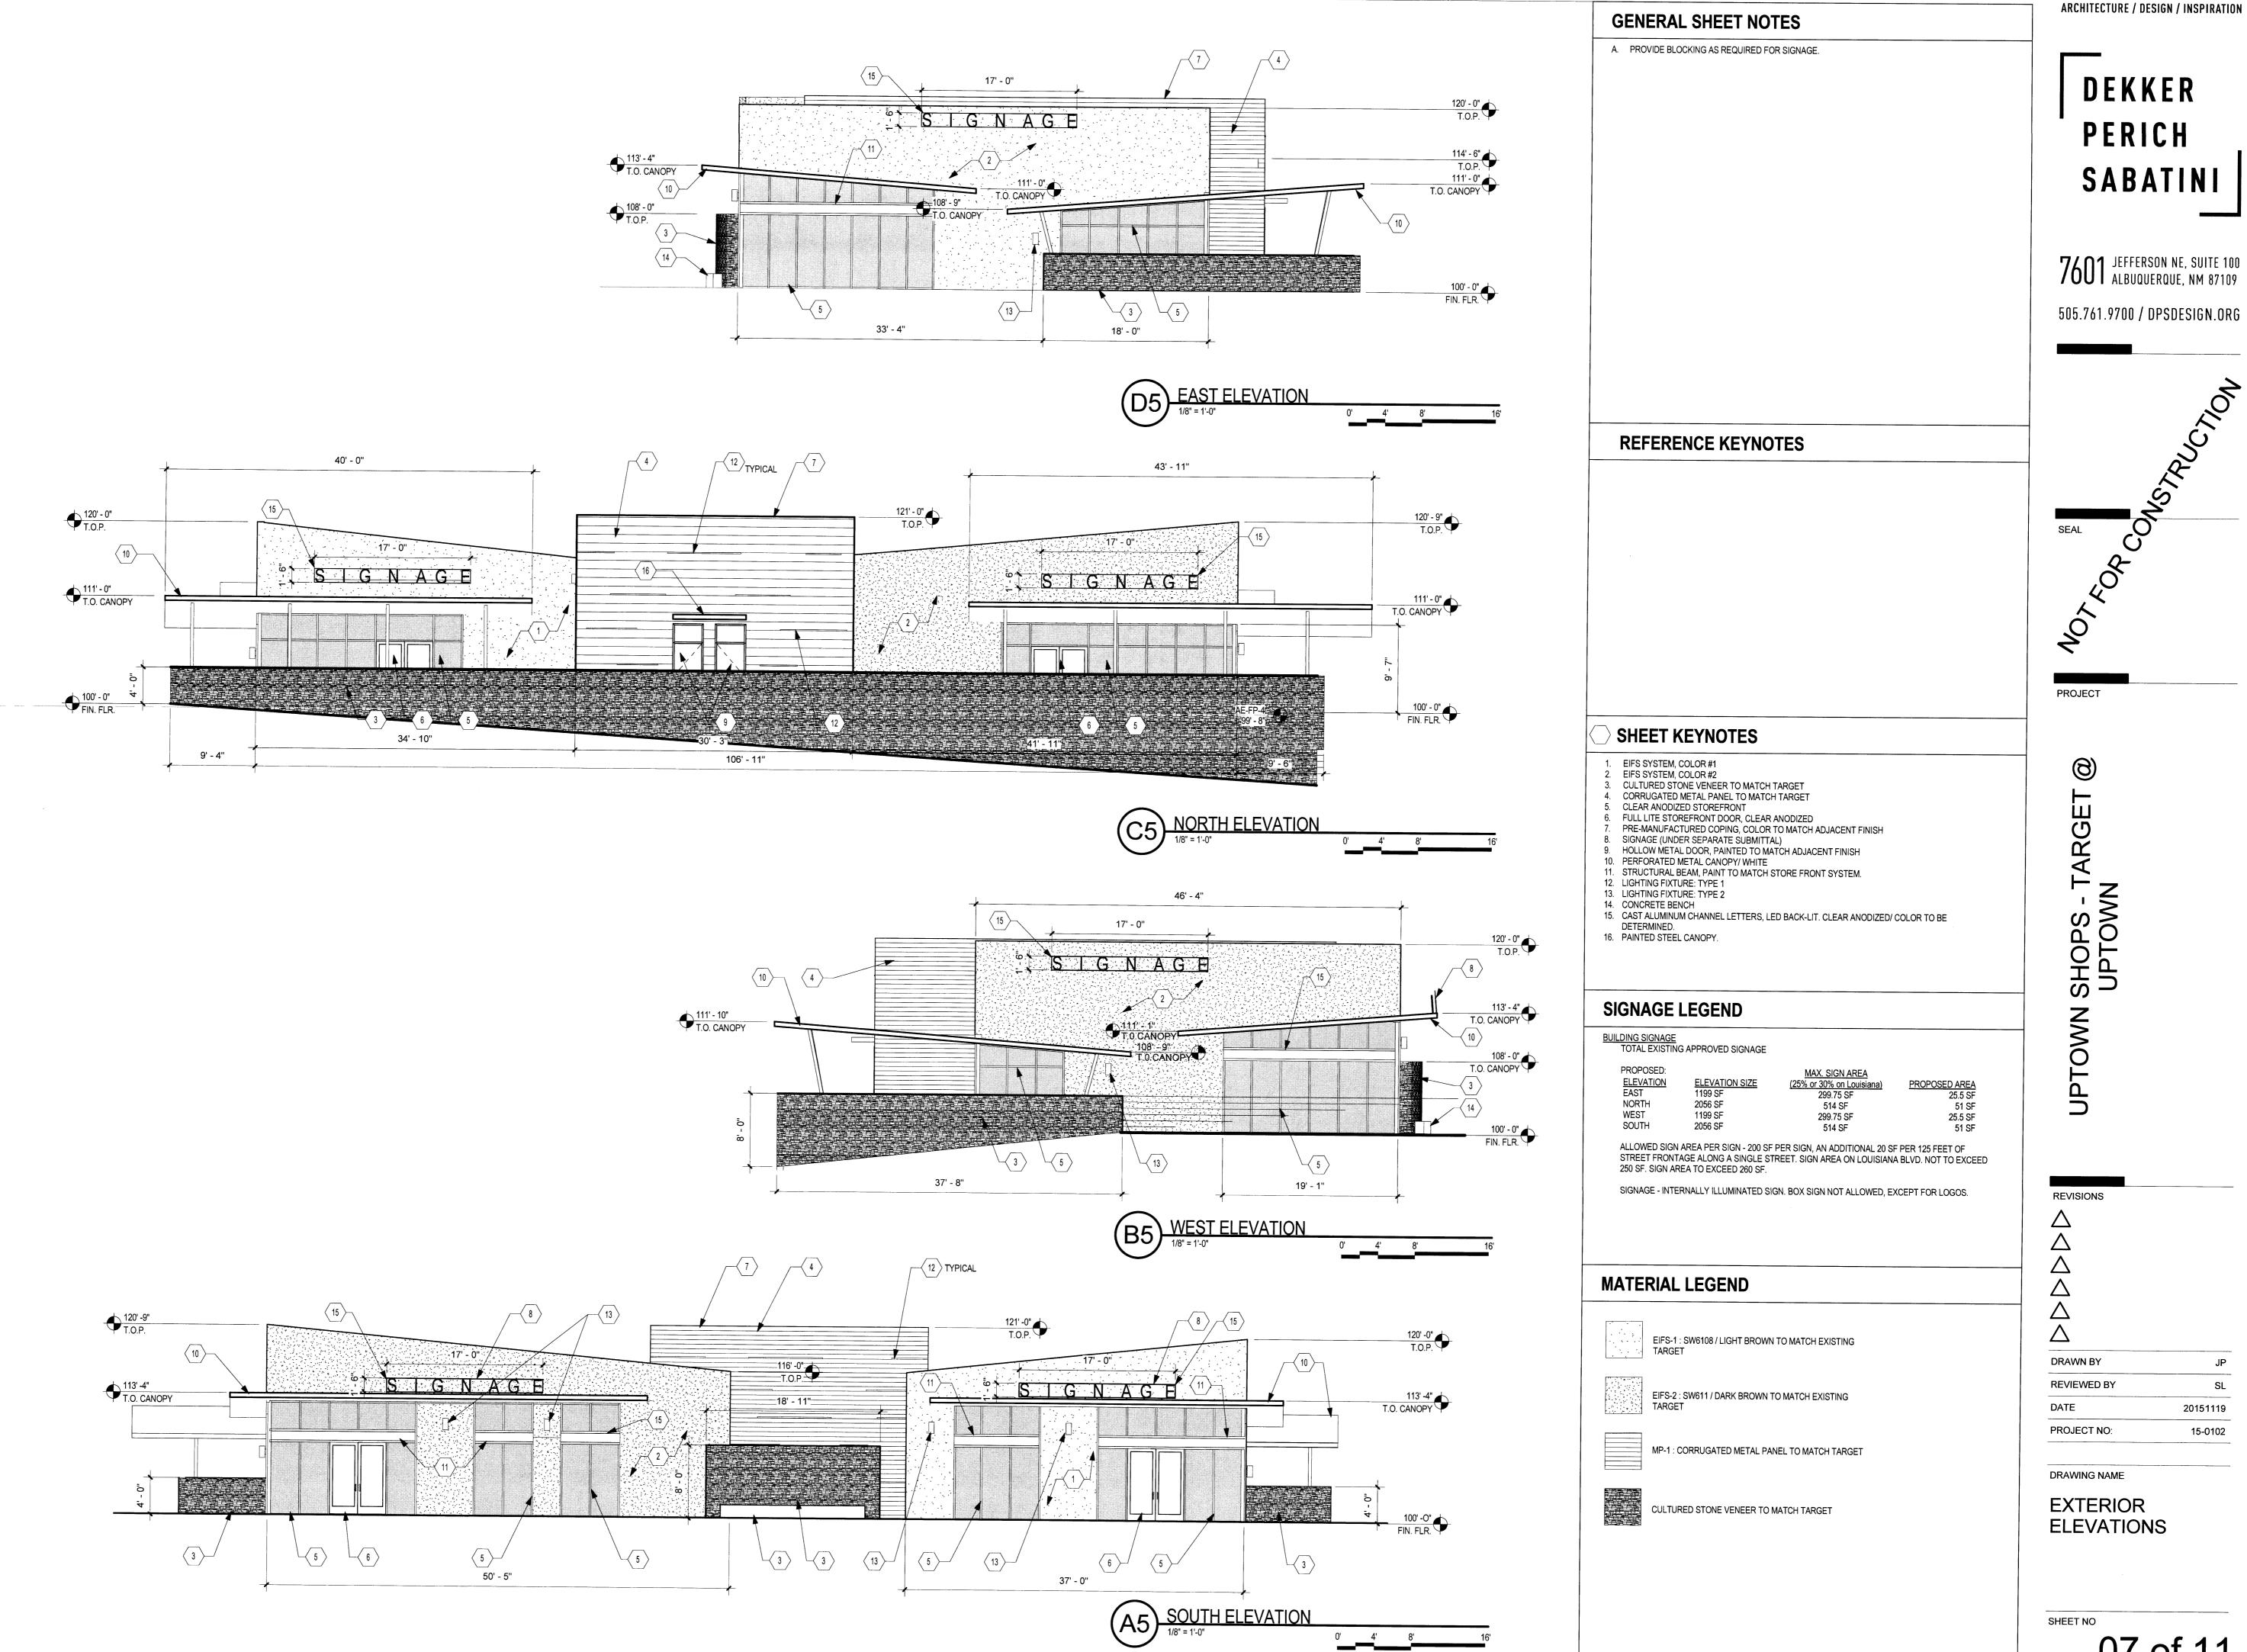



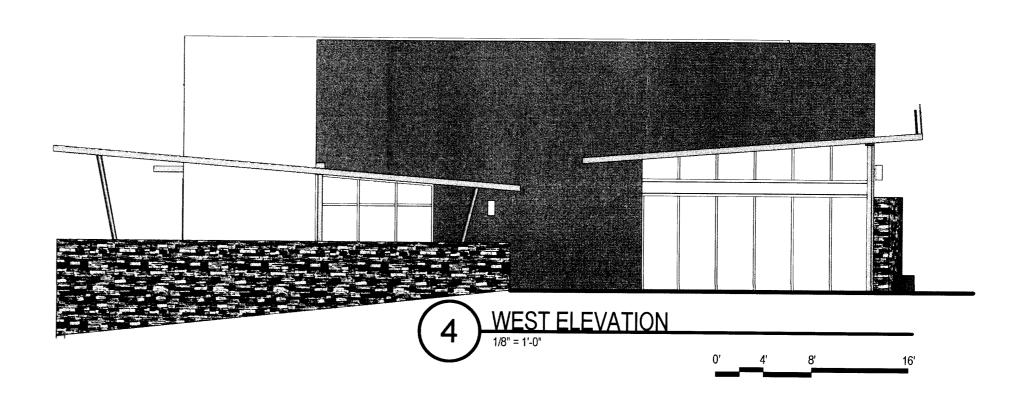

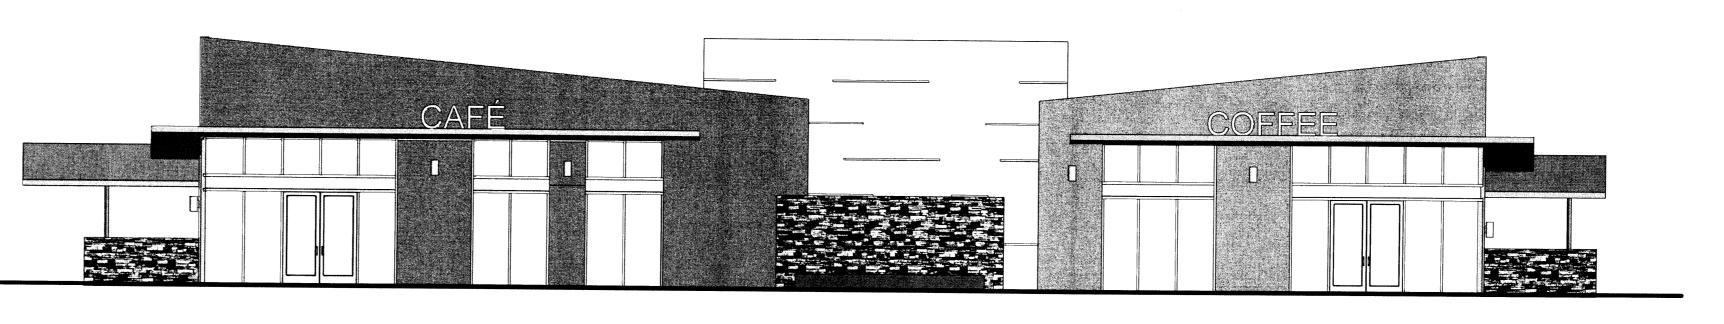

3 SOUTH ELEVATION

1/8" = 1'-0"


0' 4'

ARCHITECTURE / DESIGN / INSPIRATION

# DEKKER PERICH SABATINI

7601 JEFFERSON NE, SUITE 100 ALBUQUERQUE, NM 87109

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PROJECT

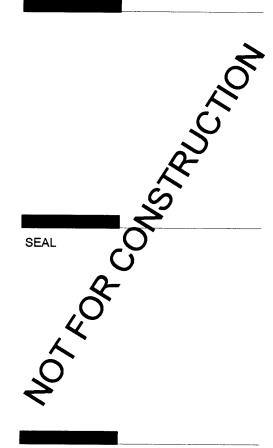TOWN SHOPS - TARGET @

REVISIONS  A  A  A  A	
DRAWN BY	
REVIEWED BY	***************************************
	2015
DATE	2015

EXTERIOR ELEVATIONS (COLOR)

SHEET NO

08 of 11


PROJECT

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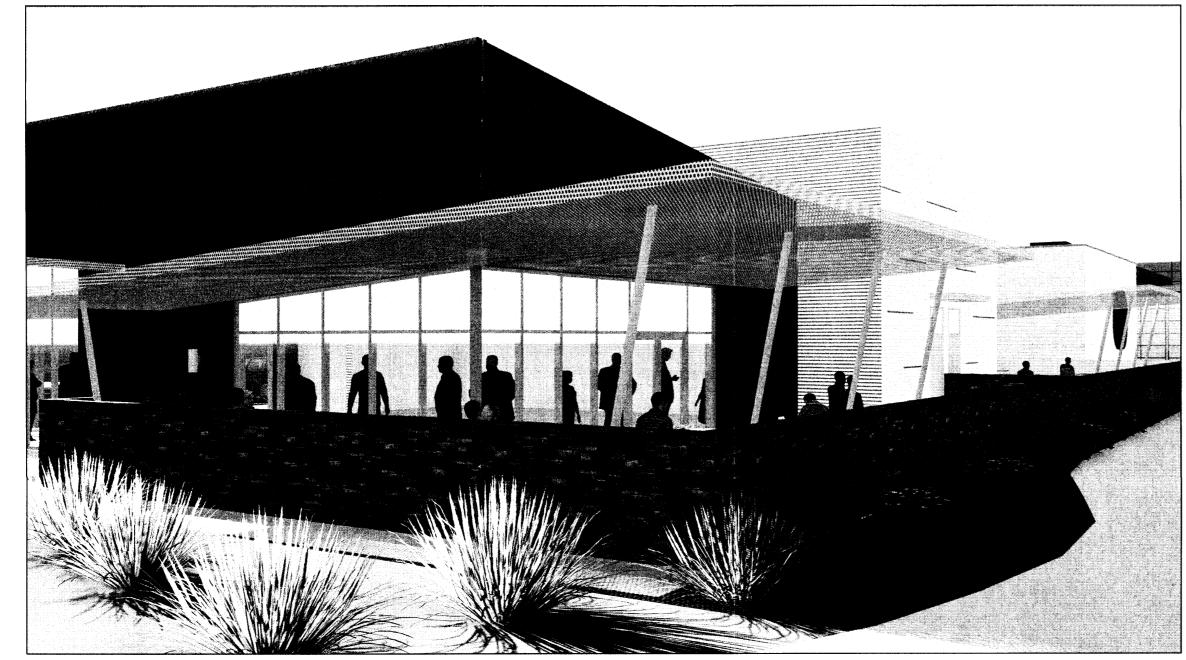
RENDERINGS



VIEW LOOKING NORTHWEST

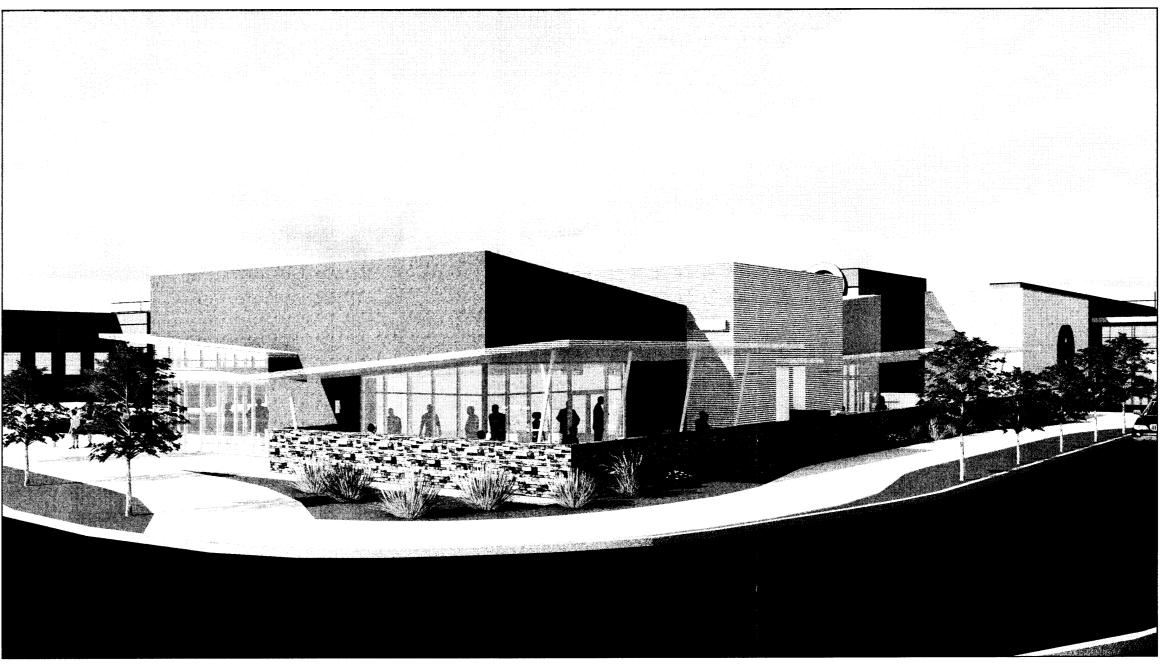

VIEW LOOKING SOUTHWEST



VIEW LOOKING SOUTHWEST



VIEW LOOKING NORTHWEST

NOTE: THE IMAGES ABOVE ARE CONCEPTUAL IN NATURE AND MAY NOT REFLECT THE REQUIREMENTS OF THESE DRAWINGS.