

DEKKER
PERICH
SABATINI

7601 JEFFERSON NE, SUITE 100 ALBUQUERQUE, NM 87109

PROJECT

Cooper SUBMIT

Q Q

Presbyte ministrative

/1\ 1/5/2016 ADD STORM EVENT NOTE

1/20/2016 DRB COMMENTS

**REVISIONS** 

**DRAWN BY** 

DATE

**REVIEWED BY** 

PROJECT NO

**DRAWING NAME** 

PLAN - AREA A

SITE DEVELOPMENT

505.761.9700 / DPSDESIGN.ORG

SHEET NO

A1a

12/03/2015

15-0129

P:\20160235\CDP\Plans\General\DRB Plans\20160235gp02.dwg Mon, 25—Jan—2016 — 10:46:am, Plotted by: BORTEGA DEKKER
PERICH
SABATINI

ARCHITECTURE / DESIGN / INSPIRATION

7601 JEFFERSON NE, SUITE 100 ALBUQUERQUE, NM 87109

505.761.9700 / DPSDESIGN.ORG

SEAL

PROJECT

Presbyterian Rev. Hugh Cooper ninistrative Center - DRB SUBMITTAL

DEVISIONS

REVISIONS

01/22/2016 DRB COMMENTS

DRAWN BY BO
REVIEWED BY GSB
DATE 01/22/2016
PROJECT NO 15-0129

DRAWING NAME

GRADING PLAN


SHEET NO

Bohannan A Huston

www.bhinc.com

800.877.5332

C102

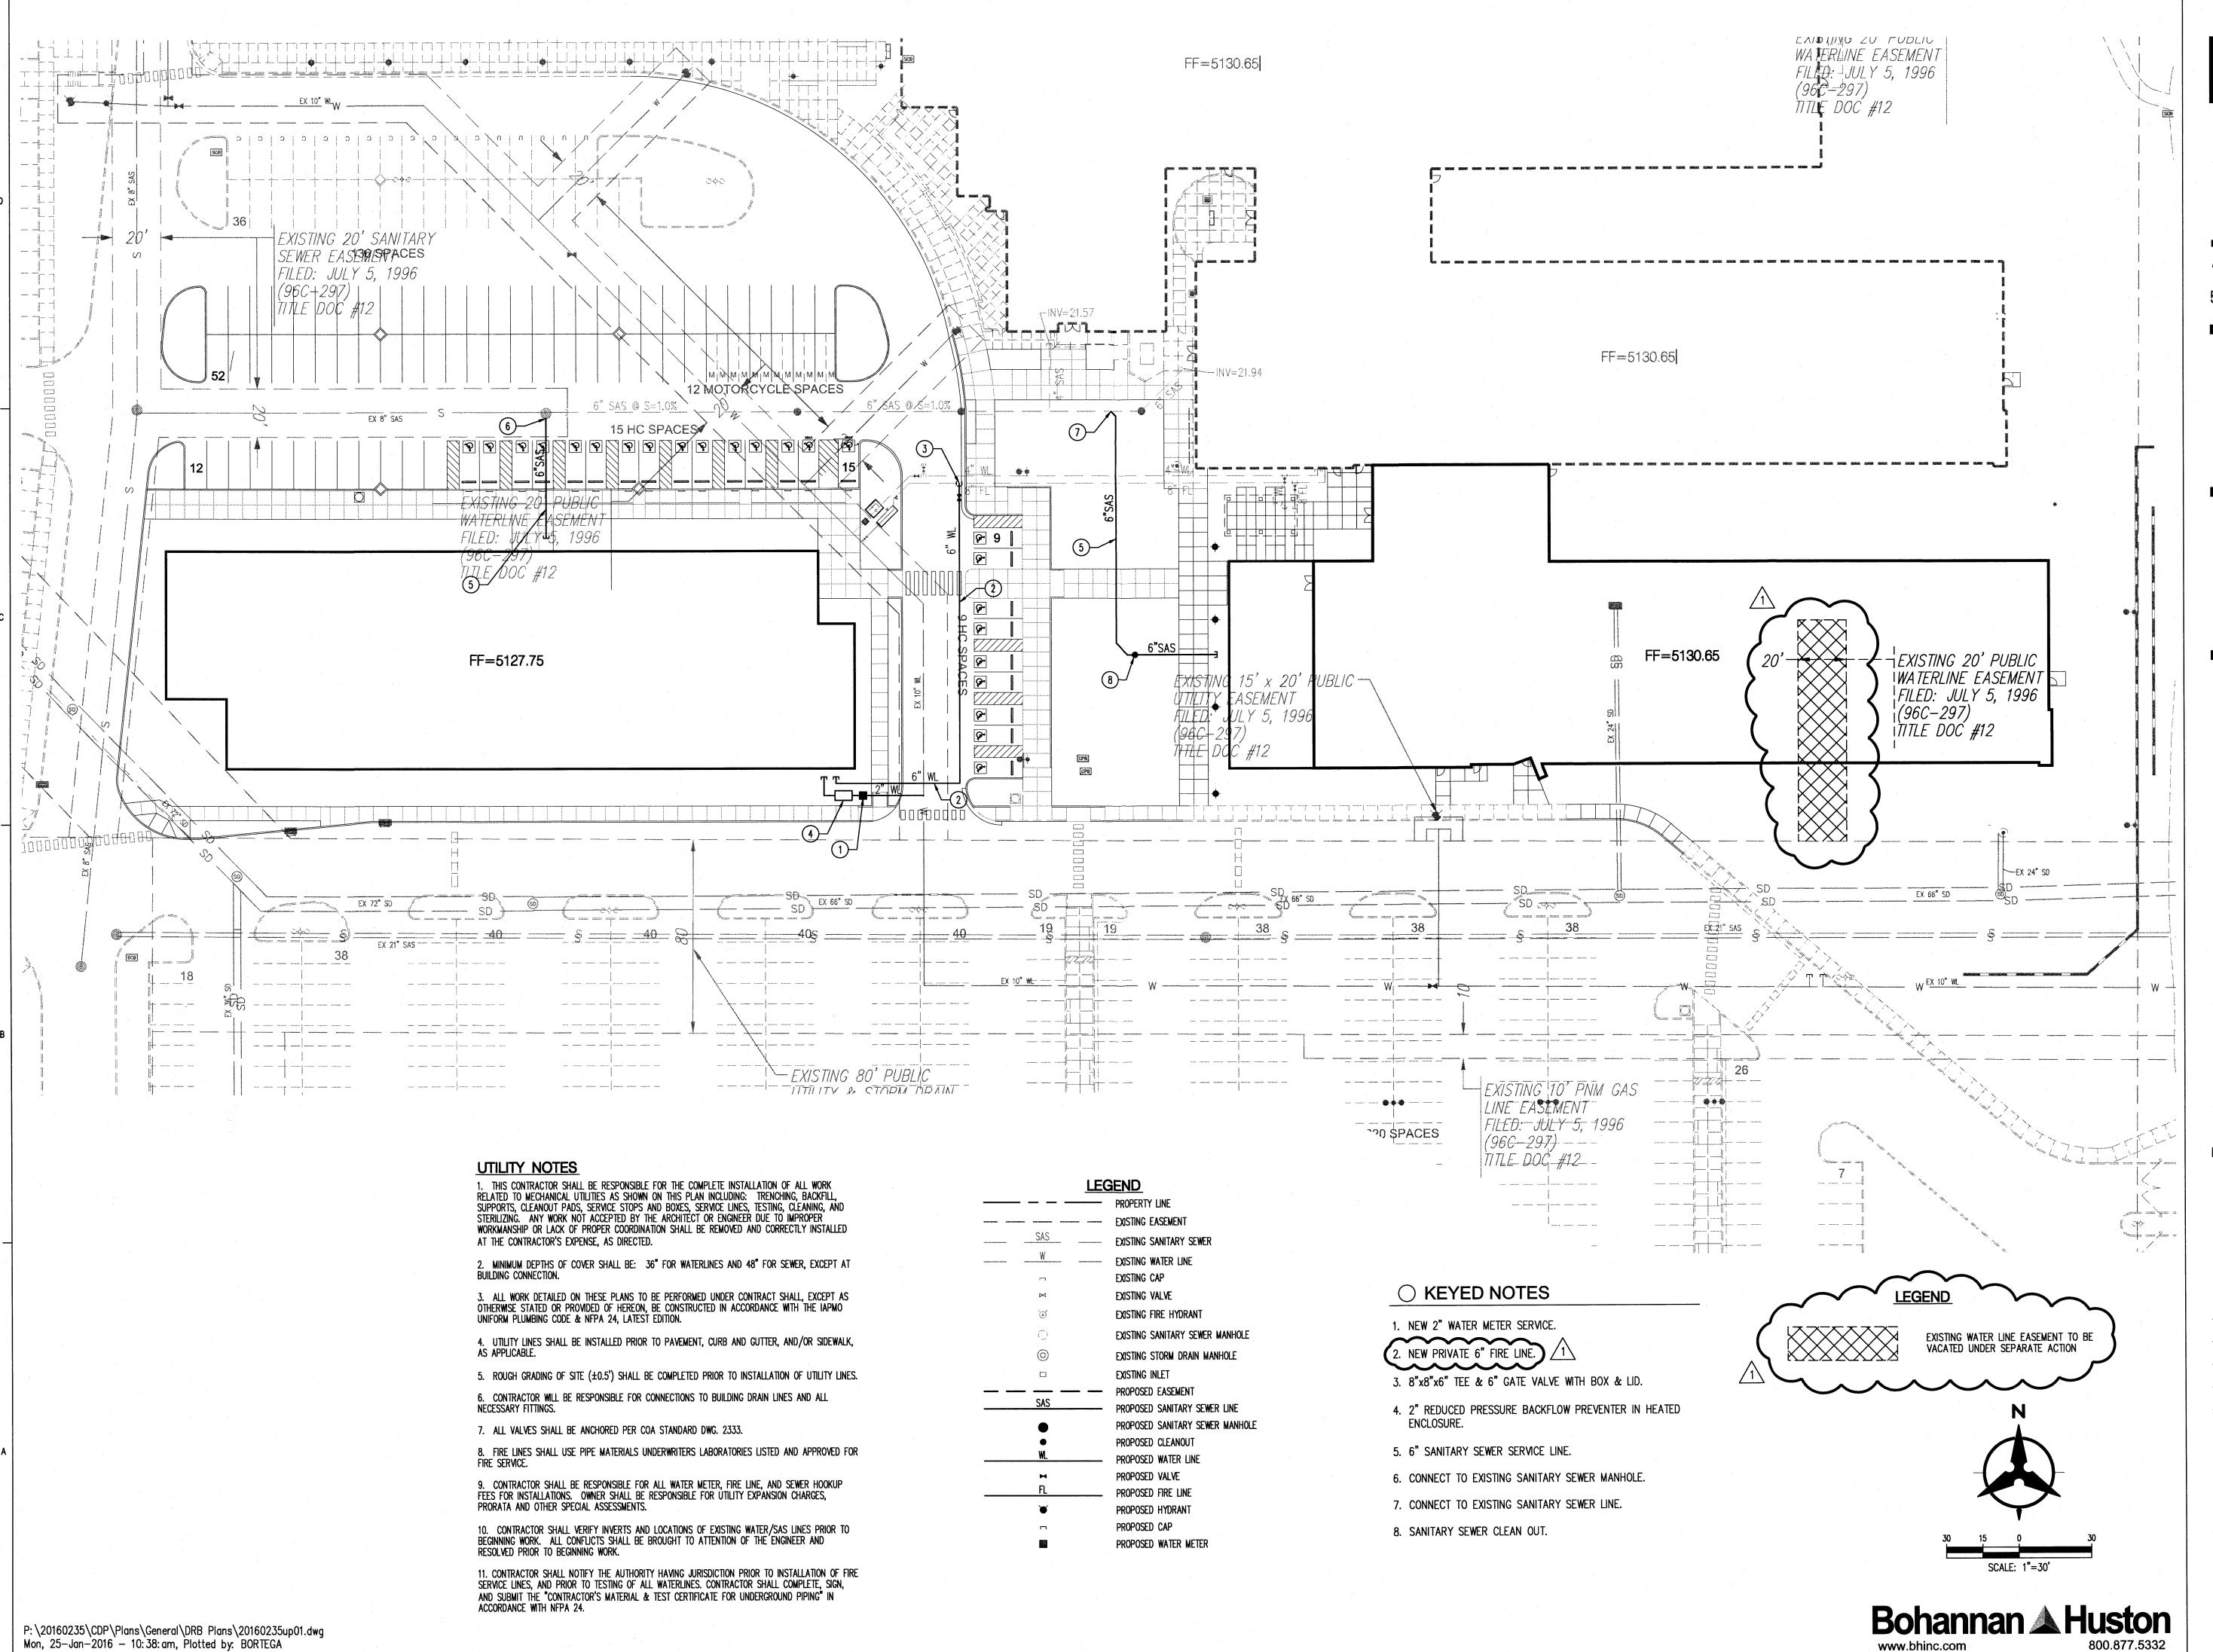

# DEKKER PERICH SABATINI

7601 JEFFERSON NE, SUITE 100 ALBUQUERQUE, NM 87109

505.761.9700 / DPSDESIGN.ORG

SEAL

PROJECT

Presbyterian Rev. Hugh Cooper dministrative Center - DRB SUBMITTAI 9521 San Mateo NE Albuquerque, New Mexico

REVISIONS

01/22/2016 DRB COMMENTS

 DRAWN BY
 BO

 REVIEWED BY
 GSB

 DATE
 01/22/2016


 PROJECT NO
 15-0129


DRAWING NAME


UTILITY PLAN

SHEET NO

C20

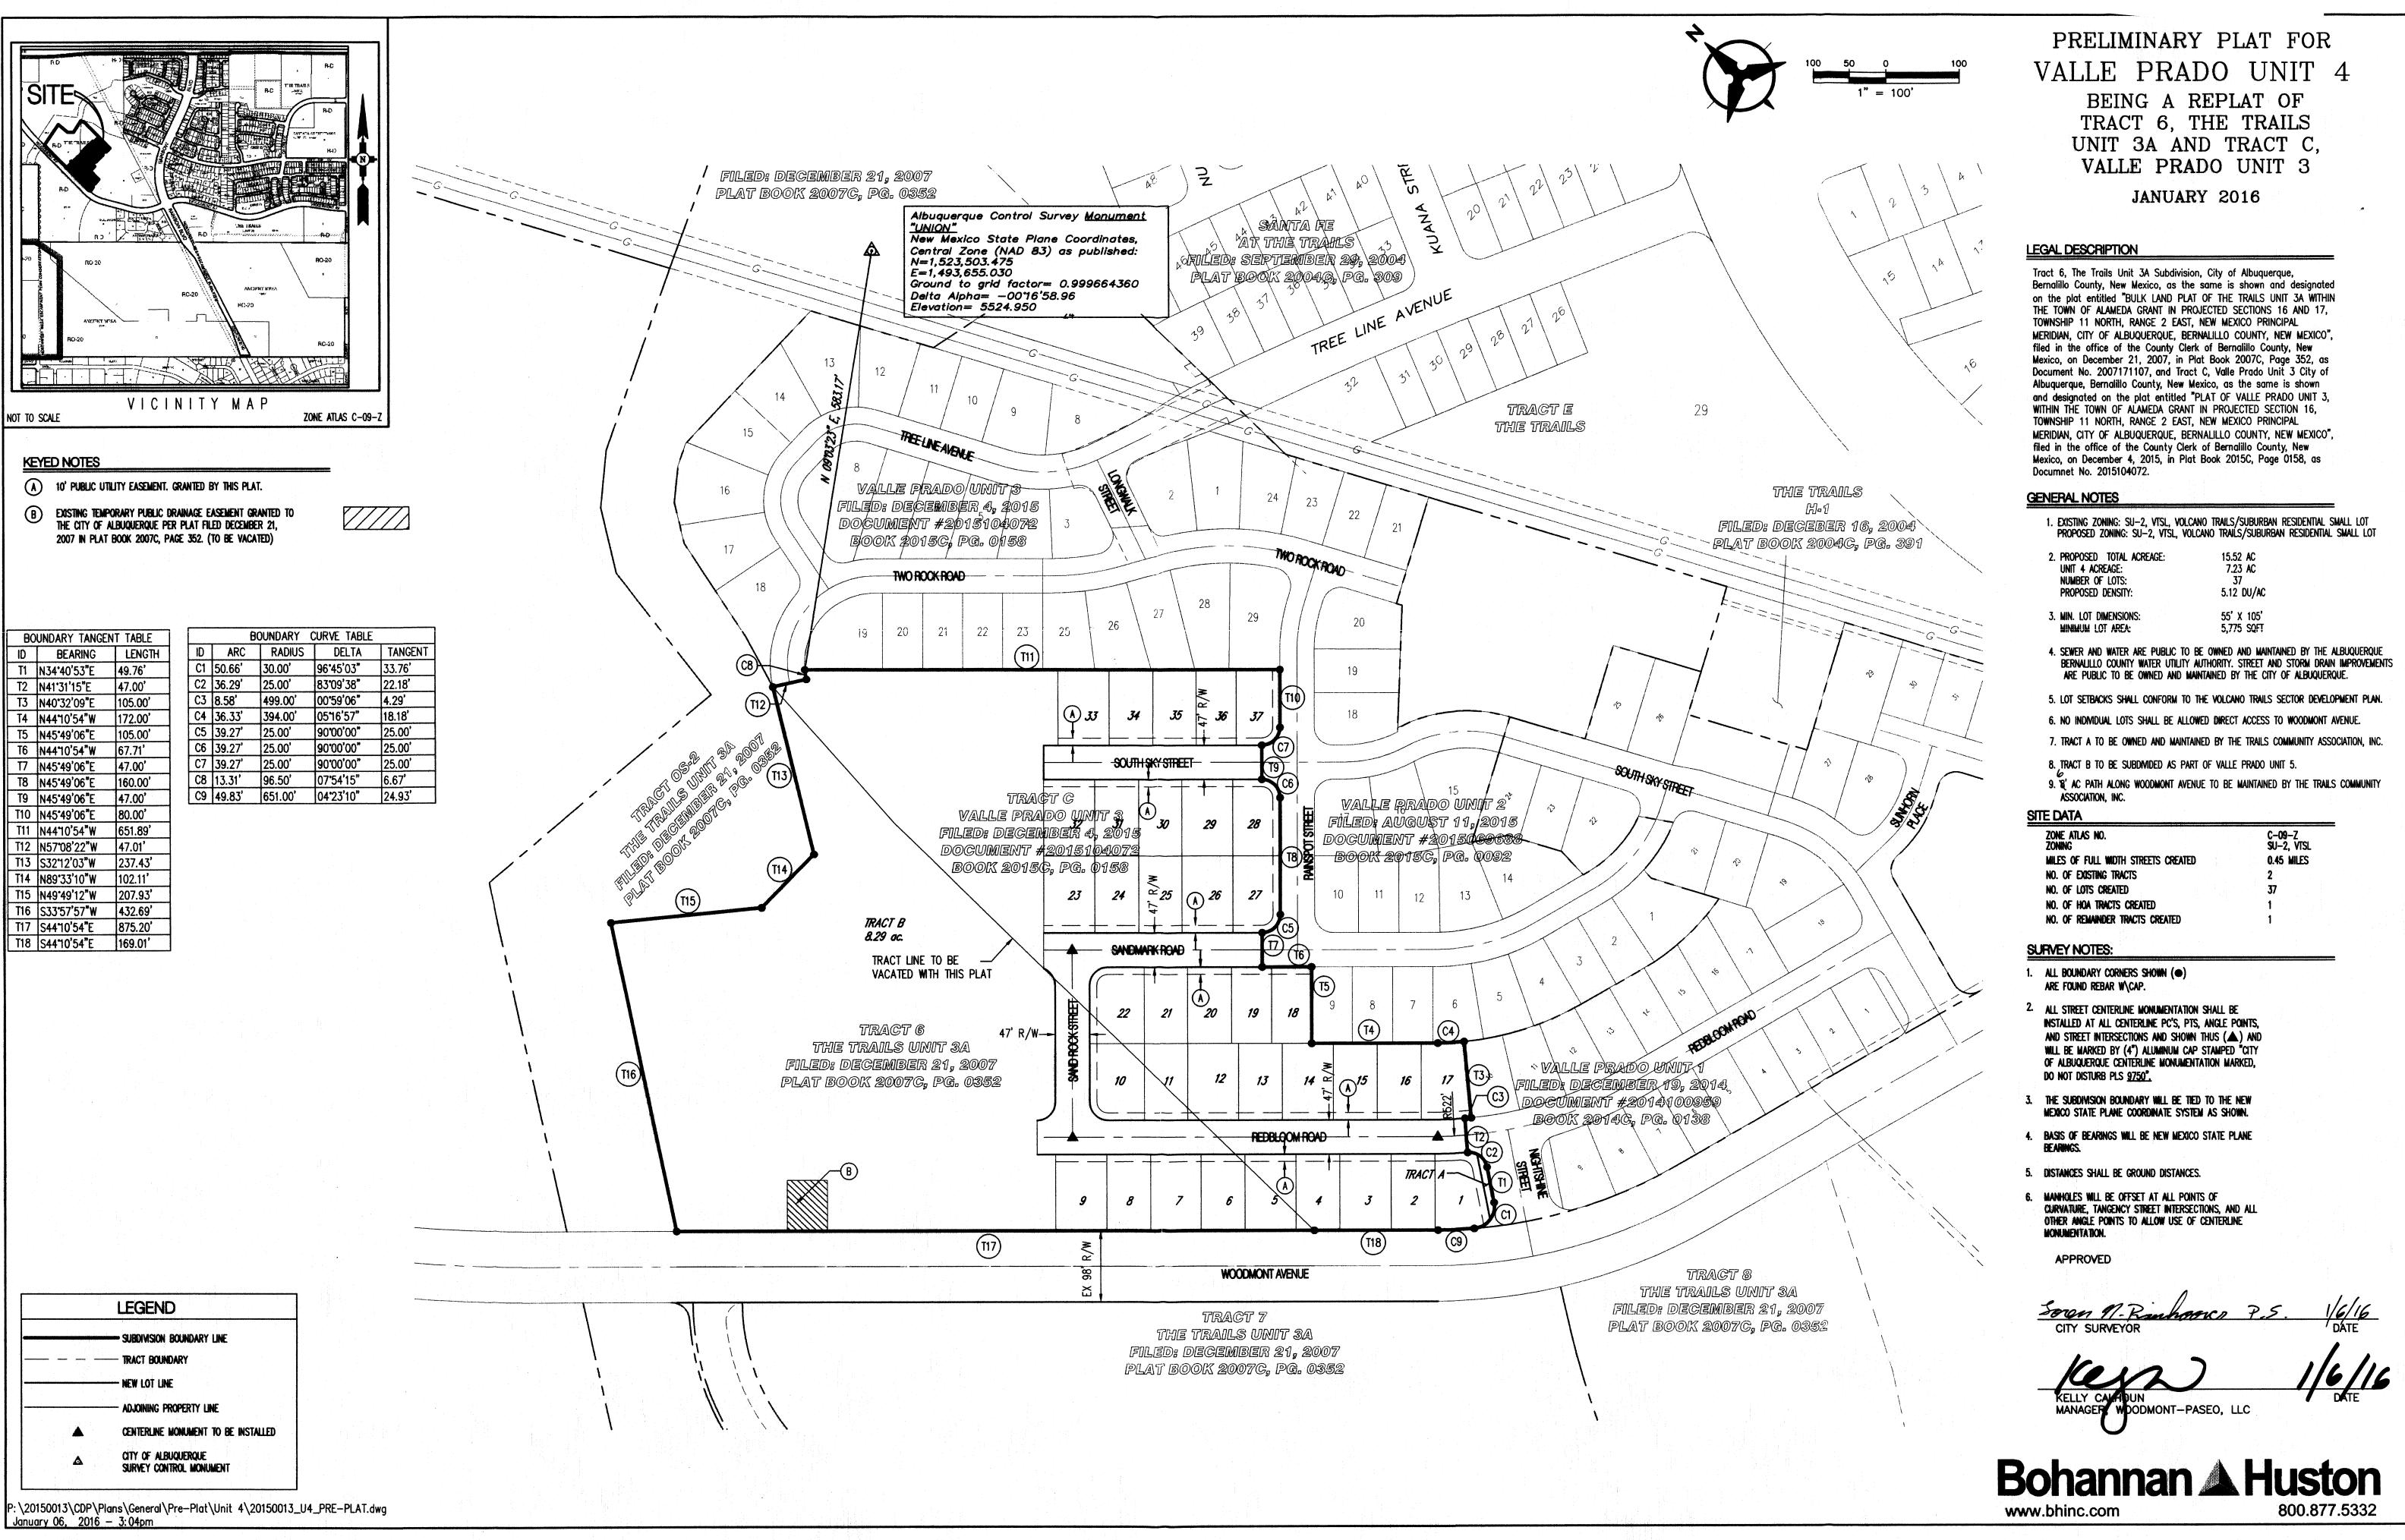

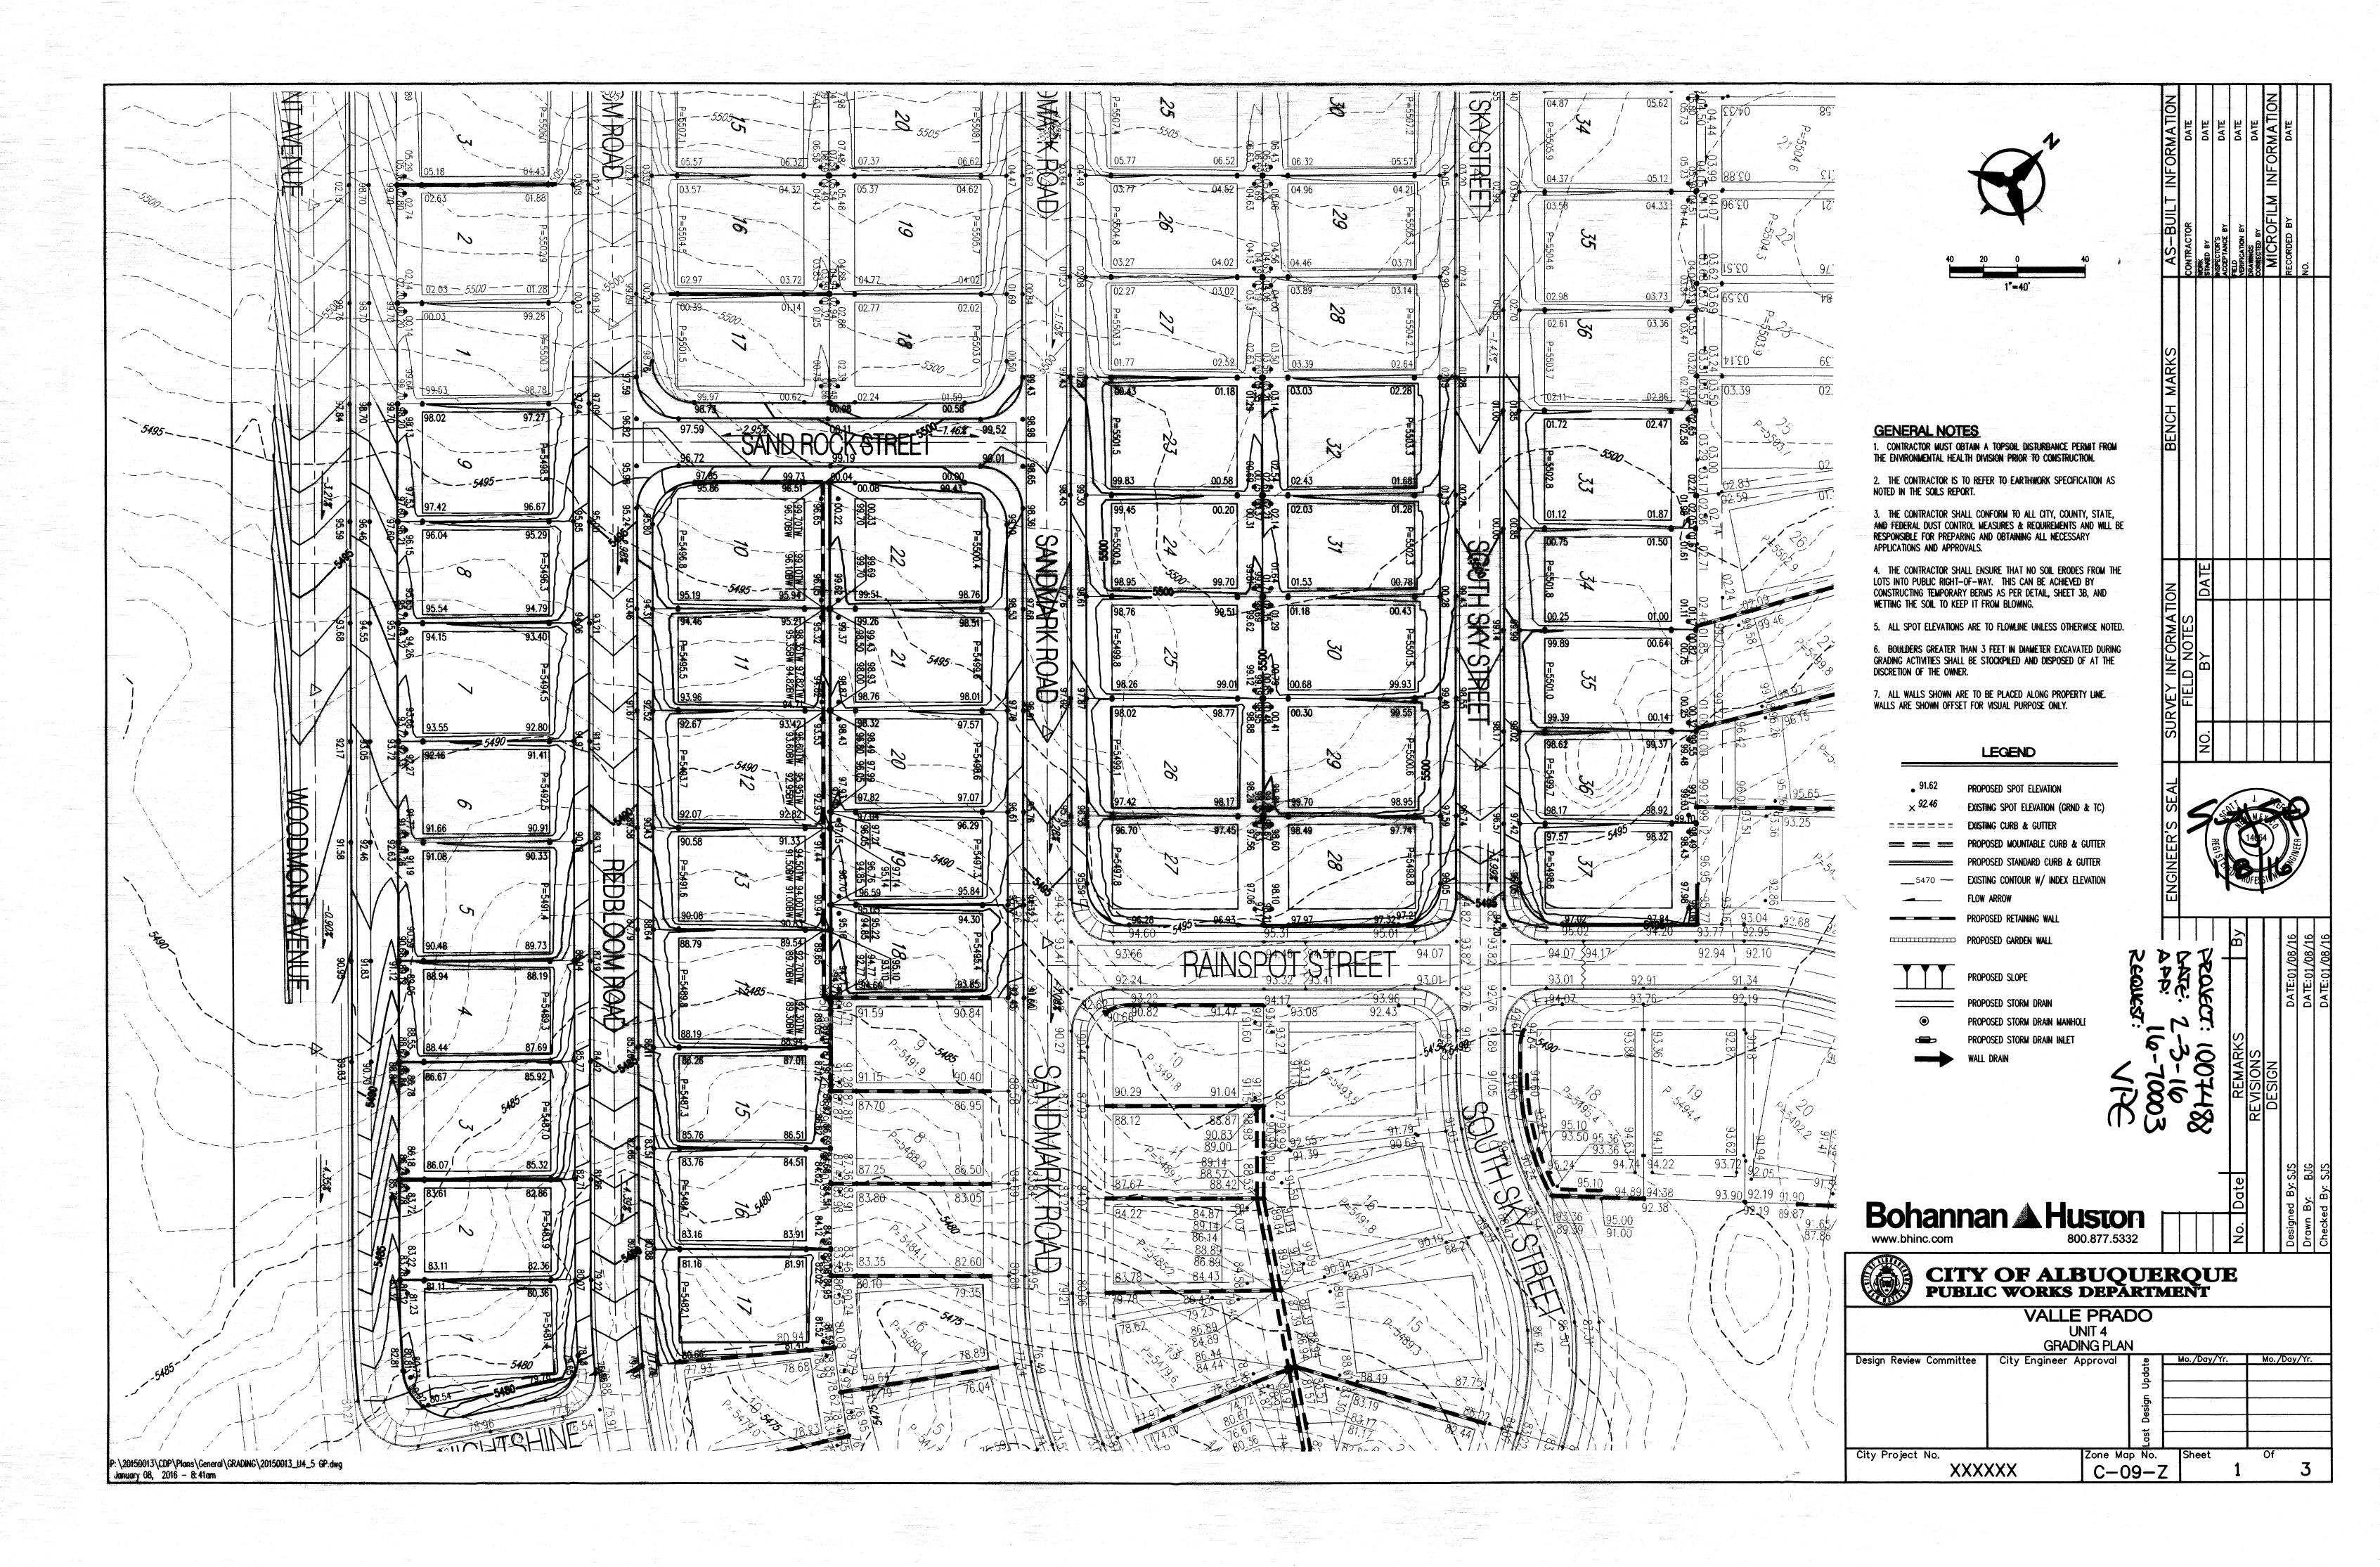

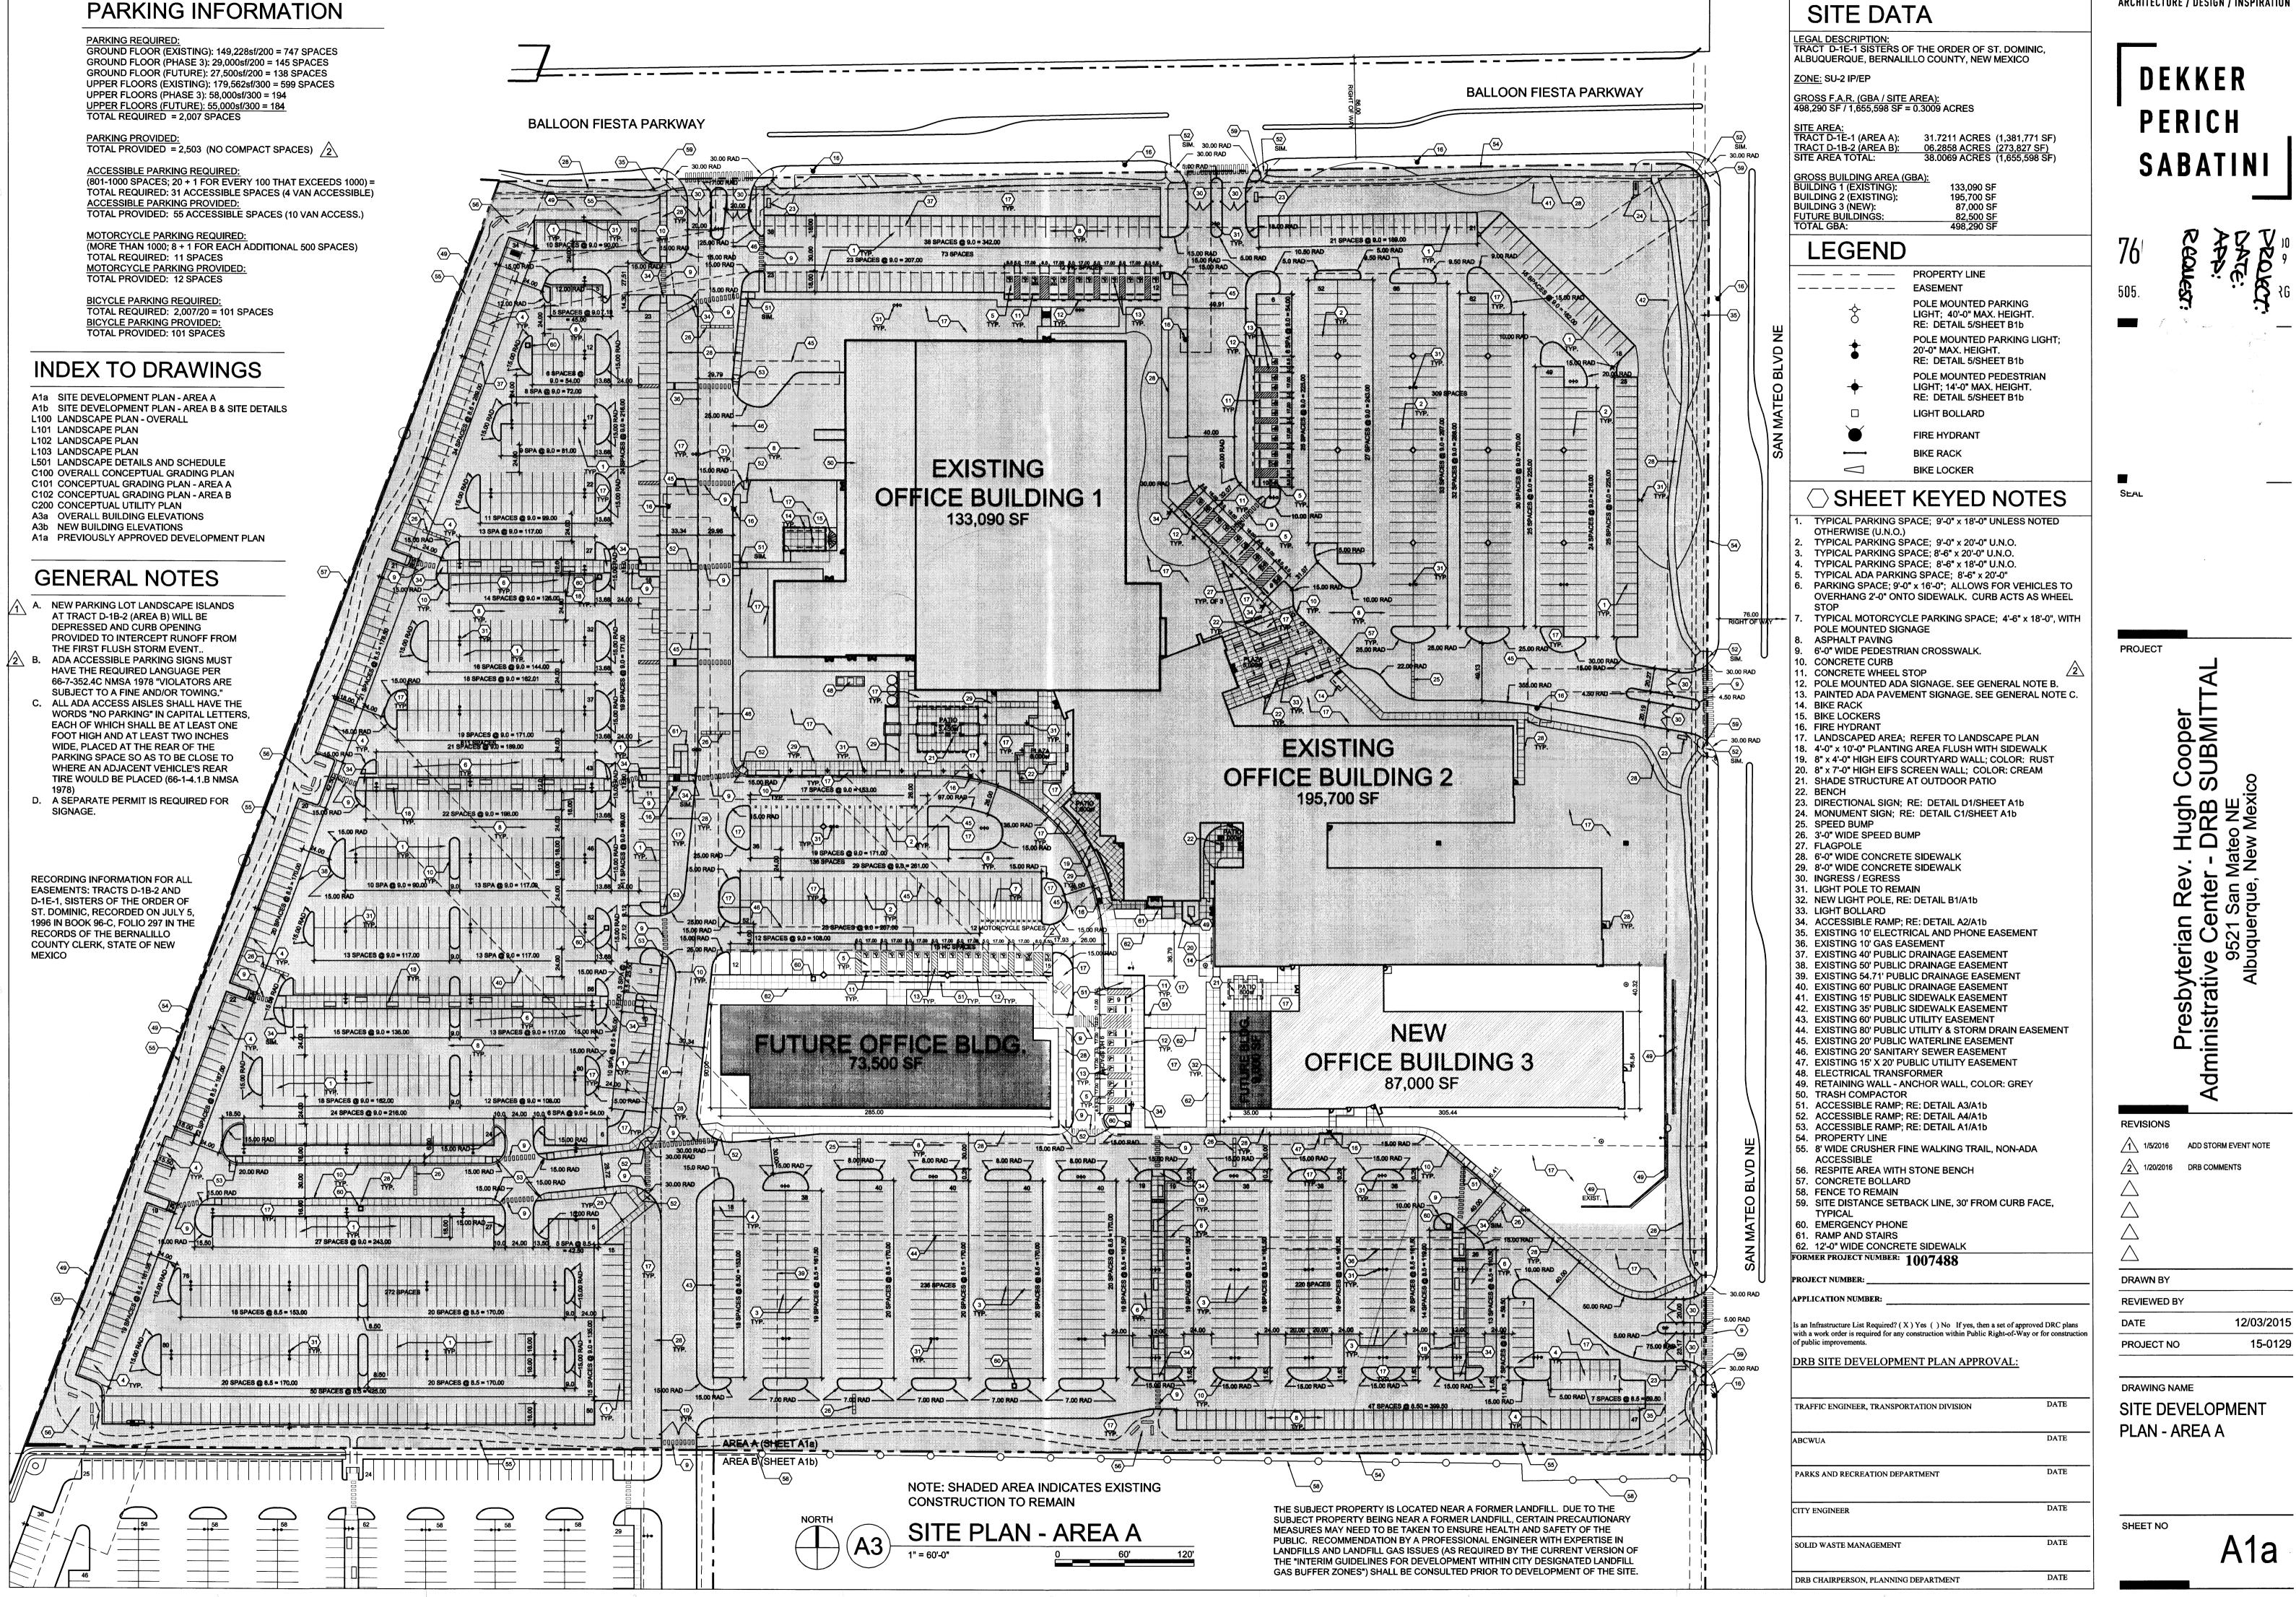


DEKKER PERICH SABATINI

1/5/2016 ADD STORM EVENT NOTE

SITE DEVELOPMENT

15-0129



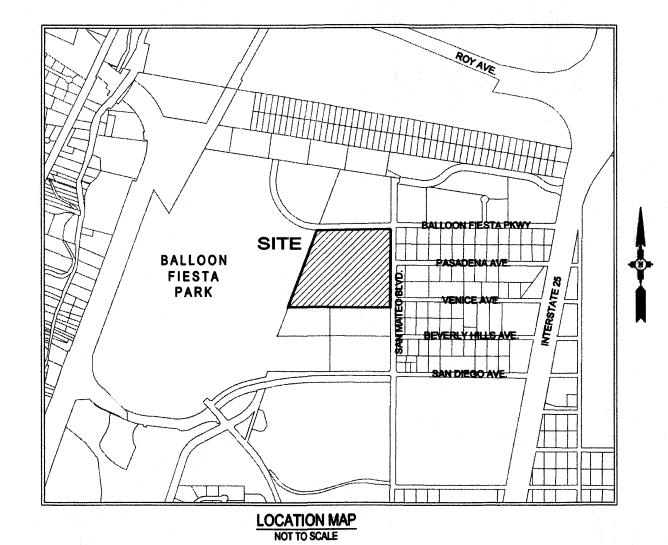

### **SUBDIVISION DATA**

- 1. DRB No. 1007488.
- 2. Zone Atlas Index Number: B-17.
- 3. Zoning: IP
- 4. Gross Subdivision Acreage: 31.7211 Acres.
- 5. Total number of Lots/Tracts Created: 1
- 6. Easement vacated by Vacation Action
- 8. Date of Survey: January 14, 2016.
- 9. Plat is located within the Elena Gallegos Grant, Projected Section 11, Township 11 North, Range 3 East, New Mexico Principal Meridian, Bernalillo County, City of Albuquerque, New Mexico.

### **PURPOSE OF PLAT**

The purpose of this Plat is to Vacate an existing waterline easement.

### **PUBLIC UTILITY EASEMENTS**

PUBLIC UTILITY EASEMENTS shown on this plat are granted for the common and joint use of:

- A. Public Service Company of New Mexico ("PNM"), a New Mexico corporation, (PNM Electric) for installation, maintenance, and service of overhead and underground electrical lines, transformers, and other equipment and related facilities reasonably necessary to provide electrical services.
- B. New Mexico Gas Company for installation, maintenance, and service of natural gas lines, valves and other equipment and facilities reasonably necessary to provide natural gas.
- C. Qwest Corporation d/b/a CenturyLink QC for the installation, maintenance, and service of such lines, cable, and other related equipment and facilities reasonably necessary to provide communication services.
- D. Cable TV for the installation, maintenance, and service of such lines, cable, and other related equipment and facilities reasonably necessary to provide Cable services.

included, is the right to build, rebuild, construct, reconstruct, locate, relocate, change, remove, replace, modify, renew, operate and maintain facilities for purposes described above, together with free access to, from, and over said easements, with the right and privilege of going upon, over and across adjoining lands of Grantor for the purposes set forth herein and with the right to utilize the right of way and easement to extend services to customers of Grantee, including sufficient working area space for electric transformers, with the right and privilege to trim and remove trees, shrubs or bushes which interfere with the purposes set forth herein. No building, sign, pool (above ground or subsurface), hot tub, concrete or wood pool decking, or other structure shall be erected or constructed on said easements, nor shall any well be drilled or operated thereon. Property owners shall be solely responsible for correcting any violations of National Electrical Safety Code by construction of pools, decking, or any structures adjacent to or near easements shown on this plet

Easements for electric transformer/switchgears, as installed, shall extend ten (10) feet in front of transformer/switchgear doors and five (5) feet on each side.

### Disclaimer

In approving this plat, Public Service Company of New Mexico (PNM), New Mexico Gas Company (NMGC) and Qwest Corporation D/B/A CenturyLink (QWEST) did not conduct a Title Search of the properties shown hereon. Consequently, PNM, NMGC and QWEST do not waive or release any easement or easement rights which may have been granted by prior plat, replat or other document and which are not shown on this plat.

#### FREE CONSENT

The plat shown hereon is made with the owner(s) free consent and in accordance of the desires of the undersigned owner(s), the execution of this plat is their free act and deed. Those signing as owner(s) warrant that they hold among them, complete indefeasible title in fee simple to the land shown on this plat. Owner(s) hereby affirm that the described property shown on this plat lies within the platting and subdivision jurisdiction of Albuquerque, New Mexico. Said owner(s) hereby grant all Easements as shown on this plat.

Diane Fisher, Senior Vice President, Presbyterian Healthcare Services

State of New Mexico )

County of Bernalillo )

This instrument was acknowledged before me on 25 day of 2016, by

Diane Fisher, Senior Vice President, Presbyterian Healthcare Services

Notary Public My Commission Expires:



#### NOTES

- 1. Bearings are New Mexico State Plane Grid Bearings (Central Zone) NAD 1983.
- 2. Basis of Bearings established from COA Monument "CC\_EG\_11\_12\_11N\_3E" to COA Monument "NMSHC I-25-11" being S45°49'08"E.
- 3. Distances are ground distances.
- 4. Project combined factor = 0.999656857 scaled about X=500,000M, Y=0.
- 5. Bearings and distances are from existing Plat of Tract D-1E-1 Sisters of the Order of St. Dominic, filed July 5, 1996 in Book 96C, Page 297.
- 6. Pursuant to section 14-14-4-7 of the City of Albuquerque Code of Ordinances, "No property within the area of this Plat shall at anytime be subject to a deed restriction, covenant, or binding agreement prohibiting solar collectors from being installed on buildings or erected on the lots or parcels within the area of proposed plat. The foregoing requirements shall be a condition to approval of this plat."
- 7. City of Albuquerque zoning and development regulations and procedures shall apply to lands within this plat if the land is sold to any private parties.
- This plat and easements as shown hereon was based on the Title Commitment issued by Fidelty National Title, File No. FT000076945-Title, effective date: June 20, 2011 and the Title Search and Report prepared by Fidelity National Title, File No. FT000194268-NM01 effective January 12, 2016.
- 9. Tract is designated as "Zone X" on FEMA FIRM Panel 129 of 825, Map 35001C0129H, Revised August 16, 2012.

### **DESCRIPTION**

Tract D-1E-1, of the Plat of Tracts D-1B-1, D-1B-2, & D-1E-1 Sisters Of The Order Of St. Dominic, Albuquerque, New Mexico, as the same is shown and designated on the plat thereof, filed in the Office of the County Clerk of Bernalillo County, New Mexico on July 5, 1996, in Plat Book 96-C, Folio 297. Tract contains 31.7211 acres, more or less.

APPLICATION NUMBER	
ITILITY APPROVALS:	
QWEST CORPORATION d/b/a CENTURYLINK QC	DATE
COMCAST CABLE	DATE
NM ELECTRIC SERVICES	DATE
IEW MEXICO GAS COMPANY	DATE
Soun M. Risempour P.S. CITY SURVEYOR	1/25/16 DATE
RAFFIC ENGINEERING, TRANSPORTATION DIVISION	DATE
NLBUQUERQUE BERNALILLO COUNTY VATER UTILITY AUTHORITY	DATE
ARKS & RECREATION DEPARTMENT	DATE
I.M.A.F.C.A.	DATE
CITY ENGINEER	DATE
RB CHAIRPERSON, PLANNING DEPARTMENT	DATE
REAL PROPERTY DIVISION	DATE
AX CERTIFICATION	
HIS IS TO CERTIFY THAT TAXES ARE CURRENT AND PA	ID ON UPC#
ROPERTY OWNER OF RECORD:	<del></del>

### SURVEYOR'S CERTIFICATION

BERNALILLO COUNTY TREASURER'S OFFICE DATE

I, Alan R. Benham, a registered Professional New Mexico Surveyor, certify that I am responsible for this survey and that this plat was prepared by me or under my supervision, shows all existing easements as shown on the plats of record, or made known to me by the owner, utility companies, or other interested parties and conforms to the Minimum Requirements of the Board of Registration for Professional Engineers and Professional Surveyors and meets the minimum requirements for monumentation and surveys contained in the Albuquerque Subdivision Ordinance, and is true and accurate to the best of my knowledge and belief.

Alan R. Benham New Mexico Professional Surveyor 15700

PROJECT NUMBER


Date: JAN 25, 2016




**Bohannan** A Huston

SHEET 1 OF 2

Courtyard I 7500 Jefferson St. NE Albuquerque, NM 87109 (505) 823-1000

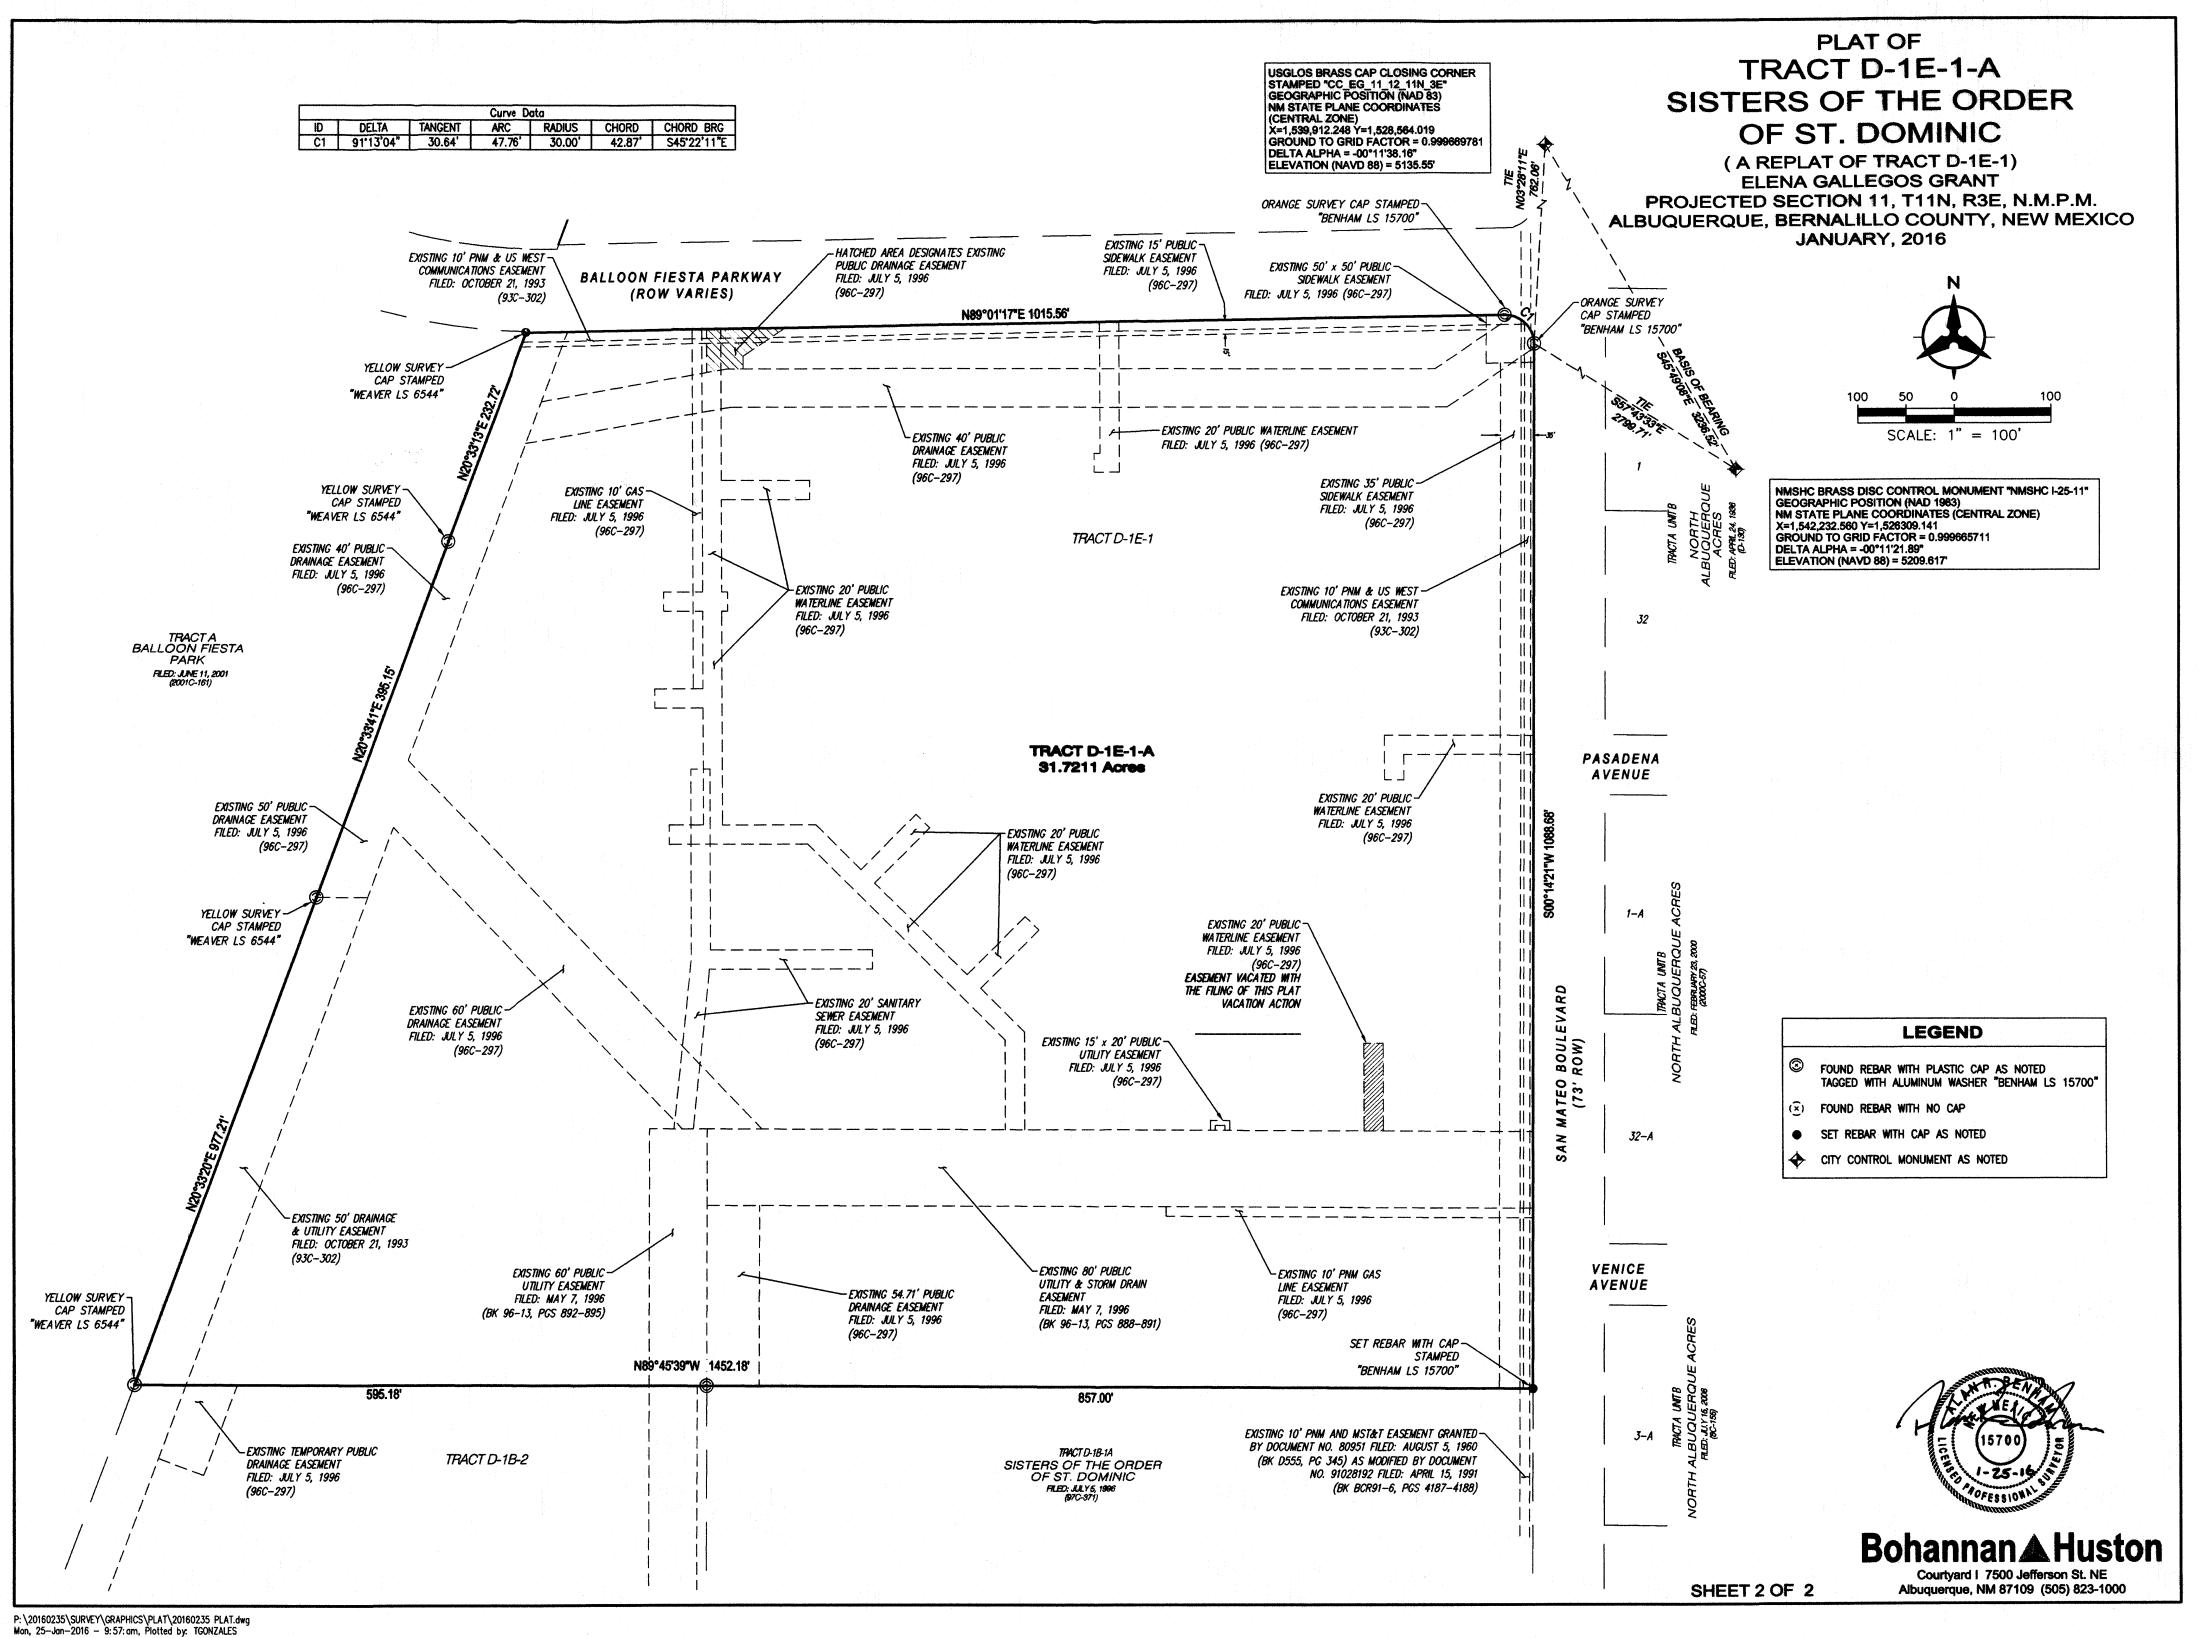

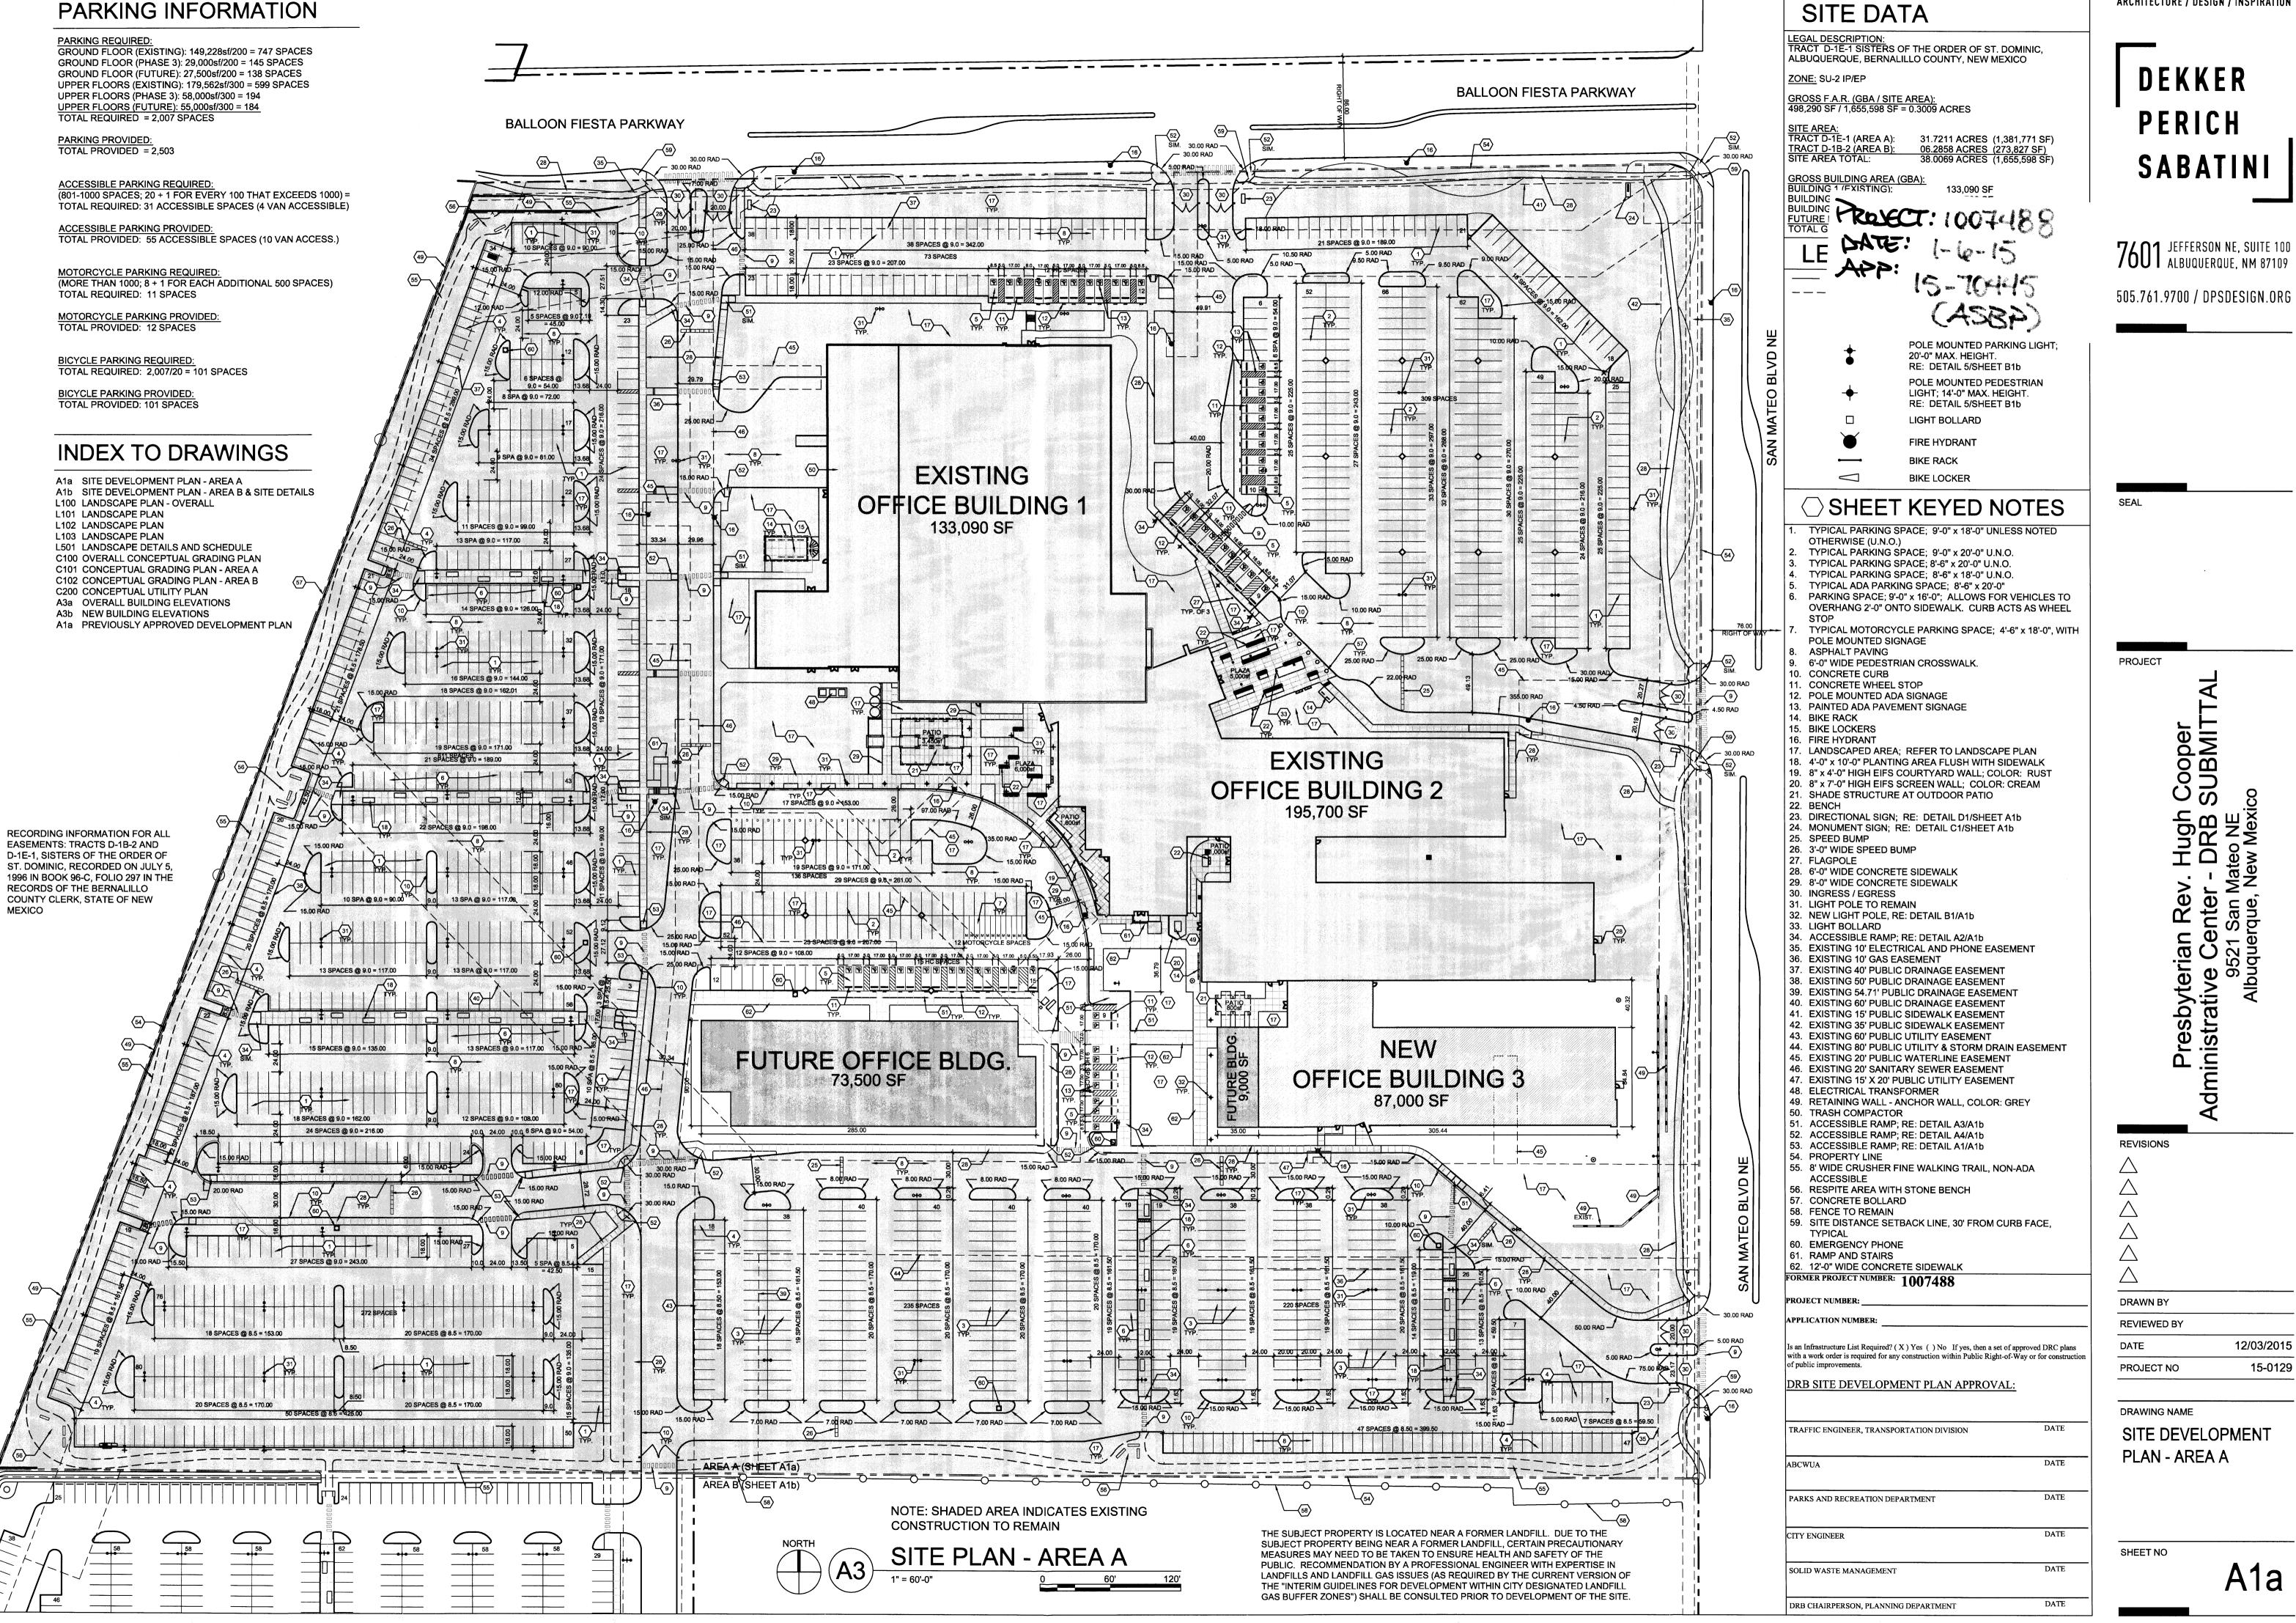


DEKKER PERICH SABATINI

7601 JEFFERSON NE, SUITE 100 ALBUQUERQUE, NM 87109

12/03/2015 15-0129

SITE DEVELOPMENT

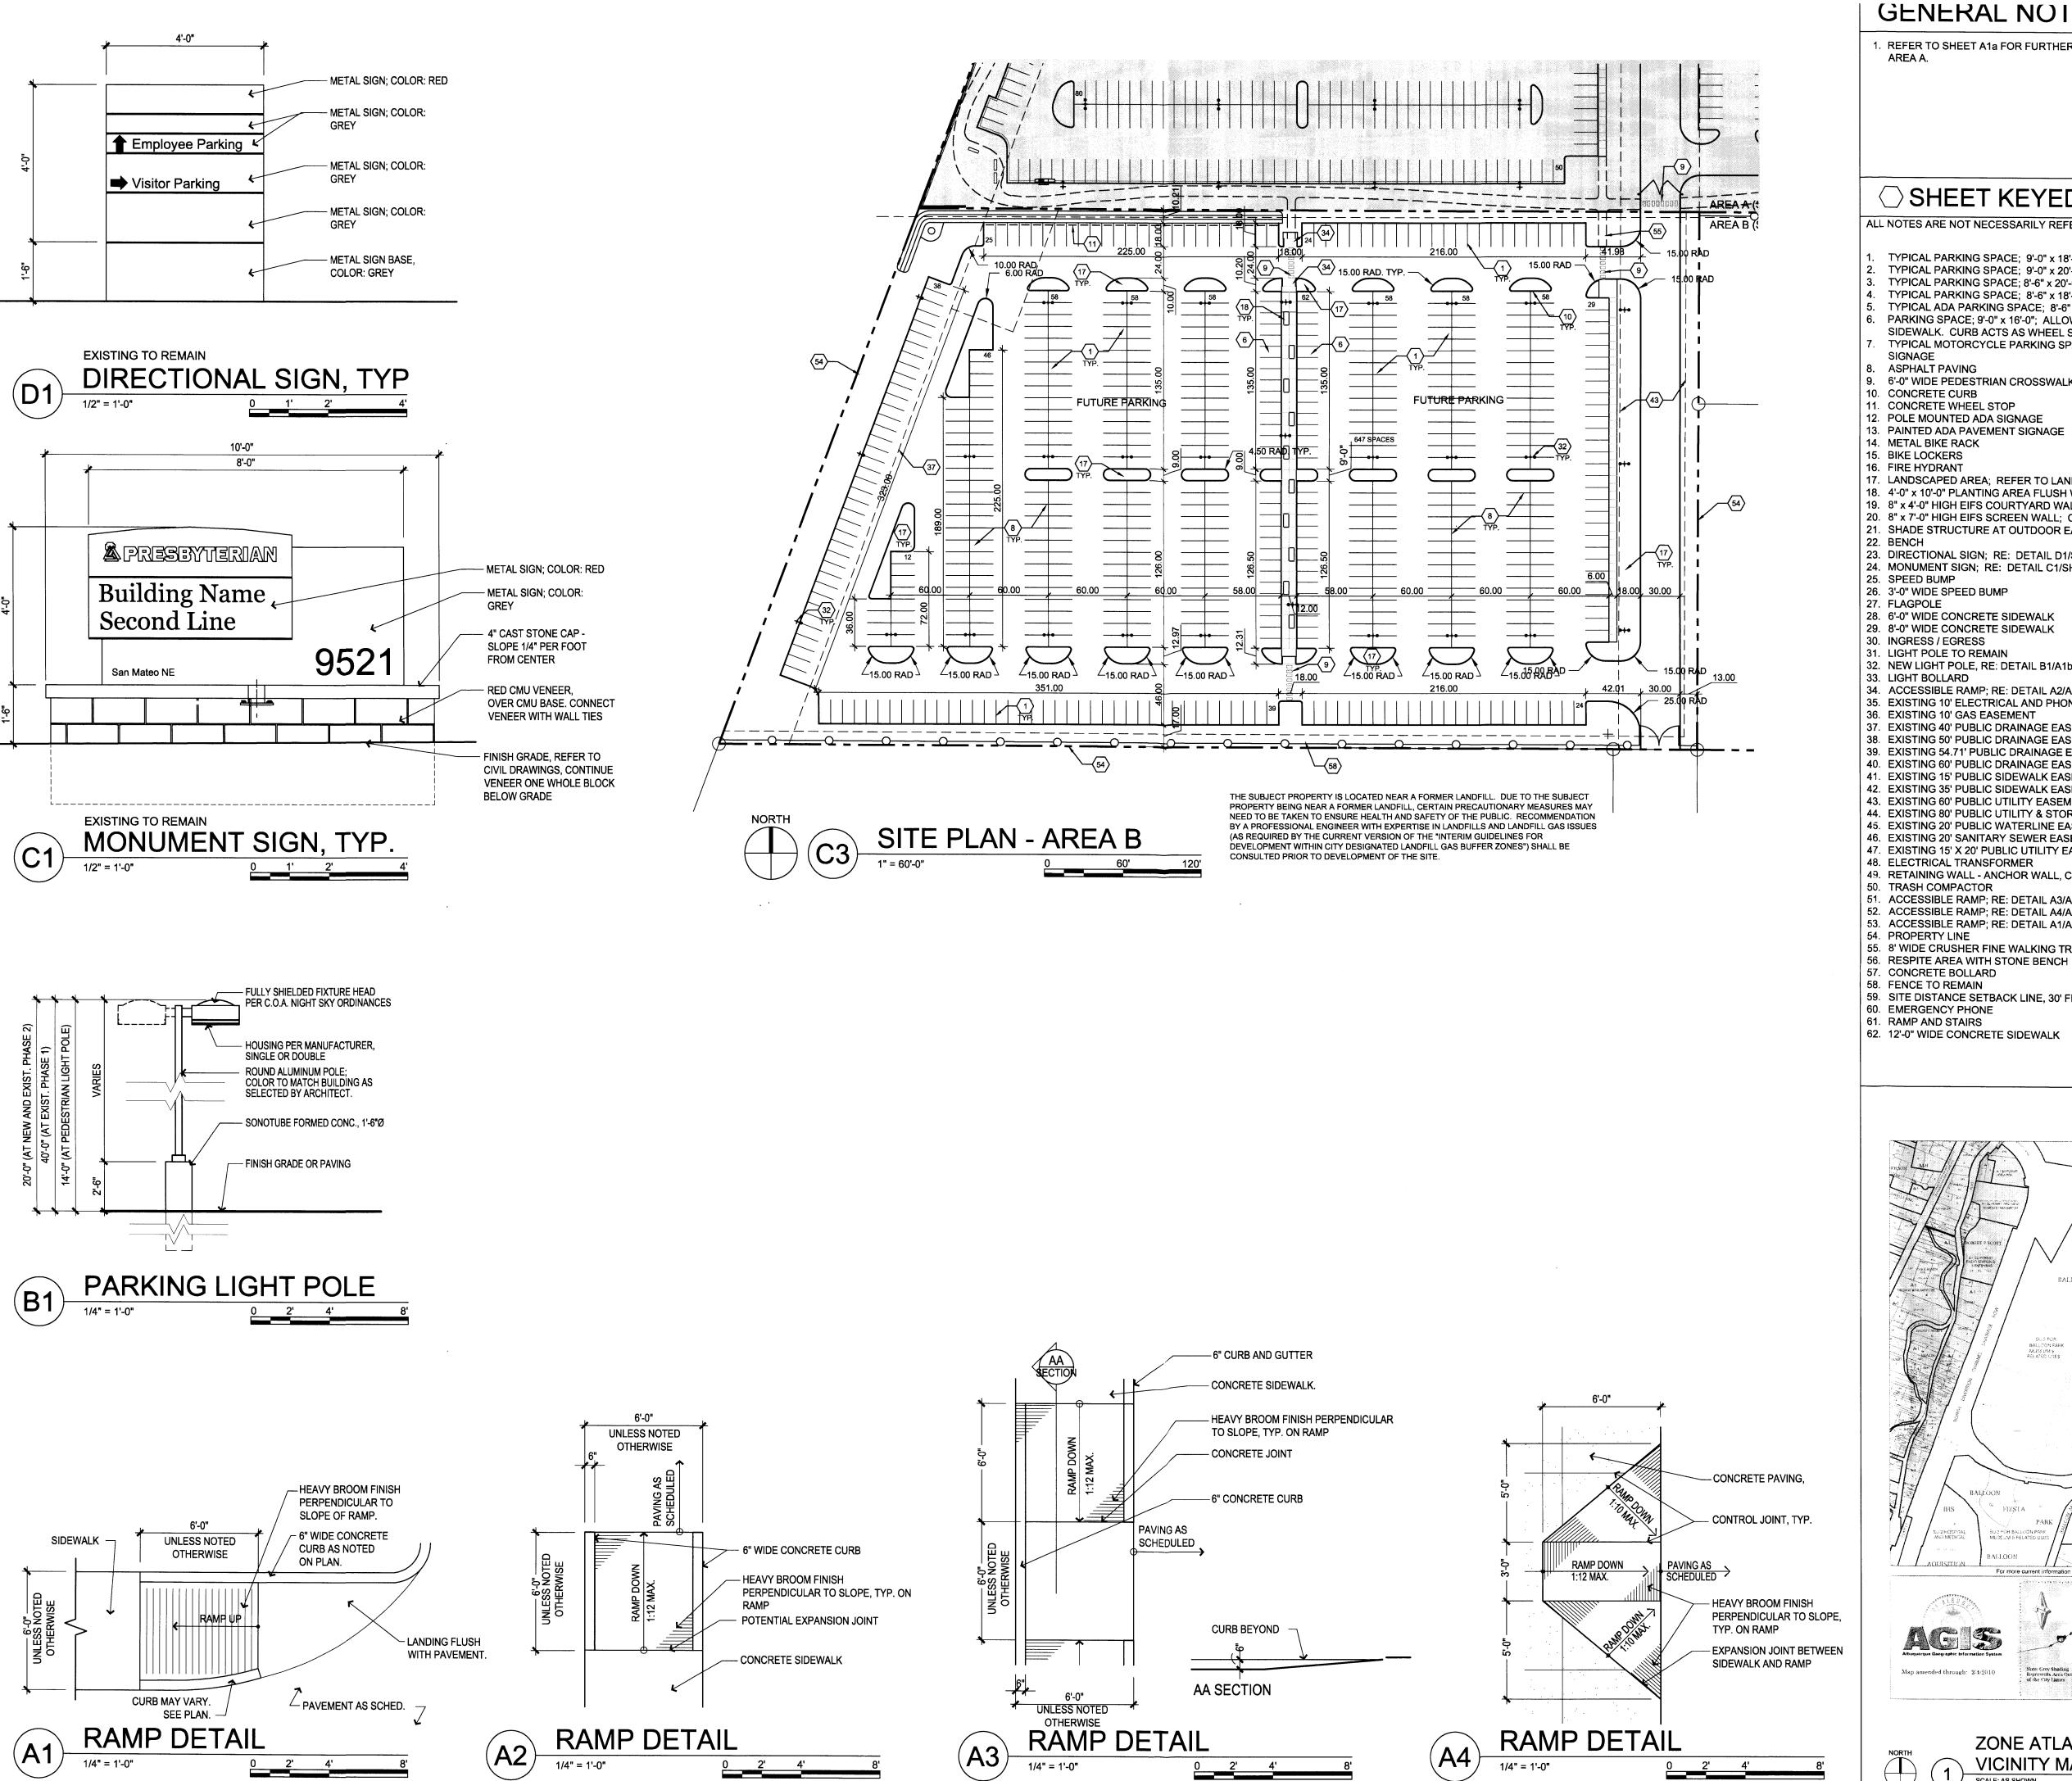

### GENERAL NOTES


. REFER TO SHEET A1a FOR FURTHER INFORMATION ON SITE

# ○ SHEET KEYED NOTES

ALL NOTES ARE NOT NECESSARILY REFERENCED ON THIS SHEET

- TYPICAL PARKING SPACE; 9'-0" x 18'-0" UNLESS NOTED OTHERWISE (U.N.O.)
- TYPICAL PARKING SPACE; 9'-0" x 20'-0" U.N.O. TYPICAL PARKING SPACE; 8'-6" x 20'-0" U.N.O.
- TYPICAL PARKING SPACE; 8'-6" x 18'-0" U.N.O. TYPICAL ADA PARKING SPACE; 8'-6" x 20'-0"
- 6. PARKING SPACE; 9'-0" x 16'-0"; ALLOWS FOR VEHICLES TO OVERHANG 2'-0" ONTO SIDEWALK. CURB ACTS AS WHEEL STOP
- TYPICAL MOTORCYCLE PARKING SPACE; 4'-6" x 18'-0", WITH POLE MOUNTED
- 9. 6'-0" WIDE PEDESTRIAN CROSSWALK.
- 11. CONCRETE WHEEL STOP
- 12. POLE MOUNTED ADA SIGNAGE 13. PAINTED ADA PAVEMENT SIGNAGE

- 17. LANDSCAPED AREA; REFER TO LANDSCAPE PLAN
- 18. 4'-0" x 10'-0" PLANTING AREA FLUSH WITH SIDEWALK 19. 8" x 4'-0" HIGH EIFS COURTYARD WALL; COLOR: RUST
- 20. 8" x 7'-0" HIGH EIFS SCREEN WALL; COLOR: CREAM 21. SHADE STRUCTURE AT OUTDOOR EATING AREA
- 23. DIRECTIONAL SIGN; RE: DETAIL D1/SHEET A1b
- 24. MONUMENT SIGN; RE: DETAIL C1/SHEET A1b
- 26. 3'-0" WIDE SPEED BUMP
- 28. 6'-0" WIDE CONCRETE SIDEWALK
- 30. INGRESS / EGRESS
- 31. LIGHT POLE TO REMAIN 32. NEW LIGHT POLE, RE: DETAIL B1/A1b
- 34. ACCESSIBLE RAMP; RE: DETAIL A2/A1b
- 35. EXISTING 10' ELECTRICAL AND PHONE EASEMENT
- 36. EXISTING 10' GAS EASEMENT
- 37. EXISTING 40' PUBLIC DRAINAGE EASEMENT 38. EXISTING 50' PUBLIC DRAINAGE EASEMENT
- 39. EXISTING 54.71' PUBLIC DRAINAGE EASEMENT
- 40. EXISTING 60' PUBLIC DRAINAGE EASEMENT
- 41. EXISTING 15' PUBLIC SIDEWALK EASEMENT
- 42. EXISTING 35' PUBLIC SIDEWALK EASEMENT 43. EXISTING 60' PUBLIC UTILITY EASEMENT
- 44. EXISTING 80' PUBLIC UTILITY & STORM DRAIN EASEMENT 45. EXISTING 20' PUBLIC WATERLINE EASEMENT
- 46. EXISTING 20' SANITARY SEWER EASEMENT
- 47. EXISTING 15' X 20' PUBLIC UTILITY EASEMENT
- 48. ELECTRICAL TRANSFORMER 49. RETAINING WALL - ANCHOR WALL, COLOR: GREY
- 51. ACCESSIBLE RAMP; RE: DETAIL A3/A1b
- 52. ACCESSIBLE RAMP; RE: DETAIL A4/A1b 53. ACCESSIBLE RAMP; RE: DETAIL A1/A1b
- 54. PROPERTY LINE 55. 8' WIDE CRUSHER FINE WALKING TRAIL, NON-ADA ACCESSIBLE
- 57. CONCRETE BOLLARD
- 59. SITE DISTANCE SETBACK LINE, 30' FROM CURB FACE, TYPICAL
- 60. EMERGENCY PHONE 61. RAMP AND STAIRS
- 62. 12'-0" WIDE CONCRETE SIDEWALK

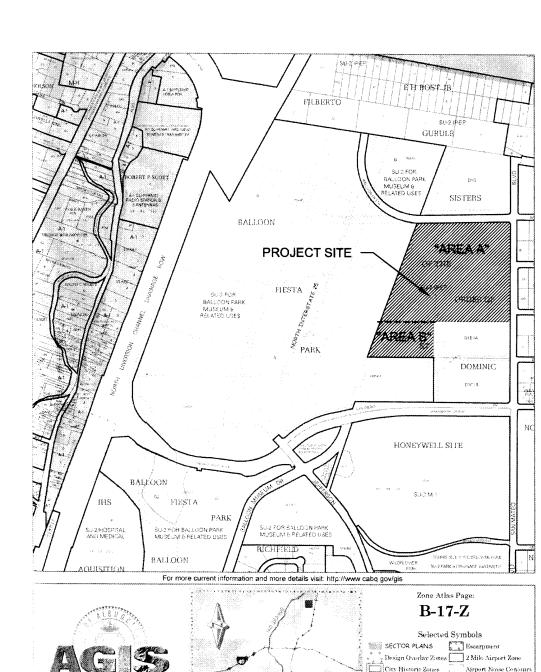

City Historic Zones

H-1 Buffer Zone

Wall Overlay Zone Petroglyph Mon. Map amended through: 2/4/2010 

**ZONE ATLAS PAGE** VICINITY MAP SCALE: AS SHOWN

DEKKER PERICH SABATINI

ARCHITECTURE / DESIGN / INSPIRATION

7601 JEFFERSON NE, SUITE 100 ALBUQUERQUE, NM 87109

505.761.9700 / DPSDESIGN.ORG

SEAL

**PROJECT** 

Presbyterian Rev ministrative Center

REVISIONS

DRAWN BY **REVIEWED BY** 

12/03/2015 DATE 15-0129 PROJECT NO

DRAWING NAME SITE PLAN - AREA B

SITE DETAILS

SHEET NO

A<sub>1</sub>b

OVERALL LANDSCAPE PLAN

# **GENERAL SHEET NOTES**

- A. FOR GRADING AND DRAINAGE INFORMATION, SEE CIVIL DRAWINGS.
  DO NOT RELY ON LANDSCAPE DRAWINGS FOR GRADING
- B. FOR ADDITIONAL INFORMATION ON SITE ELEMENTS, SEE SITE PLAN.

# PLANTING NOTES

- 1. THE LANDSCAPE DESIGN SHALL COMPLY WITH THE INTENT OF THE CITY OF ALBUQUERQUE WASTE WATER CONSERVATION, LANDSCAPING AND WATER WASTE ORDINANCE.
- 2. LANDSCAPING SHALL BE INSTALLED ACCORDING TO THE APPROVED PLAN; INSTALLATION SHALL BE COMPLETE WITHIN 60 DAYS OF THE RELATED BUILDING'S OCCUPANCY.
- MAINTENANCE OF LANDSCAPING AND IRRIGATION SHALL BE THE RESPONSIBILITY OF THE PROPERTY OWNER. 4. PLANTING SCHEDULE APPLIES TO NEW PLANT MATERIAL ONLY.
- FINAL SPECIES AND LOCATIONS MAY VARY FROM THIS PLAN. 5. LANDSCAPING SHALL HAVE ADEQUATE MAINTENANCE. LANDSCAPING WHICH DIES SHALL BE REPLACED BY THE OWNER AS EXPEDITIOUSLY AS POSSIBLE, BUT IN NO CASE LONGER THAN 60 DAYS AFTER NOTIFICATION.
- 6. THE EXISTING STREET TREE INSTALLATION IS COMPLIANT WITH THE CITY AND SECTOR PLAN REQUIREMENTS.
- 7. THERE IS EXTENSIVE EXISTING LANDSCAPE THAT WILL BE PRESERVED.
- 8. THERE IS EXISTING HIGH WATER USE TURF IN THE LANDSCAPE, BUT NO ADDITIONAL HIGH WATER USE TURF IS PROPOSED. SOME TURF WILL REQUIRE RENOVATION DUE TO CONSTRUCTION
- 9. LANDSCAPE AREAS SHALL BE COVERED WITH MULCH OR SEED. SEE PLANTING LEGEND.
- 10. MINIMUM INSTALLATION SIZES FOR PLANT MATERIAL VARY BY SPECIES. SEE PLANT LEGEND.
- 11. A MINIMUM OF 75% OF THE LANDSCAPE AREA SHALL BE COVERED WITH LIVE VEGETATIVE MATERIALS AT MATURITY.

# **IRRIGATION NOTES**

- . THE IRRIGATION SYSTEM DESIGN SHALL COMPLY WITH ALL CITY WATER CONSERVATION LANDSCAPE AND WASTE WATER
- 2. A FULLY AUTOMATED IRRIGATION SYSTEM IS USED TO IRRIGATE TREES, SHRUBS, AND GROUNDCOVER PLANTING AREAS. NEW IRRIGATION FOR NEW PLANT MATERIALS WILL TIE INTO THE EXISTING AUTOMATED SYSTEM.
- 3. THE IRRIGATION SYSTEM IS CONNECTED TO CITY WATER. THE POINT OF CONNECTION INCLUDES A WATER METER AND BACKFLOW
- 4. THE NEW IRRIGATION SYSTEM ZONES SHALL BE DESIGNED WITH
- SEPARATE ZONES ACCORDING TO PLANT WATER REQUIREMENTS. 5. EACH NEW TREE SHALL RECEIVE THREE (3) - ONE (1) GPH EMITTERS. EACH SHRUB/PERENNIAL SHALL RECEIVE TWO (2) - ONE
- 6. THE MAINTENANCE OF THE IRRIGATION SYSTEM SHALL BE THE RESPONSIBILITY OF THE PROPERTY OWNER.

# LANDSCAPE CALCULATIONS

TOTAL SITE AREA: 1,655,598 SF = 38.0 AC **TOTAL BUILDING AREA: 498,290 SF** TOTAL R.O.W. AREA: 16,298 SF NET LOT AREA: 1,141,010 SF = 26.19 AC

REQUIRED LANDSCAPE AREA: 15% OF NET LOT AREA = 171,152 SF PROVIDED LANDSCAPE AREA (NOT INCL. R.O.W.): 413,778 SF = 30%

REQUIRED OPEN SPACE: 5% OF NET LOT AREA = 57,050 SF EXISTING OPEN SPACE: 122,320 SF = 10.7%

NEW GRAVEL BED PROVIDED: 63,694 SF REQUIRED NEW LIVE GROUNDCOVER: 75% OF NEW GRAVEL BED= 47,770 SF PROVIDED NEW LIVE GROUNDCOVER: 47,893 SF

TREES/PARKING SPACES REQUIRED: 1 TREE/10 PARKING SPACES = 2,503 PARKING SPACES/10 = 251

PROVIDED: 357 TREES (274 EXISTING/83 NEW)

ARCHITECTURE / DESIGN / INSPIRATION

# DEKKER PERICH SABATINI

7601 JEFFERSON NE, SUITE 100 ALBUQUERQUE, NM 87109

505.761.9700 / DPSDESIGN.ORG

SEAL

PROJECT


REVISIONS

DRAWN BY **REVIEWED BY** 12/03/2015 PROJECT NO 15-0129

DRAWING NAME

LANDSCAPE PLAN, NOTES, AND **CALCULATIONS** 

SHEET NO

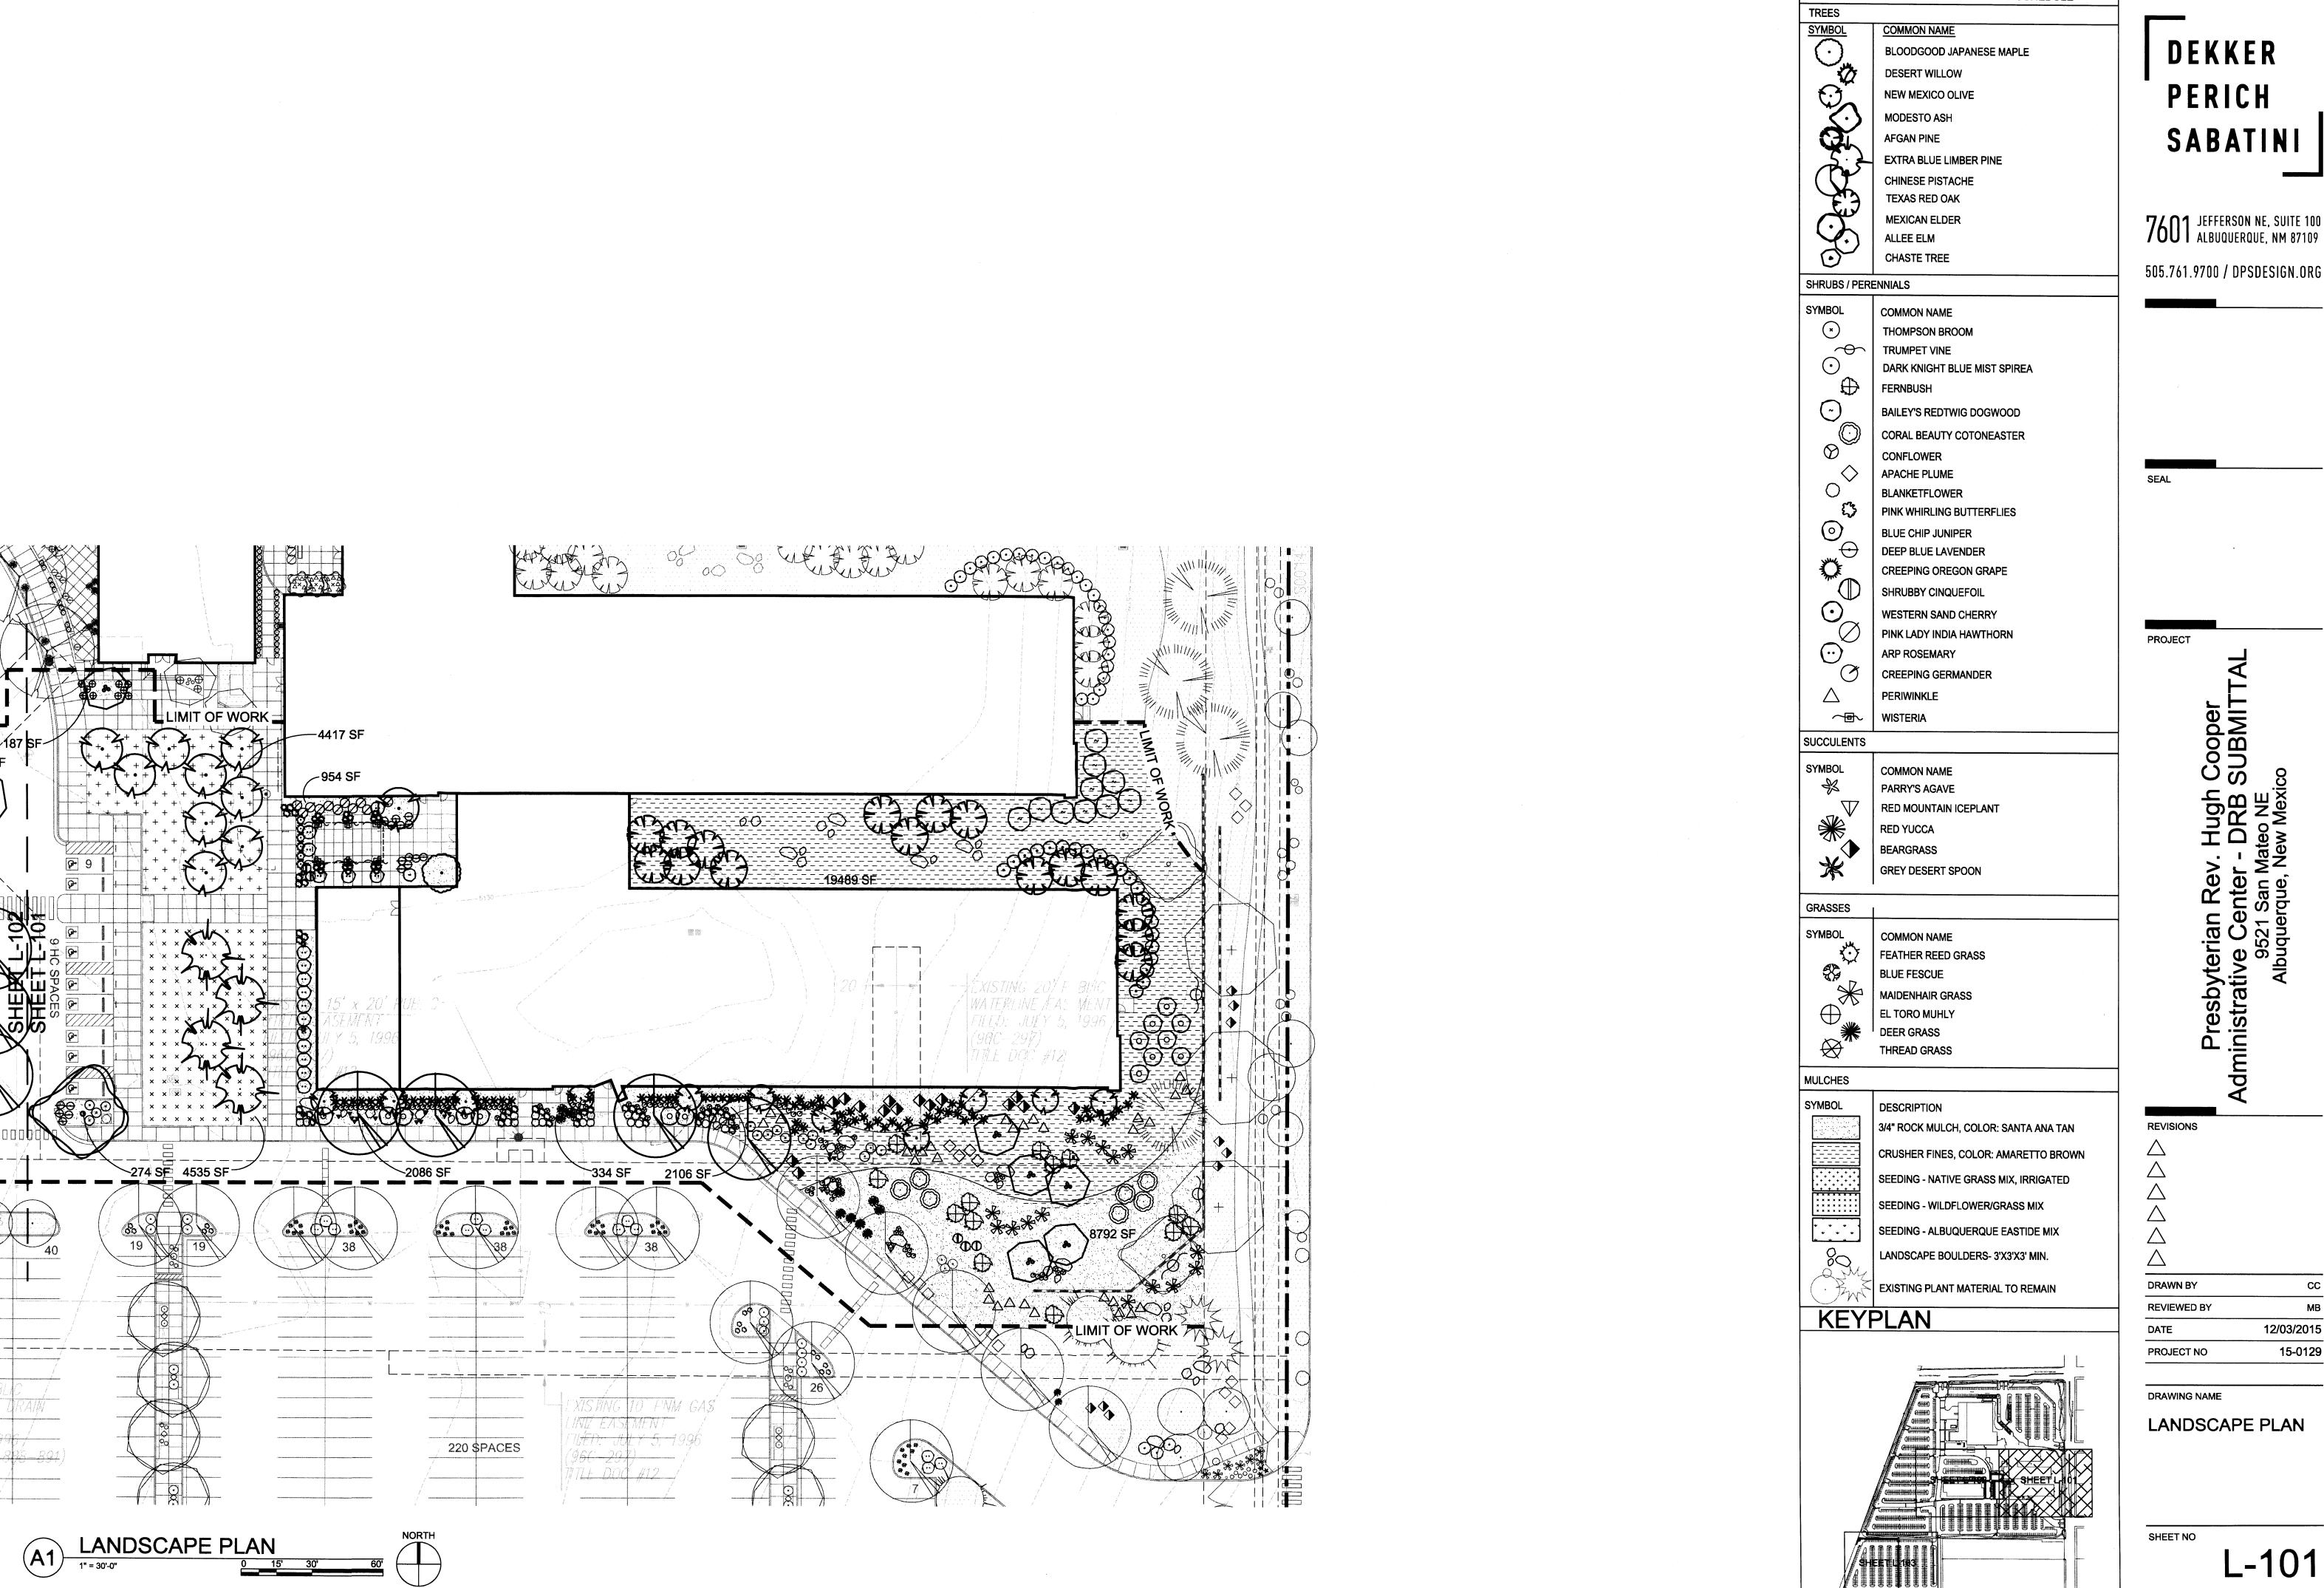


ARCHITECTURE / DESIGN / INSPIRATION PLANTING LEGEND
SEE SHEET L-501 FOR FULL PLANTING SCHEDULE


DEKKER SABATINI

7601 JEFFERSON NE, SUITE 100 ALBUQUERQUE, NM 87109

12/03/2015 15-0129

LANDSCAPE PLAN

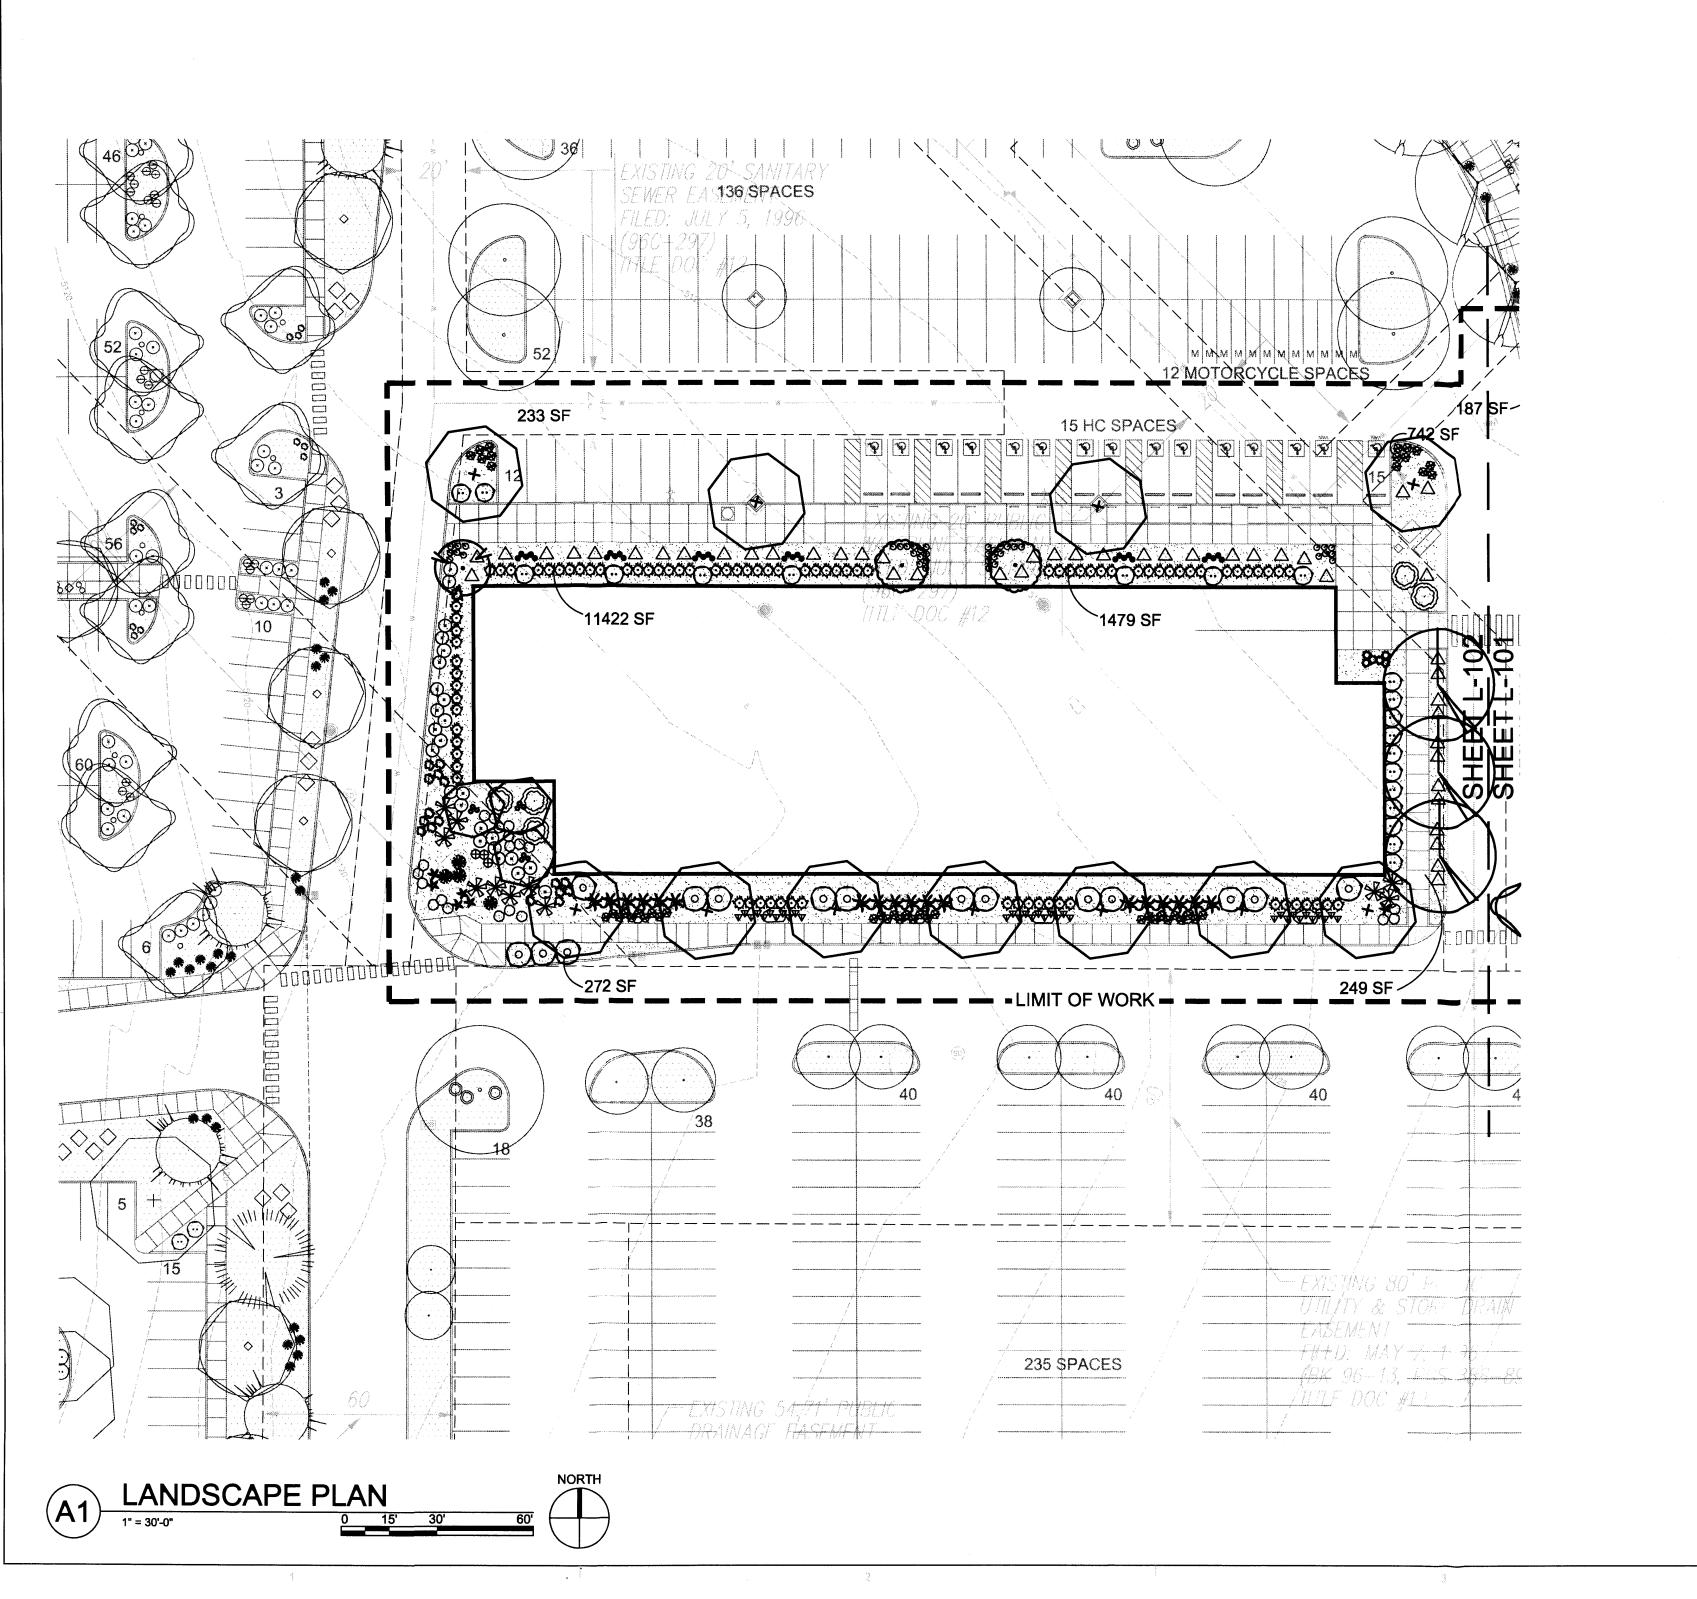

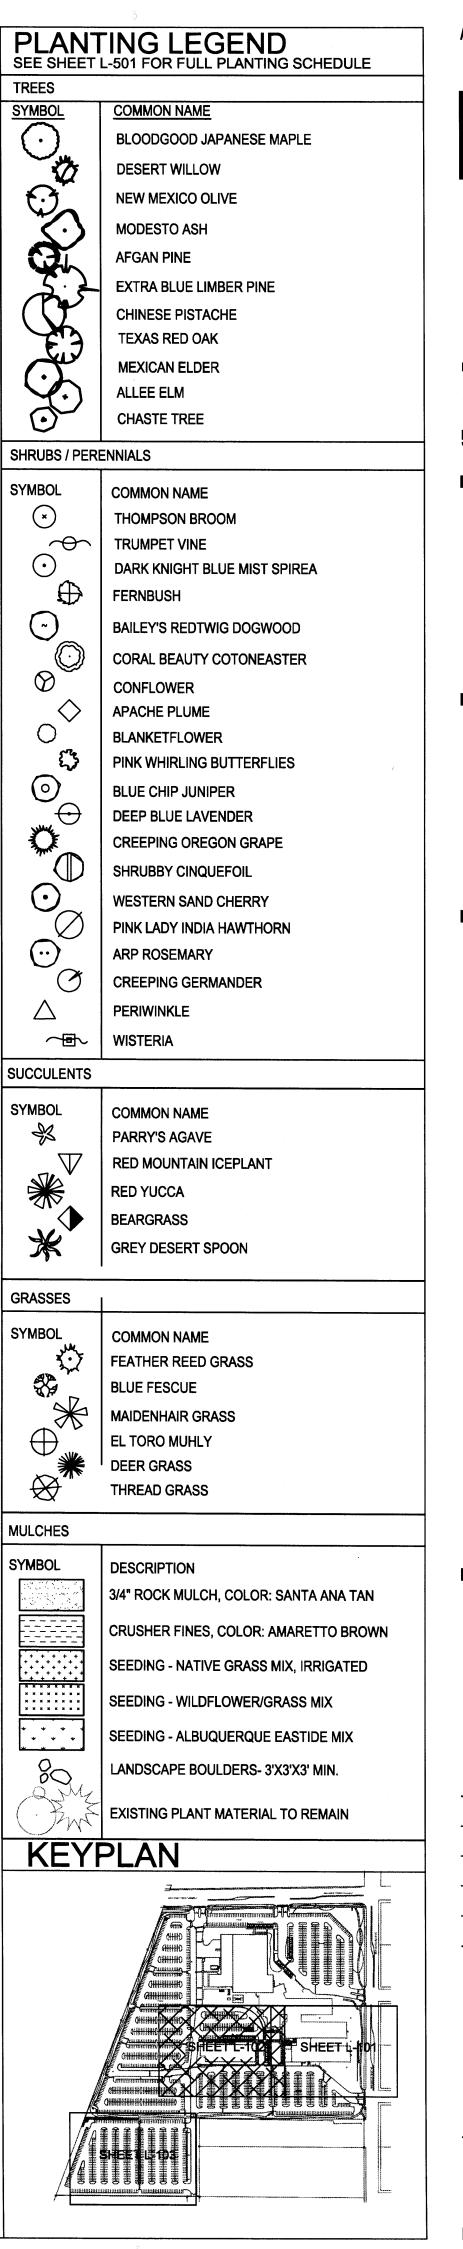

DEKKER PERICH SABATINI

7601 JEFFERSON NE, SUITE 100 ALBUQUERQUE, NM 87109

505.761.9700 / DPSDESIGN.ORG

SFAI

PROJECT

Presbyterian Rev. Hugh Cooper Administrative Center - DRB SUBMITTAL 9521 San Mateo NE Albuquerque, New Mexico

Z Z ZAWN BY

 DRAWN BY
 CC

 REVIEWED BY
 MB

 DATE
 12/03/2015


 PROJECT NO
 15-0129

DRAWING NAME

LANDSCAPE PLAN

SHEET NO

L-102

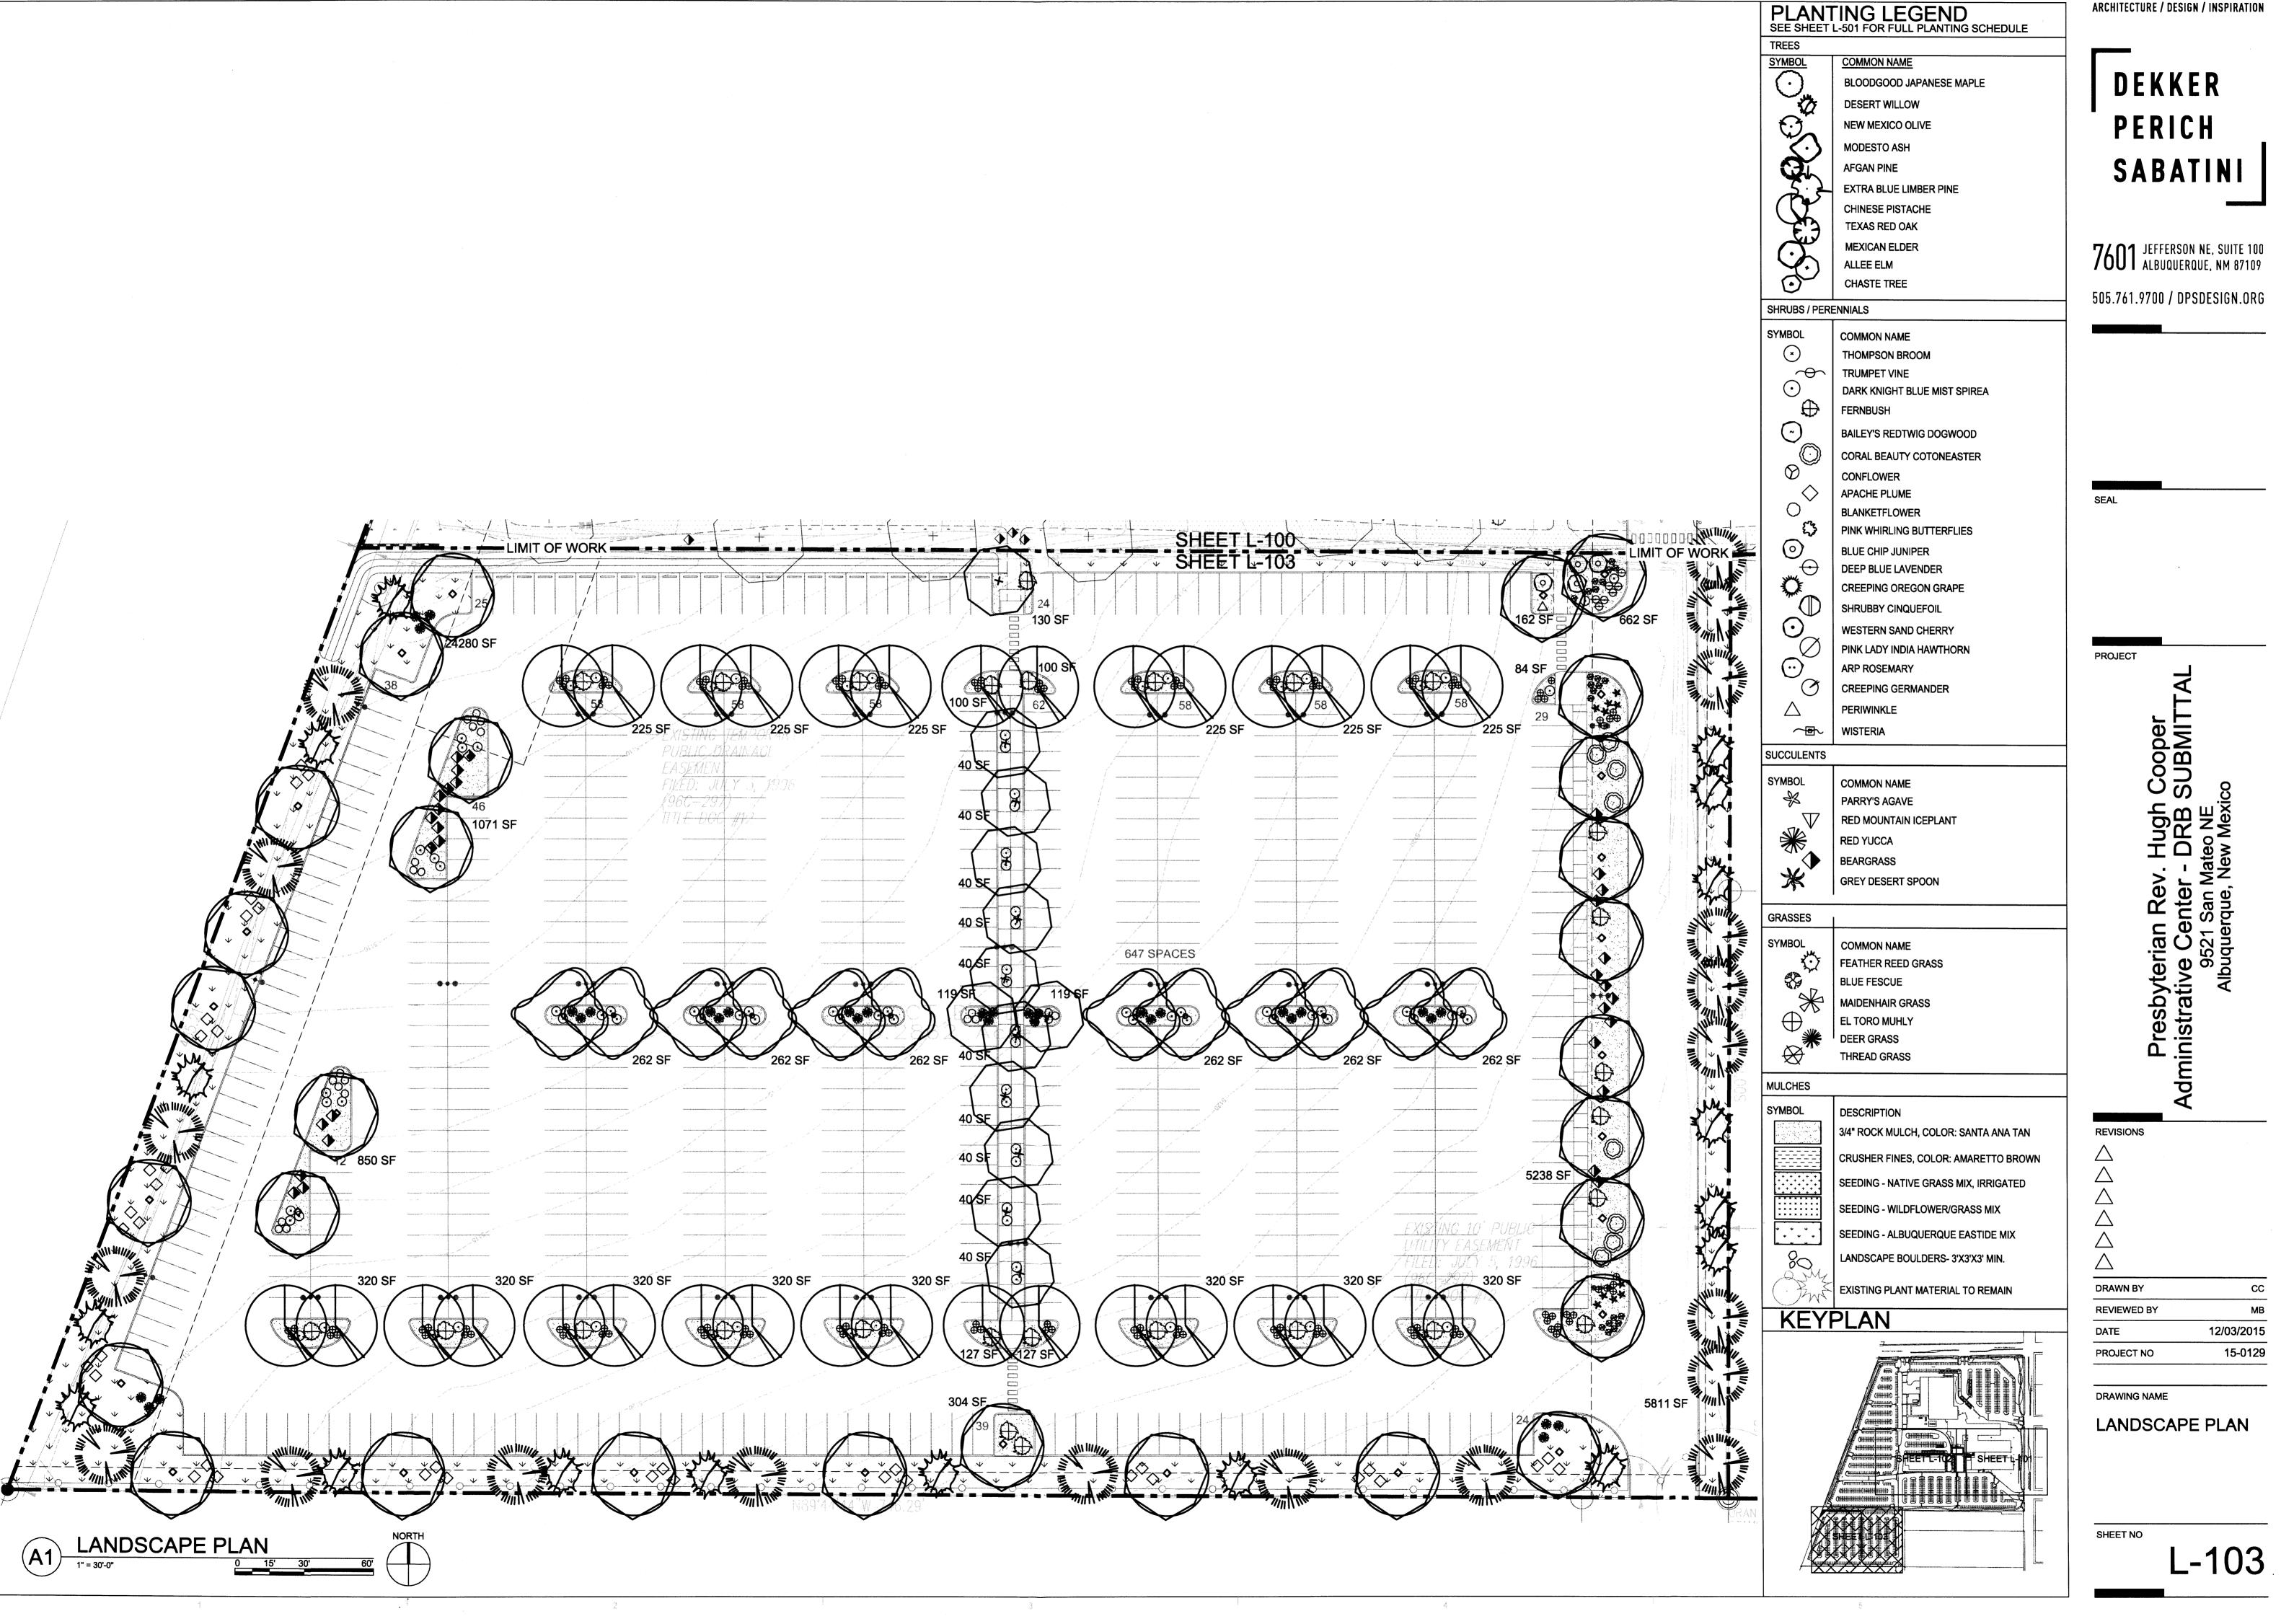

HEAVY DUTY PAVEMENT SECTION NOT TO SCALE

### **GENERAL NOTES**

1. ALL WORK DETAILED ON THESE PLANS AND PERFORMED UNDER THIS CONTRACT SHALL BE CONSTRUCTED IN ACCORDANCE WITH THE PROJECT SPECIFICATIONS AND THE PROJECT GEOTECHNICAL REPORT. WHERE APPLICABLE, CITY OF ALBUQUERQUE PUBLIC WORKS STANDARDS SHALL APPLY.

2. THE CONTRACTOR SHALL ABIDE BY ALL LOCAL, STATE, AND FEDERAL LAWS, RULES AND REGULATIONS WHICH APPLY TO THE CONSTRUCTION OF THESE IMPROVEMENTS, INCLUDING EPA REQUIREMENTS WITH RESPECT TO STORM WATER DISCHARGE.

3. PRIOR TO CONSTRUCTION, THE CONTRACTOR SHALL FIELD VERIFY THE HORIZONTAL AND VERTICAL LOCATIONS OF ALL POTENTIAL OBSTRUCTIONS INCLUDING ALL UNDERGROUND UTILITIES. SHOULD A CONFLICT EXIST, THE CONTRACTOR SHALL NOTIFY THE CONSTRUCTION OBSERVER OR ENGINEER SO THAT THE CONFLICT CAN BE RESOLVED WITH A MINIMUM AMOUNT OF DELAY.

4. TWO (2) WORKING DAYS PRIOR TO ANY EXCAVATION, THE CONTRACTOR SHALL CONTACT LINE LOCATING SERVICE FOR LOCATION OF EXISTING UTILITIES.

5. ALL ELECTRICAL, TELEPHONE, CABLE TV, GAS AND OTHER UTILITY LINES, CABLES, AND APPURTENANCES ENCOUNTERED DURING CONSTRUCTION THAT REQUIRE RELOCATION, SHALL BE COORDINATED WITH THAT UTILITY. THE CONTRACTOR SHALL BE RESPONSIBLE FOR COORDINATION OF ALL NECESSARY UTILITY ADJUSTMENTS. NO ADDITIONAL COMPENSATION WILL BE ALLOWED FOR DELAYS OR INCONVENIENCES CAUSED BY UTILITY COMPANY WORK CREWS. THE CONTRACTOR MAY BE REQUIRED TO RESCHEDULE HIS ACTIVITIES TO ALLOW UTILITY CREWS TO PERFORM THEIR

6. THE CONTRACTOR IS RESPONSIBLE FOR PROTECTING ALL EXISTING UTILITY LINES WITHIN THE CONSTRUCTION AREA. ANY DAMAGE TO EXISTING FACILITIES CAUSED BY CONSTRUCTION ACTIVITY SHALL BE REPAIRED OR REPLACED AT THE CONTRACTOR'S EXPENSE AND APPROVED BY THE CONSTRUCTION OBSERVER.

7. CONSTRUCTION ACTIVITY SHALL BE LIMITED TO THE PROPERTY AND/OR PROJECT LIMITS. ANY DAMAGE TO ADJACENT PROPERTIES RESULTING FROM THE CONSTRUCTION PROCESS SHALL BE REPAIRED OR REPLACED AT THE

8. OVERNIGHT PARKING OF CONSTRUCTION EQUIPMENT SHALL NOT OBSTRUCT DRIVEWAYS OR DESIGNATED TRAFFIC LANES. THE CONTRACTOR SHALL NOT STORE ANY EQUIPMENT OR MATERIAL WITHIN THE PUBLIC RIGHT-OF-WAY.

9. THE CONTRACTOR SHALL OBTAIN ALL THE NECESSARY PERMITS FOR THE PROJECT PRIOR TO COMMENCING CONSTRUCTION (I.E., BARRICADING, TOPSOIL DISTURBANCE, EXCAVATION PERMITS, EPA STORM WATER PERMITS, ETC.).

ALL PROPERTY CORNERS DESTROYED DURING CONSTRUCTION SHALL BE REPLACED AT THE CONTRACTOR'S EXPENSE. ALL PROPERTY CORNERS MUST BE RESET BY A REGISTERED LAND SURVEYOR.

11. THE CONTRACTOR SHALL PREPARE A CONSTRUCTION TRAFFIC CONTROL AND SIGNING PLAN AND OBTAIN APPROVAL OF SUCH PLAN FROM THE CITY OF ALBUQUERQUE, TRAFFIC ENGINEERING DEPARTMENT, PRIOR TO BEGINNING ANY CONSTRUCTION WORK ON OR ADJACENT TO EXISTING STREETS.

12. ALL BARRICADES AND CONSTRUCTION SIGNING SHALL CONFORM TO APPLICABLE SECTIONS OF THE "MANUAL ON UNIFORM TRAFFIC CONTROL DEVICES" (MUTCD), US DEPARTMENT OF TRANSPORTATION, LATEST EDITION.

13. THE CONTRACTOR SHALL MAINTAIN ALL CONSTRUCTION BARRICADES AND SIGNING AT ALL TIMES. THE CONTRACTOR SHALL VERIFY THE PROPER LOCATION OF ALL BARRICADING AT THE END AND BEGINNING OF EACH DAY.

14. THE CONTRACTOR SHALL TAKE ALL STEPS NECESSARY TO CONFORM WITH EPA REQUIREMENTS, INCLUDING COMPLIANCE WITH NPDES PHASE 2 REQUIREMENTS.

### **GRADING NOTES**

1. EXCEPT AS PROVIDED HEREIN, GRADING SHALL BE PERFORMED AT THE ELEVATIONS AND IN ACCORDANCE WITH THE DETAILS SHOWN ON THIS PLAN.

2. THE COST FOR REQUIRED CONSTRUCTION DUST AND EROSION CONTROL MEASURES SHALL BE INCIDENTAL TO THE

3. ALL WORK RELATIVE TO FOUNDATION CONSTRUCTION, SITE PREPARATION, AND PAVEMENT INSTALLATION, AS SHOWN ON THIS PLAN, SHALL BE CONSTRUCTED IN ACCORDANCE WITH THE "GEOTECHNICAL INVESTIGATION". ALL OTHER WORK SHALL, UNLESS OTHERWISE STATED OR PROVIDED FOR HEREON, BE CONSTRUCTED IN ACCORDANCE WITH THE PROJECT, (FIRST PRIORITY) SPECIFICATIONS, AND/OR THE CITY OF ALBUQUERQUE (COA) STANDARD SPECIFICATIONS FOR PUBLIC WORKS (SECOND PRIORITY).

4. EARTH SLOPES SHALL NOT EXCEED 3 HORIZONTAL TO 1 VERTICAL UNLESS SHOWN OTHERWISE.

5. IT IS THE INTENT OF THESE PLANS THAT THIS CONTRACTOR SHALL NOT PERFORM ANY WORK OUTSIDE OF THE PROPERTY BOUNDARIES EXCEPT AS REQUIRED BY THIS PLAN.

5. THE CONTRACTOR IS TO ENSURE THAT NO SOIL ERODES FROM THE SITE ONTO ADJACENT PROPERTY OR PUBLIC

7. A DISPOSAL SITE FOR ANY & ALL EXCESS EXCAVATION MATERIAL, AND UNSUITABLE MATERIAL AND/OR A BORROW SITE CONTAINING ACCEPTABLE FILL MATERIAL SHALL BE OBTAINED BY THE CONTRACTOR IN COMPLIANCE WITH APPLICABLE ENVIRONMENTAL REGULATIONS AND APPROVED BY THE OBSERVER. ALL COSTS INCURRED IN OBTAINING A DISPOSAL OR BORROW SITE AND HAUL TO OR FROM SHALL BE CONSIDERED INCIDENTAL TO THE PROJECT AND NO SEPARATE MEASUREMENT OR PAYMENT SHALL BE MADE.

8. PAVING AND ROADWAY GRADES SHALL BE +/- 0.1' FROM PLAN ELEVATIONS. PAD ELEVATION SHALL BE +/-0.05' FROM BUILDING PLAN ELEVATION.

9. ALL PROPOSED CONTOURS REFLECT TOP OF PAVEMENT ELEVATIONS IN THE PARKING AREA AND MUST BE ADJUSTED FOR MEDIANS AND ISLANDS.

10. VERIFY ALL ELEVATIONS SHOWN ON PLAN FROM BASIS OF ELEVATION CONTROL STATION PRIOR TO BEGINNING

### **LEGEND**

PROPERTY LINE
EXISTING CONTOURS
EXISTING GROUND SPOT ELEVATION
PROPOSED SPOT ELEVATION TC=TOP OF CURB, FL=FLOW LINE TS=TOP OF SIDEWALK, TA=TOP OF ASPHAL EX=EXISTING, FG=FINISHED GRADE TG=TOP OF GRATE, INV=INVERT FGH=FINISHED GRADE HIGH FGL=FINISHED GRADE LOW
PROPOSED DIRECTION OF FLOW
WATER BLOCK / RIDGE OR HIGH POINT
PROPOSED RETAINING WALL
PROPOSED INDEX CONTOURS
PROPOSED INTER CONTOURS
PROPOSED CURB & GUTTER
EASEMENT
PROPOSED STORM DRAIN LINE
PROPOSED STORM DRAIN MANHOLE
PROPOSED STORM DRAIN INLET

www.bhinc.com 800.877.5332

PERICH SABATIN

ARCHITECTURE / DESIGN / INSPIRATION

7401 JEFFERSON NE, SUITE 100 **/OUI** ALBUQUERQUE, NM 87109

505.761.9700 / DPSDESIGN.ORG

SEAL

**PROJECT** 

Cooper SUBMIT Hugh DRB yterian Retive Cente 9521 San Albuquerque

**REVISIONS** DRAWN BY во **REVIEWED BY** GSB 12/03/2015 DATE 15-0129 PROJECT NO

DRAWING NAME **OVERALL** 

**GRADING PLAN** 

SHEET NO

LIGHT DUTY PAVEMENT SECTION

NOT TO SCALE



7601 JEFFERSON NE, SUITE 100 ALBUQUERQUE, NM 87109

505.761.9700 / DPSDESIGN.ORG

SEAL

PROJECT

byterian Rev. Hugh Cooper ative Center - DRB SUBMITTAL 9521 San Mateo NE

REVISIONS

 DRAWN BY
 BO

 REVIEWED BY
 GSB

 DATE
 12/03/2015

 PROJECT NO
 15-0129

DRAWING NAME

GRADING PLAN

SHEET NO


Bohannan A Huston

www.bhinc.com

\_ \_ \_ \_ -

800.877.5332


C101

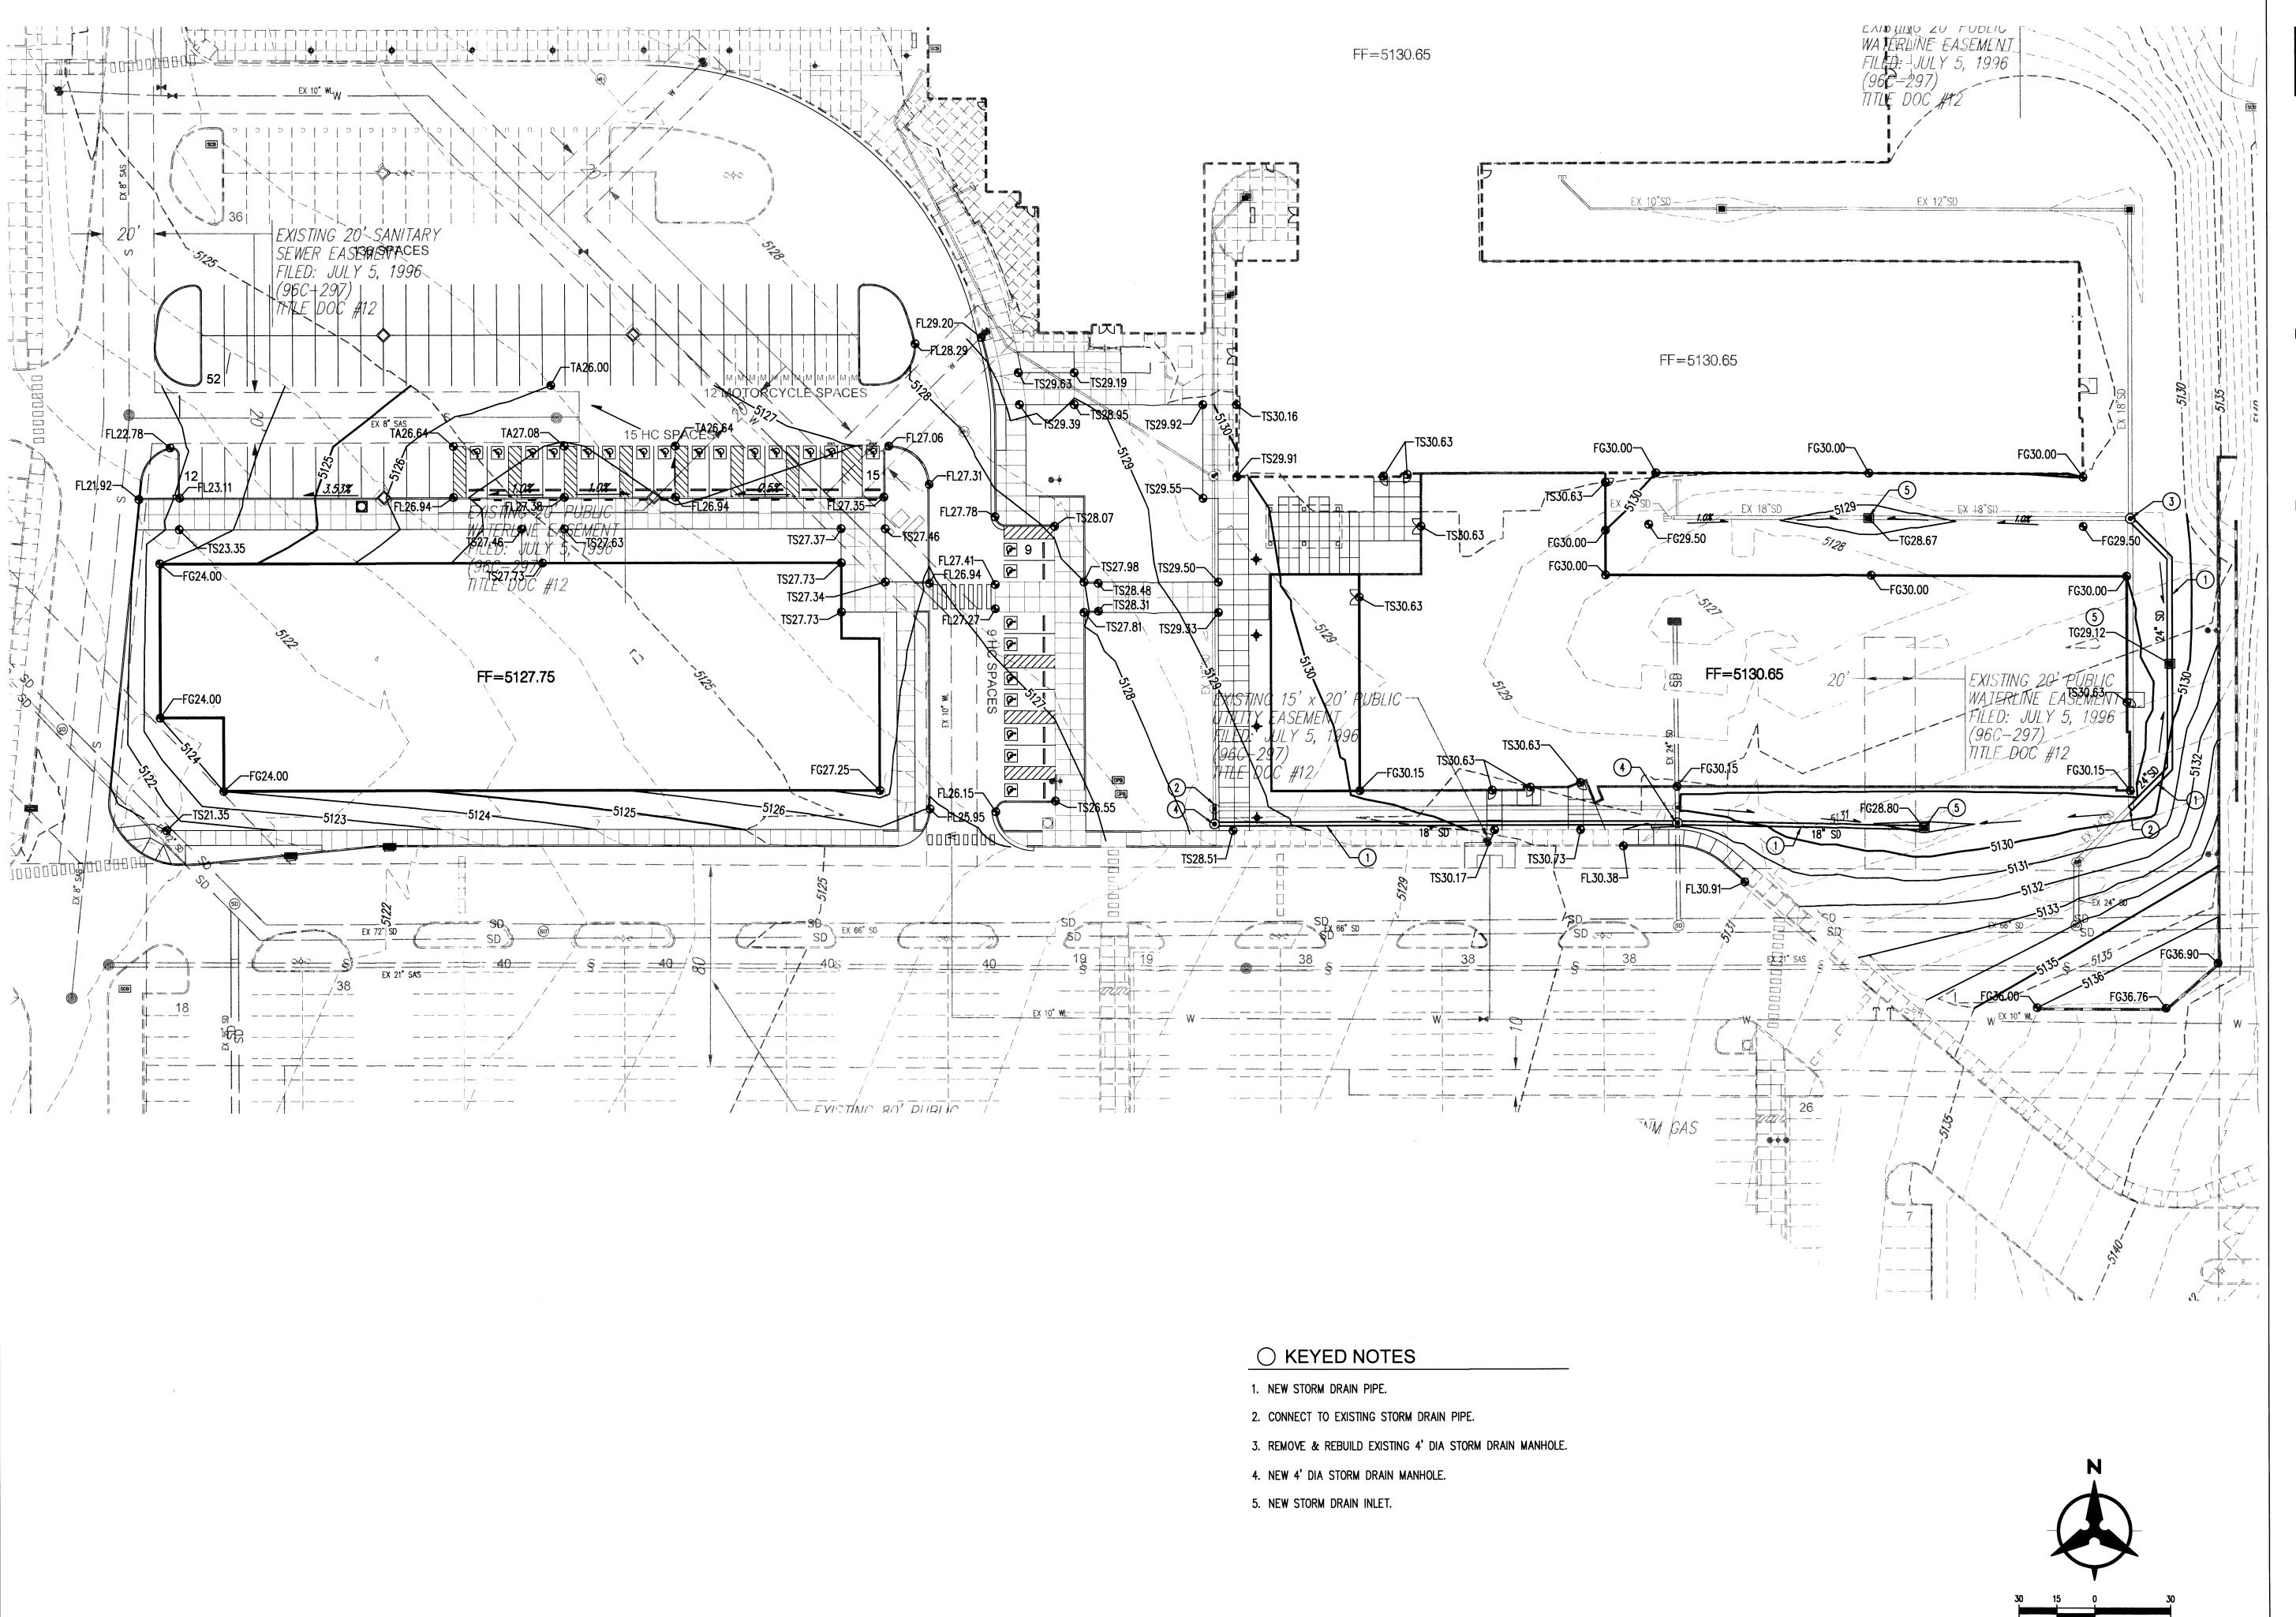

P: \20160235\CDP\Plans\General\20160235gp01.dwg Thu, 3—Dec—2015 — 10:44:am, Plotted by: BORTEGA

## ○ KEYED NOTES

- 1. SIDEWALK CULVERT.
- 2. CURB OPENING.
- 3. RIP—RAP RUNDOWN.
- 4. CONCRETE RIBBON CHANNEL.
- 5. EXISTING GROUTED RIP-RAP TO REMAIN.
- 6. 12" WIDE CURB OPENING & DEPRESSED LANDSCAPE AREA.

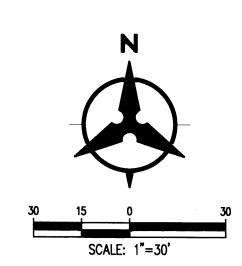

Bohannan A Huston
www.bhinc.com 800.877.5332

DEKKER PERICH SABATINI

ARCHITECTURE / DESIGN / INSPIRATION

7601 JEFFERSON NE, SUITE 100 ALBUQUERQUE, NM 87109

505.761.9700 / DPSDESIGN.ORG

SEAL

PROJEC

Presbyterian Rev. Hugh Cooper Administrative Center - DRB SUBMITTAI 9521 San Mateo NE

REVISIONS

REVISION A

 DRAWN BY
 BO

 REVIEWED BY
 GSB

 DATE
 12/03/2015


 PROJECT NO
 15-0129

DRAWING NAME

GRADING PLAN

ET NO

P:\20160235\CDP\Plans\General\20160235gp02.dwg Thu, 3—Dec—2015 — 10:44:am, Plotted by: BORTEGA

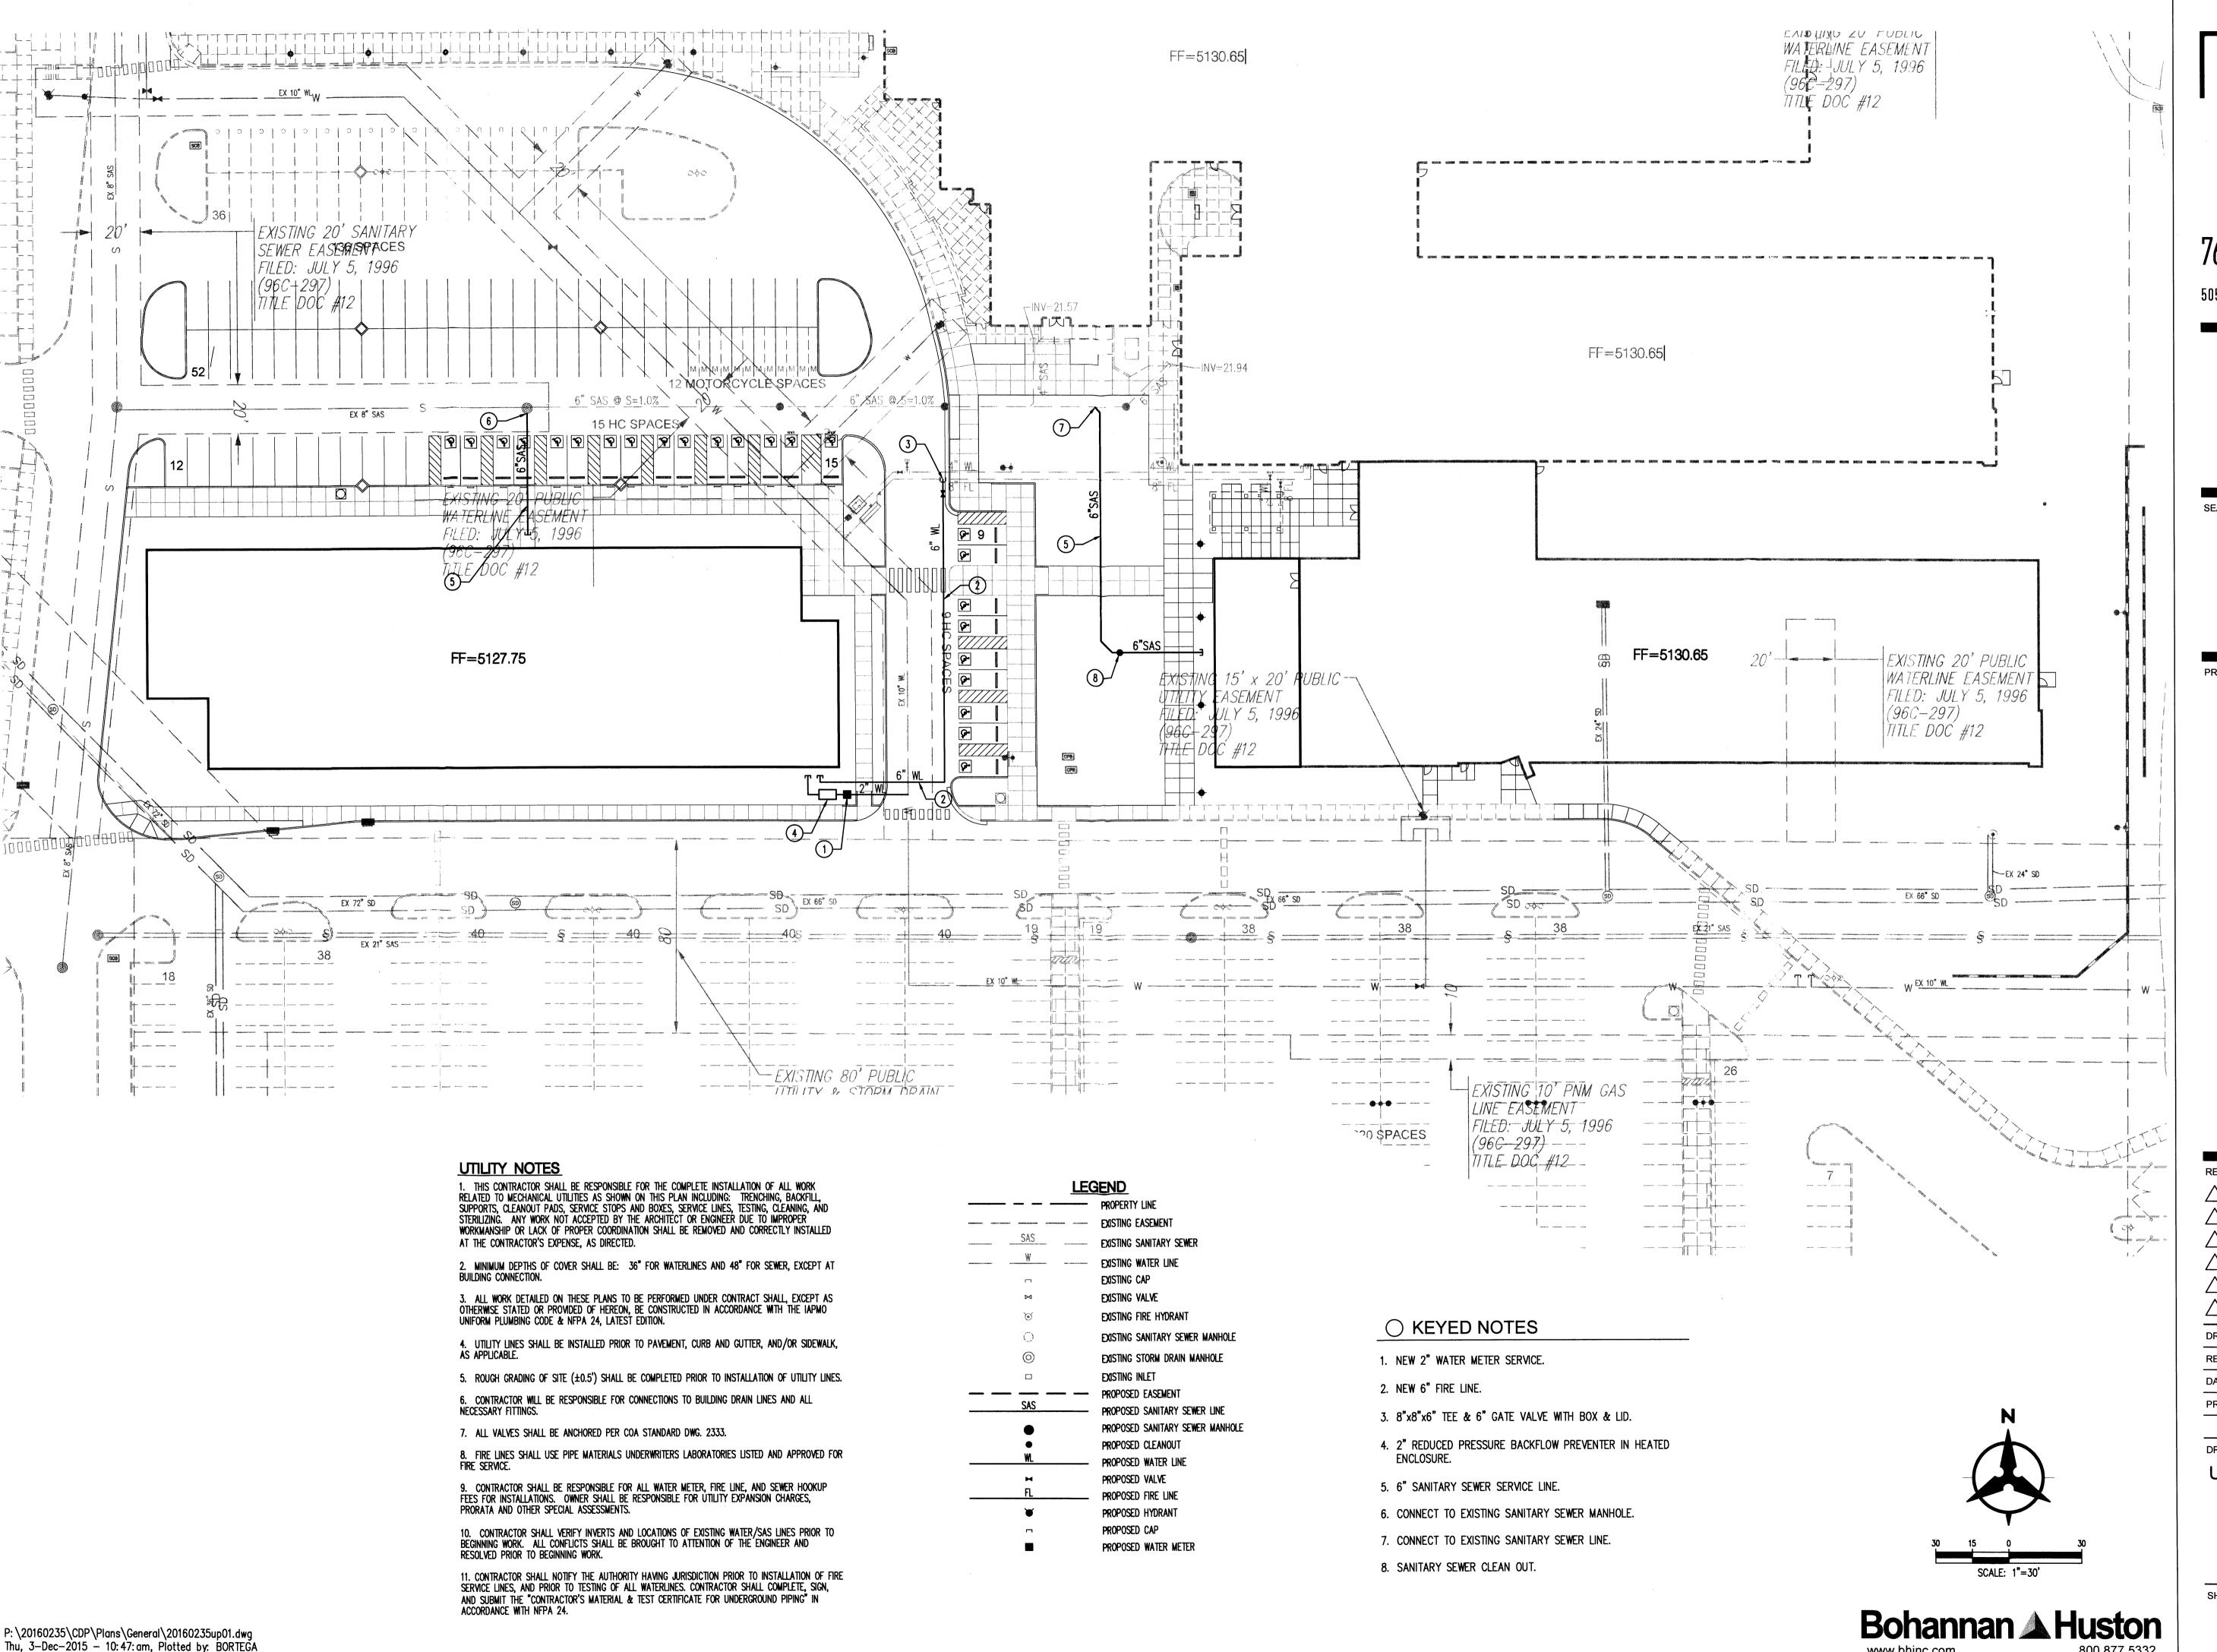

PERICH SABATINI

7601 JEFFERSON NE, SUITE 100 ALBUQUERQUE, NM 87109

505.761.9700 / DPSDESIGN.ORG

PROJECT

REVISIONS

DRAWN BY

GSB **REVIEWED BY** 12/03/2015 DATE 15-0129 PROJECT NO

во


DRAWING NAME **UTILITY PLAN** 


SHEET NO

800.877.5332

www.bhinc.com

\_\_\_\_

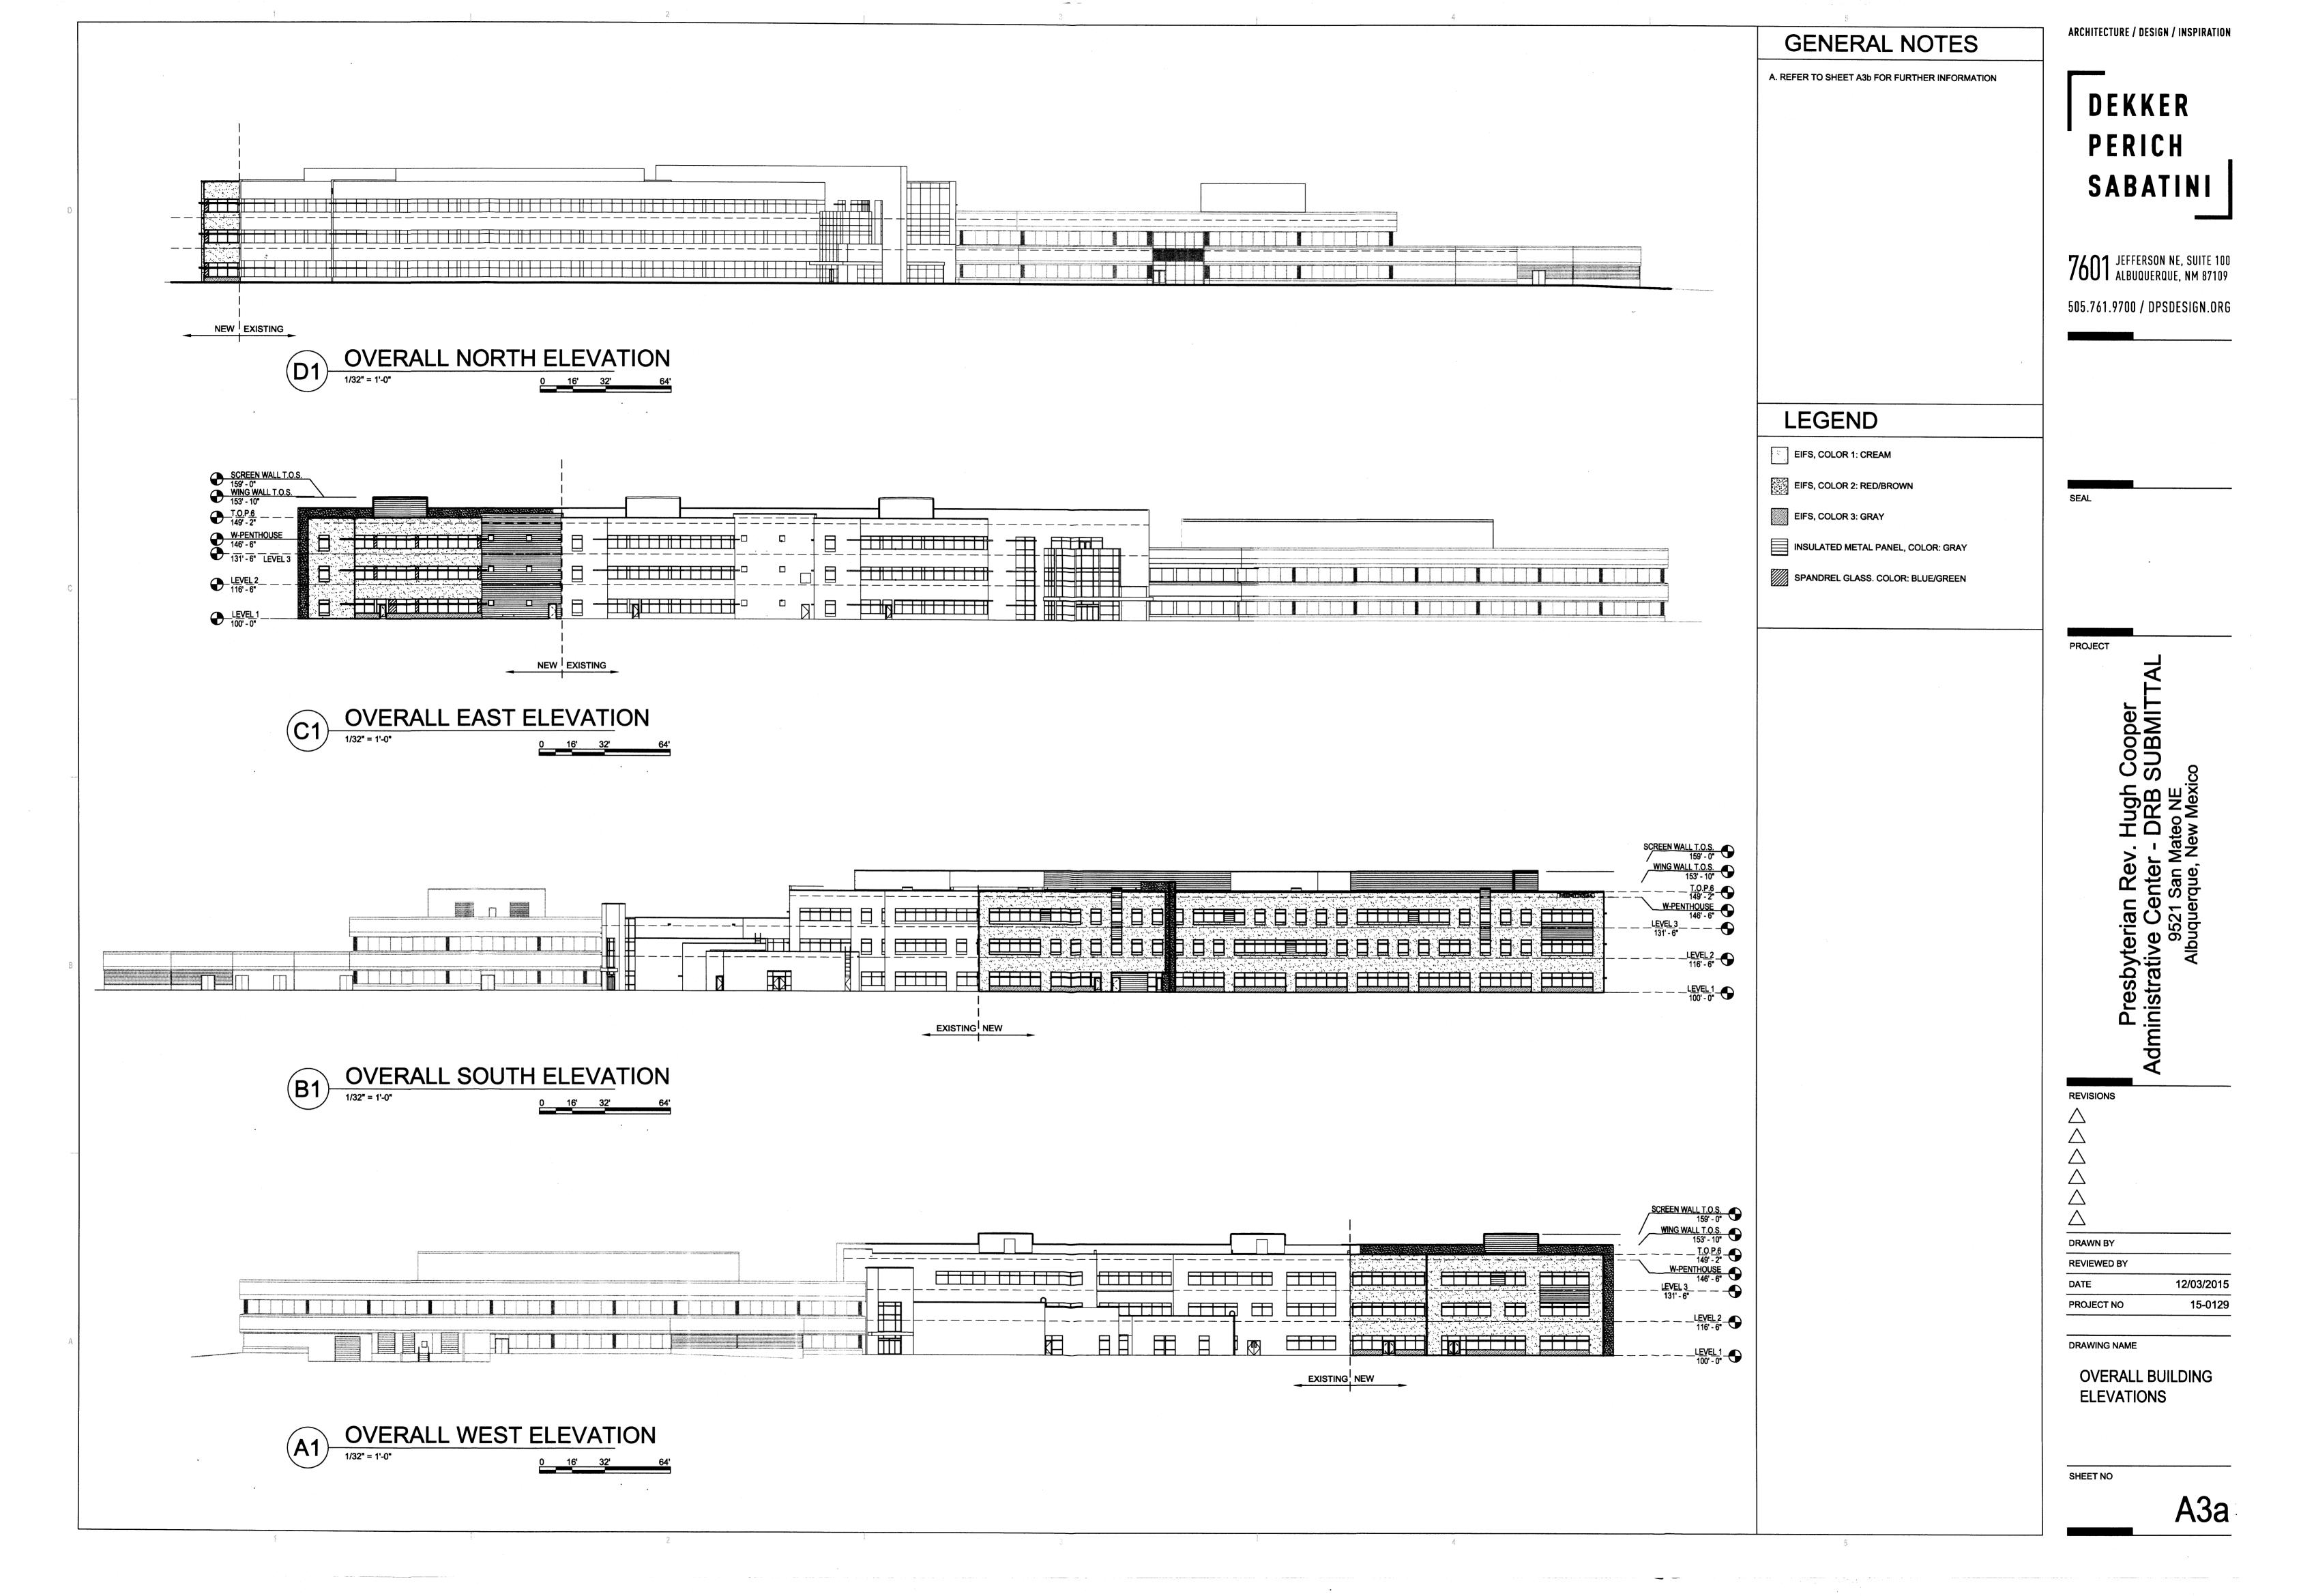

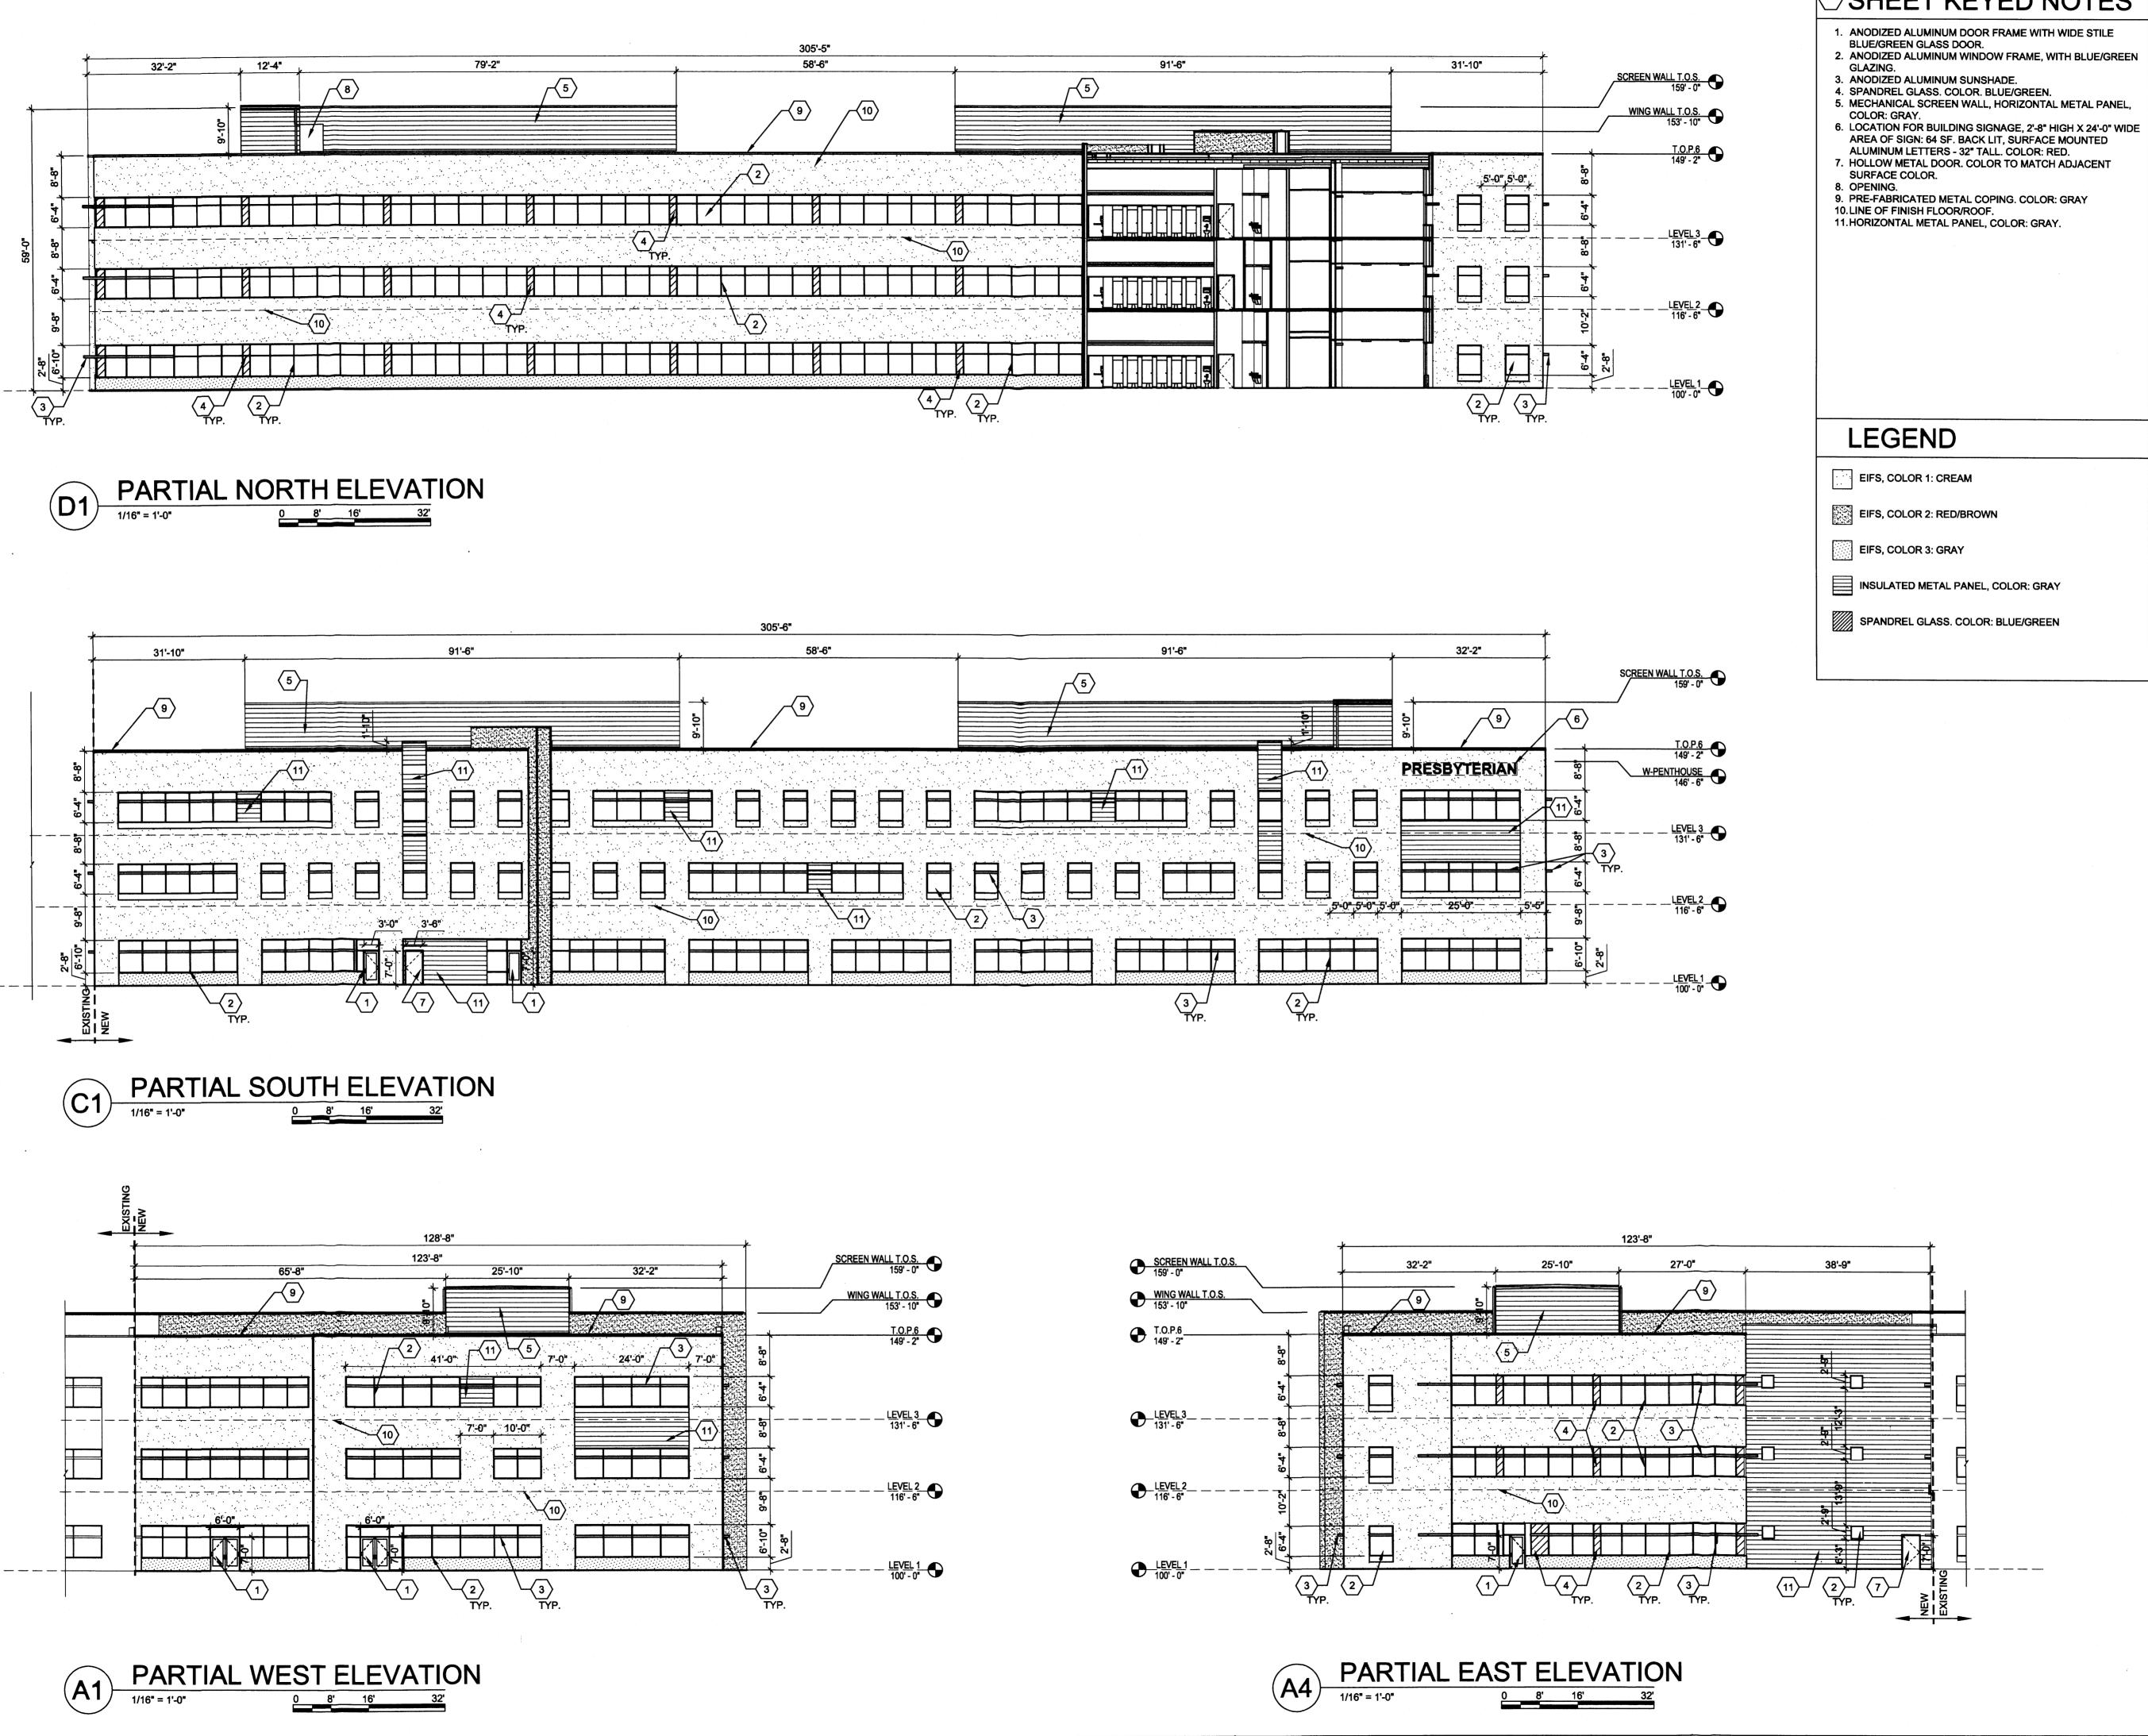

ARCHITECTURE / DESIGN / INSPIRATION ○ SHEET KEYED NOTES

> DEKKER PERICH SABATINI

7601 JEFFERSON NE, SUITE 100 ALBUQUERQUE, NM 87109

505.761.9700 / DPSDESIGN.ORG

**PROJECT** 

SUBMIT V. Hr. Mateo

**REVISIONS DRAWN BY** 

> **REVIEWED BY** DATE

PROJECT NO

DRAWING NAME **NEW BUILDING ELEVATIONS** 

SHEET NO

A3b

12/03/2015

15-0129

