

BUILDING AND FENCE COLORS

ASPHALT SHINGLES: AUTUMN BROWN (AB) BROWNWOOD (BW)

STUCCO COLORS: ALTERNATING BUILDINGS STUCCO (SA) EL REY BUCKSKIN STUCCO (SB) EL REY COTTONWOOD

WOOD TRIM COLOR:

VINYL WINDOW W/ DIVIDERS COLOR: WHITE (W)

ENTRY DOOR COLOR: WHITE (W)

WALL MOUNTED

EXTERIOR LED DOWNLIGHT

12" HIGH WALL MOUNTED


PAINTED STEEL SIGN WITH 4"

HIGH WALL MOUNTED ADDRESS

BRUSHED ALUMINUM/

SIGN - 21 SQUARE FEET

STUCCO TRIM: (AT WINDOWS) WHITE (W)

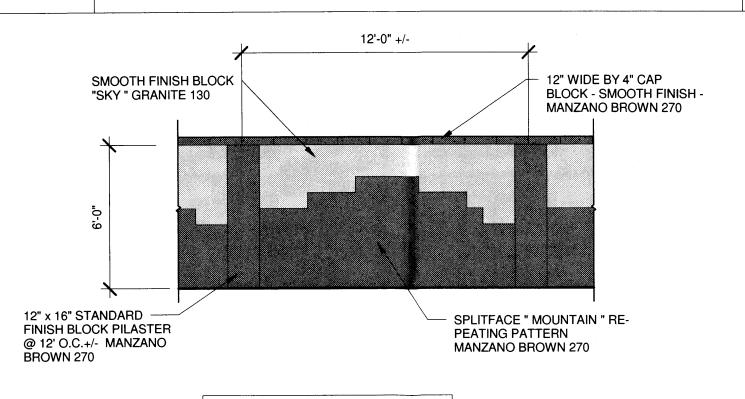

NOTE: MASONRY COLORS ARE AS PER UTILITY BLOCK CO. , ALBUQUERQUE

STREET FRONTAGE WALL Scale: 1/4" = 1'-0"CONCRETE BOLLARDS (4)

25'-6" **EAST ELEVATION**

TGRANITE 130[™] 10'-4"

NORTH AND SOUTH ELEVATION

WEST ELEVATION

The IMPACT Trapezoid cutoff wall luminaire makes an ideal complement to

site design. U.L. Listed and CSA Certified for wet locations in down mount

lugged construction and full cutoff classified optics provide facade and

C ... Optical Modules

performance 95% reflective sheet.

Type II optical module is standard.

security lighting for light restricted zones surrounding schools, office

applications and damp locations in up mounted applications.

nplexes, apartments, and recreational facilities.

of die-cast aluminum for precise

control of tolerances and

25'-6"

COOPER LIGHTING - LUMARK®

032113

TIRY24

ROGER CINELLI

Die-cast door features, 1/8" heat-

tempered glass lens mounted with

and impact-resistant clear

sealed with EPDM gasketing.

REFUSE ENCLOSURE - WEST **END** (EAST SIMILAR)

Scale: 1/4" = 1'-0"

12" HIGH COLORED **BLOCK PLANTER -**MANZANO BROWN - 270 PROJECT SIGN ELEVATION


PERSPECTIVE - 10TH

TYPICAL STREET FRONTAGE

SPLITFACE BLOCK WALL

COLORED AND

& CANDELARIA PROTOTYPE

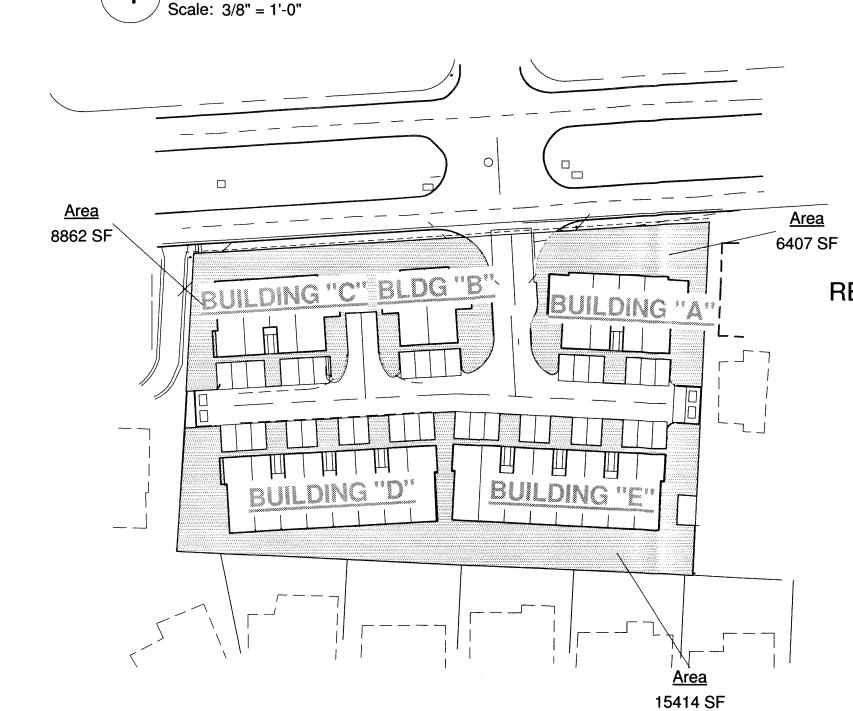

Scale: 1/64" = 1'-0"

USABLE OPEN SPACE:

REQUIRED OPEN SPACE: 26 UNITS X 550 = 14,300 SF UOS PROVIDED = 30,683 SF **COMPLIES**

USABLE OPEN SPACE 11,910 MENAUL BLVD. N.E.

HID luminaires supplied with hig Hinged door secured in place Gasketed and zinc plated rigid steel mounting attachment fits directly power factor ballast with Class H insulation. Minimum starting F ... Finish to 4" J-Box or wall with temperatures are -40°C (-40°F) for Durable polyester powder coat finish. Standard color is bronze. Hook-N-Lock" mechanism for HPS and -30°C (-22°F) for MH. quick installation. Secured with Compact Fluorescent luminaire two (2) captive corrosion resistant feature electronic universal Optional white and black colors 120-277V high efficient 50/60Hz ballast with -18°C (0°F) minimum black oxide coated allen head set available. Other finish colors screws concealed but accessible available. Consult your Cooper **IMPACT** Lighting Representative concerning special color **TRAPEZOID** 50 - 175W High Pressure Sodium *impact* Metal Halid 26 - 52W Compact Fluorescent
FULL CUTOFF WALL MOUNT LUMINAIR Temperature External Supply Wiring 90°C Down Mounted-Wet Location Up Mounted-Damp Location ENERGY DATA High Reactance Ballast Inpu OW MH HPF (72 Watts) OW HPS HPF (91 Watts 100W HPS HPF (130 Watts) 100W MH HPF (129 Watts) 150W HPS HPF (190 Watts)

DARK SKY F 50W MH HPF (185 Watts CWA Ballast Input Watts HOOK-N-LOCK MOUNTING 5W MH HPF (210 Watts 26W PL HPF (29 Watts) 42W PL HPF (46 Watts) 52W PL HPF (55 Watts) HIPPING DATA pproximate Net Weight lbs. (8 kgs.)

DAWN TO DUSK HOODED LIGHT FIXTURE

INTRODUCTION

THE SITE DEVELOPMENT PLAN FOR BUILDING PERMIT SUBMITTAL SHALL SERVE AS THE OWNER'S SUBMITTAL FOR ZONE CHANGE TO THE PROPERTY LOCATED ON THE SOUTH SIDE OF MENAUL N.E. BETWEEN DEANNA STREET N.E. AND CHELWOOD PARK BLVD. N.E. - 11,910 MENAUL BLVD. N.E.

THE SUBJECT PROPERTY CONSISTS OF ONE (1) PARCEL THAT IS ZONED 0-1. THE PROPERTY IS 1.72626 ACRES. THE PARCEL HAS NO EXISTING IMPROVEMENTS EXCEPT FOR A 6' WIDE CONCRETE SIDEWALK ALONG MENAUL. WE RESPECTFULLY SEEK A CHANGE OF ZONE TO SU-1/PLANNED RESIDENTIAL DEVELOPMENT.

THE PROPERTY IS UNDER CONTRACT BY MR.JOE AZAR OF AZAR PROPERTIES, L.L.C. MR. AZAR PLANS TO RENT THE UNITS AS THE INDIAN RIDGE PATIO HOMES. AN AUTHORIZATION LETTER FROM THE PROPERTY OWNER IS PART OF THE SUBMITTAL PACKAGE.

THE PROPOSAL FOR THE PROPERTY CONSISTS OF A TWENTY-SIX (26) UNIT TOWNHOUSE DEVELOPMENT. THIS EQUATES TO A 15 DWELLING UNITS PER ACRE. THE SUBJECT PROPERTY IS ADJACENT TO THE ENCHANTED PARK NEIGHBORHOOD'S (ENP)SOUTHERN BORDER. ENP HAS BEEN APPRISED OF THIS SUBMITTAL

THE NEIGHBORING ZONING LENDS LEGITIMACY TO THIS ZONE CHANGE REQUEST. RESIDENTIAL ZONING AND USES PREDOMINATE TO THE SOUTH AND WEST OF THE SUBJECT STREET, AND ON THE NORTH BY THE SUBJECT PROPERTY'S SOUTHERN BOUNDARY. THE RESIDENTIAL ZONE THAT ABUTS THE SUBJECT PROPERTY'S WEST BOUNDARY CONSISTS OF FOUR (4) TWO STORY HOUSING UNITS IN A HIGH DENSITY (R-3) CONFIGURATION. THE DEVELOPMENT WAS ERECTED IN 1973. THE "MENAUL VILLAGE PRIVATE CONDOMINIUM COMMUNITY" IS ACCESSED VIA STILWELL PLACE STREET N.E. WHICH CONTINUES THROUGH THE DEVELOPMENT THEN TURNS NORTH AS A PRIVATE DRIVE THAT INTERSECTS WITH MENAUL BOULEVARD. THE SUBJECT PROPERTY LIES DIRECTLY EAST OF THE PRIVATE DRIVE. AN EXISTING SHORT RETAINING WALL WITH A FOUR (4) FOOT HIGH GRAPESTAKE

COMMERCIAL USES COMPRISE THE PROPERTY TO THE NORTH ACROSS MENAUL BOULEVARD. ADDITIONAL COMMERCIAL USES ABUT THE EASTERLY BOUNDARY OF THE SUBJECT PROPERTY. THESE PARCELS AREA ALL ZONED C-1. THE NEIGHBORHOOD COMMERCIAL (C-1) ZONE PERMITS R-3 NEIGHBORHOOD RESIDENTIAL USES.; THE ZONING IS

MENAUL BOULEVARD AT THE SUBJECT PROPERTY FRONTAGE IS DESCRIBED AS A 4LD TYPE MAJOR STREET. THE 100 FOOT WIDE (100') RIGHT OF WAY CONSISTS OF FOUR (4) LANES, WHICH ARE DIVIDED WITH A RAISED MEDIAN. THE MEDIAN IS DISTINGUISHED BY WELL MAINTAINED XERISCAPING. THE MEDIAN INTERSECTION OCCURS AT FIGUEROA DRIVE N.E. THE PROJECT PROPOSED RADIUS RETURN DRIVEWAY IS CLOSELY ALIGNED WITH THE FIGUEROA DRIVE INTERSECTION TO FACILITATE LEFT TURN ACCESS FOR WESTBOUND TRAFFIC. A PUBLIC BUS TRANSIT STOP ON THE SOUTH SIDE OF MENAUL IS SITUATED SIXTY FEET (60') WEST OF THE DEVELOPMENT

A LANDSCAPED STRIP AND DECORATIVE SPLIT FACE WALL AT THE MENAUL FRONTAGE DISTINGUISHES THE DEVELOPMENT FROM THE STREET. LANDSCAPING SHALL COMPLY WITH MULTI FAMILY RESIDENTIAL USES. PROPOSED LANDSCAPING SHALL PROVIDE ADEQUATE SCREENING FOR SINGLE FAMILY DEVELOPMENTS. UNIT GARAGE DRIVEWAYS WILL BE SEPARATED BY LANDSCAPE AREAS WITH TREES. THREES SHALL REACH A 25' TO 35' SPREAD AT MATURITY.

ALL VEHICULAR ACCESS IS PROVIDED VIA THE MAIN DRIVEWAY ENTRANCE THENCE EAST-WEST PRIVATE LANES. THESE VEHICULAR/PEDESTRIAN LANES TERMINATE AT THE EAST AND WEST WHERE DUAL REFUSE/RECYCLE DUMPSTER ENCLOSURES ARE LOCATED. OFF STREET RESIDENT PARKING IS PROVIDED AT EACH GARAGE AND IT'S ACCOMPANYING DRIVEWAY. TWO PARKING SPACES ARE ACCOMMODATED IN THIS WAY AT THE TWO BEDROOM TYPE "A" & "B" UNITS. FOUR PARKING SPACES ARE PROVIDED FOR AT THE THREE BEDROOM UNIT AND THE TWO BEDROOM TWO CAR GARAGE TYPE "C" UNIT; TWO IN THE DRIVEWAY AND TWO IN THE GARAGE.

ALL PROPOSED TOWNHOUSES ARE TWO STORY WITH SINGLE STORY FEATURES. ALL VEHICULAR LANE FACADES ARE SINGLE STORY, THEN STEP UP TO A TWO STORY FACADE. ADDITIONALLY, THE THREE BEDROOM TOWNHOUSES, LOCATED ALONG DRIVEWAY ENTRANCE PRESENT A SINGLE STORY ELEVATION. THUS, A MORE GRADUAL BUILDING ELEVATION TRANSITION IS ACHIEVED FROM THE PASSERBY VIEW.

THE PROTOTYPICAL TOWNHOUSE UNIT PHOTO IS ATTACHED. THE TENTH AND CANDELARIA NW PROJECT PROVIDES AN ACCURATE PHOTOGRAPHIC RENDERING FOR REFERENCE.

DESIGN CRITERIA

2 X 264 = 528 SF

1 X 382 = 382 SF

1 X 424 = 424 SF 1334 SF GARAGE

CODES: 2009 IRC, 2009UMC, 2009 UPC, 2014NEC TWO BEDROOM/ 2 1/2 BATH TYPE "B" UNITS: PROJECT LOCATION: SOUTH SIDE OF MENAUL BETWEEN CHELLWOOD PARK BLVD. AND DEANNA FLOOR AREA (EA. UNIT): LOWER LEVEL HEATED <u>UPPER LEVEL HEATED</u> TOTAL HEATED 11,910 MENAUL BLVD N.E., ALBUQUERQUE, NM **ZONE ATLAS MAP:** H-22 LEGAL DESCRIPTION: TRACT 2-A INDIAN RIDGE TWO BEDROOM/ 2 1/2 BATH TYPE "C" UNITS: <u>UPC:</u> 102205920526634222 FLOOR AREA (EA. UNIT): LOWER LEVEL HEATED 517 TOTAL ACREAGE: 1.727 ACRES UPPER LEVEL HEATED
TOTAL HEATED **EXISTING ZONING:** O-1 **LAND USE CLASSIFICATION:** 3000 **PROPOSED USES:** RESIDENTIAL DWELLINGS THREE BEDROOM/ 2 BATH UNITS: MAXIMUM HEIGHT: 25'-10" COMPLIES FLOOR AREA (EA. UNIT): PROPOSED ZONING: SU-1 FOR PLANNED RESIDENTIAL DEVELOPMENT - MAXIMUM 26 DWELLING UNITS LOWER LEVEL HEATED UPPER LEVEL HEATED
TOTAL HEATED **CONSTRUCTION TYPE:** TYPE VB NON SPRINKLERED GARAGE TOTAL AREA SEISMIC ZONE: D MAXIMUM TOTAL DWELLING UNITS: 26 UNITS - 15 DU'S PER ACRE **BUILDING AREAS: BUILDING "A"** REQUIRED PARKING:
TOWNHOUSE UNITS- 26 UNITS X 2.0 PARKING SPACES (2) TWO BEDROOM TYPE "B" UNITS + (2) THREE BEDROOM UNITS 2 X 1214 = 2428 SF 52 PARKING SPACES 2 X 1473 = 2956 SF 5374 SF HEATED PROPOSED PARKING:
OFF STREET PARKING = 72 PARKING SPACES (INCLUDING GARAGE SPACES) COMPLIES 2 X 264 = 528 SF 2 X 424 <u>=848 SF</u> 1376 SF GARAGE **USABLE OPEN SPACE:** REQUIRED OPEN SPACE: 26 UNITS X 550 = 14,300 SF UOS PROVIDED =30,683 SF COMPLIES (2) THREE BEDROOM UNIT 1473 X 2 = 2946 SF HEATED **LANDSCAPE CALCULATION:** 424 X 2 = 848 SF GARAGE SEE SHEET DRB-5 BUILDING "C" **UNIT AREAS:** (2) TWO BEDROOM TYPE "B" UNITS + TWO BEDROOM/ 2 1/2 BATH TYPE "A" UNITS: (1) TWO BEDROOM TYPE "C" UNIT + (1) THREE BEDROOM UNIT FLOOR AREA (EA. UNIT): 2 X 1214 = 2428 SF LOWER LEVEL HEATED UPPER LEVEL HEATED TOTAL HEATED 1 X 1188 = 1188 SF <u>671</u> 1 X 1473 = 1473 SF 5089 SF HEATED 1188 SF

GARAGE TOTAL AREA

(2) TWO BEDROOM TYPE "A" UNITS + (4) TWO BEDROOM TYPE "B" UNITS + (2) TWO BEDROOM TYPE "C" UNITS 2 X 1188 = 2376 SF 4 X 1214 = 4856 SF 2 X 1188 = 2376 SF 9608 SF HEATED 2 X 264 = 528 SF 4 X 264 = 382 SF $2 \times 382 = 764 \text{ SF}$ 1820 SF GARAGE (2) TWO BEDROOM TYPE "A" UNITS + (4) TWO BEDROOM TYPE "B" UNITS + (2) TWO BEDROOM TYPE "C" UNITS 2 X 1188 = 2376 SF 4 X 1214 = 4856 SF 2 X 1188 = 2376 SF 9608 SF HEATED $2 \times 264 = 528 \text{ SF}$ $4 \times 264 = 382 \text{ SF}$ 2 X 382 = 764 SF 1820 SF GARAGE

PROJECT BUILDING AREAS:

BUILDING "B" = 2946 SF BUILDING "C" = 5089 SF BUILDING "D" = 9608 SF BUILDING "E" = 9608 SF
TOTAL HEATED AREA = 32,625 SQUARE FEET 1376 SF BUILDING "A" = BUILDING "B" = 848 SF BUILDING "C" = 1334 SF BUILDING "D" = 1820 SF BUILDING "E" = 1820 SF TOTAL GARAGE AREA = 7202 SQUARE FEET STORAGE BUILDING = 240 SQUARE FEET TOTAL PROJECT AREA = 40,067 SQUARE FEET

> ¹ Roger Cinelli & Assoc. 2418 Manuel Torres Lane N.W. Albuquerque, New Mexico 87107 ARCHITECTS (505) 243-8211

PROJECT TITLE INDIAN RIDGE PATIO HOMES FOR JOE AZAR 11,910 MENAUL BLVD. N.E. ALBUQUERQUE, NEW MEXICO

DRAWING TITLE: SITE DEVELOPMENT PLAN INTRODUCTION & CODE SUMMARY PROJECT NO.





DRB-2

DEC. 15, 2015 TIRY37

DRAWING NO.

12/15/15

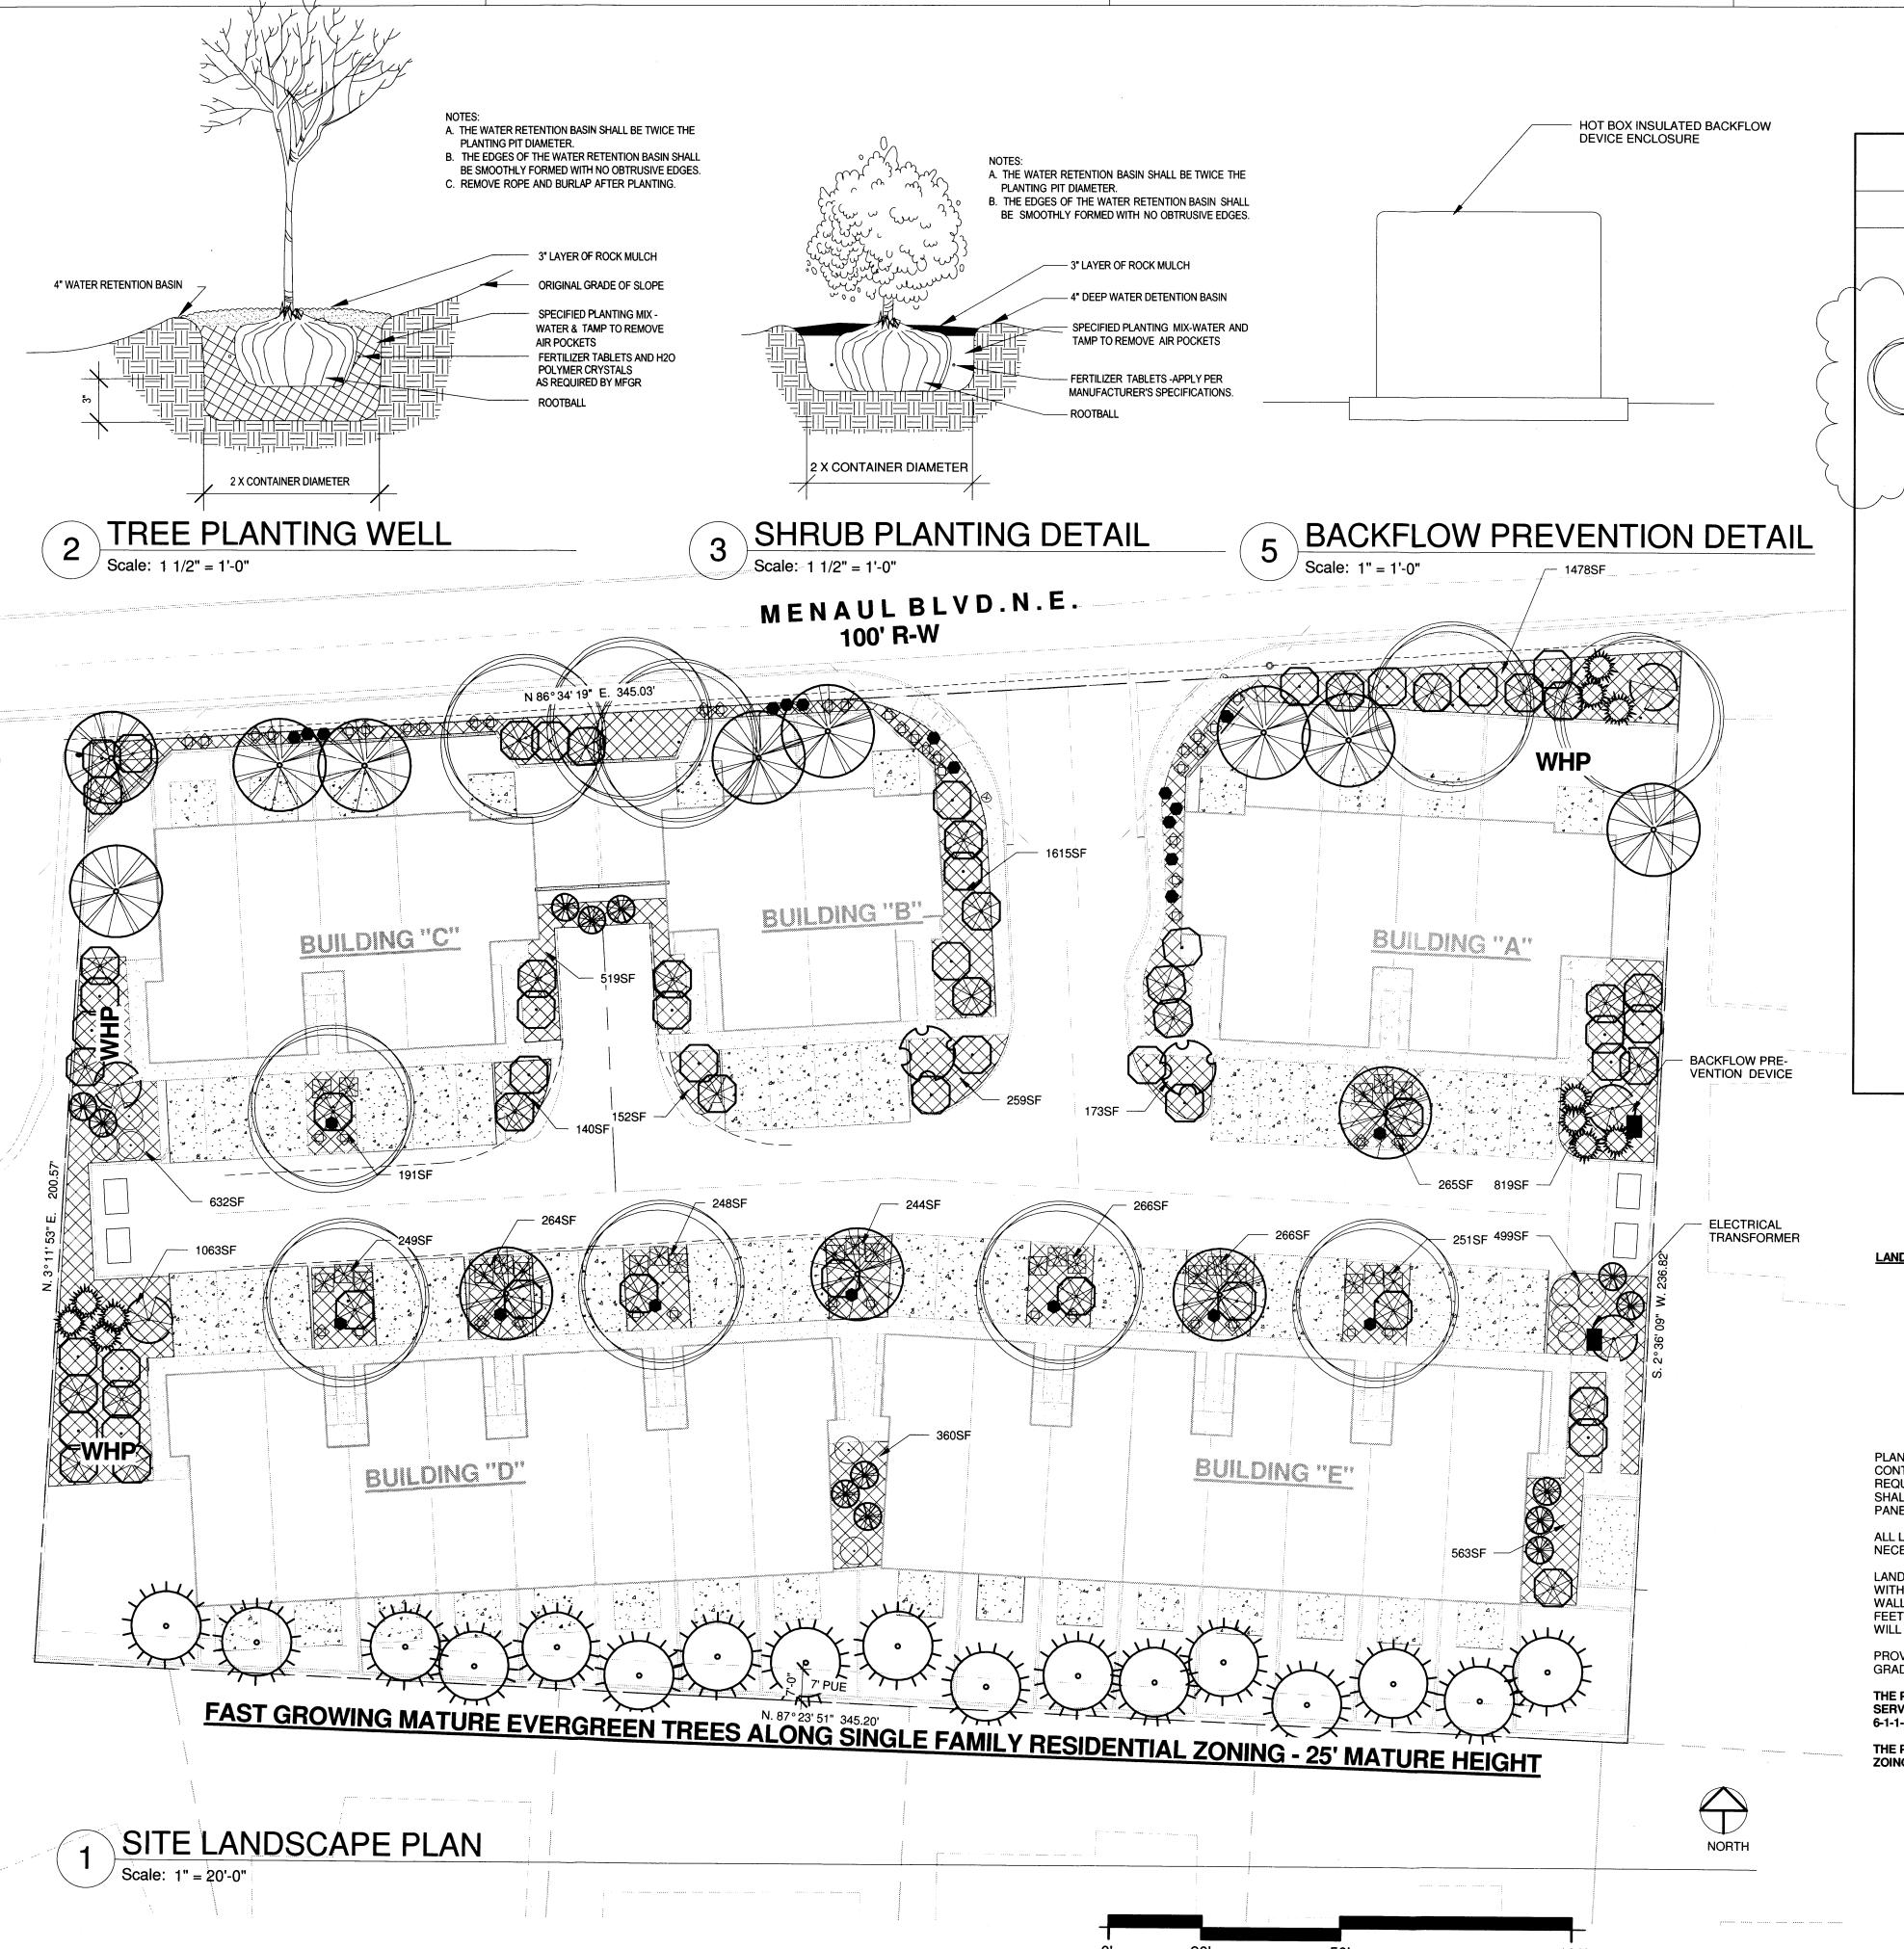

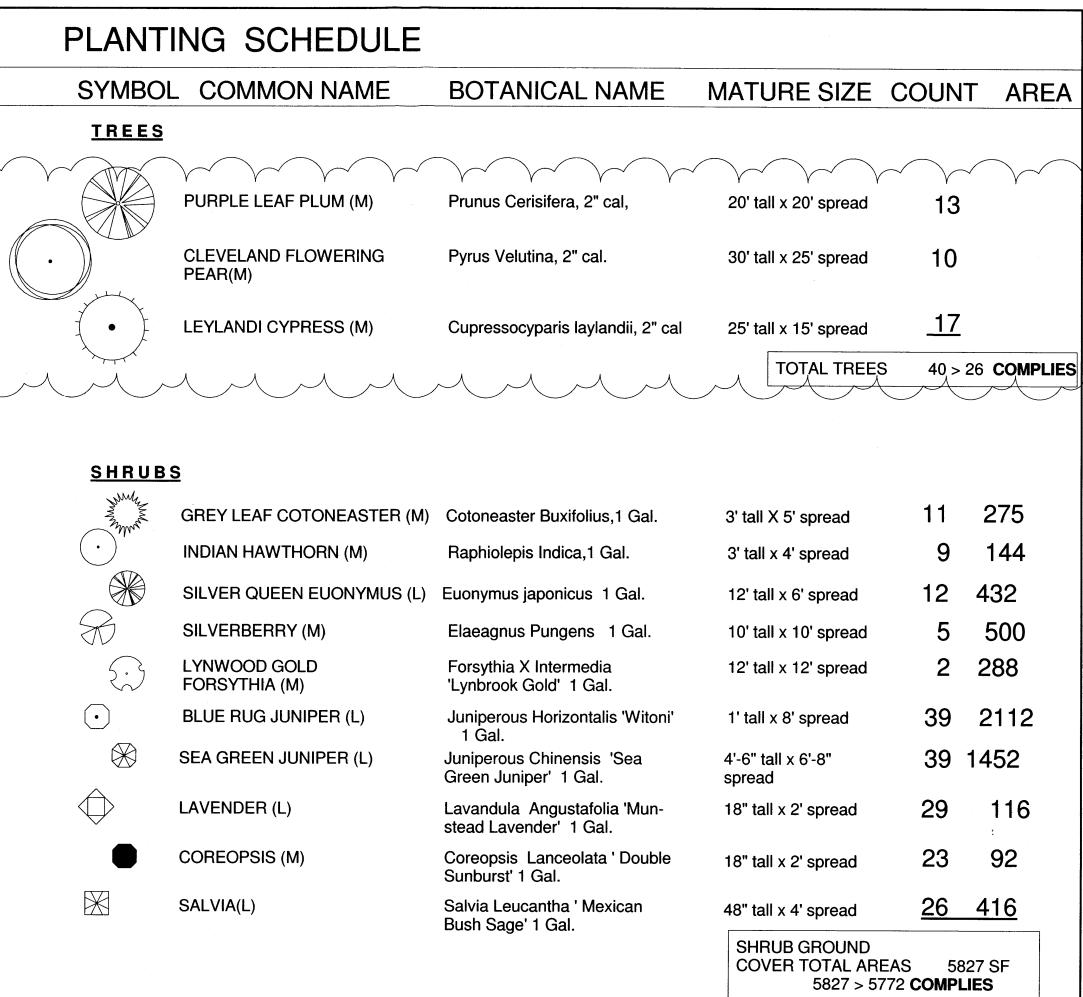

LANDSCAPING CALCULATIONS & NOTES

LANDSCAPE CALCULATION:

LOT: 1.727A X 43560 = 75,228 SF BUILDINGS: 23,920 SF NET LOT AREA REQUIRED LANDSCAPING: 51,308 X 15% = 7696 SF

LANDSCAPING PROVIDED: 10,156 SF COMPLIES REQUIRED 75% VEGETATIVE GROUND COVER = .75 X 7696 SF = 5772 SF VEGETATIVE GROUND COVER PROVIDED: 5827 SF

PLANT WATERING SHALL BE PROVIDED BY A DRIP IRRIGATION SYSTEM. CONTROLLERS SHALL BE PROVIDED IN THE NUMBER AND SPACING REQUIRED BY ZONE SPECIFICATION AND LOCATION. CONTROLLERS SHALL BE INSTALLED ON OWNERS HOUSE ELECTRICAL

ALL LANDSCAPING SHALL BE MAINTAINED AND REPLACED, IF NECESSARY, BY THE OWNER.

LANDSCAPING AND SIGNING WILL NOT INTERFERE WITH CLEAR SITE REQUIREMENTS, THEREFORE, SIGNS, WALLS, TREES AND SHRUBBERY BETWEEN 3 AND 8 FEET TALL (AS MEASURED FROM THE GUTTER PAN) WILL NOT BE ACCEPTABLE IN THIS AREA.

PROVIDE WATER HARVESTING PONDS AT ALL REAR YARDS AS PER GRADING AND DRAINAGE PLAN - SEE DRB-3


THE PROJECT SHALL COMPLY WITH THE "WATER CON-SERVATION AND WATER WASTE ORDINANCE" - ARTICLE

THE PROJECT SHALL COMPLY WITH THE CITY OF ALBUQUERQUE ZOING ORDINANCE - 14-16-3-10 GENERAL LANDSCAPE REGULATIONS

HATCH LEGEND



4" CONCRETE SIDEWALK, DRIVEWAY AND PATIO SLABS

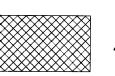

4" DEPTH OF 3/4" SANTA ANA TAN DECORATIVE GRAVEL ON 6 MIL VISQUEEN



WATER HARVESTING POND PER GRADING AND DRAINAGE PLAN


GRAVEL AREAS @ UNIT ENTRY ALCOVES ARE NOT INCLUDED IN PROPOSED LANDSCAPE AREAS



PROJECT TITLE


INDIAN RIDGE PATIO HOMES FOR JOE AZAR 11,910 MENAUL BLVD. N.E. ALBUQUERQUE, NEW MEXICO


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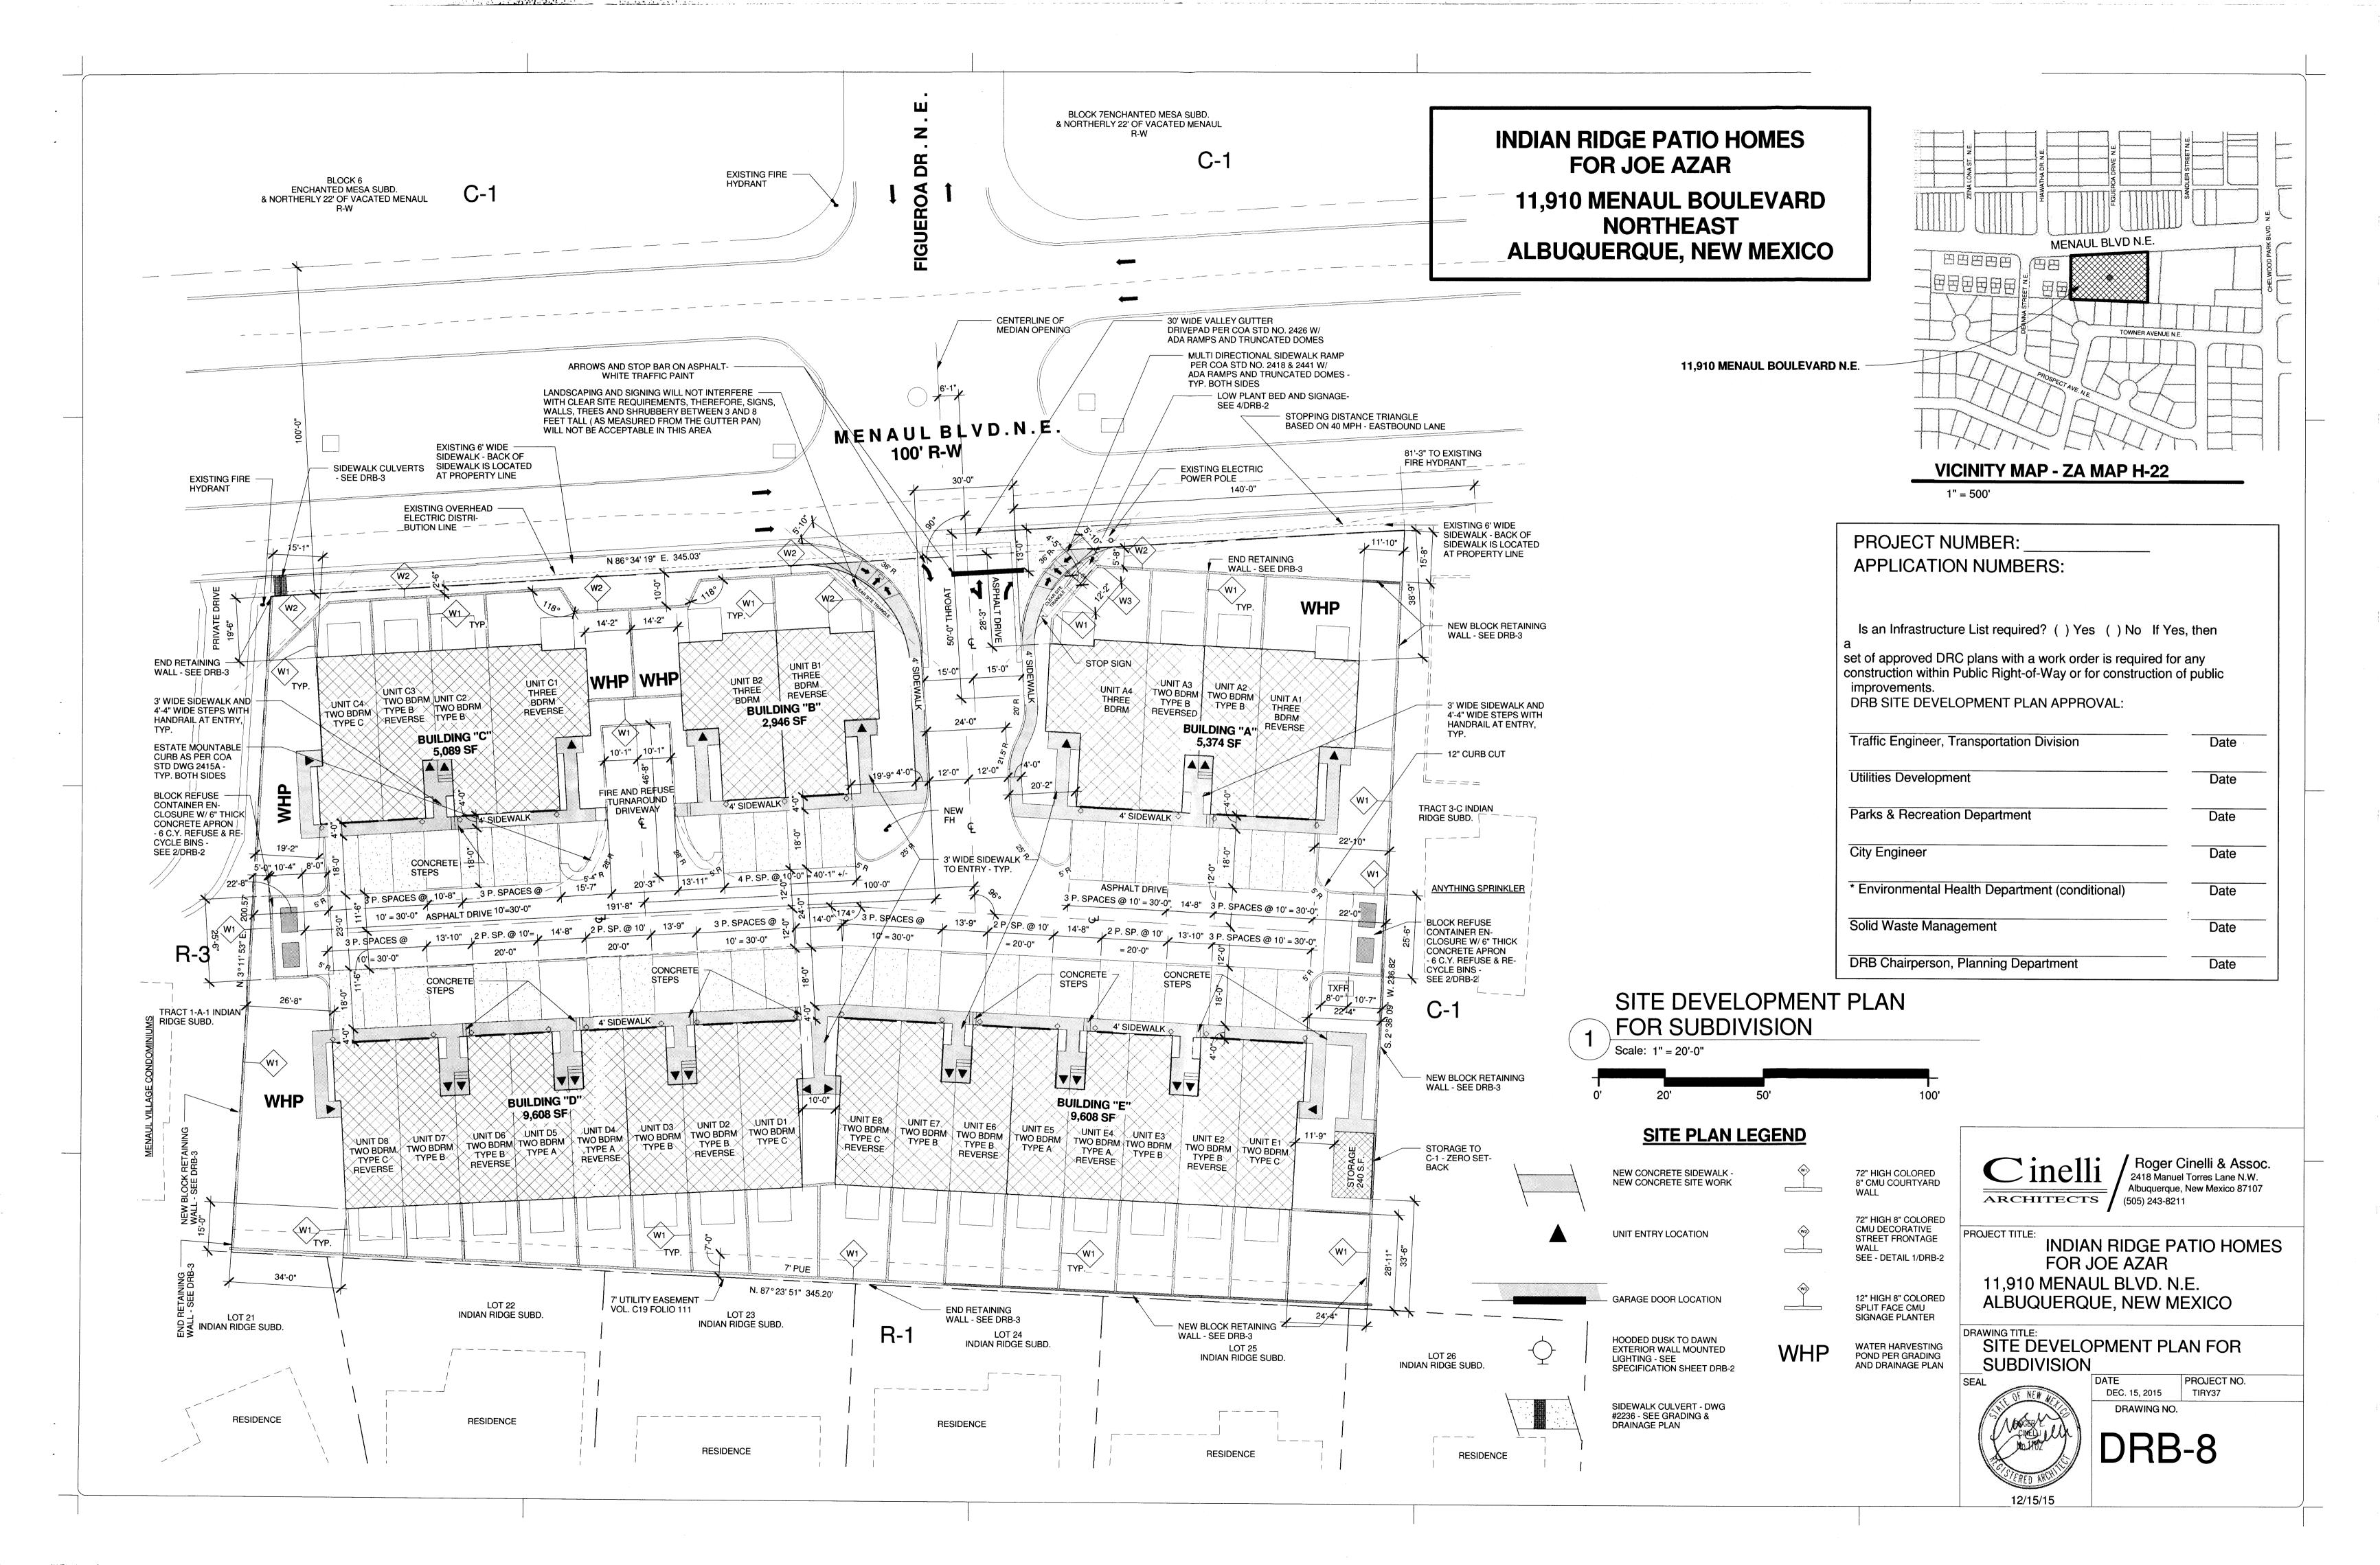


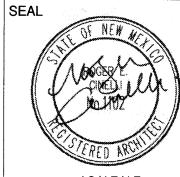PROJECT NO. DEC. 15, 2015 TIRY37 DRAWING NO.

DRB-5



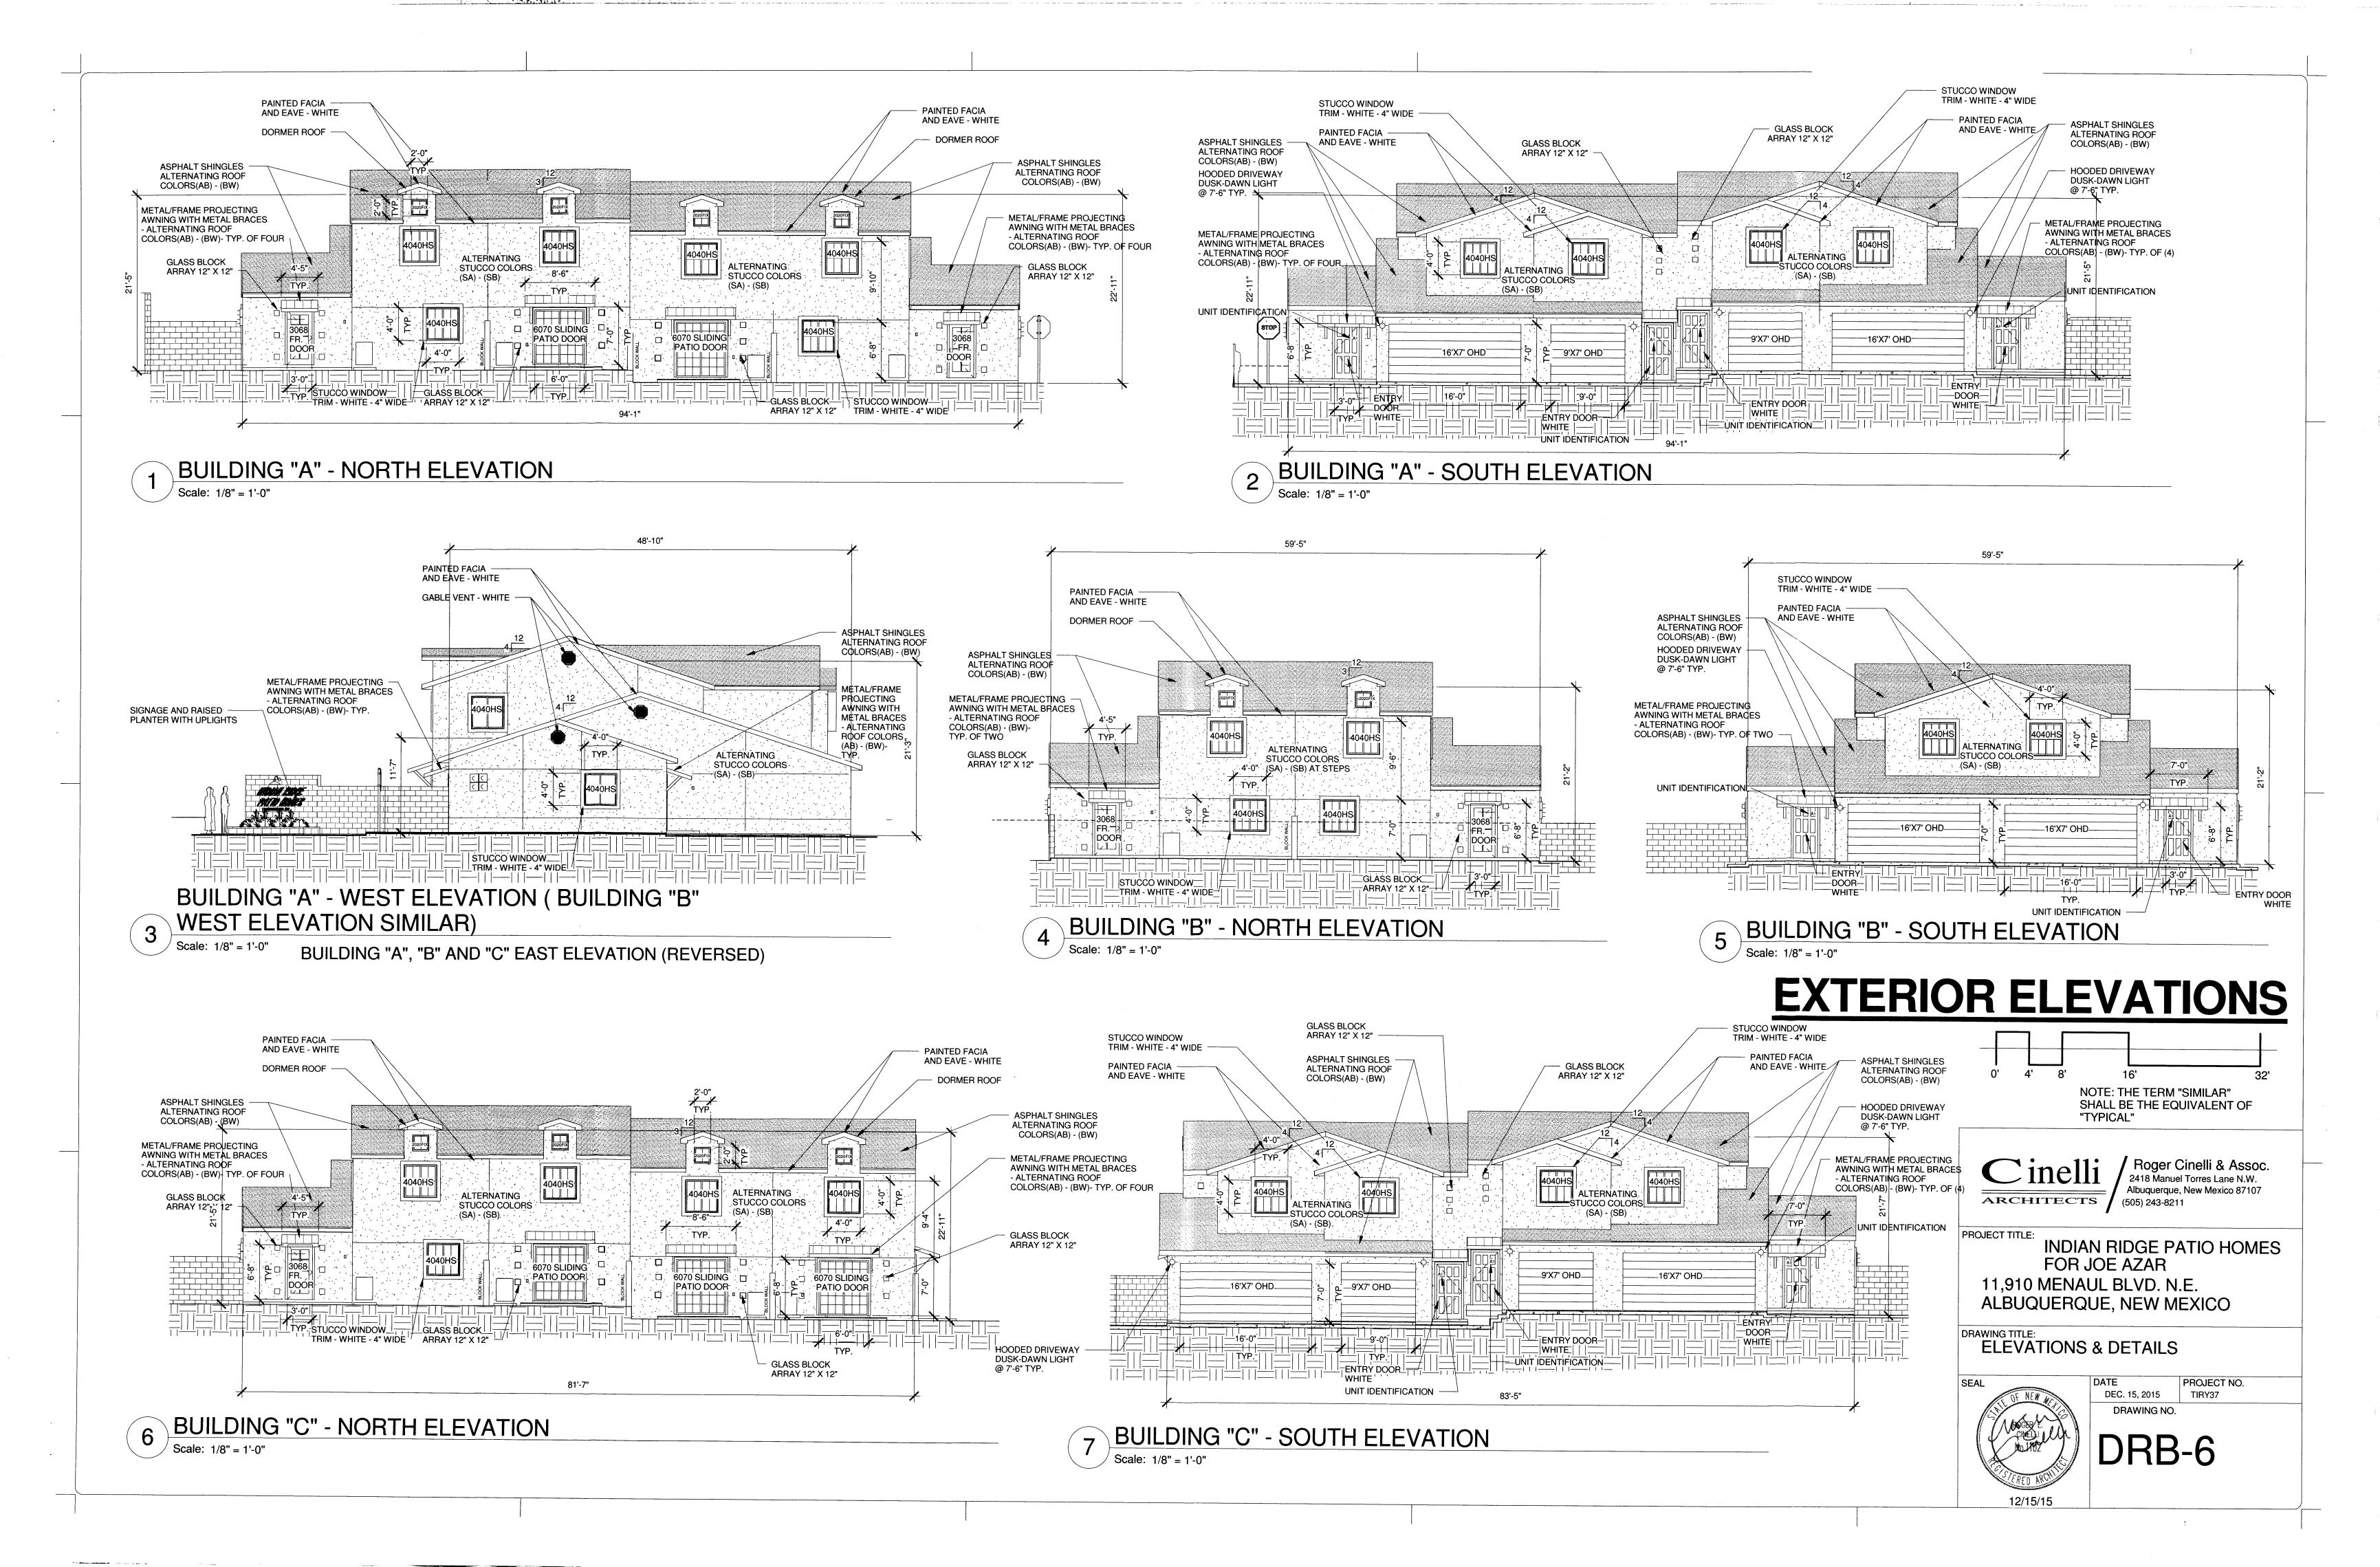


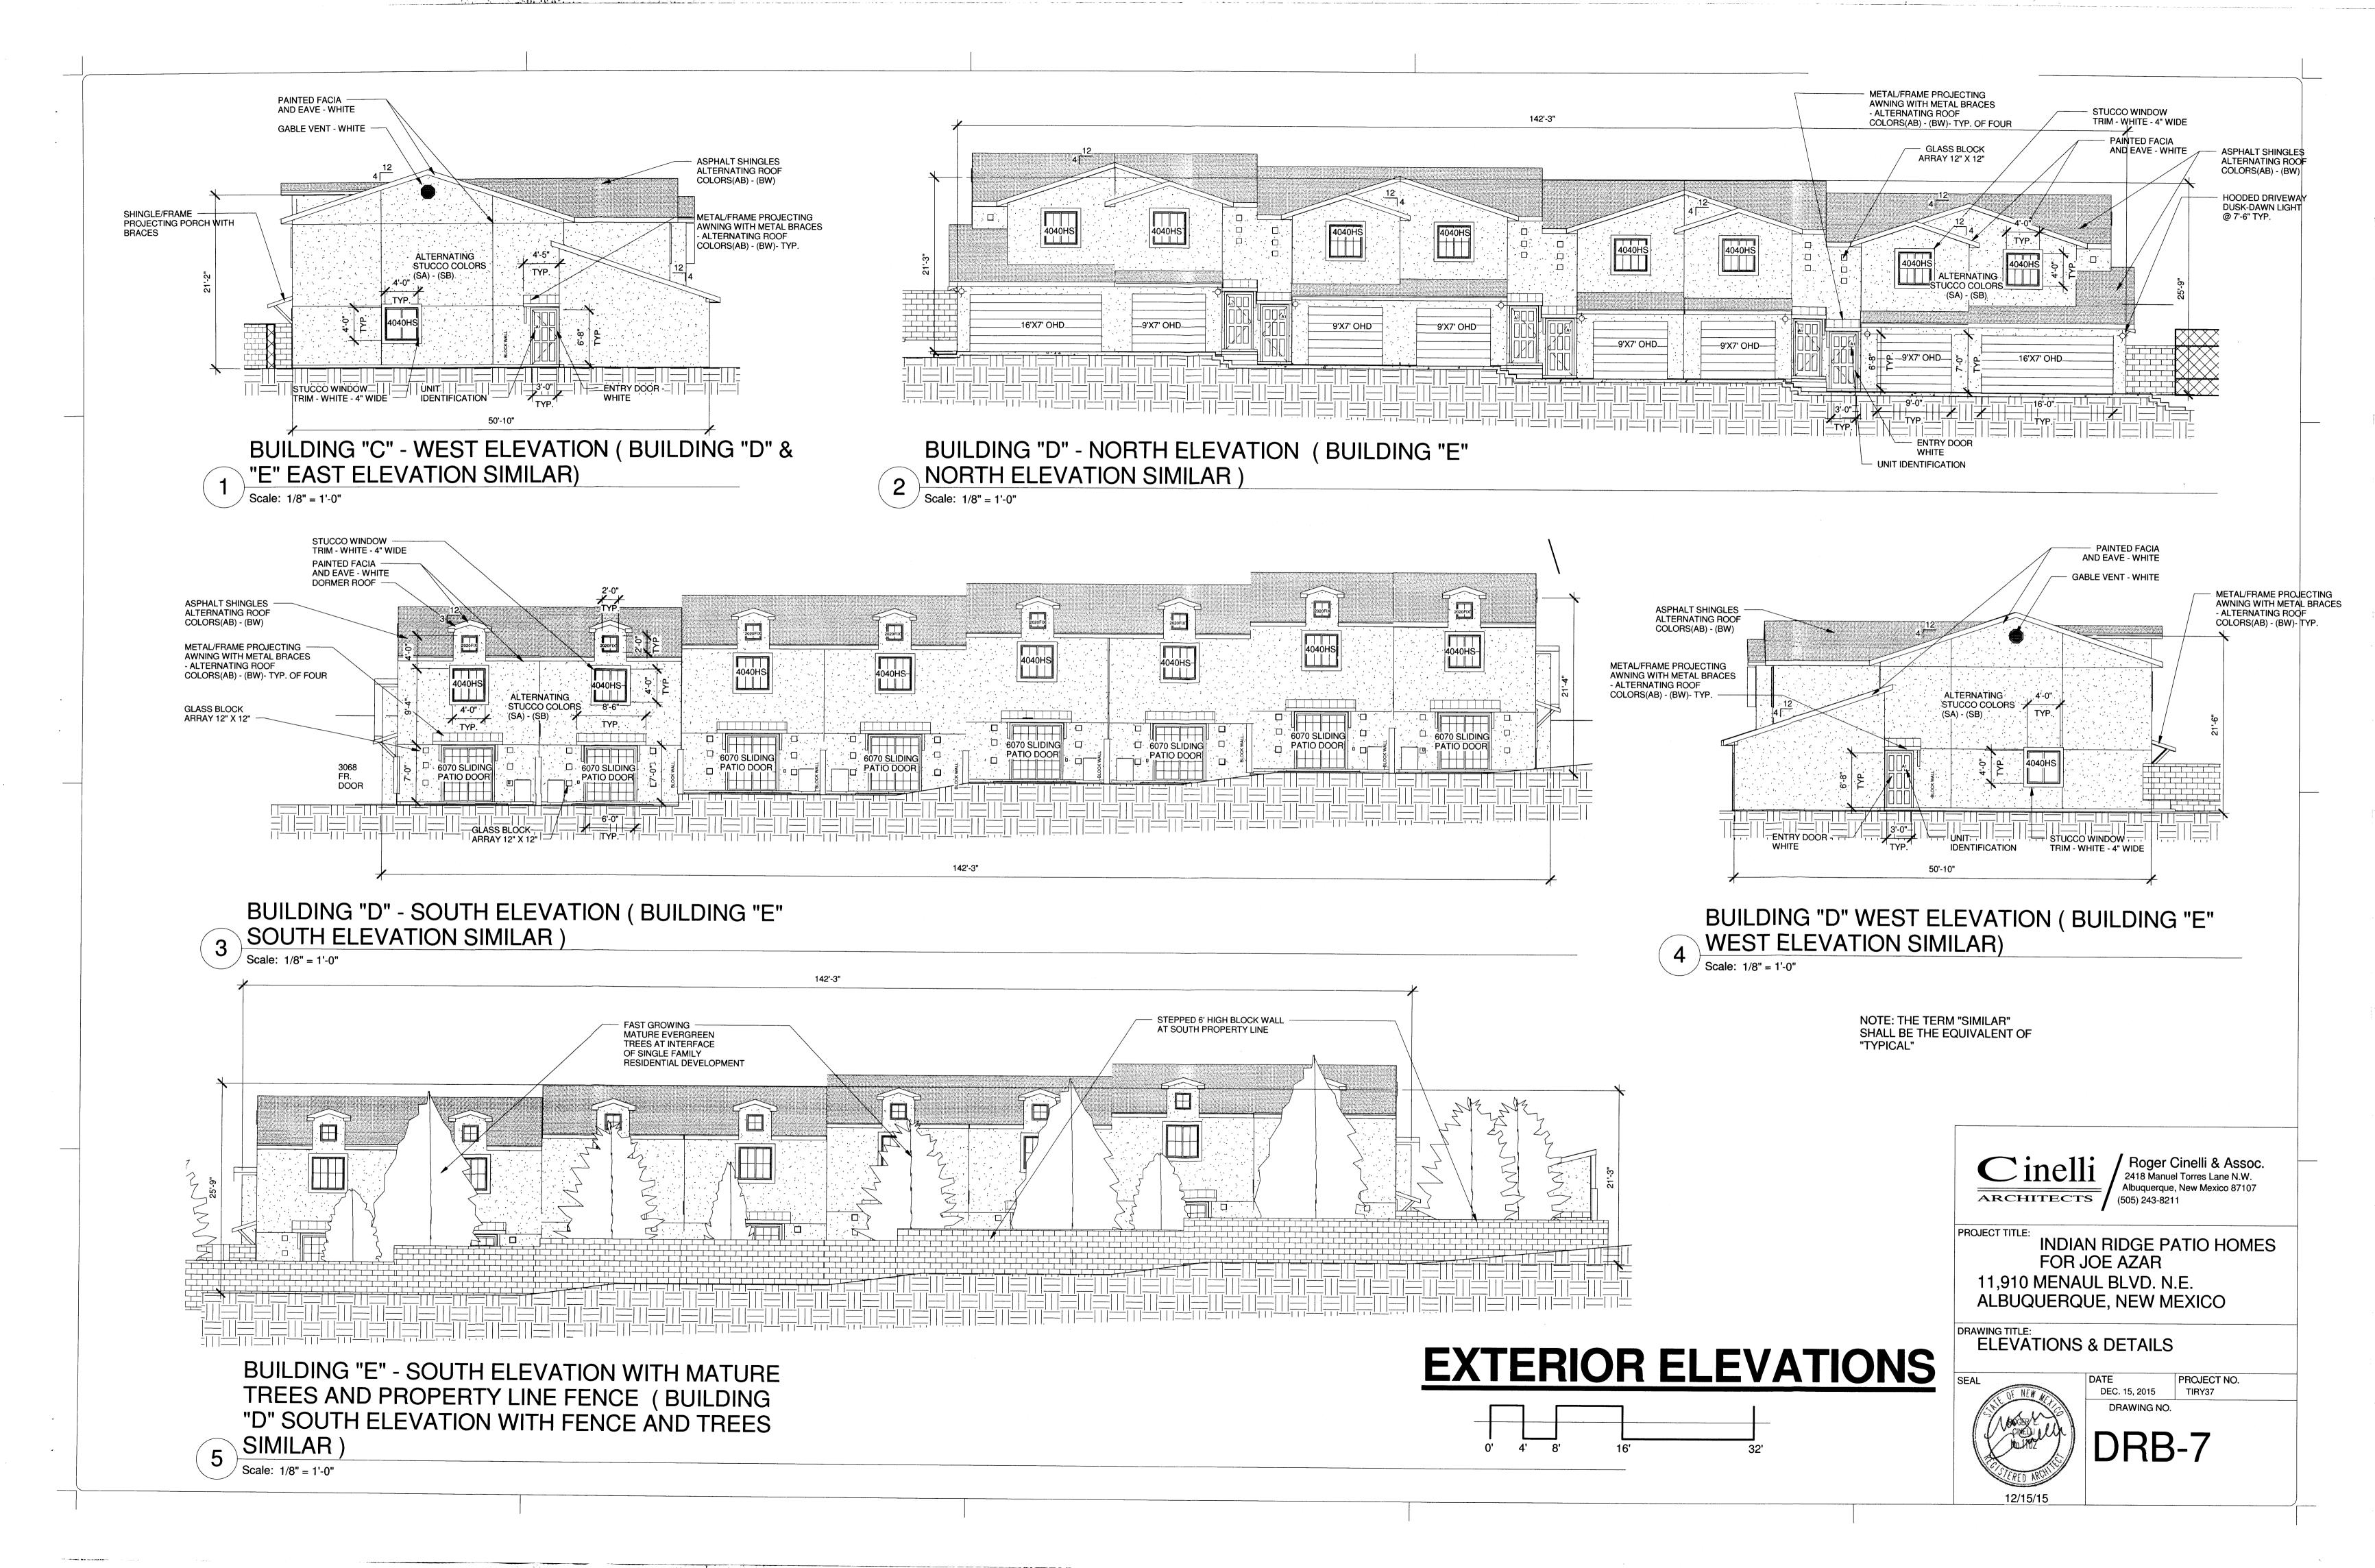


SITE DEVELOPMENT FOR SUBDIVISION - DESIGN STANDARDS


STUCCO - (SA) 3'x7' STEEL

NORTH ELEVATION

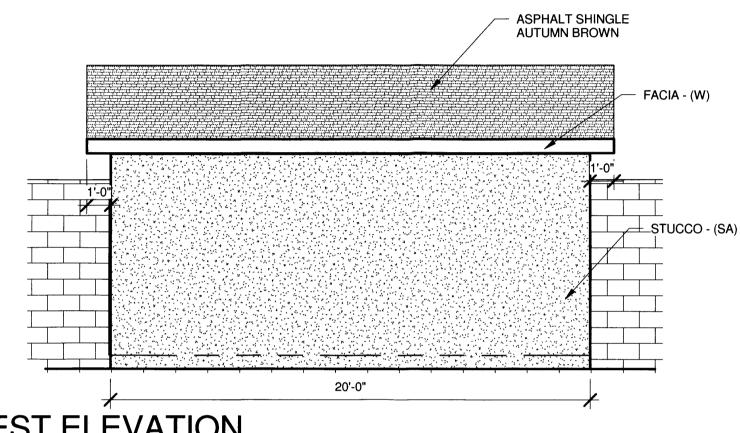


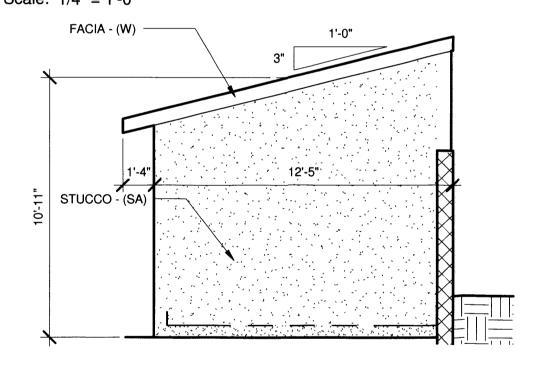

SOUTH ELEVATION

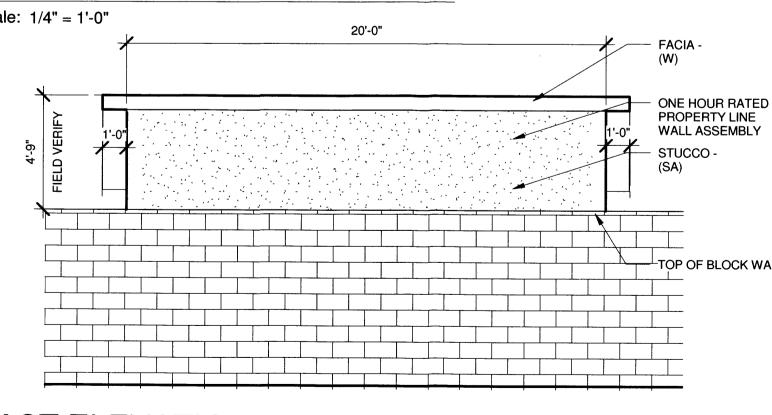

\ EAST ELEVATION

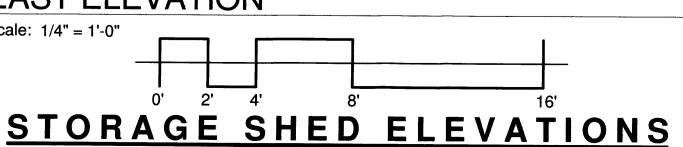

INTRODUCTION

DEVELOPMENT SHALL COMPLY WITH THE GENERAL REGULATIONS OF THE ZONING CODE.

1. SITE DESIGN

A OVERALL LAYOUT OF SITE AND BUILDINGS, RELATIONSHIP TO ADJACENT SITE

THE SUBJECT SITE IS A SINGLE PARCEL WHICH IS ADJACENT TO MENAUL BLVD. A 30' WIDE TWO WAY DRIVEWAY WITH A RIGHT TURN LANE PROVIDES VEHICULAR ACCESS THE DEVELOPMENT. A 24' WIDE PRIVATE ROADWAY RUNS BOTH EAST AND WEST TO PROVIDE ACCESS TO THE TOWNHOUSE BUILDING DRIVEWAYS. A 20' WIDE FIRETRUCK AND REFUSE TRUCK TURNAROUND IS LOCATED WEST OF THE MAIN ENTRY DRIVE. 4' WIDE NORTH TO SOUTH PEDESTRIAN WALKWAYS CONNECT TO THE MENAUL BOULEVARD PUBLIC SIDEWALK. 4' WIDE WALKWAYS ALSO PROVIDE PEDESTRIAN CIRCULATION BETWEEN UNITS. EVERY TOWNHOUSE UNIT PROVIDES A PRIVATE COURTYARD. THE STEPPED BUILDING FACADE OF THE THREE BEDROOM UNITS ON BOTH SIDES OF THE ENTRY DRIVE SCALE THE BUILDING'S MASSING DOWN TO THE PEDESTRIAN WALKWAY. MENAUL VILLAGE CONDOMINIUMS, ZONED R-3, LIES TO THE WEST. THE PUEBLO STYLE DEVELOPMENT IS COMPRISED OF TWO STORY UNITS WITH GARAGES BENEATH THE LIVING AREAS. PREDOMINANTLY, R-1 SINGLE FAMILY RESIDENCES LIE TO THE SOUTH OF THE SUBJECT PROPERTY; THE REAR YARDS OF FIVE RESIDENCES THAT FRONT ON TOWNER STREET DIRECTLY ABUT THE SOUTHERN PROPERTY LINE. THE ADJACENT RESIDENCES CONSIST OF LOW SLOPE SHINGLE AND METAL PANEL ROOFS. MASONRY VENEER EXTERIOR WALLS PREDOMINATE; MASONRY WAS A POPULAR EXTERIOR TREATMENT GIVEN THE AGE OF THE NEIGHBORHOOD. TWO OF THE RESIDENCES HAVE TWO STORY FEATURES. THE COMMERCIAL DEVELOPMENT, ANYTHING SPRINKLERS, ABUTS THE EASTERLY EDGE OF THE SUBJECT PROPERTY; THE

B. BUILDING PLACEMENT, ORIENTATION, SETBACKS

THE PROPOSED TOWNHOUSE BUILDINGS, "A", "B", "C", "D" AND "E", SHALL BE ARRAYED ALONG AN EAST-WEST VEHICULAR ASPHALT ROADWAY. THE TOWNHOUSE BUILDINGS SHALL BE SITUATED WITH THEIR FRONT ENTRIES AND DRIVEWAYS FACING THE ROADWAY. PRIVATE WALLED COURTYARDS SHALL ABUT MENAUL BOULEVARD TO THE NORTH AND THE REAR PROPERTY LINE TO THE SOUTH. SETBACKS FROM MENAUL BOULEVARD SHALL VARY WITH A MINIMUM OF 19'-6". THE MINIMUM FRONT YARD SETBACK IS 15'. THE EASTERLY SETBACK SHALL VARY WITH A MINIMUM OF 11'-10". THE WESTERLY SETBACK VARIES WITH A MINIMUM OF 15'-1". THE REQUIRED MINIMUM SIDE YARD SETBACK IS 5'. THE SOUTH PROPERTY SETBACK SHALL ALSO VARY, FROM 28'-11" AT THE SOUTHEAST TO 15' AT THE SOUTHWEST CORNER. THE REAR YARD MINIMUM SETBACK REQUIREMENT IS 15'. THE UNHEATED STORAGE BUILDING THAT ABUTS C-1 ZONING IN THE SOUTHEAST CORNER IS ZERO-CLEARANCE FROM THE PROPERTY LINE. BUILDING MASSING AT THE PROJECT ENTRY DRIVEWAY AND EAST-WEST ROADWAY IS DESIGNED AS A LOWER ROOF SLOPE THAT GRADUALLY STEPS UP. OR SLOPES UP. TO THE TWO STORY PORTION. THIS REFLECTS THE DESIGN TENDENCIES OF THE EXISTING RESIDENTIAL DEVELOPMENTS THAT LIES TO THE SOUTH. THE EXISTING FABRIC OF THE SURROUNDING RESIDENTIAL CITY BLOCKS IS REFLECTED IN THE ONE/TWO STORY CONFIGURATION WITH SHINGLE ROOF DESIGN.

C. PEDESTRIAN AND VEHICULAR CONNECTIVITY (INTERNAL & EXTERNAL)

AS FOR EXTERNAL PEDESTRIAN CONNECTIVITY, THE 6' WIDE SIDEWALK ALONG MENAUL BOULEVARD IS INTERSECTED BY THE ENTRY VEHICULAR DRIVE AND 4' WIDE SIDEWALKS ON BOTH SIDES OF THE DRIVEWAY. THIS AFFORDS UNIMPEDED PEDESTRIAN ACCESS INTO AND OUT OF THE DEVELOPMENT. INTERNAL TO THE SITE, SIDEWALKS CONNECT EACH TOWNHOUSE WITH IT'S NEIGHBOR. THE DUAL REFUSE/RECYCLE BIN ENCLOSURES AT THE EAST AND WEST END OF THE DEVELOPMENT PROVIDE FOR CONVENIENT PEDESTRIAN ACCESS FROM ANY TOWNHOUSE.

D. PARKING LOCATION AND DESIGN

OFF STREET RESIDENT PARKING IS PROVIDED AT EACH GARAGE AND IT'S ACCOMPANYING DRIVEWAY. TWO PARKING SPACES ARE ACCOMMODATED IN THIS WAY AT THE TWO BEDROOM UNITS. FOUR PARKING SPACES ARE ACCOMMODATED AT THE TWO BEDROOM/TWO CAR UNITS, TWO IN THE GARAGE AND TWO IN THE DRIVEWAY. FOUR PARKING SPACES ARE PROVIDED FOR AT THE THREE BEDROOM UNIT; TWO IN THE DRIVEWAY AND TWO IN THE GARAGE. TREES AND SHRUBS INTERSPERSED WITH THE PARKING PROVIDES FOR SHADING OF AUTOMOBILES AND FURTHER PROMOTES THE RESIDENTIAL CHARACTER OF THE

THE PEDESTRIAN WALKWAY ALONG THE SOUTH SIDE OF MENAUL BOULEVARD LEADS TO TRANSIT BUS STOP IN FRONT OF THE MENAUL VILLAGE CONDOMINIUMS. THE BUS STOP LIES DIRECTLY WEST OF THE PRIVATE DRIVE THAT SERVES THE CONDOMINIUMS

E. <u>DUMPSTER AND SERVICE AREA LOCATIONS AND SCREENING</u>

REFUSE/RECYCLE BIN ENCLOSURES ARE LOCATED AT EACH END OF THE SITE. THEY ARE ACCESSED VIA 4' INTERNAL PEDESTRIAN WALKWAYS. THEY ARE ENCLOSED ON THREE SIDES BY A 6' HIGH COLORED CMU

F. LOCATION, HEIGHT, DESIGN AND PURPOSE OF ALL WALLS AND WALL OPENINGS

ALL WALLS AND FENCES ARE SUBJECT TO SECTION 14-16-3-19 OF THE ZONING ORDINANCE. ALL WALLS SHALL BE 6'-0" IN HEIGHT; THEY SHALL BE EITHER COLORED SMOOTH BLOCK OR SPLITFACE COLORED BLOCK. THEY SHALL PROVIDE PRIVACY FOR THE RESIDENTIAL REAR COURTYARDS. WALLS ALONG MENAUL SHALL BE A DECORATIVE COMBINATION OF SMOOTH AND SPLITFACE COLORED BLOCK IN A SOUTHWESTERN

G. LOCATION, HEIGHT AND DESIGN AND PURPOSE OF LIGHTING

LIGHTING SHALL COMPLY WITH THE NIGHT SKY ORDINANCE AND ALL REQUIREMENTS IN SECTION 14-16-3-9 OF THE ZONING ORDINANCE. DUSK -TO-DAWN DRIVEWAY LIGHTING SHALL BE MOUNTED AT 7'-6" HEIGHT AND ILLUMINATE THE 4' PEDESTRIAN WALKWAY. LIGHTING SHALL NOT SHINE INTO ANY ADJACENT PROPERTIES.

H. <u>SCREENING/BUFFERING TECHNIQUES</u>

SIDEWALKS, LANDSCAPE STRIPS AND STREET TREES SCREEN RESIDENCES FROM ADJACENT STREETS WHILE CREATING PEDESTRIAN AMENITIES WITHIN THE URBAN FABRIC OF THE DEVELOPMENT.

I. "GREEN" FEATURES

WATER HARVESTING PONDS SHALL STORE DRAINAGE ON SITE BEFORE DEPOSITING OUTFLOWS INTO THE STREET.

2. STREET REALM

A. TRANSIT, BICYCLE, PEDESTRIAN AMENITIES

THE SITE IS ACCESSIBLE TO MAJOR TRANSIT ROUTE ON MENAUL BOULEVARD, A FOUR LANE MAJOR STREET. CITY OF ALBUQUERQUE "ABQ RIDE" BUS STOP IS LOCATED ADJACENT TO THE MENAUL VILLAGE CONDOMINIUMS ON THE SOUTH SIDE OF MENAUL BOULEVARD. THE NORTH-SOUTH BIKE LANE ON CHELWOOD PARK BOULEVARD LIES TWO BLOCKS TO THE EAST.

B. LANDSCAPE BUFFERS, SIDEWALKS IN THE PUBLIC RIGHT OF WAY

SIDEWALKS, LANDSCAPE STRIPS AND STREET TREES SCREEN RESIDENCES FROM ADJACENT STREETS WHILE CREATING PEDESTRIAN AMENITIES WITHIN THE URBAN FABRIC OF THE DEVELOPMENT. STREET TREE TYPES AND LOCATIONS SHALL BE AS SPECIFIED IN THE LANDSCAPE SECTION OF THESE DESIGN

3. LANDSCAPING

LANDSCAPING SHALL COMPLY WITH THE DESIGN REQUIREMENTS OF THE CITY OF ALBUQUERQUE GENERAL LANDSCAPING REGULATIONS 14-16-3-10 AND THIS SECTION. LANDSCAPING IS A KEY ELEMENT OF THE DESIGN. IT IS INTEGRAL TO THE GOAL OF PROVIDING PLACES THAT PROMOTE COMMUNITY AND ENRICH THE LIVES OF THE AREA RESIDENTS. THE LANDSCAPE NETWORK CONSISTS OF:

STREETSCAPE STREET TREES, AND LANDSCAPING IN AND AROUND UNIT DRIVEWAYS. TREES ALONG THE EAST-WEST PEDESTRIAN WALKWAYS. AT MINIMUM, ONE TREE IS PROVIDED PER TOWNHOUSE UNIT

THE DOMINANT LANDSCAPE FEATURE IS A CANOPY OF TREES AT MATURITY. DECIDUOUS STREET AND PARKING TREES PROVIDE PASSIVE SOLAR MITIGATION OF PAVED SURFACES. THEY ALSO BALANCE THE DENSITY OF THE HOUSING UNITS AND CREATE HUMAN SCALE. THE TREE SPECIES SHALL BE VARIED TO AVOID MONOCULTURE.

SUGGESTED PLANT SPECIES AS SHOWN ARE NOT MANDATORY, HOWEVER, ANY SUBSTITUTIONS WILL BE LIMITED TO MEDIUM OR LOW WATER USE SPECIES. PLANT SPECIES SHOULD REFLECT THE CHARACTER AND SCALE OF THE SURROUNDING NEIGHBORHOOD.

FAST GROWING EVERGREEN TREES SHALL POPULATE THE REAR YARDS THAT FACE THE ADJACENT RESIDENTIAL REAR YARDS AT THE SOUTH PROPERTY LINE.

REQUIREMENTS:

THE FRONT PROPERTY LINE LIES DIRECTLY ON THE SOUTHERN EDGE OF THE 6' WIDE SIDEWALK. THE STREETSCAPE ALONG MENAUL BOULEVARD SHALL CONSIST OF TREE GROUPD IN ALCOVE PLANTING AREAS BETWEEN THE SIDEWALK AND COURTYARD WALLS. THESE TREES SHALL HAVE A HIGH BRANCHING CANOPY TO ALLOW CLEAR SPACE FOR PEDESTRIANS AND REDUCE POTENTIAL FOR DAMAGE FROM PASSING VEHICLES. UNDERSTORY PLANTINGS SHALL BE LIMITED TO ALLOW CLEAR PEDESTRIAN CIRCULATION.

THE CLEAR SITE TRIANGLE REQUIREMENT SHALL BE IMPOSED ON THE ENTRY DRIVEWAY/MENAUL BOULEVARD INTERSECTION. PROVIDE A CLEAR SITE RADIUS AT THE INTERSECTION OF A DRIVEWAYS AND THE PUBLIC SIDEWALK. SHRUBS IN THE CLEAR SITE TRIANGLE AND CLEAR SITE RADIUS SHALL NOT EXCEED THREE FEET IN HEIGHT ABOVE THE GUTTER FLOWLINE. UNDERSTORY BRANCHES FROM TREES SHALL NOT HANG LOWER

WATER CONSERVATION TECHNIQUES:

THE LANDSCAPING SHALL COMPLY WITH THE WATER CONSERVATION, LANDSCAPE, POLLEN CONTROL AND WASTE WATER ORDINANCES.

THE PROPOSED DEVELOPMENT SITS IN AN AREA OF DIVERSE ZONING CATEGORIES. VARIED COMMERCIAL DEVELOPMENT, C-1, LIES TO THE NORTH ACROSS MENAUL BOULEVARD AND TO THE EAST. TO THE WEST OPPOSITE A PRIVATE DRIVE LIES THE CONDOMINIUM PROJECT, ZONED R-3, SEE PREVIOUS REFERENCES. THE PREDOMINANT USE, WHICH LIES TO THE SOUTH IS SINGLE FAMILY USES - R-1.

B. ARCHITECTURAL THEME OR STYLE

THE PROPOSED BUILDING DESIGN IS A PITCHED SHINGLE ROOF/FRAME-STUCCO DESIGN. IT FITS IN WITH THE PREDOMINANT BUILDING STYLES DISPLAYED BY THE RESIDENCES IN THE AREA. COMPLEMENTARY STUCCO COLORS APPLIED TO ALTERNATING BUILDINGS ADD VARIETY AND FURTHER THE NEIGHBORHOOD "LOOK".

C. BUILDING HEIGHT, SCALE, MASSING, MATERIALS COLORS AND ARTICULATION

EVEN THOUGH THE BUILDINGS ARE STEPPED, BUILDING HEIGHTS MEASURED FROM THE LOWEST GRADE TO THE MIDPOINT OF THE ROOF SLOPE AT THE OPPOSITE END OF THE BUILDING DO NOT EXCEED 25'-10". THE STANDARD ZONING REQUIREMENT IS 26'. THE ONE STORY PORTION OF THE THREE BEDROOM UNIT DOES NOT EXCEED 12' FROM ADJACENT GRADE TO MIP POINT OF ROOF SLOPE. THE DEVELOPMENT IS ORGANIZED TO EMPHASIZE AN URBAN BUILDING MASSING RESPONSE TO THE SITE. THE BUILDING ARE PLACED WITH THEIR FRONT FACADES FACING EACH OTHER AND PRIVATE LANES. RATHER THAN TOWER OVER THE LANDSCAPE, THE BUILDINGS ARE ENHANCED WITH SINGLE STORY FEATURES THAT SCALE DOWN TO THE STREET/LANE LEVEL. THE BUILDINGS ARE STEPPED DOWN THE SLOPED TERRAIN. COMPLEMENTARY STUCCO COLORS APPLIED TO ALTERNATING BUILDINGS AND INTEGRAL COLORED BLOCK WALLS ADD VARIETY AND FURTHER THE NEIGHBORHOOD "LOOK".

ALL OF THE EXTERIOR BUILDING WALLS AND MOST OF THE COURTYARD WALLS INCLUDE A PALETTE OF EARTH-TONED STUCCO OR BLOCK. ADDITONALLY, ROOF STYLES VARY FROM SIMPLE SHED TO LOW SLOPE GABLE.

D. SITE TOPOGRAPHY AND BUILDING DESIGN

THE SITE IS SLOPED. THE GRADE FALL FROM THE EAST END OF THE SITE TO THE WEST END IS 15 FEET. ACCOMMODATING THE SLOPE POSED A CHALLENGE WHOSE SOLUTION RESULTS IN A STEPPED BUILDING CONFIGURATION, WITH THE EXCEPTION OF BUILDING "B". EVERY OTHER UNIT IN THE BUILDINGS IS STEPPED 18' FROM IT'S NEIGHBOR. THE RESULTING DESIGN SOLUTION ADDS AN ELEMENT OF VARIETY THAT IS ENHANCED BY ALTERNATING BUILDING STUCCO AND ROOF SHINGLE COLORS.

A. STANDARDS FOR WALL MOUNTED SIGNS; LOCATION OF SIGNS; MAXIMUM NUMBER OF SIGNS

A COURTYARD WALL MOUNTED ILLUMINATED SIGN SHALL WELCOME RESIDENTS. LOCATED AT THE SOUTHEAST CORNER OF THE INTERSECTION OF MENAUL AND THE ENTRY DRIVE, THE SIGNAGE IS 21 SQUARE FEET IN SIZE; 25 SQUARE FEET IS THE MAXIMUM ALLOWABLE BY CODE. THE ILLUMINATION WILL CONFORM WITH THE NIGHT SKY ORDINANCE AND WILL NOT SHINE INTO ADJACENT PROPERTIES. ALL SIGNAGE SHALL CONFORM TO THE SIGNAGE REGULATIONS FOUND IN THE CITY OF ALBUQUERQUE ZONE CODE. EACH UNIT SHALL BE NUMBERED. ADDRESS SIGNAGE SHALL FACE MENAUL BOULEVARD N.E.

5.<u>APPROVAL PROCESS</u>

THE SITE DEVELOPMENT PLAN FOR BUILDING PERMIT MAY BE SLIGHTLY MODIFIED OR ADJUSTED, IF NECESSARY, TO ASSURE CONSISTENCY WITHIN THE DEVELOPMENT AND TO ALLOW FLEXIBILITY FOR THE DEVELOPER TO POSITIVELY REFINE THE DEVELOPMENT TO MITIGATE DESIGN CHALLENGES AND ENHANCE DESIGN OPPORTUNITIES. MODIFICATION PROCEDURES AND THE SUBSEQUENT APPROVAL PROCESS SHALL BE AS SPECIFIED FOR PROPERTIES IN THE SU-1 ZONING DESIGNATION OF THE CITY OF ALBUQUERQUE ZONING CODE.

SUBDIVISION DATA

PROJECT LOCATION: SOUTH SIDE OF MENAUL BETWEEN CHELWOOD PARK BLVD. AND DEANNA STREET 11,910 MENAUL BLVD N.E., ALBUQUERQUE, NM

ZONE ATLAS MAP:	H-22
GROSS ACREAGE:	
NO. OF LOTS:	
EXISTING ZONING:	O-1
PROPOSED ZONING:	
	MAXIMUM 26 UNITS
DATE OF SURVEY:	MARCH 26. 1982

LEGAL DESCRIPTION

LEGAL DESCRIPTION: TRACT 2-A INDIAN RIDGE SUBDIVISION. CITY OF ALBUQUERQUE, BERNALILLO COUNTY, NEW MEXICO, DECEMBER, 1981, BEING A REPLAT OF TRACTS 1-A AND 2, FILED IN THE OFFICE OF THE COUNTY CLERK OF BERNALILLO COUNTY, NEW MEXICO, ON MARCH 26, 1982, IN PLAT BOOD C19, PAGE

BUILDING DATA

MAXIMUM BUILDING HEIGHT:	25.83 FEET
MINIMUM BUILDING SETBACK:	
MENAUL BOULEVARD	19.5 FEE
EAST PROPERTY LINE	11.83 FE
WEST PROPERTY LINE	15.08 FEE
SOUTH PROPERTY LINE	15.0 FEE
MAXIMUM DWELLING UNITS:	26 UNITS

Roger Cinelli & Assoc. 2418 Manuel Torres Lane N.W. Albuquerque, New Mexico 87107 ARCHITECTS (505) 243-8211

INDIAN RIDGE PATIO HOMES FOR JOE AZAR 11,910 MENAUL BLVD. N.E. ALBUQUERQUE, NEW MEXICO

DRAWING TITLE SPS - DESIGN STD'S - STORAGE SHED ELEVATIONS



DEC. 15, 2015 TIRY37 DRAWING NO.

PROJECT NO.