


SITE DATA

SITE AREA (LOT 13): 24,728sf - 0.57 ACRES SITE AREA (LOT 20): 61,345sf - 1.40 ACRES TOTAL SITE AREA (LOT 13 & 20): 86,073sf - 1.97 ACRES

KEYED NOTES

- 1. NEW PROPERTY LINE
- 2. EXISTING BUILDING
- 4. OLD PROPERTY LINE TO BE REMOVED
- 5. EXISTING 10 FT. PUE.
- 6. FUTURE PEDESTRIAN ACCESS
- 7. PROPOSED MONUMENT SIGN LOCATION
- 8. BUILDING SETBACK LINE
- 10. NEW 20 FT. PUBLIC UTILITY EASEMENT
- 11. PRIVATE ACCESS EASEMENT

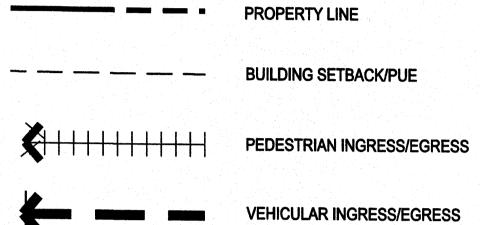

OLD PROPERTY LINE

GENERAL NOTES

A. REFER TO CONCEPTUAL UTILITY PLAN FOR PROPOSED AND EXISTING WATER, SEWER, AND STORM DRAINAGE.

B. PLEASE REFER TO SITE DEVELOPMENT PLAN FOR BUILDING PERMIT (#1008069, 09EPC-40063) FOR FURTHER INFORMATION ON ARCHITECTURAL BUILDING DESIGN STYLE AND SIGNAGE. BUILDING AND SIGNAGE HEIGHT. MASS, COLOR, MATERIALS, AND ARTICULATION CAN BE REFERENCED FROM BUILDING AND SIGNAGE ELEVATIONS. SIGNAGE FACE AREA AND

LIGHTING INFORMATION CAN BE FOUND ADDITIONALLY IN THIS SUBMITTAL. C. THE REMAINDER OF LOT 13 SHALL BE DEVELOPED IN A FUTURE PHASE ACCORDING TO A SITE DEVELOPMENT PLAN APPROVED BY THE EPC PER THE LA CUEVA SDP (2000, REV. 2003). THE SITE DEVELOPMENT PLAN INCLUDING PEDESTRIAN CIRCULATION, BUILDING ORINETATION. ARCHITECTURE AND SIGNAGE, SHALL BE DESIGNED TO COORDINATE WITH THE DEVELOPMENT OF LOT 20 TO FORM A COHESIVE RETAIL CENTER.

D. SITE PLAN SHALL COMPLY AND BE DESIGNED PER DPM STANDARDS. E. SITE PLAN SHALL COMPLY WITH THE SU-2, SU-2/MIXED USE ZONE AND COMMON DESIGN REGULATIONS (SECTIONS 5.4, 5.4.5, 5.4.6, LA CUEVA SECTOR DEVELOPMENT PLAN 2000, REVISED 2003).

F. SIGNAGE: THE GOAL IS TO PROVIDE CONSISTENCY IN APPEARANCE AND QUALITY THAT COMPLIMENTS THE VISUAL CHARACTER OF THE DEVELOPMENT. ALL BUILDING MOUNTED SIGNS SHALL COMPLY WITH SU-2/MIXED USE AND COMMON DESIGN REGULATIONS FOR SU-2 ZONED PROPERTIES IN THE LA CUEVA SECTOR DEVELOPMENT PLAN, ALL BUILDING MOUNTED SIGNS SHALL BE SUBMITTED UNDER SEPARATE


G. THE MAXIMUM INDIVIDUAL LETTER SIZE OF ALL BUILDING MOUNTED SIGNAGE SHALL NOT EXCEED 2'-0" IN HEIGHT. LOGO DESIGN SIGNS SHALL COMPLY WITH 13R-9 OF THE LA CUEVA SDP. ALL SIGNS SHALL FOLLOW THE LA CUEVA SDP SIGNAGE REGULATIONS.

H. IF A FREE STANDING SIGN ON LOT 20 IS APPROVED BY THE ZHE, THE TOTAL SIGN FACE OF BUILDING MOUNTED SIGNS ON LOT 20 SHALL NOT EXCEED 12.5% OF THE TOTAL FACADE AREA FOR THE SOUTHERN ELEVATIONS AND 10% OF THE TOTAL FACADE AREA FOR THE OTHER ELEVATIONS. THE TOTAL SIGN FACE AREA OF EACH TENANT'S BUILDING MOUNTED SIGNS SHALL NOT EXCEED 12.5% OF THE FACADE AREA OF EACH TENANT'S PREMISES FOR SOUTH ELEVATIONS AND 10% FOR OTHER **ELEVATIONS.**

I. ALL SIGNAGE TO PROVIDE MINIMUM CONTRAST OF 70% BETWEEN GRAPHICS AND BACKGROUND PER ADA.

J. IF A FREE STANDING SIGN ON LOT 20 IS APPROVED BY THE ZHE THAT INCLUDES ADVERTISING FOR TENANTS ON LOT 13, THE TOTAL SIGN FACE OF BUILDING -MOUNTED SIGNS ON LOT 13 SHALL NOT EXCEED 10% OF THE TOTAL FACADE AREA.

K. THE FREE STANDING SIGN SHOWN ON THE SITE DEVELOPMENT PLAN IS NOT ALLOWED UNLESS A VARIANCE IS OBTAINED FROM THE ZHE.

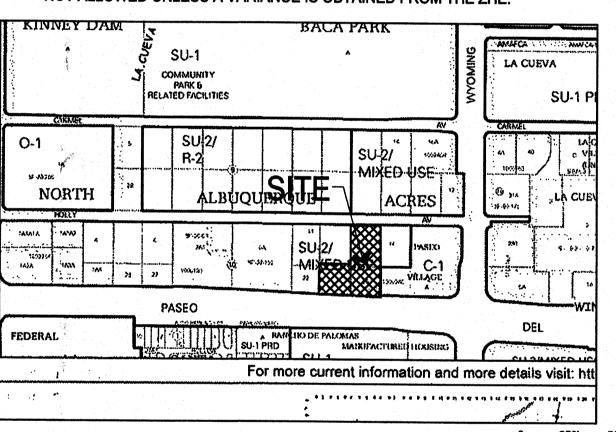

zone atlas number C-19

VICINITY MAP

FORMER PROJECT NUMBER: 1003532

PROJECT NUMBER: 1008069

APPLICATION NUMBER: 09EPC-40064/10DRB-70027

This plan is consistent with the specific Site Development Plan approved by the Environmental Planning Commission (EPC), dated December 17, 2009 and the findings and conditions in the official notification of decision are satisfied.

Is an Infrastructure List Required? (X) Yes () No If yes, then a set of approved DRC plans with a work order is required for any construction within Public Right-of-Way or for construction of public

DRB SITE DEVELOPMENT PLAN APPROV	<u>VAL:</u>
2575	02/17/10
TRAFFIC ENGINEER, TRANSPORTATION DIVISION	'DATE'
Of later	02/17/10
ABCWUA	DATE
Christina Sandoral	2/17/10
PARKS AND RECREATION DEPARTMENT	DATE
Bradley S. Bunken	2/17/10
CITY ENGINEER	DATE
N/A	
SOLID WASTE MANAGEMENT	DATE
Garl Clos	2/17/10
DDB CHAIDDED CON DI ANIAITAIC DED A DTA CENTE	DATE /

architecture interiors landscape planning engineering

7601 Jefferson NE Suite 100 Albuquerque, NM 87109 505 761-9700 fax 761-4222 dps ⊚ dpsdesign.org

ARCHITECT

ENGINEER

PROJECT

50


1/4/2010

DRAWN BY REVIEWED BY

February 2, 2010 PROJECT NO. DRAWING NAME

SITE DEVELOPMENT **PLAN FOR SUBDIVISION**


SHEET NO.

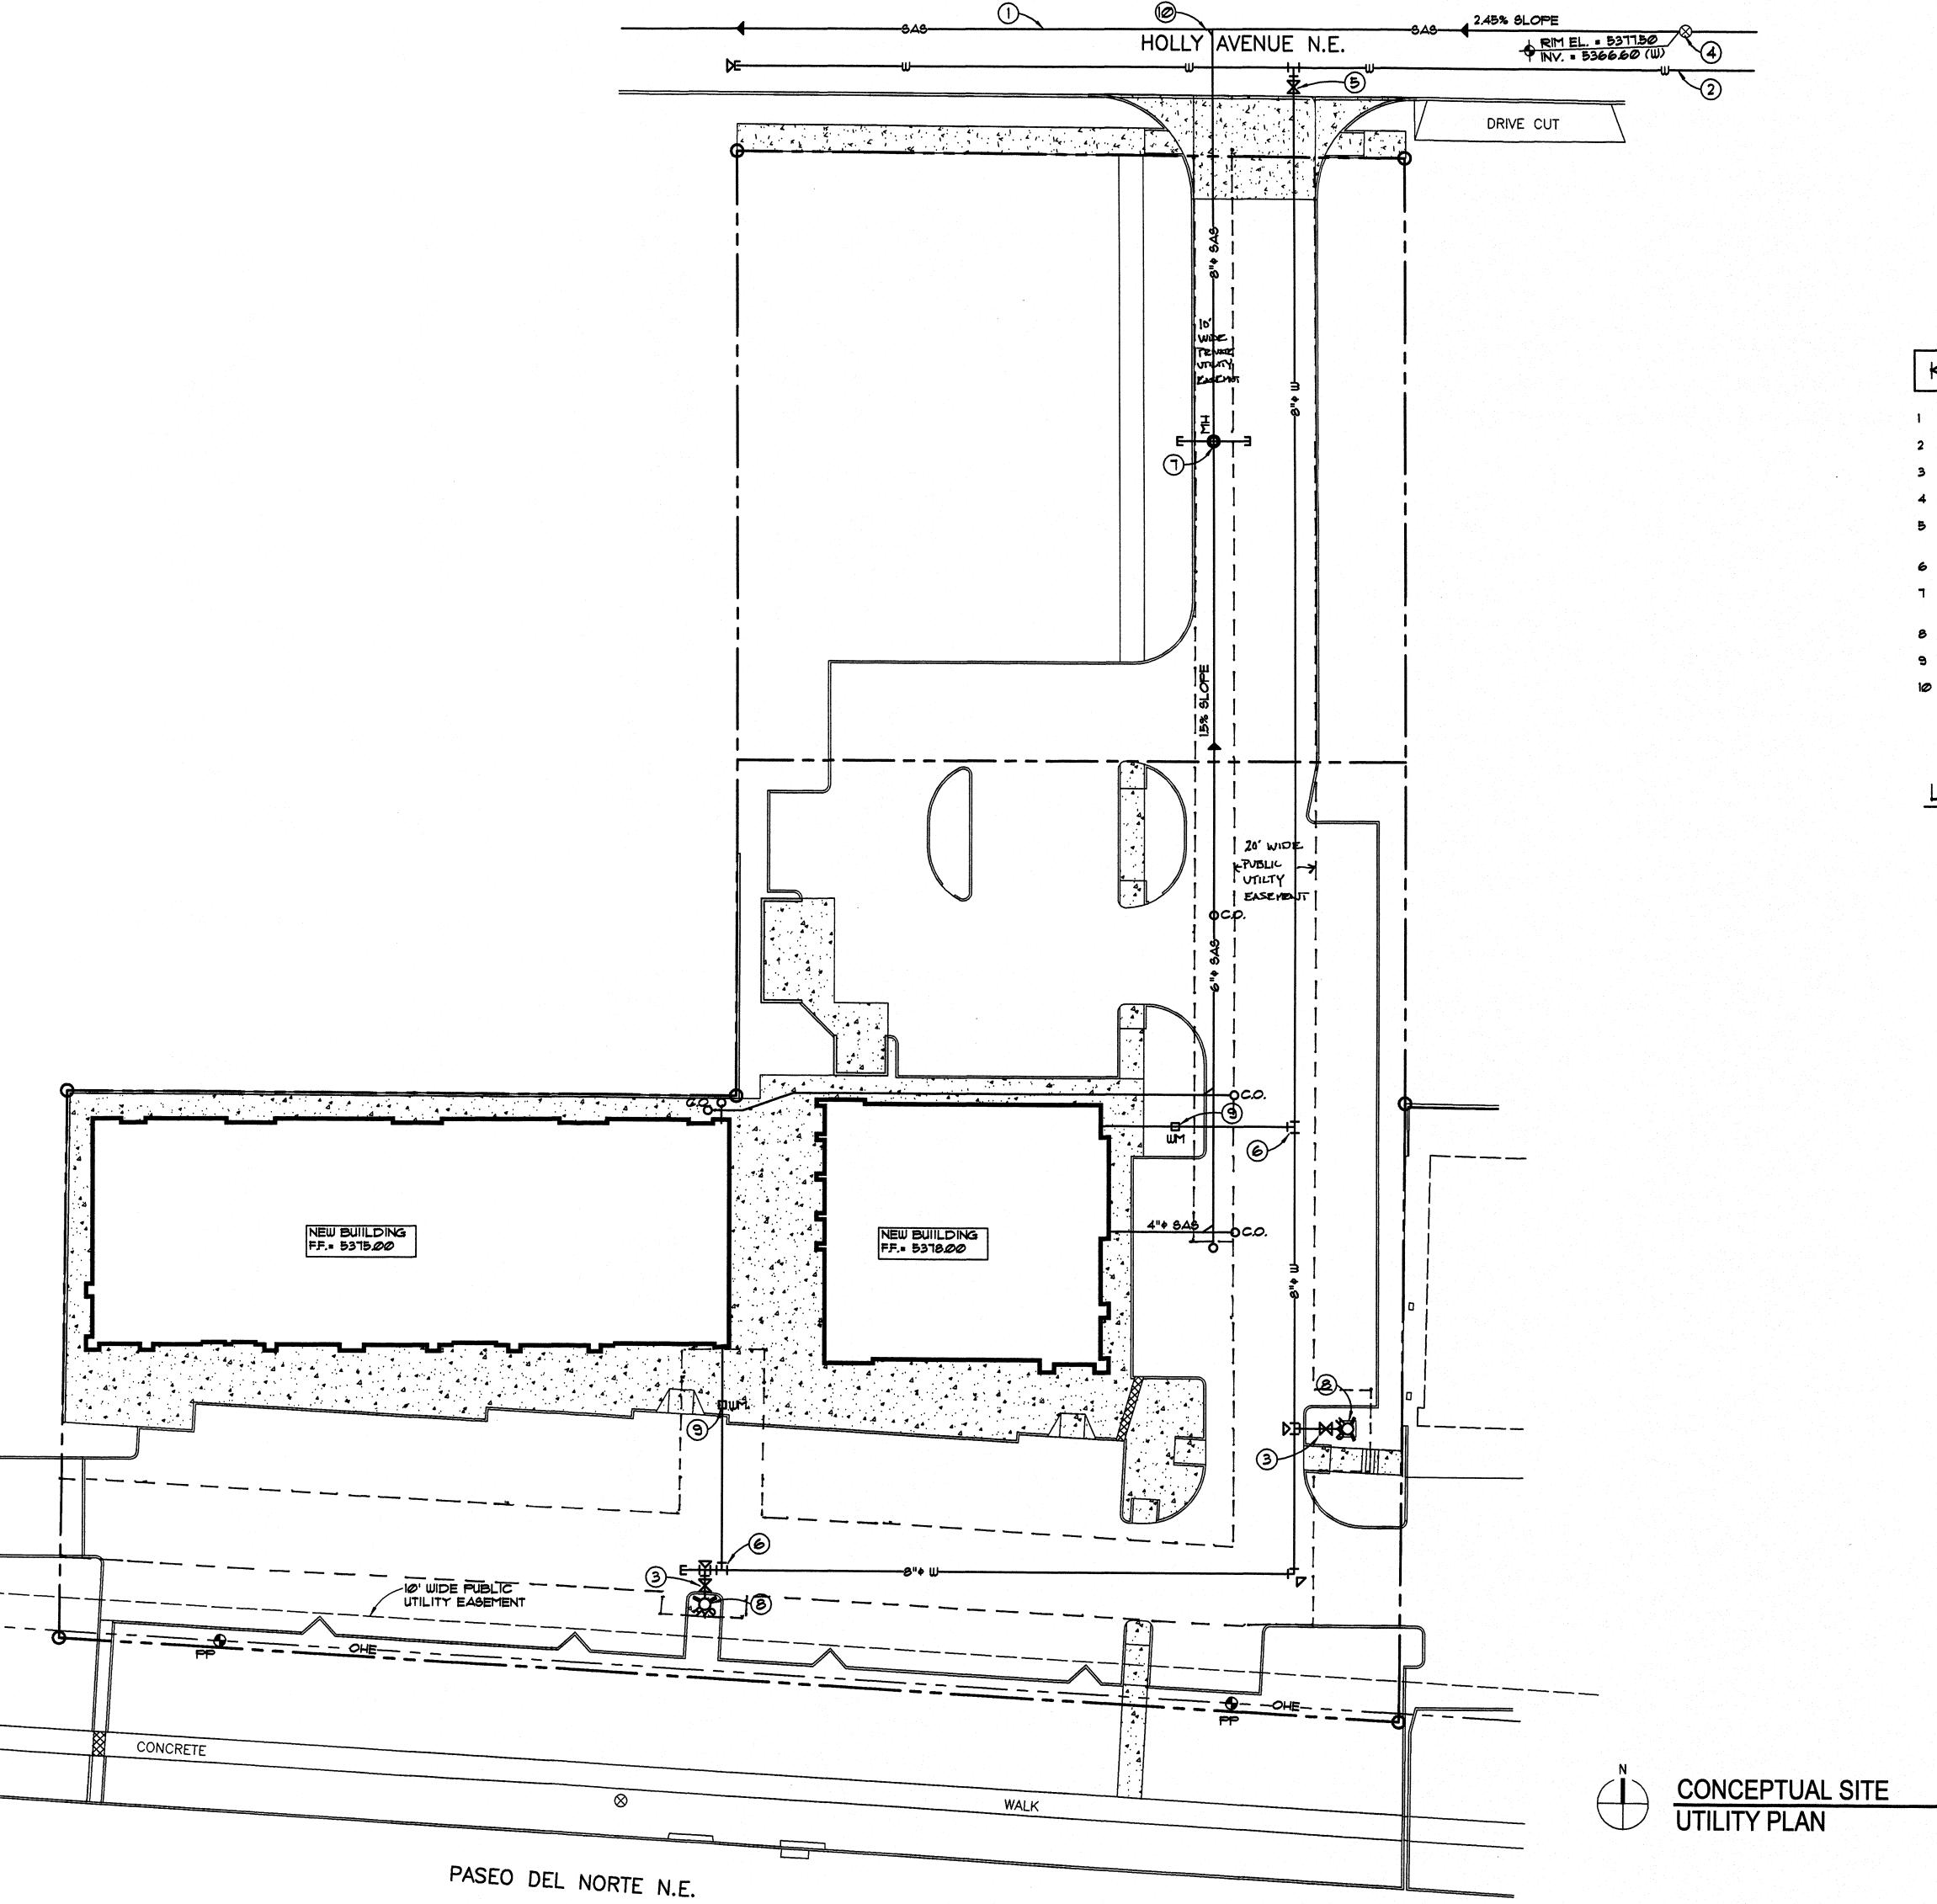




- EXISTING 8" + SANITARY SEWER PVC
- NEW 8" PVC WATER LINE EXTENSION
- 6" GATE VALVE AND VALVE BOX
- 4 EXISTING MANHOLE
- 5 8" GATE VALVE AND VALVE BOX PER C.O.A. STD. DRAWINGS 2326 AND 2333
- WATER SERVICE CONNECTION PER C.O.A. STD. DRAWING #2362
- 7 4'-0" DIA. PRECAST CONCRETE MANHOLE, TYPE "C" PER C.O.A. STD. DRAWING 2101
- 8 NEW FIRE HYDRANT PER C.O.A. STD. DRAWING #2340
- 9 NEW WATER METER AND BOX PER C.O.A. STD. DRAWING 2361
- 10 SEWER SERVICE CONNECTION




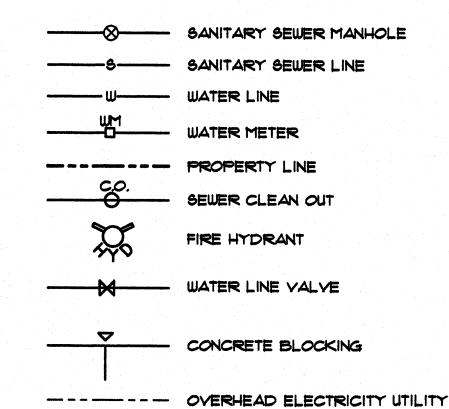

POWER POLE

1" = 20'-0"

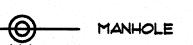


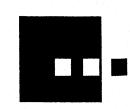

architecture interiors landscape planning engineering

Dekker Perich Sabatini

ARCHITECT

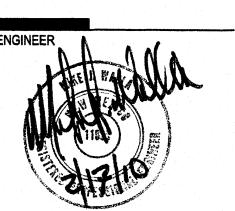

PROJECT

7441 & 7501
Paseo Del Norte

REVISIONS

1 1/4/2010 EPC Conditions of Approval

DRAWN BY		LEK
REVIEWED BY		MJW
DATE	February	17, 2010
PROJECT NO.		09-0055
DDAMAIC NAME	_	

CONCEPTUAL SITE UTILITY PLAN



SHEET NO.

C102