

GENERAL NOTES

- A. SITE PLAN SHALL BE DESIGNED & BUILT TO CURRENT DPM STANDARDS. B. SEE CIVIL PLANS FOR ADDITIONAL GRADING, DRAINAGE AND UTILITY
- C. DIMENSIONS ARE TO FACE OF CURB, OR WALL, OR EDGE OF PAVEMENT
- UNLESS OTHERWISE NOTED. D. ALL CURBS AND ACCESSIBLE RAMPS WILL BE DESIGNED AND BUILT
- E. ALL FIXTURES AND DESIGN SHALL COMPLY WITH THE NEW MEXICO NIGHT SKY PROTECTION ACT, THE CITY OF ALBUQUERQUE ZONING CODE, SECTION 14-16-3-9 AREA LIGHTING REGULATIONS, AND THE LA CUEVA SDP LIGHTING REGULATIONS
- F. LIGHTING WITHIN THE PUBLIC RIGHT-OF-WAY SHALL BE SUBJECT TO THE STANDARDS AND REVIEW OF PNM, UNLESS MAINTENANCE FOR
- RIGHT-OF-WAY LIGHTING IS THE FULL RESPONSIBILITY OF OTHER PARTIES. G. LIGHTING DESIGN FOR PARKING AREAS SHALL BE LIGHTED TO PROVIDE FUNCTIONAL, ATTRACTIVE, AND UNIFIED LIGHTING THROUGHOUT THE LOT AND BE EXTINGUISHED ONE HOUR AFTER THE CLOSE OF BUSINESS,
- H. THE CLOSEST BUS STOP IS LOCATED ON THE NORTHWEST SIDE OF THE HOLLY AVE. AND WYOMING BLVD. INTERSECTION; APPROXIMATELY 700 FT. FROM THE SITE.
- BUILDING PARAPETS SHALL TOTALLY SCREEN ALL ROOF TOP UNITS AND **EQUIPMENT FROM SIGHT.**
- K. THE MAXIMUM INDIVIDUAL LETTER SIZE OF ALL BUILDING MOUNTED SIGNAGE SHALL NOT EXCEED 2'-0" IN HEIGHT. LOGO DESIGN SIGNS SHALL COMPLY WITH 13R-9 OF THE LA CUEVA SDP. ALL SIGNS SHALL FOLLOW THE LA CUEVA SDP SIGNAGE REGULATIONS.
- ALL NEW UTILITIES SHALL BE PLACED UNDERGROUND PER 11R-2 OF THE LA CUEVA SDP.
- M. IF A FREE STANDING SIGN ON LOT 20 IS APPROVED BY ZHE, THE TOTAL SIGN FACE AREA OF BUILDING MOUNTED SIGNS ON LOT 20 SHALL NOT EXCEED 12.5% OF THE TOTAL FACADE AREA FOR THE SOUTHERN ELEVATIONS AND 10% OF THE TOTAL FACADE AREA FOR THE OTHER ELEVATIONS. THE TOTAL SIGN FACE AREA OF EACH TENANT'S BUILDING MOUNTED SIGNS SHALL NOT EXCEED 12.5% OF THE FACADE AREA OF EACH TENANT'S PREMISES FOR SOUTH ELEVATIONS AND 10% FOR OTHER
- N. ALL SIGNAGE TO PROVIDE MINIMUM CONTRAST OF 70% BETWEEN GRAPHICS AND BACKGROUND PER ADA.
- P. EXISTING UTILITY EASEMENTS OR RIGHT-OF-WAY SHALL BE DETERMINED IF THEY ARE LOCATED ON OR ADJACENT TO THE PROPERTY AND TO ABIDE BY ANY CONDITIONS OR TERMS OF THOSE EASEMENTS OR AGREEMENTS.
- Q. PNM'S NEW SERVICE DELIVERY DEPARTMENT SHALL BE CONTACTED TO COORDINATE ELECTRIC SERVICE.
- R. SCREENING SHALL BE DESIGNED TO ALLOW ACCESS TO UTILITY FACILITIES. ADEQUATE CLEARANCE SURROUNDING GROUND MOUNTED UTILITIES FOR SAFE OPERATION AND MAINTENANCE SHALL BE 10 FT. FRONT OF DOOR AND 5 FT. ON THE OTHER SIDES.
- S. PNM'S NEW SERVICE DELIVERY DEPARTMENT SHALL BE CONTACTED REGARDING COORDINATION OF PROPOSED TREE SPECIES. PLACEMENT MATURITY HEIGHT, SIGN LOCATION AND HEIGHT, AND LIGHTING HEIGHT IN ORDER TO ENSURE SUFFICIENT SAFETY CLEARANCES AND TO AVOID INTERFERENCE WITH THE EXISTING DISTRIBUTION FACILITIES ALONG PASEO DEL NORTE AND THE SOUTHERN BOUNDARY OF THE SITE.
- T. USES SHALL COMPLY AT MINIMUM WITH SU-2/MIXED USE ZONING (SECTION 5.4.5, LA CUEVA SDP 2000, REVISED 2003).

U. THE FREE STANDING SIGN SHOWN ON THE SITE DEVELOPMENT PLAN IS NOT ALLOWED UNLESS A VARIANCE IS OBTAINED FROM THE ZHE.

SITE DATA

LEGAL DESCRIPTION:

PART OF LOT 13, LOTS 20 AND 21, BLOCK 10, TRACT 2, UNIT 3, NORTH ALBUQUERQUE ACRES. ALBUQUERQUE. BERNALILLO COUNTY. NEW MEXICO.

ZONE: SU-2 Mixed Use

GROSS F.A.R. (GBA/SITE AREA): 13,173sf/61,345sf = 0.214

SITE AREA: 61,345sf - 1.40 ACRES

TOTAL (GBA) - 13,173sf

GROSS BUILDING AREA RETAIL BLDG. (1-STORY) - 8,773sf RESTAURANT (1-STORY) - 4,400sf

PARKING INFORMATION

PARKING REQUIRED:

RETAIL BLDG. (M OCCUP.) - 8,600 net sf/200 = 43 SPACES RESTAURANT (A-2 OCCUP.) - 4,400sf/204 SEATS (1 PER 4) = 51 SPACES TOTAL SPACES REQUIRED - 94

PARKING PROVIDED: 94 SPACES

(MORE SPACES PROVIDED WITH SHARED PARKING AGREEMENT WITH ADJACENT RETAIL DEVELOPMENT).

ACCESSIBLE PARKING REQUIRED: 51-100 SPACES = 4 ACCESSIBLE SPACES

ACCESSIBLE PARKING PROVIDED 4 SPACES, 2 VAN ACCESSIBLE

MOTORCYCLE PARKING REQUIRED: 51-100 SPACES = 3 SPACES MOTORCYCLE PARKING PROVIDED: **BICYCLE PARKING REQUIRED:** 1:20 AUTOMOBILES = 5 SPACES **BICYCLE PARKING PROVIDED:**

LEGEND

45 EXISTING CONCRETE

46 EXISTING CONCRETE

EASENEW

UTILITY EASENENT.

SIDEWALK.

PROPERTY LINE

BUILDING SETBACK

EXTENT OF CONCRETE WORK

POLE MOUNTED PARKING LIGHT; 16'-0" MAX. HEIGHT. RE: DETAIL 3/SHEET 1

FIRE HYDRANT

POTENTIAL FUTURE PHASE PROPERTY

FULLY SHIELDED FIXTURE HEAD PER C.O.A. NIGHT SKY ORDINANCES HOUSING PER MANUFACTURER, SINGLE OR DOUBLE " DIAMETER ROUND ALUMINUM POLE: COLOR TO MATCH BUILDING AS SELECTED BY ARCHITECT. WRB AND GUTTER 47. NEW 20 FT. PUBLIC SONOTUBE FORMED CONC., 1'-6"Ø 48 NEW 10 FT. PRIVATE UTILITY EASENENT FINISH GRADE OR PAVING

AFD PLANS CHECKING OFFICE HYDRANT(S) ONLY OMMATURE & DATE

1/4" = 1'-0"

DATE

3 LIGHT POLE ELEVATION

FORMER PROJECT NUMBER: 1003532

PROJECT NUMBER: 1008069

1 2 10 DEB CHAIRPERSON, PLANNING DEPARTMENT

APPLICATION NUMBER: <u>09EPC-40063/10DRB-70026</u>

This plan is consistent with the specific Site Development Plan approved by the Environmental Planning Commission (EPC), dated December 17, 2009 and the findings and conditions in the official notification of decision are satisfied.

Is an Infrastructure List Required? (X) Yes () No If yes, then a set of approved DRC plans with a work order is required for any construction within Public Right-of-Way or for construction of public

DRB SITE DEVELOPMENT PLAN APPROVAL:

115275	02/17/10
TRAFFIC ENGINEER, TRANSPORTATION DIVISION	DATE
allen du	2/17/10
ABCWUA	DATE
Unistina Sandoral	alizho
PARKS AND RECREATION DEPARTMENT	DATE
Bradley L. Brighan	5/17/10
CITY ENGINEER	DATE
lee whate	21-10
SOLID WASTE MANAGEMENT	DATE
Cal Class	05-17-10

REVISIONS DRAWN BY **REVIEWED BY**

2-11.2010

Nor Me

architecture

interiors

landscape

planning

engineering

7601 Jefferson NE Suite 100 🛶

Albuquerque, NM 87109

505 761-9700

fax 761-4222


ENGINEER

dps @ dpsdesign.org

February 2, 2010 PROJECT NO. **DRAWING NAME**

DEVELOPMENT PLAN FOR BUILDING PERMIT

SHEET NO.

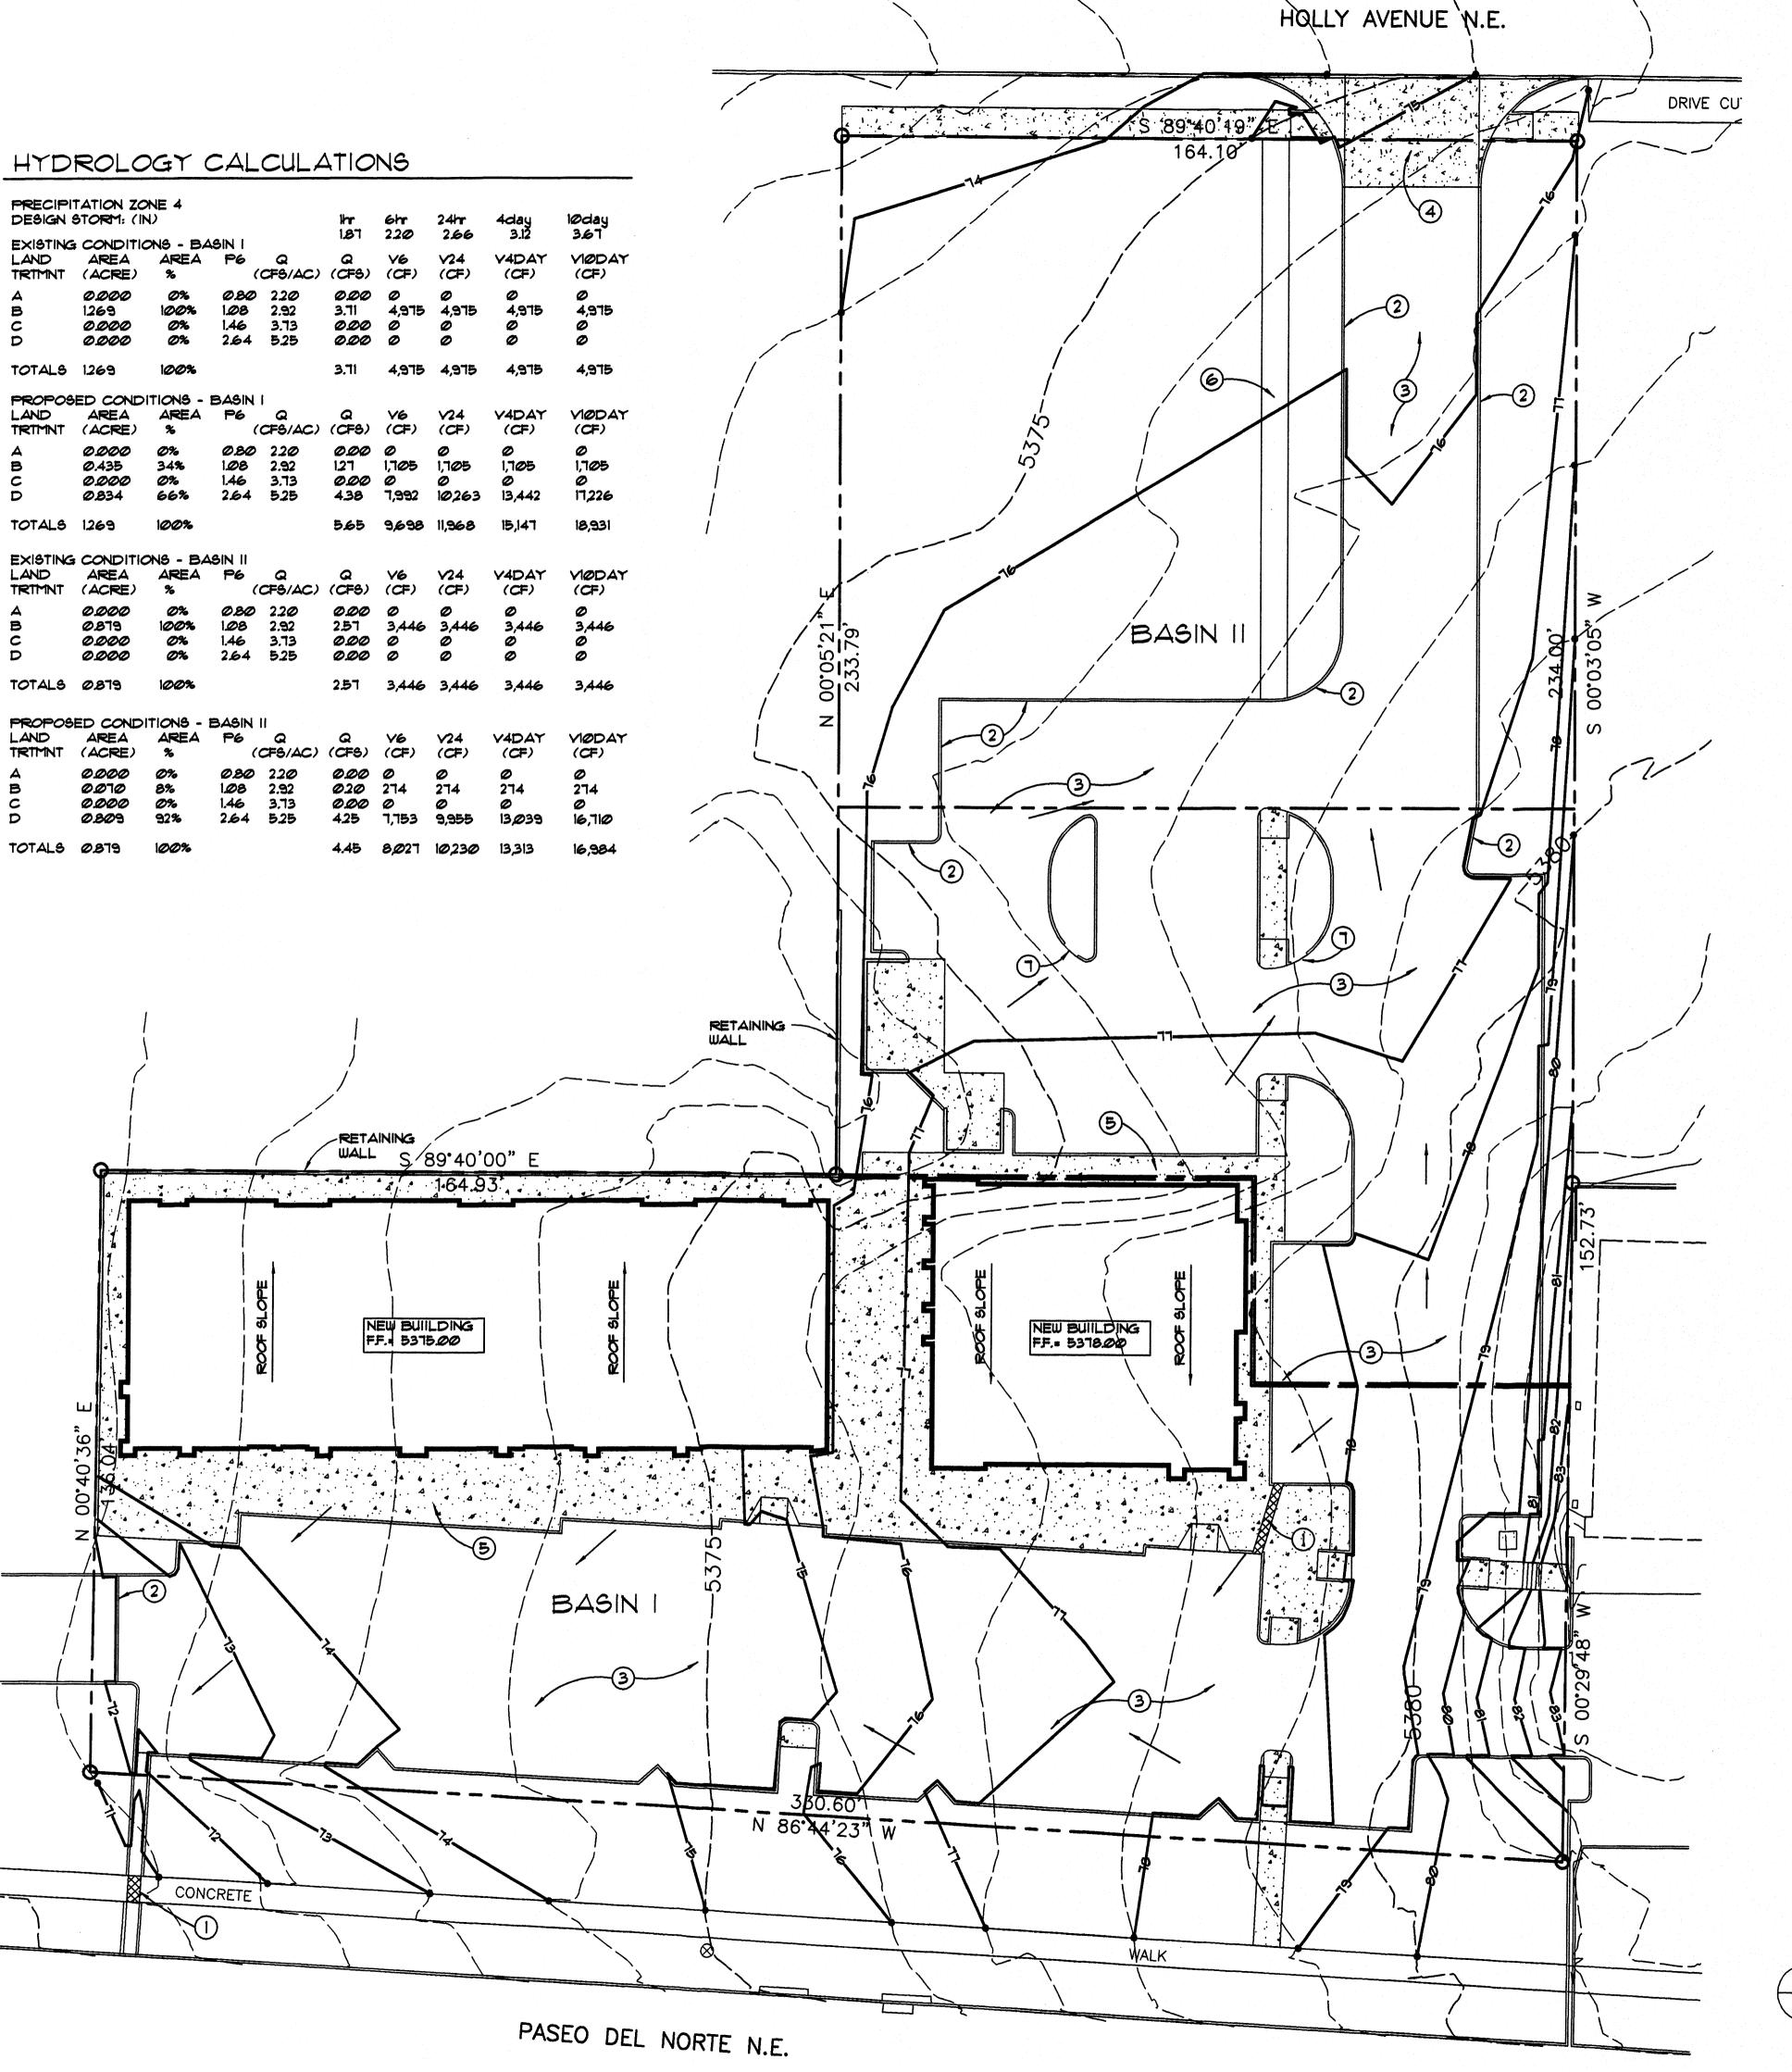

KEYED NOTES

- SIDEWALK CULVERT
- TEMPORARY ASPHALT CURB
- ASPHALT PAVING
- 4 CONCRETE DRIVE PAD
- 5 CONCRETE SIDEWALK
- TEMPORARY ASPHALT PATH
- 4'-0" WIDE CURB BREAK AT LANDSCAPE ISLAND FOR RUNOFF STORAGE

CLEVA VICINITY MAP C-19-Z

DESIGN NARRATIVE


THIS SITE IS 2.148 ACRES AND IS CURRENTLY UNIMPROVED. THE SITE WILL BE DEVELOPED FOR RETAIL BUILDINGS AND PARKING. THE DEVELOPED SITE WILL BE GRADED TO DIRECT RUNOFF TO IMPROVED DOWNSTREAM STORM DRAIN FACILITIES IN PASEO DEL NORTE AND HOLLY AVE. BASIN I STORM RUNOFF WILL ENTER PASEO DEL NORTE VIA A CONCRETE RUNDOWN AND SIDEWALK CULVERT. BASIN II RUNOFF DIRECTED NORTH WILL FLOW TO STREET IMPROVEMENTS IN HOLLY AVE. VIA THE PAVED ACCESS ROAD.

LEGAL DESCRIPTION

LOTS 13, 20, AND 21, BLOCK 10, TRACT 2, UNIT 3, NORTH ALBUQUERQUE ACRES, ALBUQUERQUE, BERNALILLO COUNTY, NEW MEXICO

BENCHMARK

ELEVATIONS ARE BASED ON CITY OF ALBUQUERQUE STATION No. "HEAVEN UNDERGROUND", HAVING AN ELEVATION OF 5278235

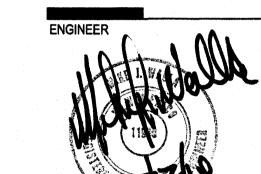

Nort Mex

<u>e</u>

750

7601 Jefferson NE Suite 100

Albuquerque, NM 87109

505 761-9700 fax 761-4222

ARCHITECT

dps @ dpsdesign.org

architecture

interiors

landscape

planning

engineering

LEGEND

--5380--- EXISTING CONTOUR

NEW CONTOUR

NEW SPOT ELEVATION EXISTING SPOT ELEVATION NEW FLOW DIRECTION ARROW

TOP OF ASPHALT TOP OF CONCRETE FINISHED GRADE

NEW AC PAYING ROOF DRAIN LOCATION

BACK OF CURB (EXISTING) EDGE OF CONCRETE (EXISTING)

NEW CONCRETE PAYING

GRADE (EXISTING) FLOW LINE TOP OF GRATE


DRAWN BY LEK **REVIEWED BY** MJW DATE February 17, 2010

PROJECT NO.

DRAWING NAME CONCEPTUAL **GRADING** and DRAINAGE PLAN




CONCEPTUAL GRADING and DRAINAGE PLAN

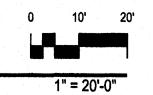



SHEET NO.

09-0055

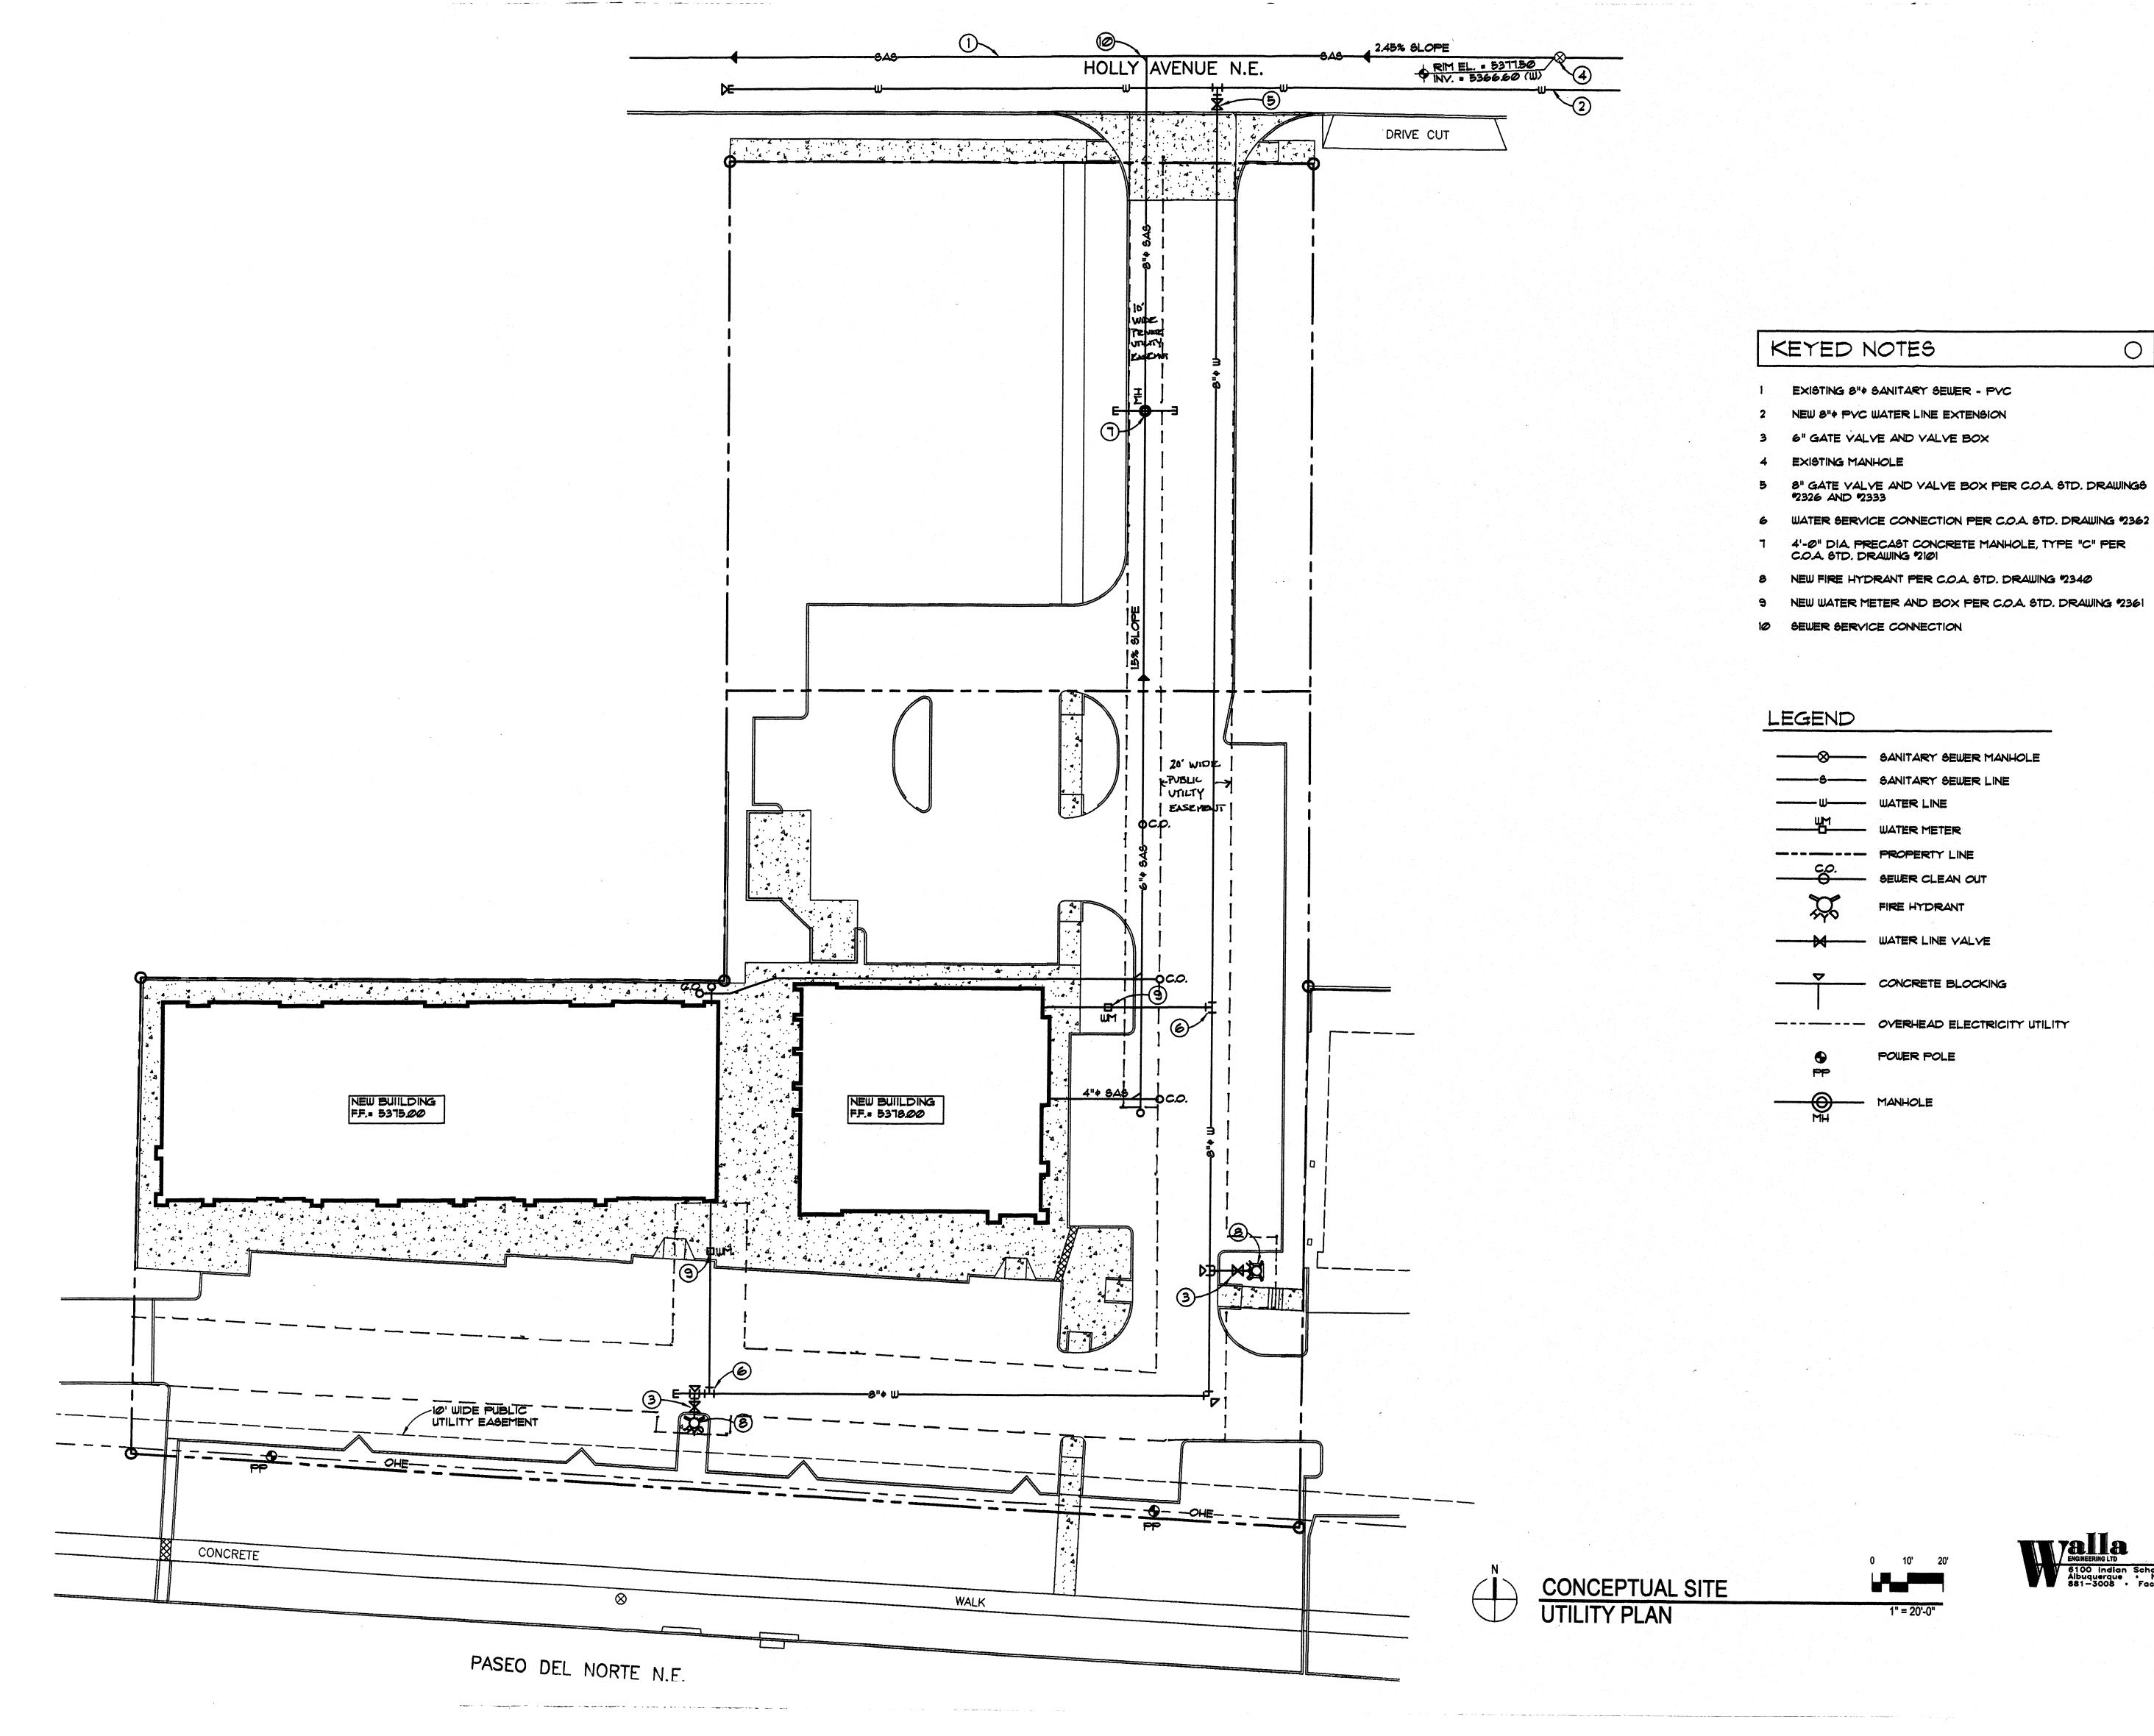



interiors landscape planning engineering

architecture

Dekker Perich Sahatin

7601 Jefferson NE Suite 100 Albuquerque, NM 87109 505 761-9700 fax 761-4222 dps@dpsdesign.org

ARCHITECT

ENGINEER

PROJECT


7441 & 7501
Paseo Del Norte

REVISIONS

1/4/2010 EPC Conditions of Approval


DRAWN BY	LE
REVIEWED BY	MJV
DATE	February 17, 201
PROJECT NO.	09-005
DRAWING NAME	

CONCEPTUAL SITE UTILITY PLAN

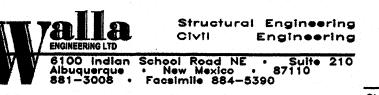

SHEET NO.

C102

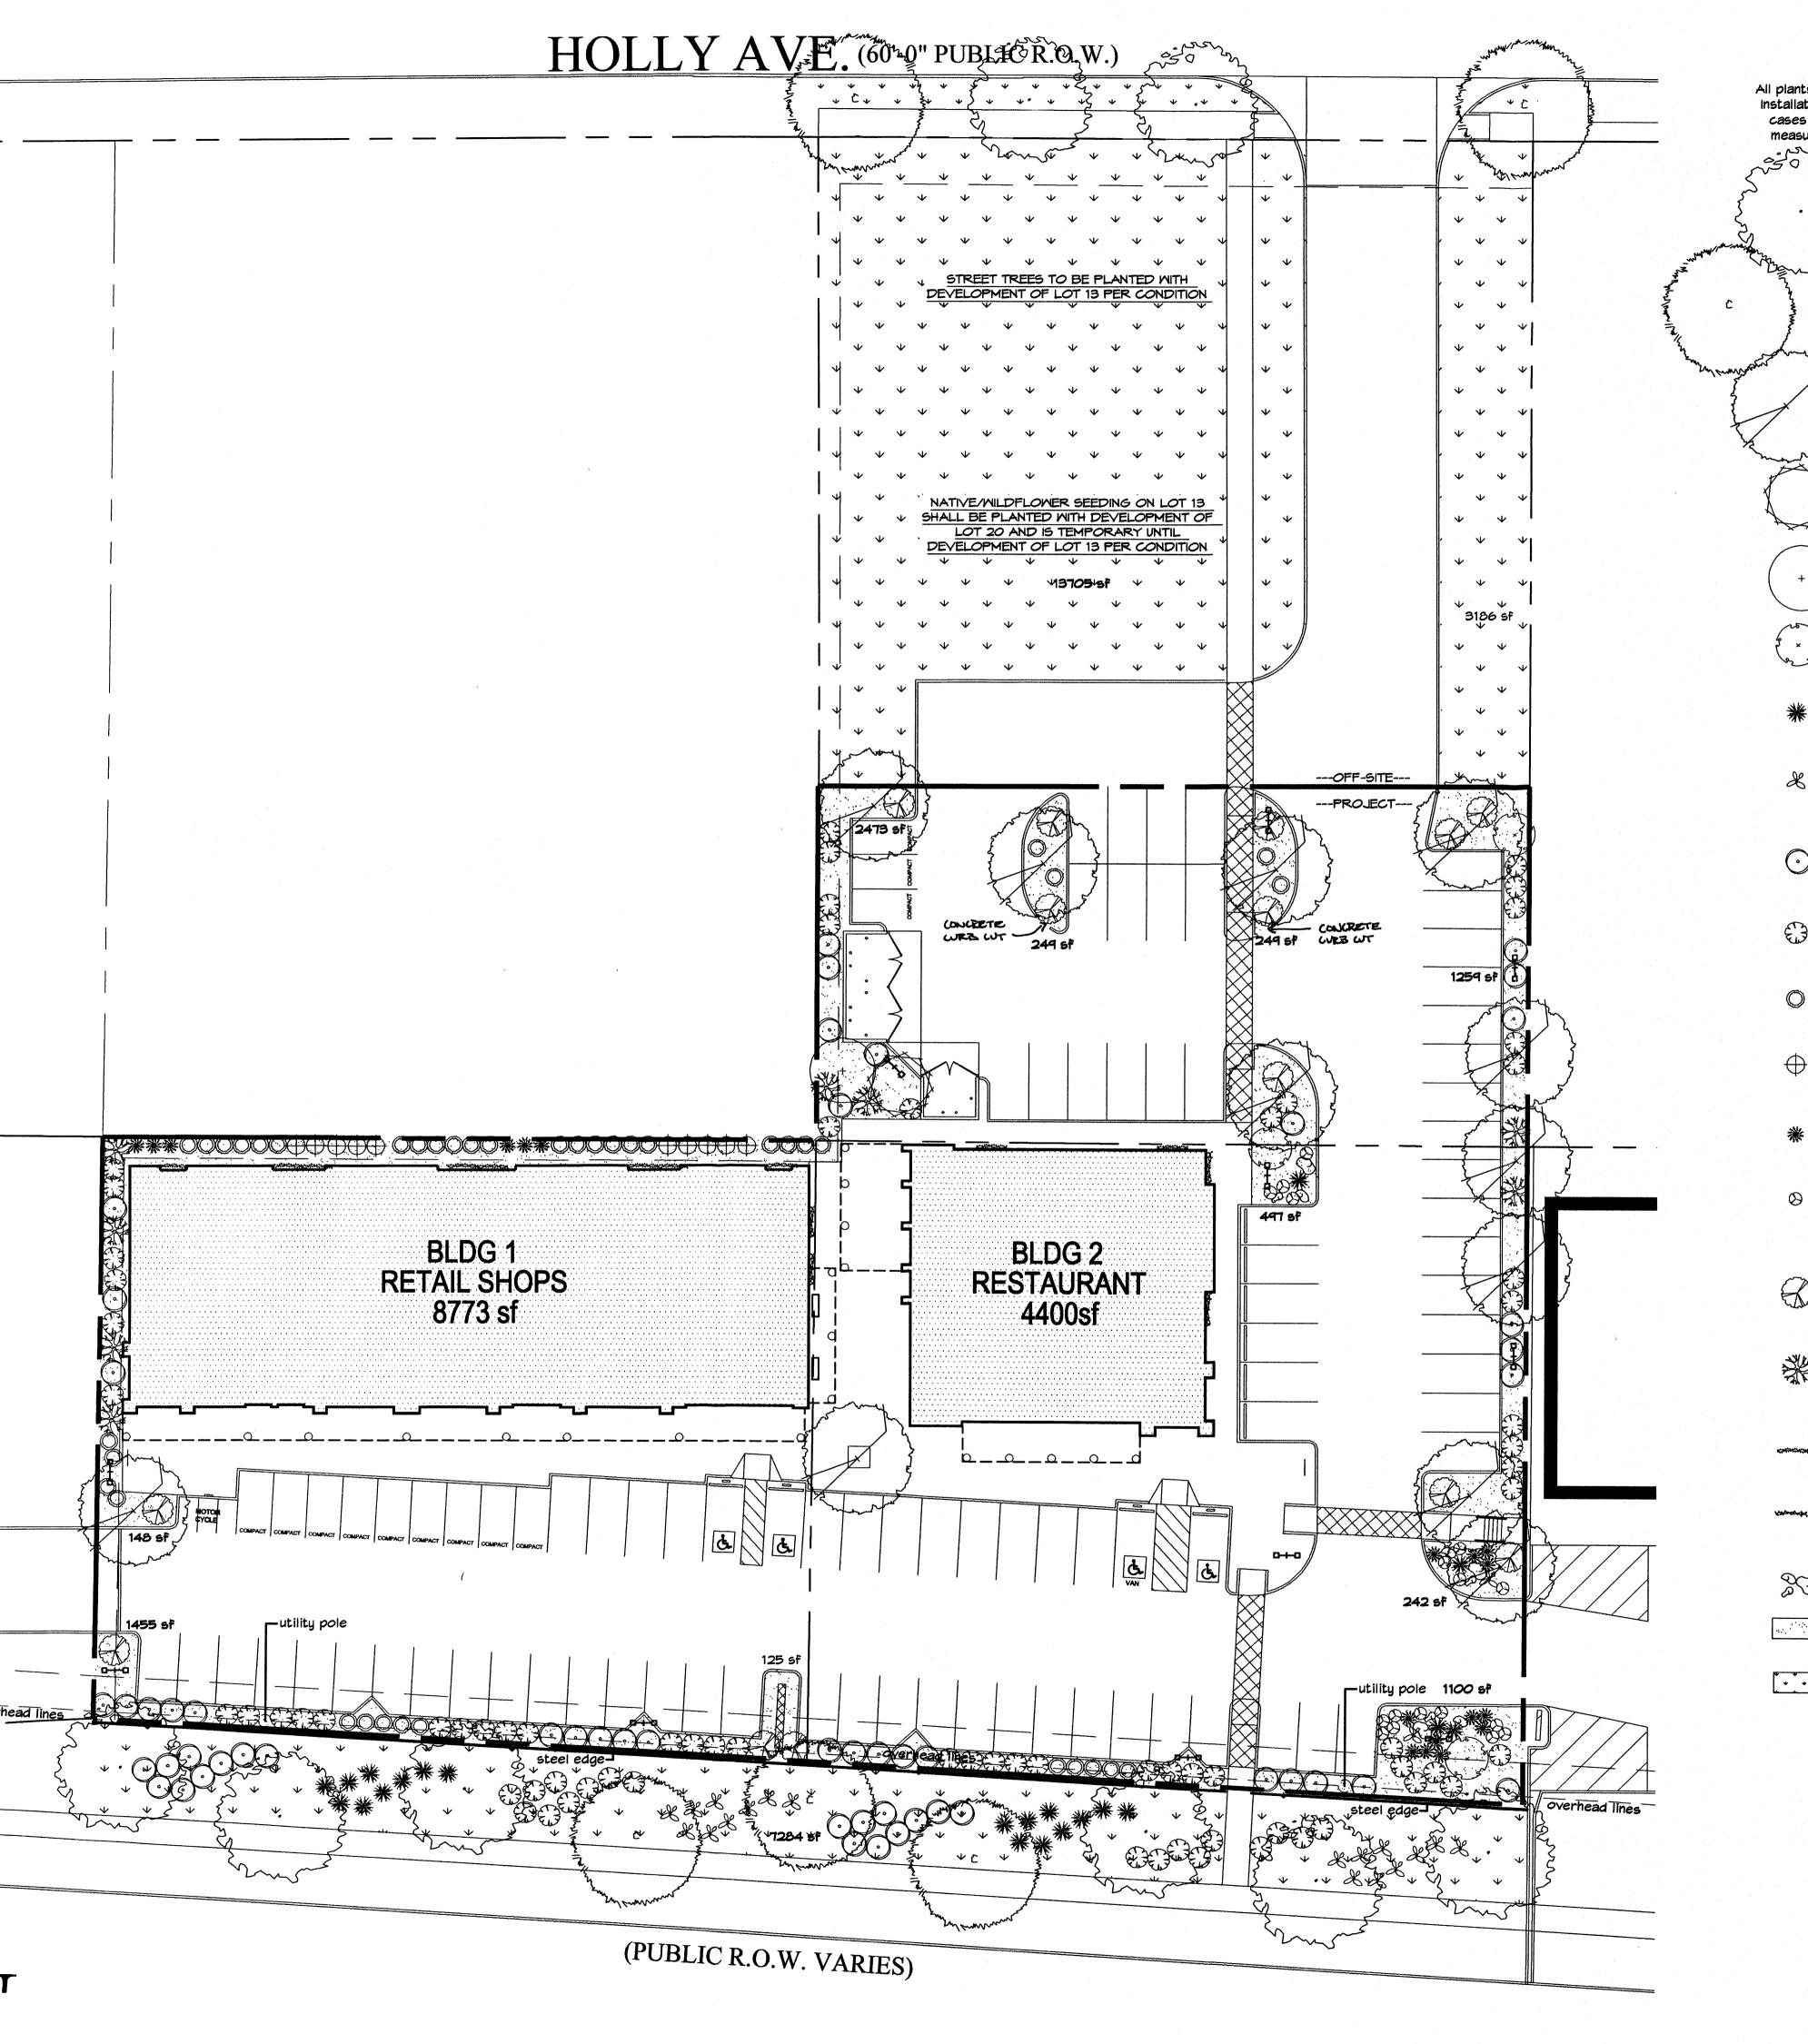

PLANT LEGEND

All plants shall be sized per American Standard for Nursery Stock. Installation size shall indicate the greater of height or spread. In cases where Type O plants have been pruned for rejuvenation, measurement should be by spread of roots rather than by the

height of the plant. * DENOTES EVERGREEN PLANT MATERIAL

STREET SHADE TREES AUTUMN PURPLE ASH 6 Fraxinus americana
2" Cal., 12'-14' Inst./60' x 60' maturity
Water (M) Allergy (H) Osf

BUR OAK 3 Quercus macrocarpa 2" Cal., 12'-14' Inst. / 60' x 60' maturity Water (M) Allergy (M) Osf

PARKING LOT SHADE TREE CHINESE PISTACHE 12 Pistachia chinensis 2" Cal., 8'-10' Inst./40' x 30' maturity Mater (M) Allergy (L) Osf

SHRUBS DESERT WILLOW 1 Chilopsis linearis 5 Gal., 4'-10' Inst./20' x 25' maturity Water (L+) Allergy (L) 225sf

NEW MEXICO OLIVE 1 Forestiera neomexicana 5 Gal., 4'-10' Inst./15' x 15' maturity Water (M) Allergy (L) 225sf

BUTTERFLY BUSH 3 Buddleia davidii 5 Gal., 12"-3' inst./10' x 10' maturity Mater (M) Allergy (L) 100sf

• RED YUCCA 22 Hesperaloe parviflora 5 Gal., 18"-3' Inst./3' x 4' maturity Water (L+) Allergy (L.) 16sf

* PRICKLY PEAR 20 Opuntia macrocentra 5 Gal., 12"-3' Inst./3' x 3' maturity Water (L) Allergy (L) 9sf

* SPANISH BROOM 53 Genista hispanica 5 Gal., 2'-4' Inst./4' x 4' maturity Water (M) Allergy (L) 16sf

* BROOM BACCHARIS 72 Baccharis sarothroides 5 Gal., 2'-4' Inst./10' x 10' maturity Water (L+) Allergy (L) 100sf

* TURPENTINE BUSH 40 Ericameria iaricifolia 1 Gal., 6"-15" Inst./3' × 4' maturity Water (L+) Allergy (L) 16sf

POTENTILLA 10
Potentilla fruticosa
1 Gal., 6"-15" Inst./3' x 3' maturity
Water (M+) Allergy (L) 9sf

BLUE AVENA/OAT GRASS 18 Helictotrichon sempervirens 1 Gal., 3"-15" Inst./2' x 1' maturity Mater (M) Allergy (L) 1sf

MILDFLOWER 17 1 Gal., 3"-15" Inst./varies at maturity Mater (varies) Allergy (varies) 4sf

GROUNDCOVERS * HONEYSUCKLE 14 Lonicera japonica 'Halliana' 1 Gal., 6"-15" Inst./3' x 12' maturity Water (M) Allergy (L) 144sf Unstaked-Groundcover

> MINTER JASMINE 8 Jasminum nudiflorum 1 Gal., 6"-15" Inst./4' × 6' maturity Water (L+) Allergy (L) 36sf

* ENGLISH IVY 9 Hedera helix 1 Gal., 6"-15" Inst./climbing to 40' Water (M) Allergy (L) * BANK'S ROSE 5 Rosa banksiae 1 Gal., 6"-15" Inst./climbing to 20' Water (M) Allergy (L)

HARDSCAPES OVERSIZED GRAVEL 4 9 BOULDERS

3/4" GRAY GRAVEL WITH FILTER FABRIC TO A MINIMUM S" DEPTH

UN-IRRIGATED CRIMP STRAWNATIVE SEED AND WILDFLOWERS (SEEDED BETWEEN MAY 15TH-SEPTEMBER

PLANT LEGEND OFF-SITE


All plants shall be sized per American Standard for Nursery Stock. Installation size shall indicate the greater of height or spread. In cases where Type O plants have been pruned for rejuvenation,

measurement should be by spread of roots rather than by the height of the plant.

* DENOTES EVERGREEN PLANT MATERIAL STREET SHADE TREES- TO BE PLANTED WITH DEVELOPMENT OF LOT 13 PER CONDITION AUTUMN PURPLE ASH 2 Fraxinus americana
2" Cal., 12'-14' Inst./60' × 60' maturity
Water (M) Allergy (H) Osf

BUR OAK 2 Quercus macrocarpa 2" Cal., 12'-14' Inst./ 60' x 60' maturity Water (M) Allergy (M) Osf


CRIMP STRAWNATIVE SEED AND **WILDFLOWERS (SEEDED BETWEEN** MAY 15TH-SEPTEMBER 15TH, FOR BEST GERMINATION). LOT 13 SEED SHALL BE WATERED BY AN ABOVEGROUND TEMPORARY IRRIGATION SYSTEM WITH LARGE AREA IRRIGATION HEADS NO MORE THAN 35' O.C. TO ENSURE 75% LIVE GROUNDCOVER GERMINATION.

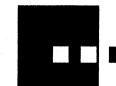

architecture interiors landscape planning

engineering

7601 Jefferson NE Suite 100 Albuquerque, NM 87109 505 761-9700 fax 761-4222 dps @ dpsdesign.org

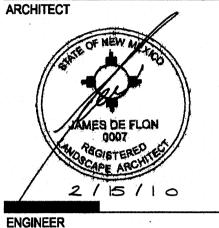

Nort Mex 50

1 1/4/2010 **EPC Conditions of Approva**

DRAWN BY rmc 8-3-09 REVIEWED BY cmj

DATE February 2, 2010

PROJECT NO. DRAWING NAME

LANDSCAPE PLAN

SHEET NO.

Cont. Lic. #26458 7909 Edith N.E.

Albuquerque, NM 87184

All creative ideas contained Herein remains the property of The Hilltop Landscape Architects and


unless applicable fees have been paid or job order

for Nursery Stock.


Fax (505) 898-7737

L001

SEE SHEET LOO2 FOR NOTES, DETAILS AND CALCULATIONS

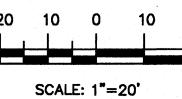

Ph. (505) 898-9690 cm i@hilltoplandscaping.com Contractors and are protected by copyright laws. This is an original design and must not be released or copied placed. All plants shall be sized per American Standard

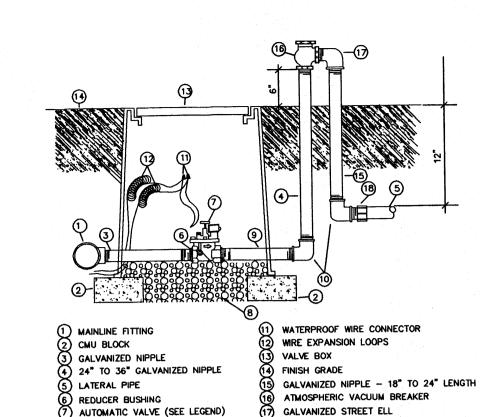

GRAVEL ACCENT DETAIL

LOT 20

square feet

16891 (100%) square feet

square feet

16891

61345

GRAVEL TYPE PER PLAN

OVERSIZED GRAVEL ACCENT

AT EVERY BOULDER CLUSTER

PLANTING PER PLAN


40-50 SQUARE FEET

BOULDER

and the second control of the contro

AUTOMATIC VALVE W/ ATMOSPHERIC VACUUM BREAKER

18) TOE NIPPLE OR MALE ADAPTER

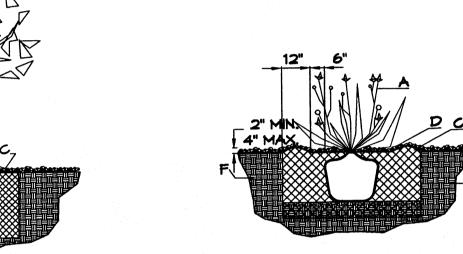

TREE PLANTING DETAIL

NTS

GENERAL NOTES:

1. ROOTBALL SHALL BE PLACED ON UNDISTURBED SOIL 1. THE OUTSIDE DIAMETER OF THE WATER

Netafim Spiral Detail

TO PREVENT TREE FROM SETTLING. 2. TOP OF ROOT COLLAR INDICATED LEVEL AT WHICH TREE WAS GROWN AND DUG: THIS REPRESENTS THE LEVEL AT WHICH THE TREE SHOULD BE INSTALLED; THAT LEVEL CONSTRUCTION NOTES: MAY BE EXCEEDED BY ONLY A ONE INCH LAYER OF SOIL.

3. PRIOR TO BACKFILLLING TREE, ALL WIRE, ROPE AND B. BACKFILL WITH EXISTING SOIL.

SYNTHETIC MATERIALS SHALL BE REMOVED FROM THE C. EARTH BERM AROUND WATER RETENTION BASIN.

REE AND THE PLANTING PIT. 4. PRIOR TO BACKFILLING ALL BURLAP SHALL BE CUT

AWAY EXCEPT FROM BOTTOM OF THE ROOTBALL.

CONSTRUCTION NOTES:

- B. BACKFILL WITH EXISTING SOIL.
- D. UNDISTRUBED SOIL.

SHRUB PLANTING DETAIL

) GRAVEL

GALVANIZED NIPPLE

) GALVANIZED ELBOW

GENERAL NOTES:

RETENTION BASIN SHALL BE TWICE THE DIAMETER OF THE SHRUB PLANTING PIT.

- D. 3" DEPTH OF GRAVEL MULCH E. FINISH GRADE. F. UNDISTURBED SOIL.

- C. 3" DEPTH OF GRAVEL MULCH.

LANDSCAPE NOTES: Landscape maintenance shall be the responsibility of the Property Owner. The Property Owner shall maintain street trees in a living, healthy, and attractive condition.

It is the intent of this plan to comply with the City Of Albuquerque Water Conservation Landscaping and Water Waste Ordinance planting restriction approach. Approval of this plan does not constitute or imply exemption from water waste provisions of the Water Conservation Landscaping and Water waste Ordinance.

Water management is the sole responsibility of the Property Owner. All landscaping will be in conformance with the City of Albuquerque Zoning Code, Street Tree Ordinance, Pollen Ordinance, and Water Conservation Landscaping and Water Waste Ordinance. In general, water conservative, environmentally sound landscape principles will be followed in design and installation.

Plant beds shall achieve 75% live ground cover at maturity.

3/4" Crushed Grey Gravel over Filter Fabric to a minimum depth of 3" shall be nplaced in all landscape areas which are not designated to receive native

IRRIGATION NOTES:

irrigation shall be a complete underground system with Trees to receive 1 Netafim spiral (50' length) with 3 loops at a final radius of 4.5' from tree trunk, pinned in place. Netafim shall have emitters 12" o.c. with a flow of .6 aph. Shrubs to receive (2) 1.0 GPH Drip Emitters. Drip and Bubbler sustems to be tied to 1/2" polypipe with flush caps at each end. Trees and shrubs shall be on separate valves.

Run time per each shrub drip valve will be approximately 15 minutes per day. Tree drip valve shall run 1.5 hours, 3 times per week. Run time will be adjusted according to the season.

Point of connection for irrigation system is unknown at current time and will be coordinated in the field. Irrigation will be operated by automatic controller.

Location of controller to be field determined and power source for controller to be provided by others.

Irrigation maintenance shall be the responsibility of the Property Owner.

Water and Power source shall be the responsibility of the Developer/Builder.

LANDSCAPE CALCULATIONS

TOTAL LOT AREA

TOTAL GROUNDCOVER PROVIDED

TOTAL OFFSITE LANDSCAPE PROVIDED

75-100% GROUNDCOVER EXPECTED IN NATIVE SEED AREAS

1017L LOT 71 LOT		_
TOTAL BUILDINGS AREA	13173	square feet
NET LOT AREA	48172	square feet
LANDSCAPE REQUIREMENT	15%	
TOTAL LANDSCAPE REQUIREMENT	7225	square feet
TOTAL BED PROVIDED	7797	_ square feet
GROUNDCOVER REQ.	75%	_ square feet
TOTAL GROUNDCOVER REQUIREMENT	5847	_ square feet
TOTAL GROUNDCOVER PROVIDED	7797 (100%)	_ square feet
TOTAL NATIVE SEED AREA	7284	square feet
GROUNDCOVER REQ.	75%	square feet
TOTAL GROUNDCOVER REQUIREMENT	5463	square feet
TOTAL GROUNDCOVER PROVIDED	7284 (100%)	_ square feet
TOTAL LANDSCAPE PROVIDED 100% GROUNDCOVER PROVIDED IN BED AREA & 75-100% G	15081 (31%) ROUNDCOVER EXPECTED II	-
		LOT 13
TOTAL OFFSITE BED PROVIDED	0	_ square feet
TOTAL OFFSITE NATIVE SEED PROVIDED	16891	_ square feet
GROUNDCOVER REQ.	T5%	_ square feet
TOTAL GROUNDCOVER REQUIREMENT	12668	square feet
	44004 (4000)	

PLANT LEGEND

All plants shall be sized per American Standard for Nursery Stock. Installation size shall indicate the greater of height or spread. In cases where Type O plants have been pruned for rejuvenation, measurement should be by spread of roots rather than by the

height of the plant. * DENOTES EVERGREEN PLANT MATERIAL STREET SHADE TREES AUTUMN PURPLE ASH 6

Fraxinus americana
'2" Cal., 12'-14' Inst./60' x 60' maturity
Water (M) Allergy (H) Osf

BUR OAK 3 Quercus macrocarpa 2" Cal., 12'-14' Inst./ 60' x 60' maturity Mater (M) Allergy (M) Osf

PARKING LOT SHADE TREE CHINESE PISTACHE 12
Pistachia chinensis
2" Cal., 8'-10' Inst./40' x 30' maturity
Water (M) Allergy (L) Osf

DESERT MILLOM 1
Chilopsis linearis
5 Gal., 4'-10' Inst./20' x 25' maturity
Water (L+) Allergy (L) 225sf NEW MEXICO OLIVE 1

Forestiera neomexicana 5 Gal., 4'-10' Inst./15' x 15' maturity Water (M) Allergy (L) 225sf BUTTERFLY BUSH 3

SHRUBS

Buddleia davidii 5 Gal., 12"-3' Inst./10' x 10' maturity Water (M) Allergy (L) 100sf • RED YUCCA 22 Hesperaloe parviflora 5 Gal., 18"-3' Inst./3' x 4' maturity Water (L+) Allergy (L) 16sf

. PRICKLY PEAR 20 Opuntia macrocentra 5 Gal., 12"-3' Inst./3' x 3' maturity Water (L) Allergy (L) 9sf

* SPANISH BROOM 53 Genista hispanica 5 Gal., 2'-4' Inst./4' x 4' maturity Mater (M) Allergy (L) 16sf

* BROOM BACCHARIS 72 Baccharis sarothroides 5 Gal., 2'-4' Inst./10' x 10' maturity Mater (L+) Allergy (L) 100sf

• TURPENTINE BUSH 40 Ericameria iaricifolia 1 Gal., 6"-15" Inst./3' x 4' maturity Mater (L+) Allergy (L) 16sf

POTENTILLA 10 Potentilla fruticosa 1 Gal., 6"-15" Inst./3' x 3' maturity Water (M+) Allergy (L) 96f

BLUE AVENA/OAT GRASS 18 Helictotrichon sempervirens 1 Gal., 3"-15" Inst./2' x 1' maturity Mater (M) Allergy (L) 1sf

WILDFLOWER 17 1 Gal., 3"-15" Inst./varies at maturitu Mater (varies) Allergy (varies) 4st

GROUNDCOVERS * HONEYSUCKLE 14 Lonicera japonica 'Halliana' 1 Gal., 6"-15" Inst /3' x 12' maturity Water (M) Allergy (L) 144sf Unstaked-Groundcover

MINTER JASMINE 8 Jasminum nudiflorum 1 Gal., 6"-15" Inst./4' x 6' maturitu Mater (L+) Allergy (L) 36sf

* ENGLISH MY 9 Hedera helix 1 Gal., 6"-15" Inst./climbing to 40' Mater (M) Allergy (L)

BANK'S ROSE 5 Rosa banksiae 1 Gal., 6"-15" Inst./climbing to 20' Mater (M) Allergy (L)

HARDSCAPES OVERSIZED GRAVEL 4 9 BOULDERS

3/4" GRAY GRAVEL WITH FILTER FABRIC TO A MINIMUM 3" DEPTH

* * * * . UN-IRRIGATED CRIMP STRAWNATIVE SEED AND WILDFLOWERS (SEEDED BETWEEN MAY 15TH-SEPTEMBER

NATIVE SEED MIX-STANDARD COA MIX

ACF
3.
3.
3.
5.
2.
2.

TOTAL RATE 18.0 LBS/AC

STREET TREE REQUIREMENTS - Minimum 2" Caliper

Street Tree Ordinance are as follows:

Name of Street: Paseo del Norte

Required # 9 Provided # 9

Name of Street: Holly Required # 4 Provided # 4

1 Shade tree per 10 spaces

NOTE TO CLIENT:

remain per plan.

Required # 10 Provided # 12

Street trees required under the City Of Albuquerque

PARKING LOT TREE REQUIREMENTS - Minimum 2" Caliper

Should The Hilltop not receive a Grading and Drainage plan during the design process or the on-site grades differ

from the Grading and Drainage plan received, The Hilltop

greater than 3:1. If the grades are greater than what was

originally designed, we will request an infield change-order

gravel, to stabilize the slope. All vegetative material shall

reserves the right to apply slope stabilization materials

where the specified gravel will not be suitable. Gravel

smaller than 2-4" cobblestone will not stay on a slope

to lay cobblestone or rip-rap, in lieu of the specified

Shade trees required under the City Of Albuquerque

Parking Lot Tree Ordinance are as follows:

NATIVE SEED MIX ADD-IN: HIGH DESERT MILDFLOWER MIX

SEED MIX INCLUDES: PURPLE ASTER, DESERT MARIGOLD, ROCKY MTN BEEPLANT, PLAINS COREOPSIS, BROOM DALEA, MEXICAN GOLD POPPY, FIREWHEEL, BLANKETFLOWER, BLUE FLAX, DESERT FOUR O'CLOCK, MEXICAN EVENING PRIMROSE, SAND PENSTEMON, WILD PINK SNAPDRAGON, CALIFORNIA BLUEBELLS, MEXICAN HAT AND YELLOW PRAIRIE CONEFLOWER. HEIGHT 2-3'

TOTAL RATE 2.0 LBS/AC

PLANT LEGEND OFF-SITE

All plants shall be sized per American Standard for Nursery Stock. Installation size shall indicate the greater of height or spread. In cases where Tupe O plants have been pruned for rejuvenation, measurement should be by spread of roots rather than by the height of the plant.

* DENOTES EVERGREEN PLANT MATERIAL STREET SHADE TREES- TO BE PLANTED WITH DEVELOPMENT OF LOT 13 PER CONDITION AUTUMN PURPLE ASH 2 Fraxinus americana 2" Cal., 12'-14' Inst./60' x 60' maturity Water (M) Allergy (H) Osf

BUR OAK 2 Quercus macrocarpa 2" Cal., 12'-14' Inst./ 60' x 60' maturity Mater (M) Allergy (M) Osf


CRIMP STRAW/NATIVE SEED AND MILDFLOWERS (SEEDED BETWEEN MAY 15TH-SEPTEMBER 15TH, FOR BEST GERMINATION). LOT 13 SEED SHALL BE WATERED BY AN ABOVEGROUND TEMPORARY IRRIGATION SYSTEM WITH LARGE AREA IRRIGATION HEADS NO MORE THAN 35' O.C. TO ENSURE 75% LIVE GROUNDCOVER GERMINATION.

architecture interiors landscape planning

engineering

7601 Jefferson NE Suite 100 Albuquerque, NM 87109 505 761-9700 fax 761-4222 dps @ dpsdesign.org

ARCHITECT

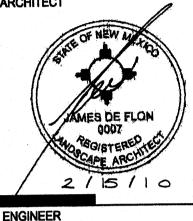

REVISIONS **EPC Conditions of Approval** 1/4/2010

DRAWN BY rmc 8-3-09

REVIEWED BY cmi DATE February 2, 2010

PROJECT NO. DRAWING NAME

LANDSCAPE PLAN

7909 Edith N.E. Albuquerque, NM 87184 Ph. (505) 898-9690

Fax (505) 898-7737 cm j@hilltoplandscaping.com All creative ideas contained Herein remains the property of The Hilltop Landscape Architects and Contractors and are protected by copyright laws. This is an original design and must not be released or copied unless applicable fees have been paid or job order

placed. All plants shall be sized per American Standard

for Nursery Stock.

LANDSCAPE ARCHITECTS & CONTRACTORS

Cont. Lic. #26458

20 10 0

SCALE: 1"=20'

SHEET NO.

09-0055

