

VICINITY MAP No.

PURPOSE OF PLAT:

THE PURPOSE OF THIS PLAT IS TO VACATE 3' OF THE 30' PRIVATE ACCESS EASEMENT AND GRANT ANY EASEMENTS AS SHOWN.

GENERAL NOTES:

- 1: UNLESS NOTED, No. 4 REBAR WITH CAP STAMPED P.S.#11463 WERE SET AT ALL PROPERTY CORNERS.
- 2: THIS PLAT SHOWS ALL EASEMENTS OF RECORD.
- 4: BASIS OF BEARINGS IS THE NEW MEXICO STATE PLANE COORDINATE SYSTEM, CENTRAL ZONE, NAD 1983.
- 5: DISTANCES ARE GROUND, BEARINGS ARE GRID.
- 6: DATE OF FIELD WORK: ___JUNE, 2012___
- 7: NO PROPERTY WITHIN THE AREA OF THIS PLAT SHALL AT ANY TIME BE SUBJECT TO A DEED RESTRICTION, COVENANT, OR BINDING AGREEMENT PROHIBITING SOLAR COLLECTORS FROM BEING INSTALLED ON BUILDINGS OR ERECTED ON LOTS OR PARCELS WITHIN THE AREA OF PROPOSED PLAT

PUBLIC UTILITY EASEMENTS

PUBLIC UTILITY EASEMENTS shown on this plat are granted for the common and joint

- A. Public Service Company of New Mexico ("PNM"), a New Mexico corporation, (PNM Electric) for installation, maintenance, and service of overhead and underground electrical lines, transformers, and other equipment and related facilities reasonably necessary to provide electrical services.
- B. New Mexico Gas Company for installation, maintenance, and service of natural gas lines, valves and other equipment and facilities reasonably necessary to provide
- C. Quest for the installation, maintenance, and service of such lines, cable, and other related equipment and facilities reasonably necessary to provide communication
- D. <u>Cable TV</u> for the installation, maintenance, and service of such lines, cable, and other related equipment and facilities reasonably necessary to provide Cable services. Included, is the right to build, rebuild, construct, reconstruct, locate, relocate, change, remove, replace, modify, renew, operate and maintain facilities for purposes described above, together with free access to, from, and over said easements, with the right and privilege of going upon, over and across adjoining lands of Grantor for the purposes set forth herein and with the right to utilize the right of way and easement to extend services to customers of Grantee, including sufficient working area space for electric transformers, with the right and privilege to trim and remove trees, shrubs or bushes which interfere with the purposes set forth herein. No building, sign, pool (aboveground or subsurface), hot tub, concrete or wood pool decking, or other structure shall be erected or constructed on said easements, nor shall any well be drilled or operated thereon. Property owners shall be solely responsible for correcting any violations of National Electrical Safety Code by construction of pools, decking, or any structures adjacent to or near easements shown on this plat. Easements for electric transformer/switchgears, as installed, shall extend ten (10) feet in front of transformer/switchgear doors and five (5) feet on each side.

Disclaimer In approving this plat, Public Service Company of New Mexico (PNM) and New Mexico Gas Company (NMGC) did not conduct a Title Search of the properties shown hereon. Consequently, PNM and NMGC do not waive or release any easement or easement rights which may have been granted by prior plat, replat or other document and which are not shown on this plat.

THIS IS TO CERTIFY THAT TAXES ARE CURRENT AND	PAID (1C
UPC#		
PROPERTY OWNER OF RECORD:		
BERNALILLO CO. TREASURER'S OFFICE:	* ¹	

FREE CONSENT

LEGAL DESCRIPTION

FOLIO 63

LOT NUMBERED TWENTY-A (20-A) IN BLOCK NUMBERED TEN (10), TRACT 2, UNIT 3, NORTH ALBUQUERQUE ACRES AS THE

SAME IS SHOWN AND DESIGNATED ON THE PLAT THEREOF, FILED IN THE OFFICE OF THE COUNTY CLERK OF BERNALILLO COUNTY, NEW MEXICO, ON MAY 26, 2010 IN MAP BOOK 2010C,

> THE SUBDIVISION HEREON DESCRIBED IS WITH THE FREE CONSENT AND IN ACCORDANCE WITH THE DESIRES OF THE UNDERSIGNED OWNERS AND PROPRIETOR THEREOF. SAID OWNER / PROPRIETOR DOES HEREBY GRANT ANY AND ALL EASEMENTS AS MAY BE CREATED BY THIS PLAT. THOSE SIGNING AS OWNERS WARRANT THAT THEY HOLD AMONG THEM COMPLETE AND INDEFEASIBLE TITLE IN FEE SIMPLE TO THE AND SUBDIVIDED.

ACKNOWLEDGMENT STATE OF NEW MEXICO) S.S.

COUNTY OF BERNALILLO) THIS INSTRUMENT WAS ACKNOWLEDGED BEFORE ME A NOTARY PUBLIC

FREE CONSENT

THE SUBDIVISION HEREON DESCRIBED IS WITH THE FREE CONSENT AND IN ACCORDANCE WITH THE DESIRES OF THE UNDERSIGNED OWNERS AND PROPRIETOR THEREOF. SAID OWNER / PROPRIETOR DOES HEREBY GRANT ANY AND ALL EASEMENTS AS MAY BE CREATED BY THIS PLAT. THOSE SIGNING AS OWNERS WARRANT THAT THEY HOLD AMONG THEM COMPLETE AND INDEFEASIBLE TITLE IN FEE SIMPLE TO THE AND SUBDIMIDED.

ACKNOWLEDGMENT STATE OF NEW MEXICO) S.S. COUNTY OF BERNALILLO)



THIS INSTRUMENT WAS ACKNOWLEDGED BEFORE ME A NOTARY PUBLIC

PLAT OF

LOT 20-A-1, BLOCK 10 TRACT 2, UNIT 3 NORTH ALBUQUERQUE ACRES

WITHIN

ELENA GALLEGOS LAND GRANT PROJECTED SECTION 18, TOWNSHIP 11 NORTH, RANGE 4 EAST, N.M.P.M. CITY OF ALBUQUERQUE BERNALILLO COUNTY, NEW MEXICO SEPTEMBER, 2012

PROJECT NUMBER:	
APPLICATION NUMBER:	
UTILITY APPROVALS:	
PUBLIC SERVICE COMPANY OF NEW MEXICO	DATE
NEW MEXICO GAS COMPANY	DATE
QWEST CORPORATION D/B/A CENTURYLINK QC	DATE
COMCAST	DATE
CITY APPROVALS:	9 - 1/ 1-
The bottom	9-24-12
CITY SURVEYOR	9-24-12 DATE
CITY SURVEYOR *REAL PROPERTY DIVISION (CONDITIONAL)	
	DATE
*REAL PROPERTY DIVISION (CONDITIONAL)	DATE
*REAL PROPERTY DIVISION (CONDITIONAL) **ENVIRONMENTAL HEALTH DEPARTMENT (CONDITIONAL)	DATE DATE
**REAL PROPERTY DIVISION (CONDITIONAL) **ENVIRONMENTAL HEALTH DEPARTMENT (CONDITIONAL) TRAFFIC ENGINEERING, TRANSPORTATION DIVISION	DATE DATE DATE DATE
*REAL PROPERTY DIVISION (CONDITIONAL) **ENVIRONMENTAL HEALTH DEPARTMENT (CONDITIONAL) TRAFFIC ENGINEERING, TRANSPORTATION DIVISION ABCWUA	DATE DATE DATE DATE

SURVEYORS CERTIFICATE: STATE OF NEW MEXICO) S.S. COUNTY OF BERNALILLO)

OFFICIAL SEAL

Trisha A. Lopes

NOTARY PUBLIC

I, ANTHONY L. HARRIS, A DULY PROFESSIONAL LICENSED LAND SURVEYOR, UNDER THE LAWS OF THE STATE OF NEW MEXICO, DO HEREBY CERTIFY THAT THE PLAT WAS PREPARED UNDER MY DIRECT SUPERVISION, THAT I AM RESPONSIBLE FOR SAID PLAT AND MEETS THE REQUIREMENTS FOR MONUMENTATION AND SURVEY OF THE ALBUQUERQUE SUBDIVISION ORDINANCE AND IS TRUE AND CORRECT TO THE BEST OF MY KNOWLEDGE AND BELIEF AND MEETS THE MINIMUM REQUIREMENTS FOR LAND SURVEYS AS SET FORTH BY THE STATE OF NEW MEXICO.


GIVEN UNDER MY HAND AND, SEAL AT ALBUQUERQUE, NEW MEXICO, THIS 17th DAY OF SEPTEMBER 2012.


DRB CHAIRPERSON, PLANNING DEPARTMEN

PHONE: (505) 889-8056 TIPLE SURVEYING, INC. PHONE: (505) 889-8645

ALBUQUERQUE, NEW MEXICO 87110

SHEET 1 OF 2

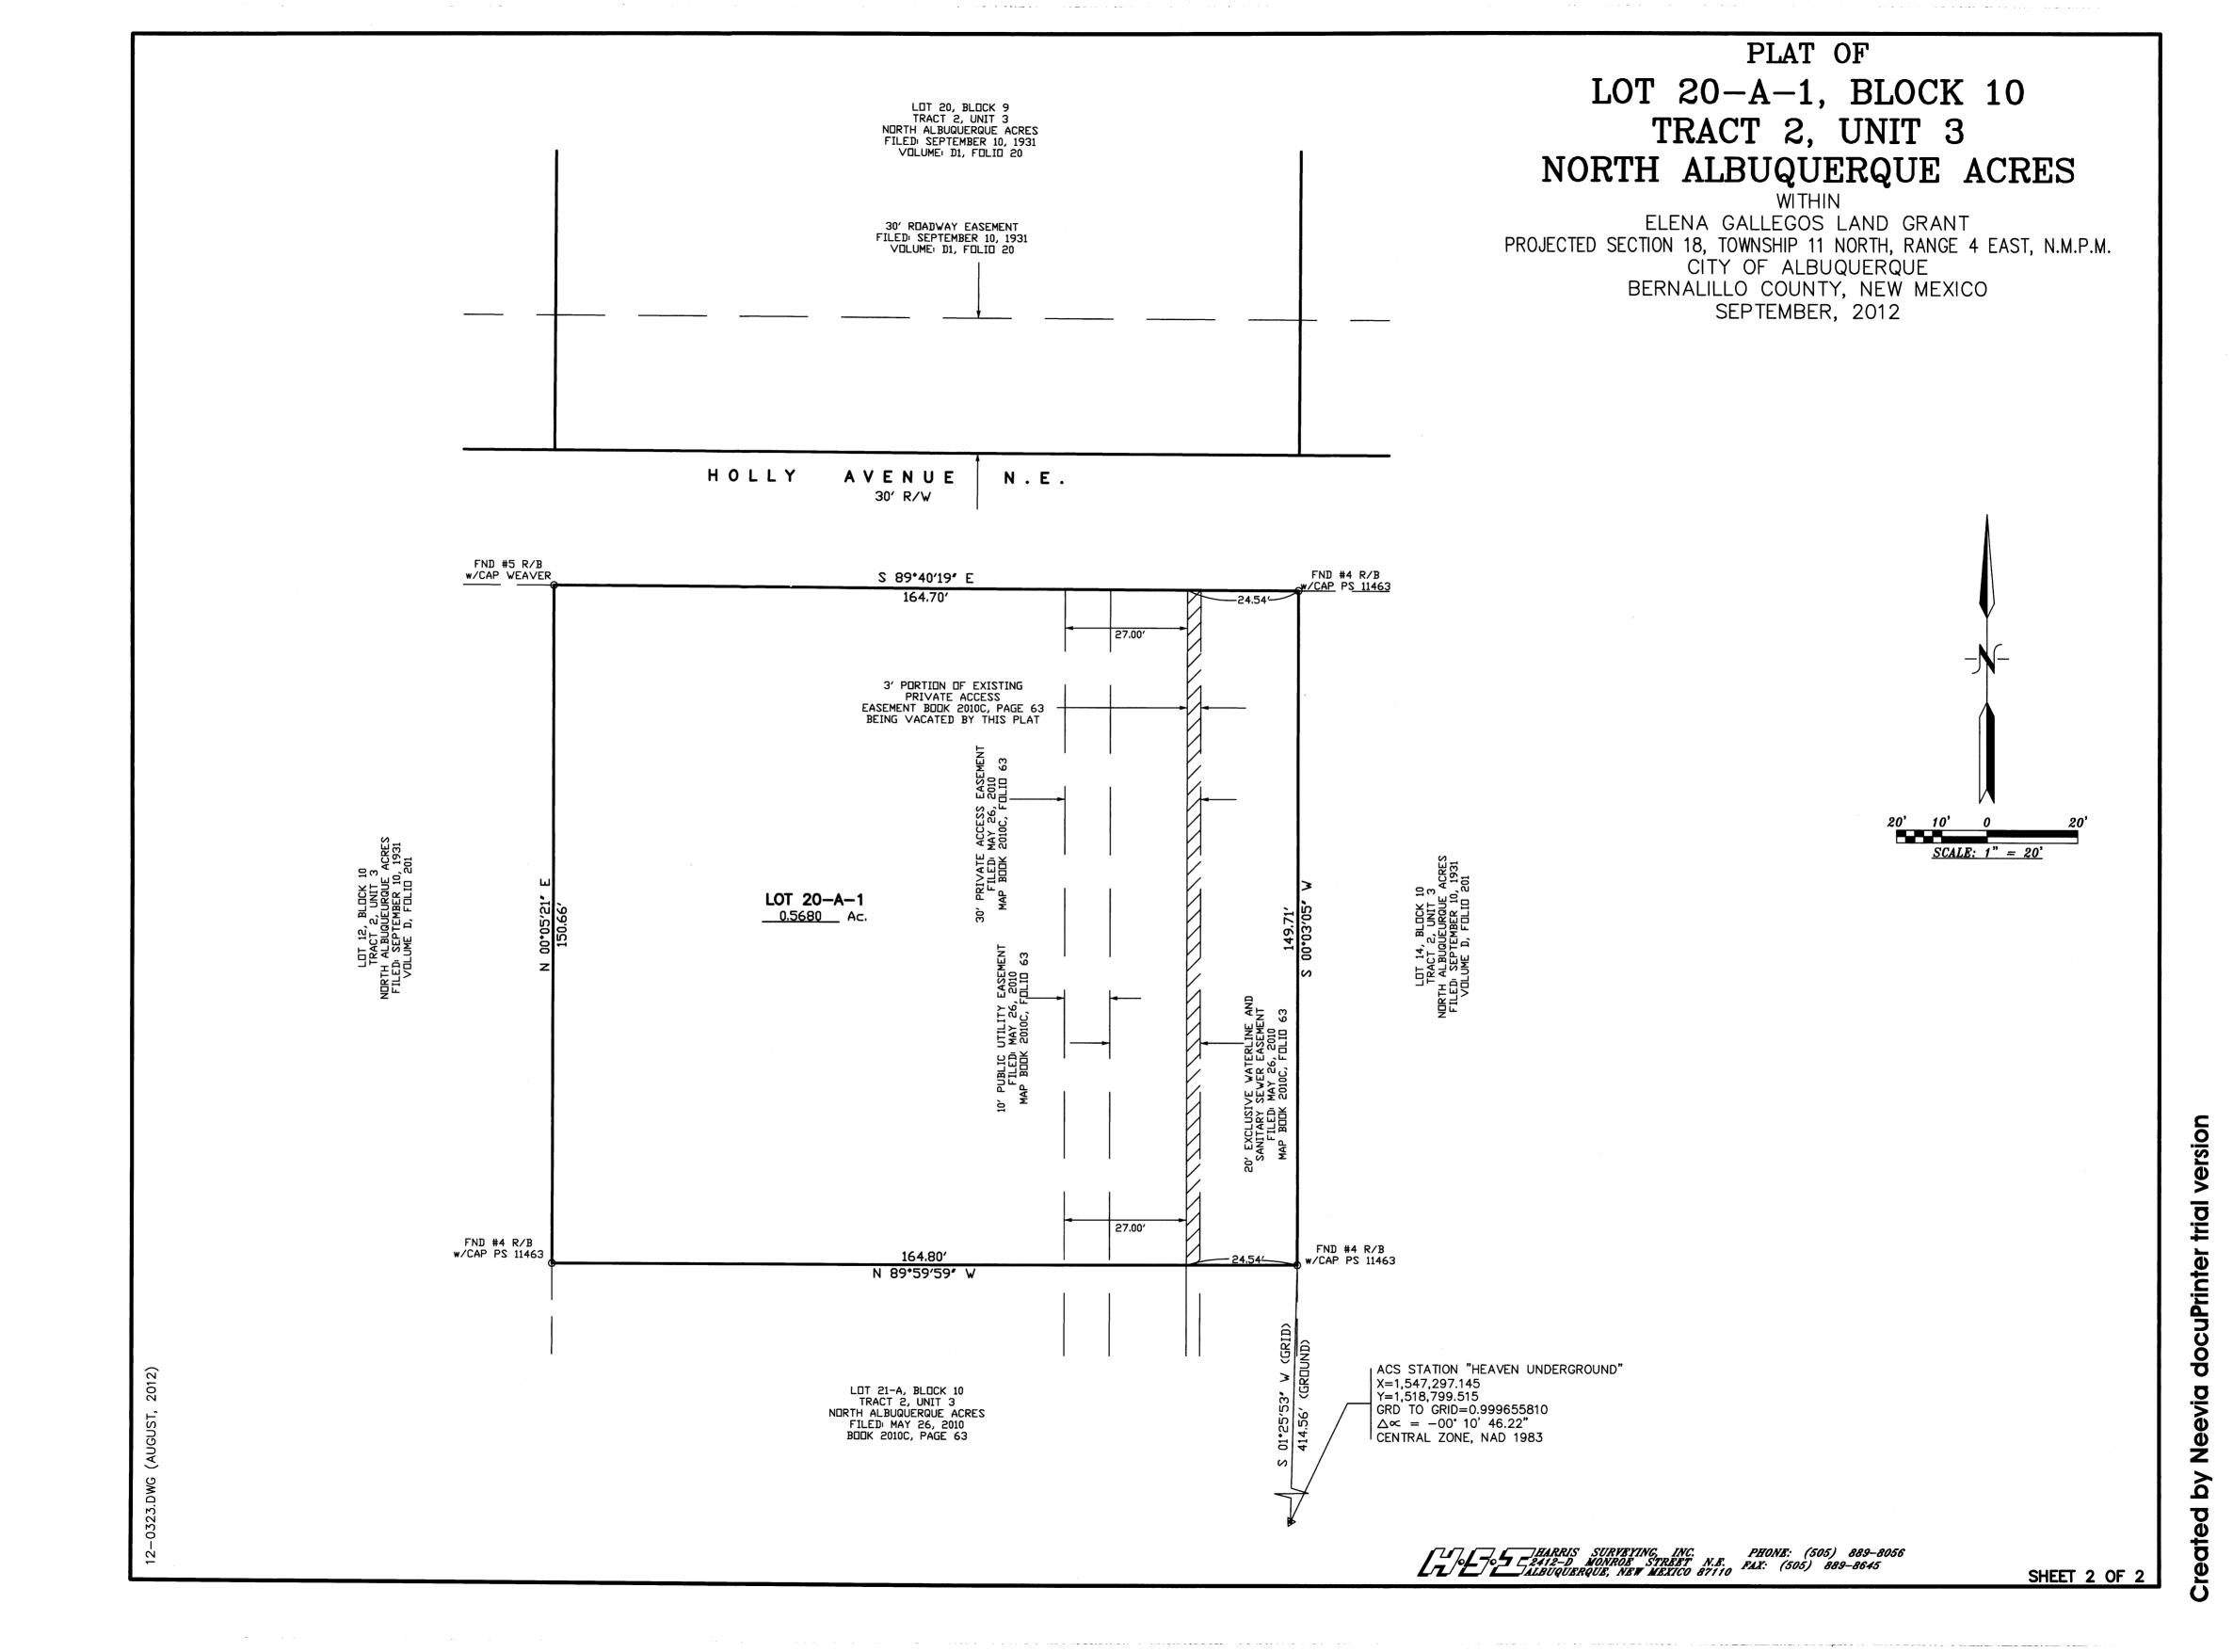

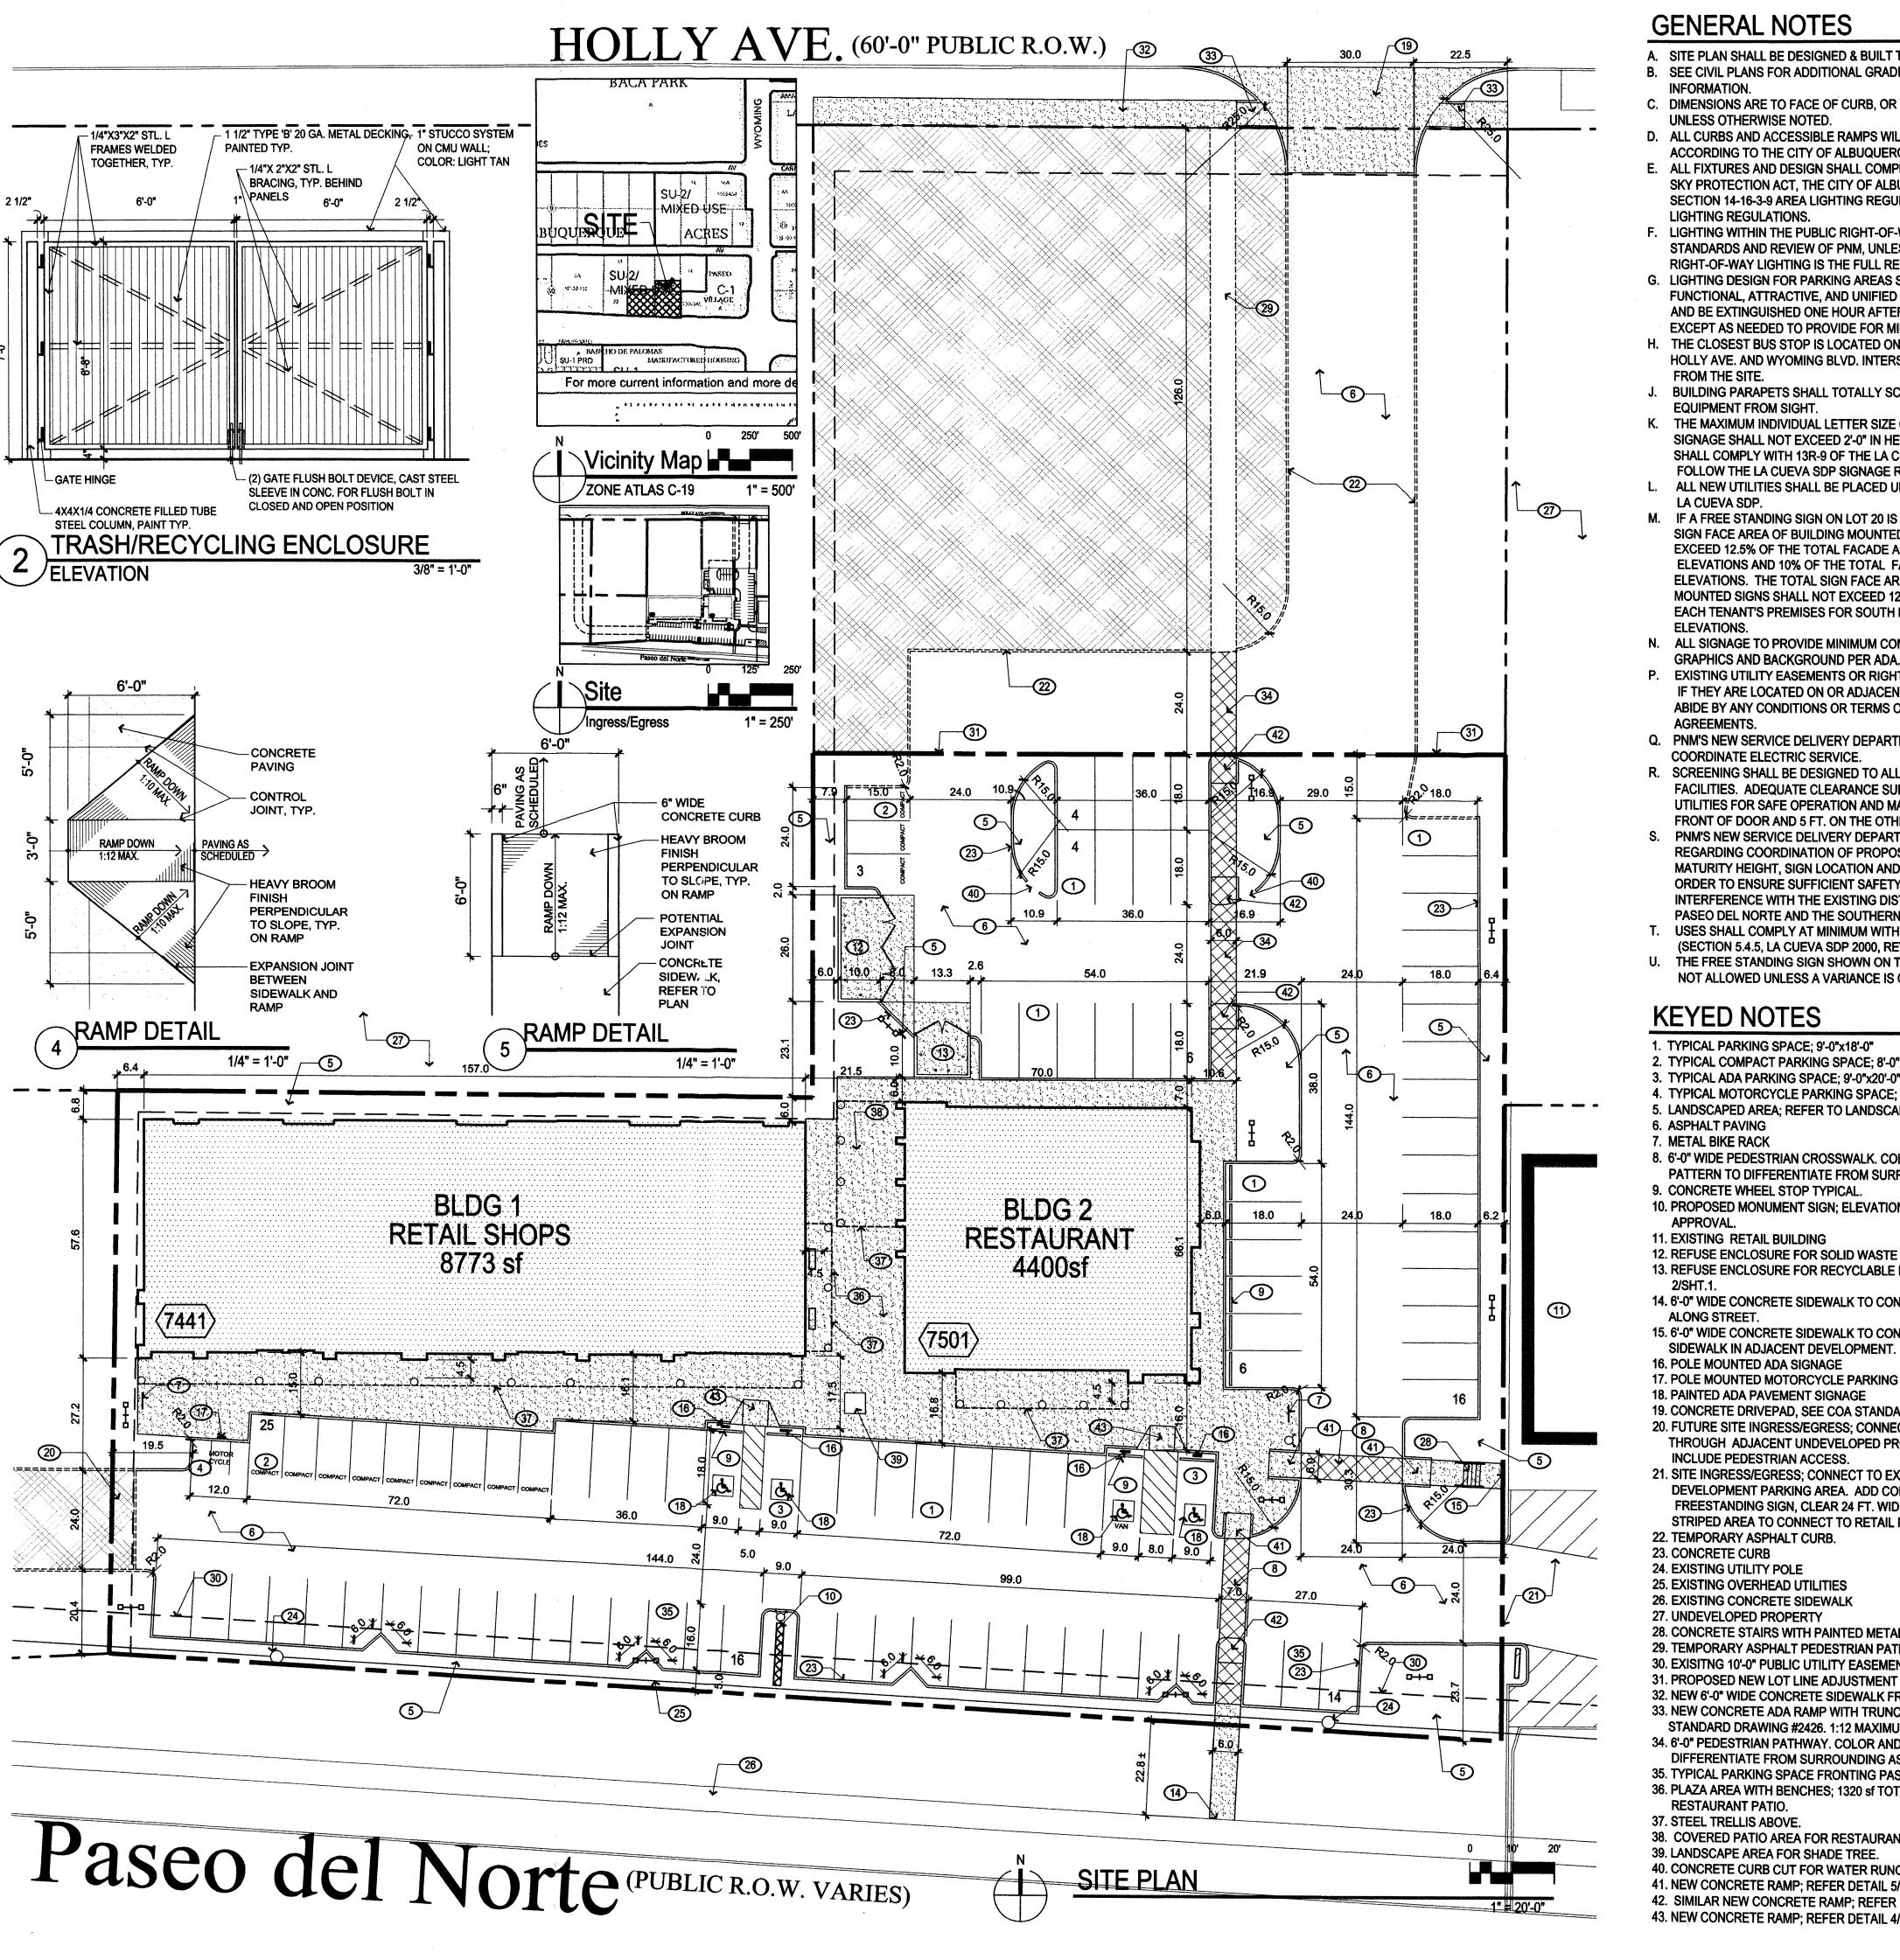

GENERAL NOTES

- A. SITE PLAN SHALL BE DESIGNED & BUILT TO CURRENT DPM STANDARDS. B. SEE CIVIL PLANS FOR ADDITIONAL GRADING. DRAINAGE AND UTILITY
- INFORMATION. C. DIMENSIONS ARE TO FACE OF CURB, OR WALL, OR EDGE OF PAVEMENT
- UNLESS OTHERWISE NOTED.
- D. ALL CURBS AND ACCESSIBLE RAMPS WILL BE DESIGNED AND BUILT ACCORDING TO THE CITY OF ALBUQUERQUE STANDARDS.
- E. ALL FIXTURES AND DESIGN SHALL COMPLY WITH THE NEW MEXICO NIGHT SKY PROTECTION ACT, THE CITY OF ALBUQUERQUE ZONING CODE, SECTION 14-16-3-9 AREA LIGHTING REGULATIONS, AND THE LA CUEVA SDP LIGHTING REGULATIONS.
- F. LIGHTING WITHIN THE PUBLIC RIGHT-OF-WAY SHALL BE SUBJECT TO THE STANDARDS AND REVIEW OF PNM, UNLESS MAINTENANCE FOR RIGHT-OF-WAY LIGHTING IS THE FULL RESPONSIBILITY OF OTHER PARTIES.
- G. LIGHTING DESIGN FOR PARKING AREAS SHALL BE LIGHTED TO PROVIDE FUNCTIONAL, ATTRACTIVE, AND UNIFIED LIGHTING THROUGHOUT THE LOT AND BE EXTINGUISHED ONE HOUR AFTER THE CLOSE OF BUSINESS,
- EXCEPT AS NEEDED TO PROVIDE FOR MINIMUM SECURITY LEVELS. H. THE CLOSEST BUS STOP IS LOCATED ON THE NORTHWEST SIDE OF THE HOLLY AVE. AND WYOMING BLVD. INTERSECTION; APPROXIMATELY 700 FT.
- J. BUILDING PARAPETS SHALL TOTALLY SCREEN ALL ROOF TOP UNITS AND **EQUIPMENT FROM SIGHT.**
- K. THE MAXIMUM INDIVIDUAL LETTER SIZE OF ALL BUILDING MOUNTED SIGNAGE SHALL NOT EXCEED 2'-0" IN HEIGHT. LOGO DESIGN SIGNS SHALL COMPLY WITH 13R-9 OF THE LA CUEVA SDP. ALL SIGNS SHALL FOLLOW THE LA CUEVA SDP SIGNAGE REGULATIONS.
- L. ALL NEW UTILITIES SHALL BE PLACED UNDERGROUND PER 11R-2 OF THE LA CUEVA SDP.
- M. IF A FREE STANDING SIGN ON LOT 20 IS APPROVED BY ZHE, THE TOTAL SIGN FACE AREA OF BUILDING MOUNTED SIGNS ON LOT 20 SHALL NOT EXCEED 12.5% OF THE TOTAL FACADE AREA FOR THE SOUTHERN ELEVATIONS AND 10% OF THE TOTAL FACADE AREA FOR THE OTHER ELEVATIONS. THE TOTAL SIGN FACE AREA OF EACH TENANT'S BUILDING MOUNTED SIGNS SHALL NOT EXCEED 12.5% OF THE FACADE AREA OF EACH TENANT'S PREMISES FOR SOUTH ELEVATIONS AND 10% FOR OTHER
- N. ALL SIGNAGE TO PROVIDE MINIMUM CONTRAST OF 70% BETWEEN
- P. EXISTING UTILITY EASEMENTS OR RIGHT-OF-WAY SHALL BE DETERMINED IF THEY ARE LOCATED ON OR ADJACENT TO THE PROPERTY AND TO ABIDE BY ANY CONDITIONS OR TERMS OF THOSE EASEMENTS OR AGREEMENTS.
- Q. PNM'S NEW SERVICE DELIVERY DEPARTMENT SHALL BE CONTACTED TO COORDINATE ELECTRIC SERVICE.
- R. SCREENING SHALL BE DESIGNED TO ALLOW ACCESS TO UTILITY FACILITIES. ADEQUATE CLEARANCE SURROUNDING GROUND MOUNTED UTILITIES FOR SAFE OPERATION AND MAINTENANCE SHALL BE 10 FT. FRONT OF DOOR AND 5 FT. ON THE OTHER SIDES
- S. PNM'S NEW SERVICE DELIVERY DEPARTMENT SHALL BE CONTACTED REGARDING COORDINATION OF PROPOSED TREE SPECIES, PLACEMENT. MATURITY HEIGHT, SIGN LOCATION AND HEIGHT, AND LIGHTING HEIGHT IN ORDER TO ENSURE SUFFICIENT SAFETY CLEARANCES AND TO AVOID INTERFERENCE WITH THE EXISTING DISTRIBUTION FACILITIES ALONG PASEO DEL NORTE AND THE SOUTHERN BOUNDARY OF THE SITE.
- USES SHALL COMPLY AT MINIMUM WITH SU-2/MIXED USE ZONING (SECTION 5.4.5, LA CUEVA SDP 2000, REVISED 2003).
- U. THE FREE STANDING SIGN SHOWN ON THE SITE DEVELOPMENT PLAN IS NOT ALLOWED UNLESS A VARIANCE IS OBTAINED FROM THE ZHE.

KEYED NOTES

- 1. TYPICAL PARKING SPACE; 9'-0"x18'-0"
- 2. TYPICAL COMPACT PARKING SPACE: 8'-0"x15'-0"
- 3. TYPICAL ADA PARKING SPACE; 9'-0"x20'-0" 4. TYPICAL MOTORCYCLE PARKING SPACE; 4'-0"x8'-0"
- 5. LANDSCAPED AREA; REFER TO LANDSCAPE PLAN
- 6. ASPHALT PAVING 7. METAL BIKE RACK
- 8. 6'-0" WIDE PEDESTRIAN CROSSWALK. COLOR AND TEXTURE PATTERN TO DIFFERENTIATE FROM SURROUNDING ASPHALT PAVING.
- 9. CONCRETE WHEEL STOP TYPICAL. 10. PROPOSED MONUMENT SIGN; ELEVATIONS SUBMITTED TO ZHE FOR
- APPROVAL.
- 11. EXISTING RETAIL BUILDING
- 12. REFUSE ENCLOSURE FOR SOLID WASTE DISPOSAL; REFER 2/SHT.1 13. REFUSE ENCLOSURE FOR RECYCLABLE MATERIAL DISPOSAL; REFER
- 14. 6'-0" WIDE CONCRETE SIDEWALK TO CONNECT TO EXISTING SIDEWALK
- ALONG STREET.
- 15. 6'-0" WIDE CONCRETE SIDEWALK TO CONNECT TO EXISTING CONCRETE SIDEWALK IN ADJACENT DEVELOPMENT.
- 16. POLE MOUNTED ADA SIGNAGE
- 17. POLE MOUNTED MOTORCYCLE PARKING SIGNAGE
- 18. PAINTED ADA PAVEMENT SIGNAGE
- 19. CONCRETE DRIVEPAD, SEE COA STANDARD DRAWING #2426
- 20. FUTURE SITE INGRESS/EGRESS; CONNECT DRIVE TO HOLLY AVE. THROUGH ADJACENT UNDEVELOPED PROPERTY. CONNECTION WILL ALSO **INCLUDE PEDESTRIAN ACCESS.**
- 21. SITE INGRESS/EGRESS; CONNECT TO EXISTING ADJACENT RETAIL DEVELOPMENT PARKING AREA. ADD CONCRETE CURB AROUND EXISTING FREESTANDING SIGN, CLEAR 24 FT. WIDE DRIVE THROUGH EXISTING STRIPED AREA TO CONNECT TO RETAIL PARKING AREA.
- 22. TEMPORARY ASPHALT CURB.
- 23. CONCRETE CURB
- 24. EXISTING UTILITY POLE
- 25. EXISTING OVERHEAD UTILITIES 26. EXISTING CONCRETE SIDEWALK
- 27. UNDEVELOPED PROPERTY
- 28. CONCRETE STAIRS WITH PAINTED METAL HAND RAIL.
- 29. TEMPORARY ASPHALT PEDESTRIAN PATH 30. EXISITNG 10'-0" PUBLIC UTILITY EASEMENT
- 31. PROPOSED NEW LOT LINE ADJUSTMENT PER THIS SUBMITTAL. 32. NEW 6'-0" WIDE CONCRETE SIDEWALK FRONTING HOLLY AVE.
- 33. NEW CONCRETE ADA RAMP WITH TRUNCATED DOMES PER COA STANDARD DRAWING #2426. 1:12 MAXIMUM SLOPE.
- 34. 6'-0" PEDESTRIAN PATHWAY, COLOR AND TEXTURE PATTERN TO
- DIFFERENTIATE FROM SURROUNDING ASPHALT PAVING. 35. TYPICAL PARKING SPACE FRONTING PASEO DEL NORTE; 9'-0"x16'-0".
- 36. PLAZA AREA WITH BENCHES; 1320 sf TOTAL OUTDOOR SPACE INCLUDING
- RESTAURANT PATIO.
- 37. STEEL TRELLIS ABOVE. 38. COVERED PATIO AREA FOR RESTAURANT.
- 39. LANDSCAPE AREA FOR SHADE TREE.
- 40. CONCRETE CURB CUT FOR WATER RUNOFF STORAGE.
- 41. NEW CONCRETE RAMP; REFER DETAIL 5/SHEET 1.
- 42. SIMILAR NEW CONCRETE RAMP; REFER DETAIL 5/SHEET 1.
- 43. NEW CONCRETE RAMP: REFER DETAIL 4/SHEET 1

SITE DATA

ZONE: SU-2 Mixed Use

GROSS F.A.R. (GBA/SITE AREA):

RETAIL BLDG. (1-STORY) - 8,773sf

RESTAURANT (1-STORY) - 4,400sf

TOTAL SPACES REQUIRED - 94

PARKING PROVIDED: 94 SPACES

ADJACENT RETAIL DEVELOPMENT).

ACCESSIBLE PARKING REQUIRED

ACCESSIBLE PARKING PROVIDED:

MOTORCYCLE PARKING REQUIRED:

MOTORCYCLE PARKING PROVIDED:

4 SPACES, 2 VAN ACCESSIBLE

51-100 SPACES = 3 SPACES

LEGEND

51-100 SPACES = 4 ACCESSIBLE SPACES

PARKING INFORMATION

RETAIL BLDG. (M OCCUP.) - 8,600 net sf/200 = 43 SPACES

RESTAURANT (A-2 OCCUP.) - 4.400sf/204 SEATS (1 PER 4) = 51 SPACES

(MORE SPACES PROVIDED WITH SHARED PARKING AGREEMENT WITH

13.173sf/61.345sf = 0.214

GROSS BUILDING AREA:

TOTAL (GBA) - 13,173sf

PARKING REQUIRED:

SITE AREA: 61,345sf - 1.40 ACRES

LEGAL DESCRIPTION: PART OF LOT 13, LOTS 20 AND 21, BLOCK 10, TRACT 2, UNIT 3, NORTH ALBUQUERQUE ACRES, ALBUQUERQUE, BERNALILLO COUNTY, NEW MEXICO.



architecture interiors landscape planning engineering

7601 Jefferson NE Suite 100 Albuquerque, NM 87109 505 761-9700 fax 761-4222 dps 🕲 dpsdesign.org

PROJECT

50

REVISIONS

DRAWN BY

DATE

REVIEWED BY

PROJECT NO.

DRAWING NAME

1 1/4/2010

POLE MOUNTED PARKING LIGHT: 16'-0" MAX. HEIGHT. RE: DETAIL 3/SHEET 1.

FIRE HYDRANT

POTENTIAL FUTURE PHASE PROPERTY

EXTENT OF CONCRETE WORK

BICYCLE PARKING REQUIRED:


BICYCLE PARKING PROVIDED:

5 SPACES

PROPERTY LINE

BUILDING SETBACK

1:20 AUTOMOBILES = 5 SPACES

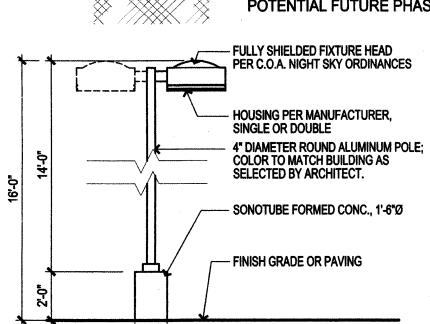

AFD PLANS CHECKING OFFICE

3 LIGHT POLE ELEVATION 1/4" = 1'-0"

FORMER PROJECT NUMBER: 1003532

PROJECT NUMBER: ____1008069

APPLICATION NUMBER: 09EPC-40063/10DRB-70026

This plan is consistent with the specific Site Development Plan approved by the Environmental Planning Commission (EPC), dated December 17, 2009 and the findings and conditions in the official notification of decision are satisfied.

Is an Infrastructure List Required? (X) Yes () No If yes, then a set of approved DRC plans with a work order is required for any construction within Public Right-of-Way or for construction of public

DRB SITE DEVELOPMENT PLAN APPROVAL:

DRB CHAIRPERSON, PLANNING DEPARTMENT

TRAFFIC ENGINEER, TRANSPORTATION DIVISION	DATE
ABCWUA	DATE
PARKS AND RECREATION DEPARTMENT	DATE
<u> </u>	DATE

Kee whate B-1-10 SOLID WASTE MANAGEMENT

DATE

February 2, 2010


09-0055

BUILDING PERMIT

DEVELOPMENT

PLAN FOR

EPC Conditions of Approval

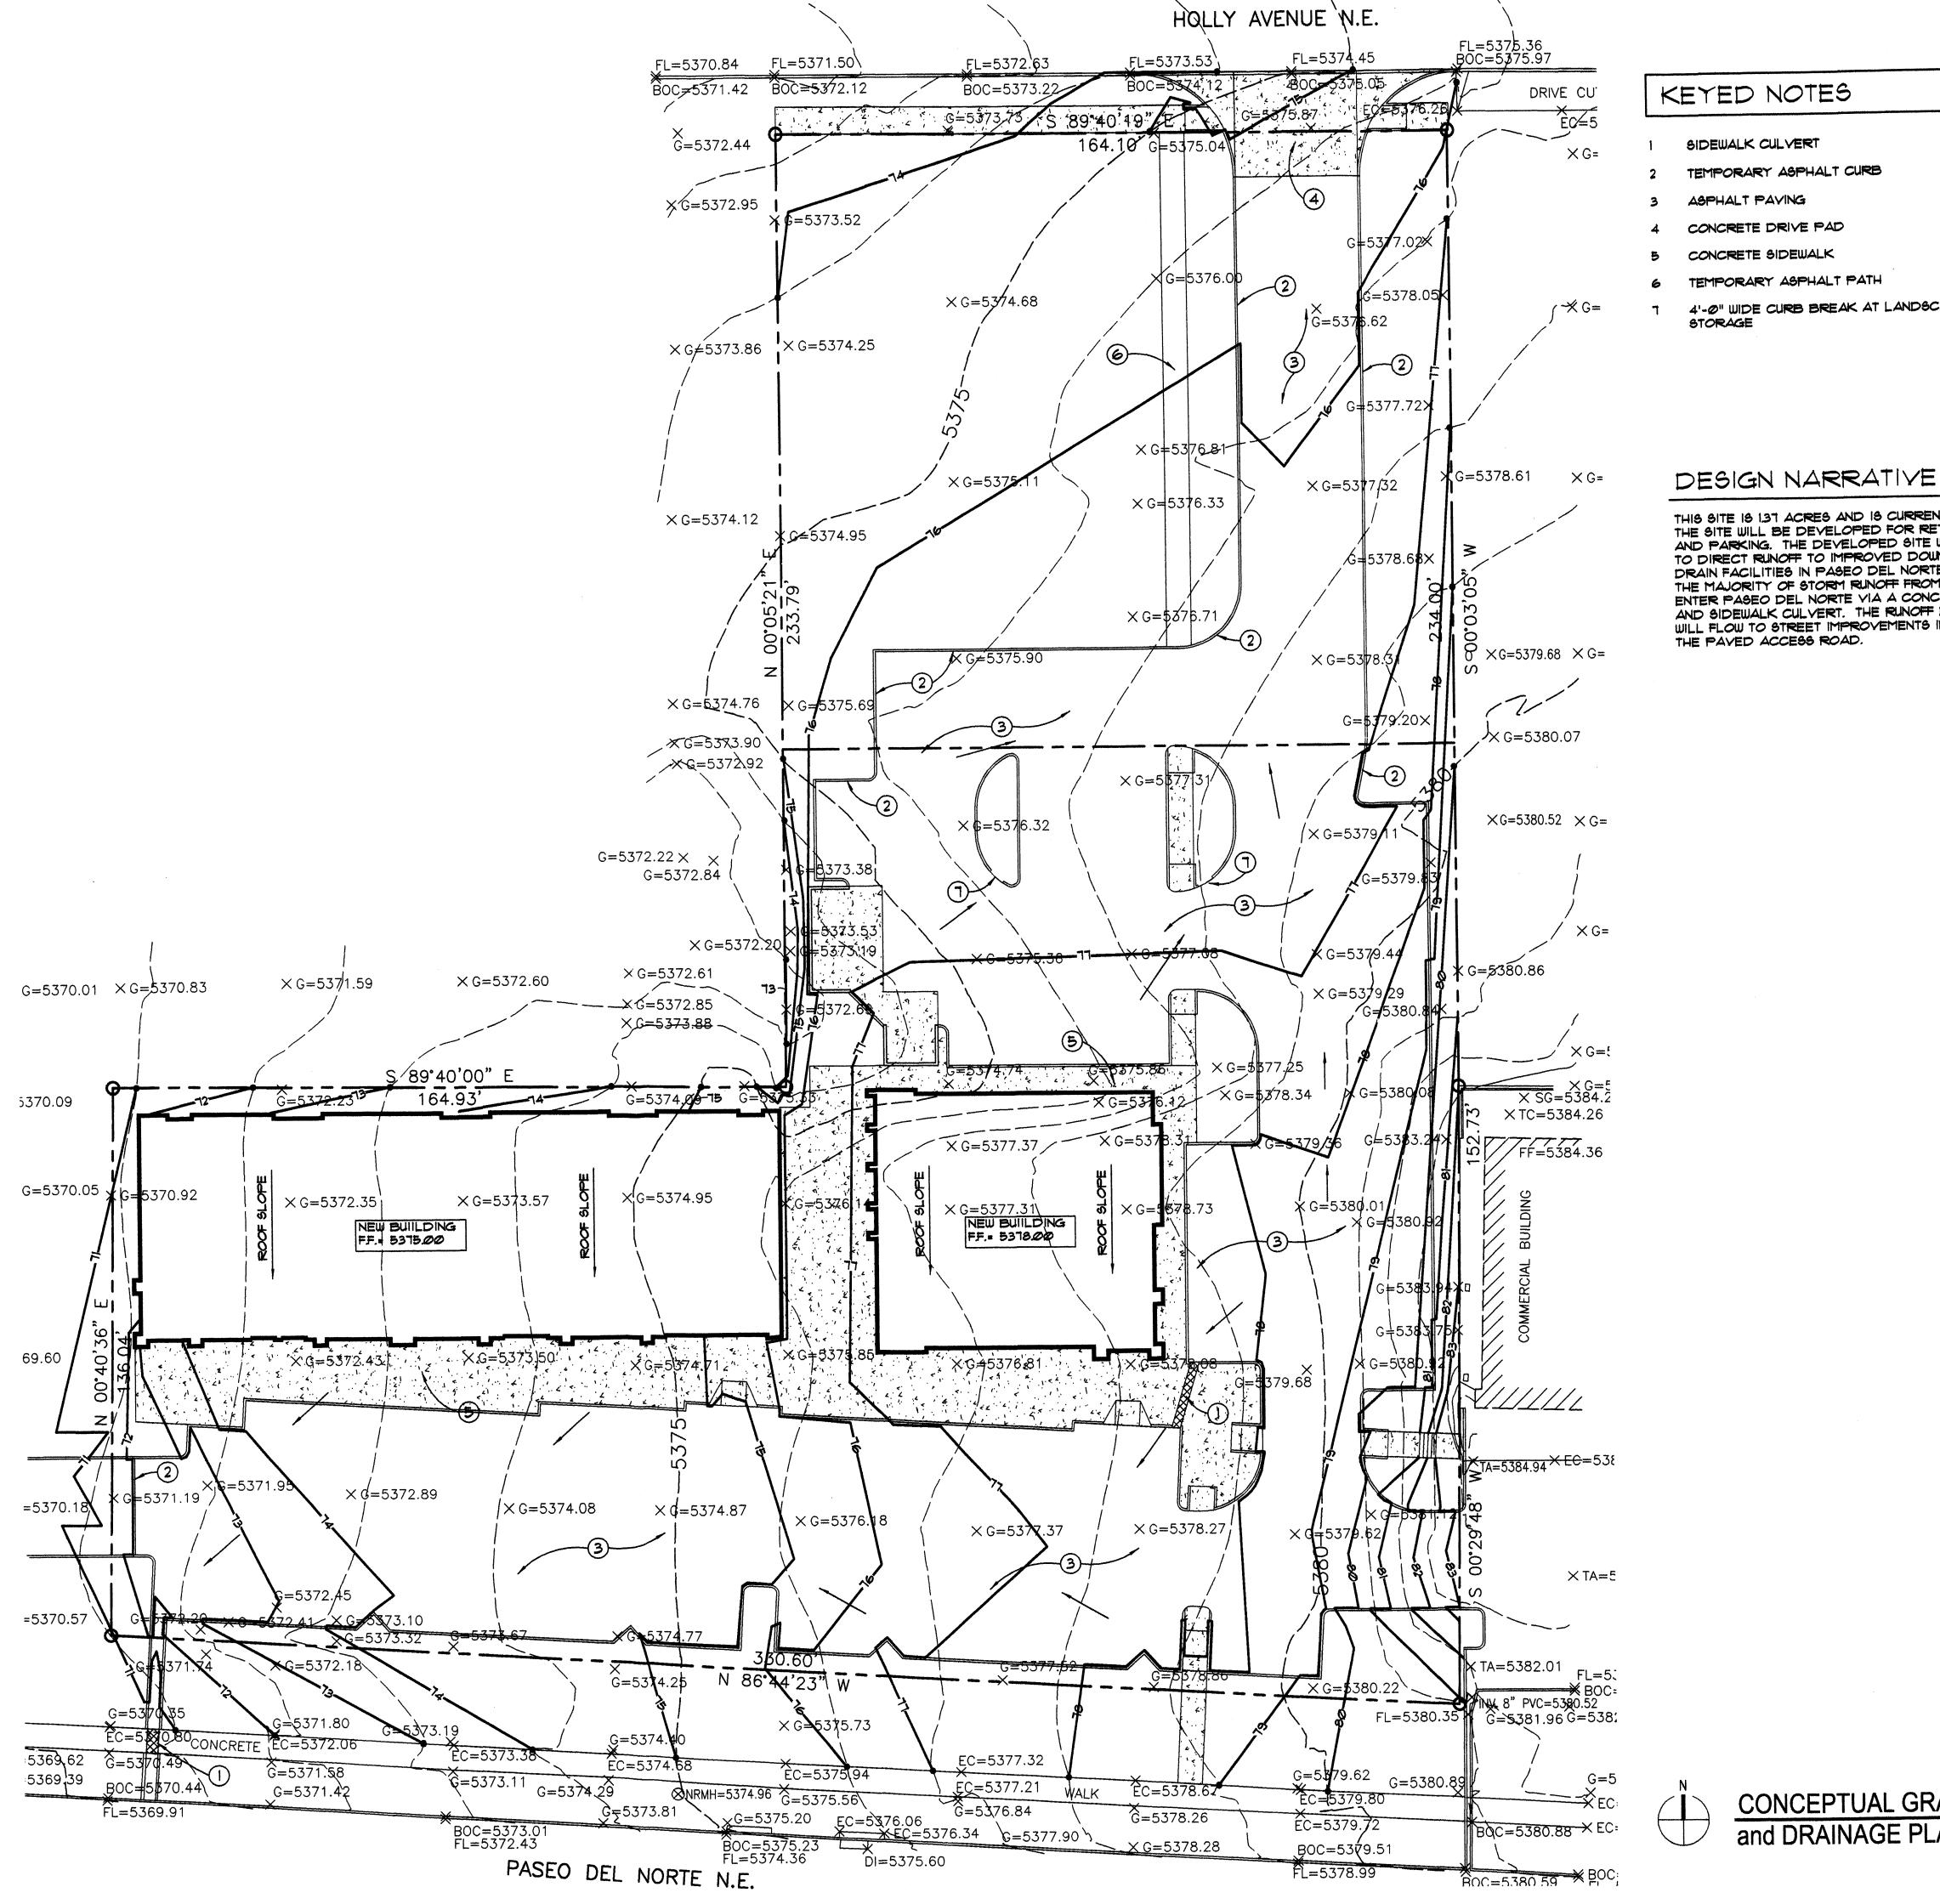


KEYED NOTES

- SIDEWALK CULVERT
- TEMPORARY ASPHALT CURB

المحاجرة الخراج الرابات المحاجرين للبيطين التهاركين

- ASPHALT PAYING
- CONCRETE DRIVE PAD
- CONCRETE SIDEWALK
- TEMPORARY ASPHALT PATH
- 4'-0" WIDE CURB BREAK AT LANDSCAPE ISLAND FOR RUNOFF STORAGE

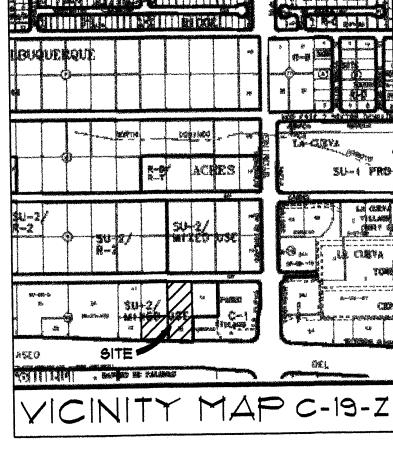

THIS SITE IS 137 ACRES AND IS CURRENTLY UNIMPROVED. THE SITE WILL BE DEVELOPED FOR RETAIL BUILDINGS AND PARKING. THE DEVELOPED SITE WILL BE GRADED TO DIRECT RUNOFF TO IMPROVED DOWNSTREAM STORM DRAIN FACILITIES IN PASEO DEL NORTE AND HOLLY AVE. THE MAJORITY OF STORM RUNOFF FROM THE SITE WILL ENTER PASEO DEL NORTE VIA A CONCRETE RUNDOWN AND SIDEWALK CULVERT. THE RUNOFF DIRECTED NORTH WILL FLOW TO STREET IMPROVEMENTS IN HOLLY AVE. VIA THE PAVED ACCESS ROAD.

CONCEPTUAL GRADING

and DRAINAGE PLAN

LEGAL DESCRIPTION

LOTS 13, 20, AND 21, BLOCK 10, TRACT 2, UNIT 3, NORTH ALBUQUERQUE ACRES, ALBUQUERQUE, BERNALILLO COUNTY, NEW MEXICO

BENCHMARK

ELEVATIONS ARE BASED ON CITY OF ALBUQUERQUE STATION NO. "HEAVEN UNDERGROUND", HAVING AN ELEVATION OF 5278.235

LEGEND

NEW BUILDING LINE 30 - - EXISTING CONTOUR

NEW CONTOUR

NEW SPOT ELEVATION

EXISTING SPOT ELEVATION

NEW FLOW DIRECTION ARROW TOP OF ASPHALT

TOP OF CONCRETE

FINISHED GRADE

NEW CONCRETE PAYING

ROOF DRAIN LOCATION

BACK OF CURB (EXISTING)

NEW AC PAYING


EDGE OF CONCRETE (EXISTING)

GRADE (EXISTING)

FLOW LINE

TOP OF GRATE



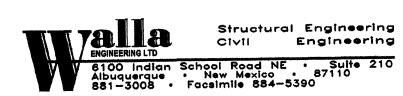

CONCEPTUAL **GRADING** and DRAINAGE PLAN

1 1/4/2010

DRAWN BY

DATE

REVIEWED BY

PROJECT NO.

DRAWING NAME

SHEET NO. C101

LEK

MJW

09-0055

February 2, 2010

architecture

landscape

planning

engineering

7601 Jefferson NE Suite 100

Norte Mexi

Del

Albuquerque, NM 87109


505 761-9700

fax 761-4222

ARCHITECT

dps@dpsdesign.org

1" = 20'-0"

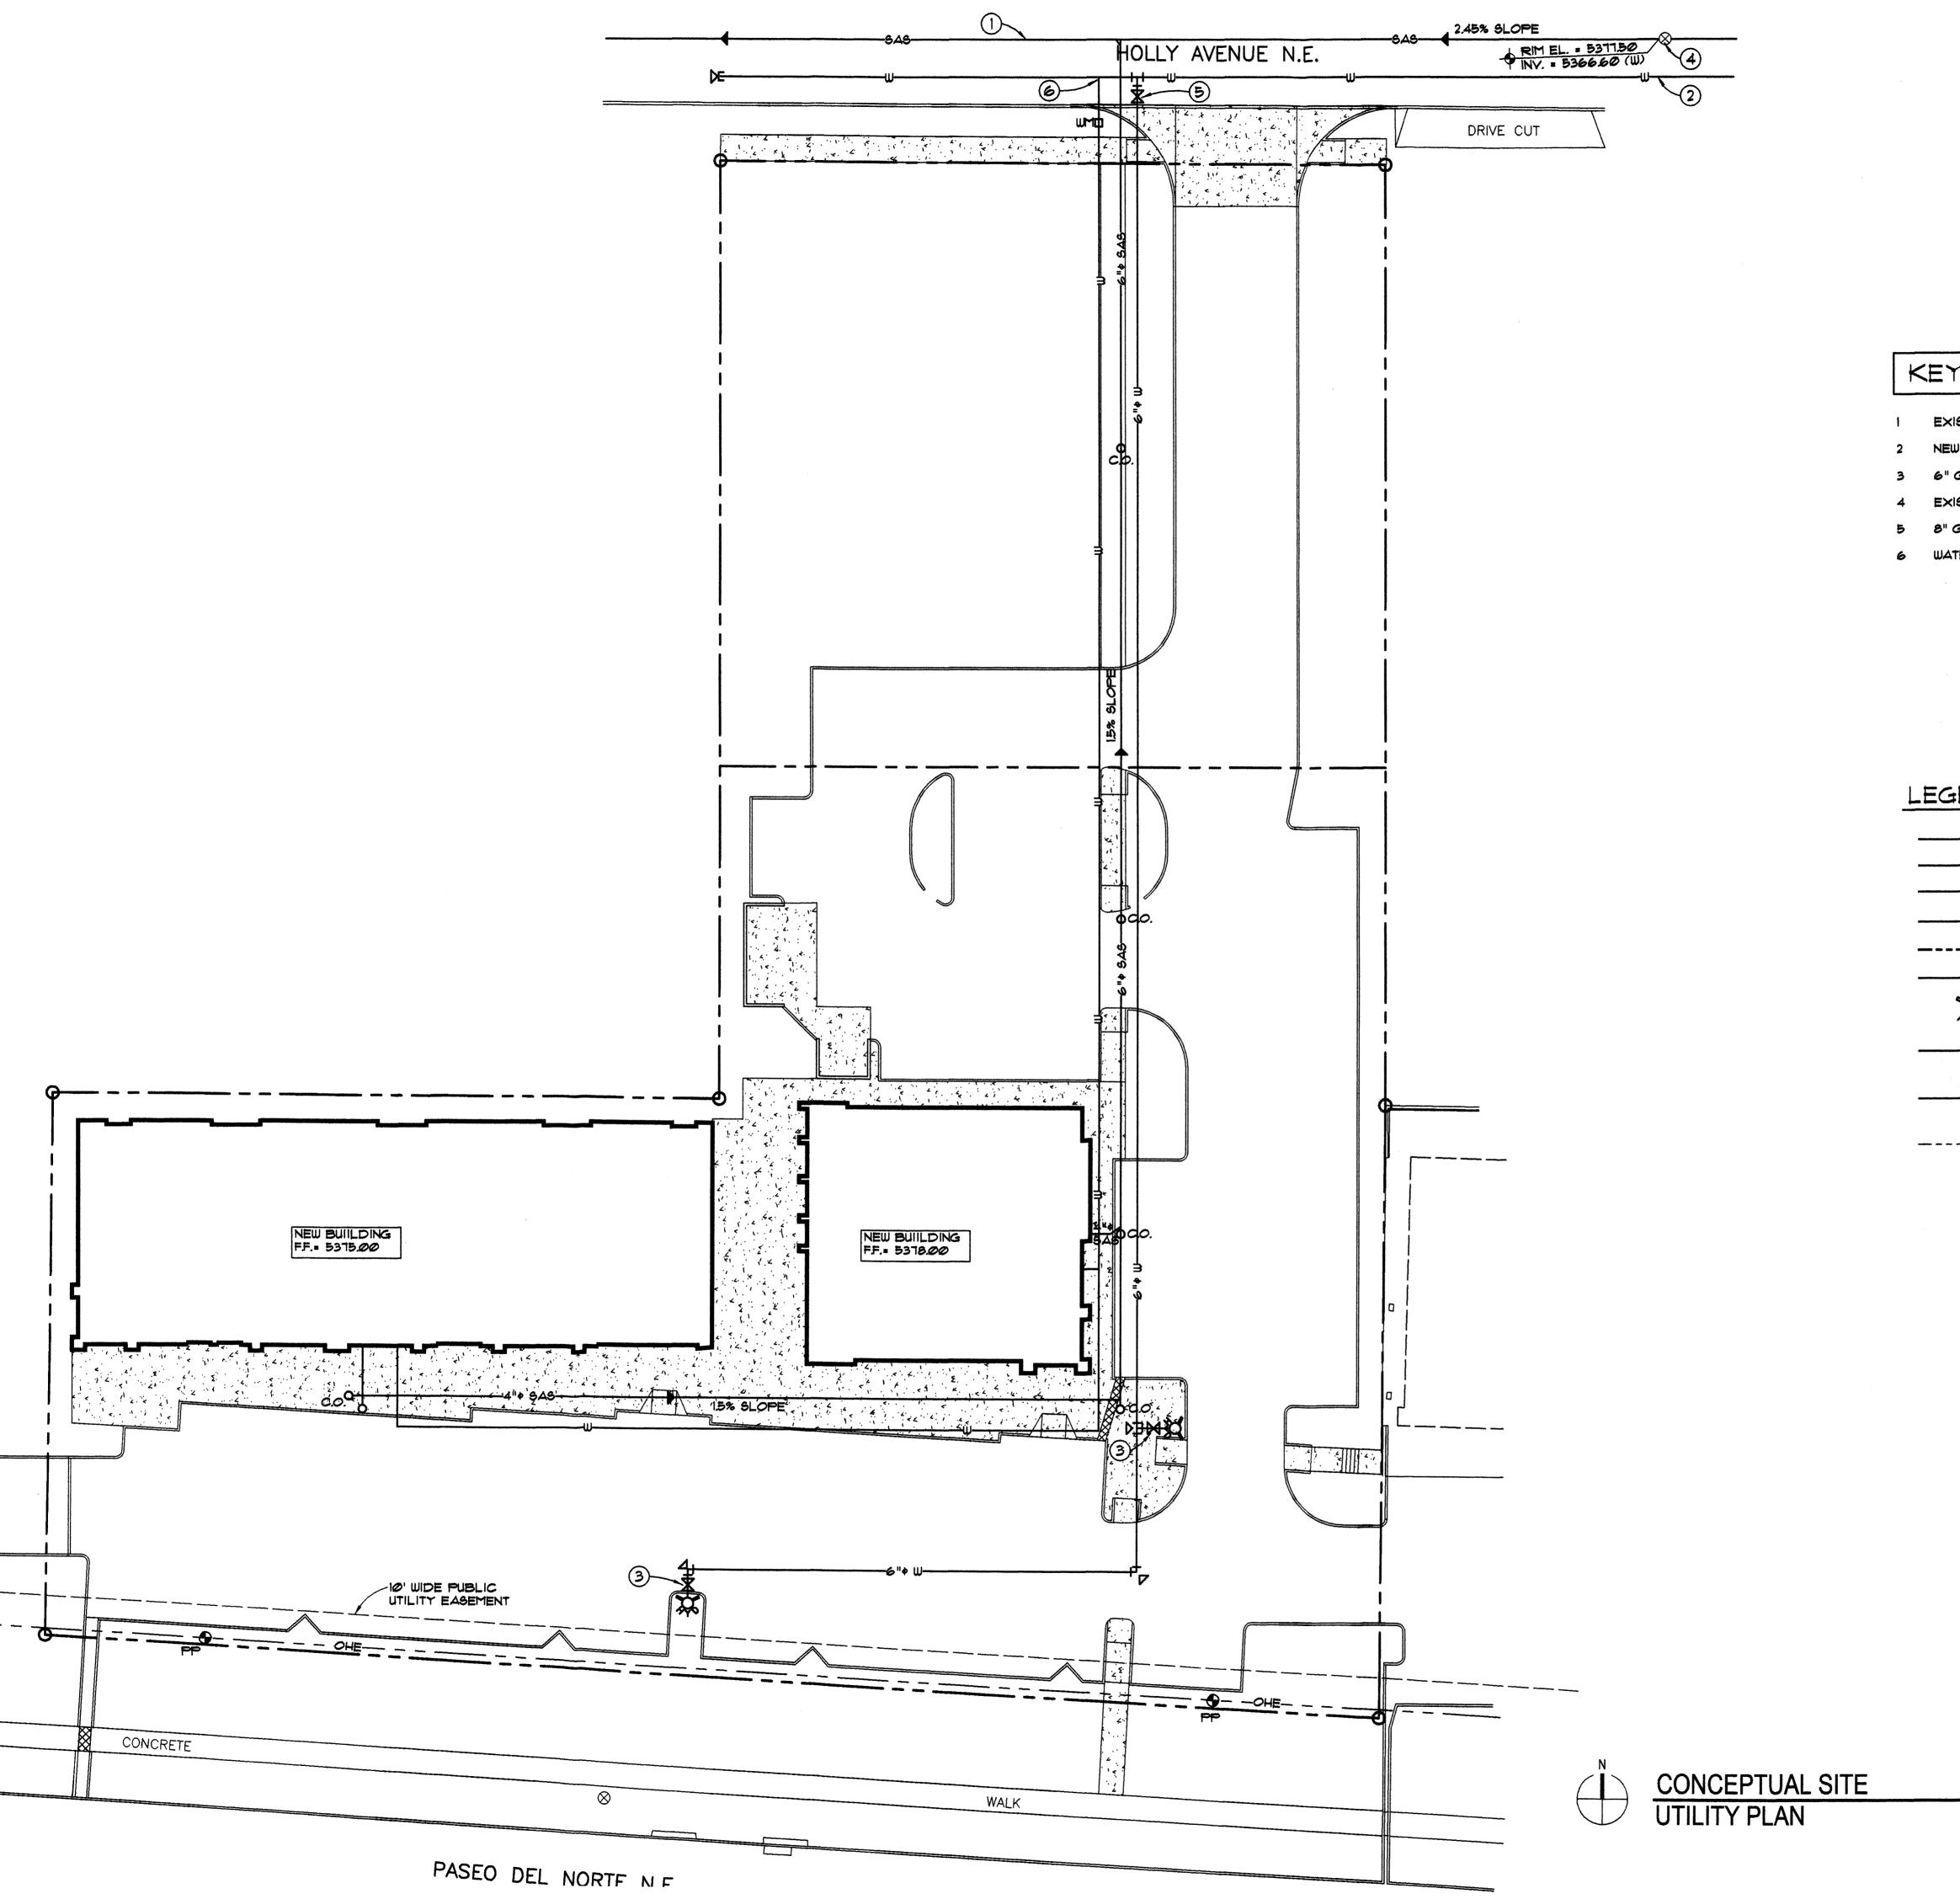

KEYED NOTES

EXISTING 8"4 SANITARY SEWER - PVC

- 2 NEW 8"+ PVC WATER LINE EXTENSION
- 3 6" GATE VALVE AND VALVE BOX
- 4 EXISTING MANHOLE
- 5 8" GATE VALVE AND VALVE BOX
- 6 WATER SERVICE CONNECTION

LEGEND

--- SANITARY SEWER MANHOLE

- SANITARY SEWER LINE

CONCRETE BLOCKING

--- OVERHEAD ELECTRICITY UTILITY

architecture

interiors

landscape

planning engineering

7601 Jefferson NE Suite 100

Albuquerque, NM 87109

505 761-9700 fax 761-4222

ARCHITECT

dps 🕲 dpsdesign.org


REVIEWED BY February 2, 2010 PROJECT NO. DRAWING NAME

CONCEPTUAL

SITE UTILITY PLAN

SHEET NO.

C102

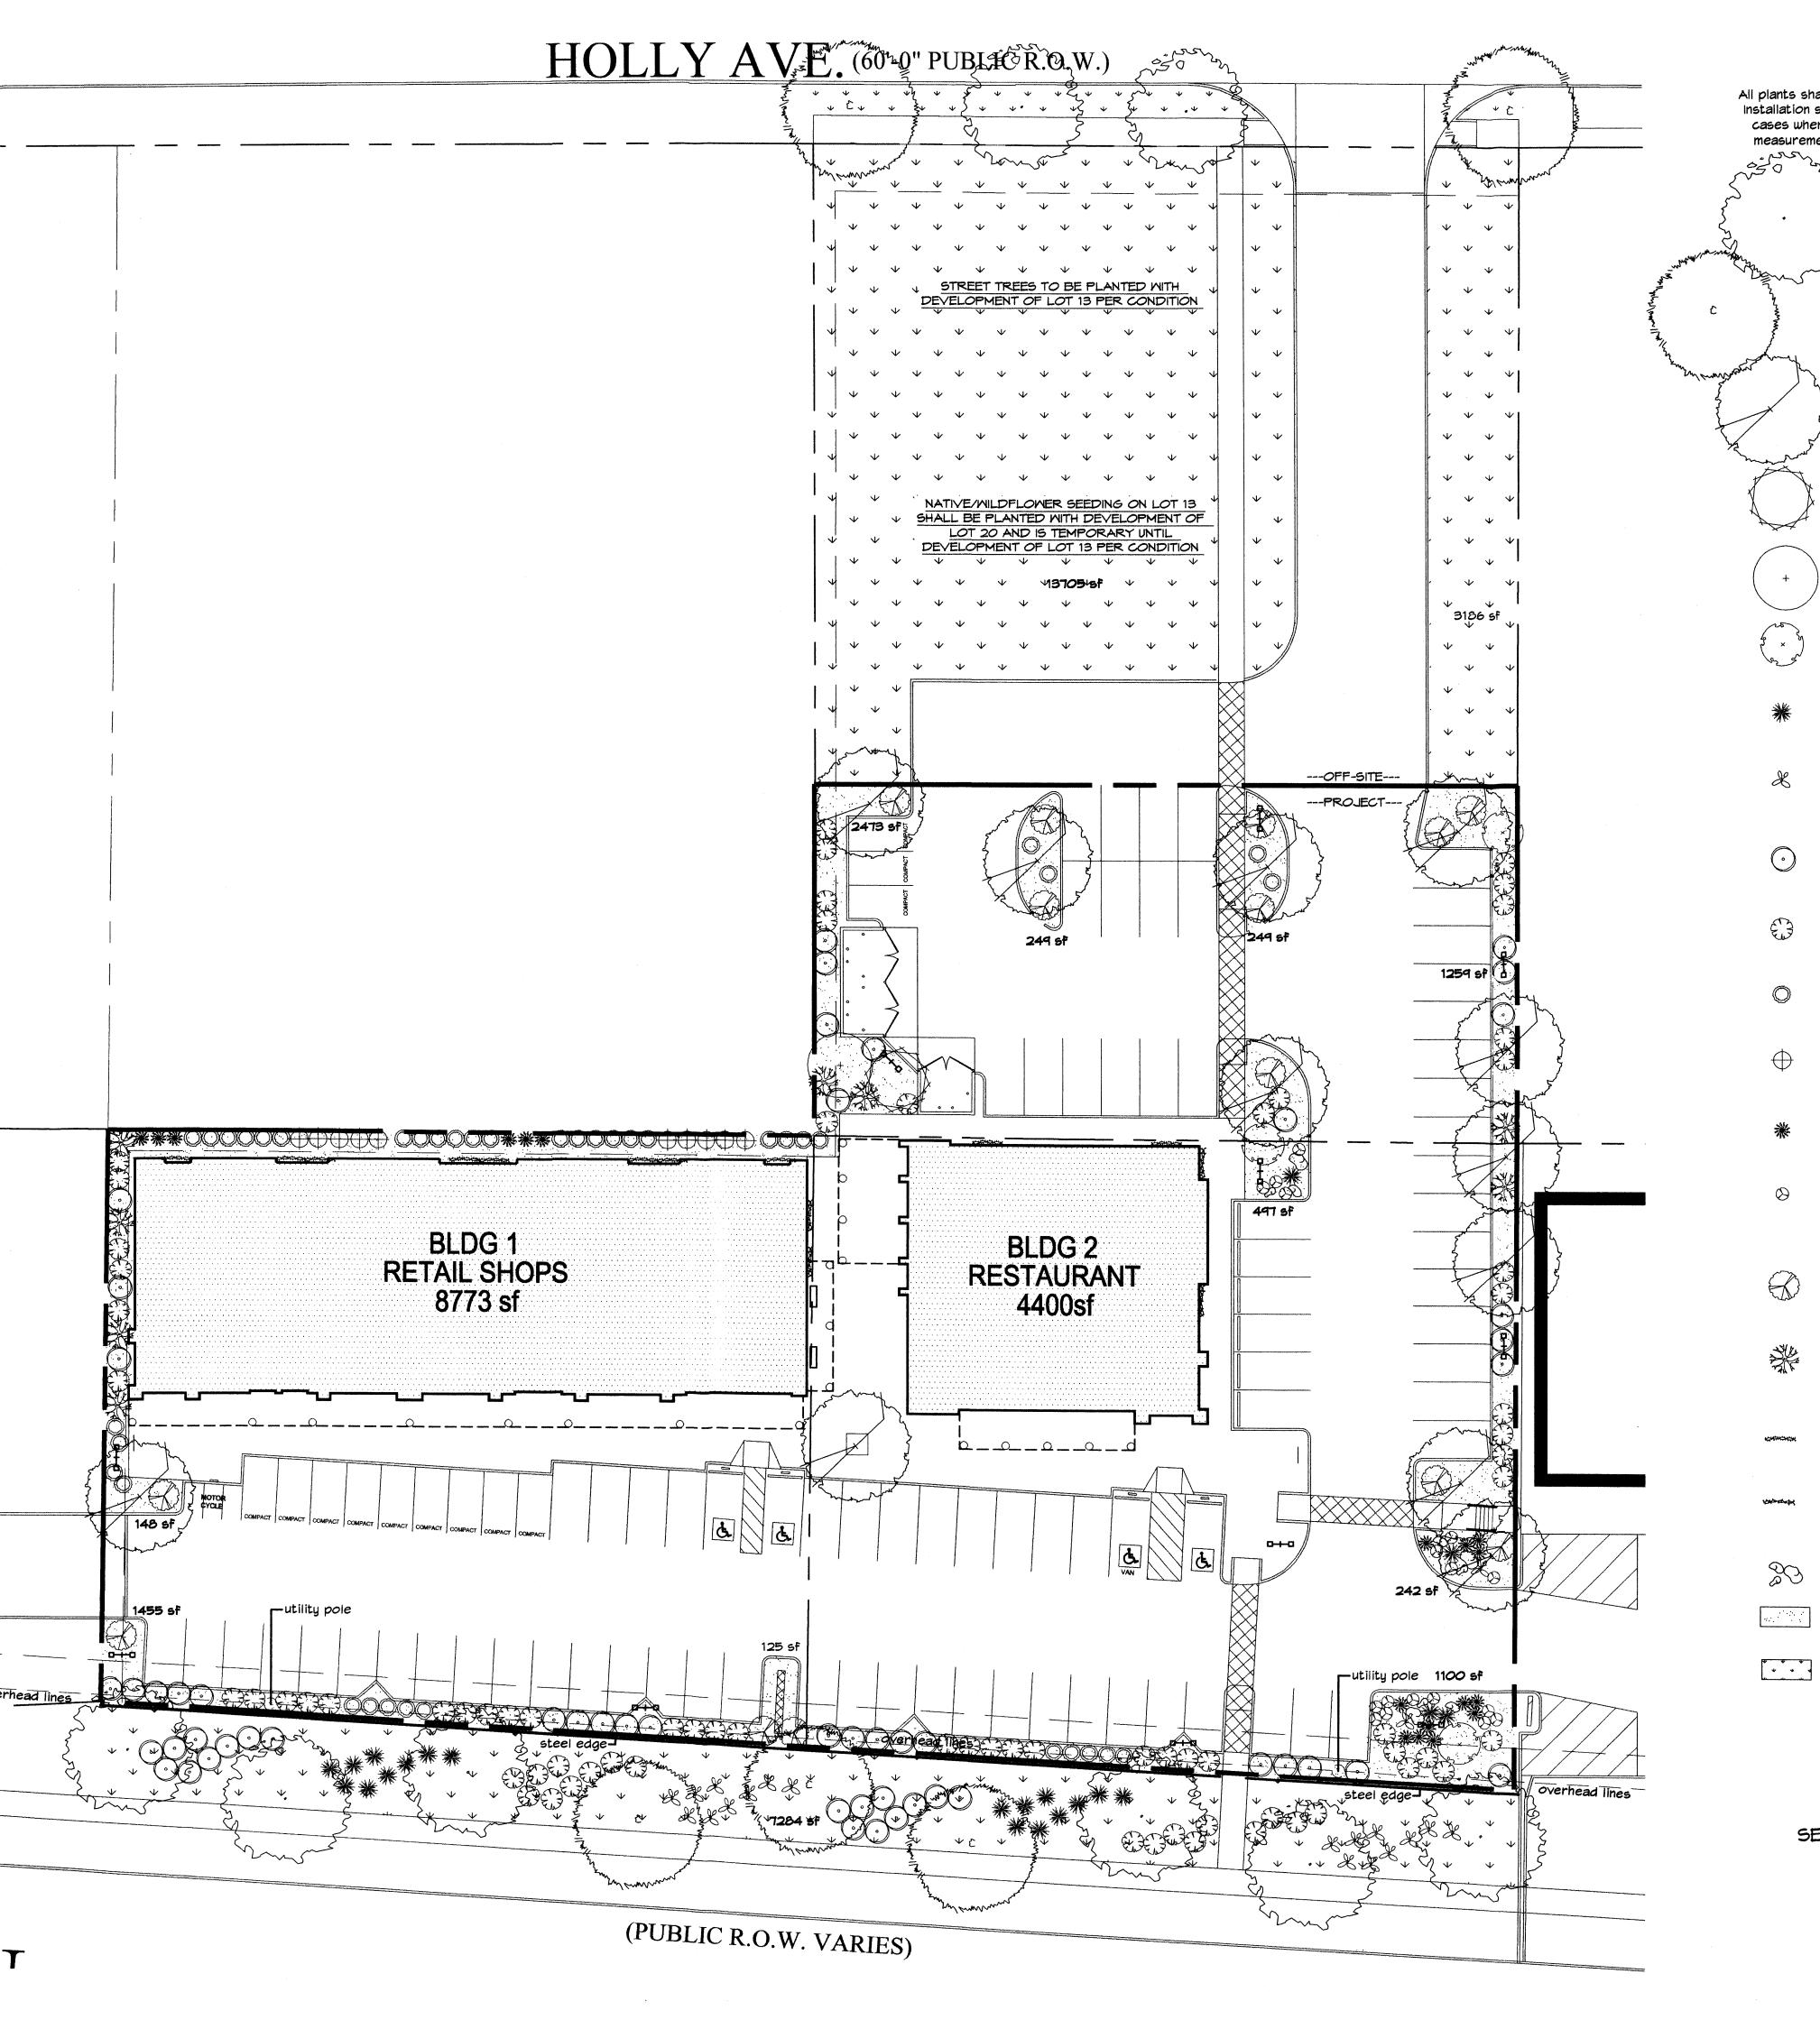

PLANT LEGEND

All plants shall be sized per American Standard for Nursery Stock. Installation size shall indicate the greater of height or spread. In cases where Type O plants have been pruned for rejuvenation, measurement should be by spread of roots rather than by the height of the plant.

• DENOTES EVERGREEN PLANT MATERIAL

STREET SHADE TREES AUTUMN PURPLE ASH 6 Fraxinus americana 2" Cal., 12'-14' inst./60' x 60' maturity Water (M) Allergy (H) Osf

BUR OAK 3 Quercus macrocarpa 2" Cal., 12'-14' inst./ 60' x 60' maturity Water (M) Allergy (M) Osf

PARKING LOT SHADE TREE CHINESE PISTACHE 12 Pistachia chinensis 2" Cal., 8'-10' Inst./40' x 30' maturity Water (M) Allergy (L) Osf

SHRUBS DESERT MILLOW 1 Chilopsis linearis 5 Gal., 4'-10' Inst./20' × 25' maturity Water (L+) Allergy (L) 225sf

NEW MEXICO OLIVE 1 Forestiera neomexicana 5 Gal., 4'-10' Inst./15' x 15' maturity Mater (M) Allergy (L) 225sf BUTTERFLY BUSH 3

Buddleia davidii 5 Gal., 12"-3' Inst./10' × 10' maturity Water (M) Allergy (L) 100sf • RED YUCCA 22 Hesperaloe parviflora

5 Gal., 18"-3' Inst./3' x 4' maturity Water (L+) Allergy (L) 16sf

* PRICKLY PEAR 20 Opuntia macrocentra 5 Gal., 12"-3' Inst./3' x 3' maturity Water (L) Allergy (L) 95f

* SPANISH BROOM 53 Genista hispanica 5 Gal., 2'-4' Inst./4' x 4' maturity Mater (M) Allergy (L) 16sf

* BROOM BACCHARIS 72 Baccharis sarothroides 5 Gal., 2'-4' Inst./10' x 10' maturity Mater (L+) Allergy (L) 100sf

* TURPENTINE BUSH 40 Ericameria laricifolia 1 Gal., 6"-15" Inst./3' x 4' maturity Water (L+) Allergy (L) 16sf

POTENTILLA 10 Potentilla fruticosa 1 Gal., 6"-15" Inst./3' \times 3' maturity Water (M+) Allergy (L) 9sf

BLUE AVENA/OAT GRASS 18 Helictotrichon sempervirens 1 Gal., 3"-15" Inst./2' x 1' maturity Water (M) Allergy (L) 1sf

MILDFLOWER 17 1 Gal., 3"-15" Inst./varies at maturity Water (varies) Allergy (varies) 4sf

GROUNDCOVERS * HONEYSUCKLE 14 Lonicera japonica 'Halliana' 1 Gal., 6"-15" Inst./3' x 12' maturity Mater (M) Allergy (L) 144sf Unstaked-Groundcover

MINTER JASMINE 8 Jasminum nudiflorum 1 Gal., 6"-15" Inst./4' x 6' maturity Water (L+) Allergy (L) 36sf

* ENGLISH IVY 9 Hedera helix 1 Gal., 6"-15" Inst./climbing to 40' Mater (M) Allergy (L)

* BANK'S ROSE 5 Rosa banksiae 1 Gal., 6"-15" Inst./climbing to 20' Mater (M) Allergy (L)

HARDSCAPES OVERSIZED GRAVEL 4 9 BOULDERS

3/4" GRAY GRAVEL WITH FILTER FABRIC TO A MINIMUM 3" DEPTH

> UN-IRRIGATED CRIMP STRAWNATIVE SEED AND WILDFLOWERS (SEEDED BETWEEN MAY 15TH-SEPTEMBER

PLANT LEGEND OFF-SITE

All plants shall be sized per American Standard for Nursery Stock. Installation size shall indicate the greater of height or spread. In cases where Type O plants have been pruned for rejuvenation, measurement should be by spread of roots rather than by the

height of the plant.

* DENOTES EVERGREEN PLANT MATERIAL STREET SHADE TREES- TO BE PLANTED WITH DEVELOPMENT OF LOT 13 PER CONDITION AUTUMN PURPLE ASH 2 Fraxinus americana 2" Cal., 12'-14' Inst./60' x 60' maturity Mater (M) Allergy (H) Osf

BUR OAK 2 Quercus macrocarpa 2" Cal., 12'-14' Inst./ 60' × 60' maturity Water (M) Allergy (M) Osf


CRIMP STRAWNATIVE SEED AND WILDFLOWERS (SEEDED BETWEEN MAY 15TH-SEPTEMBER 15TH, FOR BEST GERMINATION). LOT 13 SEED SHALL BE WATERED MANUALLY TO ENSURE 75% LIVE GROUNDCOVER

GENMINATION.

architecture interiors landscape planning

engineering

7601 Jefferson NE Suite 100 Albuquerque, NM 87109 505 761-9700 fax 761-4222 dps@dpsdesign.org

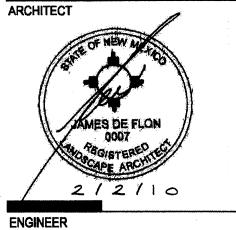

Nort Mex 50 Ŏ 0 asi

DRAWN BY rmc 8-3-09 REVIEWED BY cmj February 2, 2010

PROJECT NO. DRAWING NAME

LANDSCAPE PLAN

cm j@hilltoplandscaping.com SHEET NO.

Cont. Lic. #26458 7909 Edith N.E.

Albuquerque, NM 87184 Ph. (505) 898-9690 Fax (505) 898-7737

All creative ideas contained Herein remains the property of The Hilltop Landscape Architects and


for Nursery Stock.

ntractors and are protected by copyright laws. This is an original design and must not be released or copied unless applicable fees have been paid or job order placed. All plants shall be sized per American Standard

L001

SEE SHEET LOO2 FOR NOTES, DETAILS AND CALCULATIONS

SCALE: 1"=20'

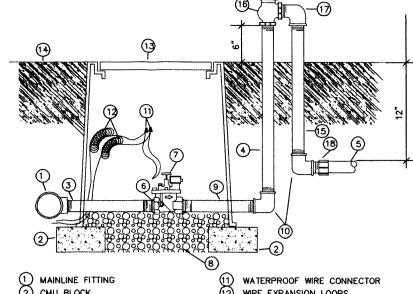

CMU BLOCK GALVANIZED NIPPLE) 24" TO 36" GALVANIZED NIPPLE LATERAL PIPE REDUCER BUSHING AUTOMATIC VALVE (SEE LEGEND) GRAVEL GALVANIZED NIPPLE 10) GALVANIZED ELBOW

and the same of th

WIRE EXPANSION LOOPS 3) VALVE BOX 4) FINISH GRADE GALVANIZED NIPPLE - 18" TO 24" LENGTH ATMOSPHERIC VACUUM BREAKER (7) GALVANIZED STREET ELL (18) TOE NIPPLE OR MALE ADAPTER

GRAYEL ACCENT DETAIL

GRAVEL TYPE PER PLAN


OVERSIZED GRAVEL ACCENT AT EVERY BOULDER CLUSTER

PLANTING PER PLAN

40-50 SQUARE FEET

BOULDER

AUTOMATIC VALVE W/ ATMOSPHERIC VACUUM BREAKER

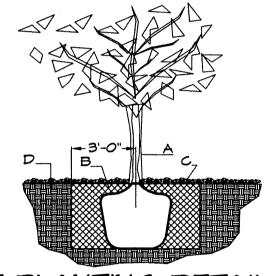

Netafim Spiral Detail

TREE PLANTING DETAIL

NTS

GENERAL NOTES:

1. ROOTBALL SHALL BE PLACED ON UNDISTURBED SOIL 1. THE OUTSIDE DIAMETER OF THE WATER TO PREVENT TREE FROM SETTLING. 2. TOP OF ROOT COLLAR INDICATED LEVEL AT WHICH TREE WAS GROWN AND DUG; THIS REPRESENTS THE LEVEL


AT WHICH THE TREE SHOULD BE INSTALLED; THAT LEVEL CONSTRUCTION NOTES: MAY BE EXCEEDED BY ONLY A ONE INCH LAYER OF SOIL. A. SHRUB 3. PRIOR TO BACKFILLLING TREE, ALL MIRE, ROPE AND SYNTHETIC MATERIALS SHALL BE REMOVED FROM THE TREE AND THE PLANTING PIT.

4. PRIOR TO BACKFILLING ALL BURLAP SHALL BE CUT AWAY EXCEPT FROM BOTTOM OF THE ROOTBALL.

CONSTRUCTION NOTES:

A. TREE

B. BACKFILL WITH EXISTING SOIL. C. 3" DEPTH OF GRAVEL MULCH.

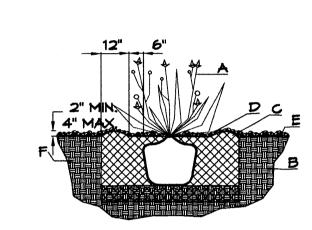

SHRUB PLANTING DETAIL

GENERAL NOTES:

RETENTION BASIN SHALL BE TWICE THE DIAMETER OF THE SHRUB PLANTING PIT.

B. BACKFILL WITH EXISTING SOIL.

C. EARTH BERM AROUND WATER RETENTION BASIN.

D. 3" DEPTH OF GRAVEL MULCH. F. UNDISTURBED SOIL.

D. UNDISTRUBED SOIL.

LANDSCAPE NOTES: Landscape maintenance shall be the responsibility of the Property Owner. The Property Owner shall maintain street trees in a living, healthy, and

It is the intent of this plan to comply with the City Of Albuquerque Water Conservation Landscaping and Water Waste Ordinance planting restriction approach. Approval of this plan does not constitute or imply exemption from water waste provisions of the Water Conservation Landscaping and Water Maste Ordinance.

Mater management is the sole responsibility of the Property Owner. All landscaping will be in conformance with the City of Albuquerque Zoning Code, Street Tree Ordinance, Pollen Ordinance, and Mater Conservation Landscaping and Water Waste Ordinance. In general, water conservative, environmentally sound landscape principles will be followed in design and

Plant beds shall achieve 75% live ground cover at maturity.

3/4" Crushed Grey Gravel over Filter Fabric to a minimum depth of 3" shall be nplaced in all landscape areas which are not designated to receive native

IRRIGATION NOTES:

attractive condition.

Irrigation shall be a complete underground system with Trees to receive 1 Netafim spiral (50' length) with 3 loops at a final radius of 4.5' from tree trunk, pinned in place. Netafim shall have emitters 12" o.c. with a flow of .6 aph. Shrubs to receive (2) 1.0 GPH Drip Emitters. Drip and Bubbler systems to be tied to 1/2" polypipe with flush caps at each end. Trees and shrubs shall be on separate valves.

Run time per each shrub drip valve will be approximately 15 minutes per day. Tree drip valve shall run 1.5 hours, 3 times per week. Run time will be adjusted according to the season.

Point of connection for irrigation system is unknown at current time and will be coordinated in the field. Irrigation will be operated by automatic controller.

Location of controller to be field determined and power source for controller to be provided by others.

Irrigation maintenance shall be the responsibility of the Property Owner.

Mater and Power source shall be the responsibility of the Developer/Builder.

LANDSCAPE CALCULATIONS

TOTAL OFFSITE LANDSCAPE PROVIDED

TOTAL LOT AREA	61345	- square feet
TOTAL BUILDINGS AREA	13173	square feet
NET LOT AREA	48172	square feet
LANDSCAPE REQUIREMENT	15%	-
TOTAL LANDSCAPE REQUIREMENT	7225	square feet
TOTAL BED PROVIDED		square feet
GROUNDCOVER REQ.	T5%	square feet
TOTAL GROUNDCOVER REQUIREMENT	5847	square feet
TOTAL GROUNDCOVER PROVIDED		square feet
TOTAL NATIVE SEED AREA	7284	_ square feet
TOTAL LANDSCAPE PROVIDED	15081 (31%)	_ square feet
TOTAL OFFSITE BED PROVIDED TOTAL OFFSITE NATIVE SEED PROVIDED	<i>O</i> 16891	square feet square feet

square feet

STREET TREE REQUIREMENTS - Minimum 2" Caliper

Required # 9 Provided # 9

Required # 4 Provided # 4

PARKING LOT TREE REQUIREMENTS - Minimum 2" Caliper

1 Shade tree per 10 spaces Required # 10 Provided # 12

NOTE TO CLIENT:

Should The Hilltop not receive a Grading and Drainage plan during the design process or the on-site grades differ from the Grading and Drainage plan received, The Hilltop reserves the right to apply slope stabilization materials where the specified gravel will not be suitable. Gravel smaller than 2-4" cobblestone will not stay on a slope greater than 3:1. If the grades are greater than what was originally designed, we will request an infield change-order to lay cobblestone or rip-rap, in lieu of the specified gravel, to stabilize the slope. All vegetative material shall remain per plan.

NATIVE SEED MIX-STANDARD COA MIX

EAST OF RIVER MIX:	
COMMON NAME	PLS/ACRI
"PALOMA" INDIAN RICE GRASS	3.0
"VIVA" GALLETA GRASS	3.0
"NINER" SIDEOATS GRAMA	3.0
"HATCHITA" BLUE GRAMA	5.0
SAND DROPSEED	2.0
FOURMIND SALTBUSH	2.0

Street trees required under the City Of Albuquerque Street Tree Ordinance are as follows:

Name of Street: Paseo del Norte

Name of Street: Holly

Shade trees required under the City Of Albuquerque Parking Lot Tree Ordinance are as follows:

SEED AND WILDFLOWERS (SEEDED BETWEEN MAY 15TH-SEPTEMBER

PLANT LEGEND

STREET SHADE TREES

BUR OAK 3 Quercus macrocarpa

PARKING LOT SHADE TREE

Water (M) Allergy (L) Osf

CHINESE PISTACHE 12 Pistachia chinensis

SHRUBS

DESERT WILLOW Chilopsis linearis

NEW MEXICO OLIVE 1 Forestiera neomexicana

BUTTERFLY BUSH 3 Buddleia davidii

* RED YUCCA 22 Hesperaloe parviflora

* PRICKLY PEAR 20 Opuntia macrocentra

* SPANISH BROOM 53 Genista hispanica

AUTUMN PURPLE ASH 6

All plants shall be sized per American Standard for Nursery Stock.

cases where Type O plants have been pruned for rejuvenation,

measurement should be by spread of roots rather than by the

height of the plant.

Fraxinus americana
2" Cal., 12'-14' Inst./60' x 60' maturity
Water (M) Allergy (H) Osf

2" Cal., 12'-14' Inst. / 60' x 60' maturity Mater (M) Allergy (M) Osf

2" Cal., 8'-10' Inst./40' x 30' maturity

5 Gal., 4'-10' inst./20' x 25' maturity Water (L+) Allergy (L) 225sf

5 Gal., 4'-10' Inst./15' x 15' maturity Water (M) Allergy (L) 225sf

5 Gal., 12"-3' Inst./10' x 10' maturity Water (M) Allergy (L) 100sf

5 Gal., 18"-3' Inst./3' x 4' maturity Mater (L+) Allergy (L) 16sf

5 Gal., 12"-3' Inst./3' x 3' maturity Mater (L) Allergy (L) 9sf

5 Gal., 2'-4' Inst./4' x 4' maturitu

5 Gal., 2'-4' Inst./10' x 10' maturity

Water (L+) Allergy (L) 100sf

1 Gal., 6"-15" Inst./3' x 4' maturity

1 Gal., 6"-15" inst./3' x 3' maturity

Mater (L+) Allergy (L) 16sf

Water (M+) Allergy (L) 9sf

BLUE AVENA/OAT GRASS 18 Helictotrichon sempervirens

Mater (M) Allergy (L) 1sf

1 Gal., 3"-15" Inst./2' x 1' maturity

MILDFLOMER 17 1 Gal., 3"-15" Inst./varies at maturity

Water (varies) Allergy (varies) 4sf

1 Gal., 6"-15" Inst./3' x 12' maturity Mater (M) Allergy (L) 144sf

1 Gal., 6"-15" Inst./4' × 6' maturity

Hedera helix
1 Gal., 6"-15" Inst./climbing to 40'

1 Gal., 6"-15" Inst./climbing to 20'

Water (L+) Allergy (L) 36sf

Water (M) Allergy (L) 16sf

* BROOM BACCHARIS 72

Baccharis sarothroides

* TURPENTINE BUSH 40 Ericameria iaricifolia

POTENTILLA 10

Potentilla fruticosa

GROUNDCOVERS

HONEYSUCKLE 14

Unstaked-Groundcover

MINTER JASMINE 8 Jasminum nudiflorum

* ENGLISH MY 9

Mater (M) Allergy (L)

Mater (M) Allergy (L)

OVERSIZED GRAVEL

3/4" GRAY GRAVEL

MITH FILTER FABRIC TO A MINIMUM 3" DEPTH

* BANK'S ROSE 5

Rosa banksiae

HARDSCAPES

4 9 BOULDERS

Lonicera japonica 'Halliana'

* DENOTES EVERGREEN PLANT MATERIAL

Installation size shall indicate the greater of height or spread. In

ST OF RIVER MIX:	
MMON NAME	PLS/ACRE
LOMA" INDIAN RICE GRASS	3.0
VA" GALLETA GRASS	3. <i>0</i>
NER" SIDEOATS GRAMA	3. <i>0</i>
TCHITA" BLUE GRAMA	5. <i>0</i>
ND DROPSEED	2.0
IRWIND GAI TRUGH	20

TOTAL RATE 18.0 LBS/AC

NATIVE SEED MIX ADD-IN: HIGH DESERT WILDFLOWER MIX

TOTAL RATE 2.0 LBS/AC

UN-IRRIGATED CRIMP STRAWNATIVE

SEED MIX INCLUDES: PURPLE ASTER, DESERT MARIGOLD, ROCKY MTN BEEPLANT, PLAINS COREOPSIS, BROOM DALEA, MEXICAN GOLD POPPY, FIREWHEEL, BLANKETFLOWER, BLUE FLAX, DESERT FOUR O'CLOCK, MEXICAN EVENING PRIMROSE. SAND PENSTEMON, WILD PINK SNAPDRAGON. CALIFORNIA BLUEBELLS, MEXICAN HAT AND YELLOW PRAIRIE CONEFLOWER. HEIGHT 2-3'

PLANT LEGEND OFF-SITE

All plants shall be sized per American Standard for Nursery Stock. Installation size shall indicate the greater of height or spread. In cases where Type O plants have been pruned for rejuvenation, measurement should be by spread of roots rather than bu the

height of the plant. * DENOTES EVERGREEN PLANT MATERIAL STREET SHADE TREES- TO BE PLANTED WITH DEVELOPMENT OF LOT 13 PER CONDITION AUTUMN PURPLE ASH 2 Fraxinus americana 2" Cal., 12'-14' Inst./60' x 60' maturity Mater (M) Allergy (H) Osf

BUR OAK 2 Quercus macrocarpa 2" Cal., 12'-14' Inst. / 60' x 60' maturity Water (M) Allergy (M) Osf


CRIMP STRAWNATIVE SEED AND WILDFLOWERS (SEEDED BETWEEN MAY 15TH-SEPTEMBER 15TH, FOR BEST GERMINATION), LOT 13 SEED SHALL BE WATERED MANUALLY TO ENSURE 75% LIVE GROUNDCOVER GENMINATION.



architecture interiors landscape planning

engineering

7601 Jefferson NE Suite 100 Albuquerque, NM 87109 505 761-9700 fax 761-4222 dps @ dpsdesign.org

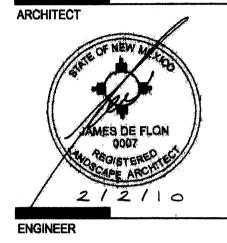

Norte Mexi 50 Del 0 4 O S 4 **Albuquerq**

EPC Conditions of Approva

DRAWN BY rmc 8-3-09 REVIEWED BY cmj February 2, 2010 PROJECT NO. 09-0055

DRAWING NAME

REVISIONS

<u>/1</u>\ 1/4/2010

LANDSCAPE ARCHITECTS & CONTRACTORS

All creative ideas contained Herein remains the

property of The Hilltop Landscape Architects and

an original design and must not be released or copied unless applicable fees have been paid or job order placed. All plants shall be sized per American Standard

for Nursery Stock.

GRAPHIC SCALE

SCALE: 1"=20'


10


LANDSCAPE PLAN Cont. Lic. #26458 7909 Edith N.E.

Albuquerque, NM 87184 Ph. (505) 898-9690 Fax (505) 898-7737

SHEET NO. cm i@hilltoplandscaping.com Contractors and are protected by copyright laws. This is

_002

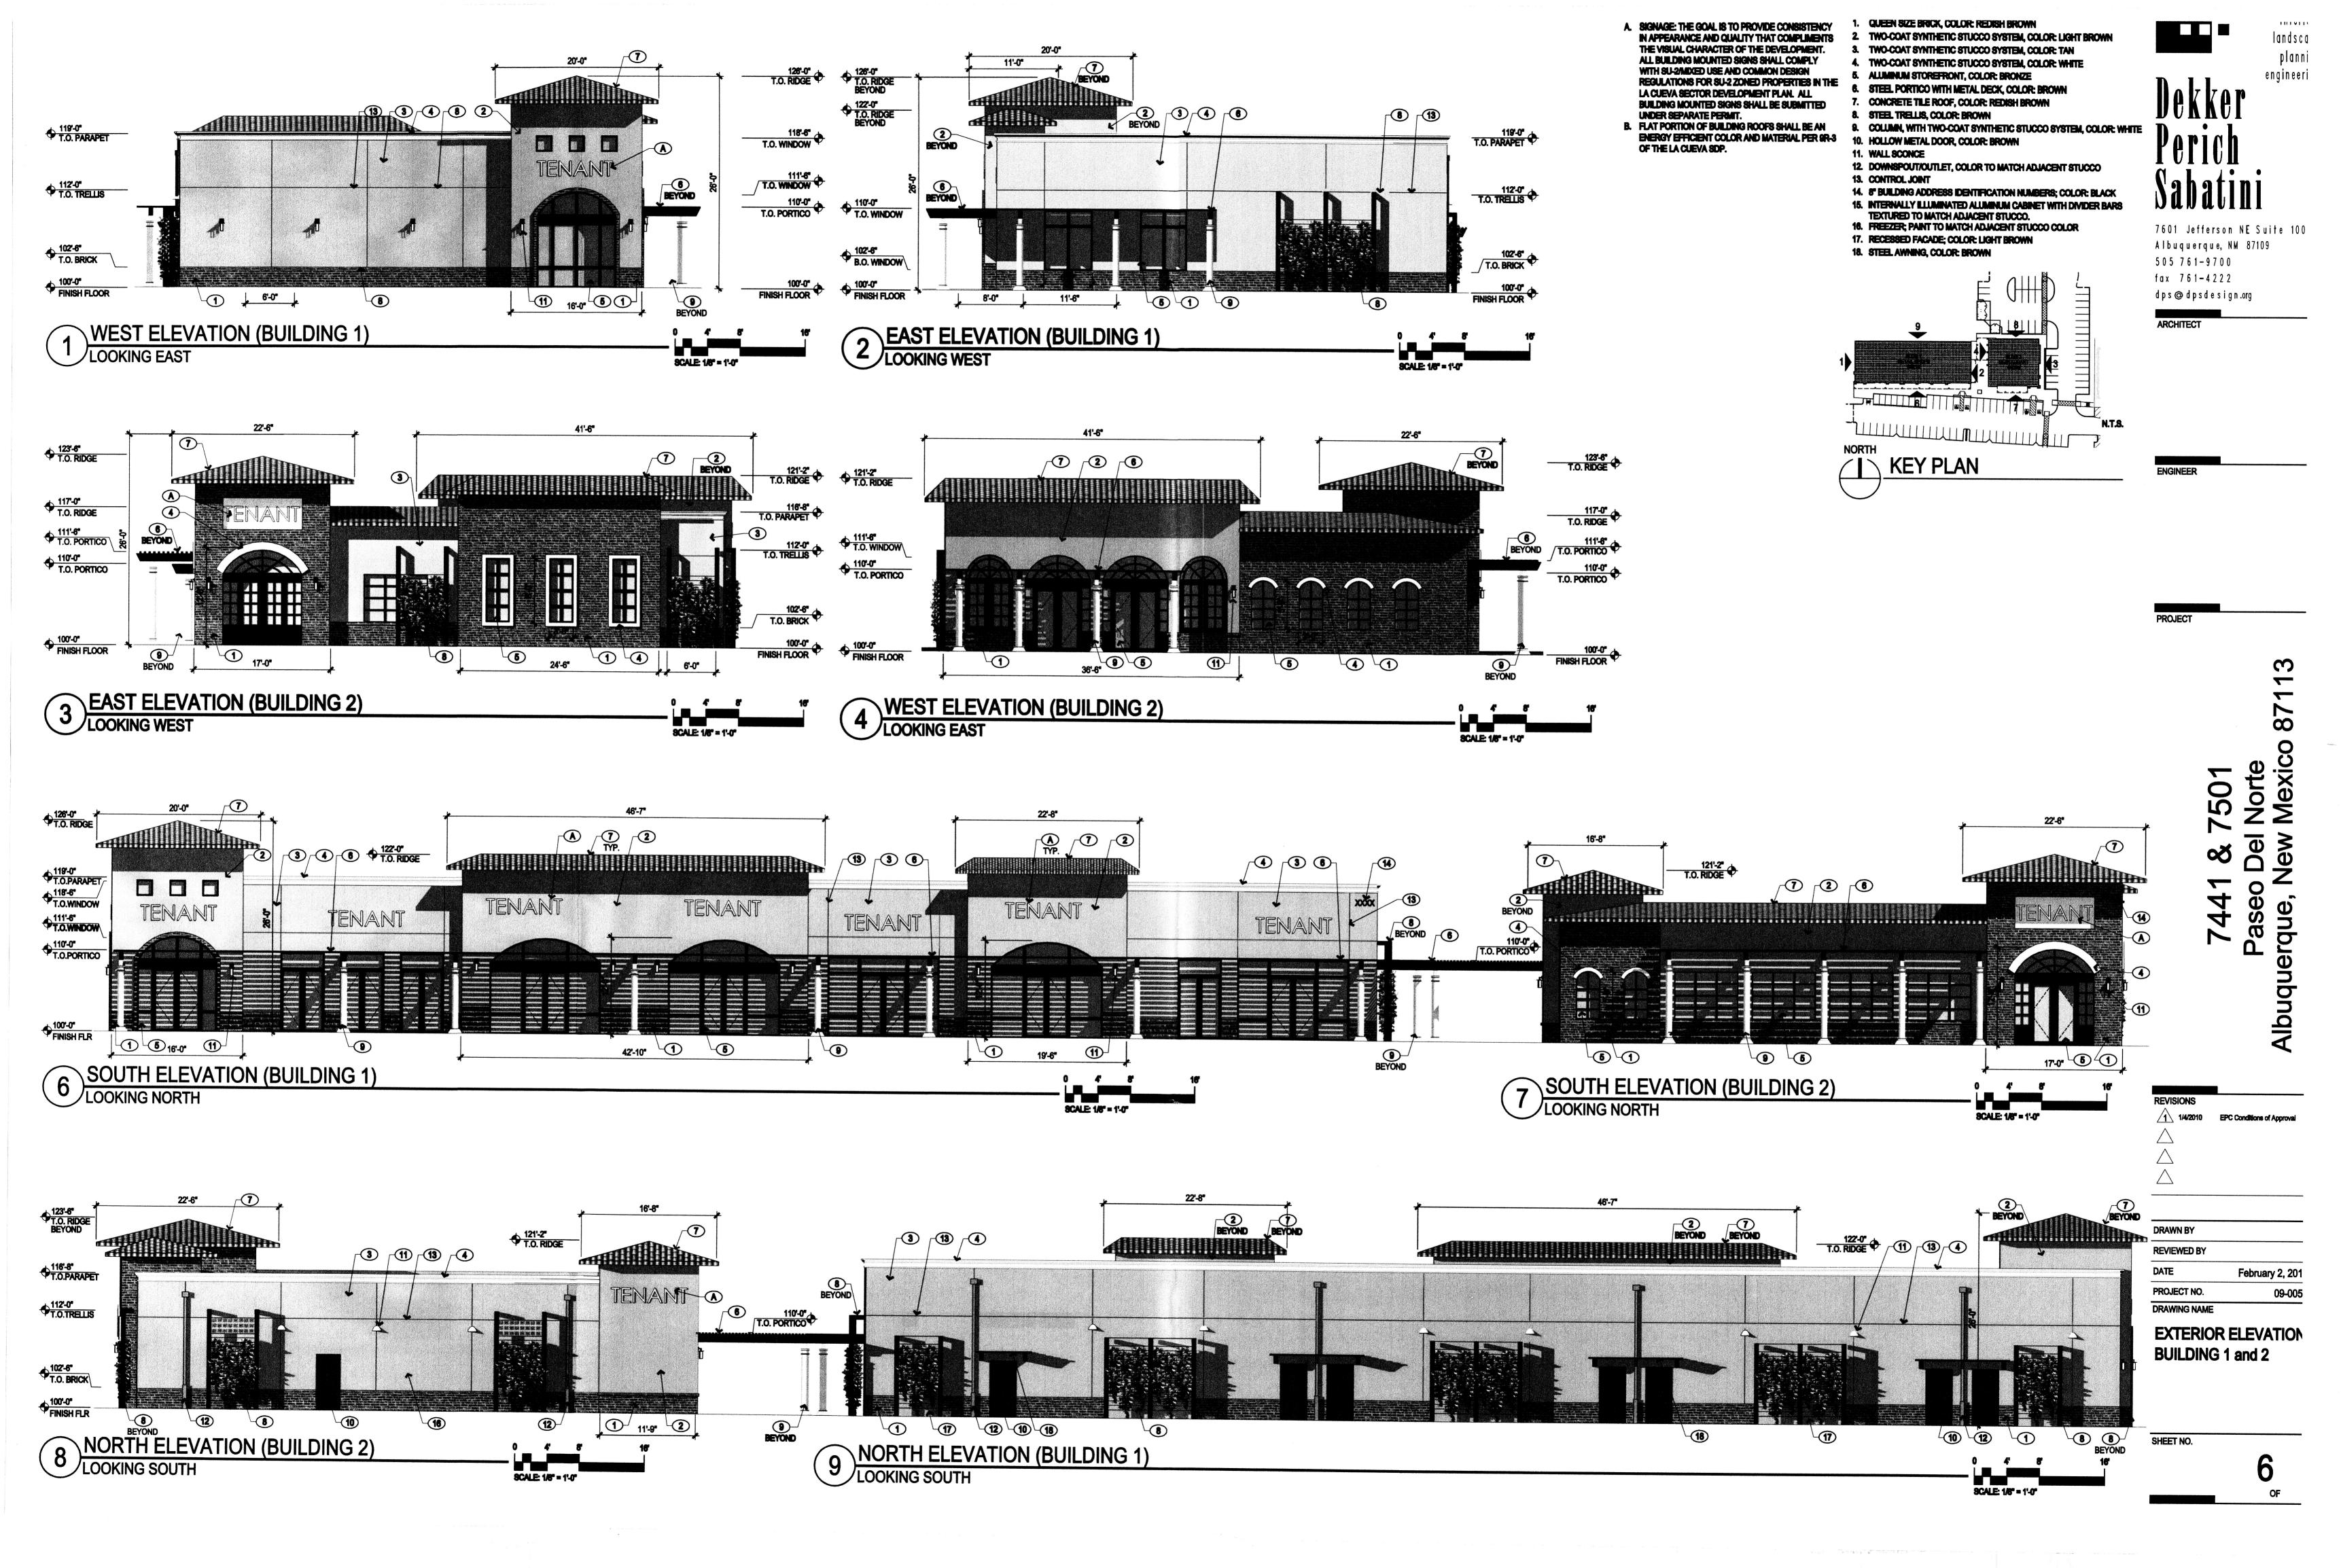

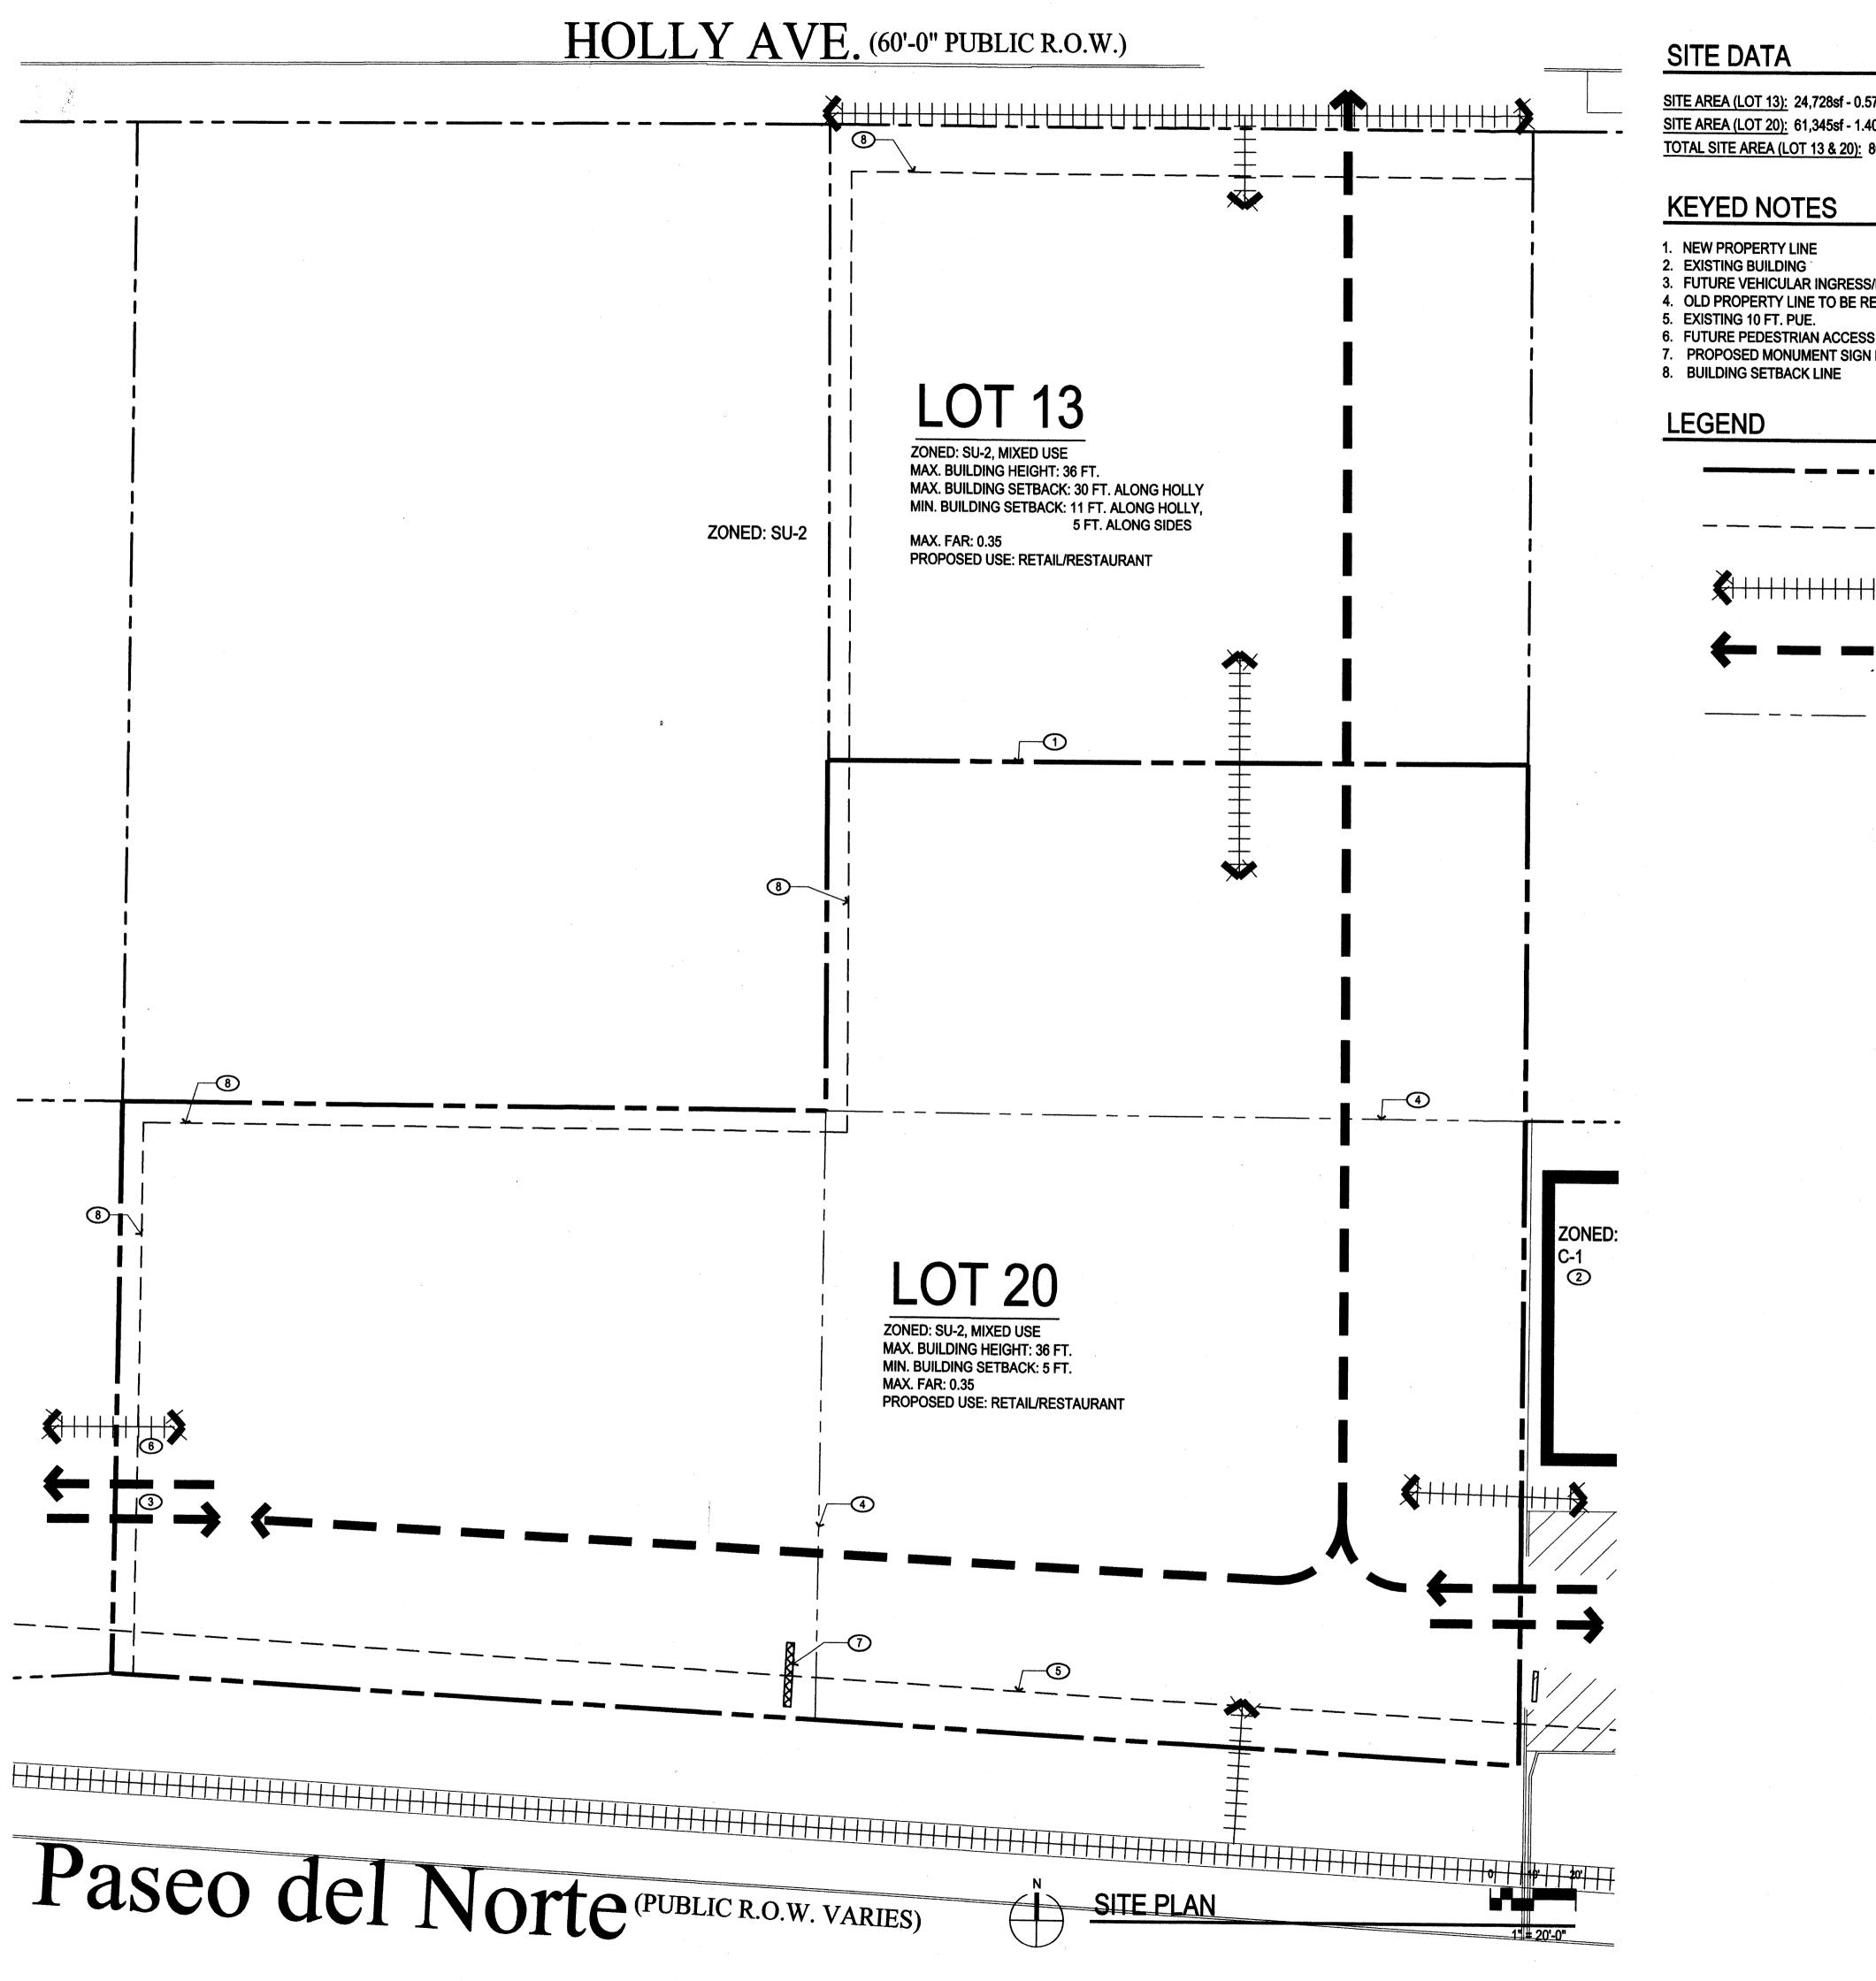

SITE DATA

SITE AREA (LOT 13): 24,728sf - 0.57 ACRES SITE AREA (LOT 20): 61,345sf - 1.40 ACRES TOTAL SITE AREA (LOT 13 & 20): 86,073sf - 1.97 ACRES

KEYED NOTES

- 1. NEW PROPERTY LINE
- 2. EXISTING BUILDING
- 3. FUTURE VEHICULAR INGRESS/EGRESS 4. OLD PROPERTY LINE TO BE REMOVED
- 5. EXISTING 10 FT. PUE.
- 7. PROPOSED MONUMENT SIGN LOCATION
- 8. BUILDING SETBACK LINE

LEGEND

PROPERTY LINE

BUILDING SETBACK/PUE

PEDESTRIAN INGRESS/EGRESS

VEHICULAR INGRESS/EGRESS

OLD PROPERTY LINE

GENERAL NOTES

A. REFER TO CONCEPTUAL UTILITY PLAN FOR PROPOSED AND EXISTING WATER, SEWER, AND STORM DRAINAGE.

B. PLEASE REFER TO SITE DEVELOPMENT PLAN FOR BUILDING PERMIT (#1008069, 09EPC-40063) FOR FURTHER INFORMATION ON ARCHITECTURAL BUILDING DESIGN STYLE AND SIGNAGE. BUILDING AND SIGNAGE HEIGHT. MASS, COLOR, MATERIALS, AND ARTICULATION CAN BE REFERENCED FROM BUILDING AND SIGNAGE ELEVATIONS. SIGNAGE FACE AREA AND LIGHTING INFORMATION CAN BE FOUND ADDITIONALLY IN THIS SUBMITTAL.

C. THE REMAINDER OF LOT 13 SHALL BE DEVELOPED IN A FUTURE PHASE ACCORDING TO A SITE DEVELOPMENT PLAN APPROVED BY THE EPC PER THE LA CUEVA SDP (2000, REV. 2003). THE SITE DEVELOPMENT PLAN INCLUDING PEDESTRIAN CIRCULATION, BUILDING ORINETATION, ARCHITECTURE AND SIGNAGE, SHALL BE DESIGNED TO COORDINATE WITH THE DEVELOPMENT OF LOT 20 TO FORM A COHESIVE RETAIL CENTER.

D. SITE PLAN SHALL COMPLY AND BE DESIGNED PER DPM STANDARDS. E. SITE PLAN SHALL COMPLY WITH THE SU-2, SU-2/MIXED USE ZONE AND COMMON DESIGN REGULATIONS (SECTIONS 5.4, 5.4.5, 5.4.6, LA CUEVA

SECTOR DEVELOPMENT PLAN 2000, REVISED 2003). SIGNAGE: THE GOAL IS TO PROVIDE CONSISTENCY IN APPEARANCE AND QUALITY THAT COMPLIMENTS THE VISUAL CHARACTER OF THE DEVELOPMENT. ALL BUILDING MOUNTED SIGNS SHALL COMPLY WITH SU-2/MIXED USE AND COMMON DESIGN REGULATIONS FOR SU-2 ZONED PROPERTIES IN THE LA CUEVA SECTOR DEVELOPMENT PLAN, ALL BUILDING MOUNTED SIGNS SHALL BE SUBMITTED UNDER SEPARATE

G. THE MAXIMUM INDIVIDUAL LETTER SIZE OF ALL BUILDING MOUNTED SIGNAGE SHALL NOT EXCEED 2'-0" IN HEIGHT. LOGO DESIGN SIGNS SHALL COMPLY WITH 13R-9 OF THE LA CUEVA SDP. ALL SIGNS SHALL FOLLOW THE LA CUEVA SDP SIGNAGE REGULATIONS.


H. IF A FREE STANDING SIGN ON LOT 20 IS APPROVED BY THE ZHE, THE TOTAL SIGN FACE OF BUILDING MOUNTED SIGNS ON LOT 20 SHALL NOT EXCEED 12.5% OF THE TOTAL FACADE AREA FOR THE SOUTHERN ELEVATIONS AND 10% OF THE TOTAL FACADE AREA FOR THE OTHER ELEVATIONS. THE TOTAL SIGN FACE AREA OF EACH TENANT'S BUILDING MOUNTED SIGNS SHALL NOT EXCEED 12.5% OF THE FACADE AREA OF EACH TENANT'S PREMISES FOR SOUTH ELEVATIONS AND 10% FOR OTHER **ELEVATIONS.**

ALL SIGNAGE TO PROVIDE MINIMUM CONTRAST OF 70% BETWEEN

GRAPHICS AND BACKGROUND PER ADA.

J. IF A FREE STANDING SIGN ON LOT 20 IS APPROVED BY THE ZHE THAT INCLUDES ADVERTISING FOR TENANTS ON LOT 13, THE TOTAL SIGN FACE OF BUILDING -MOUNTED SIGNS ON LOT 13 SHALL NOT EXCEED 10% OF THE TOTAL FACADE AREA.

K. THE FREE STANDING SIGN SHOWN ON THE SITE DEVELOPMENT PLAN IS NOT ALLOWED UNLESS A VARIANCE IS OBTAINED FROM THE ZHE.

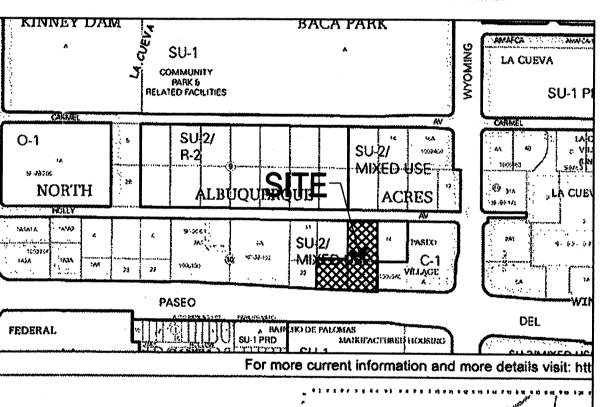

VICINITY MAP zone atlas number C-19

0 250' 500

FORMER PROJECT NUMBER: 1003532

PROJECT NUMBER: 1008069

APPLICATION NUMBER: 09EPC-40064/10DRB-70027

This plan is consistent with the specific Site Development Plan approved by the Environmental Planning Commission (EPC), dated December 17, 2009 and the findings and conditions in the official notification of decision are satisfied.

Is an Infrastructure List Required? (X) Yes () No If yes, then a set of approved DRC plans with a work order is required for any construction within Public Right-of-Way or for construction of public

DRB SITE DEVELOPMENT PLAN APPROVAL:

DRB CHAIRPERSON, PLANNING DEPARTMENT

TRAFFIC ENGINEER, TRANSPORTATION DIVISION DATE **ABCWUA** DATE PARKS AND RECREATION DEPARTMENT DATE CITY ENGINEER DATE SOLID WASTE MANAGEMENT

SHEET NO.

interiors landscape planning engineering

architecture

7601 Jefferson NE Suite 100 Albuquerque, NM 87109 505 761-9700 fax 761-4222

dps @ dpsdesign.org


ENGINEER

DRAWN BY

REVIEWED BY February 2, 2010 PROJECT NO.


DRAWING NAME

SITE **DEVELOPMENT PLAN FOR SUBDIVISION**

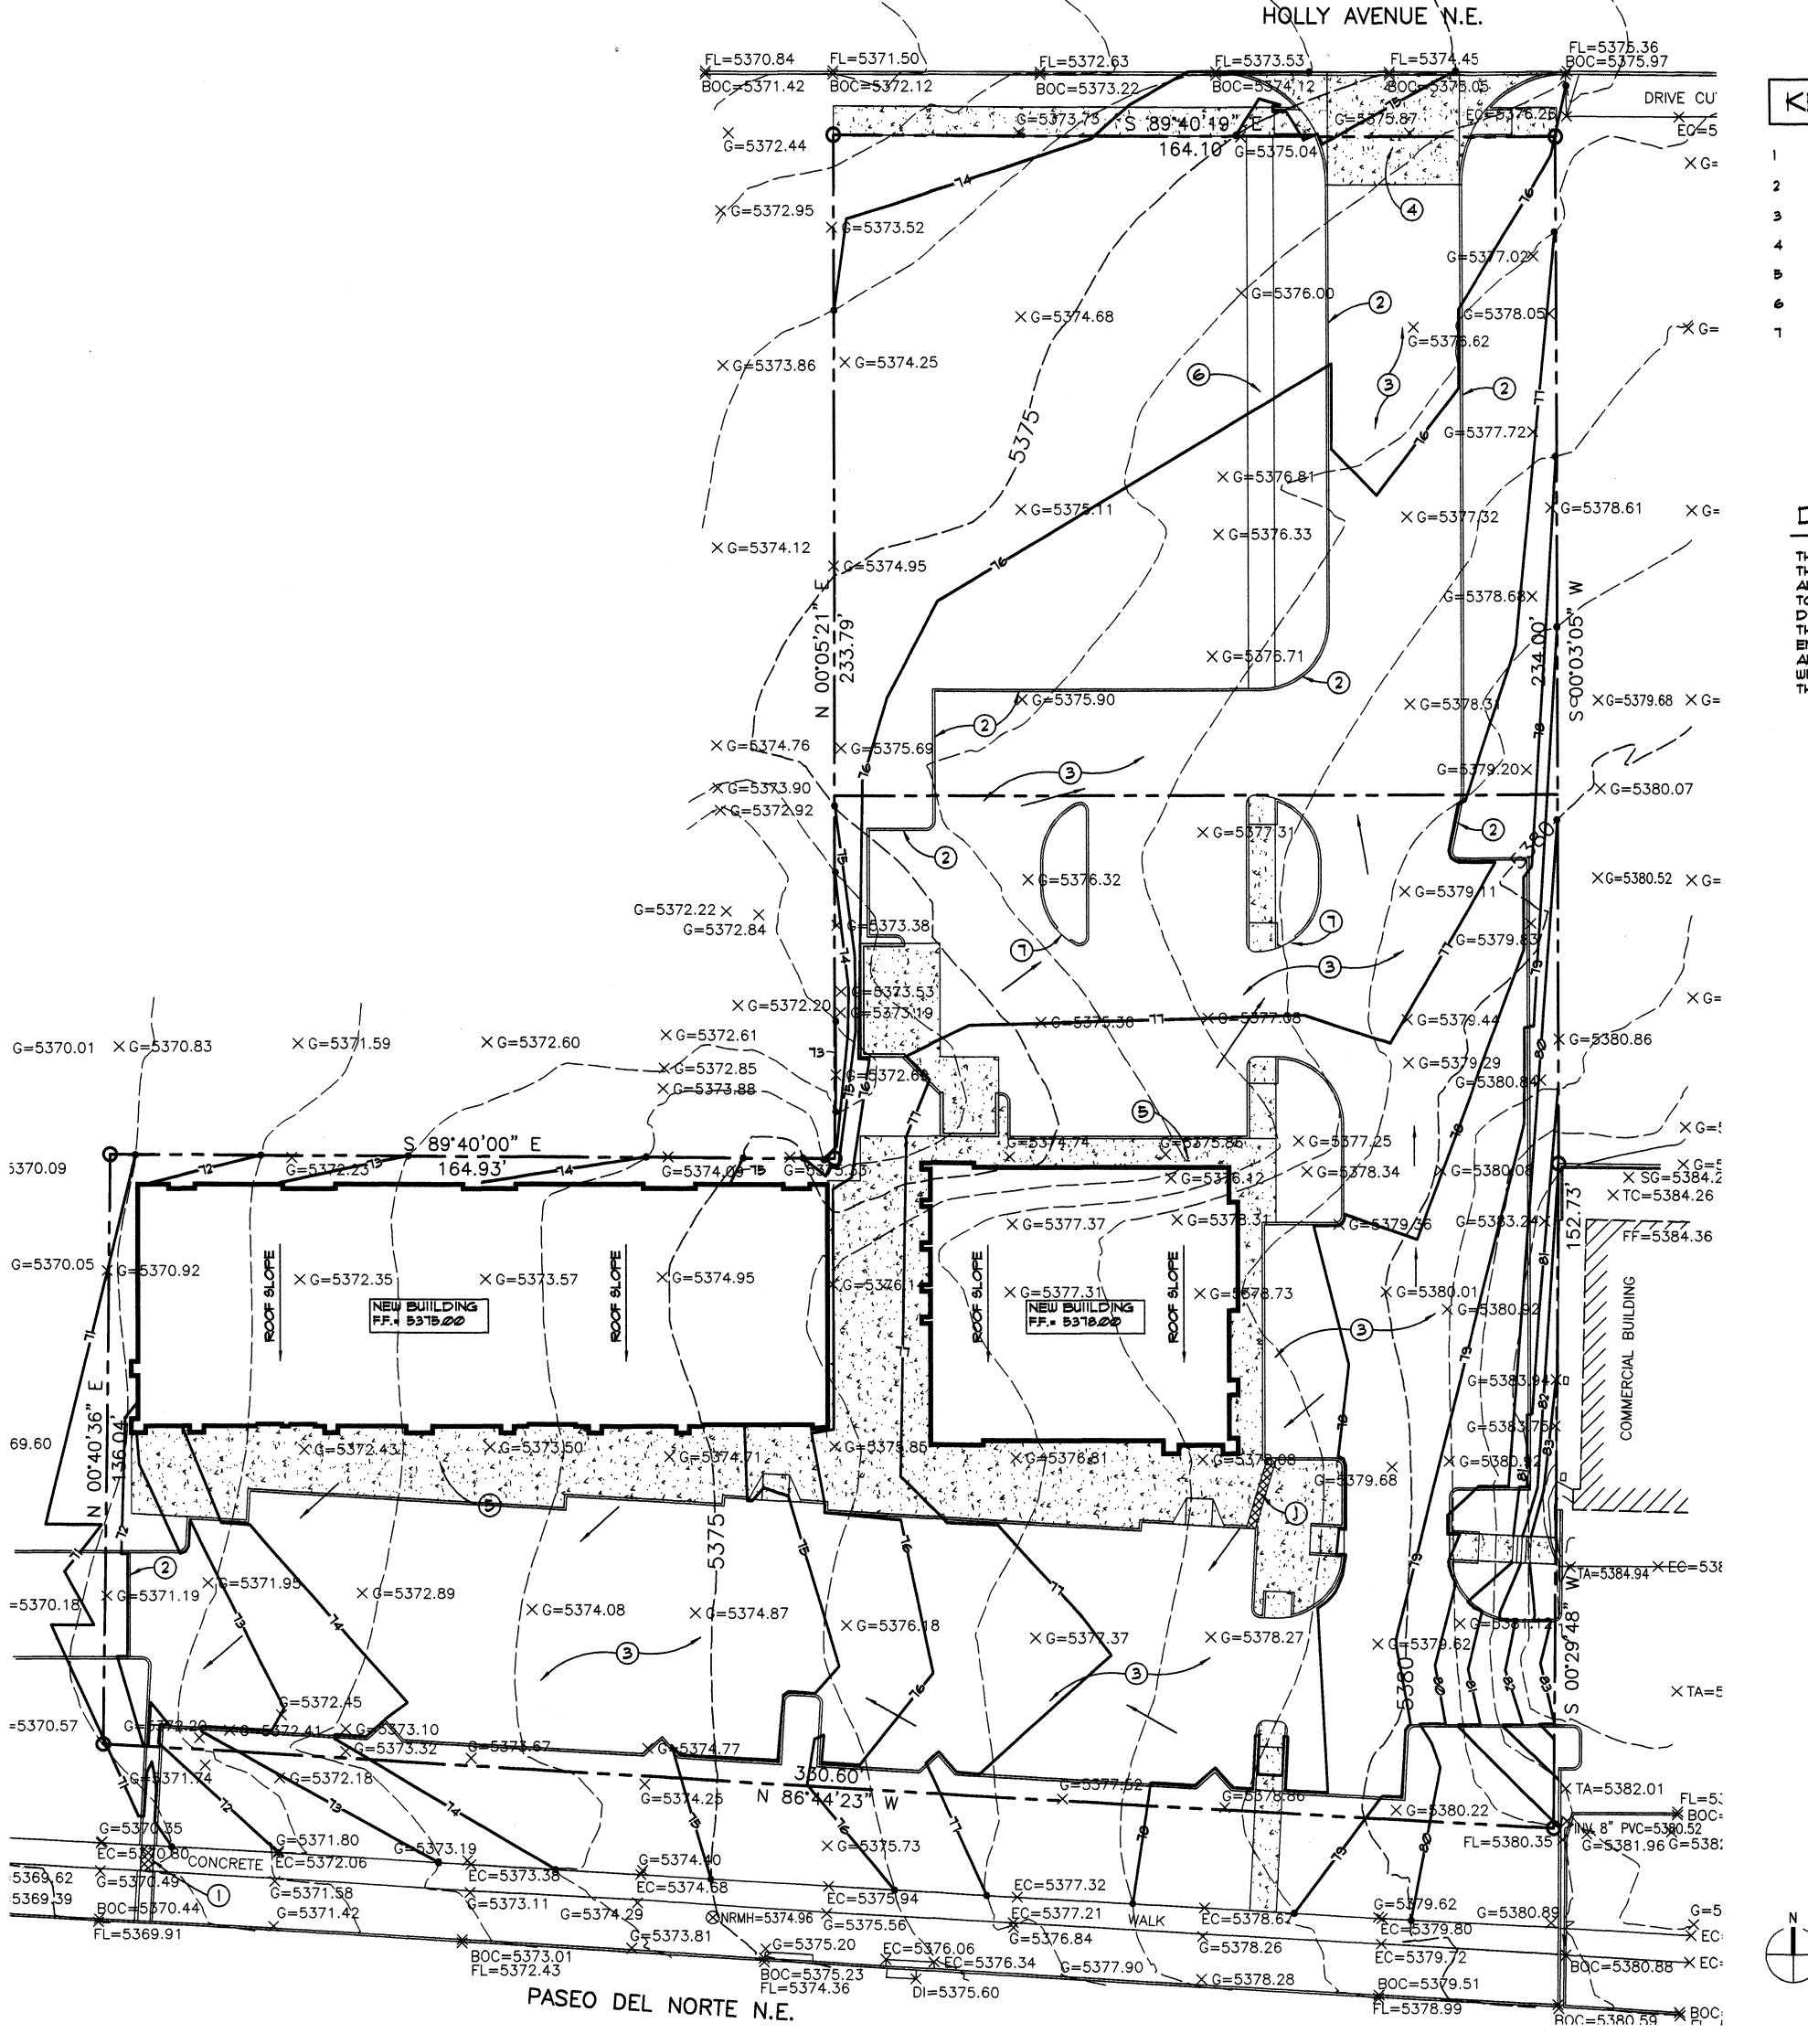

KEYED NOTES

- SIDEWALK CULVERT
- TEMPORARY ASPHALT CURB
- ASPHALT PAYING
- CONCRETE DRIVE PAD
- CONCRETE SIDEWALK
- TEMPORARY ASPHALT PATH
- 4'-0" WIDE CURB BREAK AT LANDSCAPE ISLAND FOR RUNOFF STORAGE

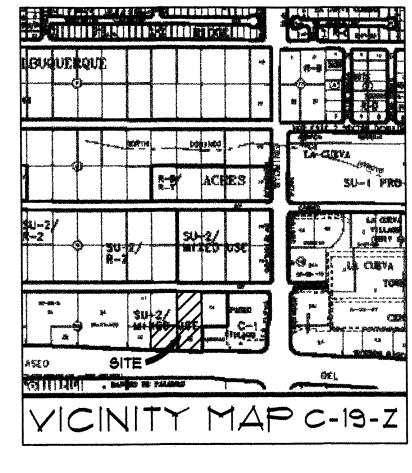

DESIGN NARRATIVE

THIS SITE IS 137 ACRES AND IS CURRENTLY UNIMPROVED. THE SITE WILL BE DEVELOPED FOR RETAIL BUILDINGS AND PARKING. THE DEVELOPED SITE WILL BE GRADED TO DIRECT RUNOFF TO IMPROVED DOWNSTREAM STORM DRAIN FACILITIES IN PASEO DEL NORTE AND HOLLY AVE. THE MAJORITY OF STORM RUNOFF FROM THE SITE WILL ENTER PASEO DEL NORTE VIA A CONCRETE RUNDOUN AND SIDEWALK CULVERT. THE RUNOFF DIRECTED NORTH WILL FLOW TO STREET IMPROVEMENTS IN HOLLY AVE. VIA THE PAYED ACCESS ROAD.

CONCEPTUAL GRADING

and DRAINAGE PLAN

LEGAL DESCRIPTION

LOTS 13, 20, AND 21, BLOCK 10, TRACT 2, UNIT 3, NORTH ALBUQUERQUE ACRES, ALBUQUERQUE, BERNALILLO COUNTY, NEW MEXICO

BENCHMARK

ELEVATIONS ARE BASED ON CITY OF ALBUQUERQUE STATION NO. "HEAVEN UNDERGROUND", HAVING AN ELEVATION OF 5278.235

LEGEND

NEW BUILDING LINE

--- EXISTING CONTOUR

NEW SPOT ELEVATION

EXISTING SPOT ELEVATION

VEW FLOW DIRECTION ARROW

TOP OF ASPHALT

TOP OF CONCRETE

FINISHED GRADE

NEW CONCRETE PAYING

ROOF DRAIN LOCATION

NEW AC PAYING

BACK OF CURB (EXISTING)

EDGE OF CONCRETE (EXISTING) GRADE (EXISTING)

FLOW LINE TOP OF GRATE

1" = 20'-0"

SHEET NO.

DRAWN BY

DATE

REVIEWED BY

PROJECT NO.

DRAWING NAME

CONCEPTUAL

GRADING and

DRAINAGE PLAN

C101

February 2, 2010

09-0055

architecture

interiors

landscape

planning

engineering


7601 Jefferson NE Suite 100

Albuquerque, NM 87109

505 761-9700 fax 761-4222

ARCHITECT

dps @ dpsdesign.org

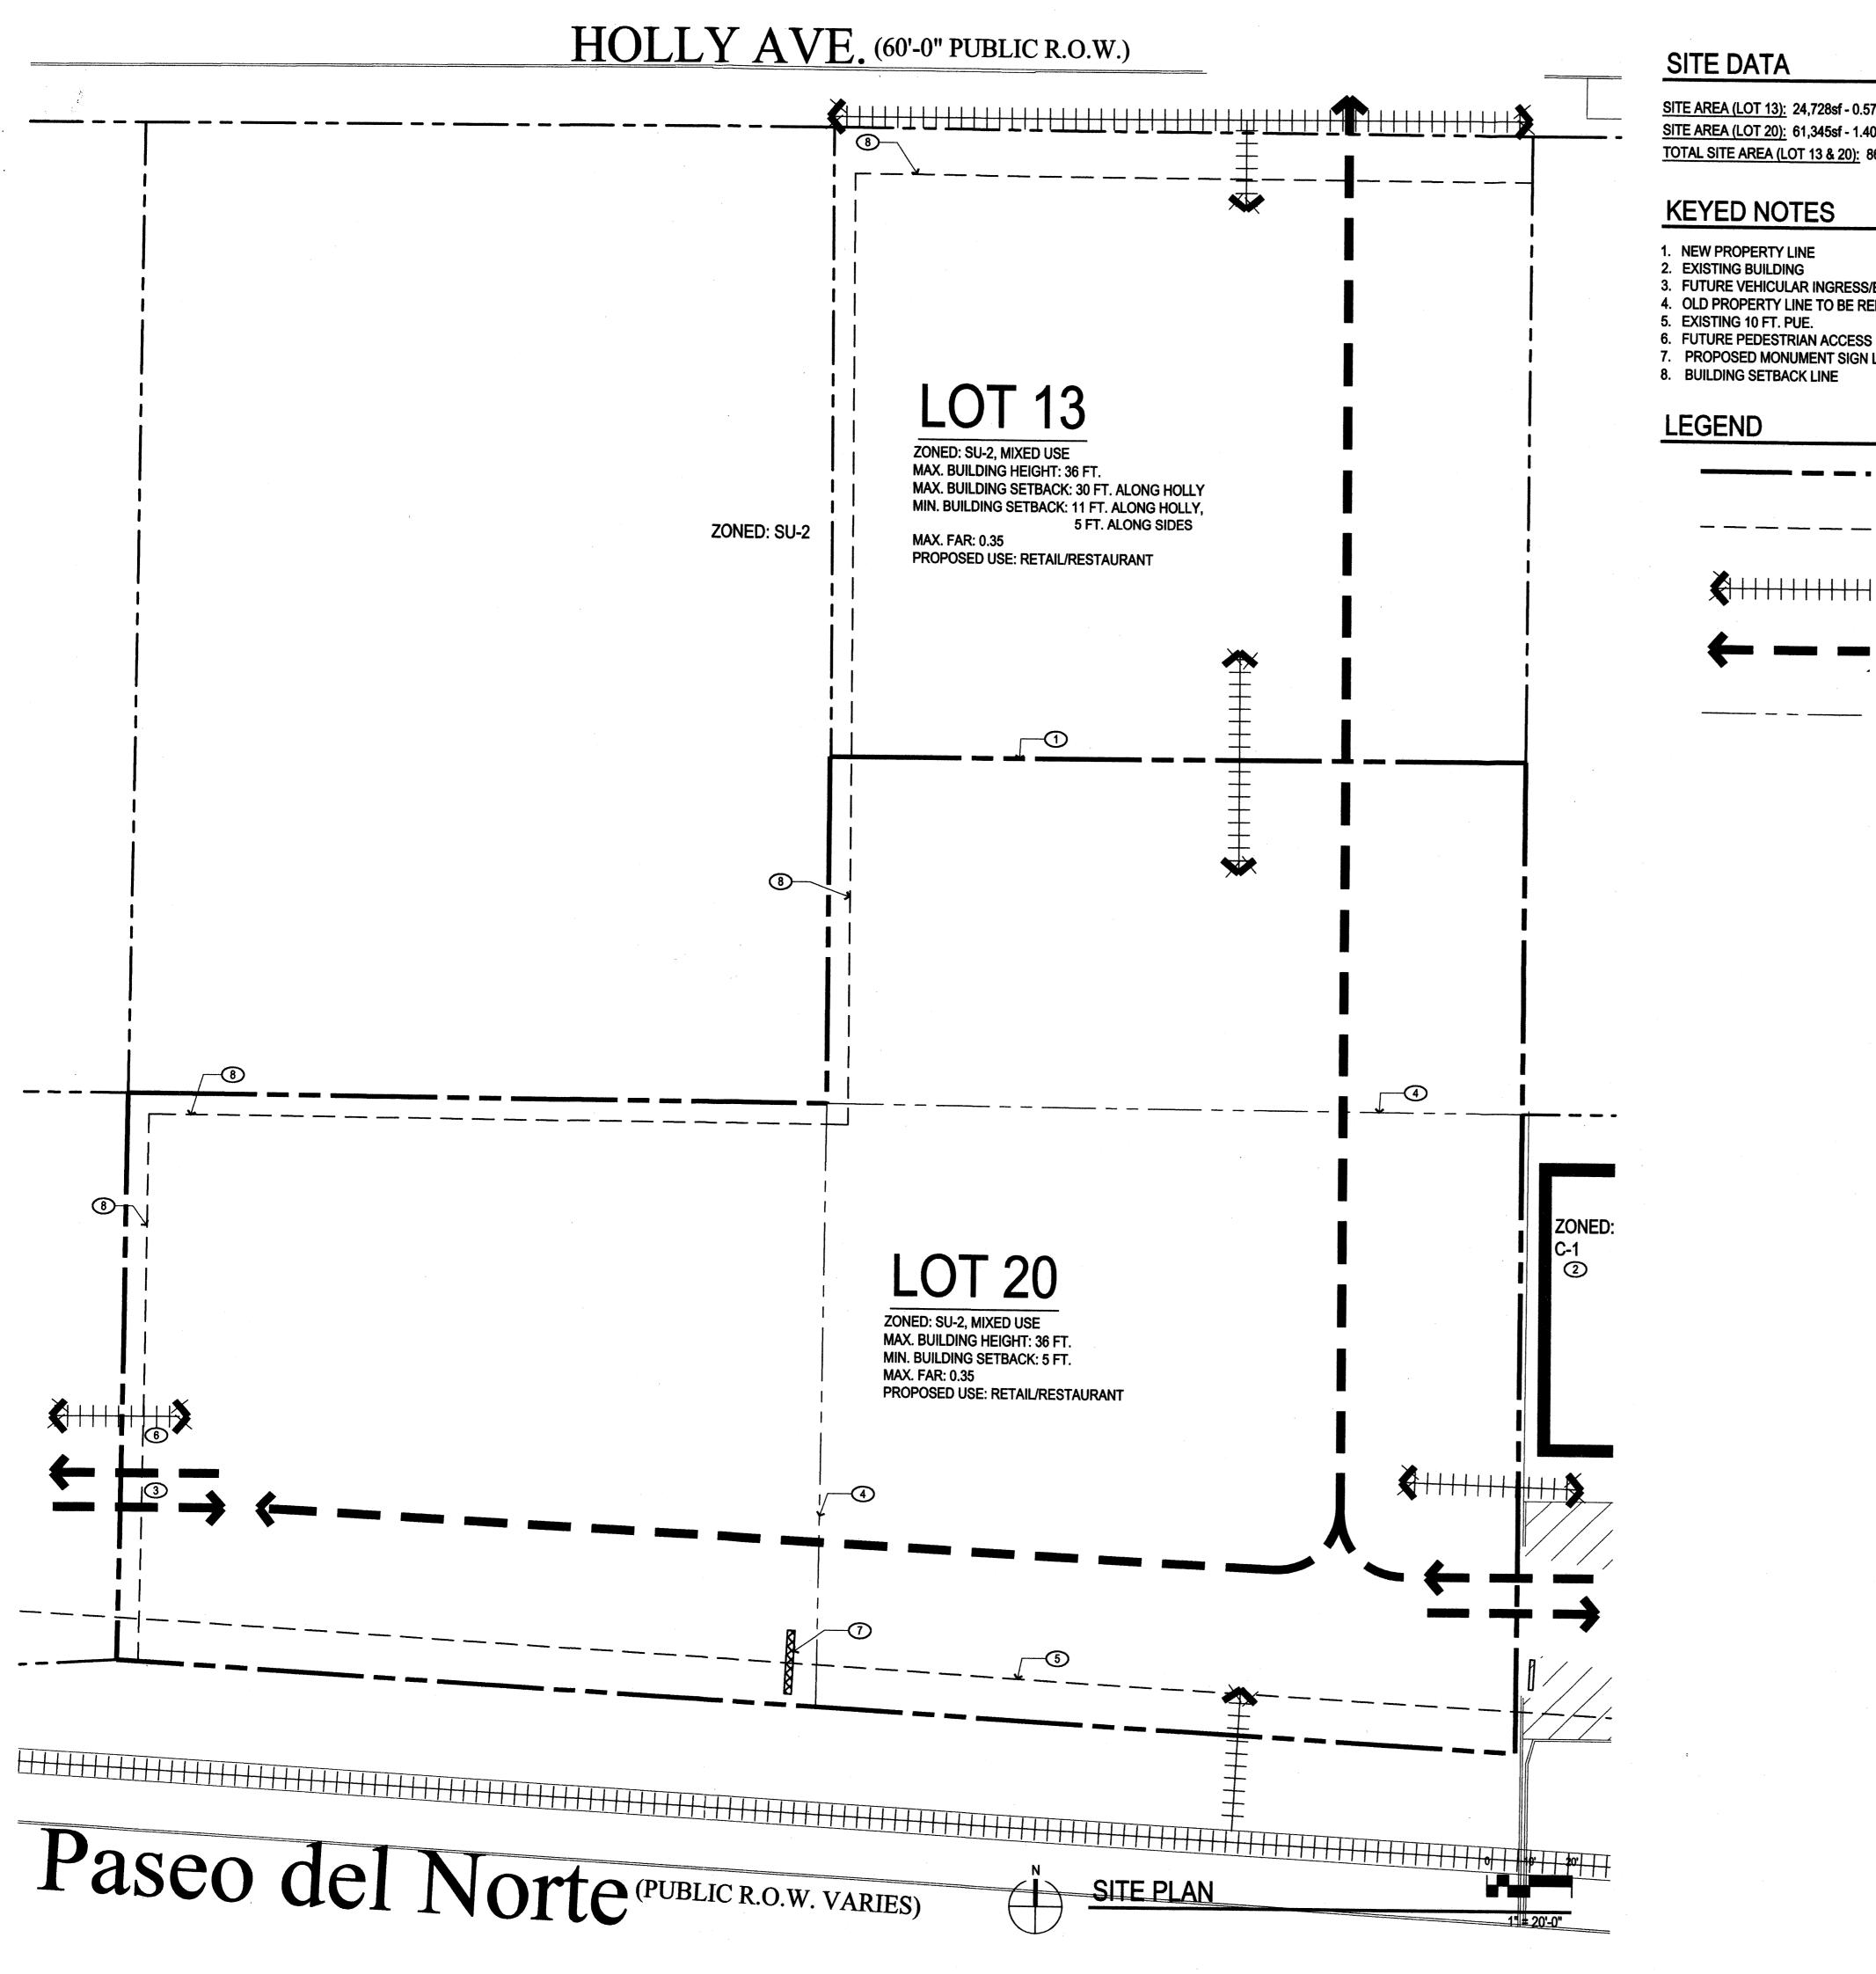

SITE DATA

SITE AREA (LOT 13): 24,728sf - 0.57 ACRES SITE AREA (LOT 20): 61,345sf - 1.40 ACRES TOTAL SITE AREA (LOT 13 & 20): 86,073sf - 1.97 ACRES

KEYED NOTES

- 1. NEW PROPERTY LINE
- 2. EXISTING BUILDING
- 3. FUTURE VEHICULAR INGRESS/EGRESS 4. OLD PROPERTY LINE TO BE REMOVED
- 5. EXISTING 10 FT. PUE.
- 7. PROPOSED MONUMENT SIGN LOCATION
- 8. BUILDING SETBACK LINE

LEGEND

PROPERTY LINE

BUILDING SETBACK/PUE

PEDESTRIAN INGRESS/EGRESS



VEHICULAR INGRESS/EGRESS

OLD PROPERTY LINE

GENERAL NOTES

A. REFER TO CONCEPTUAL UTILITY PLAN FOR PROPOSED AND EXISTING

WATER, SEWER, AND STORM DRAINAGE. B. PLEASE REFER TO SITE DEVELOPMENT PLAN FOR BUILDING PERMIT (#1008069, 09EPC-40063) FOR FURTHER INFORMATION ON ARCHITECTURAL BUILDING DESIGN STYLE AND SIGNAGE. BUILDING AND SIGNAGE HEIGHT, MASS, COLOR, MATERIALS, AND ARTICULATION CAN BE REFERENCED FROM BUILDING AND SIGNAGE ELEVATIONS. SIGNAGE FACE AREA AND LIGHTING INFORMATION CAN BE FOUND ADDITIONALLY IN THIS SUBMITTAL.

C. THE REMAINDER OF LOT 13 SHALL BE DEVELOPED IN A FUTURE PHASE ACCORDING TO A SITE DEVELOPMENT PLAN APPROVED BY THE EPC PER THE LA CUEVA SDP (2000, REV. 2003). THE SITE DEVELOPMENT PLAN INCLUDING PEDESTRIAN CIRCULATION, BUILDING ORINETATION, ARCHITECTURE AND SIGNAGE, SHALL BE DESIGNED TO COORDINATE WITH THE DEVELOPMENT OF LOT 20 TO FORM A COHESIVE RETAIL CENTER.

D. SITE PLAN SHALL COMPLY AND BE DESIGNED PER DPM STANDARDS. E. SITE PLAN SHALL COMPLY WITH THE SU-2, SU-2/MIXED USE ZONE AND COMMON DESIGN REGULATIONS (SECTIONS 5.4, 5.4.5, 5.4.6, LA CUEVA SECTOR DEVELOPMENT PLAN 2000, REVISED 2003).

F. SIGNAGE: THE GOAL IS TO PROVIDE CONSISTENCY IN APPEARANCE AND QUALITY THAT COMPLIMENTS THE VISUAL CHARACTER OF THE DEVELOPMENT. ALL BUILDING MOUNTED SIGNS SHALL COMPLY WITH SU-2/MIXED USE AND COMMON DESIGN REGULATIONS FOR SU-2 ZONED PROPERTIES IN THE LA CUEVA SECTOR DEVELOPMENT PLAN. ALL BUILDING MOUNTED SIGNS SHALL BE SUBMITTED UNDER SEPARATE

G. THE MAXIMUM INDIVIDUAL LETTER SIZE OF ALL BUILDING MOUNTED SIGNAGE SHALL NOT EXCEED 2'-0" IN HEIGHT. LOGO DESIGN SIGNS SHALL COMPLY WITH 13R-9 OF THE LA CUEVA SDP. ALL SIGNS SHALL FOLLOW THE LA CUEVA SDP SIGNAGE REGULATIONS.

H. IF A FREE STANDING SIGN ON LOT 20 IS APPROVED BY THE ZHE, THE TOTAL SIGN FACE OF BUILDING MOUNTED SIGNS ON LOT 20 SHALL NOT EXCEED 12.5% OF THE TOTAL FACADE AREA FOR THE SOUTHERN ELEVATIONS AND 10% OF THE TOTAL FACADE AREA FOR THE OTHER ELEVATIONS. THE TOTAL SIGN FACE AREA OF EACH TENANT'S BUILDING MOUNTED SIGNS SHALL NOT EXCEED 12.5% OF THE FACADE AREA OF EACH TENANT'S PREMISES FOR SOUTH ELEVATIONS AND 10% FOR OTHER ELEVATIONS.


ALL SIGNAGE TO PROVIDE MINIMUM CONTRAST OF 70% BETWEEN GRAPHICS AND BACKGROUND PER ADA.

J. IF A FREE STANDING SIGN ON LOT 20 IS APPROVED BY THE ZHE THAT INCLUDES ADVERTISING FOR TENANTS ON LOT 13, THE TOTAL SIGN FACE

TOTAL FACADE AREA.


K. THE FREE STANDING SIGN SHOWN ON THE SITE DEVELOPMENT PLAN IS NOT ALLOWED UNLESS A VARIANCE IS OBTAINED FROM THE ZHE.

OF BUILDING -MOUNTED SIGNS ON LOT 13 SHALL NOT EXCEED 10% OF THE

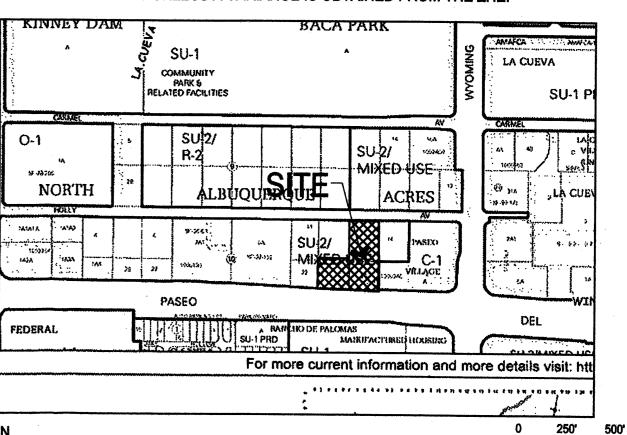



VICINITY MAP zone atlas number C-19

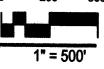

FORMER PROJECT NUMBER: 1003532

PROJECT NUMBER: 1008069

APPLICATION NUMBER: <u>09EPC-40064/10DRB-70027</u>

This plan is consistent with the specific Site Development Plan approved by the Environmental Planning Commission (EPC), dated December 17, 2009 and the findings and conditions in the official

Is an Infrastructure List Required? (X) Yes () No If yes, then a set of approved DRC plans with a work order is required for any construction within Public Right-of-Way or for construction of public

DRB SITE DEVELOPMENT PLAN APPROVAL:

DRB CHAIRPERSON, PLANNING DEPARTMENT

TRAFFIC ENGINEER, TRANSPORTATION DIVISION	DATE
ABCWUA	DATE
PARKS AND RECREATION DEPARTMENT	DATE
CITY ENGINEER	DATE
SOLID WASTE MANAGEMENT	DATE

interiors landscape planning engin**e**ering

architecture

7601 Jefferson NE Suite 100 Albuquerque, NM 87109 505 761-9700 fax 761-4222 dps ⊚ dpsdesign.org

ARCHITECT

1/4/2010


DRAWN BY


REVIEWED BY February 2, 2010 PROJECT NO.

DRAWING NAME SITE **DEVELOPMENT**

PLAN FOR SUBDIVISION

SHEET NO.

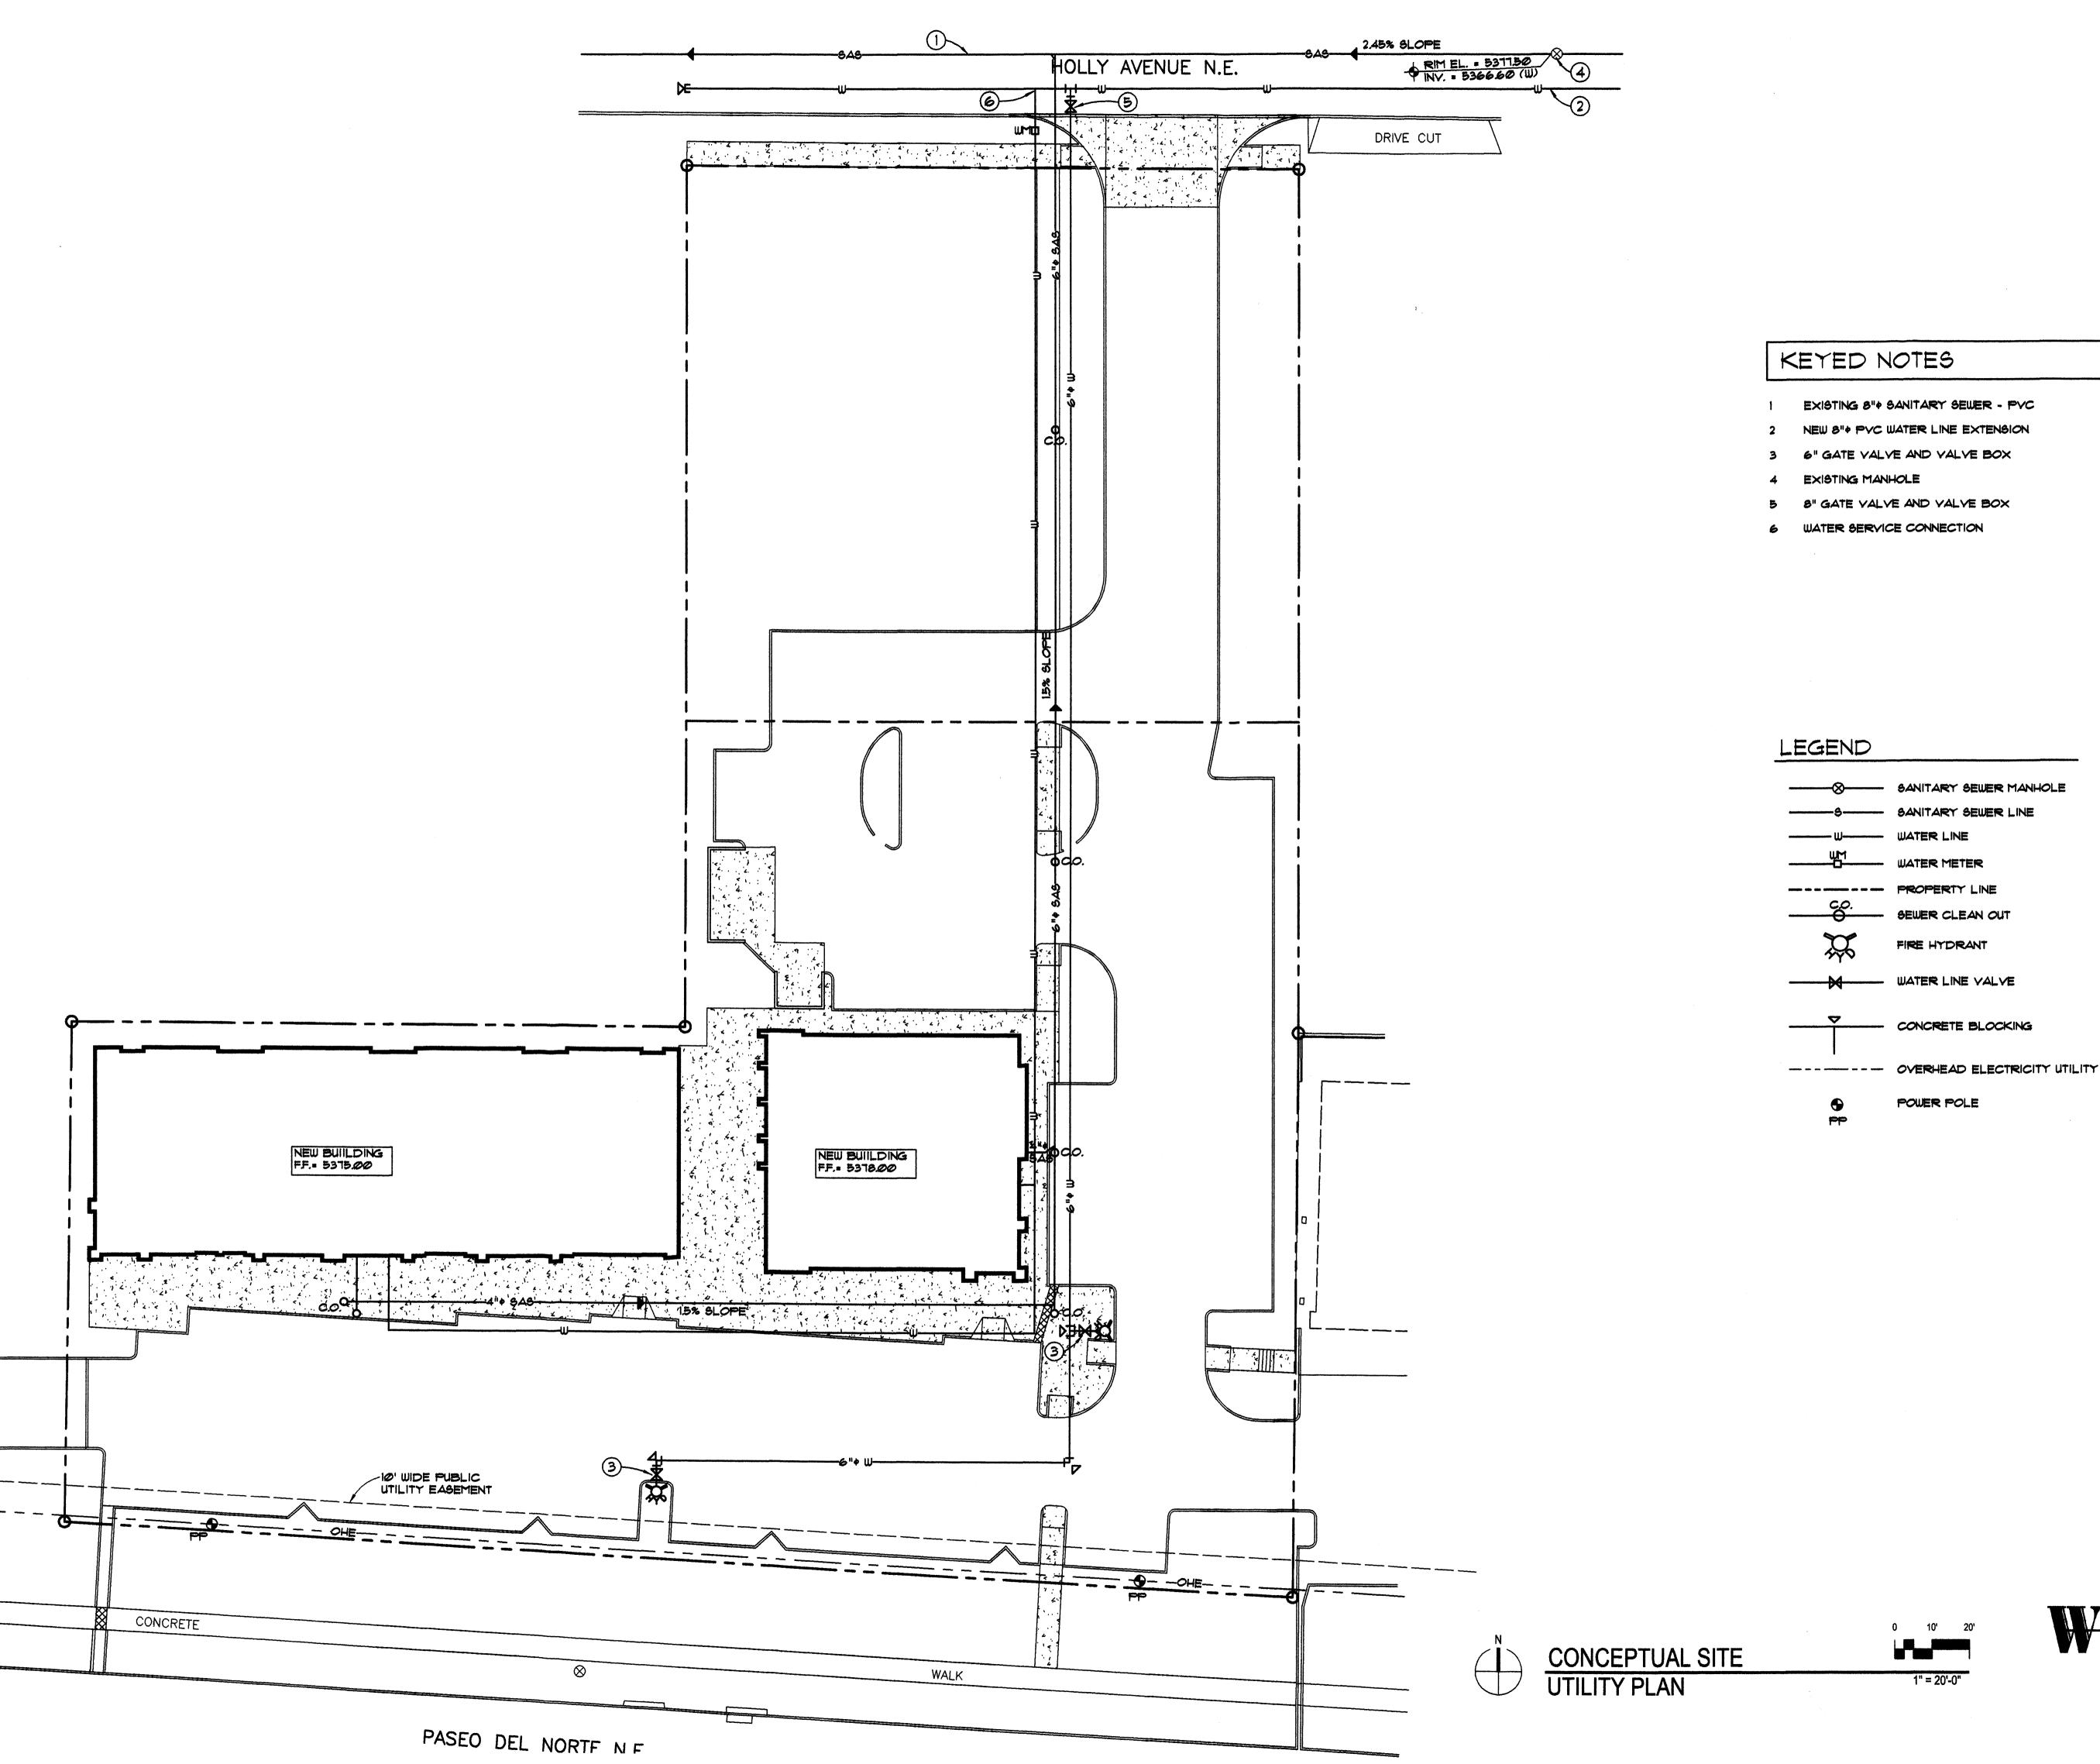

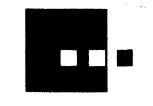

architecture interiors landscape planning engineering

Dekker Perich Sabatin

7601 Jefferson NE Suite 100 Albuquerque, NN 87109 505 761-9700 fax 761-4222 dps @dpsdesign.org

ARCHITECT

7441 & 7501 Paseo Del Norte querque, New Mexico 87113

REVISIONS

1/4/2010 EPC Conditions of Approval

DRAWN BY

REVIEWED BY

DATE

PROJECT NO.

DRAWING NAME

LEK

MJW

MJW

09-0055

CONCEPTUAL
SITE UTILITY PLAN



SHEET NO.

C102