

CONCEPTUAL SITE PLAN

PARKING CALCULATIONS

NEW FELLOWSHIP HALL BUILDING REQUIRED: 1 SPACE FOR EACH 4 SEATS. UNCONCENTRATED SEATING 467 SEATS/ 4 = 117 SPACES PARKING REQUIRED: 117 SPACES PARKING PROVIDED: 133 SPACES ADA PARKING REQUIRED: 8 SPACES ADA PARKING PROVIDED: 8 SPACES MOTORCYCLE PARKING REQUIRED: 4 SPACES MOTORCYCLE PARKING PROVIDED: 4 SPACES BICYCLE PARKING REQUIRED: 7

FUTURE OFFICE BUILDING ONE SPACE PER 200 SF. NET LEASABLE AREA: 3,000 GROSS SQUARE FEET. PARKING REQUIRED: 15 SPACES PARKING PROVIDED: 15 SPACES ADA PARKING REQUIRED: 1 SPACE ADA PARKING PROVIDED: 1 SPACE MOTORCYCLE PARKING REQUIRED: 1 SPACE MOTORCYCLE PARKING PROVIDED: 1 SPACE BICYCLE PARKING REQUIRED: 1 SPACE BICYCLE PARKING PROVIDED: 2 SPACE

EXISTING SANCTUARY 1 SPACE FOR EACH 4 SEATS IN MAIN SANCTUARY (EA. 30 INCH OF PEW SPACE IS CONSIDERED ONE SEAT) 675 LF OF BENCH 675/2.5= 270 SEATS 270/4=67.8 OR 68 SPACES PARKING REQUIRED: 68 SPACES PARKING PROVIDED: 68 SPACES ADA PARKING REQUIRED: 4 SPACES ADA PARKING PROVIDED: 6 SPACES MOTORCYCLE PARKING REQUIRED: 3 SPACE MOTORCYCLE PARKING PROVIDED: 3 SPACES BICYCLE PARKING REQUIRED: 3 SPACE BICYCLE PARKING PROVIDED: 5 SPACES

TOTAL SITE PARKING
PARKING REQUIRED: 200 SPACES PARKING PROVIDED: 216 SPACES ADA PARKING REQUIRED: 13 SPACES ADA PARKING PROVIDED: 15 SPACES MOTORCYCLE PARKING REQUIRED: 8 SPACES MOTORCYCLE PARKING PROVIDED: 8 SPACES BICYCLE PARKING REQUIRED: 11 SPACES BICYCLE PARKING PROVIDED: 14 SPACES

BICYCLE PARKING PROVIDED: 7

VICINITY MAP M-10-Z

INDEX OF DRAWINGS

AS-101 SITE PLAN FOR BUILDING PERMIT SITE PLAN DETAILS PROPOSED LANDSCAPE PLAN L- 100 DEMOLITION & EXISTING LANDSCAPE L- 101

CG-102 PRELIMINARY UTILITY PLAN PRELIMINARY GRADING PLAN

CG-101 A-201 BUILDING ELEVATIONS 8. G-002 DESIGN STANDARDS

KEYED NOTES

- 1. NEW 6' CONCRETE SIDEWALK.
- 2. NEW STANDARD CONCRETE DRIVE PAD. PER COA STANDARD DETAIL 2425
- 3. FUTURE 3,000 G.S.F. BUILDING, NIC.
- 4. NEW EXTERIOR LIGHT POLE, SEE DETAIL 15/AS-501.
- 5. NEW WHEELCHAIR RAMP W/ MAX. SLOPE OF 1:12 SEE DETAIL 10/AS-5C1
- 6. NEW CONCRETE CURB & GUTTER, SEE DETAIL 34. NEW PLAZA & LANDSCAPE AREA- SEE 14/AS-501.
- NEW ASPHALT PAVING, SEE DETAIL 12/AS501. 35. (2) NEW 20' GATES TO MATCH EXISTING
- NEW MOTORCYCLE PARKING SPACE \$ SIGN SEE DETAIL 7/AS-501. MOTORCYCLE PARKING SPACES FOR EACH BUILDING ON THE SITE SHALL BE LOCATED TO COMPLY MITH 14-16-3-1(C).
- 9. EXISTING LIGHT POLES TO REMAIN.
- 10. EXISTING FREE STANDING SIGNAGE TO BE REMOVED ONTO SUBJECT PROPERTY.
- NEW 4" WIDE THERMOPLASTIC CROSSMALK STRIPING.
- 12. NEW 4" WIDE PAVEMENT MARKING.
- 13. NEW LANDSCAPE ISLAND.
- 14. NEW TURN-DOWN CONCRETE SIDEMALK, SEE DETAIL 13/AS-501.
- DESIGNATED PARISHIONER DROP/ PICK-UP AREA.
- 16. NEW DUMPSTER, SEE DETAIL 2/AS-501
- 17. NEW BIKE RACK, SEE DETAIL 1/AS-501.
- 18. EXISTING 6' IN HEIGHT CMU WALL.
- NEW STOP SIGN, SEE DETAIL 6/AS-501.
- 20. NEW ACCESSIBLE PARKING SIGN, SEE DETAIL 8/AS-501 & 9/AS-501.
- 21. NEW ACCESSIBLE PARKING SPACE, SEE DETAIL 5/AS-501.
- 22. EXISTING ACCESSIBLE PARKING SPACE.
- 23. EXISTING STORAGE STRUCTURE.
- 24. NEW DESIGN OF EXISTING DETENTION POND, SEE GRADING AND DRAINAGE SHEET CG-101.
- 25. EXISTING DETENTION POND.
- 26. EXISTING CMU WALL, HEIGHT VARIES FROM 3' TO 6' IN HEIGHT (BROWN STUCCO).
- 27. EXISTING 6' IN HEIGHT WROUGHT IRON FENCE.
- 28. NEW TREE WELL& LANDSCAPE AREA SEE DETAIL 5/AS-501

- 29. EXISTING CMU RETENTION WALL. HEIGHT YARIES FROM 3' TO 20' IN HEIGHT (BROWN STUCCO).
- 30. FUTURE LANDSCAPE & SIDEWALK AREA. 31. NEW STEEL GATE, SEE DETAIL 17/AS-501.
- 32. REMOVE EXISTING LIGHT POLES AND RETURN TO OWNER.
- 33. NEW SITE BENCHES, SEE DETAIL 18/AS-501.
- LANSCAPE DRAWINGS.
- FENCING & GATE.

GENERAL NOTES

- A. ALL WHEELCHAIR RAMPS IN THE CITY RIGHT OF WAY SHALL HAVE A MAXIMUM SLOPE OF 1:12 AND MUST HAVE A DETECTABLE WARNING SURFACE CONSISTING OF RAISED, TRUNCATED DOMES.
- B. EXACT LOCATION OF SITE LIGHTING WILL BE VERIFIED BY PHOTOMETRIC STUDY, DURING CONSTRUCTION DOCUMENT PHASE. THE LOCATION OF SITE LIGHTING SHALL BE COORDINATED WITH THE LANDSCAPE PLAN AND GRADING & DRAINAGE PLAN TO AVOID CONFLICTS WITH SHADE TREES AND STORM MATER FLOMS.
- ALL ROOF & GROUND MOUNTED EQUIPMENT TO BE SCREENED. PER 14-16-3-18(C)(6) ANY STRUCTURAL FEATURES USED TO SCREEN EQUIPMENT SHALL MATCH THE PREDOMINANT MATERIALS AND COLORS USED IN THE BUILDING.
- IT IS THE APPLICANT'S OBLIGATIONS TO DETERMINE IF EXISTING UTILITY EASEMENTS OR RIGHTS-OF-WAY ARE LOCATED ON OR ADJACENT TO THE PROPERTY AND TO ABIDE BY ANY CONDITIONS OR TERMS OF THE EASEMENTS OR AGREEMENTS.
- ALL SCREENING AND VEGETATION SURROUNDING GROUND MOUNTED TRANSFORMERS AND UTILITY PADS ARE TO ALLOW 10 FEET OF CLEARANCE IN FRONT OF THE EQUIPMENT DOOR AND 5-6 FEET OF CLEARANCE ON THE REMAINING THREE SIDES FOR SAFE OPERATION, MAINTENANCE AND REPAIR PURPOSE.
- F. AREA LIGHTING SHALL COMPLY WITH 14-16-3-9 OF THE ZONING CODE.
- EPC DELEGATES APPROVAL OF THE FUTURE OFFICE BUILDING TO THE DRB, PER THE DESIGN STANDARDS ON SHEET 8 (G-002).
- H. EXTERIOR LIGHTING FIXTURES SHALL RELATE STYLISTICALLY TO THE ARCHITECTURE OF THE ADJACENT BUILDINGS.
- CONTROLLED, DIRECTIONAL LIGHTING SHALL BE USED TO HIGHLIGHT PUBLIC SPACES AND MALKWAYS.
- K FIXTURE STYLE AND DESIGN SHALL BE COMPATIBLE AND CONSISTENT.

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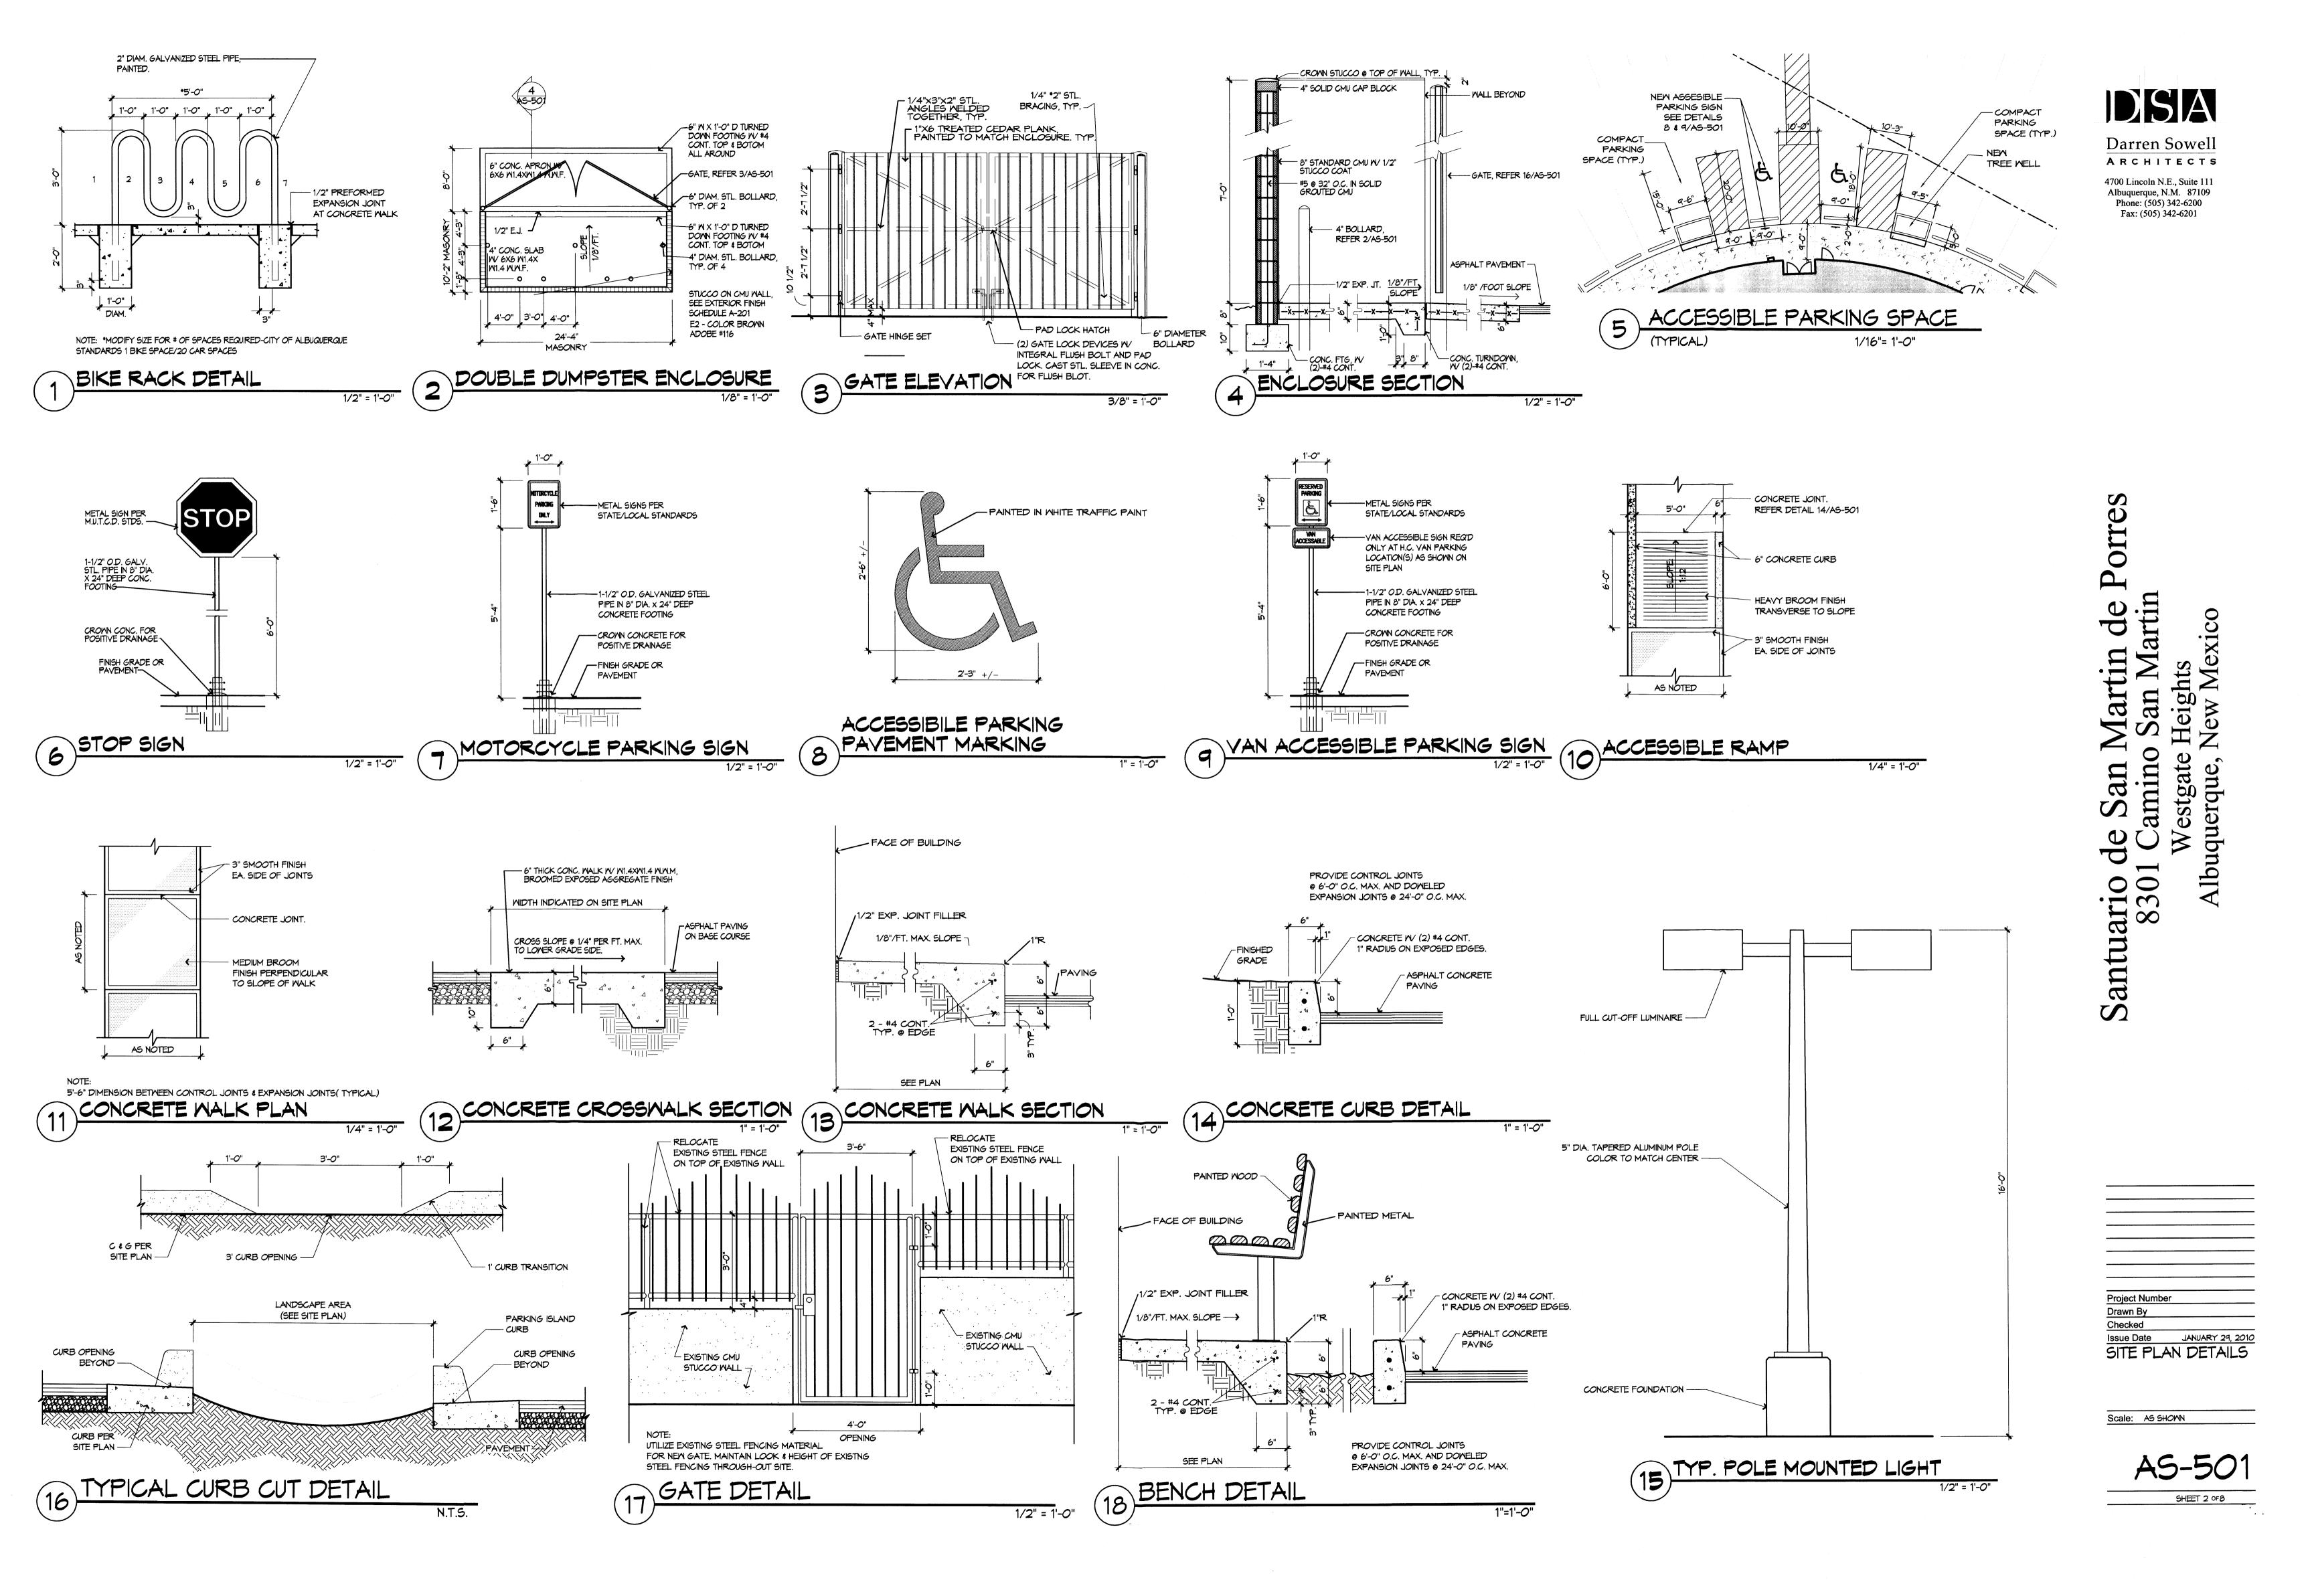
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Project Number Drawn By Checked JANUARY 29, 2010 Issue Date SITE PLAN FOR BUILDING PERMIT

SHEET 1 OF 8

Scale: AS SHOWN



PHASE TWO

TOTAL PROPOSED LANDSCAPE PROVIDED (sf), (See Legend) 36906

198,411

- 22*,000*

176,411

× .15

26,462

NATIVE SEED MIX: PLS/ACRE

PLS/LBS/ACRE

Achnatherum hymenoides

Bouteloua curtipendula

Sporobolus cryptandrus

Bouteloua gracilis

Atriplex canescens

Hilaria jamesii

NAME

Indian Ricegrass, Paloma

Galleta Grass, Viva

Blue Grama, Hachita

Fourwing Saltbush

Sideoats Grama

Sand Dropseed

BOTANICAL

5.0

1.0

3.0

1.0

1.0

Total 12.0

LANDSCAPE CALCULATIONS

TOTAL EXISTING LANDSCAPE PROVIDED (sf), (See Legend)

TOTAL BUILDING AREA (sf) (Inc. Future Office)

TOTAL LANDSCAPE PROVIDED (%f), 3258 %

TOTAL SITE AREA

NET LOT AREA (sf)

LANDSCAPE REQUIREMENT (%)

TOTAL LANDSCAPE REQUIRED (SF)

- 19,000

179,411

26,912

+ 24460

LANDSCAPE CALCULATIONS

TOTAL EXISTING LANDSCAPE PROVIDED (\$f), (See Legend)

TOTAL PROPOSED LANDSCAPE PROVIDED (sf), (See Legend) 34526

TOTAL SITE AREA

NET LOT AREA (6f)

TOTAL BUILDING AREA (sf)

LANDSCAPE REQUIREMENT (%)

TOTAL LANDSCAPE REQUIRED (SF)

TOTAL LANDSCAPE PROVIDED (sf), 32.87 %

LANDSCAPE LEGEND

	LANDSCAPE LEGEND							
	Q TY	SIZE	Dec/Ev.	CØMMON / BOTANICAL	AV. SP.	AV. HT.	H20 USE	AREA
· ·	13	2" Cal	D	Honey Locust Gleditsia triacanthos 'enermis'	35-40'	60'	M+	
	25	2" Cal	D	Chitalpa Chitalpa x tashkenensis	3Ø'	3 <i>0</i> '	М	
	6	15 Gal.	D	Desert Willow Chilopsis linearis "Lucretia Hami	25' 'Iton"	25'	L	
	39	5 Gal	E	Wintergreen Barberry Berberis julianae	5'	5'	M	78
\$, <u>"</u> }	32	5 Gal	E	India Hawthorne	4'	4'	M	37
	21	5 Gal	E	Raphiolepis indica Honeysuckle Lonicera japonica	12'	2'	M	24
*	129	5 Gal	na	Dwarf Feathertop	2'	2'	М	_40
		24460		Pennisetum villosum Existing Landscape to Remain 'As Is' (See I	Note)		tota	1 39
		4436		Proposed Landscape, Gravel Mulch				
* *	+ +	30090	=	Proposed Landscape, Native Re-Veg See	d Mix			

Ash, Pinon Pine, Apache Plume, Spanish Broom, Tam Juniper's, Flowering Bulb's, Mixture of various grasses.

Existing Landscape includes the following but is not limited to the following species.

Cottonwood, Russian Olive, Japanese Black Pine, Austrian Pine, Desert Willow, Golden Rain Tree, Western Soapberry,

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01262010

<u>02.012010</u>

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Landscape notes

Landscape shall be watered by a complete underground irrigation system operated by automatic timer. Trees shall have bubblers and shrubs shall have a minimum of 2 emitters per shrub. Trees and shrubs shall be zoned seperately. Point of Connection for irrigation system shall be coordinated between the Landscape

All landscape areas shall be covered in 2-3" of landscape gravel, and commercial grade weed barrier fabric approved by the Owner's representative, prior to placement

It is the intent of this plan to comply with the City of Albuquerque Landscape Regulations Applicable to Apartments and Nonresidential Development, Revised

Landscaping shall be installed according to the approved plan.

Landscape areas in excess of 36 square feet shall be planted so as to achieve 75% Live Ground Cover at maturity.

Approval of this plan does not constitute or imply exemption from water waste provisions of the water conservation landscaping and water waste ordinance. Water management is the sole responsibility of the property owner.

This plan shall comply with the Street Tree requirement's as defined in the

Owner is responsible for maintenance of landscape and irrigation system.

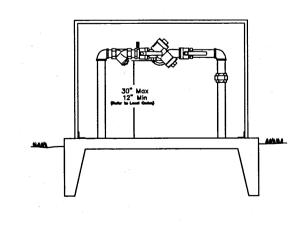
Contractor and the General Contractor of the project prior to construction.

Street Tree Ordinance 6-2-2-1.

DO NOT CUT LEADER. PRUNE DAMAGED OR DEAD WOOD AFTER PLANTING AND STAKING. KEEP CROWN SHAPE TYPICAL OF SPECIES. UNDISTURBED PIT BOTTOM FOR ROOTBALL BASE BALL DIA. +24"

TRUNK 4 "DEPTH SPECIFIED MULCH AT EDGE OF RING, INSIDE 4" WATERING SAUCER WATER SAUCER TO BE 25' FROM TRUNK OF DECIDUOUS TREES ADD ROOR STIMULATOR TO NATIVE BACKFILL, REMOVE ALL TWINE AND WIRE FROM BALL. REMOVE WIRE BASKETS. INITIAL STABILIZING BACKFILL 1/3 DEPTH, COMPACTED.

TREE PLANTING DETAIL



BACKFLOW PREVENTION DETAIL

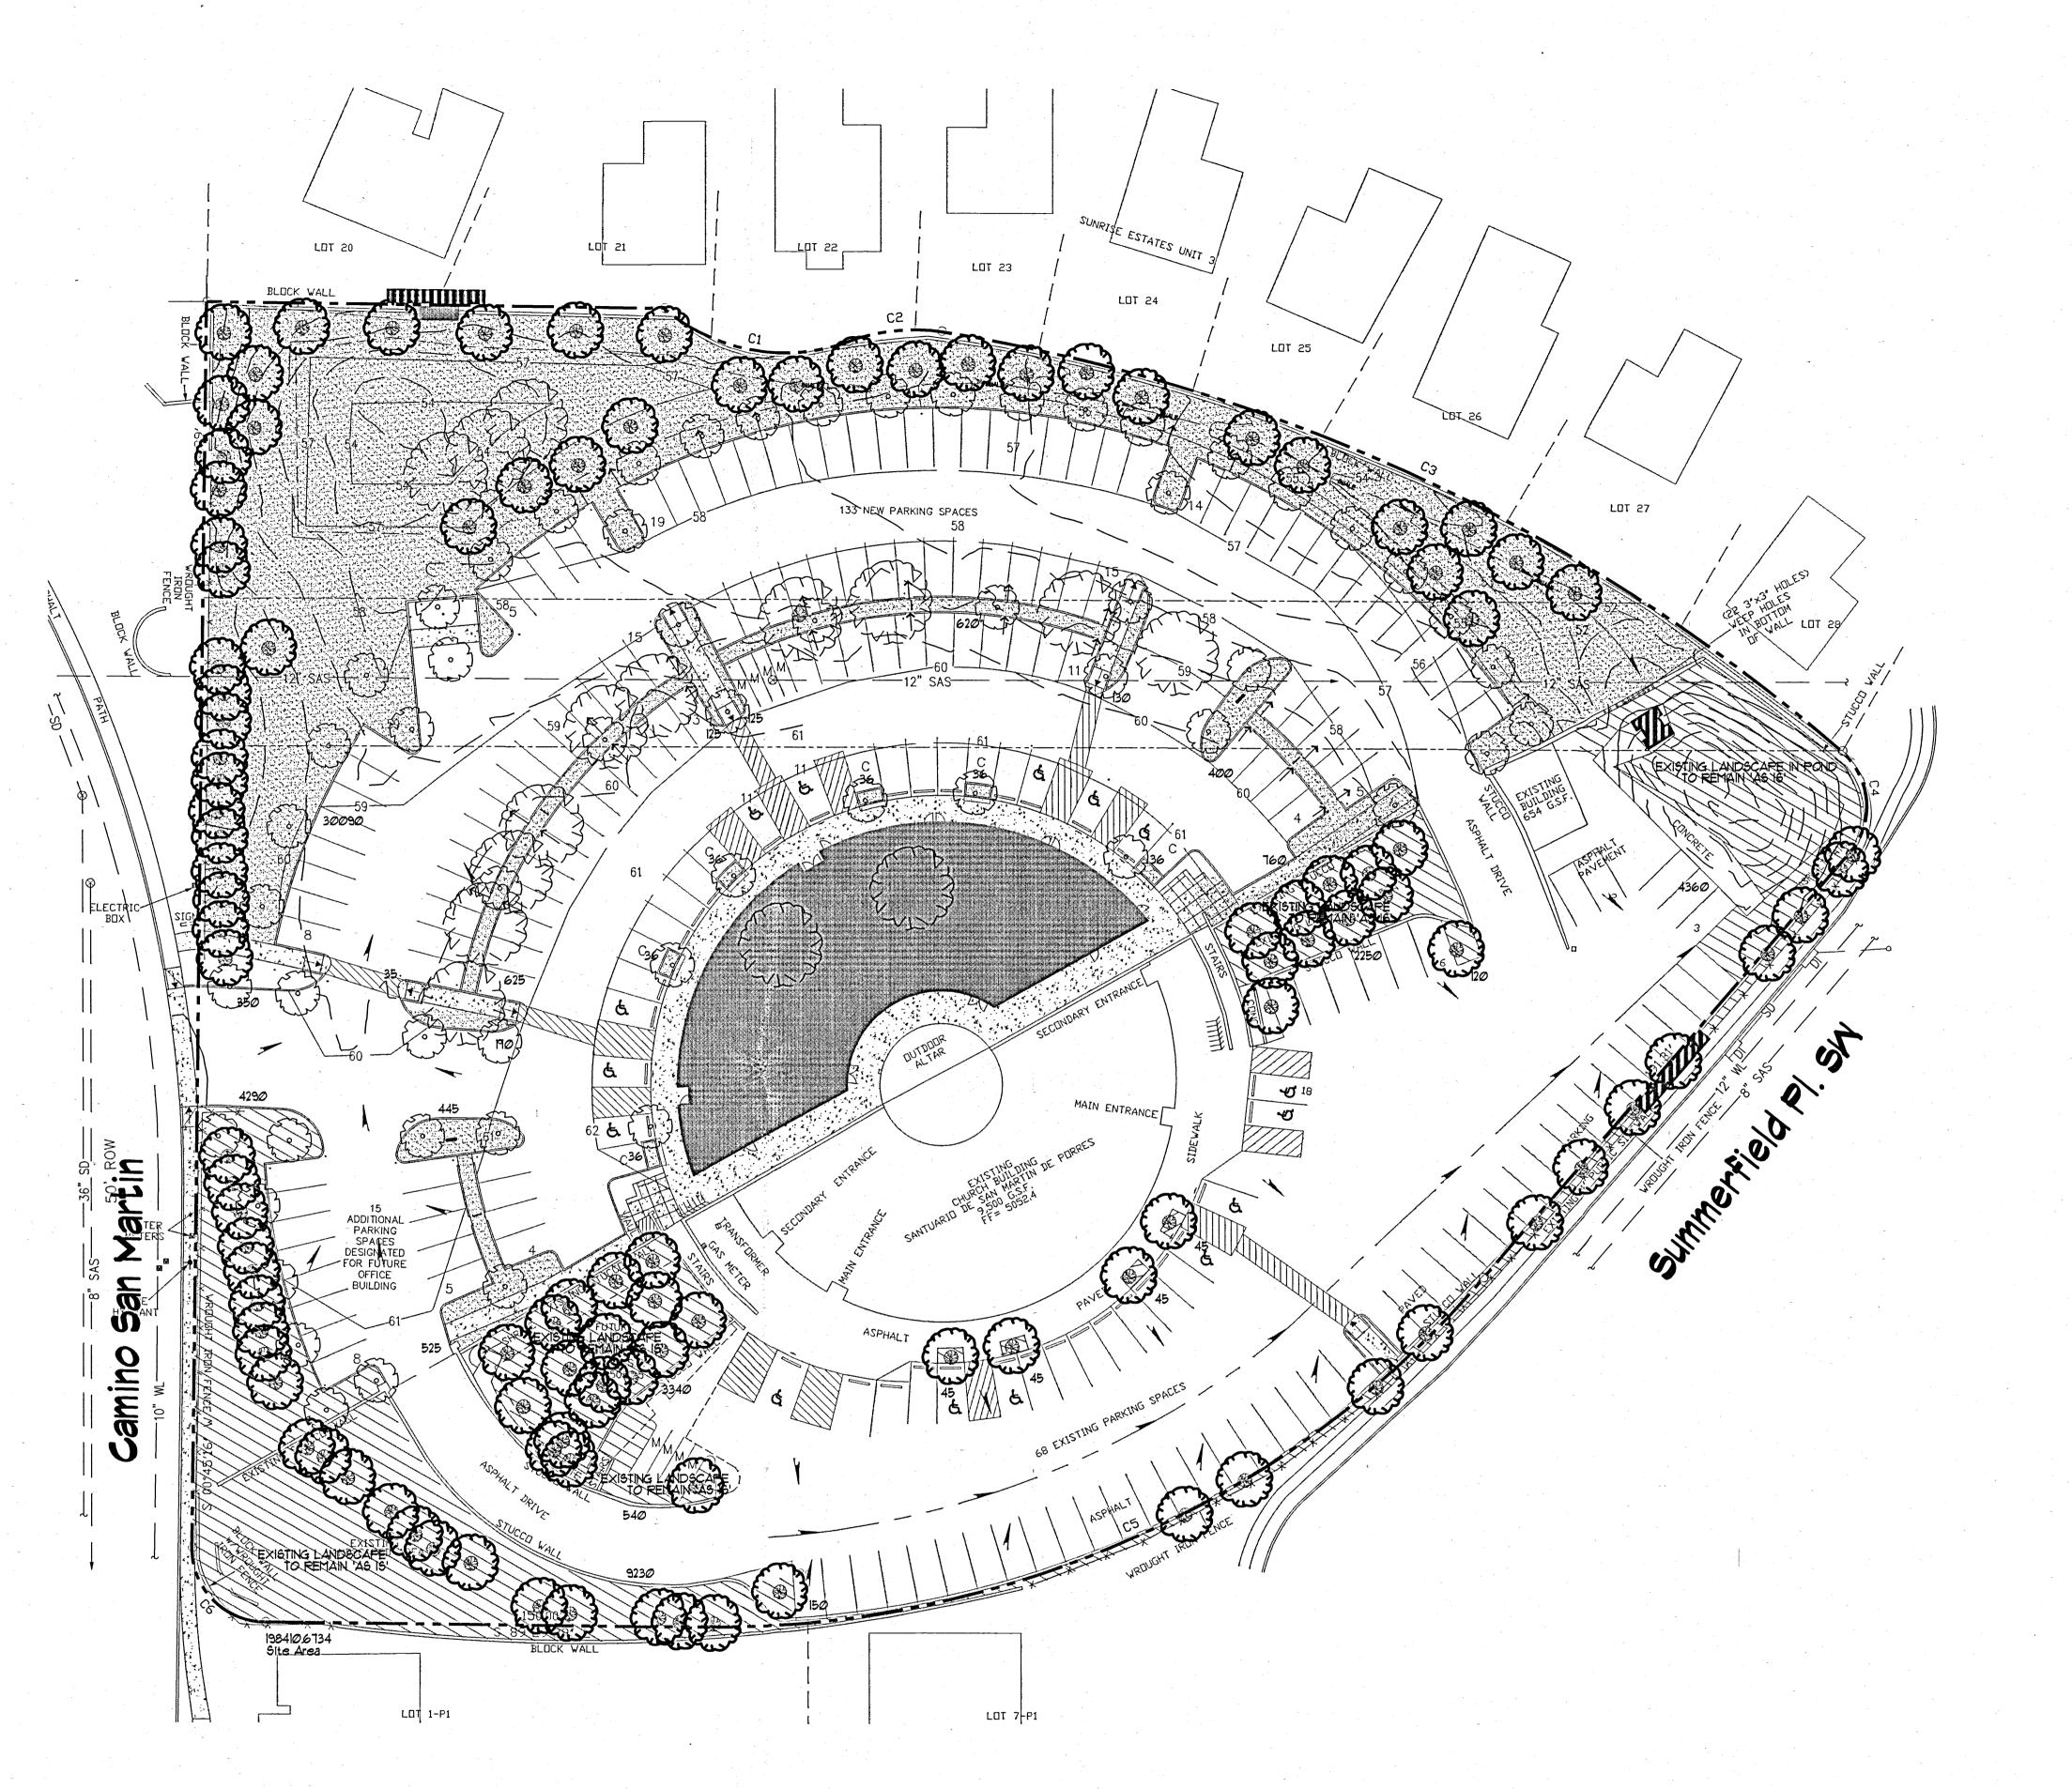
Mitchell Associates. LLC DANNY D. MITCHELL 239 Landscape Architects 3150 Carlisle Blvd. NE Suite 112 Albuquerque, NM 87110 (505) 830-6036

Project Number Drawn By DDM Checked Issue Date January 7, 2010 Proposed Landscape Plan AS SHOWN


Respond to Staff Planner Comment's

Revised Site Plan, Entrance, Walks

Sheet No. 2



Dem and Existing Landscape Plan

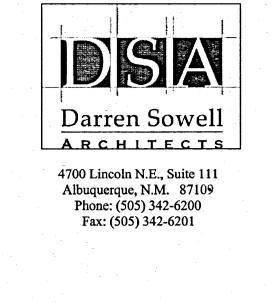




LANDSCAPE LEGEND


Existing Tree / To Be Removed

Existing Tree / To Remain

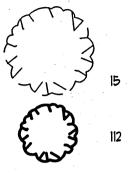Existing Landscape to Remain 'As Is'.



Proposed Landscape and Ponding Area's

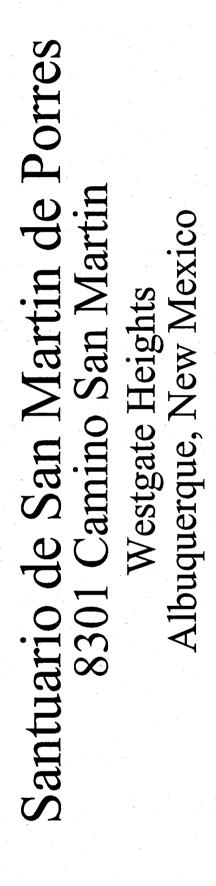

01262010 Respond to Staff Planner Comment's 02.01.2010 Revised Site Plan, Entrance, Walks

Project Number

Drawn By

Checked

DDM

Issue Date


January 7, 2010

Demo & Existing

Landscape AS SHOWN

Sheet No. 3 OF

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UTILITY NOTES

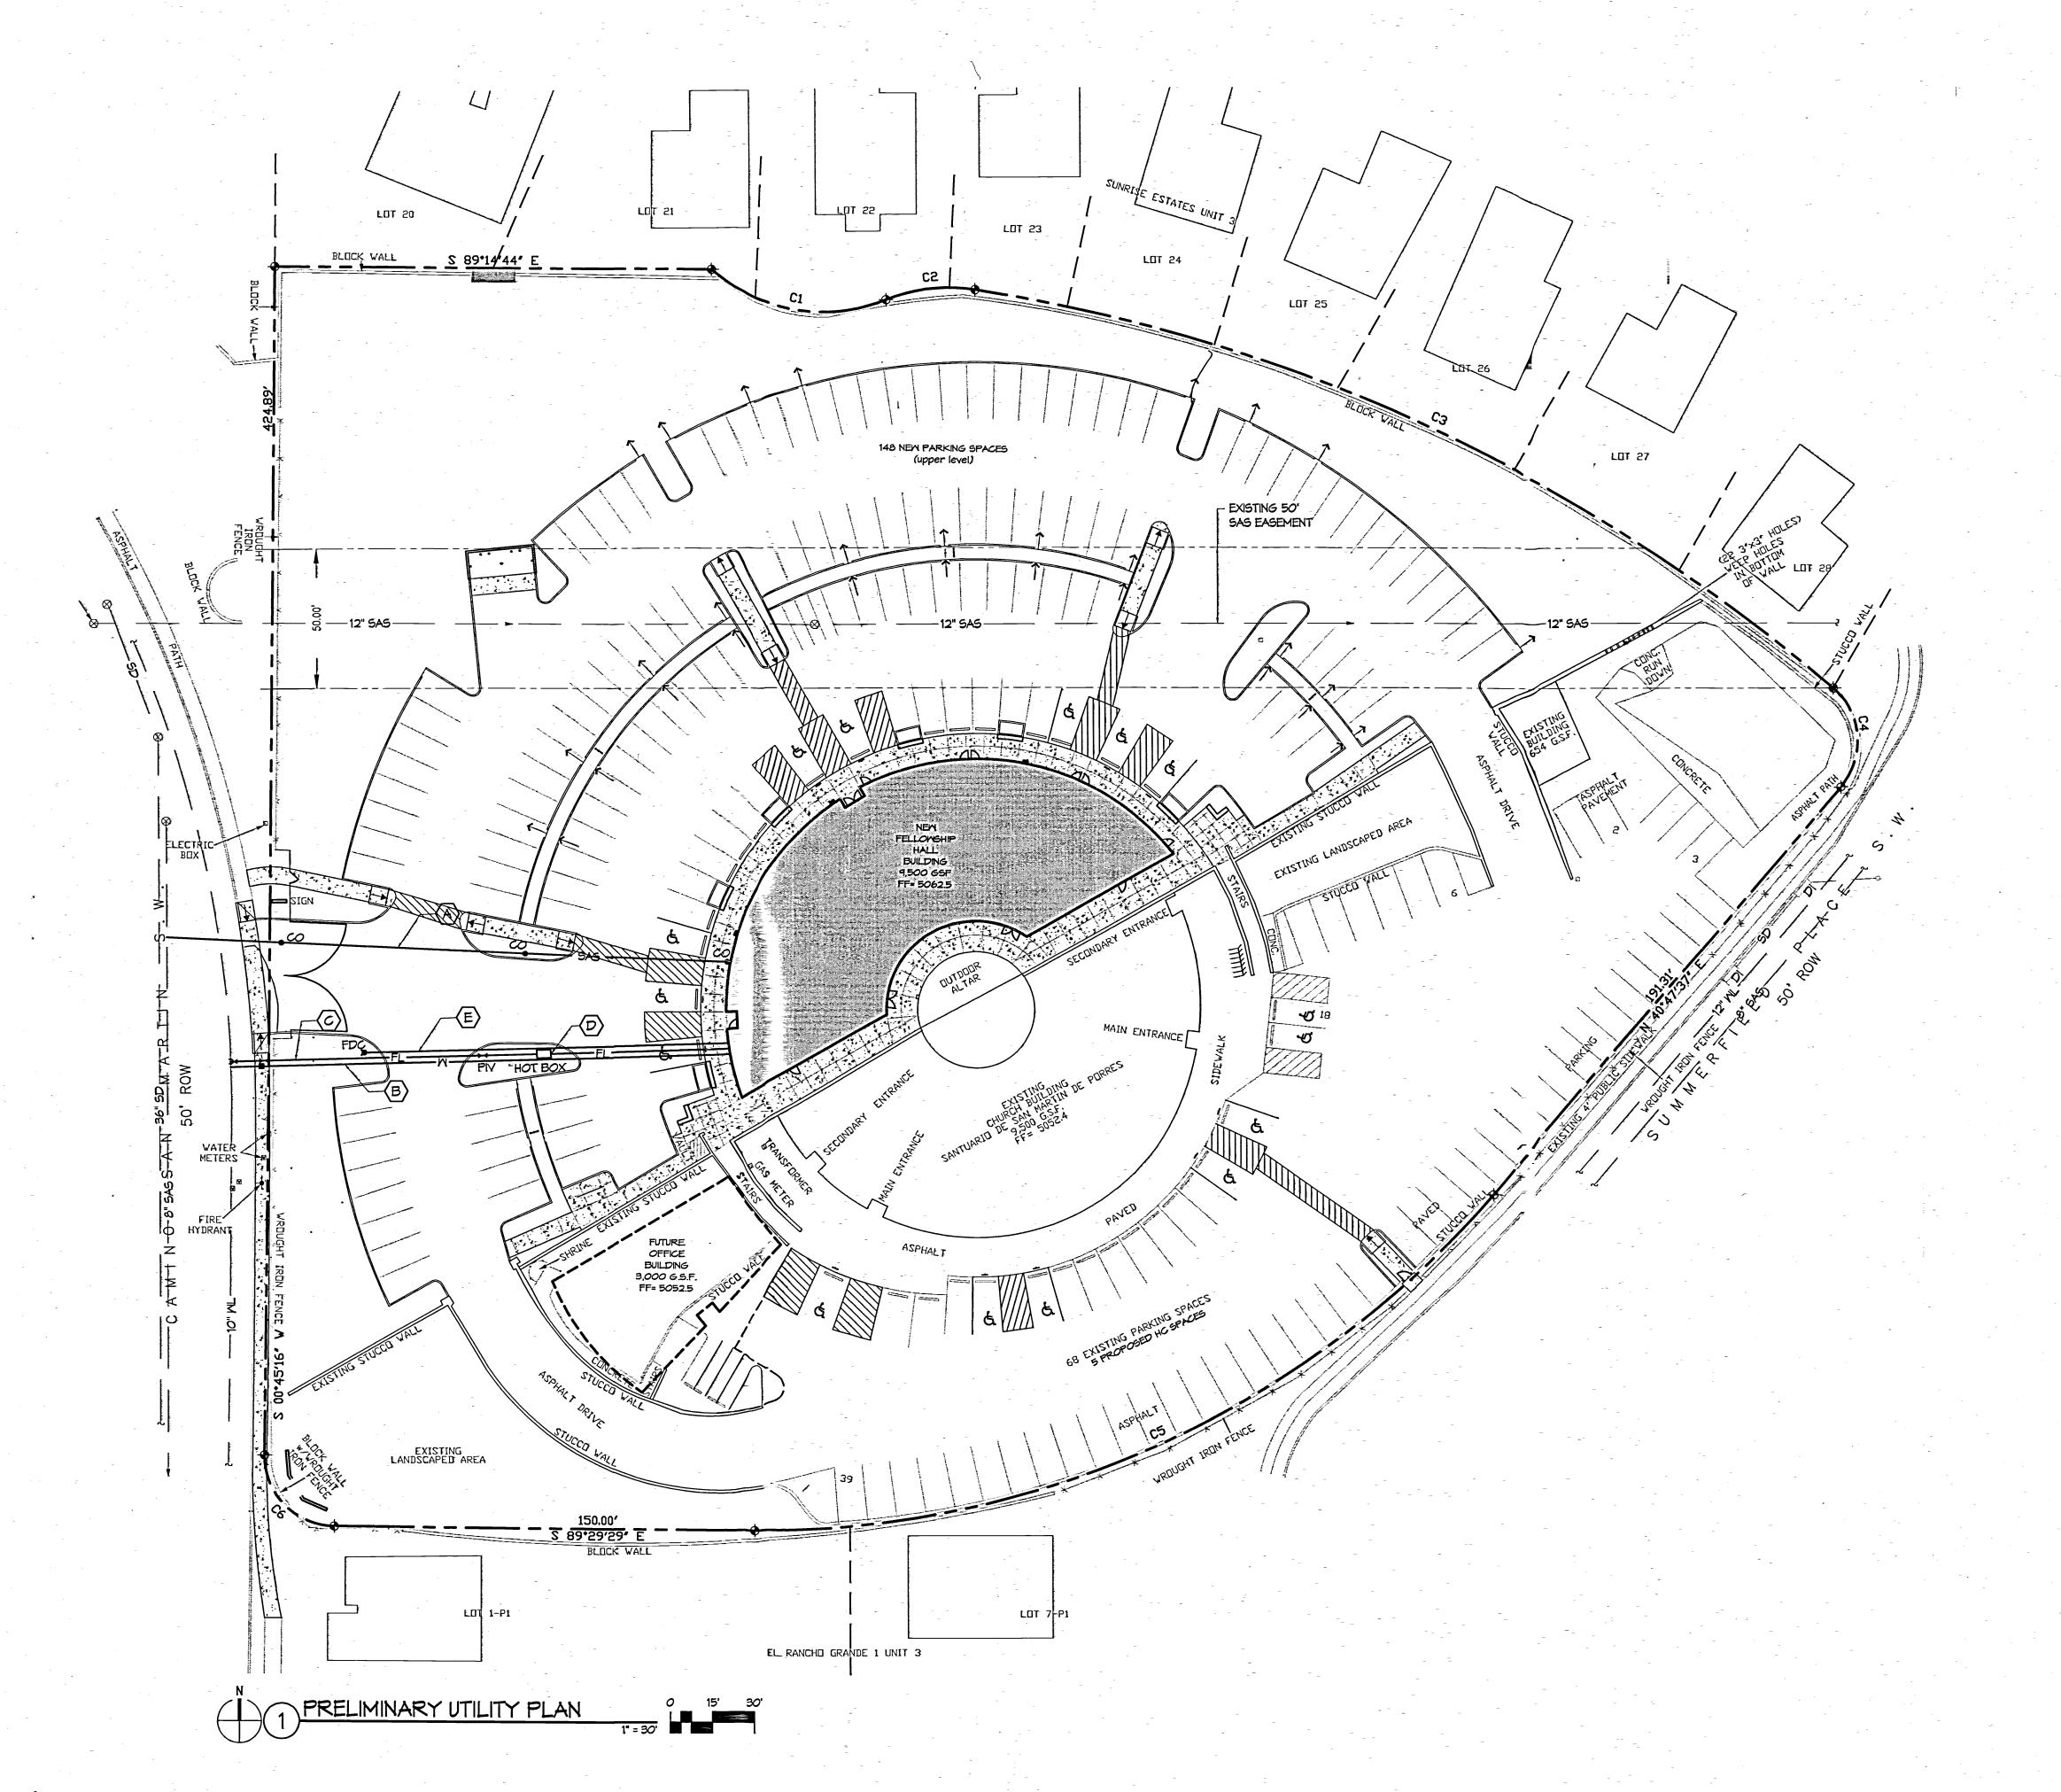- A. NEW 6" SANITARY SEWER SERVICE PER ABCWUA STD DWG. NO.
 B. NEW 2" DOMESTIC WATER SERVICE & METER PER ABCWUA STD DWG. NO.
 C. NEW PRIVATE BUILDING FIRELINE WITH POST INDICATOR VALVE AS SHOWN.
 D. NEW REDUCED PRESSURE BACKFLOW ASSEMBLY (RPBA) IN HOT BOX AS SHOWN.
 E. NEW REMOTE STANDPIPE (FDC) AS SHOWN.

LEGEND

- <u>-</u>		
 	-10" ML-	EXISTING WATERLINE W/ SIZE
	—8" SAS —	EXISTING SANITARY SEMER
	—36" SD—	EXISTING STORM DRAIN
	COTG	CLEAN OUT TO GRADE
_		EXISTING DROP INLET
	SAS	NEW SANITARY SEMER SERVICE
÷ 5	FL	NEW BUILDING FIRELINE
	PIV	POST INDICATOR VALVE
	FDC FDC	FIRE DEPARTMENT CONNECTIO


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Darren Sowell
ARCHITECTS


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CG-102



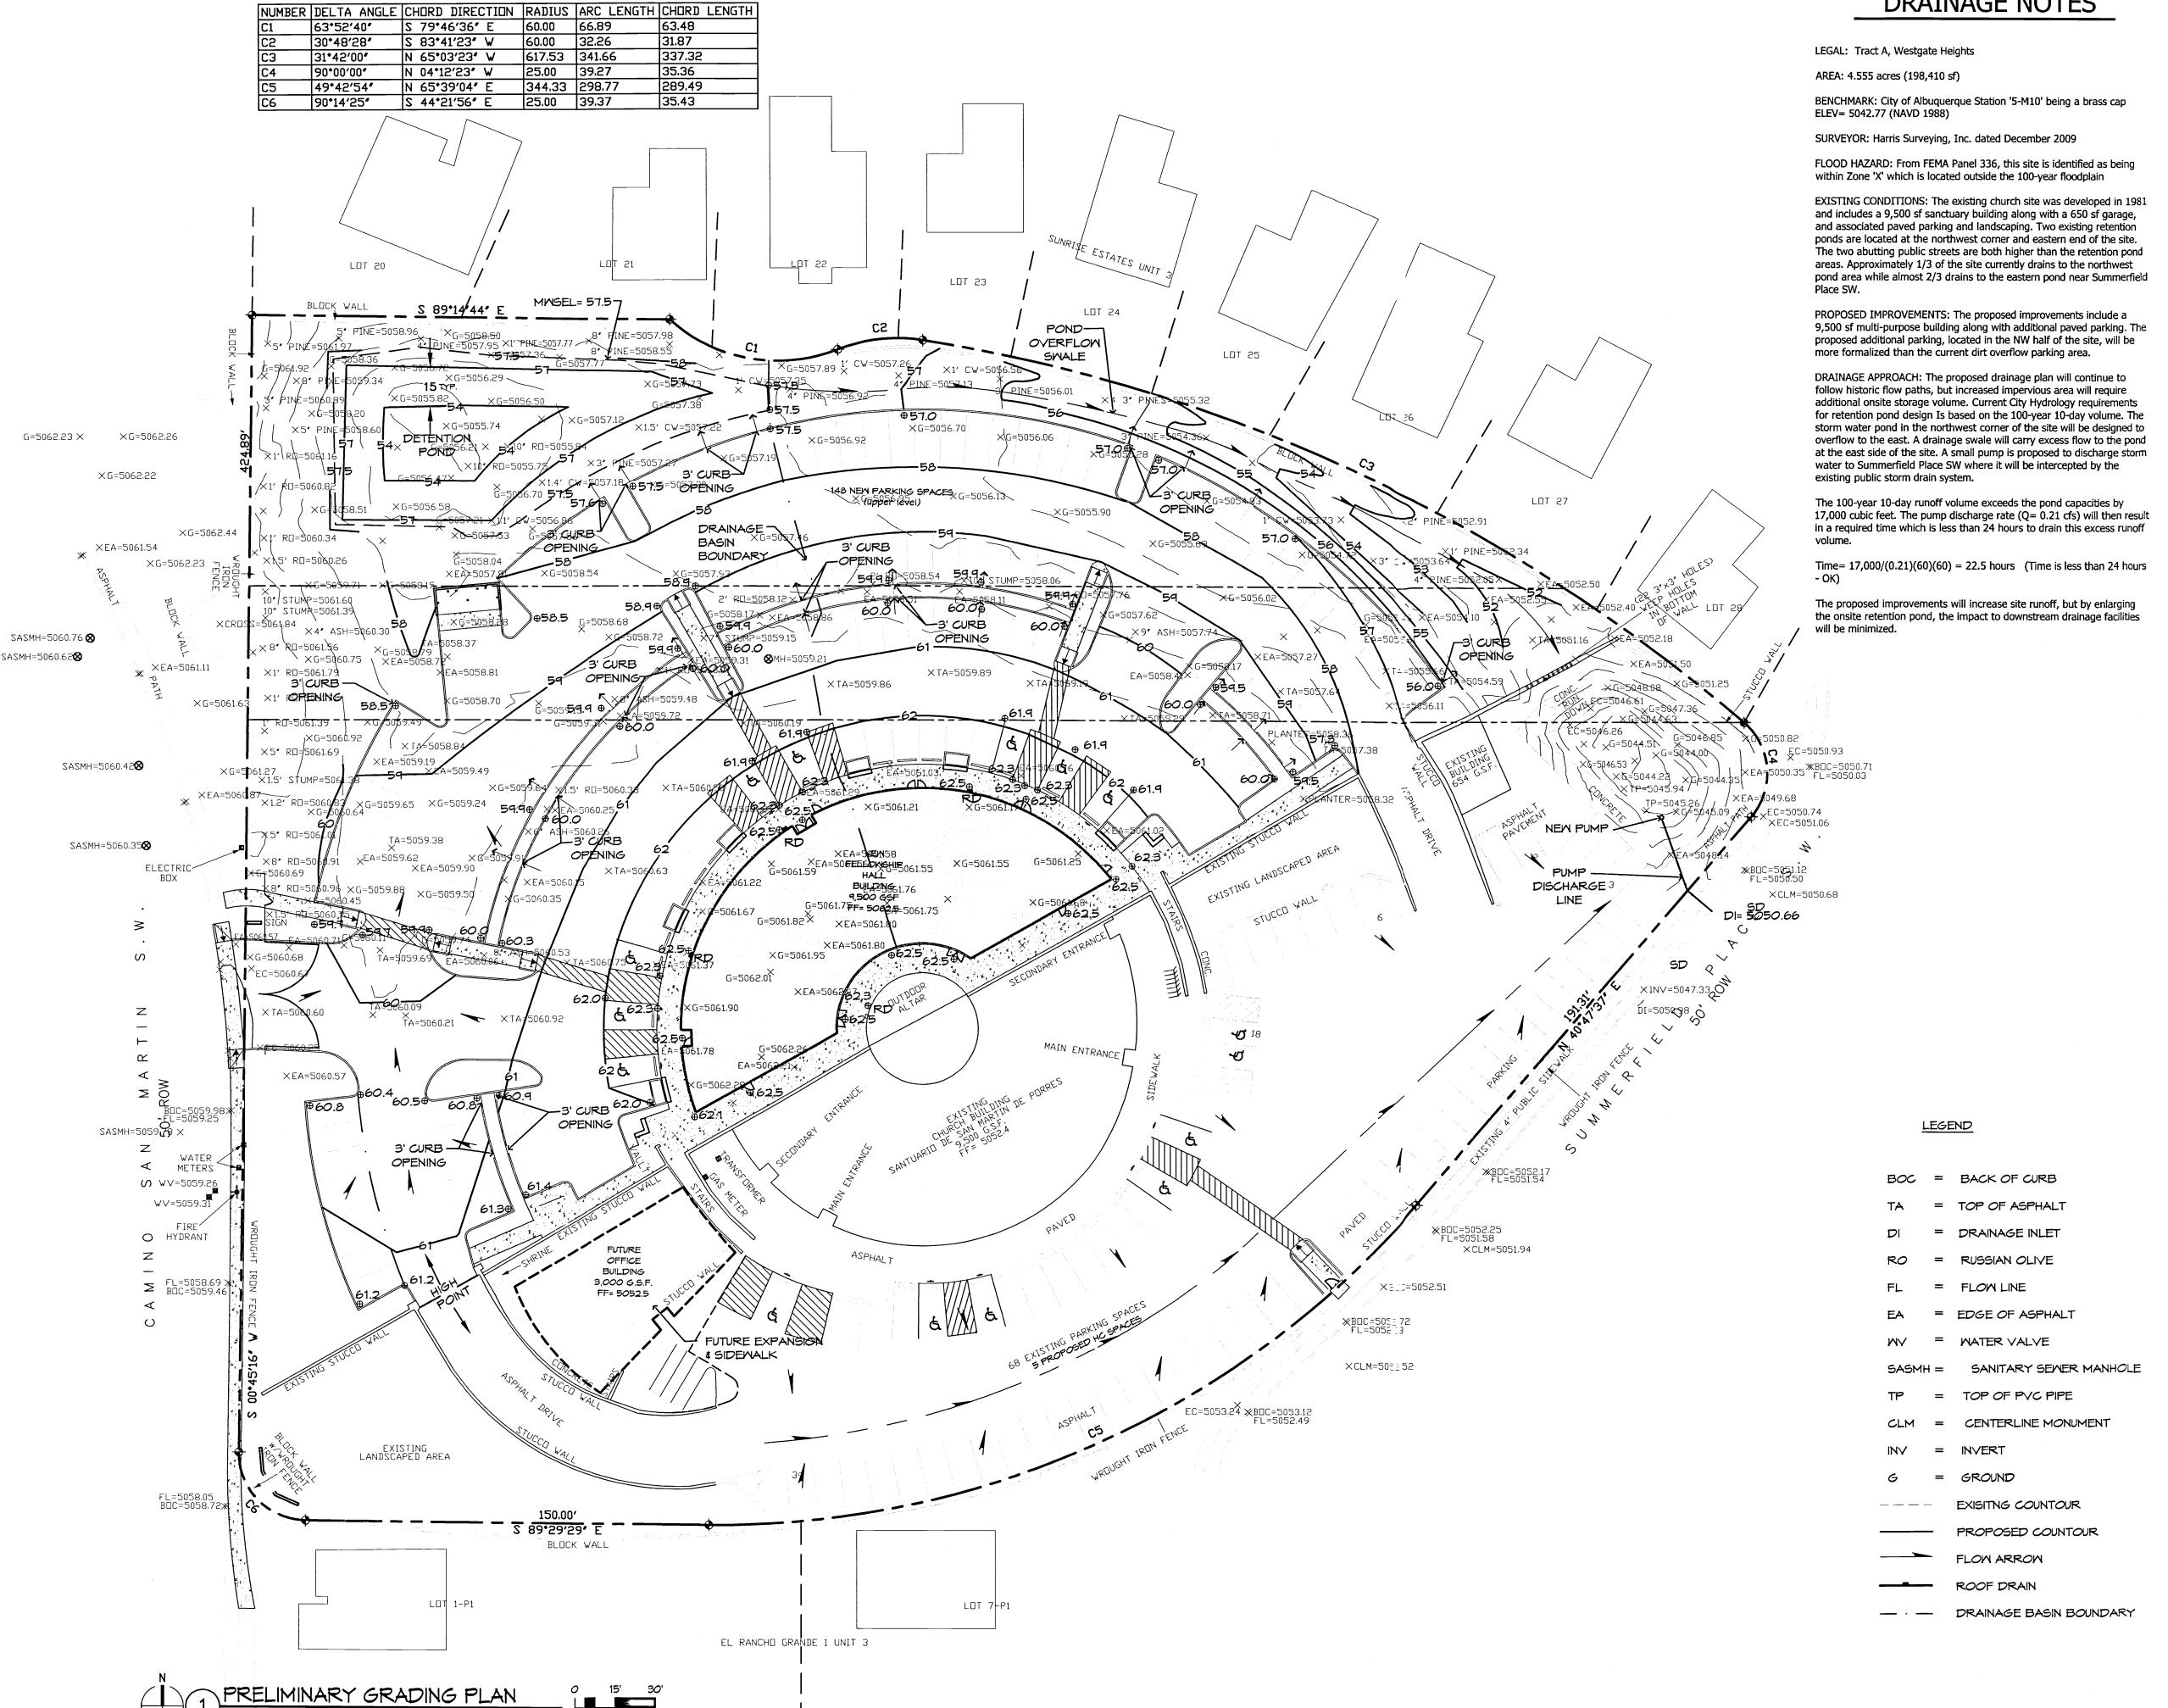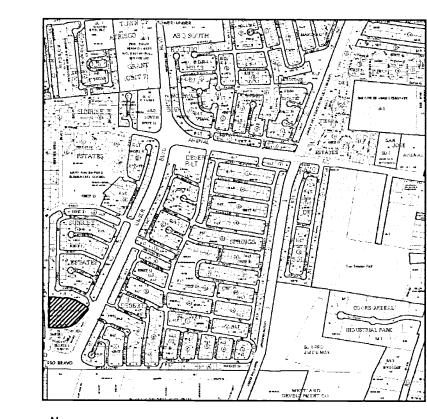DRAINAGE NOTES





VICINITY MAP M-10-Z

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Heights

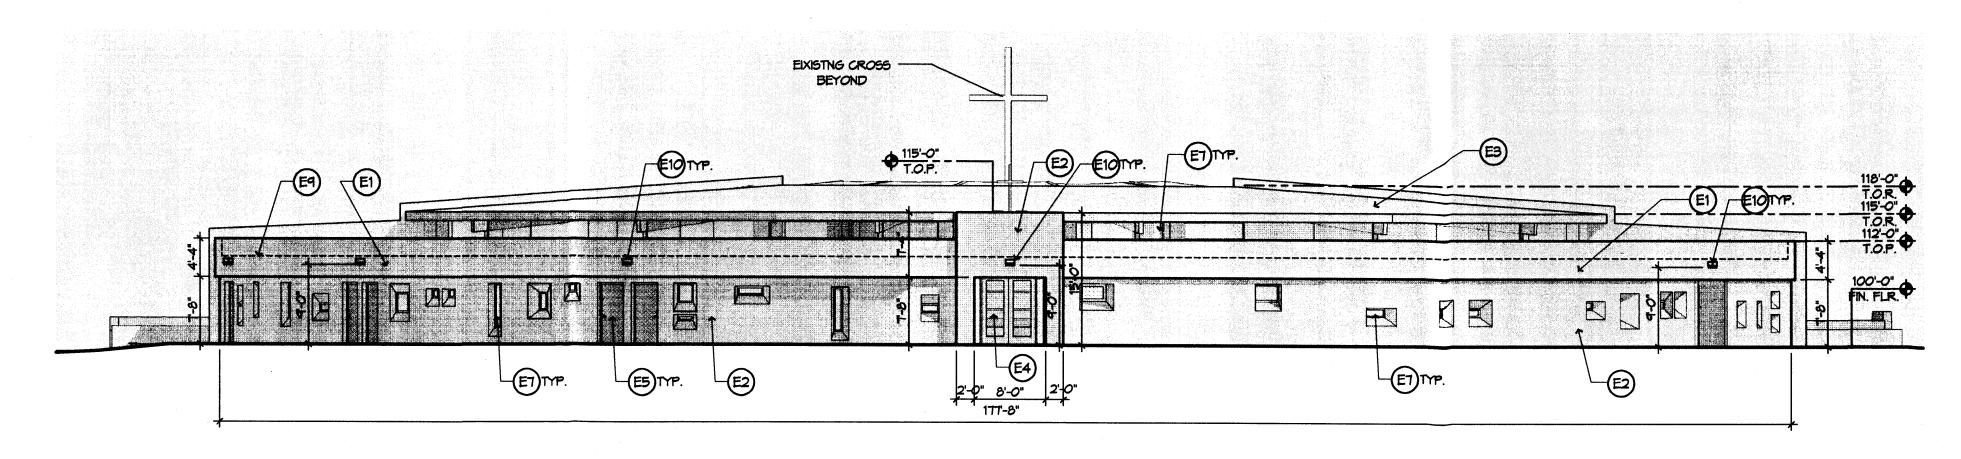
gate

Albuquera

Project Number Issue Date JANUARY 29, 2010 PRELIMINARY GRADING PLAN

Scale: AS SHOWN


SHEET 6 OF 8




EXTERIOR FINISH SCHEDULE COMMON COLOR NAME MFR. COLOR TAG MATERIAL / DESCRIPTION NOTES (E1) EIFS/STUCCO #122 STRAW EL REY ACRYLIC TAN #116 ADOBE E2 EIF5/STUCCO MATCH EXISTING COLOR ON SANCTUARY EL REY ACRYLIC BROWN STANDING SEAM METAL ROOFING SILVER LOW REFLECTIVE ULTRA SEAM METALIC COLOR INSULATED GLAZING ALUM STOREFRONT SYS. BRONZE ANODIZE BROWN KAWNEER # HOLLOW METAL DOOR & FRAME 14'X10' INSULATED GLAZING GARAGE DOORS SMOKEY TOPAZ SM 6117 PAINT TO MATCH "E2" BROWN OVERHEAD GARAGE DOOR BRONZE ANODIZE BROWN INSULATED GLAZING ALUM MINDOM SYS. BRONZE ANODIZE KAWNEER BROWN ROUGH SAWN GLUE LAMINATE BEAM MATCH EXISTING GLUELAM. © SANCTUARY WOOD TIMBER DOW ROOFING SYSTEMS TPO ROOFING SYSTEM MHITE MATCH EXISTING COLOR ON SANCTUARY BROWN

FUTURE 3,000 G.S.F. BUILDING- ELEVATIONS TO MATCH PROPOSED 9,500 G.S.F.ADDITION.

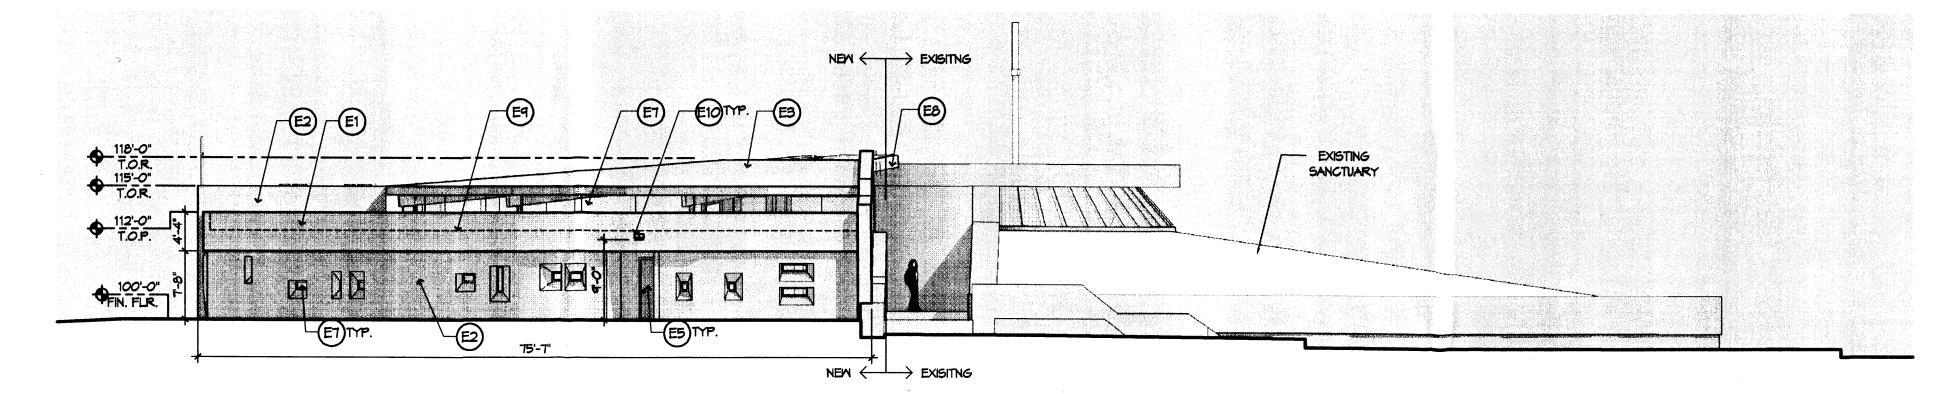
0 16' 32' 3/32"= 1'-0" BUILDING ELEVATION - NORTH



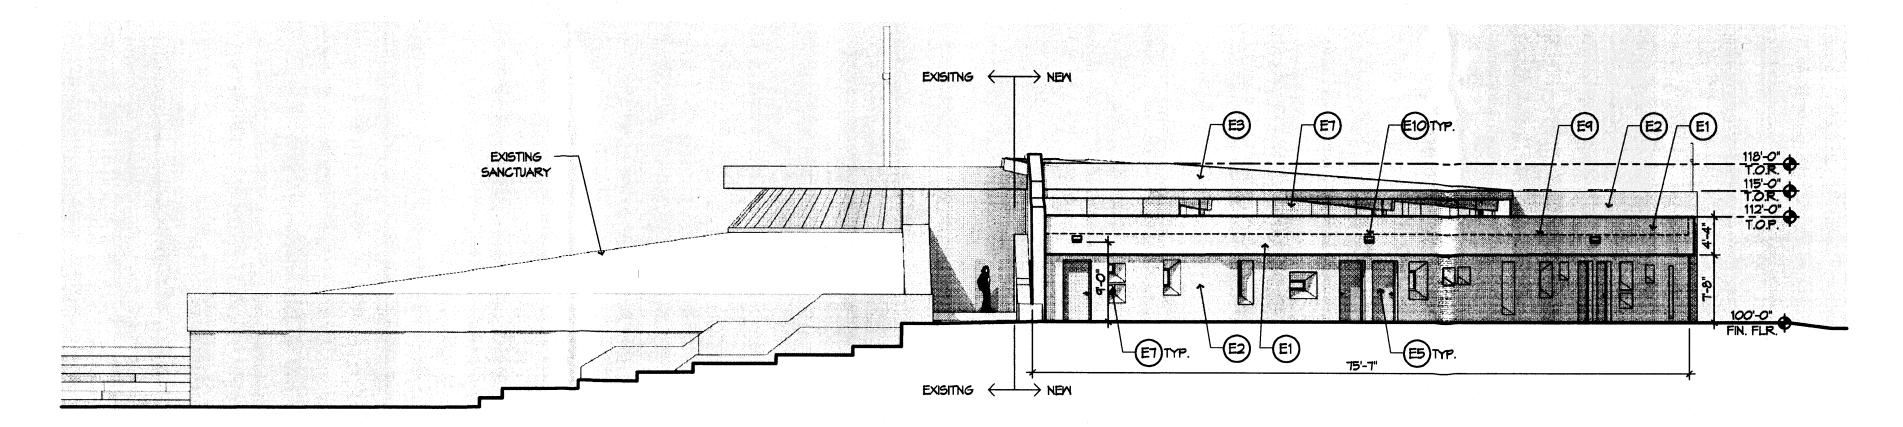(2) BUILDING ELEVATION - WEST 0 16' 32' 3/32"= 1'-0"



3 BUILDING ELEVATION -EAST

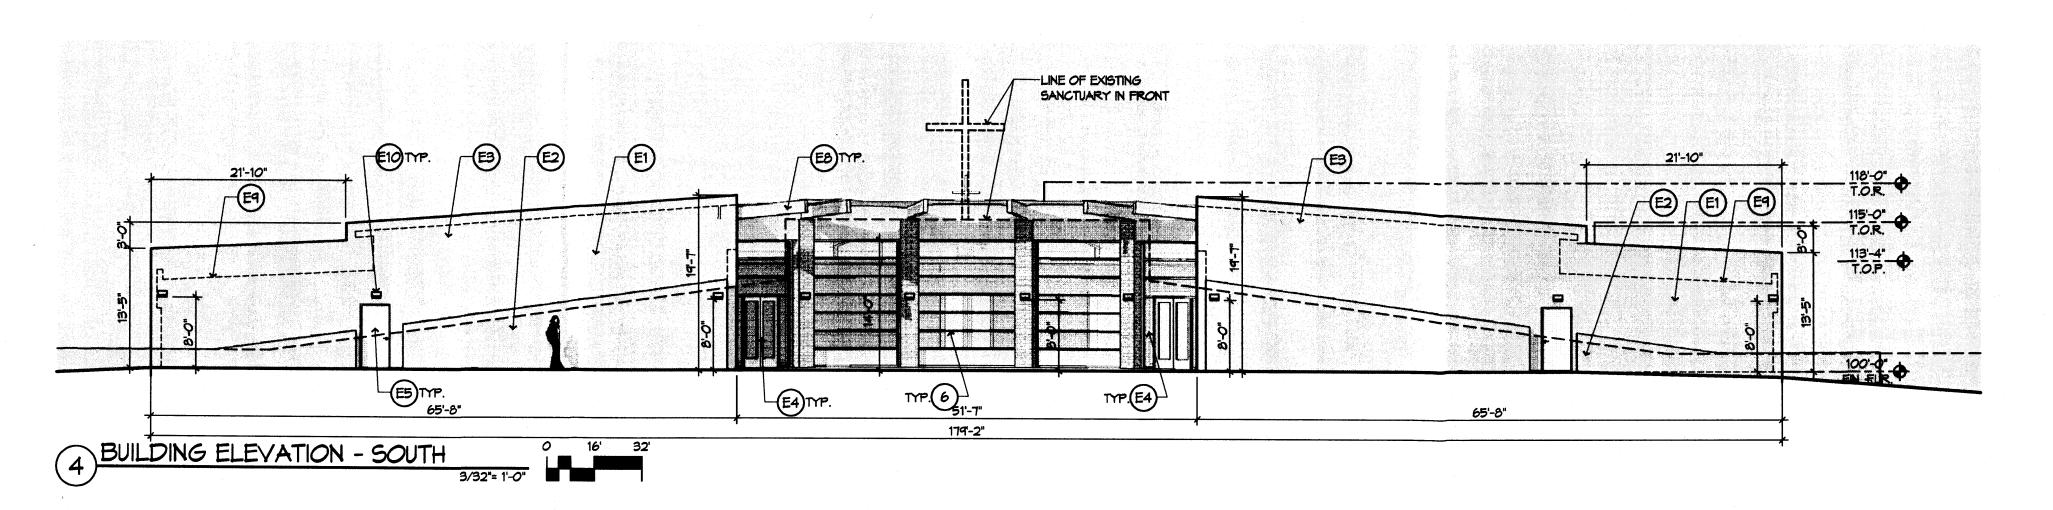

orres de San Martin de Camino San Martin Westgate Heights Albuquerque, New Mexico Santuario c 8301

DSA

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Project Number	
Drawn By	
Checked	
Issue Date	JANUARY 29, 2010
BUILDING	ELEVATION

Scale: AS SHOWN

INTRODUCTION

THE FOLLOWING DESIGN STANDARDS FOR SANTUARIO DE SAN MARTIN DE PORRES ARE ATTACHED TO AND MADE PART OF THE SITE PLAN FOR BUILDING PERMIT. THESE DESIGN STANDARDS ARE INTENDED TO ADDRESS AREAS OF THE SITE SHOWN FOR ILLUSTRATIVE PURPOSES, AND ARE PROVIDED TO ENSURE A CONSISTENT LEVEL OF DEVELOPMENT THROUGHOUT SANTUARIO DE SAN MARTIN DE PORRES. ALL SITE PLANS FOR BUILDING PERMIT MUST BE CONSISTENT WITH THESE STANDARDS. SITE PLANS FOR BUILDING PERMIT, WHICH ARE IN COMPLIANCE WITH THE DESIGN STANDARDS AND ILLUSTRATIVE SITE PLANS SHALL BE DELEGATED TO THE DEVELOPMENT REVIEW BOARD (DRB).

1. OVERALL DESIGN THEME

THE STYLE AND ARCHITECTURE OF SANTUARIO DE SAN MARTIN DE PORRES WAS INSPIRED BY A SMALL VILLAGE CHURCH IN PERU, WHICH THE FATHER AND MEMBERS OF THE SANTUARIO DE SAN MARTIN CONGREGATION VISITED IN THE 1970'S. FROM THERE, A "REPLICATED" DESIGN WAS CREATED AND A SITE DEVELOPMENT PLAN WAS APPROVED BY THE ENVIRONMENTAL PLANNING COMMISSION IN JUNE 1980 (PROJECT # Z-79-138). THIS PROJECT IS A CONTINUATION OF THAT VISION, RE-CREATING THE VILLAGE CHURCH VISITED SO LONG AGO IN PERU.

2. PERMITTED USES

SU-1 FOR CHURCH AND RELATED FACILITIES

SANTUARIO DE SAN MARTIN DE PORRES WILL BE A CHURCH AND WILL COMPLY WITH ALL PLANS ZONES AFFECTING THIS PROPERTY.

3. DESIGN STANDARDS

A. INTRODUCTION

THESE DESIGN STANDARDS ARE ESTABLISHED TO PROVIDE ASSURANCE THAT FUTURE DESIGN AND CONSTRUCTION WILL MEET THE COHESIVE STANDARDS OF QUALITY ESTABLISHED BY WHICH THESE ORIGINAL STRUCTURES ARE PRODUCED. THESE STANDARDS WILL ASSIST IN CREATING AN ATTRACTIVE CHURCH FACILITY AND WILL DEFINE A UNIFIED IMAGE FOR ARCHITECTURAL AND LANDSCAPE DESIGN THAT CREATES A DISTINCTIVE VISUAL IDENTITY.

B. STREETSCAPE

THE DEVELOPMENT OF AN IDENTITY THAT SYMBOLIZES THE MISSION AND HERITAGE OF SANTUARIO DE SAN MARTIN DE PORRES IS PARAMOUNT TO THE PARISHIONERS OF THE CHURCH, THE COMMUNITIES IT SERVES AND THE ARCHDIOCESE OF SANTA FE.

- LANDSCAPE BUFFERS SHALL BE PROVIDED TO ENSURE FLEXIBILITY FOR ENTRY, LANDSCAPING, SIDEWALK DEVELOPMENT AND OTHER PEDESTRIAN AMENITIES, AS WELL AS OPPORTUNITIES FOR VISUAL SCREENING AND ENVIRONMENTAL AMENITIES.
- ☐ LIVING PLANT MATERIALS SHALL COVER A MINIMUM OF 75 PERCENT OF THE REQUIRED LANDSCAPE AREA.
- ☐ LOW MATER USE TURF MAY BE PROVIDED AT A MAXIMUM OF 40 PERCENT OF THE REQUIRED LANDSCAPE AREA.
- ☐ HIGH WATER USE TURF IS NOT ALLOWED.
- MATERIALS FOR THE SEPARATION OF TURF AND PLANTING BEDS MAY BE CONCRETE, BRICK, OR SIMILAR QUALITY MATERIAL. STEEL EDGING IS NOT ALLOWED.

C. PARKING

THE INTENT OF THE STANDARDS FOR THE DEVELOPMENT OF PARKING AREAS IS TO PROVIDE ACCESSIBLE, SAFE CIRCULATION WITHIN AND ADJACENT TO THE PARKING AREAS.

- □ NO ON-STREET PARKING SHALL BE PROVIDED.
- ☐ PARKING SPACE STANDARDS SHALL BE IN ACCORDANCE WITH THE CITY OF ALBUQUERQUE'S COMPREHENSIVE ZONING CODE.
- ☐ ADA-COMPLIANT PARKING SHALL BE LOCATED ADJACENT TO MAIN BUILDING ENTRIES.
- LANDSCAPED ISLANDS SHALL BE DISTRIBUTED THROUGHOUT PARKING AREAS. PARKING AREAS VISIBLE FROM THE PUBLIC STREET SHALL INCLUDE AT LEAST ONE TREE FOR EVERY SIX PARKING SPACES, AND THE MAXIMUM DISTANCE FROM ANY PARKING SPACE TO A TREE SHALL BE 50 FEET.
- ☐ MOTORCYCLE, MOPED, AND MOTOR SCOOTER PARKING SHALL BE PROVIDED CLOSE TO BUILDING ENTRANCES PER CITY REGULATION ☐ 14-16-3-1 AND SHALL BE VISIBLE FROM BUILDING ENTRANCES.

D. BICYCLE FACILITIES

BICYCLE PARKING FOR PARISHIONERS SHALL BE PROVIDED TO PROMOTE ALTERNATIVE VEHICLE USE. ONE BICYCLE RACK SPACE PER 20 PARKING SPACES IS REQUIRED, AND SHALL BE CONVENIENTLY LOCATED NEAR BUILDING ENTRANCES, BUT NOT WITHIN PEDESTRIAN PATHWAYS OR LANDSCAPE AREAS.

E. SITE LANDSCAPE

LANDSCAPED AREAS SERVE TO ENHANCE THE VISUAL DYNAMIC OF THE DEVELOPMENT AND AID IN REINFORCING THE ENVIRONMENT.

THE PLANT PALETTE FOR SANTUARIO DE SAN MARTIN DE PORRES SHALL PROVIDE YEAR-ROUND COLOR AND INTEREST AND SHALL CONSIST OF REGIONALLY APPROPRIATE, LOM MATER USE PLANTS. A PALETTE OF HARDSCAPE MATERIALS WILL ALSO BE SELECTED FOR THE ENTIRE SITE TO FURTHER CONTRIBUTE TO THE SENSE OF VISUAL ENTITY.

- ALL LANDSCAPE PLANS SHALL COMPLY WITH THE CITY'S WATER CONSERVATION ORDINANCE, AND POLLEN ORDINANCE, AND ZONING CODE 14-16-3-10.
- □ MATER HARVESTING TECHNIQUES, INCLUDING SOME COMBINATION OF CURB CUTS FOR DRAINAGE TO LANDSCAPED AREAS, BIOSMALES TO SLOW AND TREAT STORM MATER RUNOFF, OR OTHER INNOVATIVE TECHNOLOGIES, ARE REQUIRED.
- LIVE PLANT MATERIALS SHALL COVER A MINIMUM OF 75 PERCENT OF ALL REQUIRED LANDSCAPED AREAS.
- LANDSCAPE HEADERS SHALL BE USED TO SEPARATE TURF AND PLANTING BEDS. HEADERS MAY BE CONCRETE, BRICK, STONE OR OTHER SIMILAR QUALITY MATERIAL. STEEL EDGING IS NOT ALLOWED.
- ☐ GRAVEL MULCH, COBBLE, AND SIMILAR MATERIALS ARE ACCEPTABLE AS A TOP DRESSING FOR LANDSCAPED AREAS, BUT ORGANIC MULCHES SHALL BE ENCOURAGED WHERE THE GRADE ALLOWS.
- AN AUTOMATIC UNDERGROUND IRRIGATION
 SYSTEM IS REQUIRED TO SUPPORT SITE
 LANDSCAPING. THE SYSTEM SHALL BE DESIGNED
 TO MAXIMIZE EFFICIENCY AND AVOID
 OVER-SPRAYING ONTO WALKS, BUILDINGS,
 FENCES, WALLS, ETC.
- ALL PLANT MATERIAL SHALL BE MAINTAINED BY THE OWNER IN A LIVING, ATTRACTIVE CONDITION. THIS INCLUDES PROPER MAINTENANCE OF THE IRRIGATION SYSTEM AND REMOVAL OF WEEDS, TRASH, OR DEBRIS.
- ☐ MINIMUM PLANT MATERIAL SIZES AT THE TIME OF INSTALLATION SHALL BE AS FOLLOWS:

CANOPY TREES - 2" CALIPER B4B OR BOXED

EVERGREEN TREES - 8 FOOT MINIMUM HEIGHT

ACCENT TREES - 1 1/2" CALIPER B&B OR BOXED MULTITRUNK TREES - 15-GALLON MINIMUM SHRUBS, ORNAMENTAL GRASSES AND

GROUND COYERS - 1 GALLON MINIMUM

I. ARCHITECTURE

IN GENERAL, ALL BUILDINGS SHALL COMPLY WITH THE CURRENT CITY OF ALBUQUERQUE ZONING CODE AND ALL APPLICABLE SECTOR PLAN, POLICIES, AND ORDINANCES. HOWEVER, IN CASES WHERE THE SANTUARIO DE SAN MARTIN DE PORRES REQUIREMENTS EXCEED THE ZONING CODE, THE SANTUARIO DE SAN MARTIN DE PORRES CENTER STANDARDS WILL GOVERN. THE FOCUS OF THESE ARCHITECTURAL STANDARDS AND GUIDELINES IS TO PROMOTE CONSISTENCY AND CONTINUITY IN RELATION TO BUILDING AESTHETICS AND DESIGNS.

MATERIALS AND COLORS

BUILDINGS SHOULD CONVEY SOLIDITY AND DURABILITY AND EMPLOY HIGH QUALITY MATERIALS. MATERIALS AND COLORS SHOULD PAY HOMAGE TO THE VERNACULAR ARCHITECTURE OF THE EXISTING SANTUARIO DE SAN MARTIN DE PORRES BUILDING. ACCEPTABLE MATERIALS INCLUDE: STUCCO, PAINTED METAL, MOOD, AND EIFS. ARCHITECTS SHALL USE THOSE MATERIALS TRADITIONALLY USED IN THE ALBUQUERQUE OR NEW MEXICO AREA.

ACCEPTABLE COLORS INCLUDE: TAN (#122 STRAW), BROWN (#116 ADOBE) AND BROWN (SM6117 SMOKY TOPAZ) BRONZE ANODIZE. THE USE OF ACCENT COLORS AND MATERIALS IS ENCOURAGED TO BRING OUT DETAILING TO BETTER ARTICULATE OR GIVE SCALE TO A BUILDING, WOOD TRIM, PAINT, METAL, ETC.

NO METAL OR PLAIN CONCRETE BUILDINGS SHALL BE ALLOWED.

PROHIBITED BUILDING MATERIALS INCLUDE THE FOLLOWING:
PLASTIC OR VINYL BUILDING PANELS,
AWNINGS, OR CANOPIES
EXPOSED, UNTREATED PRECISION BLOCK
OR WOOD
HIGHLY REFLECTIVE SURFACES

BUILDING HEIGHTS

BUILDING HEIGHT MAXIMUM 26 FT.

CONTEXT

NEM BUILDINGS SHALL BE DESIGNED TO HARMONIZE WITH ADJACENT BUILDINGS.

BUILDING ARTICULATION/DESIGN

BUILDINGS SHALL CONVEY AN IMAGE APPROPRIATE TO A NEIGHBORHOOD CHURCH AND RELATED Facilities.

BUILDINGS SHALL BE SENSITIVE TO THE LOCAL CHARACTER OF THE REGION AND THE VERNACULAR ELEMENTS OF BUILDINGS.

EQUIPMENT

ALL ROOF TOP EQUIPMENT AND APPURTENANCES SHALL BE BELOW THE TOP OF THE PARAPET, OR ARCHITECTURALLY SCREENED WITH A VISUALLY SURROUND THAT IS COMPATIBLE WITH THE PREDOMINANT BUILDING MATERIALS AND COLOR. ROOF PENETRATIONS THAT ARE NOT ARCHITECTURALLY SCREENED WITH A VISUALLY SURROUND SHALL BE PAINTED TO MATCH ROOF COLOR OR GENERAL BUILDING COLOR.

ALL GROUND EQUIPMENT SHALL BE
ARCHITECTURALLY SCREENED AND ENCLOSED,
WITH THE TOP OF THE EQUIPMENT BELOW THE
TOP OF THE SCREEN. THIS INCLUDES, BUT IS
NOT LIMITED TO: WATER BACKFLOW
PREVENTERS, GAS METERS, ELECTRIC
METERS, EXPOSED CONDUIT, CABLING, AND
WIRING.

TRANSFORMERS UTILITY PADS AND
TELEPHONE BOXES SHALL BE APPROPRIATELY
SCREENED WITH WALLS AND/OR VEGETATION
WHEN VIEWED FROM THE PUBLIC
RIGHT-OF-WAY BUT IN SUCH A WAY THAT IS
ACCEPTABLE TO THE AFFECTED SERVICE
PROVIDER TO ENSURE SAFETY AND ACCESS
FOR MAINTENANCE, REPAIR, AND
REPLACEMENT OF EQUIPMENT.

PORTABLE BUILDINGS

PERMANENT PORTABLE BUILDINGS ARE NOT ALLOWED IN SANTUARIO DE SAN MARTIN DE PORRES.

PERMANENT PORTABLE BUILDINGS SHALL BE FINISHED TO MATCH THE PRIMARY MATERIALS OF THE OVERALL BUILDING.

SUSTAINABILITY

GREEN ARCHITECTURAL DESIGN AND CONSTRUCTION HAS BEEN IMPLEMENTED WHENEVER POSSIBLE. SANTUARIO DE SAN MARTIN DE PORRES USES SUSTAINABLE DESIGN PRINCIPLES, ENVIRONMENTALLY RESPONSIBLE BUILDING CONCEPTS AND PRACTICES, AND EARTH-FRIENDLY PRODUCTS.

- LOW WATER USE TURF MAY BE PROVIDED AT A MAXIMUM OF 40 PERCENT OF THE LANDSCAPED AREA.
- ☐ HIGH WATER USE TURF WILL NOT BE ALLOWED.
- ☐ ALL LANDSCAPE PLANS COMPLY WITH THE CITY'S WATER CONSERVATION ORDINANCE AND POLLEN ORDINANCE.
- ☐ WATER HARVESTING TECHNIQUES, INCLUDING SOME COMBINATION OF CURB CUTS FOR DRAINAGE TO LANDSCAPED AREAS, BIOSWALES TO SLOW AND TREAT STORM WATER RUNOFF ARE REQUIRED.
- AN AUTOMATIC UNDERGROUND IRRIGATION SYSTEM WILL BE INSTALLED TO SUPPORT SITE LANDSCAPING. THE SYSTEM SHALL BE DESIGNED TO MAXIMIZE EFFICIENCY AND AVOID OVER-SPRAYING ONTO WALKS, BUILDINGS, FENCES, WALLS, ETC.

J. LIGHTING

A CONSISTENT THEME FOR THE LIGHTING FIXTURES MILL CONTRIBUTE SIGNIFICANTLY TO SANTUARIO DE SAN MARTIN'S OVERALL AESTHETIC CHARACTER. SAFETY AND SECURITY SHALL BE THE PRIMARY DESIGN CONSIDERATION, AS WELL AS THE DAYTIME APPEARANCE OF THE LIGHT FIXTURES.

- LIGHTING SHALL BE FULLY SHIELDED HORIZONTAL LAMPS SO THAT NO FUGITIVE LIGHT MAY ESCAPE BEYOND THE PROPERTY LINE AND NO LIGHT SOURCE SHALL BE VISIBLE FROM THE SITE PERIMETER.
- $\hfill\square$ LIGHT FIXTURES SHALL NOT EXCEED 16' IN HEIGHT.
- ☐ THE PATTERN OF LIGHT POOLING FROM EACH FIXTURE SHALL AVOID GLARE OR REFLECTION ON ADJACENT PROPERTIES, BUILDINGS, OR ROADWAYS.
- ☐ THE USE OF ENERGY EFFICIENT LIGHTING IS REQUIRED.

K. SCREENING/BUFFERING

- MECHANICAL EQUIPMENT WHETHER ON ROOF AREAS OR AT STREET LEVEL, SHALL BE FULLY SCREENED FROM PEDESTRIANS OR MOTORISTS. SCREENING SHALL BE COMPATIBLE WITH MATERIALS AND DESIGN OF THE BUILDING.
- ☐ THE USE OF BARBED WIRE, WOOD FENCING, OR PLASTIC VINYL FENCING IS NOT PERMITTED.
- REFUSE ENCLOSURES SHALL SCREENED WITH WALLS OF THE SAME MATERIAL AS THE BUILDING ITSELF.




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Project Number
Prawn By
Checked
ssue Date JANUARY 29, 2010
DESIGN STANDARDS

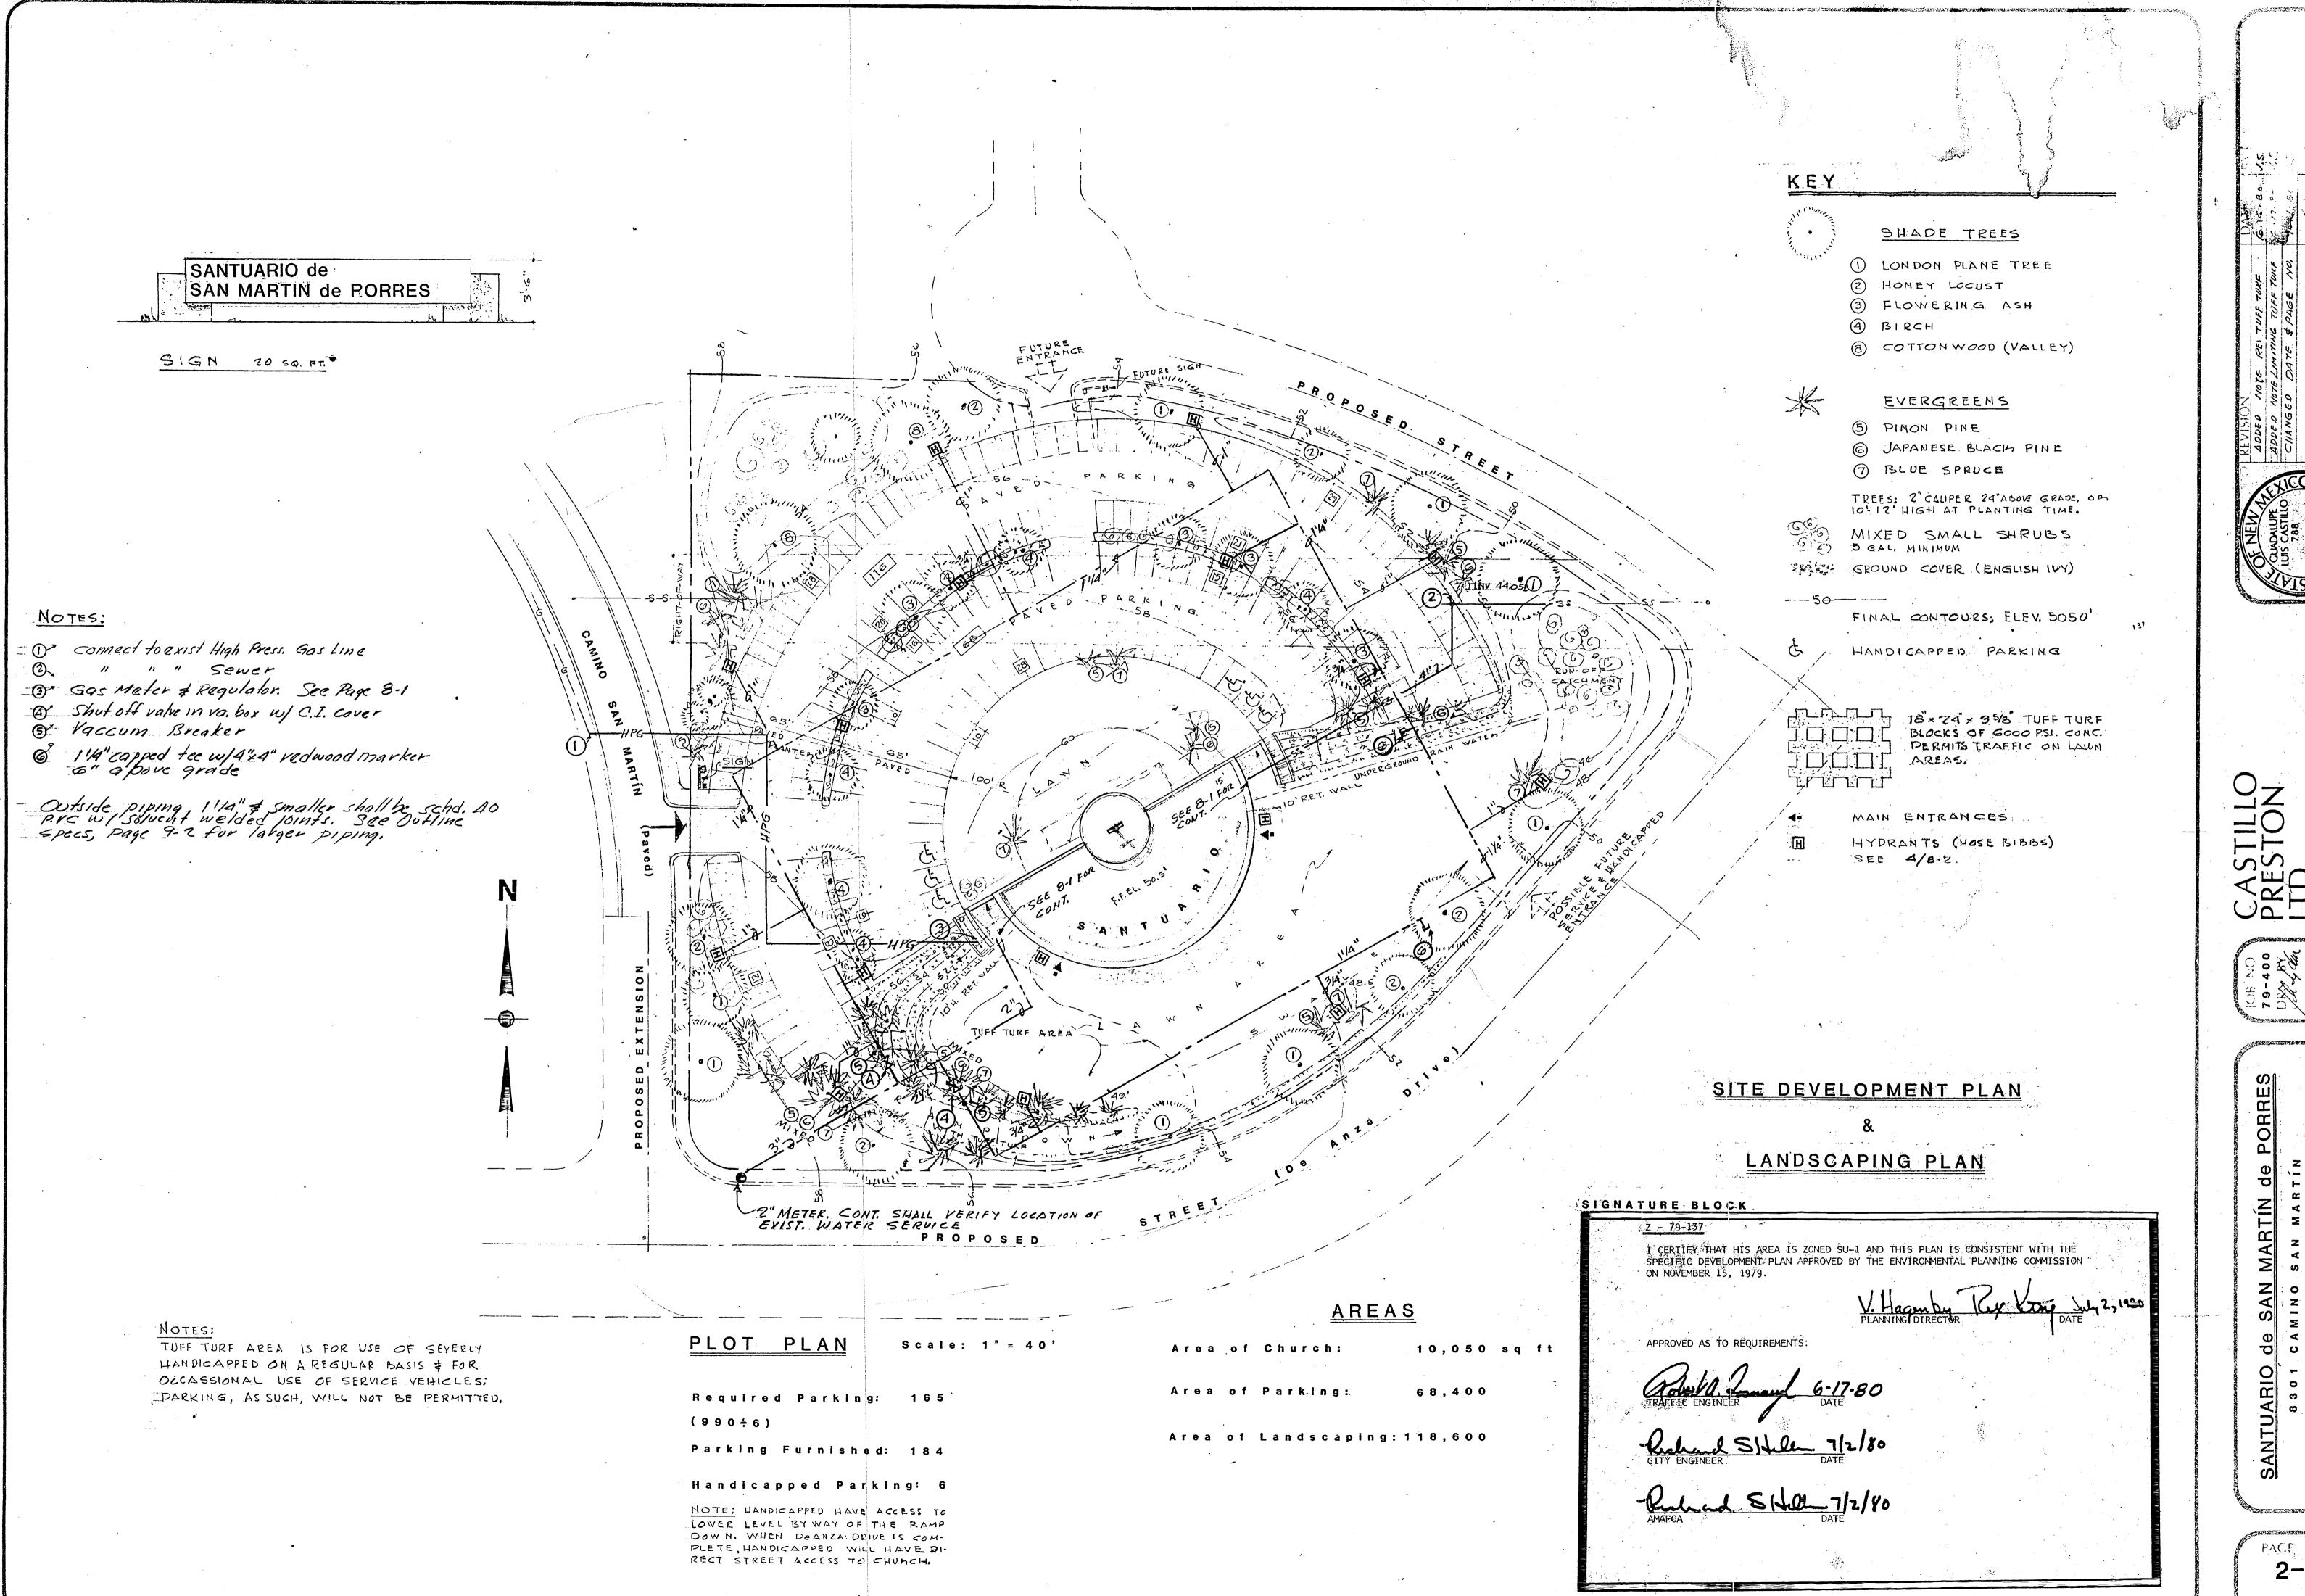Scale: AS SHOWN





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