

PROJECT # 1008147

LEGEND

SIGN LOCATIONS ARE APPROXIMATE. ALL TRAFFIC CONTROL DEVICES SHALL BE IN ACCORDANCE WITH CITY OF ALBUQUERQUE AND MUTCD STANDARDS




GENERAL NOTES

1. THIS PROJECT SHALL BE CONSTRUCTED IN ACCORDANCE WITH THE CITY OF ALBUQUERQUE STANDARD SPECIFICATIONS FOR CONSTRUCTION.
2. CONTRACTOR SHALL REFERENCE ARCHITECTURAL SHEETS FOR ALL DEMOLITION WORK.
3. ALL STRIPING AND SIGNING SHALL CONFORM TO MUTCD STANDARDS OR CITY OF ALBUQUERQUE STANDARDS WHICHEVER IS MORE RESTRICTIVE.

KEY NOTES

- ① RETROREFLECTORIZED 4" SOLID WHITE STRIP.
- ② 12" WIDE PAINTED WHITE STOP BAR.
- ③ DIRECTION OF TRAVEL ARROW PAINTED ON ROADWAY.

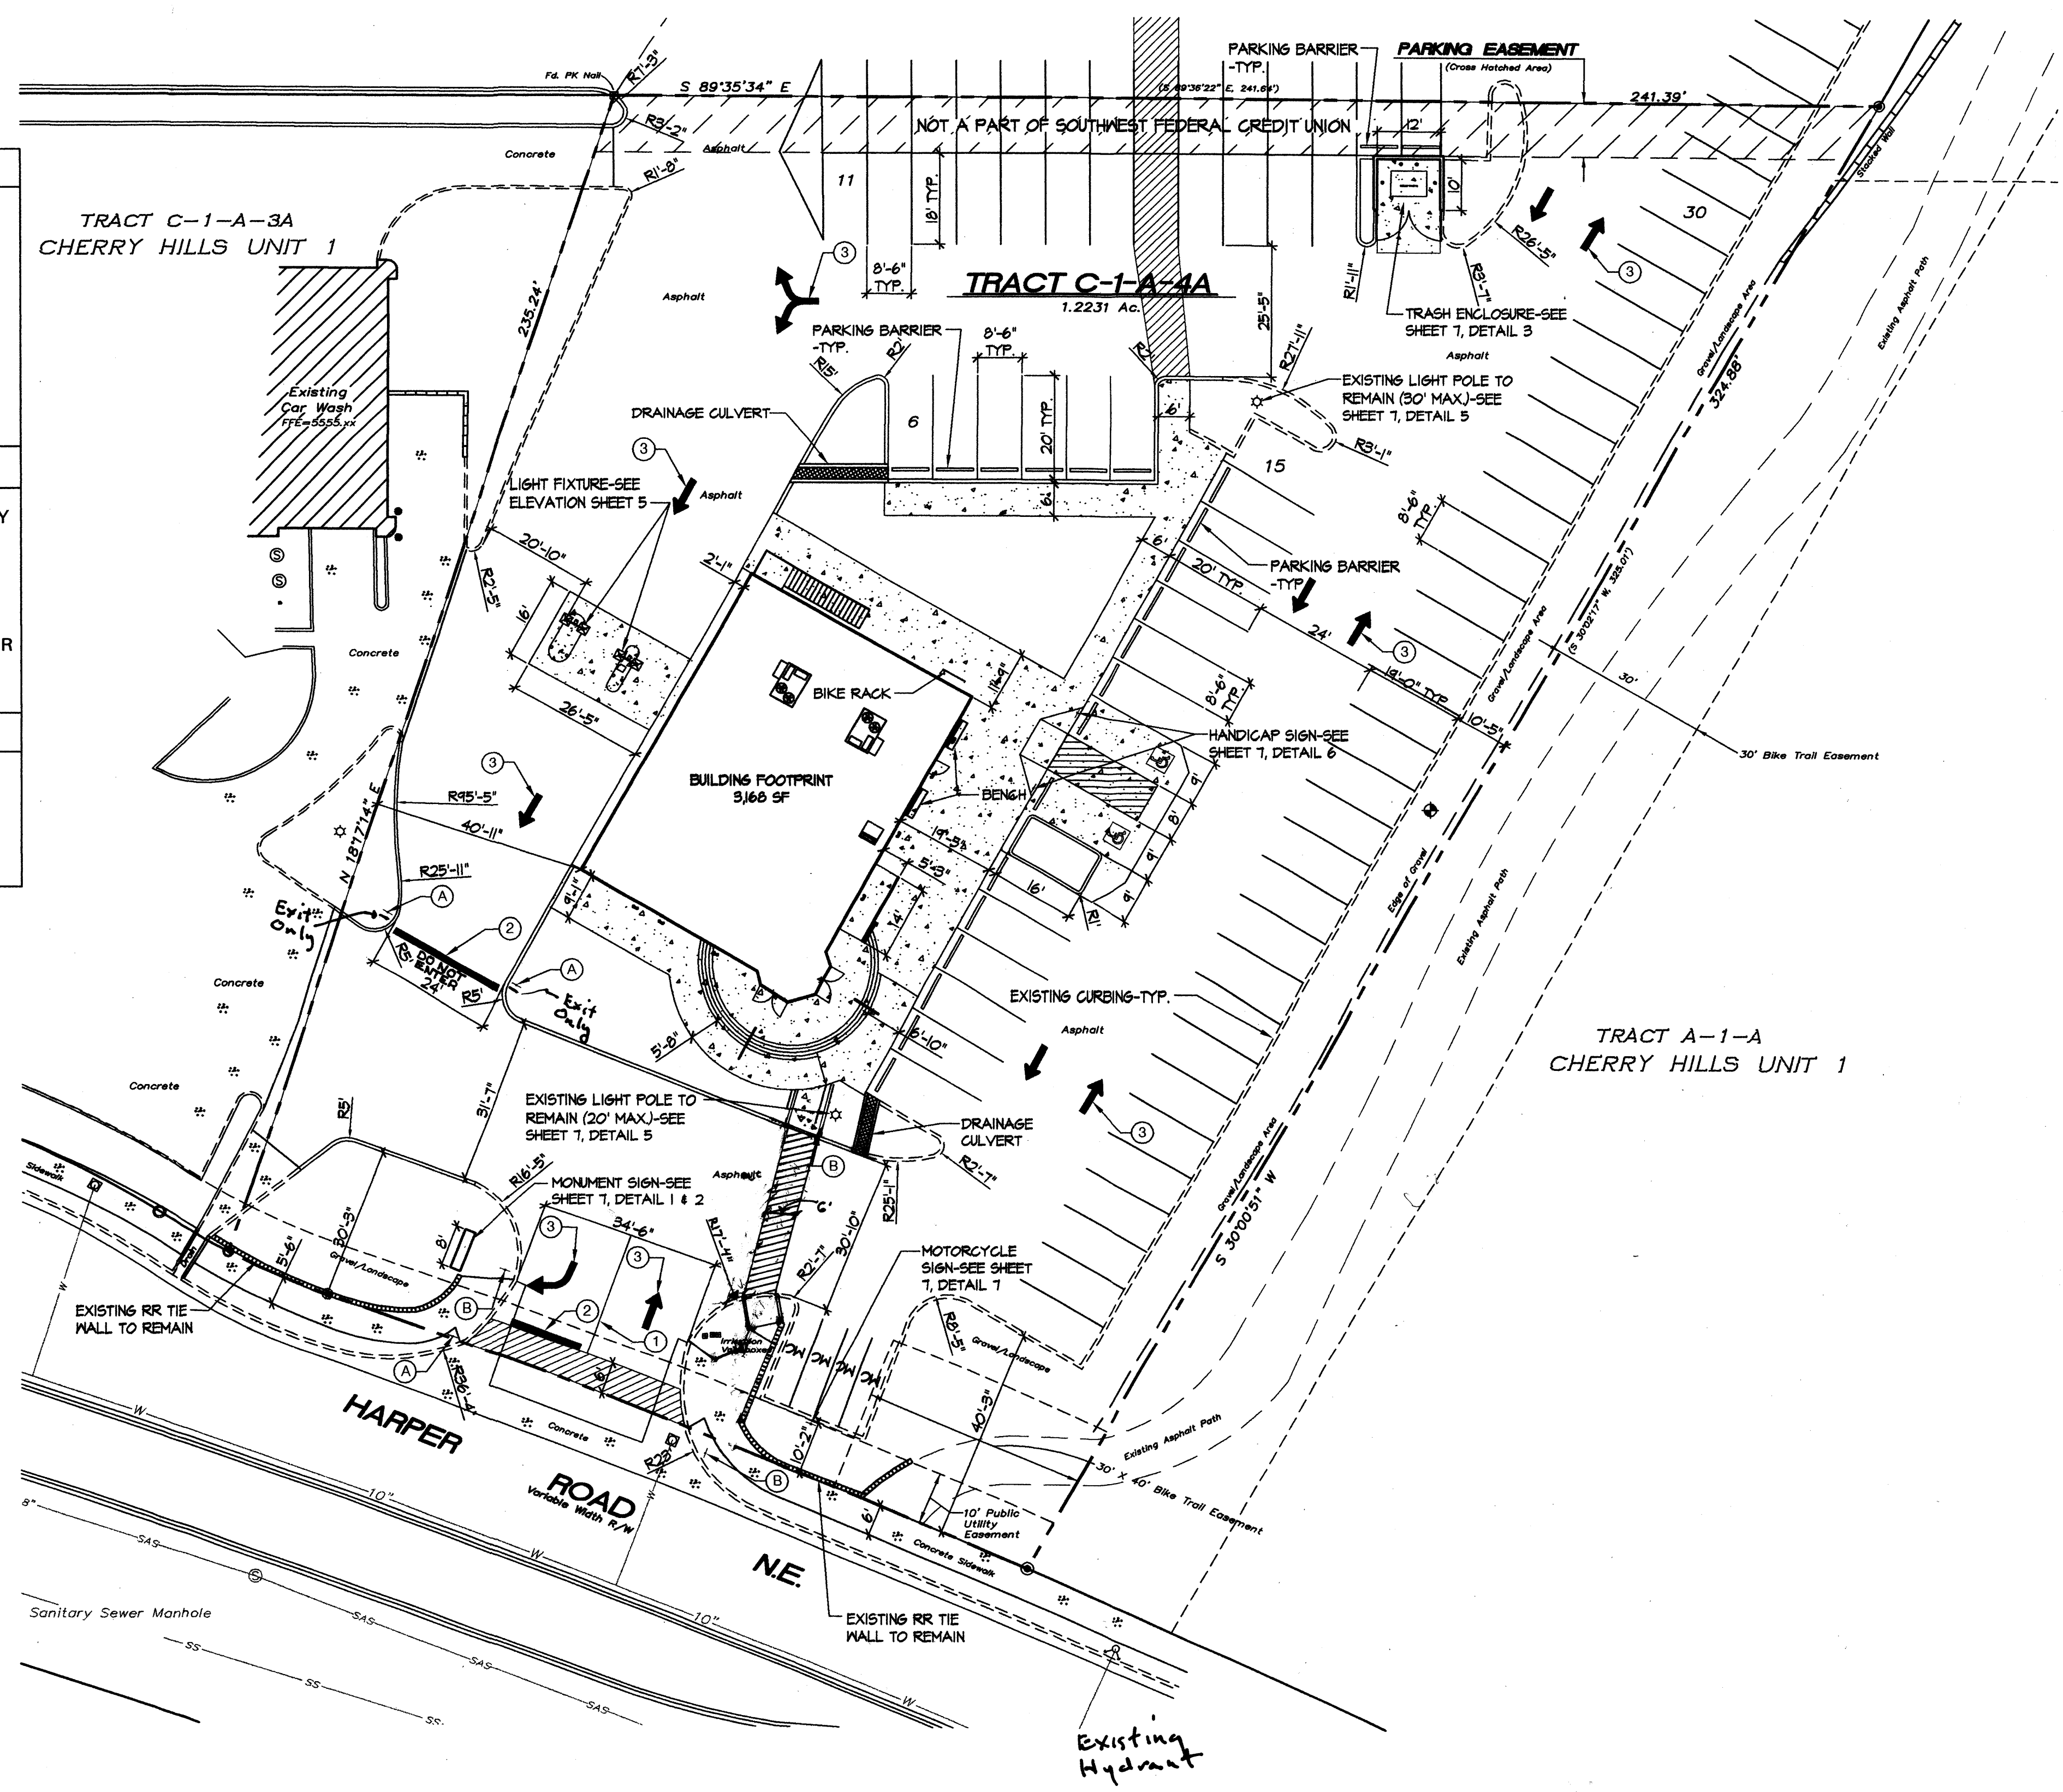

SITE DATA:

LEGAL DESCRIPTION: TRACT C-1-A-4A, CHERRY HILLS-UNIT 1 (BEING A REPLAT OF TRACTS C-1-A-1 THRU C-1-A-5, CHERRY HILLS-UNIT 1).

ZONING: SU-1 FOR C-1 PERMISSIVE USES, TWO DRIVE-UP FACILITIES AND PACKAGE LIQUOR SALES AS AN ANCILLARY USE LIMITED TO ONE RETAIL ESTABLISHMENT NOT EXCEEDING 25% OF THE GROSS FLOOR AREA, BUT IN NO CASE LARGER THAN 5,000 S.F. FOR TRACTS CIA1 THROUGH CIA5 INCLUSIVE.

LAND USE: 2-STORY CREDIT UNION WITH DRIVE IN FACILITIES AND ATM.

BUILDING AREA: 5,356 S.F. (NET LEASABLE)

SETBACK: MINIMUM BUILDING SETBACK FROM HARPER ROAD IS 20 FEET.
MINIMUM LANDSCAPE SETBACK FROM HARPER ROAD IS 20 FEET.

BUILDING HEIGHT: MAXIMUM BUILDING HEIGHT IS 26 FEET.

SITE AREA: 1.2231 ACRES

PARKING: REQUIRED PARKING: 2,914 S.F. 1ST FLOOR @ 1 PER 200 S.F. = 15
2,914 S.F. 2ND FLOOR @ 1 PER 300 S.F. = 10
TOTAL PROVIDED PARKING: 25
62


HANDICAPPED REQUIRED: 2
HANDICAPPED PROVIDED: 2
MOTORCYCLE REQUIRED: 2
MOTORCYCLE PROVIDED: 4
BICYCLE REQUIRED: 2
BICYCLE PROVIDED: 2

VEHICULAR ACCESS: VEHICULAR ACCESS TO THIS SITE IS PROVIDED FROM THE EXISTING CURB CUT ON HARPER ROAD AND FROM THE ADJACENT DEL NORTE CENTER.


TRANSIT ACCESS: THERE ARE FOUR BUS STOPS ALONG WYOMING BOULEVARD THAT ARE WITHIN WALKING DISTANCE (LESS THAN 1/4 OF A MILE) FROM THE SUBJECT SITE. WYOMING BOULEVARD IS AN ENHANCED TRANSIT CORRIDOR SERVING ABO RIDE ROUTES 98 AND 31.

INTERNAL CIRCULATION: INTERNAL CIRCULATION AROUND THE PROPOSED BUILDING WILL BE DIRECTED BY TRAFFIC SIGNAGE. PEDESTRIAN CONNECTIONS TO THIS SITE EXIST ALONG HARPER ROAD, AND THERE IS AN EXISTING ASPHALT TRAIL BETWEEN THE SUBJECT SITE AND THE CHERRY HILLS LIBRARY TO THE EAST.

- GENERAL NOTES:**
1. ALL UTILITIES SERVING THE SITE ARE EXISTING AND WILL NOT REQUIRE ANY MODIFICATION.
 2. ONE MONUMENT SIGN IS PROPOSED AT THE SOUTHWEST CORNER OF THE PROPERTY THAT IS LIMITED TO 24 S.F. PER FACE.
 3. WALL SIGNS SHALL NOT EXCEED 6% OF "THE AREA OF THE FACADE TO WHICH IT IS RELATED".
 4. NO OFF-PREMISE SIGNS ARE PERMITTED.
 5. LIGHTING SHALL BE IN COMPLIANCE WITH SECTION 14-16-3-1, AREA LIGHTING REGULATIONS.
 6. ROOF MOUNTED MECHANICAL EQUIPMENT SHALL BE SCREENED.
 7. THE MECHANICAL SYSTEMS (HEATING AND COOLING) AND BUILDING ENVELOPE (WALLS, ROOF, AND WINDOWS) SHALL BE DESIGNED AND MAINTAINED TO PROMOTE THE EFFICIENT USE OF ENERGY.
 8. THE SITE DEVELOPMENT PLAN FOR BUILDING PERMIT SHALL COMPLY WITH THE APPROVED SITE DEVELOPMENT PLAN FOR SUBDIVISION FOR TRACTS CIA1A THROUGH CIA5A (Z-43-45).
 9. VIDEO SURVEILLANCE CAMERAS SHALL BE INSTALLED TO VIEW EXTERIOR PROPERTY AREAS AND MAIN ENTRANCES.
 10. RAINWATER HARVESTING MEASURES, SUCH AS CURB CUTS AND SWALES IN THE LANDSCAPE BUFFER ON HARPER, SHALL BE PROVIDED.
 11. ALL SCREENING AND VEGETATION SURROUNDING GROUND-MOUNTED TRANSFORMERS AND UTILITY PADS SHALL ALLOW 10 FEET OF CLEARANCE IN FRONT OF THE EQUIPMENT DOOR AND 5-6 FEET OF CLEARANCE ON THE REMAINING THREE SIDES FOR SAFE OPERATION, MAINTENANCE, AND REPAIR PURPOSES.
 12. RECYCLING CARTS SHALL BE PROVIDED IN THE BUILDING AND PICKED UP THROUGH A PRIVATE CONTRACTOR.

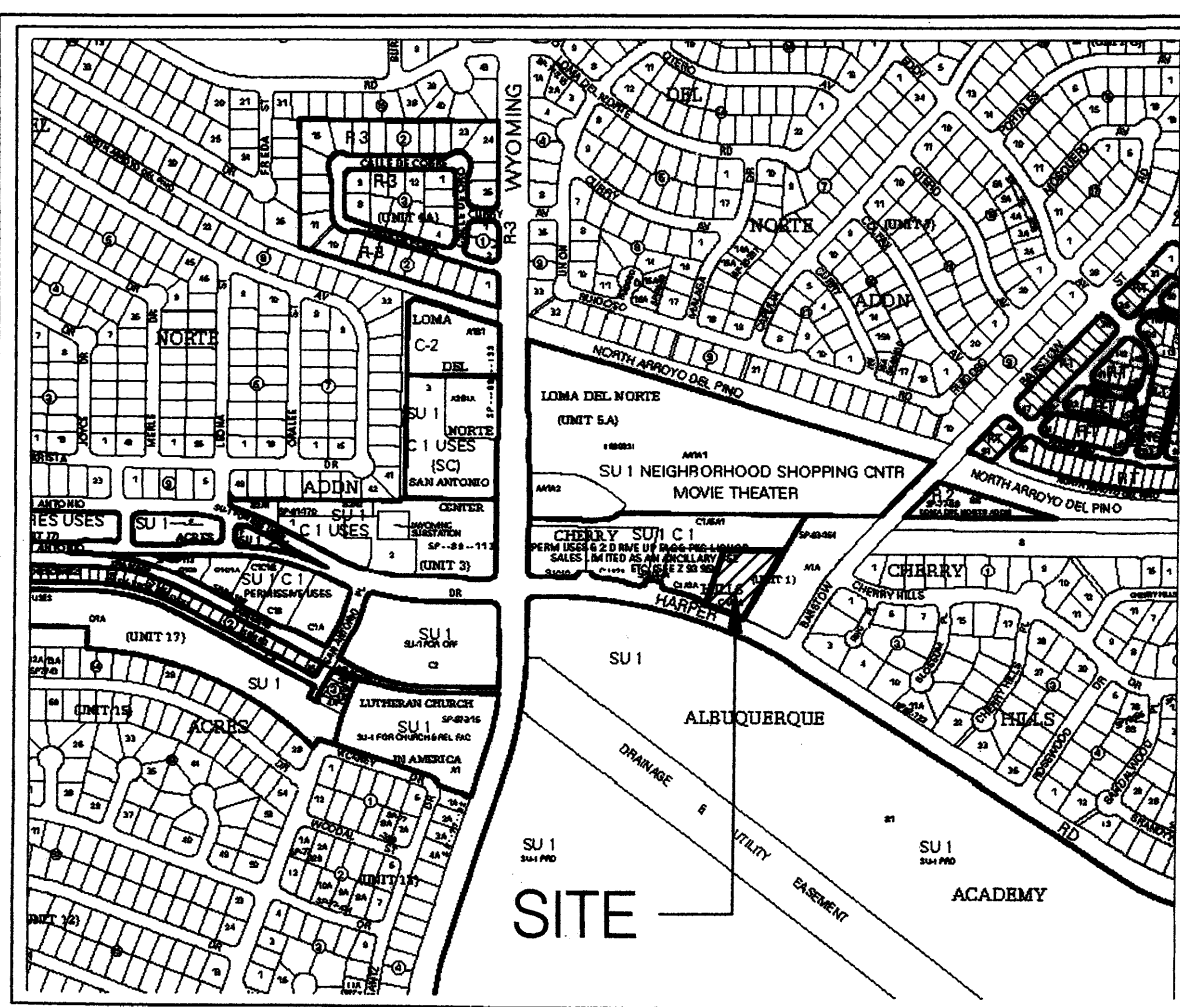

VICINITY MAP ZONE ATLAS PAGE E-19 NO SCALE

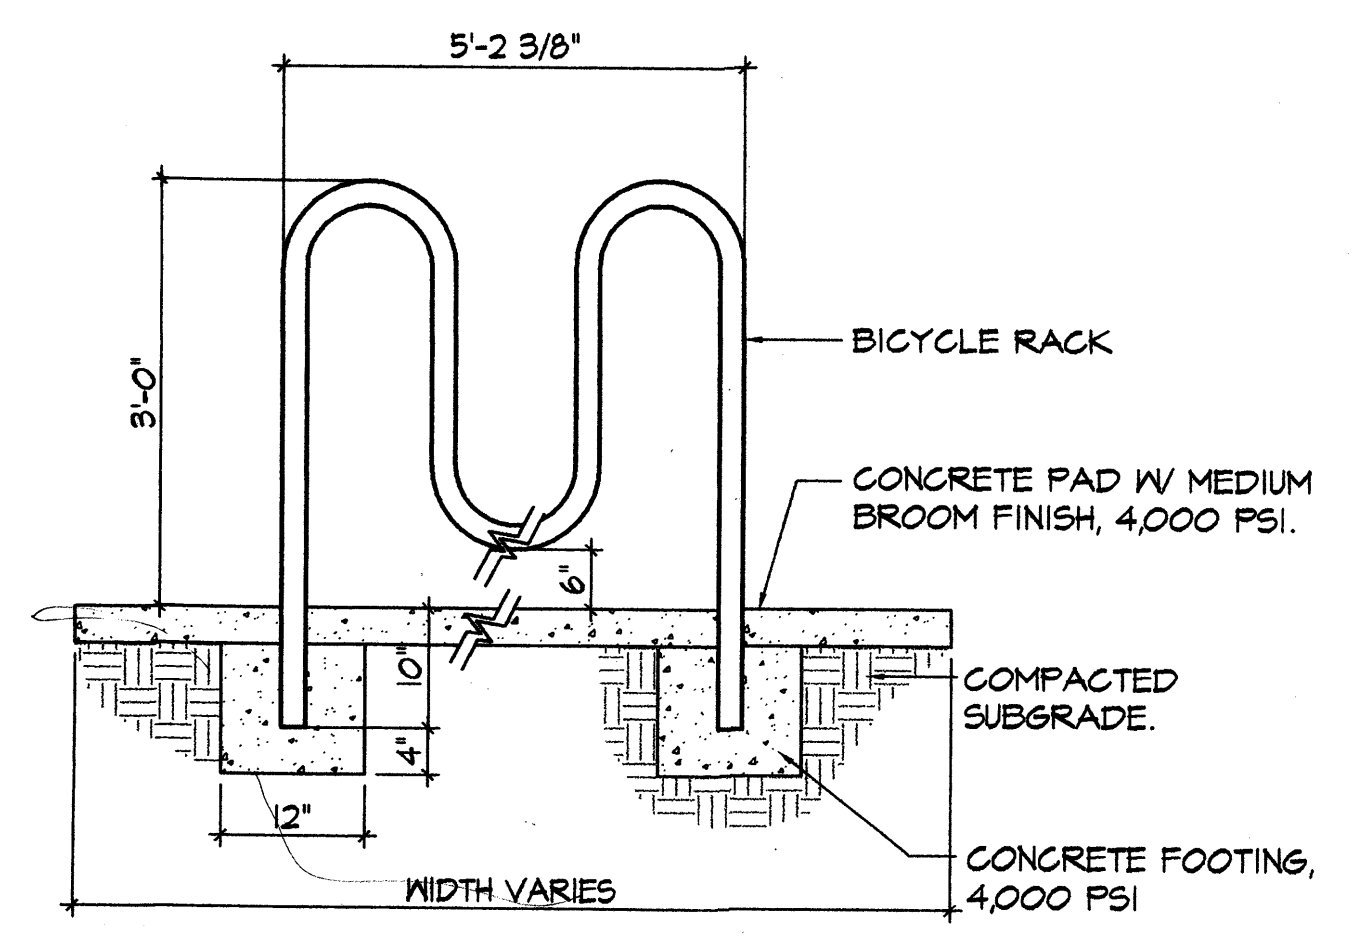

BIKE RACK DETAIL NOT TO SCALE

PROJECT NUMBER: 1008147
Application Number: 10 DRB - 70206

This Plan is consistent with the specific Site Development Plan approved by the Environmental Planning Commission (EPC), dated June 10, 2010 and the Findings and Conditions in the Official Notification of Decision are satisfied.

Is an Infrastructure List required? () Yes (X) No. If yes, then a set of approved DRC plans with a work order is required for any construction within Public Right-of-Way or for construction of public improvements.

DRB SITE DEVELOPMENT PLAN SIGNOFF APPROVAL:

Traffic Engineering, Transportation Division	08-09-10
ABCWUA	07/28/10
Parks and Recreation Department	7/28/10
City Engineer	7/28/10
Solid Waste Management	7-19-10
DRB Chairperson, Planning Department	8-9-10

APD PLANS CHECKING OFF.
824-3611
APPROVED/IS APPROVED
(HYDRANT(S) ONLY)
Signature: [Signature]
7-20-10
58280
V8 Const/Worssank
2066ppm
2 Fin hydrants

SOUTHWEST FEDERAL CREDIT UNION
SITE PLAN FOR BUILDING PERMIT

Prepared for: Southwest Federal Credit Union
PO Box 2247
Albuquerque, NM 87103-2247


Prepared by: Consensus Planning, Inc.
Miller Engineering Consultants
NABS, Inc.

Scale: 1" = 20'

CONSENSUS PLANNING

July 20, 2010

Sheet 1 of 7

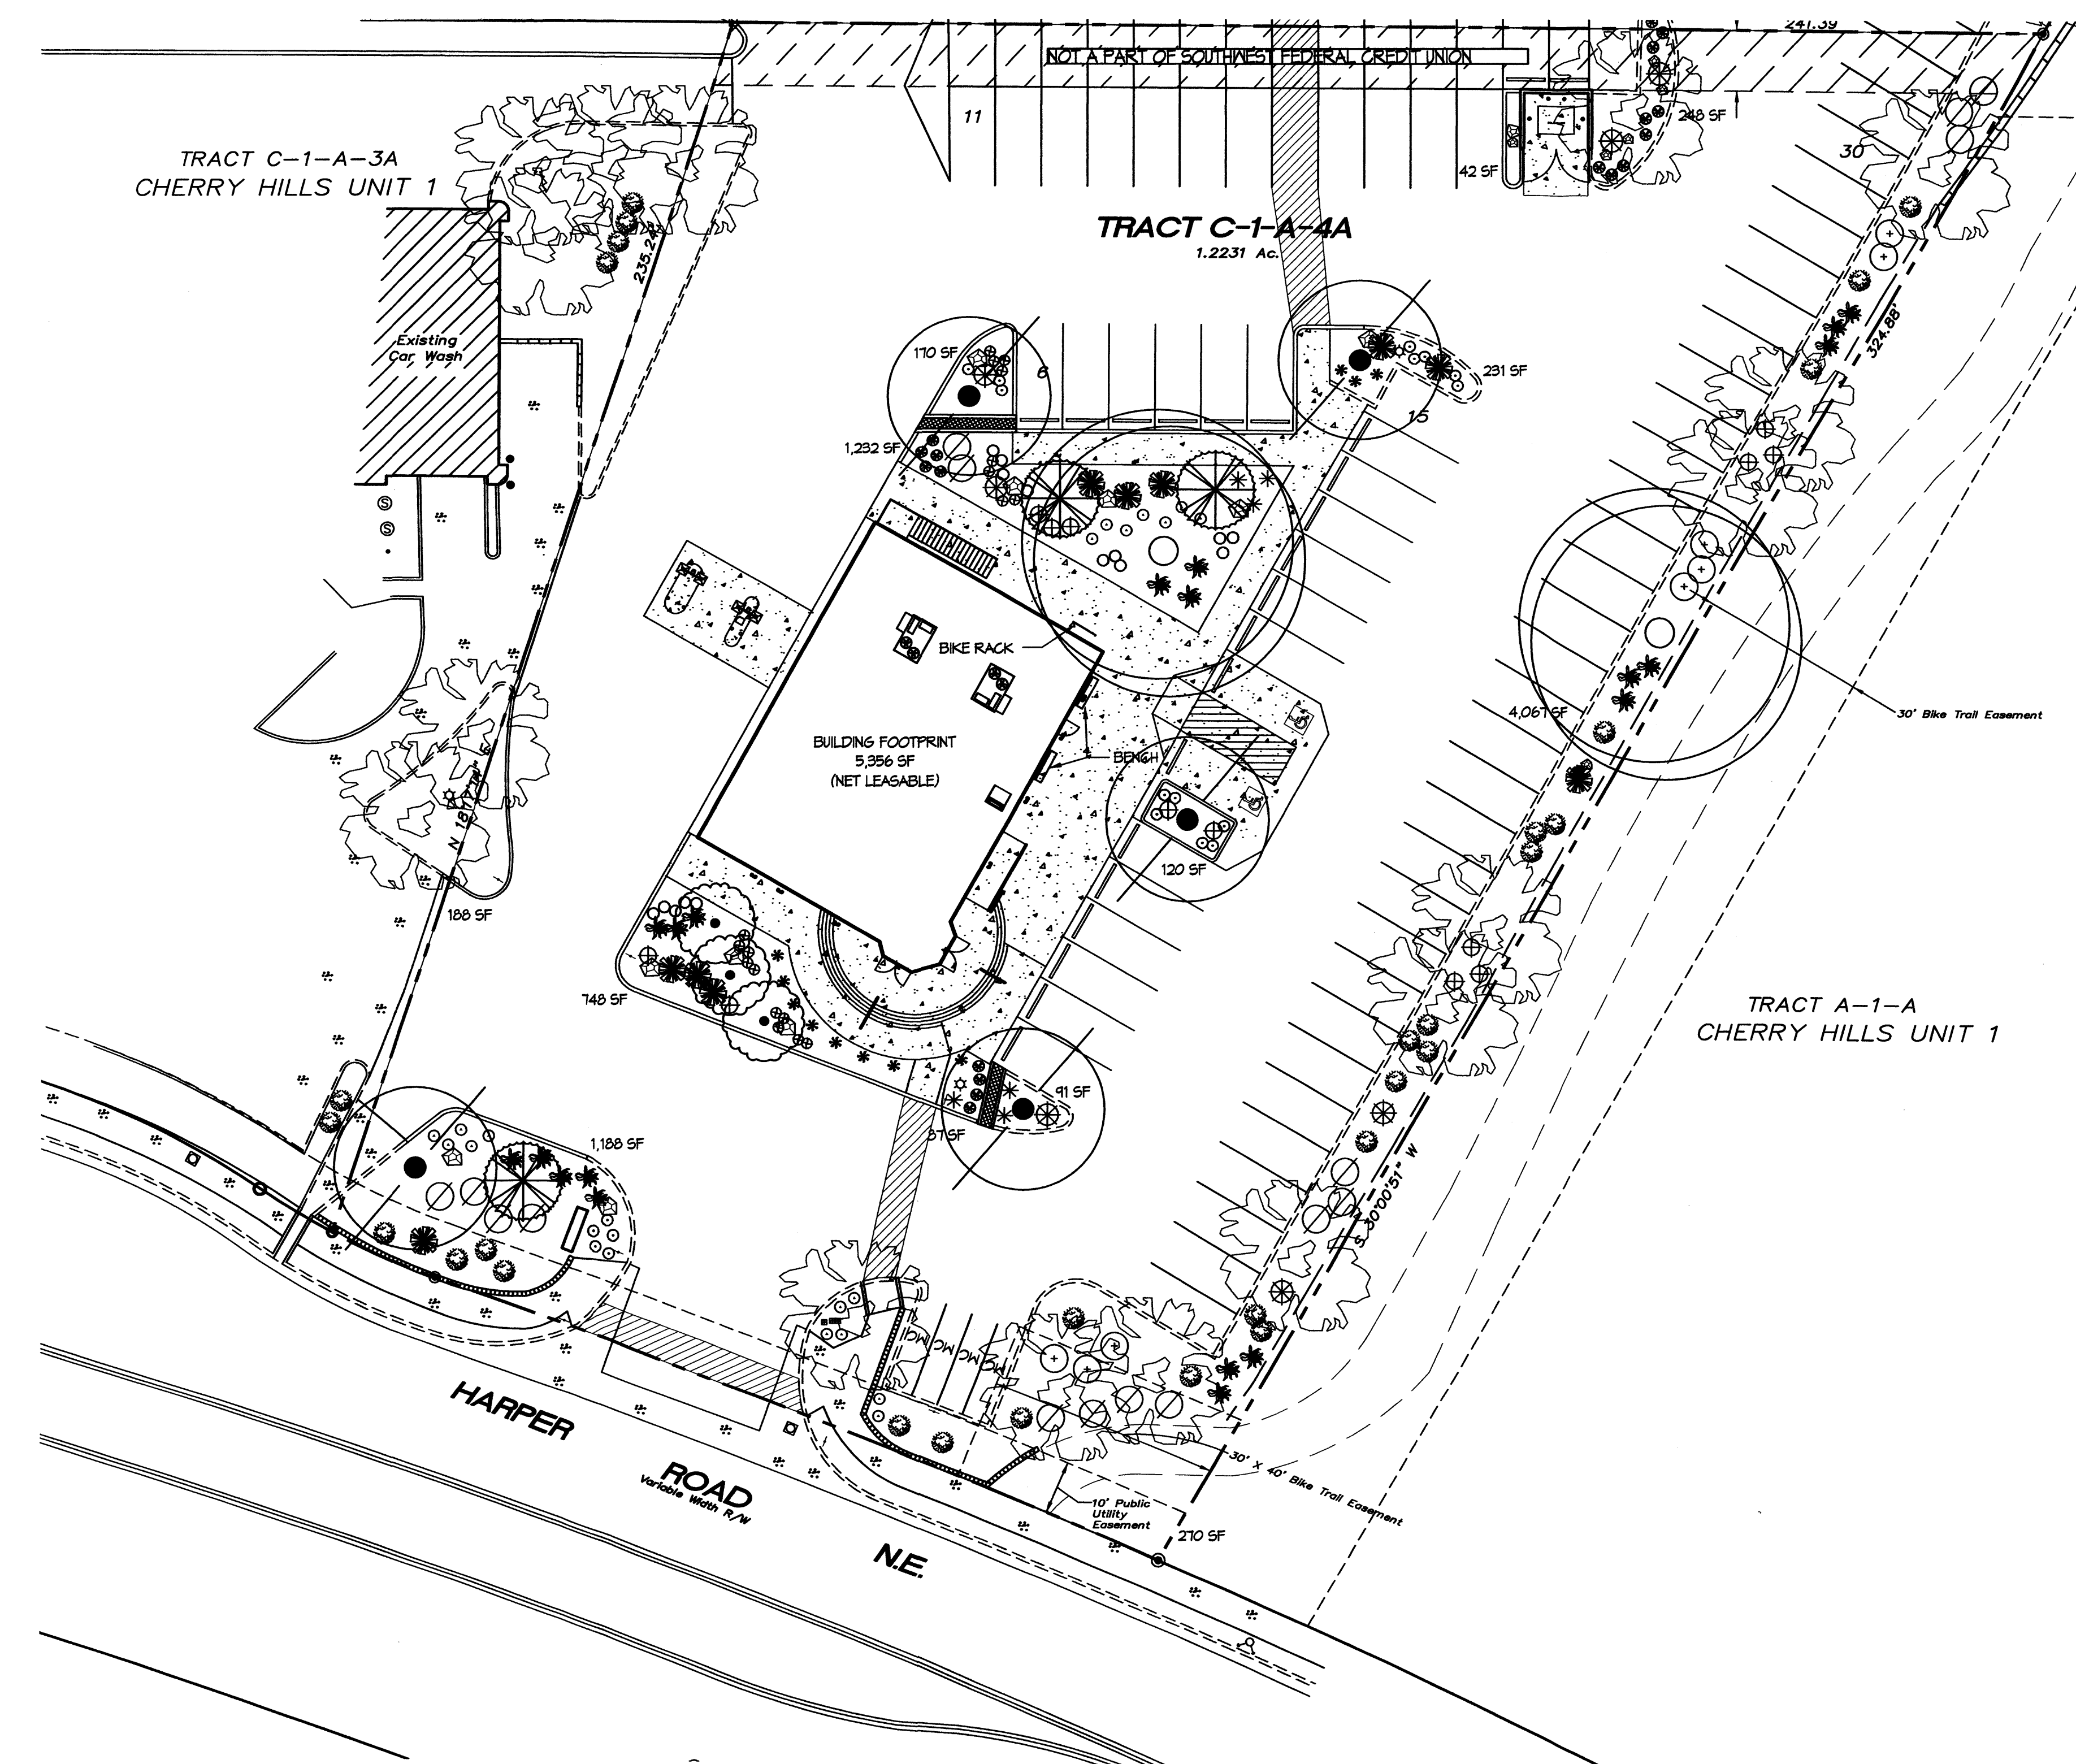

GENERAL LANDSCAPE NOTES

LANDSCAPE DESIGN
ALL PLANTING AREAS SHALL BE TOP DRESSED WITH A COMBINATION OF SANTA ANA TAN ROCK MULCH, SANTA FE BROWN ROCK MULCH AND 2"-4" BUILDLOGY BROWN COBBLE.

IRRIGATION SYSTEM
IRRIGATION SYSTEM STANDARDS OUTLINED IN THE WATER CONSERVATION LANDSCAPING AND WATER WASTE ORDINANCE SHALL BE STRICTLY ADHERED TO. A FULLY AUTOMATED IRRIGATION SYSTEM WILL BE USED TO IRRIGATE TREE, SHRUB AND GROUNDCOVER PLANTING AREAS. THE IRRIGATION SYSTEM WILL BE DESIGNED TO ISOLATE PLANT MATERIAL ACCORDING TO SOLAR EXPOSURE AND WILL BE SET UP BY PLANT ZONES ACCORDING TO WATER REQUIREMENTS. THE TREES WILL BE PROVIDED WITH (6) 2 GPH EMITTERS, WITH THE ABILITY TO BE EXPANDED TO ACCOMMODATE THE GROWTH OF THE TREE. SHRUBS AND GROUNDCOVERS WILL BE PROVIDED WITH (2) 1 GPH EMITTERS. TREES, SHRUBS AND GROUNDCOVERS WILL BE GROUPED ON THE SAME VALVE.

MAINTENANCE RESPONSIBILITY
MAINTENANCE OF THE LANDSCAPING AND IRRIGATION SYSTEM, INCLUDING THOSE AREAS WITHIN THE PUBLIC R.O.W., SHALL BE THE RESPONSIBILITY OF THE OWNER.

WATER CONSERVATION ORDINANCE COMPLIANCE
THE LANDSCAPE PLAN FOR THIS SITE SHALL LIMIT THE PROVISION OF HIGH WATER USE TURF TO A MAXIMUM OF 20 PERCENT OF THE REQUIRED LANDSCAPE AREA. THE PLANT PALETTE IS PREDOMINANTLY COMPRISED OF PLANTS WITH LOW TO MEDIUM WATER USE REQUIREMENTS, THEREBY MINIMIZING IRRIGATION NEEDS WHILE ENSURING VIABILITY OF THE PLANTS. AN EVAPOTRANSPIRATION MANAGEMENT CONTROLLER WILL BE INCLUDED IN THE DESIGN OF THE IRRIGATION SYSTEM TO MONITOR WEATHER CONDITIONS SO THAT OPTIMUM MOISTURE BALANCE IS ACHIEVED AND THE POSSIBILITY OF OVER-WATERING IS REDUCED.

LANDSCAPE COVERAGE
PLANTING BEDS SHALL HAVE 75% LIVING GROUNDCOVER AT FULL MATURITY.

LANDSCAPE CALCULATIONS

SITE AREA: (1.2231 AC.)	53,270 S.F.
BUILDING AREA:	-3,168 S.F.
TOTAL NET	50,110 S.F.

*IMPERVIOUS AREA	41,520 S.F.
REQUIRED LANDSCAPE: (15%)	7,517 S.F.
EXISTING LANDSCAPE:	5,666 S.F. (11%)
PROVIDED LANDSCAPE:	2,924 S.F. (6%)
TOTAL	8,590 S.F. (17%)


STREET TREES REQUIRED:	4
STREET TREES PROVIDED:	5

PARKING LOT TREES REQUIRED:	7
PARKING LOT TREES PROVIDED:	16

PLANT LEGEND


QTY.	SYMBOL	SCIENTIFIC NAME COMMON NAME	SIZE	INSTALLED SIZE MATURE SIZE	WATER USE
9	(Symbol)	EXISTING TREES TO REMAIN			
23	(Symbol)	EXISTING SHRUBS TO REMAIN			
TREES					
5	(Symbol)	SUMMIT GREEN ASH FRAXINUS PENNSYLVANICA 'SUMMIT'	2" CAL.	16' HT. X 6' SPR. 50' HT. X 30' SPR.	MEDIUM
3	(Symbol)	AUTUMN BLAZE FLOWERING PEAR PYRUS CALLERYANA 'AUTUMN BLAZE'	15-GAL.	8' HT. X 6' SPR. 25' HT. X 15' SPR.	MEDIUM +
3	(Symbol)	HONEY LOCUST GLEDTISIA TRIANGANTHOS	B&B	16' HT. X 6' SPR. 60' HT. X 50' SPR.	MEDIUM +
3	(Symbol)	HOT WINGS MAPLE ACER TARTARICUM 'HOT WINGS'	24" BOX	8' HT. X 4' SPR. 15' HT. X 15' SPR.	MEDIUM
SHRUBS/GROUNDCOVERS/ORNAMENTAL GRASSES					
19	(Symbol)	ERICAMERIA LARICIFOLIA 'AGUIRRE' TURPENTINE BUSH	1-GAL.	2' O.C. 2' HT. X 2' SPR.	LOW
13	(Symbol)	SALVIA GREGGII CHERRY SAGE	1-GAL.	3' O.C. 3' HT. X 3' SPR.	MEDIUM
15	(Symbol)	DELOSPERMA NUBIGENUM HARDY YELLOW ICEPLANT	1-GAL.	2' O.C. 3' HT. X 2' SPR.	LOW
16	(Symbol)	RUSSIAN SAGE PEROVSKIA ATRIPLICIFOLIA	5-GAL.	5' O.C. 4' HT. X 5' SPR.	MEDIUM
8	(Symbol)	CHRYSOTHAMNUS NAUSEOSUS CHAMISA	5-GAL.	5' O.C. 5' HT. X 5' SPR.	LOW
7	(Symbol)	MUGO PINE PINUS MUGO	5-GAL.	4' O.C. 4' HT. X 4' SPR.	MEDIUM
18	(Symbol)	PENSTEMON PINIFOLIUS PINELEAF PENSTEMON	1-GAL.	2' O.C. 1' HT. X 2' SPR.	LOW
18	(Symbol)	DWARF HEAVENLY BAMBOO NANDINA DOMESTICA	1-GAL.	2' O.C. 2' HT. X 2' SPR.	MEDIUM
20	(Symbol)	ROSMARINUS OFFICINALIS 'UPRIGHT' UPRIGHT ROSEMARY	5-GAL.	4' O.C. 4' HT. X 4' SPR.	LOW
18	(Symbol)	SEDUM TELEPHIUM AUTUMN JOY SEDUM	1-GAL.	2' O.C. 2' HT. X 2' SPR.	LOW
11	(Symbol)	CALAMAGROSTIS X ACUTIFLORA KARL FORESTER	1-GAL.	2' O.C. 3' HT. X 2' SPR.	MEDIUM
DESERT ACCENTS					
10	(Symbol)	NOLINA MICROCARPA BEARGRASS	5-GAL.	5' O.C. 4' HT. X 5' SPR.	LOW
6	(Symbol)	HESPERALOE PARVIFLORA RED YUCCA	5-GAL.	3' O.C. 3' HT. X 3' SPR.	LOW
17	(Symbol)	MOSS ROCK BOULDER (3' X 3' MIN.)			

NOTES:
A. THE WATER RETENTION BASIN SHALL BE TWICE THE PLANTING PIT DIAMETER.
B. THE EDGES OF THE WATER RETENTION BASIN SHALL BE SMOOTHLY FORMED WITH NO OBTRUSIVE EDGES.
C. REMOVE ROPE AND BURLAP AFTER PLANTING.

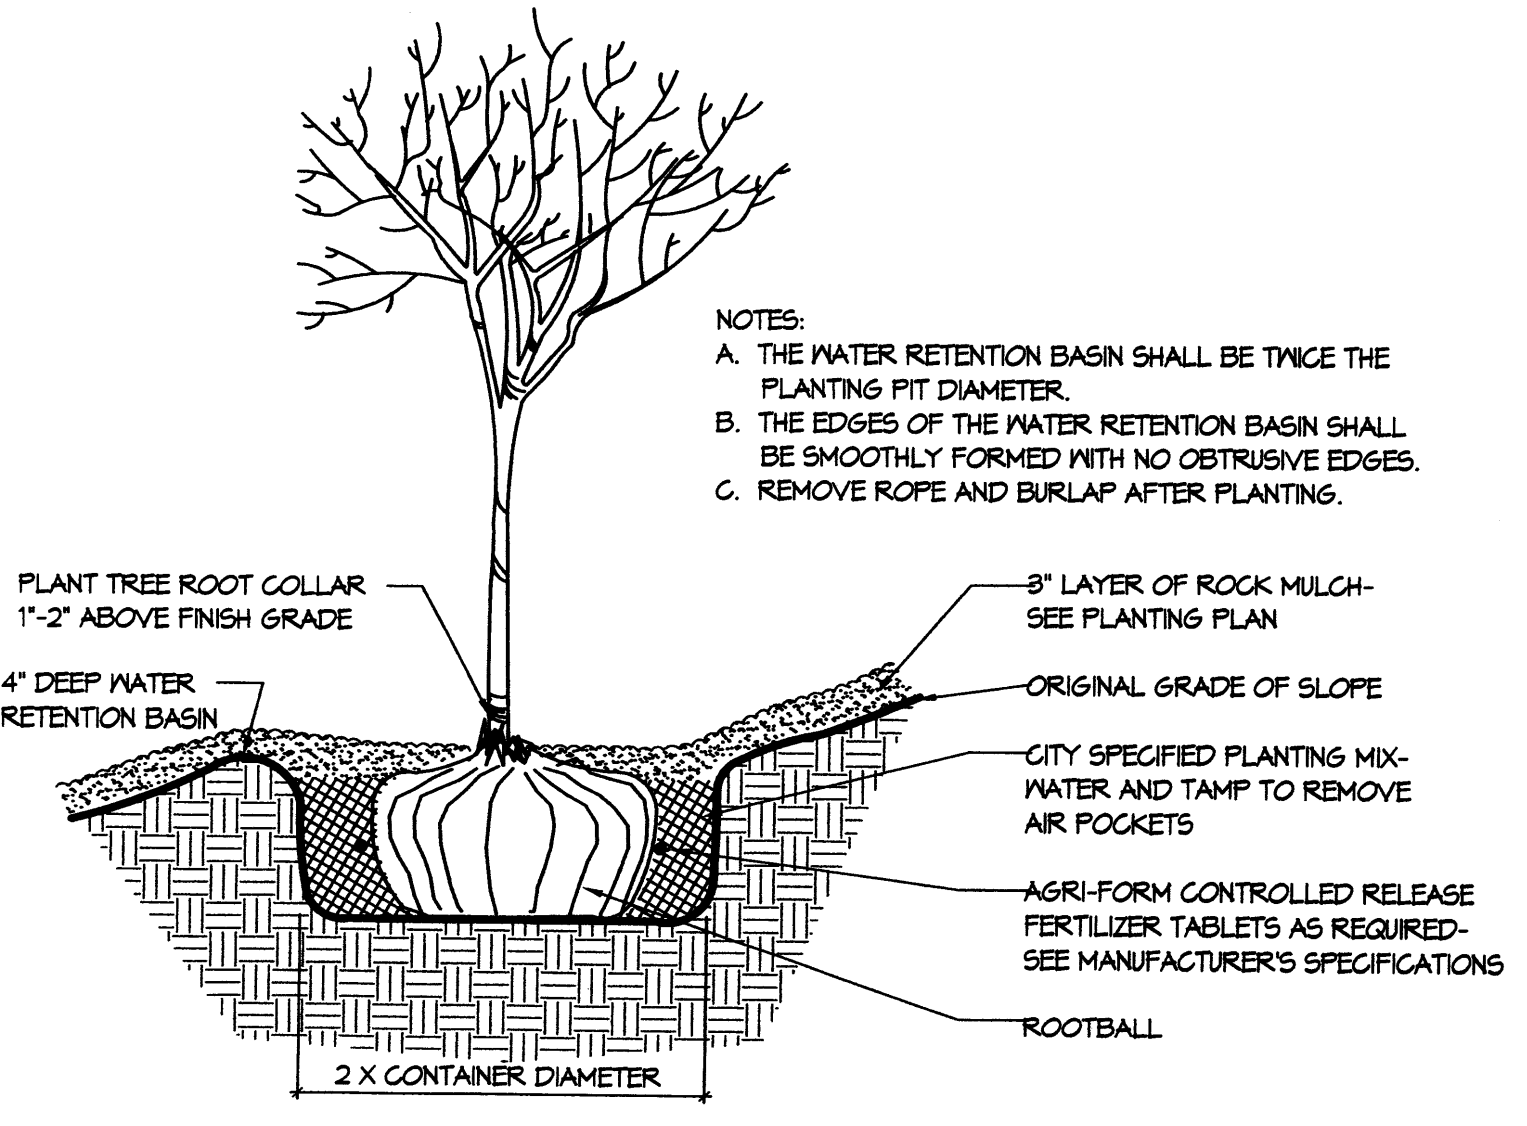


TREE PLANTING ON GRADE Not to Scale

NOTES:
A. THE WATER RETENTION BASIN SHALL BE TWICE THE PLANTING PIT DIAMETER.
B. THE EDGES OF THE WATER RETENTION BASIN SHALL BE SMOOTHLY FORMED WITH NO OBTRUSIVE EDGES.
C. REMOVE ROPE AND BURLAP AFTER PLANTING.

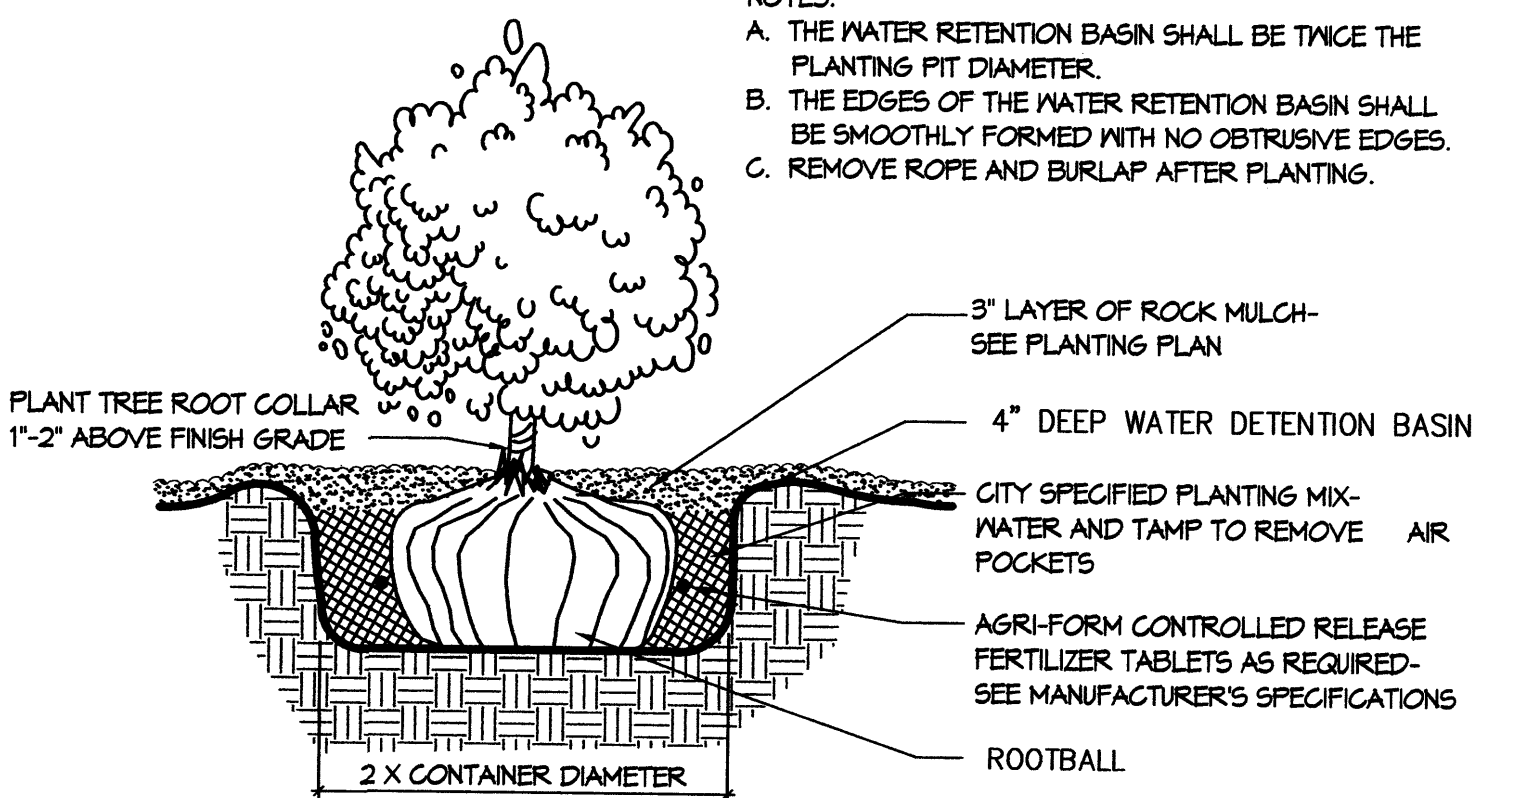


SHRUB PLANTING ON GRADE Not to Scale

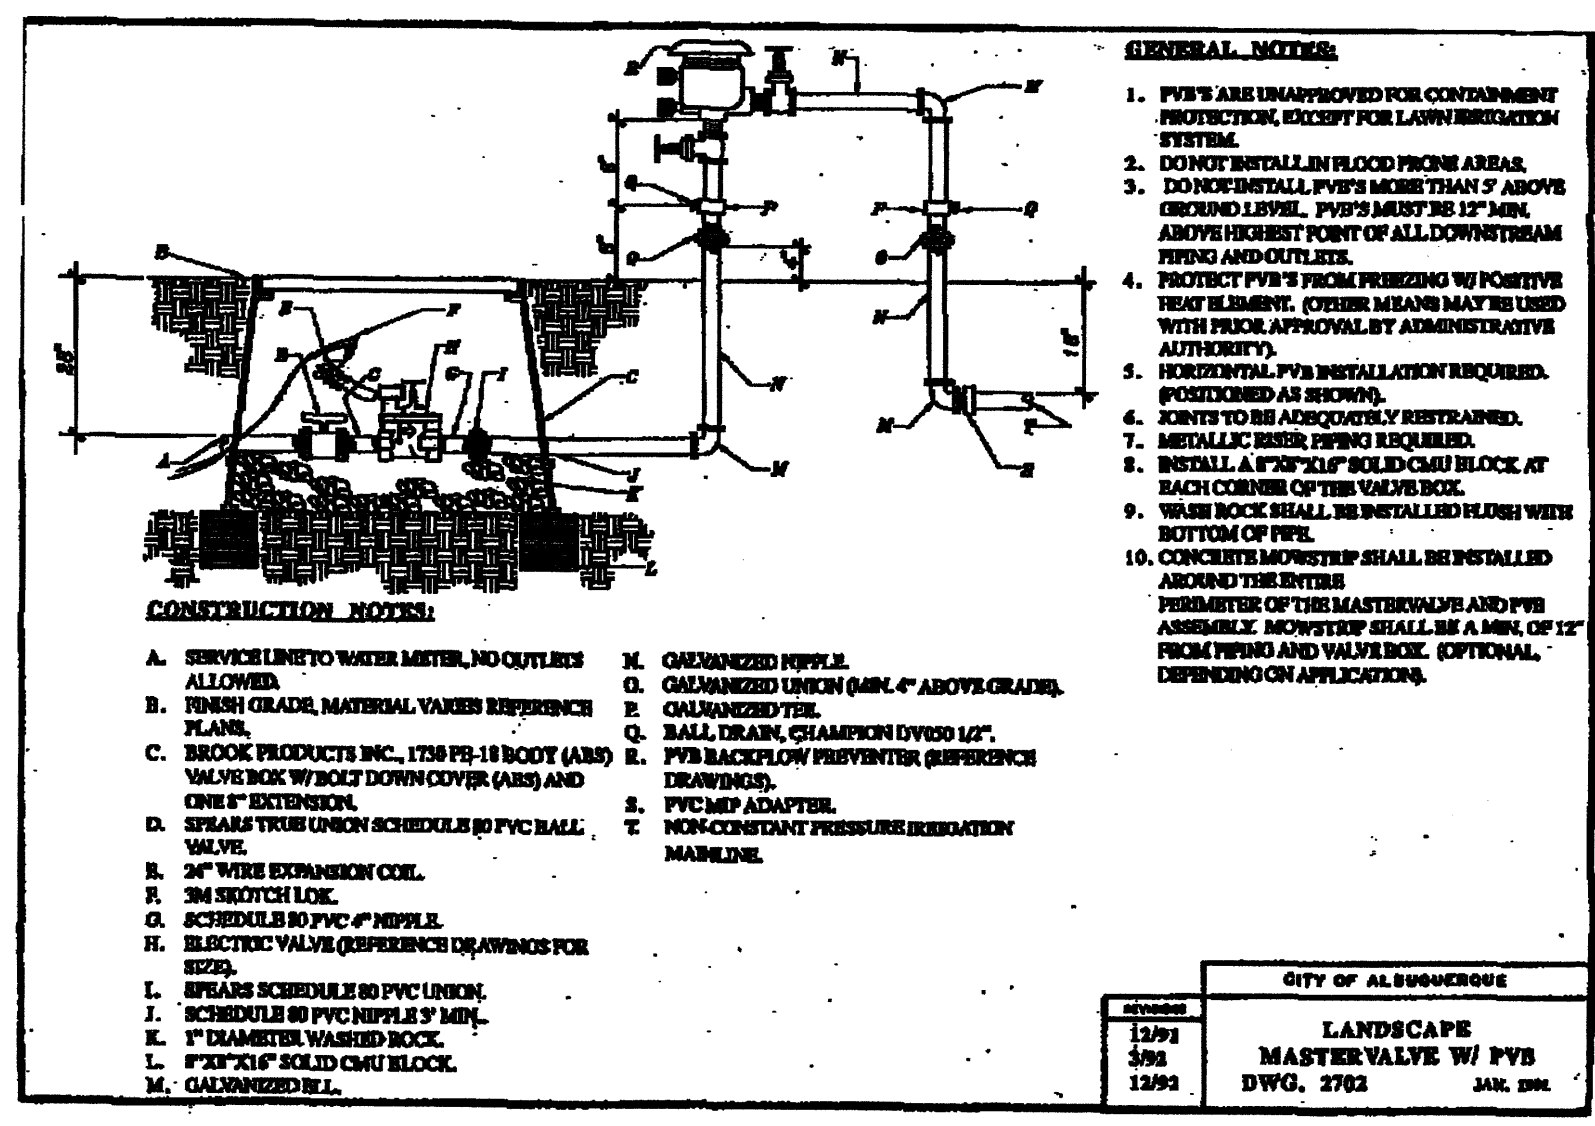


SOUTHWEST FEDERAL CREDIT UNION
LANDSCAPE PLAN

Prepared for: Southwest Federal Credit Union
PO Box 2247
Albuquerque, NM 87103-2247

Prepared by: Consensus Planning, Inc.
Miller Engineering Consultants
NABS, Inc.

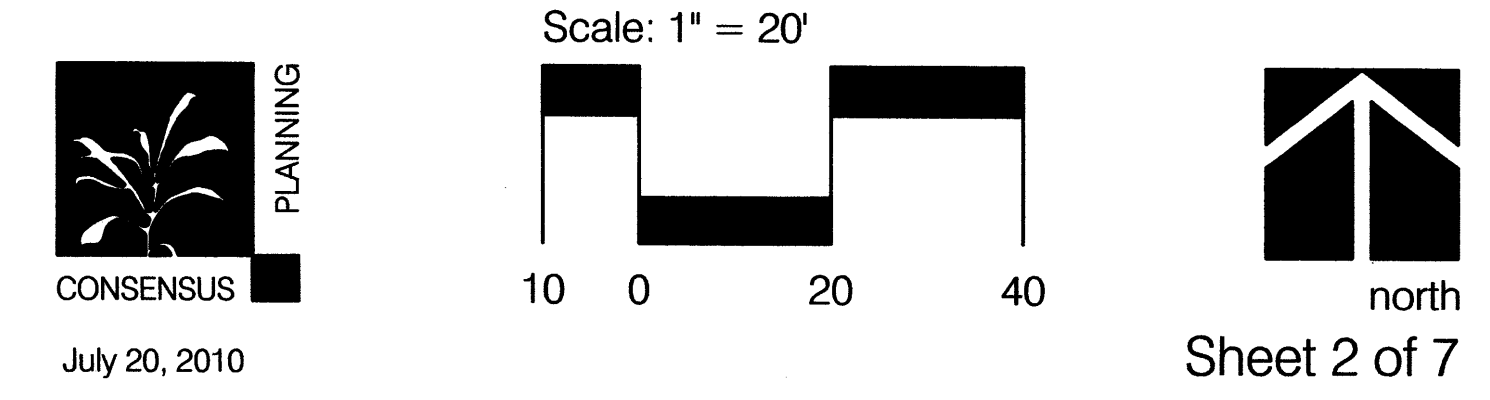

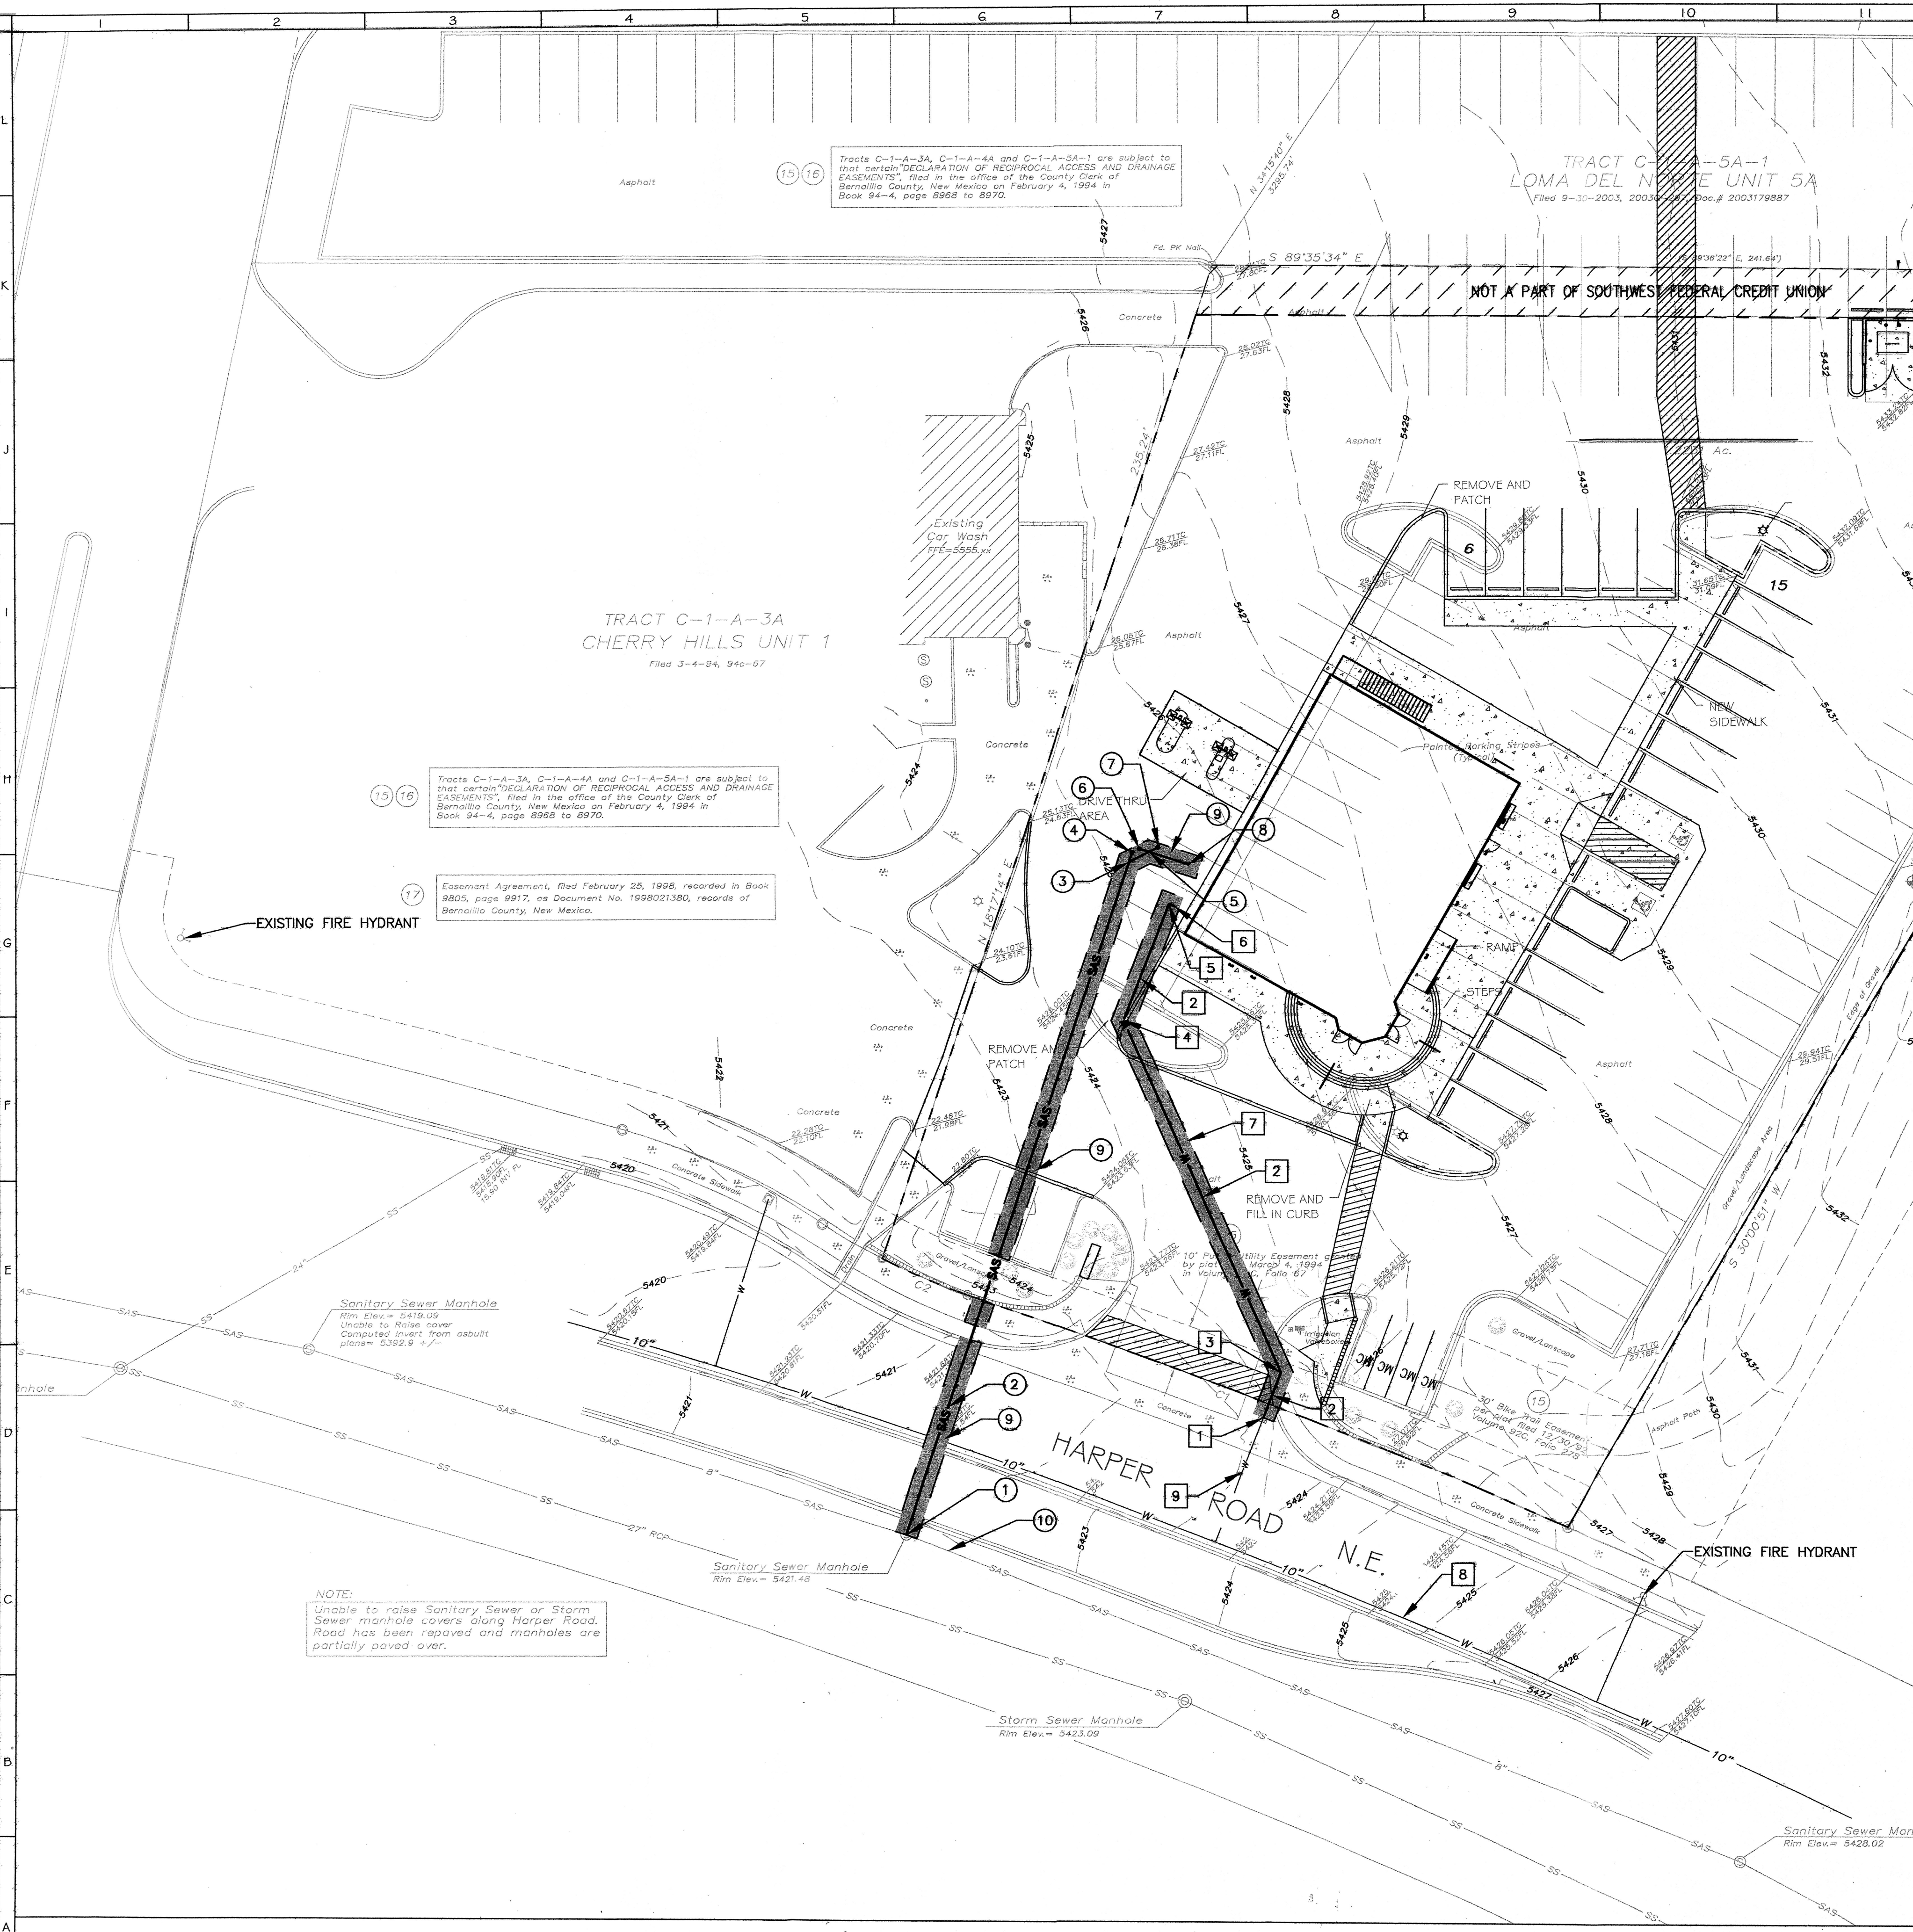

LEGEND

	PROPOSED WATER SERVICE LINE
	PROPOSED SEWER SERVICE LINE
	EXISTING WATER SERVICE LINE
	EXISTING SEWER SERVICE LINE

- ### GENERAL NOTES
- A. CONTRACTOR SHALL FIELD VERIFY THE LOCATIONS OF EXISTING UTILITIES INCLUDING INVERT ELEVATIONS. CONTRACTOR SHALL NOTIFY THE PROJECT ENGINEER OF ANY CONFLICTS IN THE PROPOSED DESIGN, PRIOR TO CONSTRUCTION.
 - B. CONTRACTOR SHALL PROVIDE A 3" MINIMUM COVER ON ALL NEW UTILITY LOCATIONS.
 - C. CONTRACTOR SHALL NOTIFY UTILITY COMPANIES 48 HOURS PRIOR TO ANY UTILITY WORK.
 - D. FOR ALL WATER AND SEWER SERVICE INSTALLATION AND CONNECTIONS CONTRACTOR SHALL ADHERE TO CITY OF ALBUQUERQUE SPECIFICATIONS, THE UNIFORM PLUMBING CODE, AND/OR APWA STANDARDS, WHICHEVER IS MORE STRINGENT.
 - E. IF THERE IS A CONFLICT BETWEEN PROPOSED SEWER SERVICE, OR WATER SERVICE LINES, THE CONTRACTOR SHALL NOTIFY THE PROJECT ENGINEER, PRIOR TO CONSTRUCTION.

- ### WATER NOTES
1. CONNECT NEW 3" DOMESTIC WATER SERVICE LINE TO EXISTING WATER SERVICE LINE AND METER. CONTRACTOR SHALL VERIFY THE LOCATION OF ALL EXISTING UTILITIES PRIOR TO CONSTRUCTION.
N=1513718.38, E=1549160.47.
 2. INSTALL NEW 3" DOMESTIC WATER SERVICE LINE.
N=1513728.55, E=1549164.39.
 3. INSTALL NEW 3", 45° ELBOW FITTING.
N=1513807.65, E=1549129.29.
 4. INSTALL NEW 3", 45° ELBOW FITTING.
N=1513834.04, E=1549139.45.
 5. INSTALL NEW 3", 90° ELBOW FITTING.
 6. POINT OF CONNECTION FOR NEW 3" DOMESTIC WATER SERVICE LINE. SEE MECHANICAL/PLUMBING SHEETS FOR EXACT LOCATION OF BUILDING STUBOUT.
N=1513833.56, E=1549140.69.
 7. REMOVE ASPHALT PAVING, CURB AND GUTTER, OR CONCRETE AS REQUIRED TO INSTALL NEW WATER LINE. REPLACE ASPHALT PAVING, CURB AND GUTTER, OR CONCRETE TO MATCH EXISTING SECTIONS AND PRE-EXISTING CONDITIONS.
 8. EXISTING WATER DISTRIBUTION LINE.
 9. EXISTING WATER SERVICE LINE. CONTRACTOR SHALL FIELD VERIFY THE ACTUAL LOCATION OF EXISTING UTILITIES.

- ### SEWER NOTES
1. CONNECT NEW 6" PVC SANITARY SEWER LINE TO EXISTING SANITARY SEWER MANHOLE.
INV=21.58, N=1513692.19, E=1549080.99
 2. INSTALL NEW 6" PVC SANITARY SEWER SERVICE LINE.
INV=22.60, N=1513843.69, E=1549130.56.
 3. INSTALL NEW 45° ELBOW FITTING.
 4. INSTALL NEW 6" CLEANOUT.
N=1513845.83, E=1549131.26
 5. INSTALL NEW 45° ELBOW FITTING.
INV=22.80, N=1513845.95, E=1549135.01
 6. INSTALL NEW 6" CLEANOUT.
N=1513846.65, E=1549132.88
 7. INSTALL NEW 6" CLEANOUT.
N=1513846.97, E=1549137.02
 8. POINT OF CONNECTION FOR NEW 6" PVC SANITARY SEWER. SEE MECHANICAL/PLUMBING SHEETS FOR CONTINUATION OF SAS LINE AND REQUIRED CONNECTIONS.
N=1513843.08, E=1549143.81.
 9. REMOVE ASPHALT PAVING, CURB AND GUTTER, OR CONCRETE AS REQUIRED TO INSTALL NEW SANITARY SEWER LINE. REPLACE ASPHALT PAVING, CURB AND GUTTER, OR CONCRETE TO MATCH EXISTING SECTIONS AND PRE-EXISTING CONDITIONS.
 10. EXISTING SANITARY SEWER MAIN.

A1 SITE UTILITY PLAN
SCALE: 1" = 20'

ME MILLER ENGINEERING CONSULTANTS
Engineers • Planners
3500 COMANCHE BLVD NE
BUILDING F
ALBUQUERQUE, NM 87107
(505) 888-7500, (505) 888-3800 (FAX)

DISCLAIMER
This plan was prepared by the undersigned in accordance with the professional engineer's seal and signature. It is not to be construed as a contract. The contractor shall be responsible for verifying the location of all existing utilities prior to construction.

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M.E.C. MILLER ENGINEERING CONSULTANTS
19160
PROFESSIONAL ENGINEER

MNABS, Inc.
9139 E 37th St N
Albuquerque, NM 87126
(316) 821-9590
www.mnabsinc.com

CREDIT UNION
SOUTHWEST FEDERAL
ALBUQUERQUE, NEW MEXICO

REVISIONS BY: _____
DATE: _____


ISSUE DATE: _____

DRAWN BY: JAL
DRAWN ON: 07/19/10
PROJECT#: 84-09-4866

SHEET TITLE: SITE UTILITY PLAN

SHEET: C-102


SHT: OF: _____

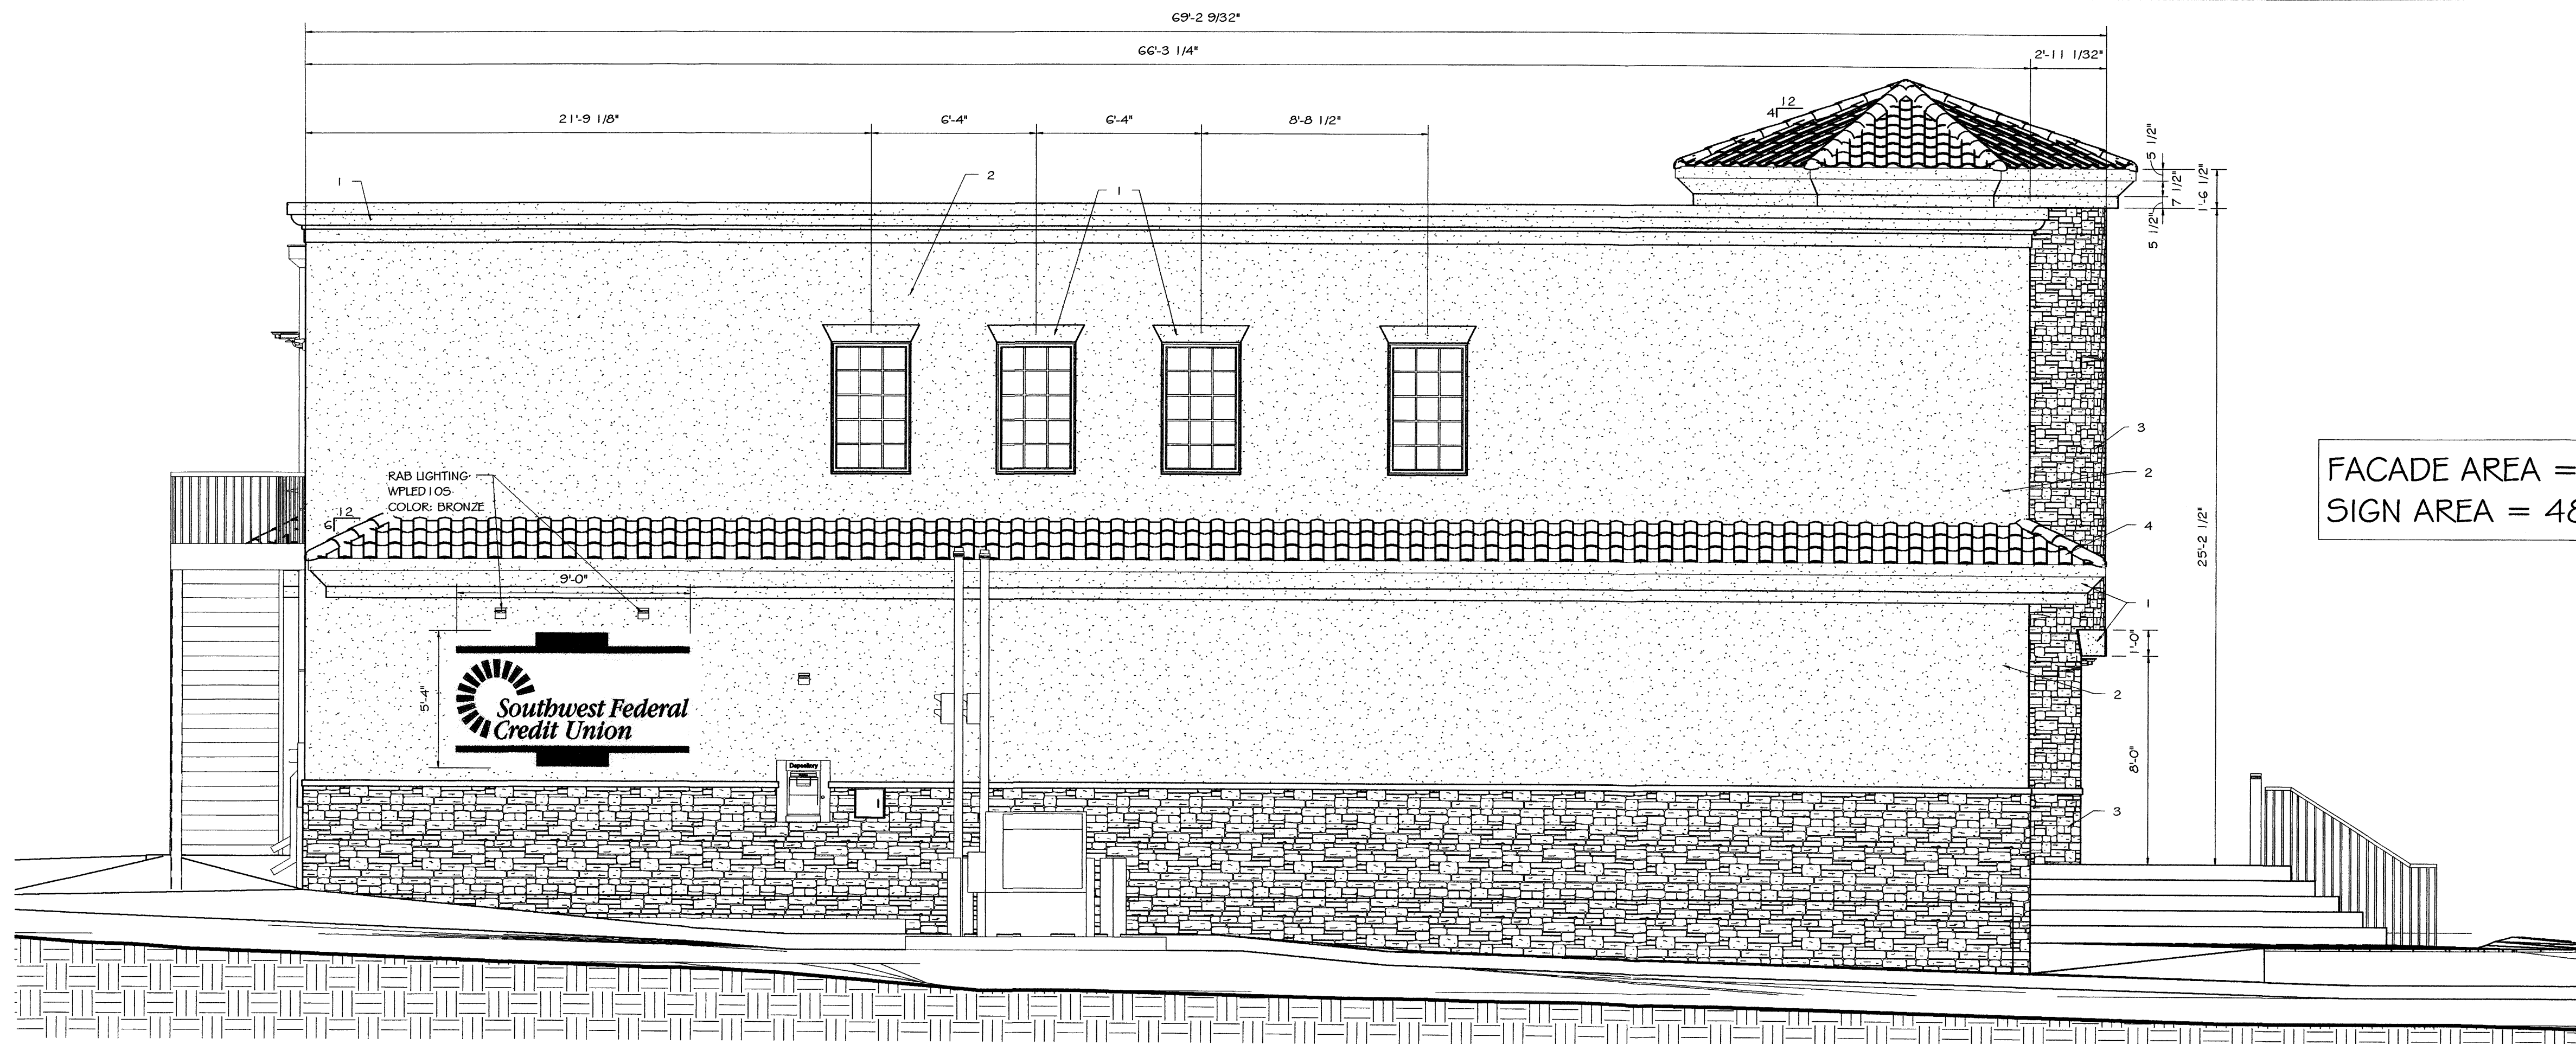

1 NORTHWEST ELEVATION
A-303 SCALE: 1/4" = 1'-0"
0' 2' 4' 8' 16'

FACADE AREA = 1870.21 SQ. FT.
SIGN AREA = 48 SQ. FT.

MAXIMUM BUILDING HEIGHT OF 26'

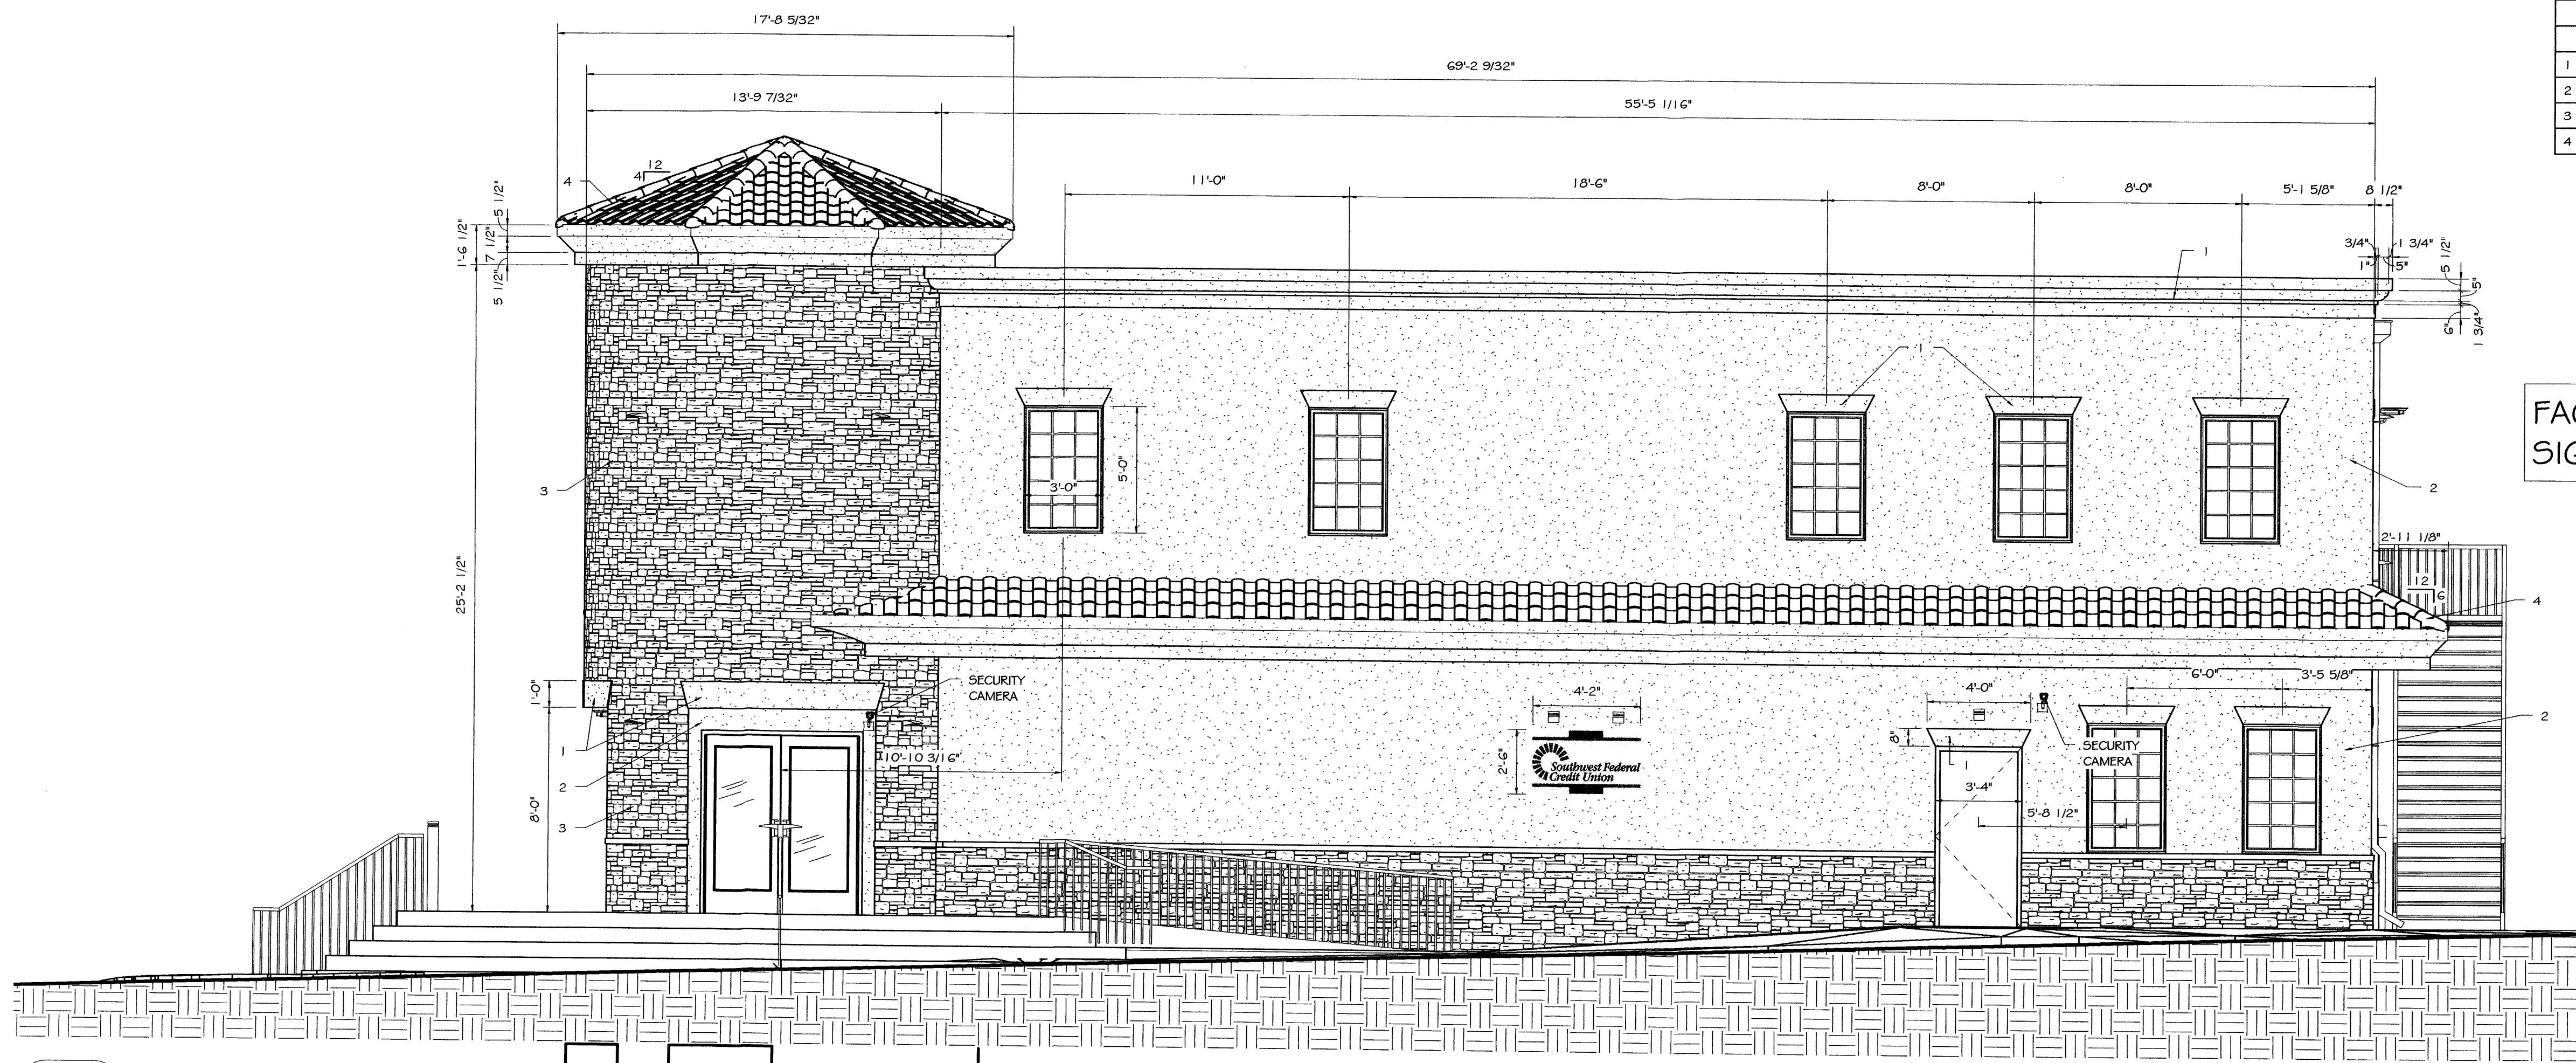

2 SOUTHEAST ELEVATION
A-303 SCALE: 1/4" = 1'-0"
0' 2' 4' 8' 16'

FACADE AREA = 1418.72 SQ. FT.
SIGN AREA = 10.42 SQ. FT.

EXTERIOR FINISHES		
MATERIAL/PRODUCT	COLOR/STYLE	MANUFACTURE
1 Medium Textured Stucco	Pottery (Dark Tan)	El Rey Stucco
2 Medium Textured Stucco	Tierra (Tan)	El Rey Stucco
3 ProStone® Easy Fit Savannah Ledge	Vintage Wine (Mixed Browns)	Owens Corning
4 Distinction Tile	Desert Red (Red)	Trimline Building Products

- * ALL WINDOW FRAMES TO BE WHITE
- * STORE FRONT ENTRY DOORS ARE ALUMINUM
- * 3' METAL DOORS ARE TO BE PAINTED TAN

DISCLAIMER
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The architect is not responsible
for the accuracy of the location
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SEAL


SOUTHWEST FEDERAL CREDIT UNION
ALBUQUERQUE, NEW MEXICO

REVISIONS	BY:	
DATE:	C. GLASS	
NO.		
ISSUE DATE		
DRAWN BY:	C. GLASS	
DRAWN ON:	05/3/10	
PROJECT#:	84-09-4866	
SHEET TITLE:	EXT ELEVATIONS	
SHEET:	A-303	
SHT:	6 OF 7	




1 DOUBLE FACE MONUMENT SIGN
A-301 NOT TO SCALE


D/F DISPLAY-INTERIOR ILLUM.
ROUTED ALUMINUM FACES
FINISHED TO MATCH
STO ISOI TORREON
LETTERS TO HAVE WHITE FLEX BACKER
WITH VINYL OVERLAY
USE CALON 25 SUNFLOWER AND
36 DK. BLUE
REVEAL FINISHED TO MATCH
STO 4180 CIMARRON
BASE FINISHED TO MATCH
STO ISOI TORREON

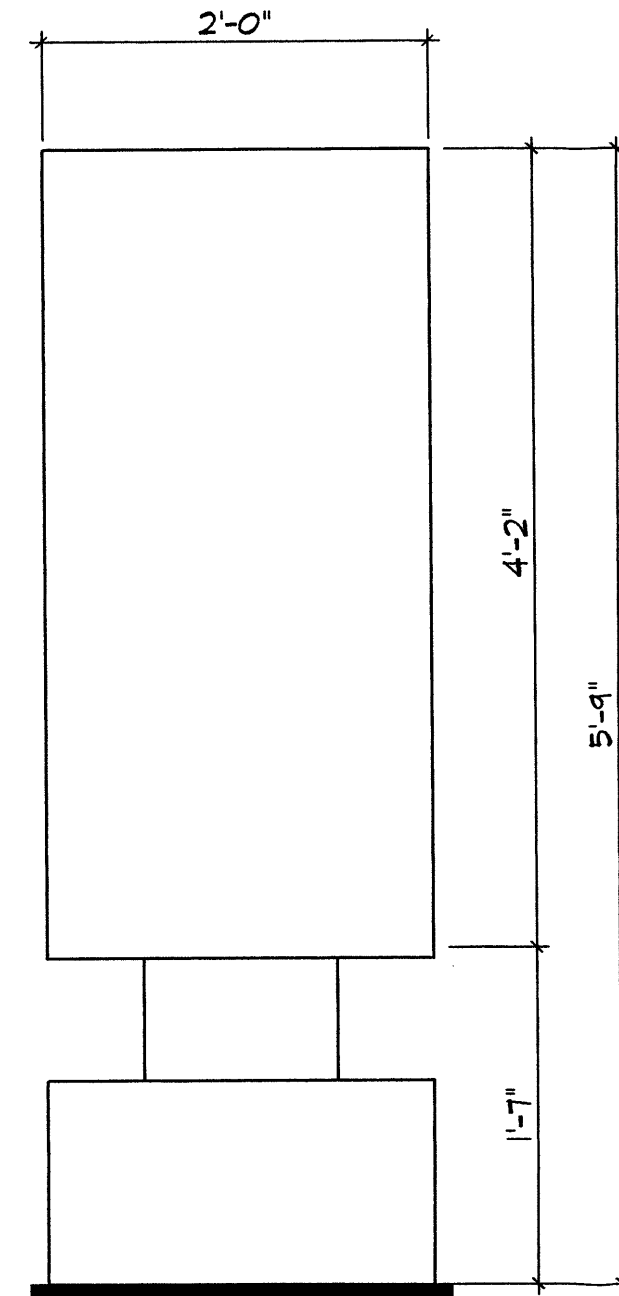


2 DOUBLE FACE MONUMENT SIGN (SIDE VIEW)
A-301 NOT TO SCALE

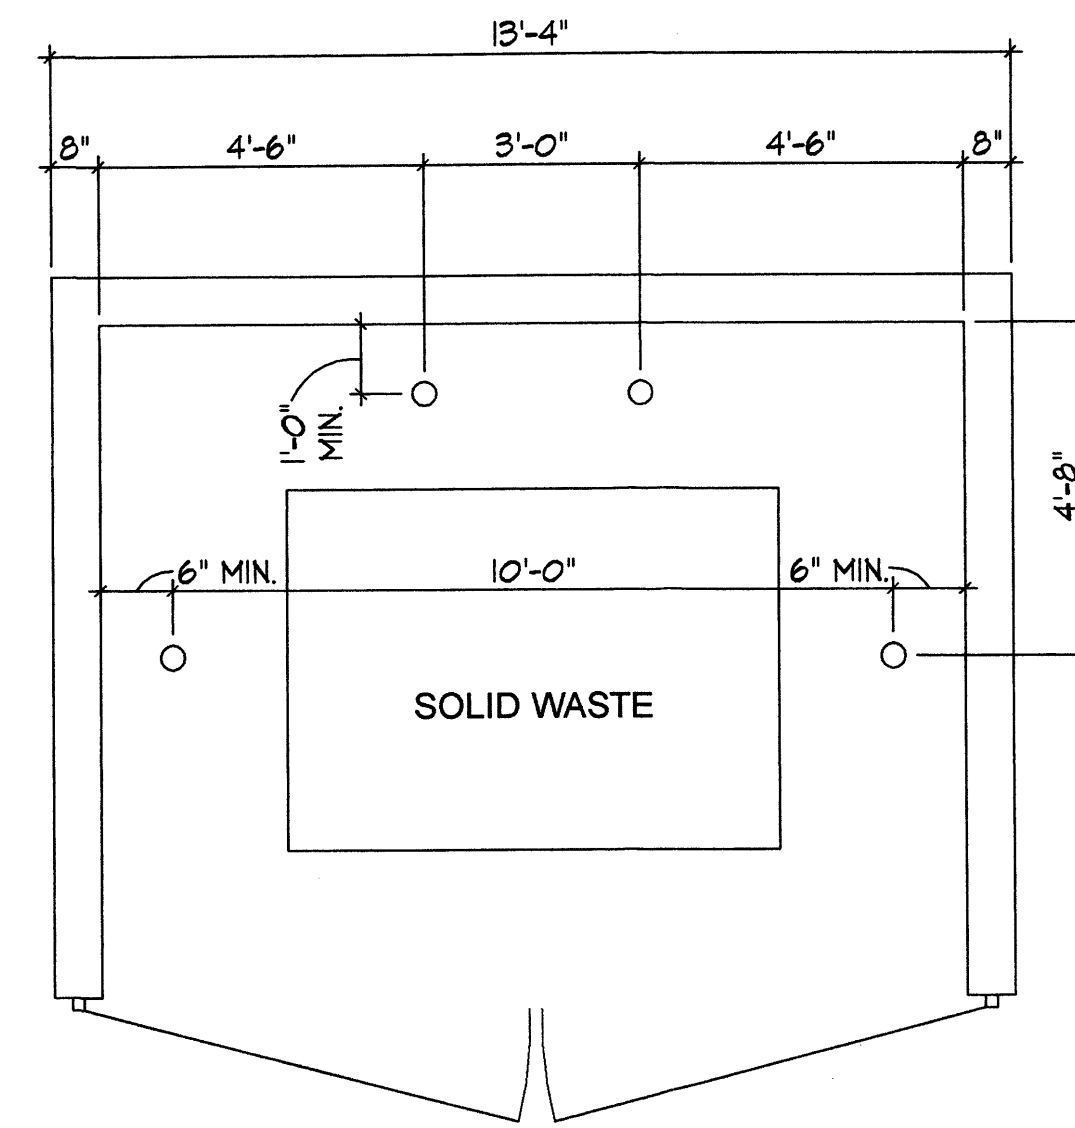


PLAN

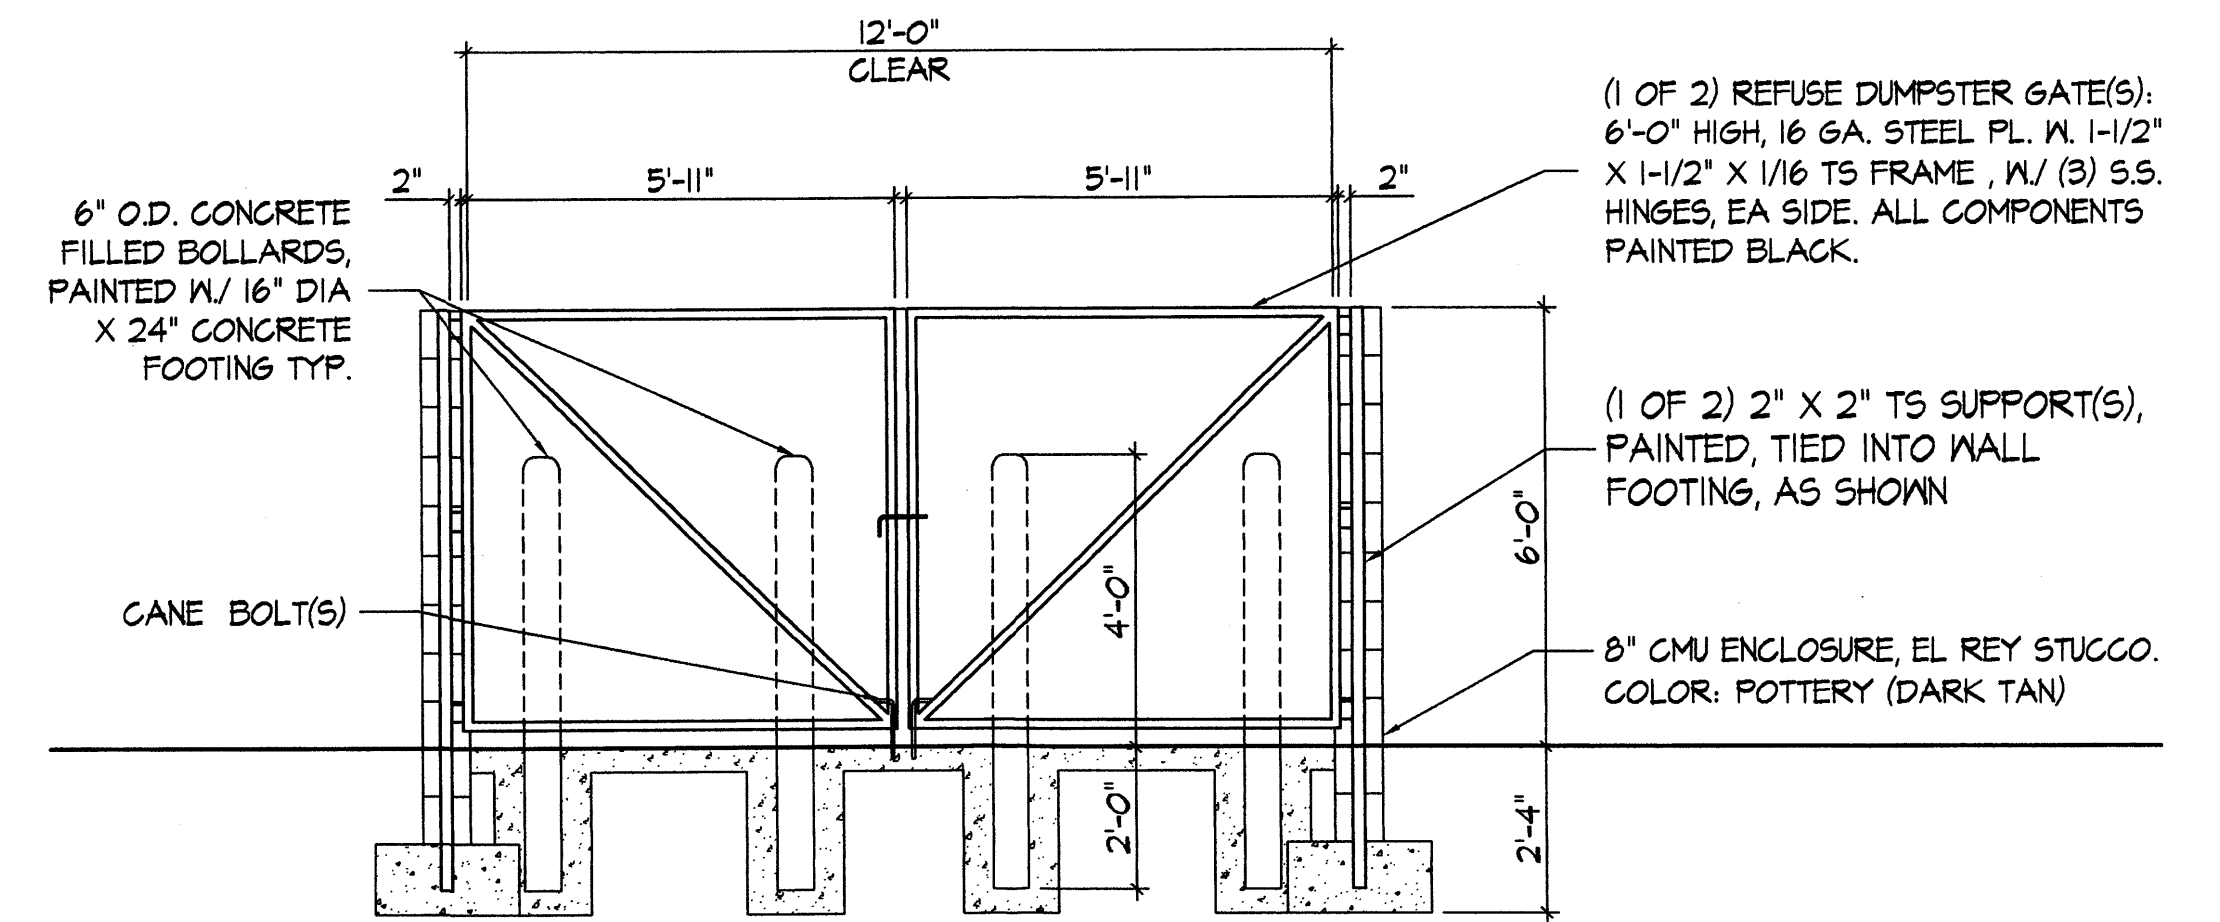


3 TRASH ENCLOSURE DETAIL
A-301 NOT TO SCALE

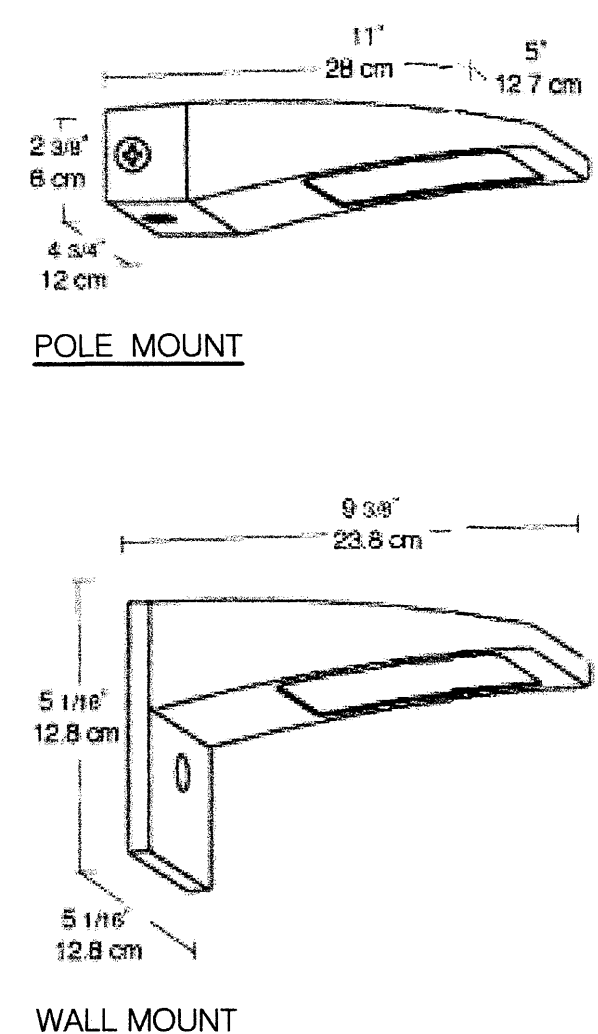


4 WALL/POLE LIGHTING DETAIL (NEW)
A-301 NOT TO SCALE

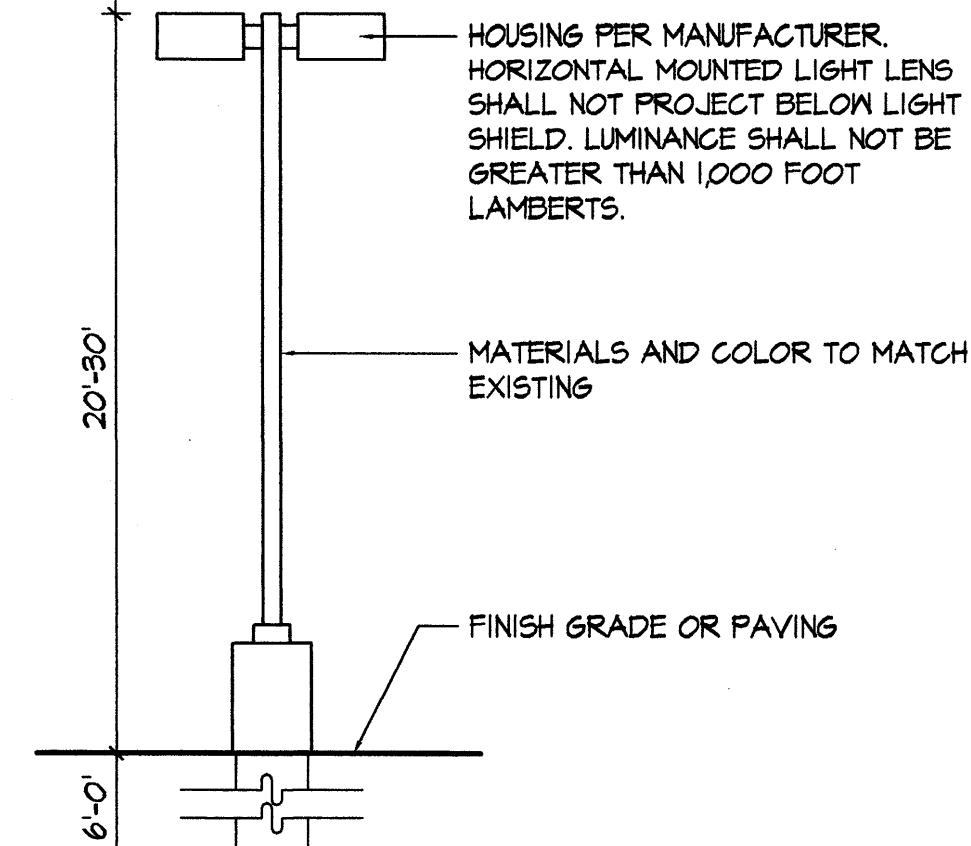

5 LIGHTING DETAIL (EXISTING)
A-301 NOT TO SCALE

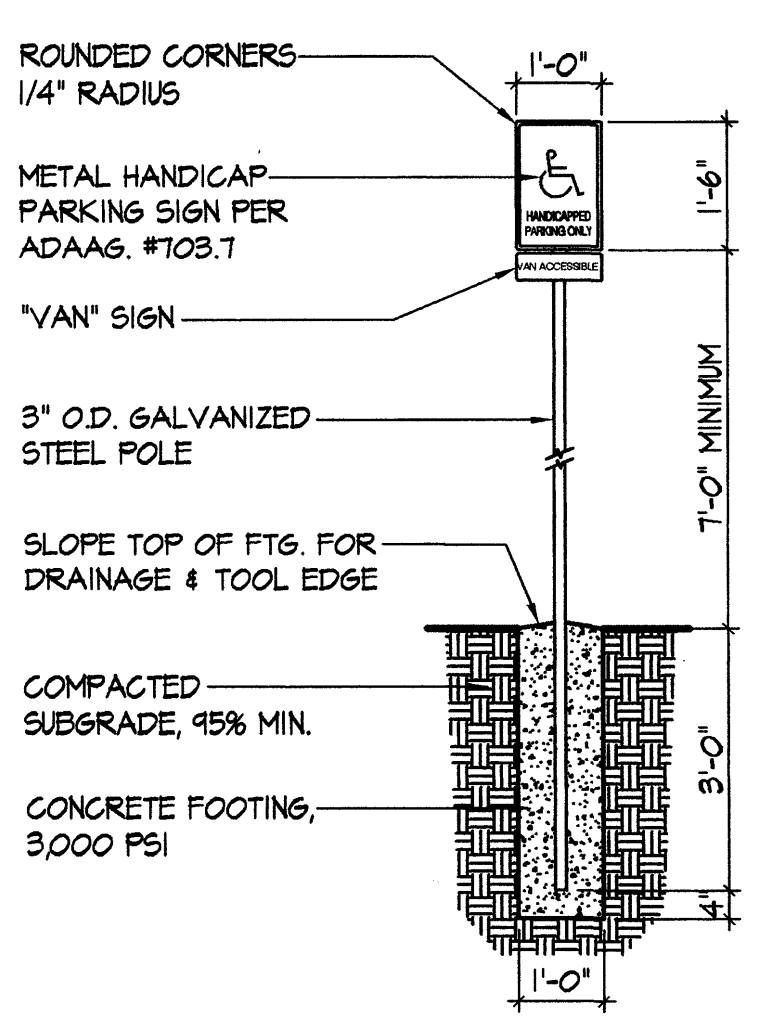

6 HANDICAP SIGN DETAIL
A-301 NOT TO SCALE

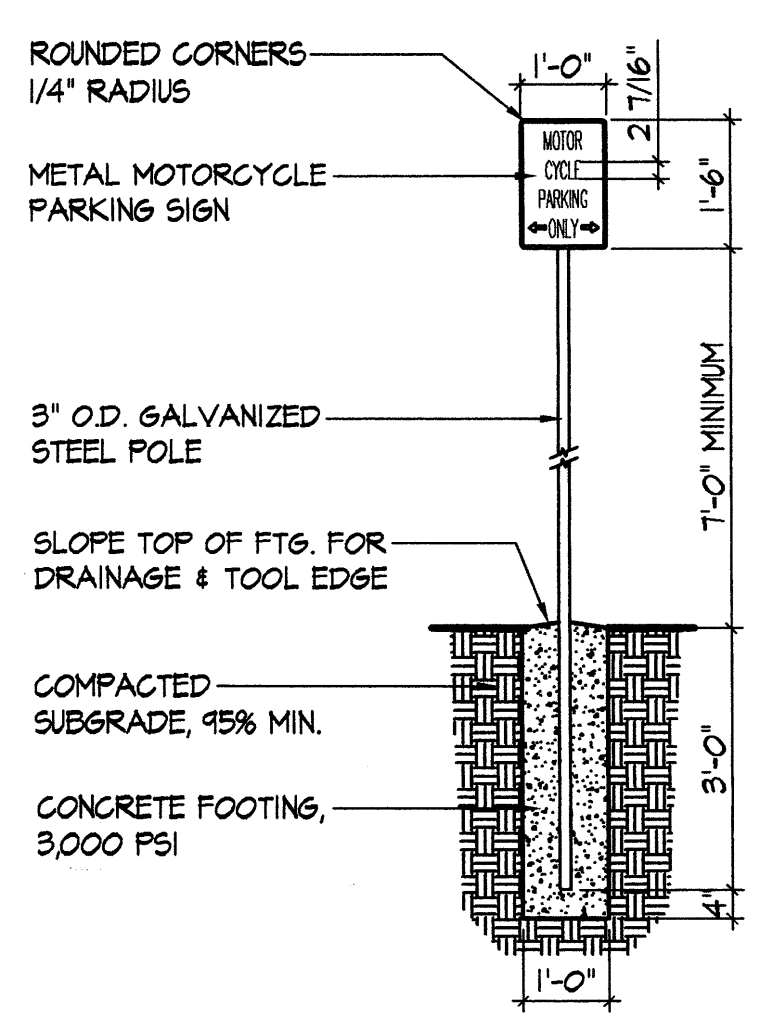

7 MOTORCYCLE SIGN DETAIL
A-301 NOT TO SCALE

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SEAL

SOUTHWEST FEDERAL CREDIT UNION
ALBUQUERQUE, NEW MEXICO

REVISIONS:
BY: C. GLASS
DATE: 05/03/10
NO. 1

ISSUE DATE
DRAWN BY: C. GLASS
DRAWN ON: 05/03/10
PROJECT#: 84-09-4866

SHEET TITLE:
SIGN ELEVATIONS

SHEET:
A-301

SHT: 7 OF 7