
BOUNDARY CURVE TAI		
C1 44.24' 30.00' 27.25'	<i>84'30'03"</i>	
C3 9.83' 5.00' 7.51' C4 44.45' 63.66' 23.18'	112°41′56″ 40°00′30″	
	17:38'11"	
CURVE LENGTH RADIUS TAMGENT	### 1001 BAY 1001	SAS — 72°SD —
HAINES	PARKING LOT LAYOUT SITE PLAN SCALE: 1" = 20' GRAPHIC SCALE	HEWOY
SITE PLAN LEGEND	20 0 20 40	
	(IN FEET)	
INDICATES EXTENT OF NEW CONCRETE PAVING AND CONCRETE SIDEWALKS	1 inch = 20ft.	
INDICATES EXTENT OF OPEN SPACE AREA - SEE LANDSCAPE PLAN		,
INDICATES EXTENT OF NEW ASPHALT PAVING - SEE SPECIFICATIONS		

CONSTRUCTION NOTES:

- (1) REMOVE 25 FEET OF AN EXISTING CONCRETE DRIVEWAY, CONCRETE VALLEY GUTTER, CURB AND GUTTER, SIDEWALK AND EXISTING ASPHALT PAVING.
- (2) CONSTRUCT STANDARD CURB AND GUTTER PER CITY STD. DWG. 2415A.
- (3) CONSTRUCT A 6' WIDE CONCRETE SIDEWALK PER CITY STD. DWG. 2430.
- (4) SEE LANDSCAPING PLAN FOR TREATMENT BETWEEN CURB AND SIDEWALK.
- (5) PARKING LOT BADGE ENTRY SYSTEM WITH GATE AT ENTRY AND AN EXIT CONTROL SYSTEM WITH SPIKES AT EXIT.
- (6) CONSTRUCT A 1'-6" HEADER CURB PER CITY STD. DWG. 2415B WITH 6" OF THE CURB ABOVE THE ASPHALT GRADE AND 12" BELOW THE ASPHALT GRADE.
- 7 PROVIDE 1' WIDE CURB OPENING AT 20' ON CENTER TO ALLOW DRAINAGE FROM PARKING LOT INTO LANDSCAPE WATER HARVESTING AREA, SEE DRAINAGE PLAN.
- (8) CONSTRUCT A 27' WIDE CONCRETE DRIVEPAD PER CITY STD.
- 9 SAWCUT AND REMOVE +/-10' OF EXISTING CONCRETE DRIVEWAY AND REPLACE WITH 9' OF CONCRETE SIDEWALK PER CITY STD. 2430.
- (10) SAWCUT AND REMOVE +/-12' OF EXISTING DRIVEWAY AND SIDEWALK.

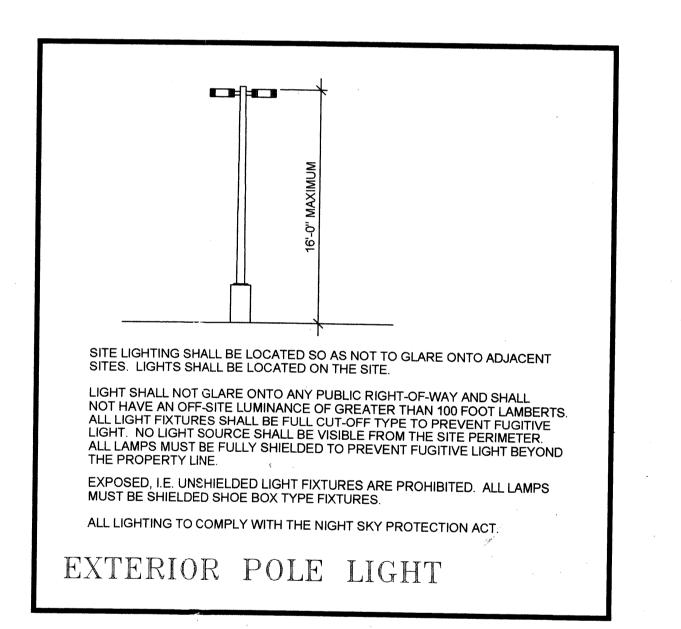

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- 2. TWO WORKING DAYS PRIOR TO ANY EXCAVATION, CONTRACTOR MUST CONTACT NEW MEXICO ONE CALL SYSTEM (260-1990) AND DETERMINE LOCATION OF EXISTING UTILITIES.
- 3. PRIOR TO ANY CONSTRUCTION, THE CONTRACTOR SHALL EXCAVATE AND VERIFY THE HORIZONTAL AND VERTICAL LOCATIONS OF ALL OBSTRUCTION. SHOULD A CONFLICT EXIST, THE CONTRACTOR SHALL NOTIFY THE ENGINEER OR THE OWNER SO THAT THE CONFLICT CAN BE RESOLVED WITHOUT DELAY.
- 4. CONTRACTOR WILL BE RESPONSIBLE FOR PROVIDING AND MAINTAINING ALL CONSTRUCTION BARRICADING UNTIL PROJECT HAS BEEN COMPLETED.
- 5. ADJUST ALL VALVE CANS AND SEWER LINE CLEANOUTS TO FINAL GRADE.

PARKING CRITERIA

 ${f PROJECT}$: NEW MEXICO EDUCATORS FEDERAL CREDIT UNION EMPLOYEE PARKING LOT NEW MEXICO EDUCATORS FEDERAL CREDIT UNION OWNER:

P.O.BOX 8530 ALBUQUERQUE, NEW MEXICO 87198 **ENGINEER:**

APPLIED ENGINEERING & SURVEYING, INC. 1605 BLAIR DRIVE NE ALBUQUERQUE, NEW MEXICO 87112


LEGAL DESCRIPTION: TRACT 2, BLOCK "F" BEVERLY-WOOD ADDITION ZONING CLASSIFICATION: SU-3 SPECIAL USE ZONE


ZONING ATLAS MAP: J-18 UNIFORM PROPERTY CODE: 1-018-058-445-515-11609 PARKING SPACES SIZES: 33 - 20'x8'-6" SPACES & 2 - 16'-6" X 8'-0" SPACES

BICYCLE SPACES: NOT APPLICABLE SITE LIGHTING: SEE DETAIL

TOTAL LOT AREA: 17,424SF LANDSCAPE AREA REQUIRED: SEE LANDSCAPE PLAN

LANDSCAPE AREA PROVIDED: SEE LANDSCAPE PLAN

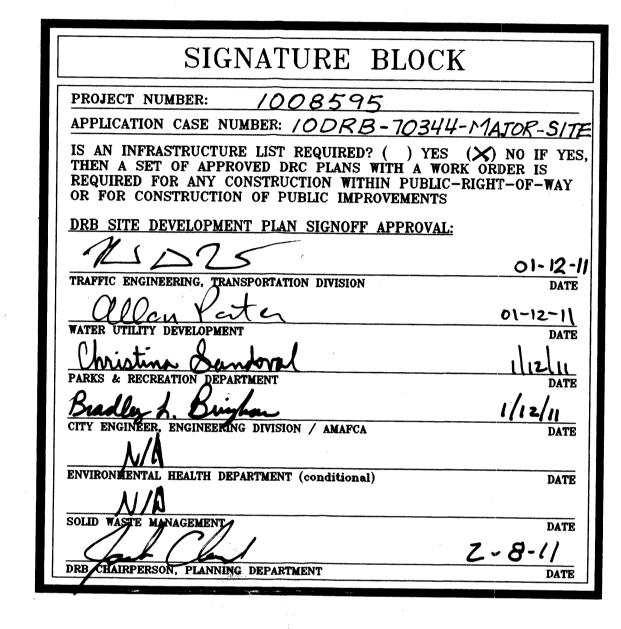

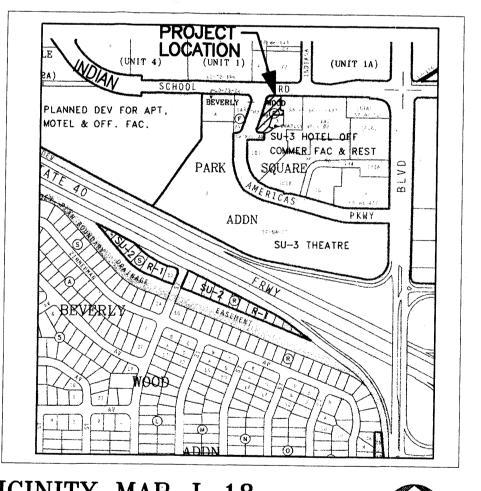

VICINITY MAP J-18 SCALE: N.T.S.

APD PLANS CHECHNIS CTTISE

UTILITY PRECAUTIONS THE CONTRACTOR SHALL INFORM ITSELF OF THE LOCATION OF ANY UTILITY LINE, PIPELINE, OR UNDERGROUND UTILITY LINE IN OR NEAR THE AREA OF THE WORK IN ADVANCE OF AND DURING EXCAVATION WORK. THE CONTRACTOR IS FULLY RESPONSIBLE FOR ANY AND ALL DAMAGE CAUSED BY ITS FAILURE TO LOCATE, IDENTIFY AND PRESERVE ANY AND ALL EXISTING UTILITIES, PIPELINES, AND UNDERGROUND UTILITY LINES. IN PLANNING AND CONDUCTING EXCAVATION, THE CONTRACTOR SHALL COMPLY WITH STATE STATUTES, MUNICIPAL AND LOCAL ORDINANCES, RULES AND REGULATIONS, IF ANY, PERTAINING TO THE LOCATION OF THESE LINES AND FACILITIES. APPLIED ENGINEERING AND SURVEYING, INC.

PLANNING AND SURVEYING


CIVIL ENGINEERING, LANDES

1605 Blair Drive NE Albuquerque, New Mexico 87112
Office: (505) 480-8125 Facsimile: (505) 237-8164 email: galdaz47@yahoo.com

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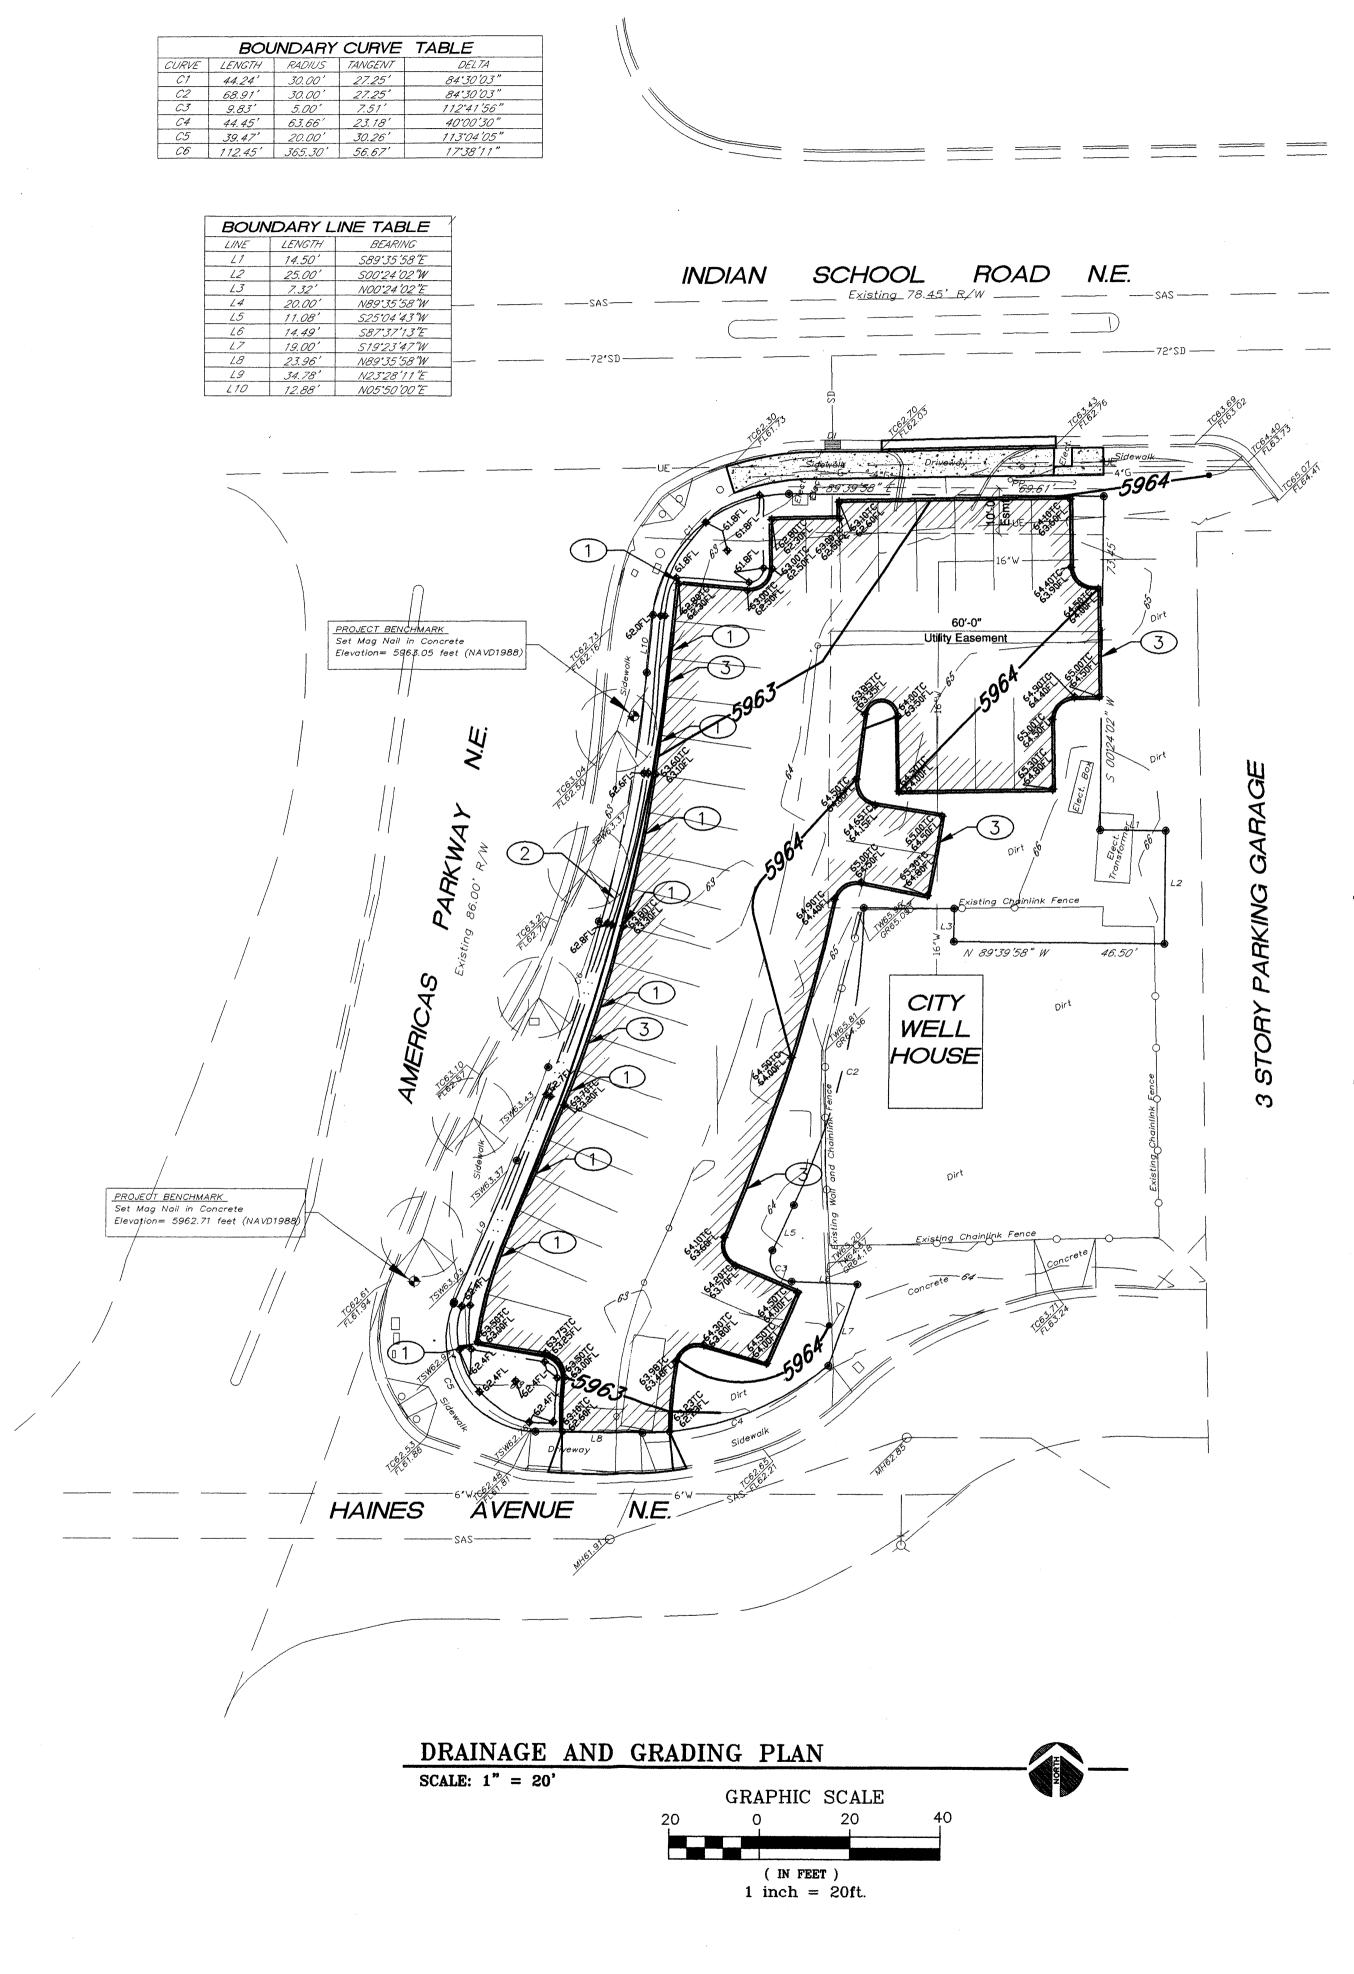
NM EDUCATORS PARKING LOT ALBUQUERQUE, NEW MEXICO


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SHEET TITLE PARKING LAYOUT SITE PLAN

> SHEET NUMBER SP-01

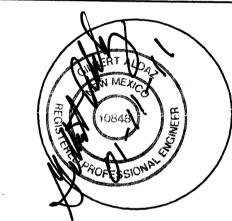




TYPICAL WATER HARVESTING LANDSCAPE AREA

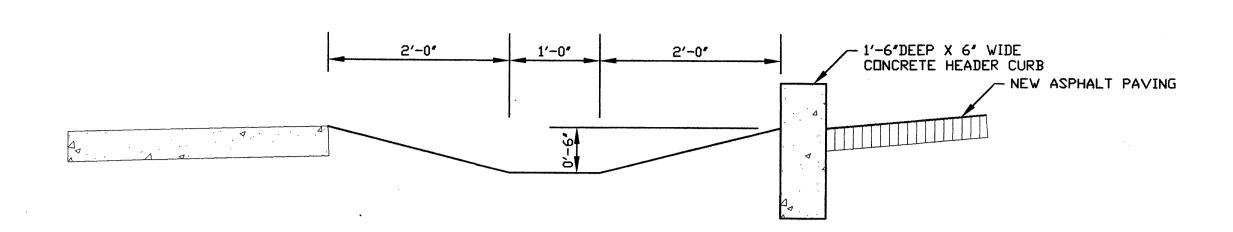CROSS SECTION VIEW

SCALE: 1" = 1'-0"

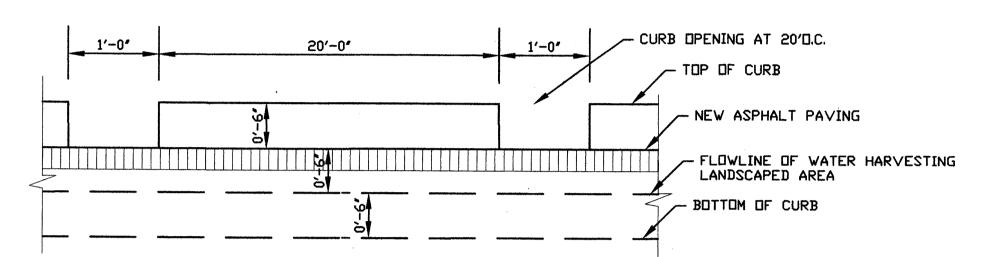

TYPICAL WATER HARVESTING LANDSCAPE AREA

LONGITUDINAL VIEW ALONG WEST CURB

SCALE: 1" = 1'-0"

CONSTRUCTION NOTES:

- 1 PROVIDE 1' WIDE CURB OPENING AT 20' ON CENTER.
- 2 PROPOSED PONDING AREA FOR WATER HARVESTING DRAINAGE FLOWS FROM PARKING LOT TO SUPPLEMENT LANDSCAPING.
- 3 CONSTRUCT 1'-6" HEADER CURB, 6" ABOVE ASPHALT AND 12" BELOW ASPHALT GRADE PER CITY STD. DWG. 2415B.

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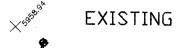
LEGEND



LIMITS OF ASPHALT PAVING REMOVAL AND REPLACEMENT, SEE PAVING SECTION.




EXISTING GRADE ELEVATION



PROPOSED FLOWLINE GRADE

PROPOSED TOP OF CURB

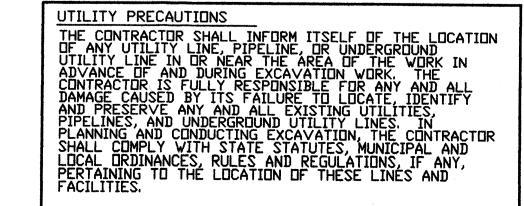

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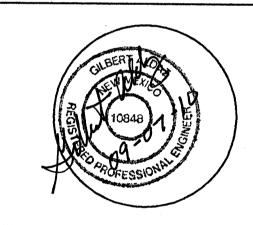
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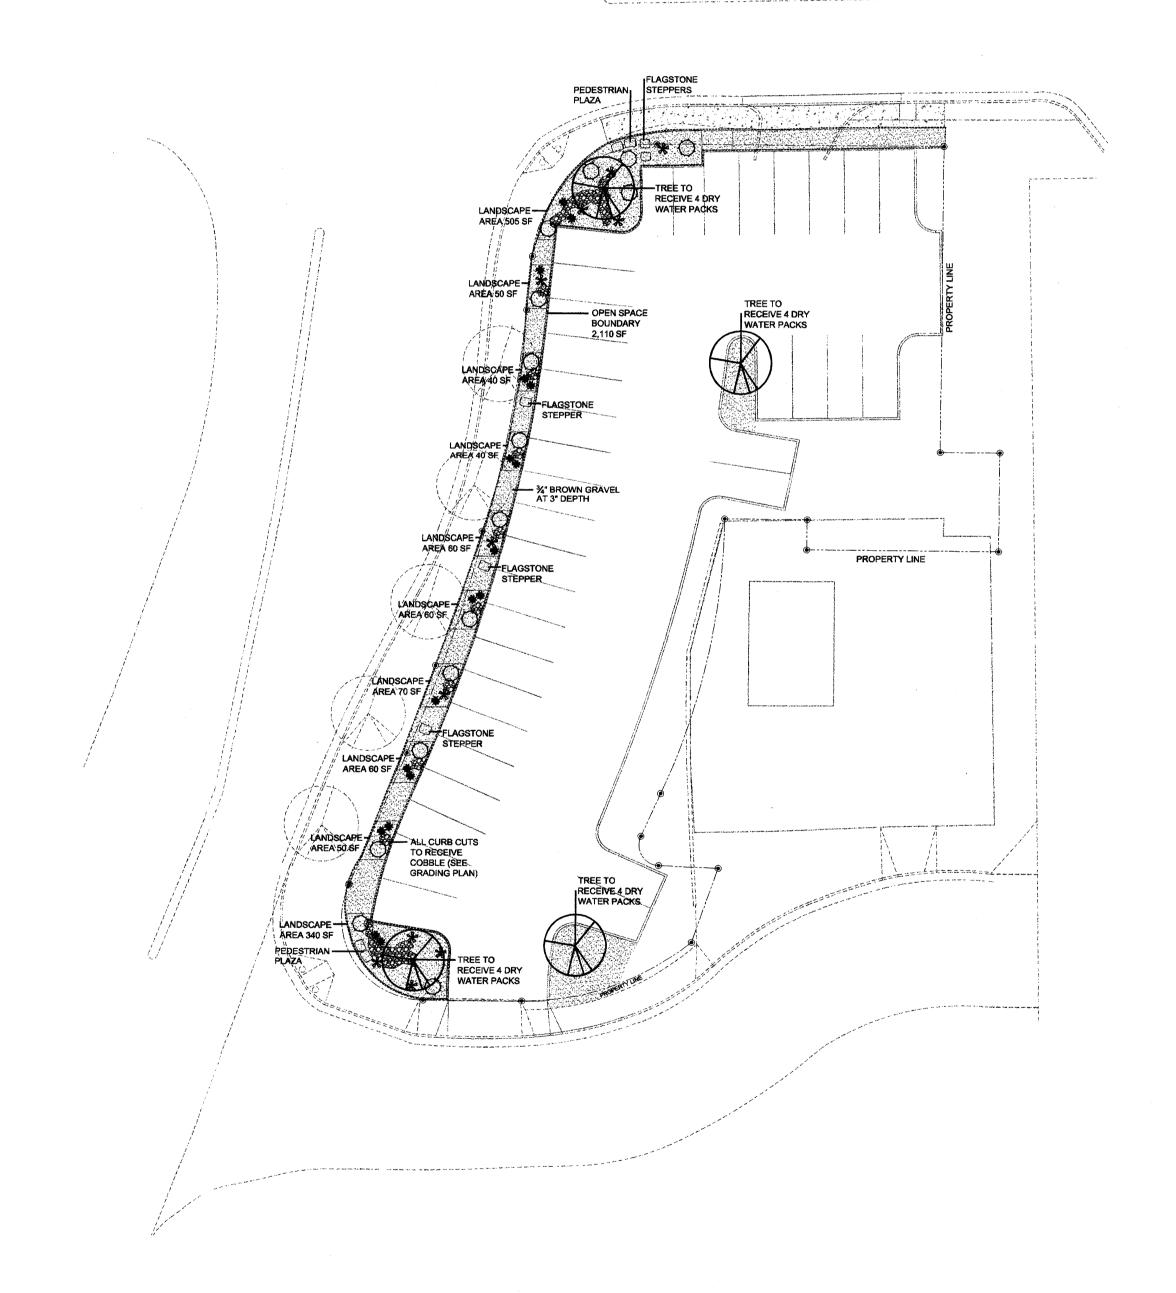
NM EDUCATORS
PARKING LOT
ALBUQUERQUE, NEW MEXICO

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PROPOSED
GRADING/DRAINAGE
IMPROVEMENTS


SHEET NUMBER



PLANT LEGEND Shrubs/Groundcovers Hesperaloe parviflora Red Yucca LANDSCAPE DATA GROSS LOT AREA/PHASE 1 LESS BUILDING(S) NET LOT AREA REQUIRED LANDSCAPE
 10% OPEN SPACE
 2.110 SF

 40% OF OPEN SPACE LANDSCAPE
 844 SF

 LANDSCAPE PROVIDED (60%)
 1,275 SF
 REQUIRED PARKING LOT TREES PROVIDED AT 1 PER 8 SPACES (37 SPACES/8) REQUIRED LANDSCAPE COVERAGE 60% LIVE VEGETATIVE MATERIAL (1,275 SF x 60%) 765 SF MIN. PROVIDED LANDSCAPE COVERAGE 781 SF (61%) GRAVEL USE 5% OF OPEN SPACE (2,110 SF x 5%) 105 SF MIN. 105 SF (5%) NOTE MAINTENANCE OF LANDSCAPE AND IS THE RESPONSIBILITY OF THE OWNER WATER MANAGEMENT IS THE SOLE RESPONSIBILITY OF THE PROPERTY OWNER THIS PLAN IS TO COMPLY WITH UPTOWN SECTOR DEVELOPMENT PLAN THIS PLAN SHALL PROVIDE AT MINIMUM 60% LIVE GROUNDCOVER OF LANDSCAPE AREAS AT MATURITY. LANDSCAPE AREAS TO BE MULCHED WITH 3/4" BROWN GRAVEL AT 3" DEPTH APPROVAL OF THE LANDSCAPE PLAN DOES NOT CONSTITUTE OR IMPLY COMPLIANCE WITH, OR EXEMPTION FROM, THE C.O.A LANDSCAPE AND WATER WASTE ORDINANCE ONCE INSTALLED AND RESPONSIBILITY IS TURNED OVER TO THE OWNER TREES ARE NOT TO BE PLACED IN PUBLIC UTILITY EASEMENTS PROVIDE CURB CUTS INTO LANDSCAPE AREAS TO ALLOW FOR PASSIVE WATER HARVESTING

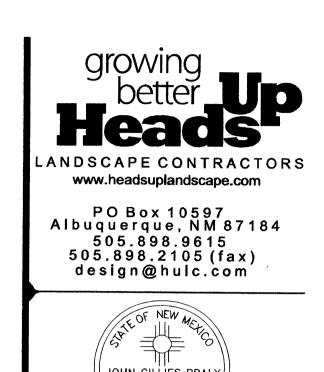

Date: 8/5/2010
Revisions: 9/29/10
10/04/10

Drawn by: <u>MSW</u> Reviewed by: <u>Hulc</u>

ark

ing Lot

lbuquerque, New Mexico

NORTH

Scale: 1" = 20'



Sheet Title:

Landscape Plan

Sheet Number:

LS-01