


SITE DATA SU-1 FOR PLANNED INDUSTRIAL PARK 516,188 SF (11.85 AC) PROPOSED USAGE TRUCK TERMINAL BUILDING AREA OFFICE DOCK 3,818 SF 15,995 SF 19,813 SF FUEL ISLAND 3,410 SF OCCUPANCY: DOCK-S1 OFFICE-B CONSTRUCTION TYPE: 11-B, UNPROTECTED PARKING REQUIRED OFFICE 20 SPACES (1 SPACE PER 200 SF) 8 SPACES (1 SPACE PER 2000 SF) WAREHOUSE HC PARKING REQUIRED 3 SPACES 3 SPACES (1 VAN ACCESSIBLE) 70 SPACES HC PARKING PROVIDED TOTAL PARKING PROVIDED MC PARKING REQUIRED 2 SPACES 2 SPACES MC PARKING PROVIDED

5 SPACES

TRAILER STORAGE BREAKDOWN

KEYED NOTE:

- (A) 6" MEDIAN CURB & GUTTER PER COA STD DWG #2415B
- (B) 4" THICK CONCRETE SIDEWALK PER COA STD DWG #2430
- C DRIVEWAY PER COA STD DWG #2426 (HEAVY DUTY CONCRETE PVMT)
- (D) HC RAMP PER DETAIL ON SHEET C5
- E ACCESSIBLE RAMP W/ TRUNCATED DOMES PER COA STD
- F) ACCESSIBLE PARKING PER ADA STANDARDS, DETAILS ON C4 & C5
- G CHAIN LINK FENCE W/SLIDING VEHICLE GATE, SEE ARCHITECTURAL & MEP PLANS
- (H) TUBULAR STEEL FENCE PER DETAIL ON C4.
- TUBULAR STEEL FENCE VEHICULAR GATE. FENCE PER DETAIL ON U4, MAKUWAKE PER ARCH DETAILS.
- (J) TRANSFORMER, REF MEP PLANS. COORDINATE W/ PNM.
- (K) MONUMENT SIGN PER ARCH DETAILS
- L BIKERACK PER DETAIL C4.
- (M) 8" BOLLARDS (4 IN EACH LOCATION TYP.) PER ARCH DETAILS.
- (N) 8' CHAIN LINK FENCE WITH 3 STRAND BARBED WIRE PER ARCH DETAILS.
- (0) FIRE HYDRANT, SEE SHEET C3.
- (P) 30 CY TRASH CONTAINER (SCREENED FROM PUBLIC VIEW BEHIND BLDG)
- Q TUBULAR STEEL MAN GATE. FENCE PER DETAIL ON C4, HARDWARE PER ARCH DETAILS.
- (R) CHAIN LINK/BARBED WIRE MAN GATE PER ARCH DETAILS.
- (S) HEAVY DUTY CONCRETE PAVEMENT PER DETAIL SHEET C4. T HEAVY DUTY ASPHALT PAVEMENT PER DETAIL SHEET C4.
- (U) STANDARD DUTY ASPHALT PAVEMENT PER DETAIL SHEET C4.
- (V) LIGHT POLE, SEE MEP PLANS.
- (W) CANOPY MOUNTED LIGHTS, SEE ARCH/MEP PLANS.
- (X) APPROXIMATE LOCATION UNDERGROUND FUEL TANKS.
- Y FUEL CANOPY PER ARCHITECTURAL PLANS.
- (Z) 4" WIDE PAINTED STRIPING (2 COATS)
- (A) 8' HIGH CMU SCREEN WALL PER DETAIL SHEET C4.
- BB SINGLE 10' WIDE SWING GATE W/ CHAIN LINK/BARBED WIRE TO MATCH ARCHITECTURAL DETAILS.
- (CC) EXISTING CHAIN LINK/BARBED WIRE FENCE TO REMAIN.
- DD 10'X12' CONCRETE PAD FOR FLUIDS BUILDING PER HEAVY DUTY CONCRETE DETAIL SHEET C4.
- (EE) TYPE "B" INTEGRAL CURB PER DETAIL SHEET C4.
- (FF) "TRUCKS ONLY" SIGN
- (HH) "DO NOT ENTER" SIGN
- (II) "ONE WAY" SIGN
- (JJ) PAINTED DIRECTIONAL ARROWS PER DETAIL SHEET C5.

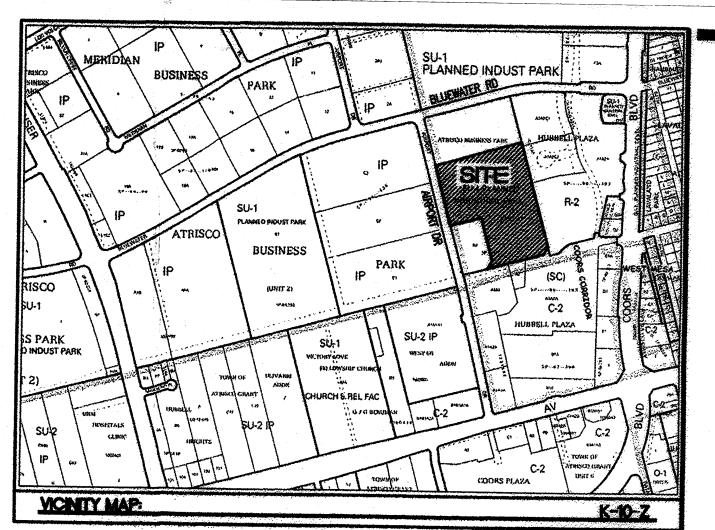

LEGAL DESCRIPTION

TRACT "B-1-B" OF ATRISCO BUSINESS PARK, UNIT ONE, AS THE SAME IS SHOWN AND DESIGNATED ON THE PLAT THEREOF, FILED IN THE OFFICE OF THE COUNTY CLERK OF BERNALILLO COUNTY, NEW MEXICO, ON 02/04/13, AS DOCUMENT NO. 2013012914.

SCREEN WALL (EAST PROPERTY LINE) EXISTING SIDEWALK - CHAIN LINK FENCE WITH 3 STRAND BARBED WIRE HEAVY DUTY CONCRETE EXXXXXXXXXXXXX SITE VISIBILITY AREA

PROJECT NUMBER: 1009544 APPLICATION NUMBER: 13 DRB-70458 is an infrastructure List required? () Yes () No if Yes, then a set of approved DRC plans with a work order is required for any construction within Public Right—of—Way or for construction of public improvements. DRB SITE DEVELOPMENT PLAN SIGNOFF APPROVAL: Traffic Engineer, Transportation Division 03 | 20 | 13 Date 03/20/13 Water Utility Development Date Carol 5. Duniont
Parks & Recreation Department 3-20-13 Date 3-20-13 City Engineer * Environmental Health Department (conditional) 3-21-13 Solid Waste Magagement Date 3-21-13 DRB Chairperson, Planning Department Date Environmental Health, if necessary

INDEX TO DRAWINGS SITE PLAN FOR BUILDING PERMIT GRADING AND DRAINAGE PLAN MASTER UTILITY PLAN DETAIL SHEET C5. DETAIL SHEET C6. DEMOLITION PLAN A2.4 BUILDING ELEVATIONS A3.1 BUILDING ELEVATIONS

LS-3. LANDSCAPING PLAN

29 9 Building Schw 2349 Dallas **Schwob**

ပ္ပ

P. #16892

GHT I

 α


Final Permit Set: 03-01-13


ODFL Albuquerque, NM - ALI

Project No. 12071.00 The Architect hereby reserves its common low copyright and other property rights in these plans, ideas and designs which are not to be reproduced, changed or capied in any form or manner whatsoever; nor are they to be assigned to any third party without first obtaining the express written permission from the Architect. The drawing is not final or to be used for construction until signed by the Architect.

Sheet Name: SITE PLAN FOR **BUILDING PERMIT**

Sheet Number:

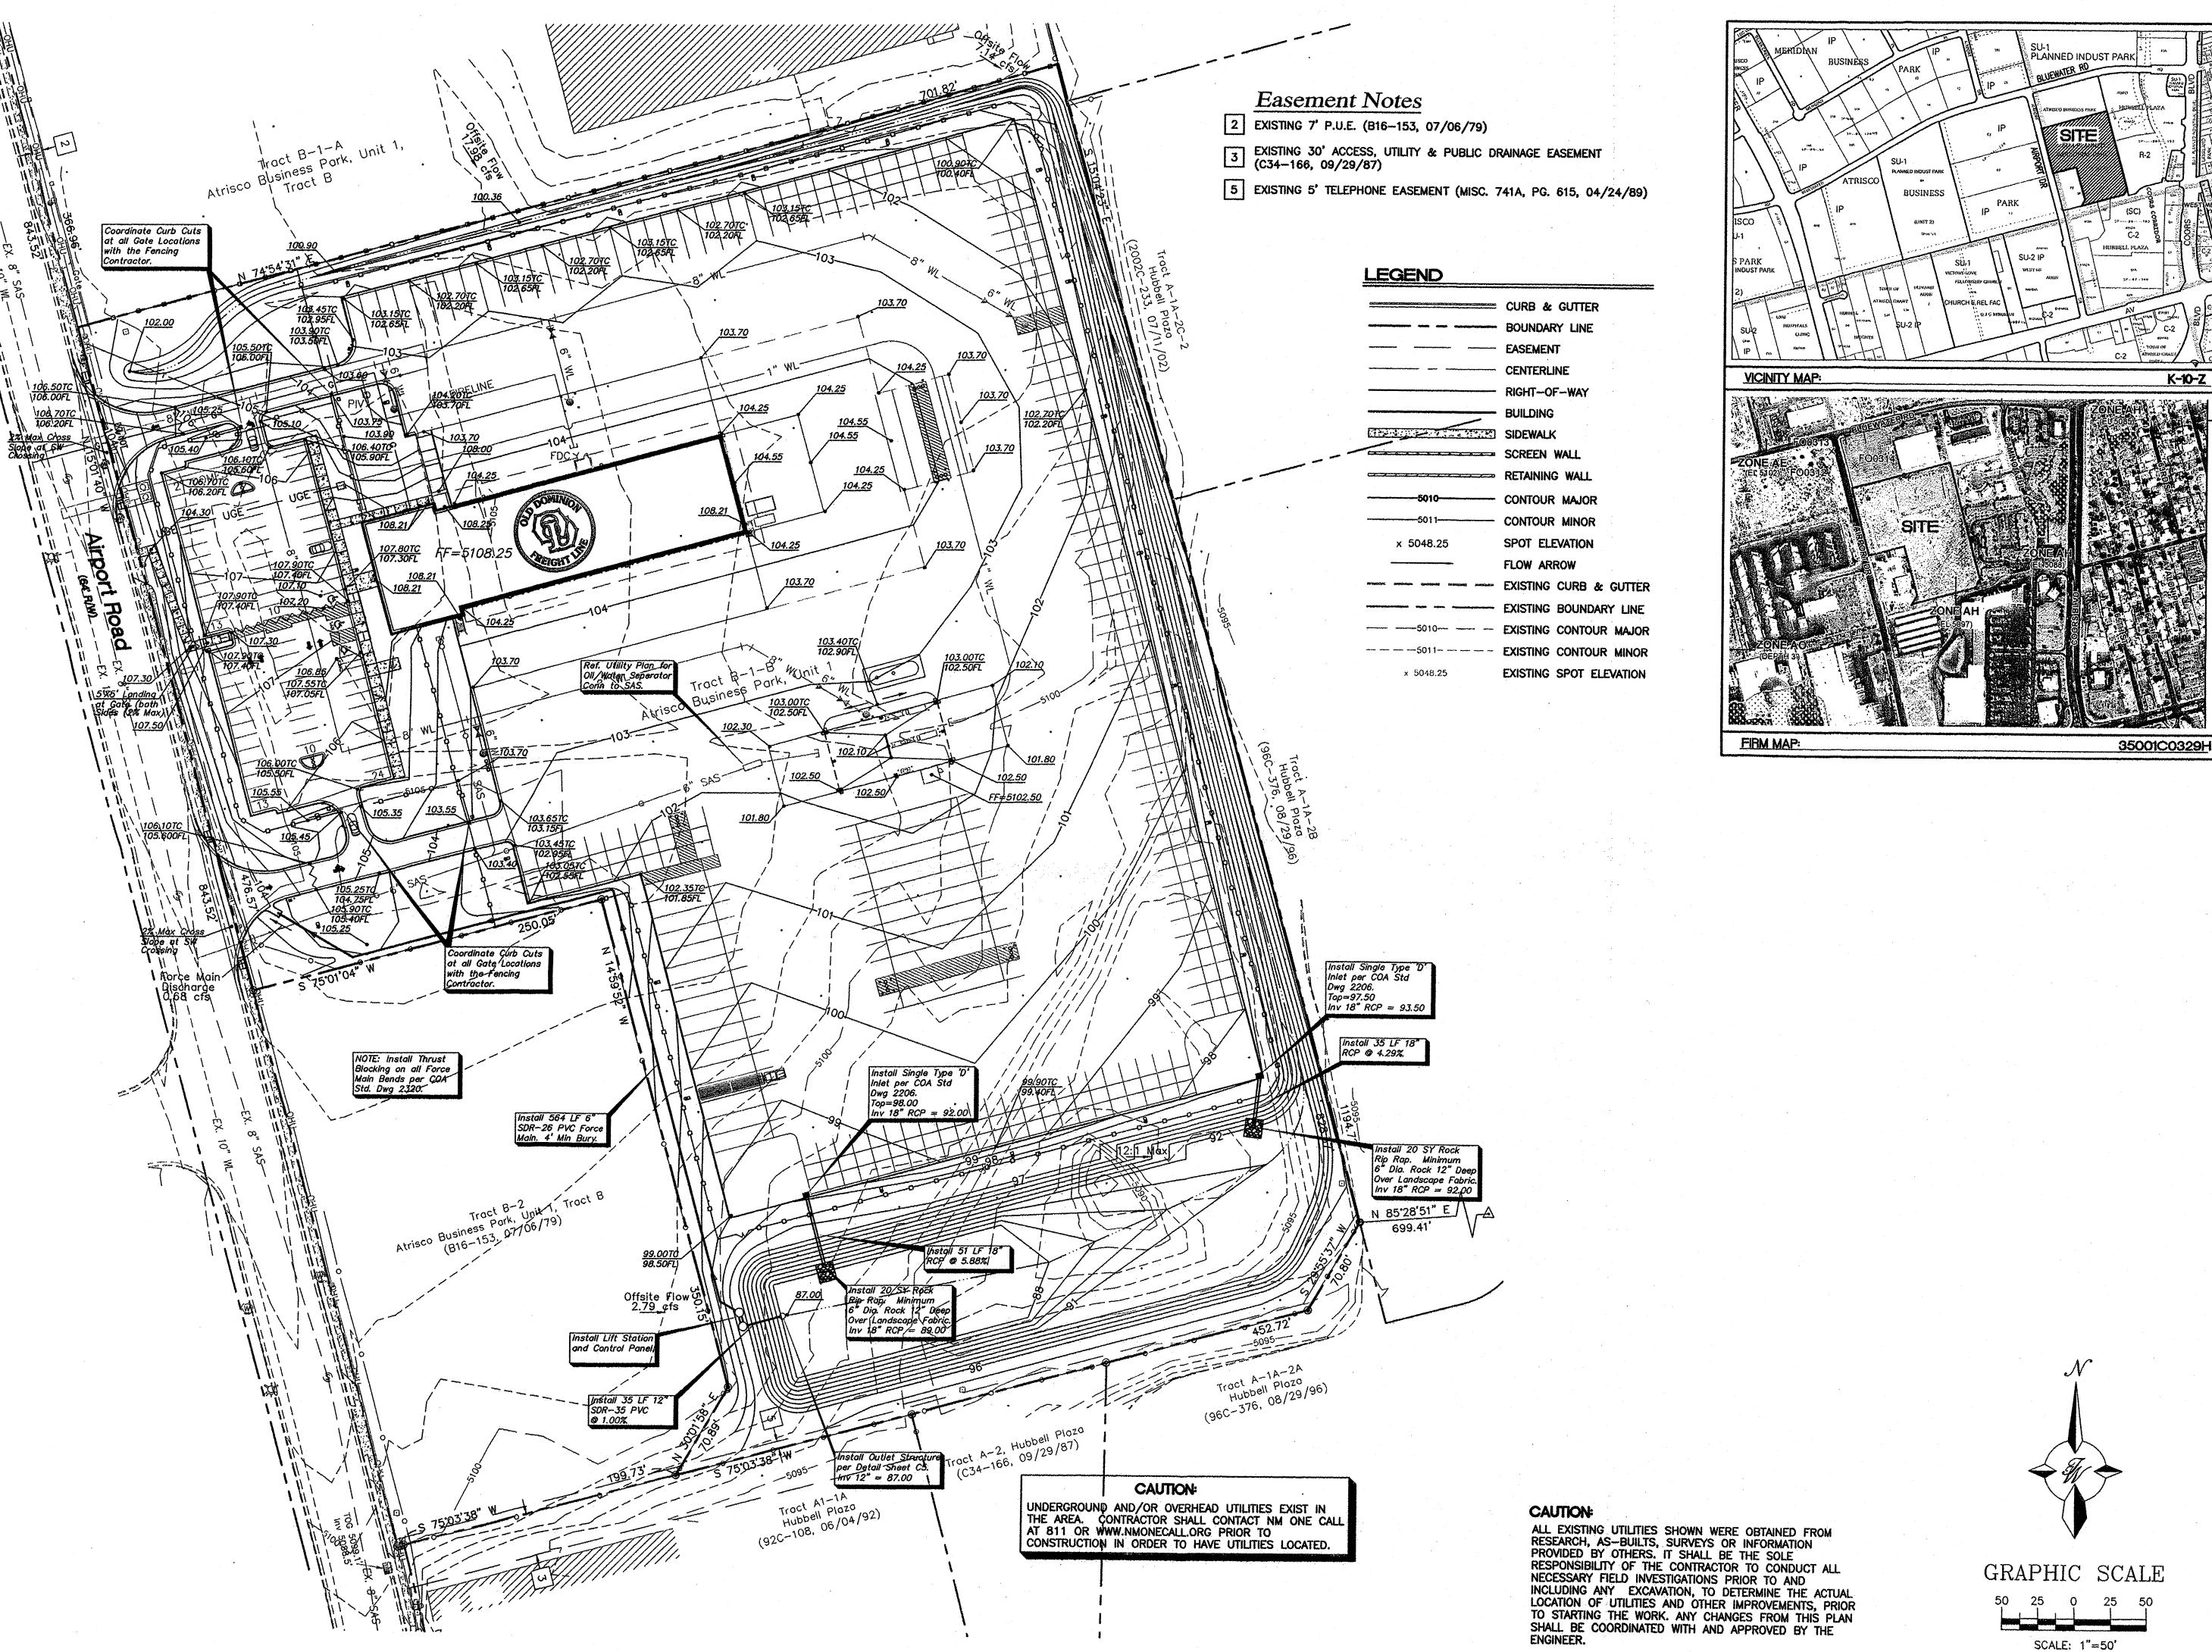

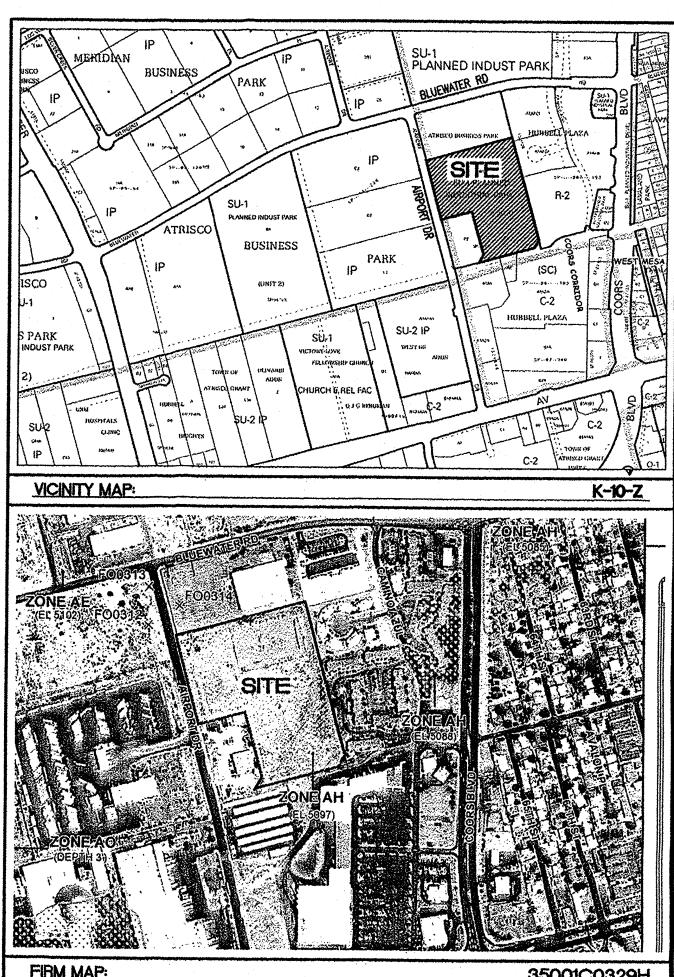


Building enda Lar TX 75229 Schwob 2349 Gl Dallas,

Schwob BUILDING COMPANY, LTD

LINE NW VM 8712

Final Permit Set: 03-01-13

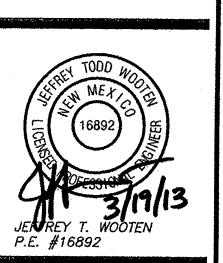


ODFL Albuquerque, NM - ALE

Project No. 12071.00

The Architect hereby reserves its common law copyright and other property rights in these plans, ideas and designs which are not to be reproduced, changed ar copied in any form or manner whatsoever; nor are they to be assigned to any third party without first obtaining the express written permission from the Architect. The drawing is not final or to be used for construction until signed by the Architect.

Sheet Name: GRADING AND DRAINAGE PLAN

Sheet Number:

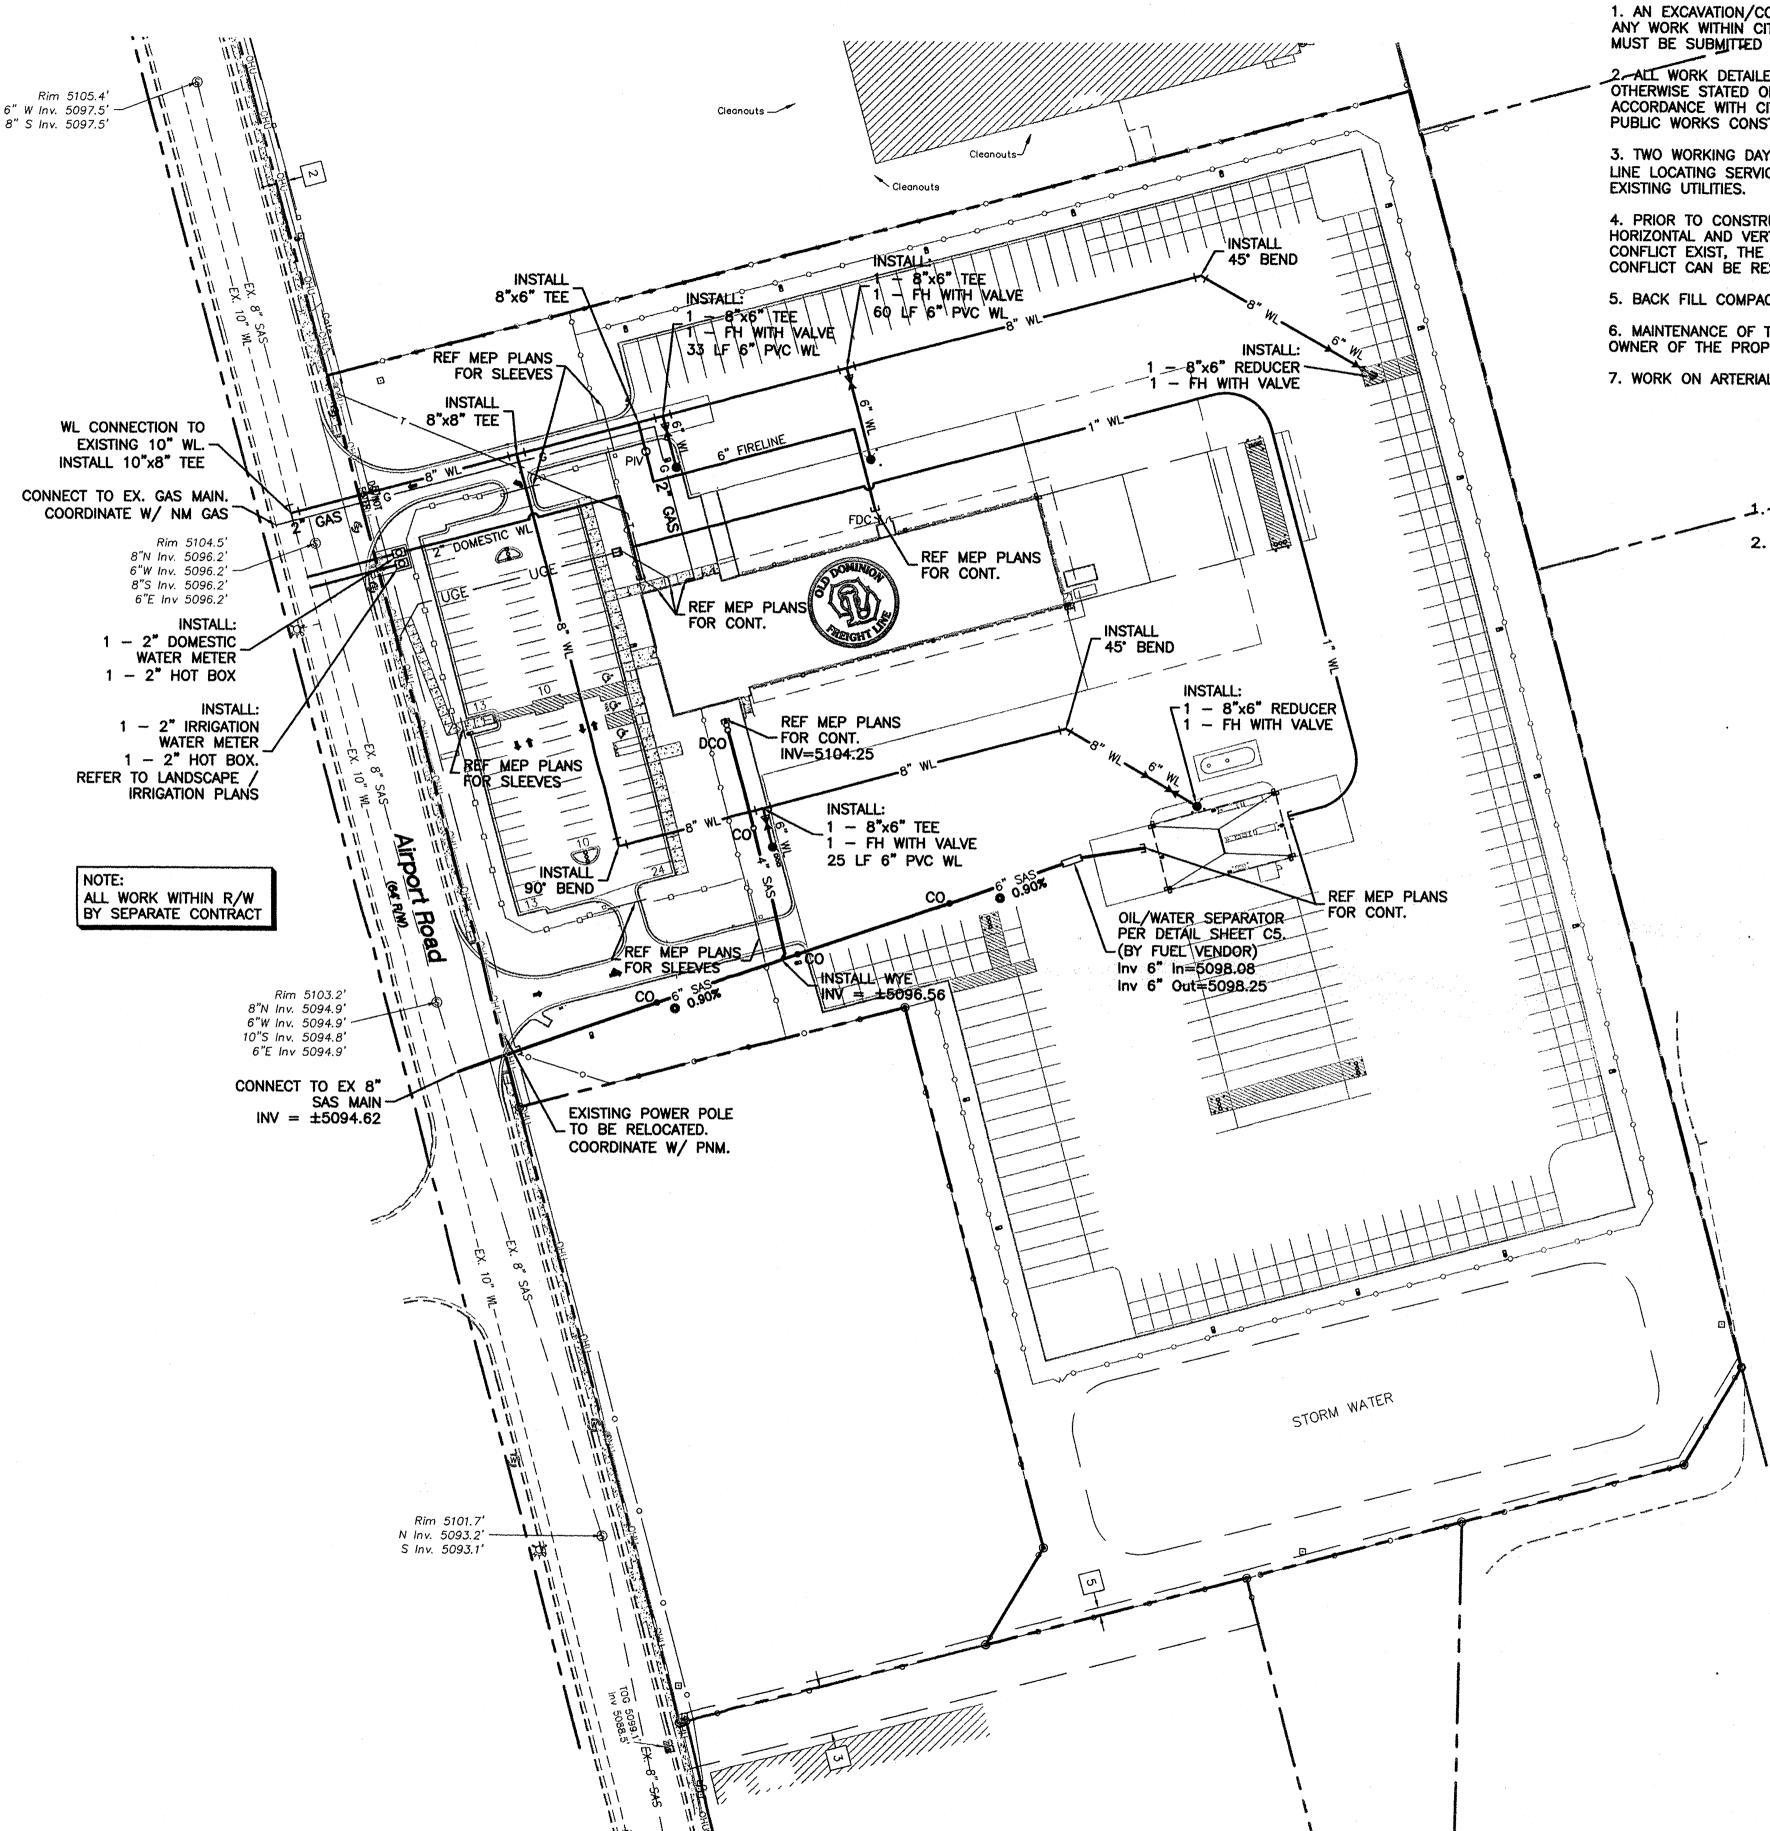

NOTICE TO CONTRACTORS

1. AN EXCAVATION/CONSTRUCTION PERMIT WILL BE REQUIRED BEFORE BEGINNING ANY WORK WITHIN CITY RIGHT-OF-WAY. AN APPROVED COPY OF THESE PLANS MUST BE SUBMITTED AT THE TIME OF APPLICATION FOR THIS PERMIT.

2-ALL WORK DETAILED ON THESE PLANS TO BE PERFORMED, EXCEPT AS OTHERWISE STATED OR PROVIDED HEREON, SHALL BE CONSTRUCTED IN ACCORDANCE WITH CITY OF ALBUQUERQUE INTERIM STANDARD SPECIFICATIONS FOR PUBLIC WORKS CONSTRUCTION, 1985.

3. TWO WORKING DAYS PRIOR TO ANY EXCAVATION, CONTRACTOR MUST CONTACT LINE LOCATING SERVICE, 260-1990 (OR DIAL 811 LOCALLY), FOR LOCATION OF

4. PRIOR TO CONSTRUCTION, THE CONTRACTOR SHALL EXCAVATE AND VERIFY THE HORIZONTAL AND VERTICAL LOCATIONS OF ALL CONSTRUCTIONS. SHOULD A CONFLICT EXIST, THE CONTRACTOR SHALL NOTIFY THE ENGINEER SO THAT THE CONFLICT CAN BE RESOLVED WITH A MINIMUM AMOUNT OF DELAY.

5. BACK FILL COMPACTION SHALL BE ACCORDING TO RESIDENTIAL STREET USE.

6. MAINTENANCE OF THESE FACILITIES SHALL BE THE RESPONSIBILITY OF THE OWNER OF THE PROPERTY SERVED.

7. WORK ON ARTERIAL STREETS SHALL BE PERFORMED ON A 24-HOUR BASIS.

GENERAL NOTES:

-ALL STUBS AND UTILITY LOCATIONS MUST BE FIELD VERIFIED PRIOR TO CONSTRUCTION.

2. SEE ARCHITECTURAL/MEP PLANS FOR LIGHTING CONDUITS AND TELÉPHONE LINES.

GENERAL UTILITY NOTES:

- 1. ALL WATER AND SEWER UTILITY WORK TO BE DONE IN ACCORDANCE WITH COA STANDARDS AND SPECIFICATIONS LATEST EDITION.
- 2. 4' MINIMUM BURY REQUIRED FOR ALL UTILITIES UNLESS OTHERWISE NOTED.
- 3. REFERENCE MEP PLANS FOR WATER LINE RISER LOCATIONS.
- 4. CLEAN OUTS ARE TO BE BUILT PER UNIFORM PLUMBING CODE STANDARDS.
- 5. ALL PLUMBING PIPE MATERIAL TO BE USED PER UPC.
- 6. FIRE LINE AND DOMESTIC WATERLINE MUST HAVE BACKFLOW PREVENTORS PER UPC. IF BACKFLOW PREVENTOR IS INSTALLED EXTERIOR OF BUILDING A HOT BOX SHALL BE INSTALLED AND USED.
- 7. ALL MANHOLES AND CLEANOUTS SHALL HAVE 8" THICK CONCRETE COLLARS POURED AND BE ADJUSTED TO FINISHED GRADE.
- 8. ALL EXCAVATION, TRENCHING AND SHORING ACTIVITIES MUST BE CARRIED-OUT IN ACCORDANCE WITH OSHA 29 CFR 1926.650 SUBPART P.
- 9. PNM HAS NUMEROUS ELECTRIC FACILITIES NEAR THIS SITE CURRENTLY SERVING EXISTING CUSTOMERS. THE APPLICANT SHALL COORDINATE WITH PNM REGARDING THESE EXISTING FACILITIES. ANY RELOCATION, CHANGES OR REALIGNMENT OF EXISTING ELECTRIC UTILITIES WILL BE THE DEVELOPER EXPENSE. IN SOME CASES, RELOCATION OR CHANGES TO EXISTING FACILITIES MAY NOT BE FEASIBLE DUE TO PHYSICAL, USE OR SAFETY CLEARANCE CONSTRAINTS.
- 10. PNM WILL REVIEW ALL TECHNICAL NEEDS, ISSUES AND SAFETY CLEARANCES FOR ITS ELECTRIC POWER SYSTEMS. ANY EXISTING AND PROPOSED PUBLIC UTILITY EASEMENTS SHALL BE INDICATED ON THE SITE PLAN UTILITY SHEET PRIOR TO DRB REVIEW. PNM'S STANDARD FOR PUBLIC UTILITY EASEMENTS IS 10 FEET IN WIDTH TO ENSURE ADEQUATE, SAFE CLEARANCES.
- 11. SCREENING SHALL BE DESIGNED TO ALLOW FOR ACCESS TO UTILITY FACILITIES. IT IS NECESSARY TO PROVIDE ADEQUATE CLEARANCE OF TEN FEET SURROUNDING ALL GROUND-MOUNTED UTILITIES FOR SAFE OPERATION. MAINTENANCE AND REPAIR PURPOSES.

CAUTION:

ENGINEER.

ALL EXISTING UTILITIES SHOWN WERE OBTAINED FROM RESEARCH, AS-BUILTS, SURVEYS OR INFORMATION PROVIDED BY OTHERS. IT SHALL BE THE SOLE


RESPONSIBILITY OF THE CONTRACTOR TO CONDUCT ALL

SHALL BE COORDINATED WITH AND APPROVED BY THE

INCLUDING ANY EXCAVATION, TO DETERMINE THE ACTUAL

LOCATION OF UTILITIES AND OTHER IMPROVEMENTS, PRIOR TO STARTING THE WORK. ANY CHANGES FROM THIS PLAN

NECESSARY FIELD INVESTIGATIONS PRIOR TO AND

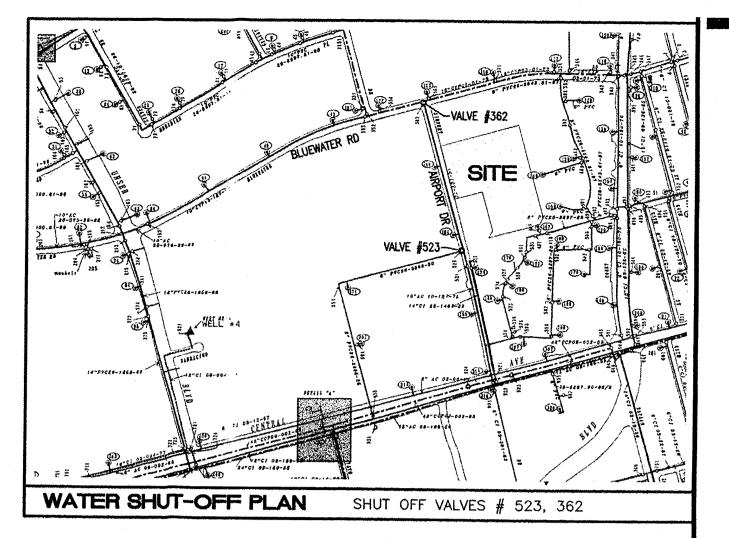

1. ONLY ABCWUA WATER SYSTEMS PERSONNEL ARE AUTHORIZED TO OPERATE VALVES.

2. THE CONTRACTOR SHALL COORDINATE WITH THE WATER AUTHORITY SEVEN (7) DAYS IN ADVANCE OF PERFORMING WORK THAT WILL AFFECT THE PUBLIC WATER OR SANITARY SEWER INFRASTRUCTURE. WORK REQUIRING SHUTOFF OF FACILITIES DESIGNATED AS MASTER PLAN FACILITIES MUST BE COORDINATED WITH THE WATER AUTHORITY 14 DAYS IN ADVANCE OF PERFORMING SUCH WORK. ONLY WATER AUTHORITY CREWS ARE AUTHORIZED TO OPERATE PUBLIC VALVES. SHUTOFF REQUESTS MUST BE MADE ONLINE AT HTTP://ABCWUA.ORG/CONTENT/VIEW/463/729/.

3. APPROXIMATE SHUT OFF TIME WILL BE 24 HOURS.

4. SHUTOFF THE VALVES INDICATED IN THE ABOVE PLAN.


5. IF REQUIRED, CONTRACTOR SHALL PREPARE AND SUBMIT A DETOUR PLAN FOR APPROVAL PRIOR TO BEGINNING WORK.

LEGEND


CURB & GUTTER BOUNDARY LINE EASEMENT CENTERLINE RIGHT-OF-WAY SIDEWALK SCREEN WALL RETAINING WALL EXISTING CURB & GUTTER EXISTING BOUNDARY LINE -36" SD----- STORM SEWER LINE -8" SAS----- SANITARY SEWER LINE -8" WL----- WATERLINE SINGLE CLEAN OUT DOUBLE CLEAN OUT EXISTING SD MANHOLE EXISTING INLET EXISTING SAS MANHOLE EXISTING FIRE HYDRANT EXISTING WATER METER EXISTING POWER POLE EXISTING GAS VALVE EXISTING OVERHEAD UTILITIES

----EX. UGE---- EXISTING UNDERGROUND UTILITIES ----EX. 2" GAS---- EXISTING GAS --- EX. 8" SAS--- EXISTING SANITARY SEWER LINE ----EX. 10" WL--- EXISTING WATER LINE

EXISTING STORM SEWER LINE

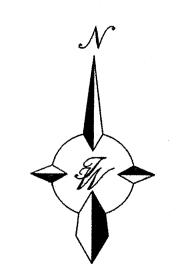

GRAPHIC SCALE

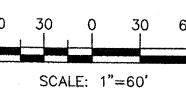

Sheet Number:

PLAN

Sheet Name:

MASTER UTILITY

AK NE 855 Taw

 $\overline{\mathbb{D}}$

 \circ

Bai

go

യ

992

Idina a L 752

qq

 $\overline{\mathbb{Q}}$

chw 349 allas

070

330 Albu

Final Permit Set: 03-01-13

ODFL Albuquerque, NM - AL

Project No. 12071.00


The Architect hereby reserves its common law copyright and other property rights in these plans, ideas and designs which are not to be reproduced, changed or copied in any form or manner whatsoever; nor are they to be assigned to any third party without first

obtaining the express written permission from the Architect. The drawing is not final or to

be used for construction until signed by the


Schwob

≤

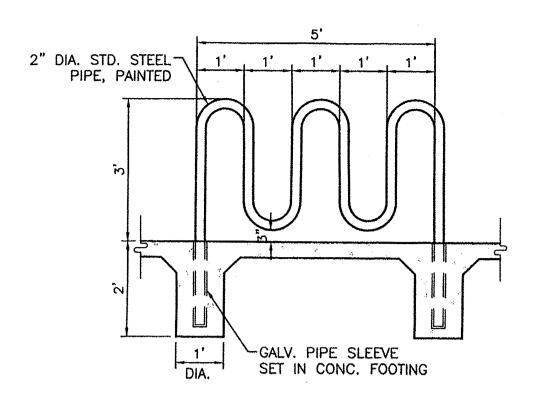


BIKE RACK DETAIL

SCALE: 1/2"=1'

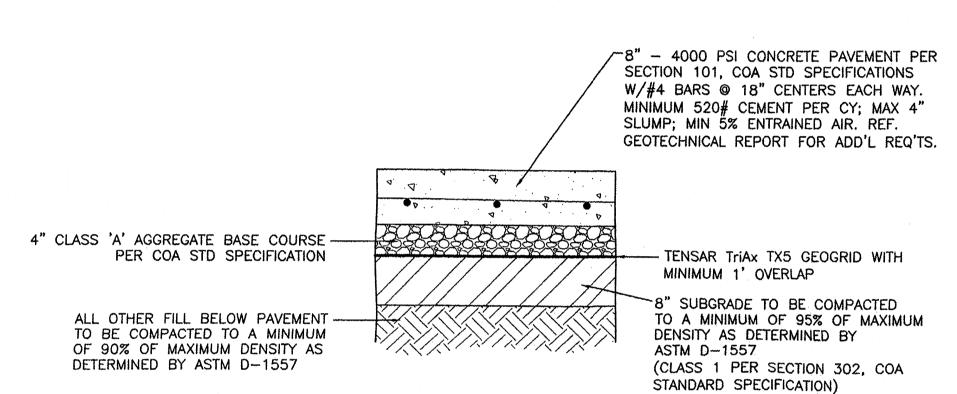


HEAVY DUTY CONCRETE TYPICAL PAVING SECTION

DESIGNATED BY X8E VINYARD.

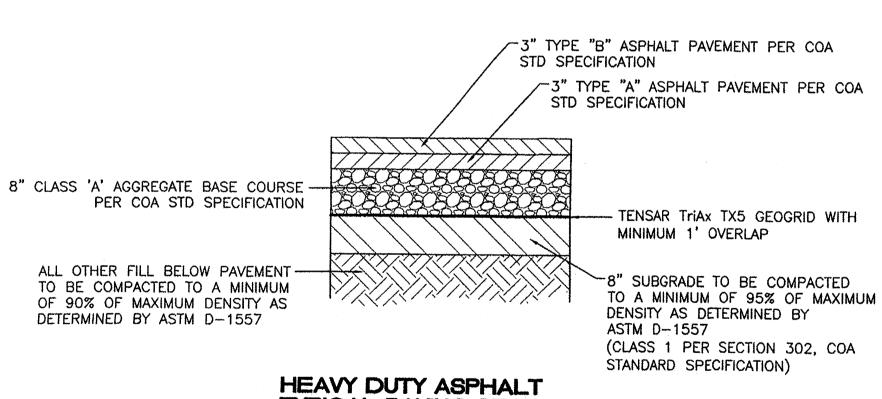


TYPICAL PAVING SECTION

DESIGNATED BY X8E VINYARD

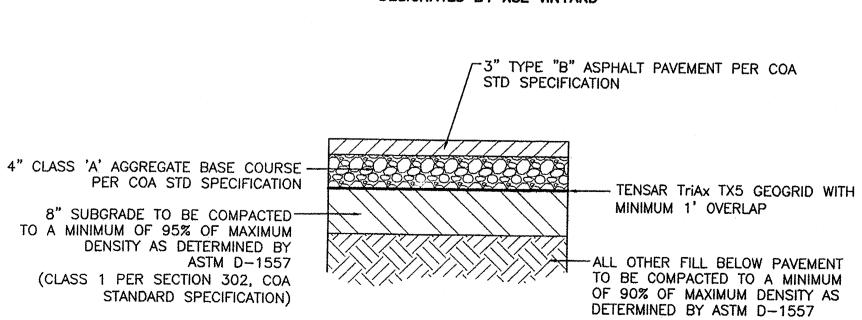



STANDARD DUTY ASPHALT TYPICAL PAVING SECTION

DESIGNATED BY X8E VINYARD

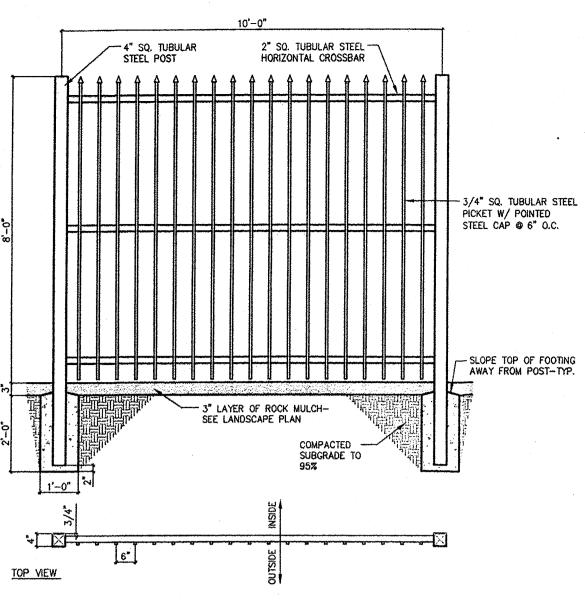

TUBULAR FENCE DETAIL

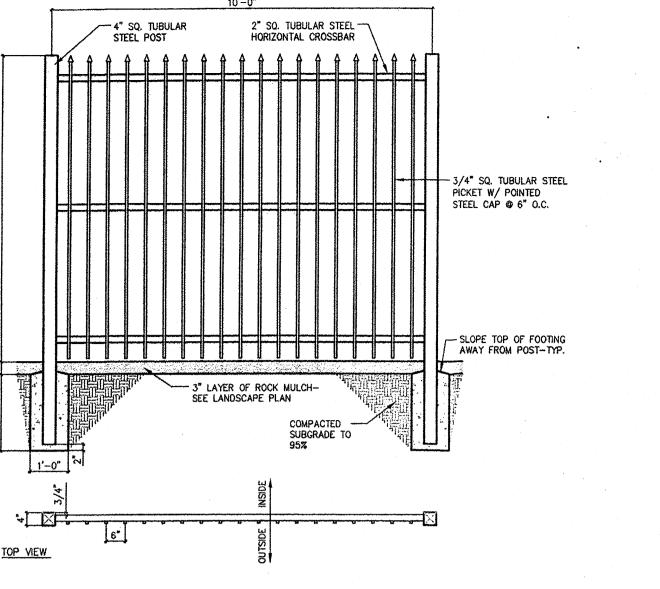

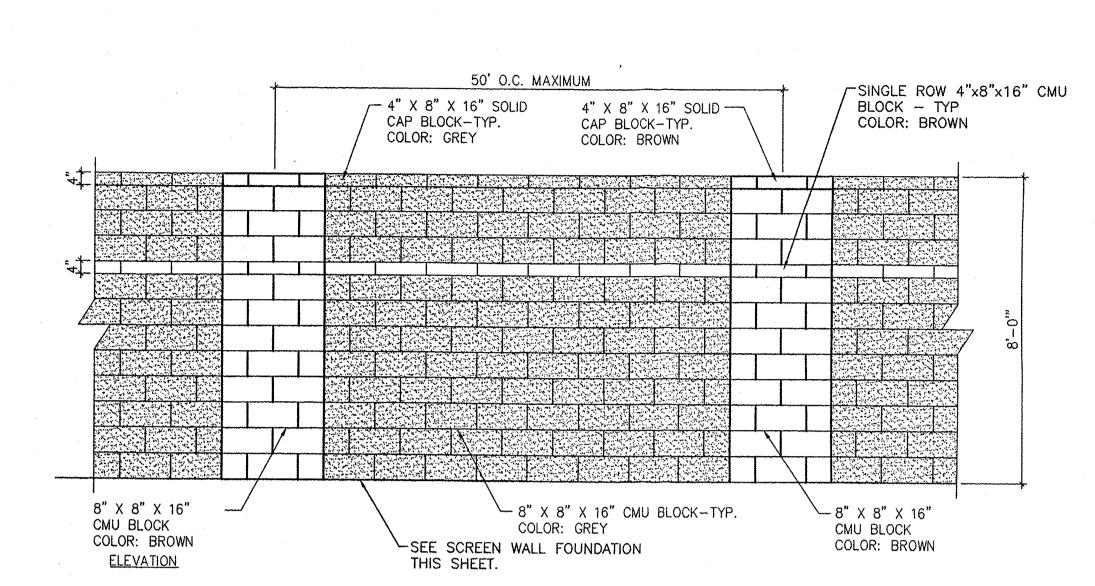

CMU SCREEN WALL DETAIL


GENERAL NOTES:


ALL CONCRETE IS TO BE 3000 PSI @ 28 DAYS. MINIMUM COMPACTION UNDER FOOTINGS IS TO BE 95% PER ASTM. D 1557 FOR A DEPTH OF 12" MOISTURE CONTENT IS


3'-0"

TOP VIEW (STREET SIDE)


- TO BE \pm 2.0%. 3. BACK FILL AGAINST WALLS IS TO BE HAND-PLACED AND
- COMPACTED. ALL BARS ARE TO BE GRADE 60, ASTM 615.
 TRUSS TYPE DUR-O-WALL EVERY OTHER COURSE.
- 6. DOWELS SHALL BE AT LEAST EQUAL IN SIZE AND SPACING TO V-BARS, SHALL PROJECT A MINIMUM OF 30 BAR DIA. INTO THE FILLED BLOCK CORES, AND SHALL EXTEND TO THE TOE OF THE FOOTING.
- 7. INSTALL EXPANSION JOINTS ON 20' CENTERS.

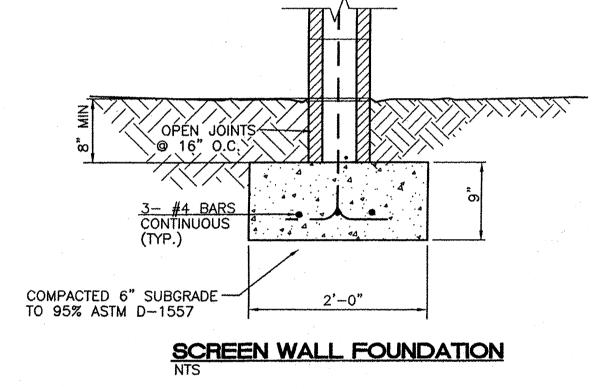

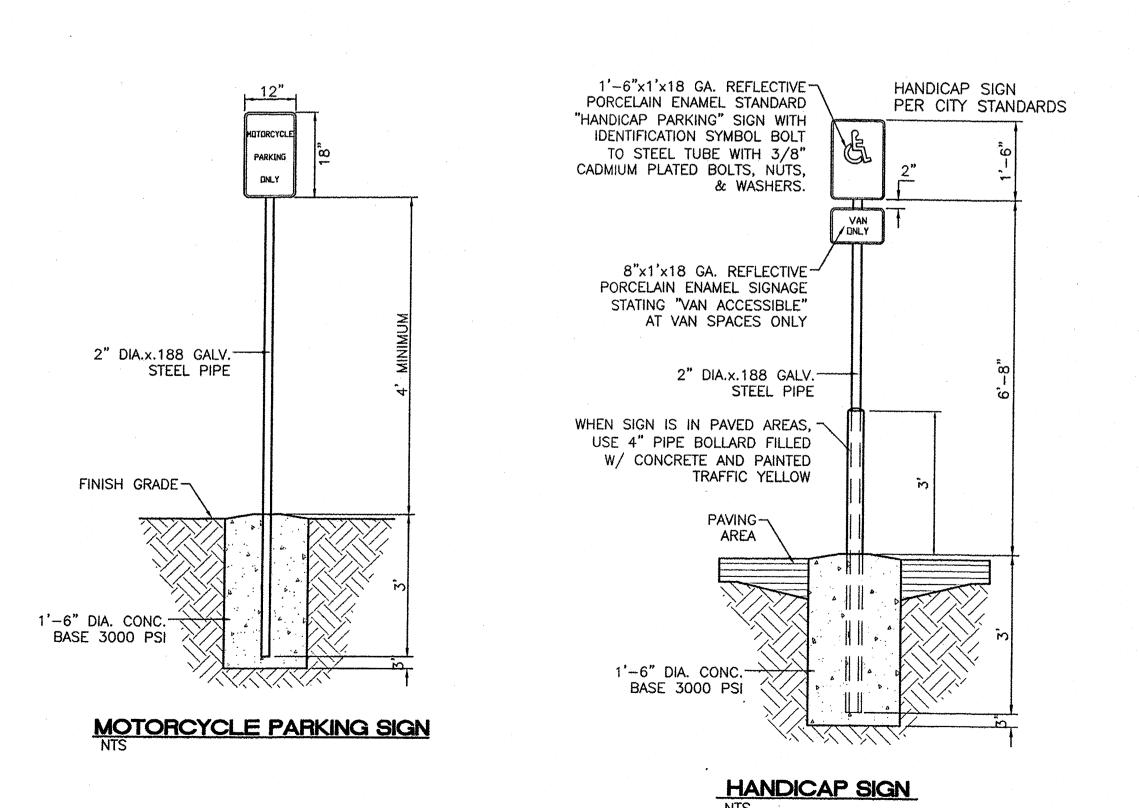

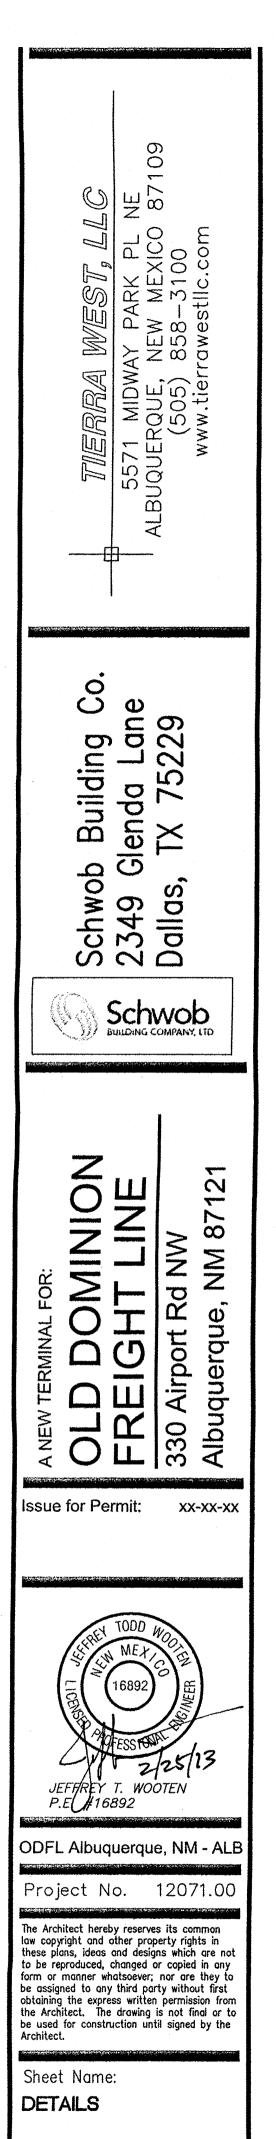


Sheet Number:

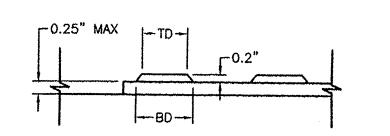



DOME SECTION

BD - BASE DIAMETER 0.9" MIN TD - TOP DIAMETER 50% OF BD MIN TO 65% OF BD MAX

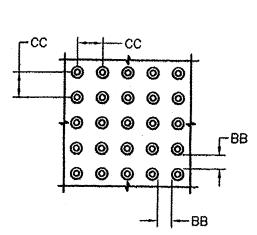


DOME SPACING CC - CENTER TO CENTER SPACING 2.35" BB - BASE TO BASE SPACING 1.48" MIN

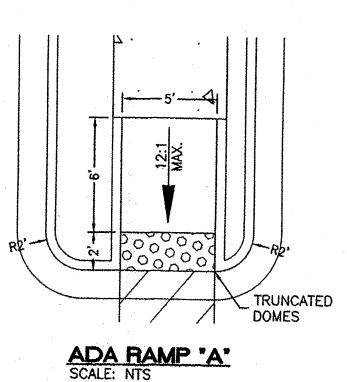

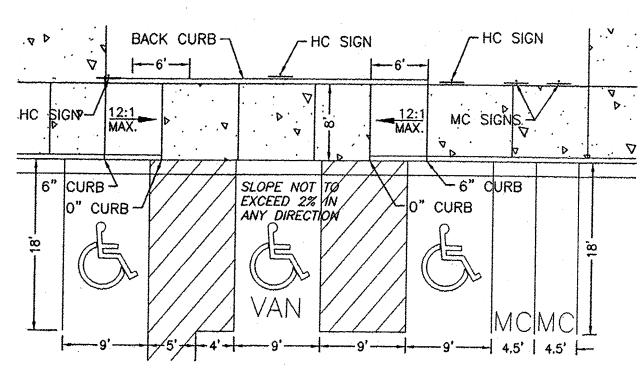

HC PARKING • MAIN BLDG. ENTRANCE
SCALE: NTS

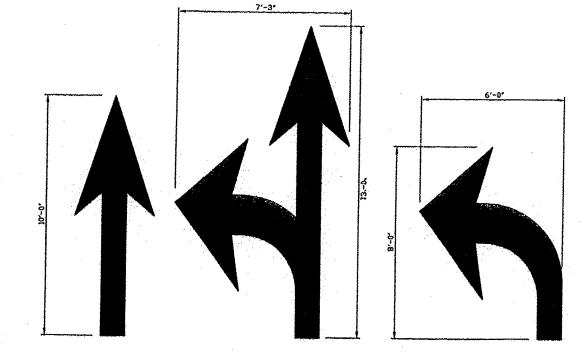


WORDS AND ARROWS SHALL BE APPLIED IN ACCORDANCE WITH SECTION 3B.20 OF THE MANUAL ON UNIFORM TRAFFIC CONTROL

THESE WORDS AND ARROWS ARE TO BE PAINTED RETROREFLECTIVE WHITE.


5-10-07


SOLID ARROW MARKINGS
USED AT EXITS FROM THE PARKING LOT TO PUBLIC STREETS


PAVEMENT MARKINGS

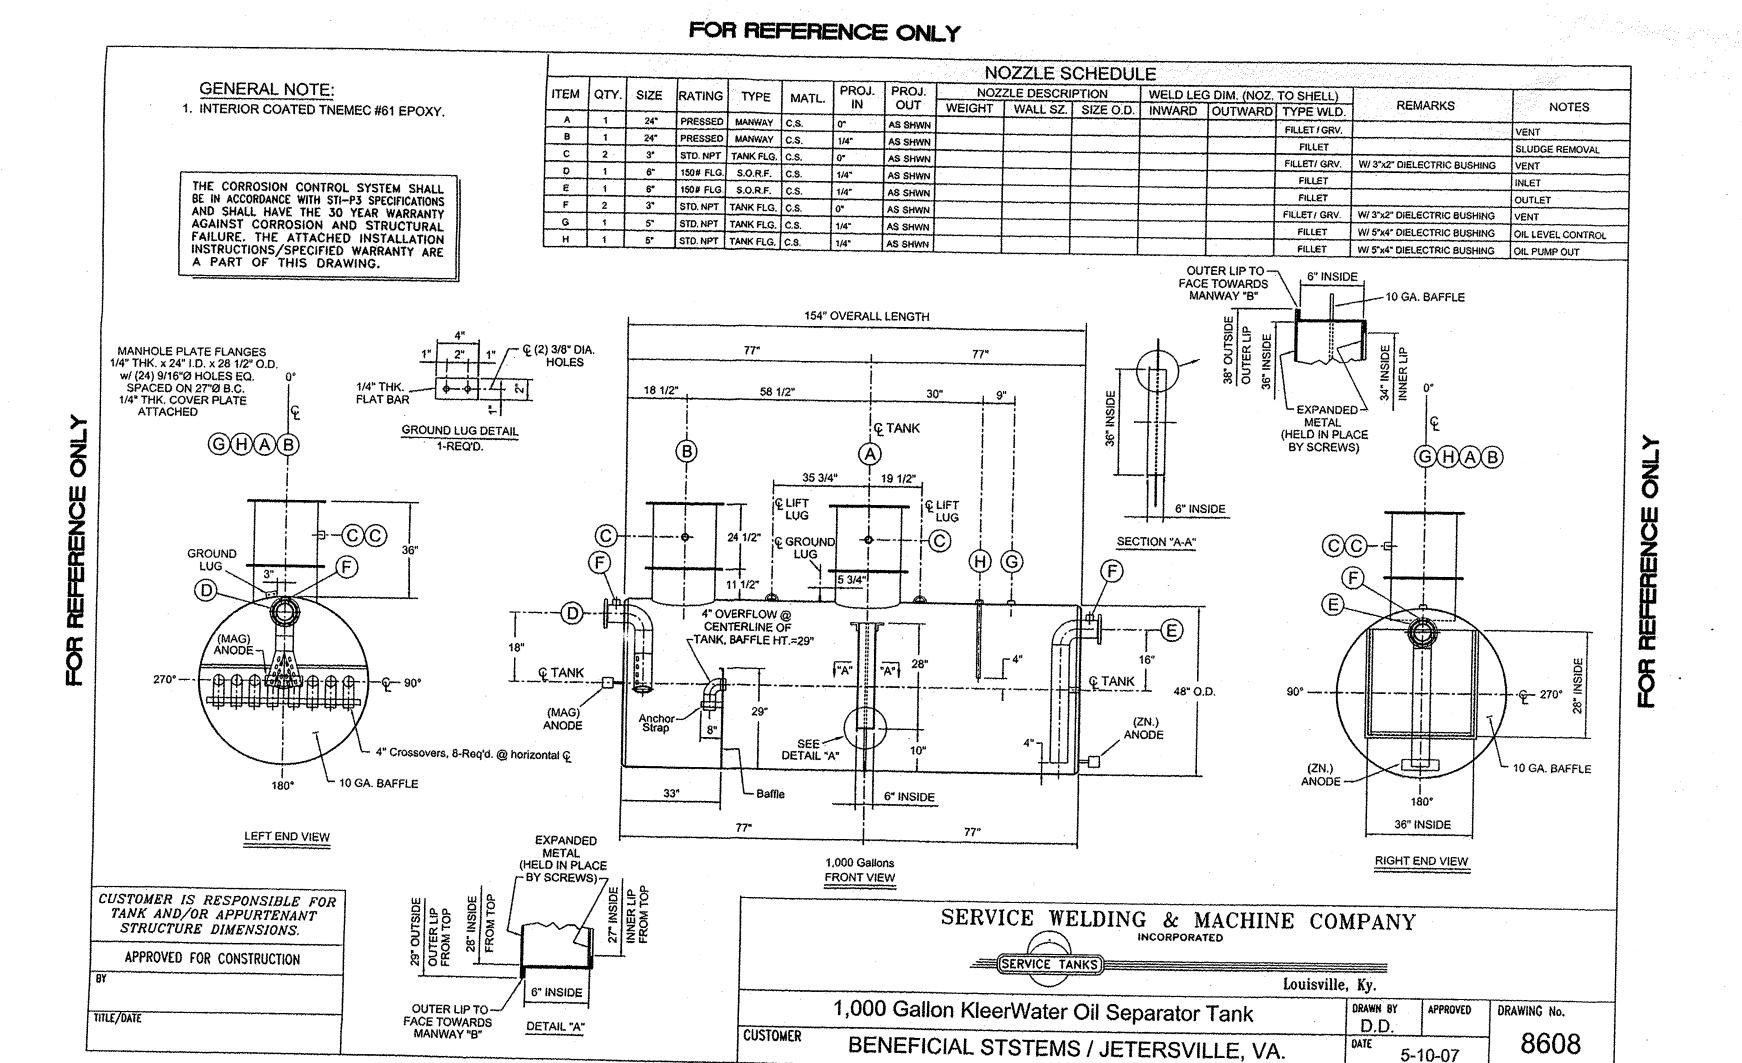

FOR REFERENCE ONLY

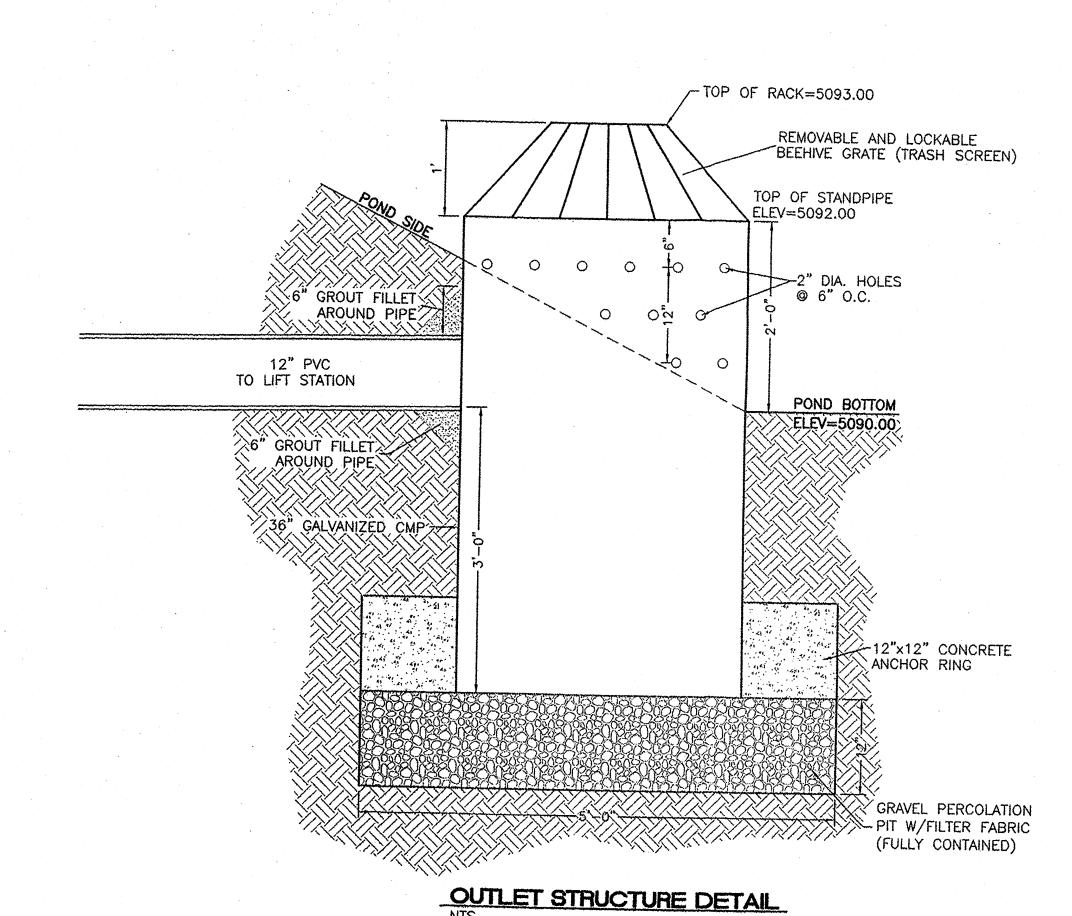


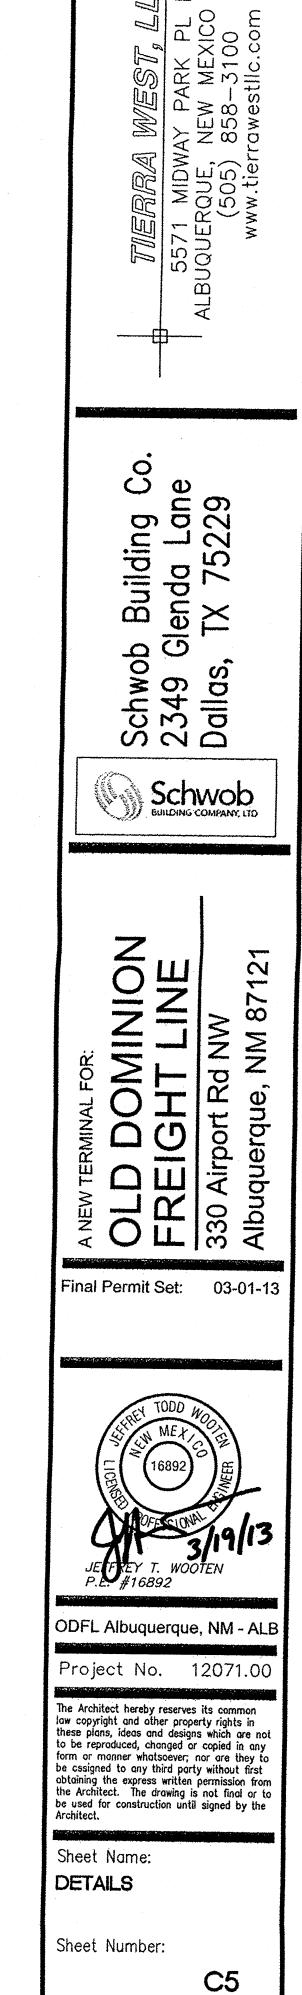

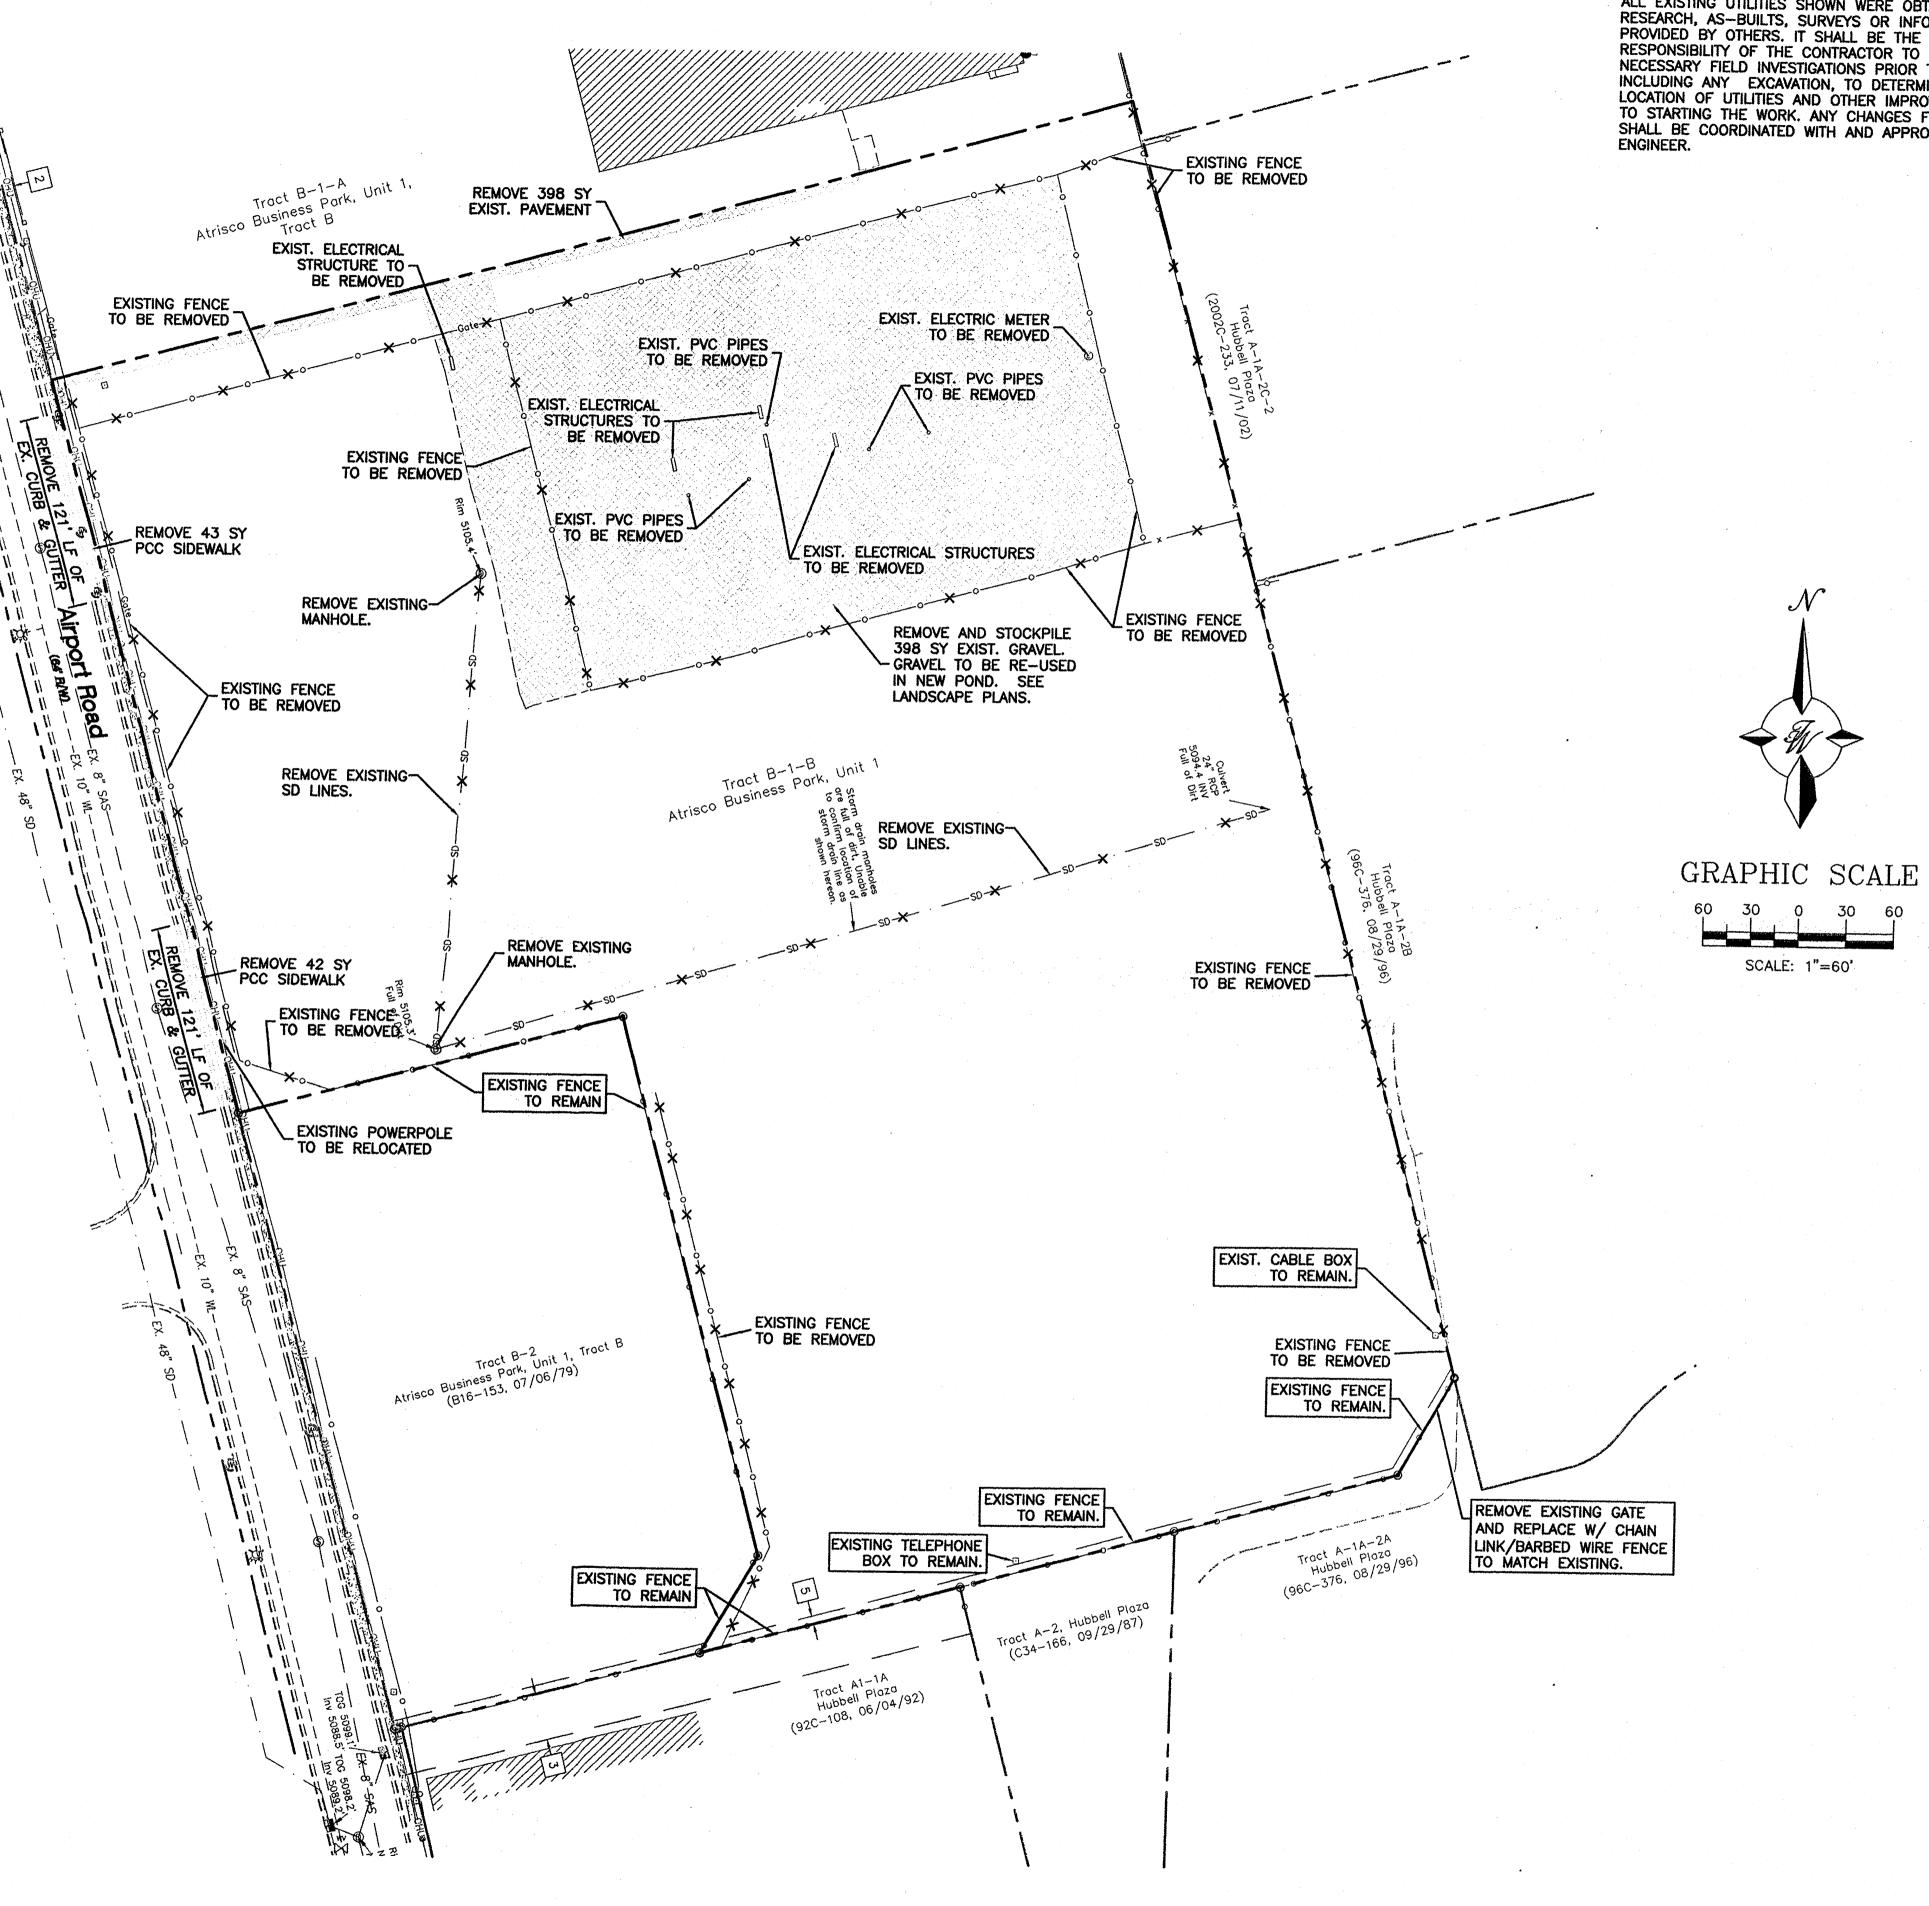

CAUTION:

ALL EXISTING UTILITIES SHOWN WERE OBTAINED FROM RESEARCH, AS—BUILTS, SURVEYS OR INFORMATION PROVIDED BY OTHERS. IT SHALL BE THE SOLE RESPONSIBILITY OF THE CONTRACTOR TO CONDUCT ALL NECESSARY FIELD INVESTIGATIONS PRIOR TO AND INCLUDING ANY EXCAVATION, TO DETERMINE THE ACTUAL LOCATION OF UTILITIES AND OTHER IMPROVEMENTS, PRIOR TO STARTING THE WORK ANY CHANGES FROM THIS PLAN TO STARTING THE WORK. ANY CHANGES FROM THIS PLAN SHALL BE COORDINATED WITH AND APPROVED BY THE ENGINEER.

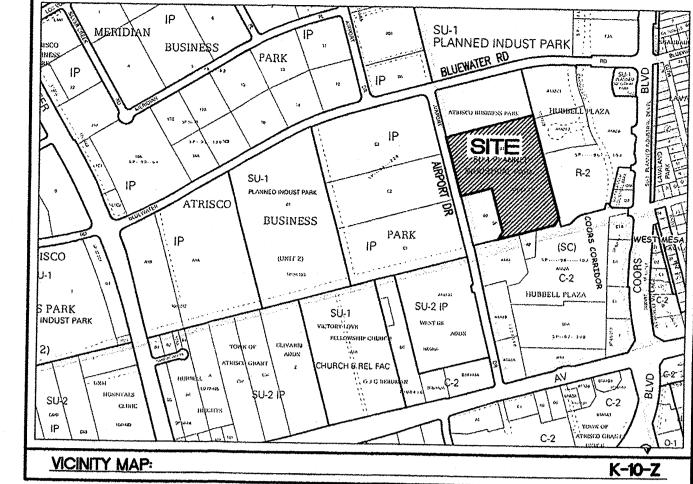


Legend

N 90'00'00" E	MEASURED BEARING AND DISTANCES RECORD INFO PER PLAT OF RECORD
(N 90.00,00, E)	(B16-153, 07/06/79)
•	FOUND MONUMENT AS INDICATED
•	SET BATHEY MARKER WITH CAP "LS 14271"
\mathcal{A}	FIRE HYDRANT
-OHU-	OVERHEAD UTILITY LINES
•	UTILITY POLE
	CHAINLINK FENCE
•	UTILITY PEDESTAL
	GUY WIRE
-0-	SIGN
₩	WATER METER
©	GAS METER
©	ELECTRIC METER
T	TRANSFORMER
0	STORM DRAIN MANHOLE
TO THE STATE OF TH	STORM DRAIN INLET
0	TELEPHONE MANHOLE
— OHU —	EXISTING OVERHEAD UTILITIES
EX. UGE	EXISTING UNDERGROUND UTILITIES
EX. 2" GAS	EXISTING GAS
— EX. 8" SAS— —	EXISTING SANITARY SEWER LINE
EX. 10" WL	EXISTING WATER LINE

--- SD --- EXISTING STORM SEWER LINE

Notes


- 1. FIELD SURVEY PERFORMED IN DECEMBER 2012.
- 2. ALL DISTANCES ARE GROUND DISTANCES: U.S. SURVEY FOOT.
- 3. THE BASIS OF BEARINGS REFERENCES NEW MEXICO STATE PLANE COORDINATES (NAD 83-GRID).
- 4. PVC PIPES AS SHOWN HEREON MAY HAVE BEEN USED PREVIOUSLY FOR WATERLINE OR ELECTRICAL CONDUIT.
- 5. ALL EXISTING ONSITE IMPROVEMENTS (INCLUDING LANDSCAPING & PLANTINGS) WITHIN THE LIMITS OF ONSITE DEMOLITION SHALL BE REMOVED AND PROPERLY DISPOSED OF BY THE CONTRACTOR UNLESS OTHERWISE NOTED.
- 6. REFERENCE OFF-SITE IMPROVEMENT PLAN SHEETS FOR ADDITIONAL REMOVALS NOT COVERED BY THIS ON-SITE DEMOLITION PLAN.
- 7. ALL WEATHER ACCESS TO EXISTING BUSINESSES WITHIN THE CENTER SHALL BE MAINTAINED AT ALL TIMES. THE CONTRACTOR SHALL COORDINATE WITH THE EXISTING BUSINESS OWNERS PRIOR TO REMOVALS THAT DIRECTLY AFFECT THEIR PROPERTY OR ACCESS TO THEIR BUSINESS.
- 8. UNDER GROUND UTILITIES MAY EXIST WHERE NONE ARE SHOWN. THE LOCATIONS OF UNDERGROUND UTILITIES SHOWN ARE BASED ON AS-BUILT INFORMATION. EXACT LOCATIONS SHALL BE VERIFIED BY THE
- 9. IT IS RECOMMENDED THAT THE CONTRACTOR VISIT THE SITE PRIOR TO SUBMITTING A BID TO FAMILIARIZE THEMSELVES WITH ALL EXISTING
- 10. EXISTING SILT FENCE NOT SHOWN FOR CLARITY
- 11. EXISTING ON-SITE POWER POLES & GUY WIRES TO REMAIN UNLESS OTHERWISE NOTED.

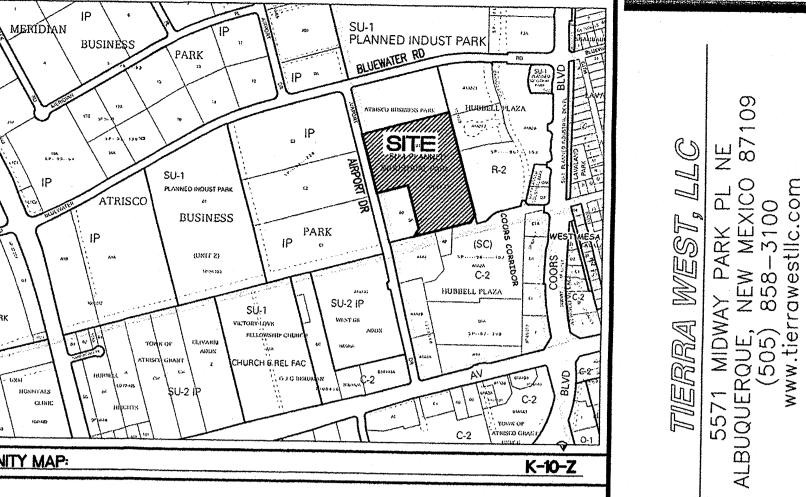

 $\mathbf{\Phi}$ Building (lenda Lane TX 75229 chw 349 allas 022 Schwob

DOMINION IGHT LINE 2

Issue for Permit: xx-xx-xx

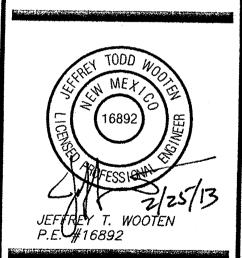

ODFL Albuquerque, NM - ALF

Project No. 12071.00

The Architect hereby reserves its common law copyright and other property rights in these plans, ideas and designs which are not to be reproduced, changed or copied in any form or manner whatsoever; nor are they to be essented to any third are the second be assigned to any third party without first obtaining the express written permission from the Architect. The drawing is not final or to

be used for construction until signed by the Architect.


Sheet Name: DEMOLITION PLAN


Sheet Number:

C6


KEY


HB - HOSE BIB
WF - WASHER FLUID
O - OIL
AF - ANTI-FREEZE

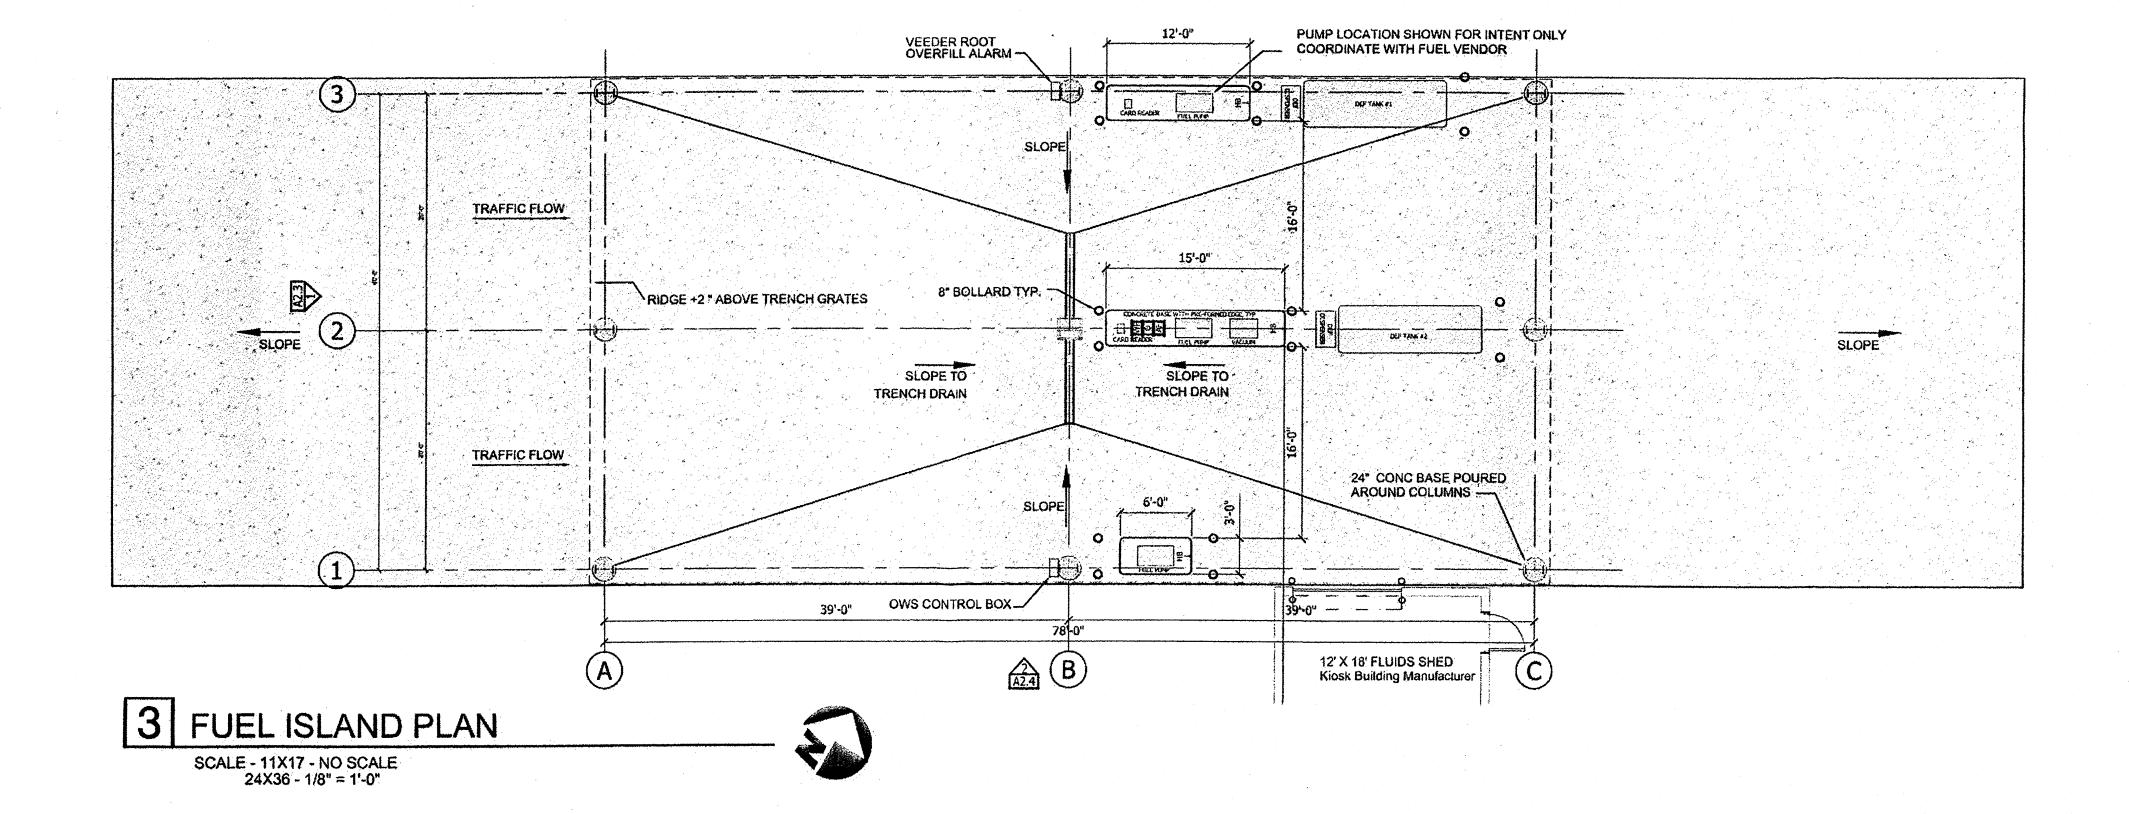

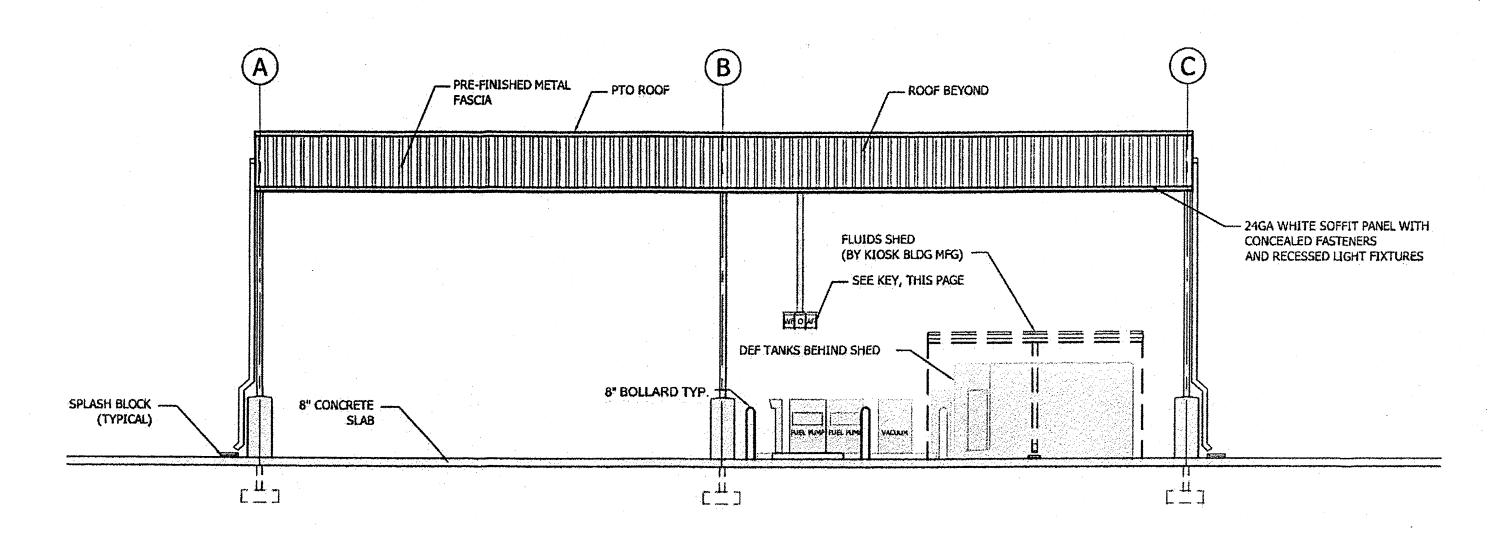



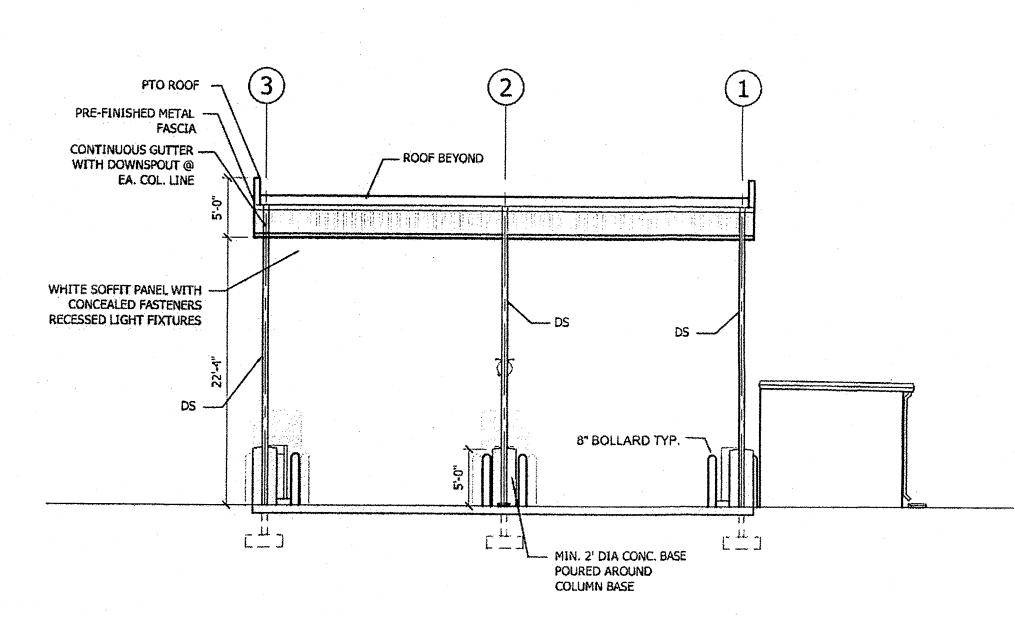

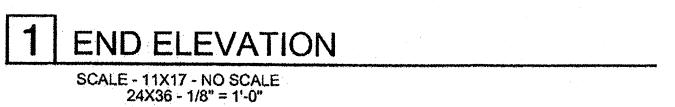



209 10th Ave. S + Suite 414 Nashville, Tennessee 37203 v: 615.296.9146 + f: 615.733.0052 www.themdgllc.com


PRELIMINARY TORY
NOT FOR REGULATORY
APPROVAL PERMITTING
APPROVAL ONSTRUCTION
APPROVAL ON TRUCTION

NM LICENSE #005181 EXP 12-31-2013 Architect: David J. Mollenkopf

> Schwob Building Co 2349 Glenda Lane Dallas, TX 75229



OLD DOMINION
-REIGHT LINE
330 Airport Road NW

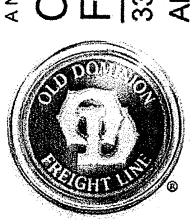

100% Check Set: 02-22-13

ODFL Albuquerque, NM - ABQ

Project No. 13020.00

The Architect hereby reserves its common law copyright and other property rights in these plans, ideas and designs which are not to be reproduced, changed or copied in any form or manner whatsoever; nor are they to be assigned to any third party without first obtaining the express written permission from the Architect. The drawing is not final or to be used for construction until signed by the Architect.

Sheet Name: Fuel Island

Sheet Number:

A2.4

