

2. 10' CLEARANCE SHALL BE PROVIDED FOR ALL GROUND MOUNTED PNM UTILITIES FOR SAFE OPERATION, MAINTENANCE AND REPAIR PROPOSES.

5 EXISTING 5' TELEPHONE EASEMENT (MISC. 741A, PG. 615, 04/24/89)

SU-1 PLANNED INDUST PARK SU-1 FOR PLANNED INDUSTRIAL PARK 516,188 SF (11.85 AC) TRUCK TERMINAL 3,818 SF 15,995 SF 19,813 SF BUSINESS 3,410 SF FUEL ISLAND DOCK-S1 OFFICE-B 11-B, UNPROTECTED CONSTRUCTION TYPE: 20 SPACES (1 SPACE PER 200 SF) 8 SPACES (1 SPACE PER 2000 SF) WAREHOUSE 3 SPACES HC PARKING REQUIRED 3 SPACES (1 VAN ACCESSIBLE) HC PARKING PROVIDED TOTAL PARKING PROVIDED 70 SPACES VICINITY MAP MC PARKING REQUIRED 2 SPACES MC PARKING PROVIDED 2 SPACES LEGAL DESCRIPTION: TRACT "B-1-B" OF ATRISCO BUSINESS PARK, UNIT ONE, AS THE SAME IS 5 SPACES BICYCLE PARKING PROVIDED

PH. 2 - 40 PH. 2 - 16

PH. 2-10

TOTAL - 94

TOTAL-16 TOTAL - 13

SHOWN AND DESIGNATED ON THE PLAT THEREOF, FILED IN THE OFFICE OF THE COUNTY CLERK OF BERNALILLO COUNTY, NEW MEXICO, ON 02/04/13, AS DOCUMENT NO. 2013012914.

LEGEND

CURB & GUTTER - BOUNDARY LINE EASEMENT CENTERLINE - BUILDING MANAGEMENT SIDEWALK SCREEN WALL (EAST PROPERTY LINE) STRIPING EXISTING CURB & GUTTER EXISTING SIDEWALK --- TUBULAR STEEL FENCE CHAIN LINK FENCE WITH 3 STRAND BARBED WIRE HEAVY DUTY CONCRETE

TE LAN AMENDMENT APPLICATION NO. 44 10272 Mal Che PROJECT NUMBER:

APPLICATION NUMBER: 13 DRB-70458

This plan is consistent with the specific Site Development Plan approved by the Environmental Planning Commission (EPC), dated _____, and the Findings and Conditions in the Official Notification of Decision are satisfied.

Is an Infrastructure List required? () Yes () No If Yes, then a set of approved DRC plans with a work order is required for any construction within Public Right—of—Way or for construction of public improvements.

Milo & felgado-Jernandez

03 20 13 Traffic Engineer, Fransportation Division Date 03/20/13 Water Utility Development Date 3-20-13 Parks & Recreation Department Date City Engineer 3-20-13 Date * Environmental Health Department (conditional) Date 3-21-13 Solid Waste Management Date DRB Chairperson, Planning Department

Date

* Environmental Health, if necessary

INDEX TO DRAWINGS C1. SITE PLAN FOR BUILDING PERMIT C2. GRADING AND DRAINAGE PLAN C3. MASTER UTILITY PLAN C4. DETAIL SHEET C5. DETAIL SHEET C6. DEMOLITION PLAN A2.4 BUILDING ELEVATIONS A3.1 BUILDING ELEVATIONS LS-3. LANDSCAPING PLAN

K-10-Z


uilding nda Lar (7522 300 S4 S SNO

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Schwob

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Final Permit Set: 03-01-13



ODFL Albuquerque, NM - ALB

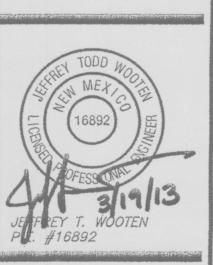
Project No. 12071.00

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Sheet Name: SITE PLAN FOR **BUILDING PERMIT**

Sheet Number:

1 1 alnolis V

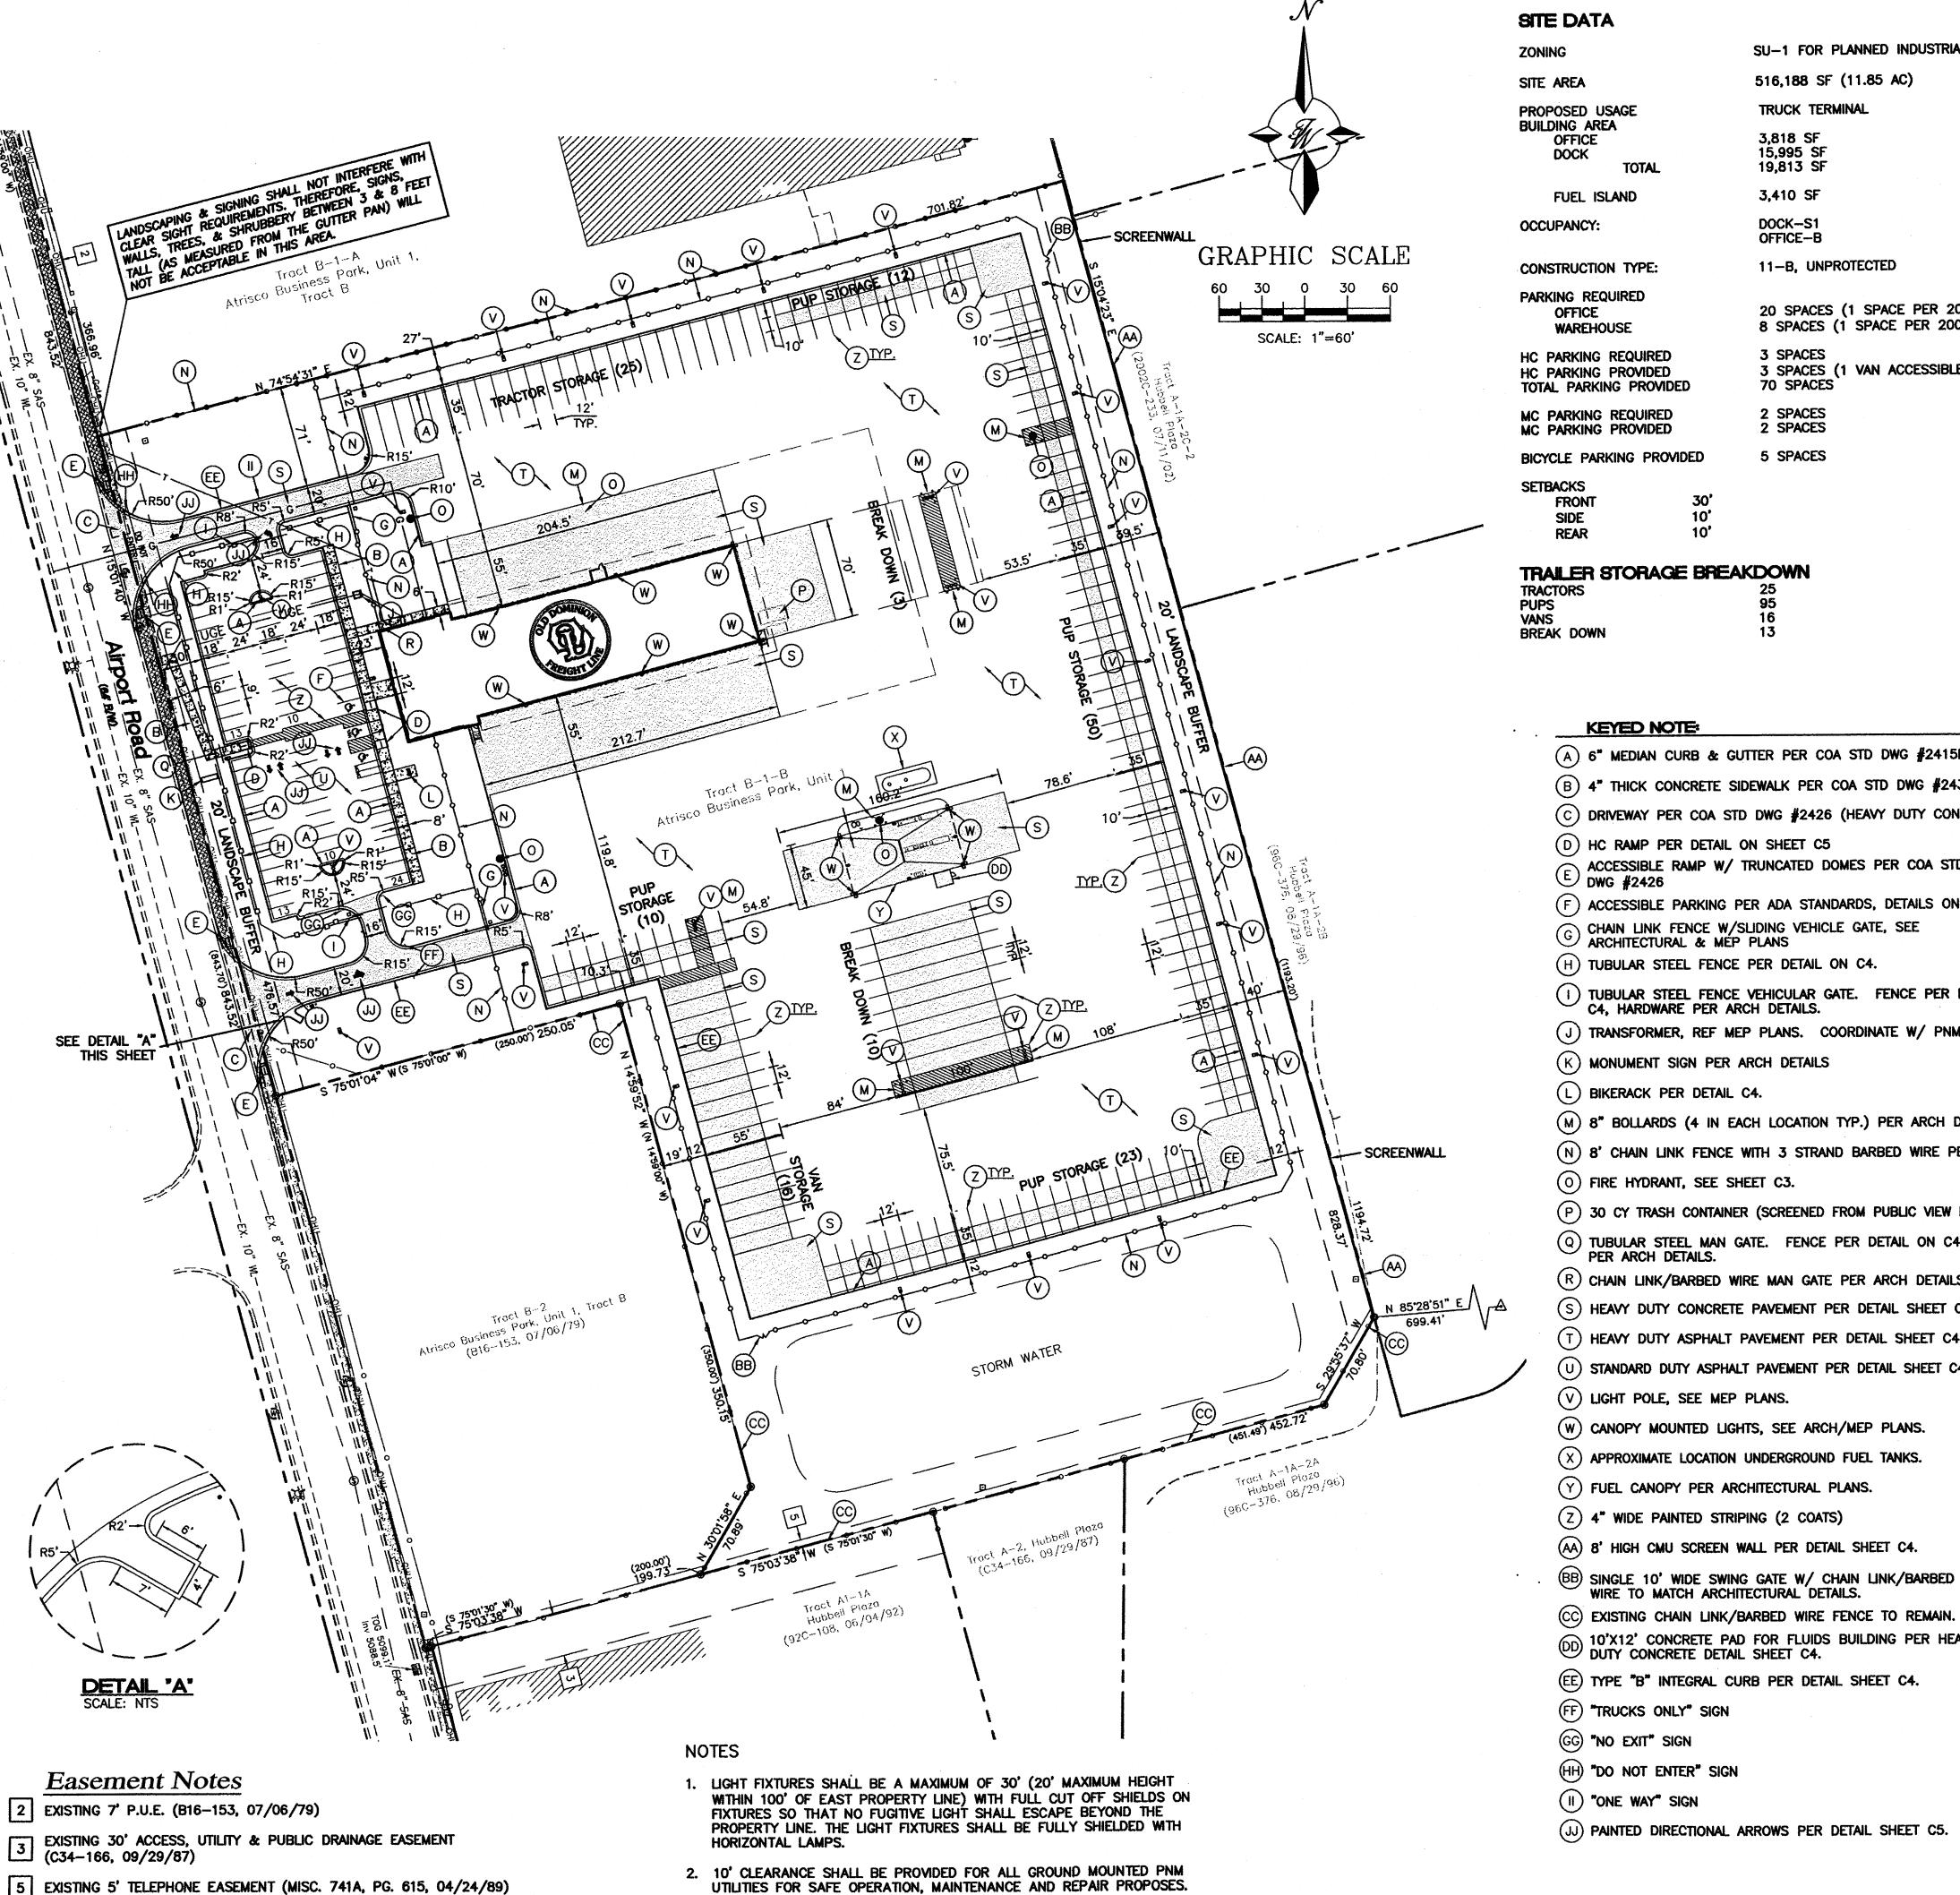

5 EXISTING 5' TELEPHONE EASEMENT (MISC. 741A, PG. 615, 04/24/89)

SITE DATA SU-1 FOR PLANNED INDUSTRIAL PARK 516,188 SF (11.85 AC) TRUCK TERMINAL PROPOSED USAGE BUILDING AREA 3,818 SF OFFICE 15,995 SF 19,813 SF 3,410 SF FUEL ISLAND DOCK-S1 OFFICE-B OCCUPANCY: 11-B, UNPROTECTED **CONSTRUCTION TYPE:** 20 SPACES (1 SPACE PER 200 SF) OFFICE 8 SPACES (1 SPACE PER 2000 SF) WAREHOUSE

PARKING REQUIRED


3 SPACES (1 VAN ACCESSIBLE) HC PARKING PROVIDED 70 SPACES TOTAL PARKING PROVIDED 2 SPACES MC PARKING REQUIRED

2 SPACES MC PARKING PROVIDED 5 SPACES BICYCLE PARKING PROVIDED

TRAILER STORAGE BREAKDOWN

KEYED NOTE:

- (A) 6" MEDIAN CURB & GUTTER PER COA STD DWG #2415B
- (B) 4" THICK CONCRETE SIDEWALK PER COA STD DWG #2430
- (C) DRIVEWAY PER COA STD DWG #2426 (HEAVY DUTY CONCRETE PVMT)
- (D) HC RAMP PER DETAIL ON SHEET C5
- ACCESSIBLE RAMP W/ TRUNCATED DOMES PER COA STD E DWG #2426
- (F) ACCESSIBLE PARKING PER ADA STANDARDS, DETAILS ON C4 & C5
- G CHAIN LINK FENCE W/SLIDING VEHICLE GATE, SEE ARCHITECTURAL & MEP PLANS
- (H) TUBULAR STEEL FENCE PER DETAIL ON C4.
- (1) TUBULAR STEEL FENCE VEHICULAR GATE. FENCE PER DETAIL ON
- (J) TRANSFORMER, REF MEP PLANS. COORDINATE W/ PNM.
- (K) MONUMENT SIGN PER ARCH DETAILS
- (L) BIKERACK PER DETAIL C4.
- (M) 8" BOLLARDS (4 IN EACH LOCATION TYP.) PER ARCH DETAILS.
- (N) 8' CHAIN LINK FENCE WITH 3 STRAND BARBED WIRE PER ARCH DETAILS.
- (0) FIRE HYDRANT, SEE SHEET C3.
- (P) 30 CY TRASH CONTAINER (SCREENED FROM PUBLIC VIEW BEHIND BLDG)
- Q TUBULAR STEEL MAN GATE. FENCE PER DETAIL ON C4, HARDWARE PER ARCH DETAILS.
- (R) CHAIN LINK/BARBED WIRE MAN GATE PER ARCH DETAILS.
- (S) HEAVY DUTY CONCRETE PAVEMENT PER DETAIL SHEET C4.
- (T) HEAVY DUTY ASPHALT PAVEMENT PER DETAIL SHEET C4.
- (U) STANDARD DUTY ASPHALT PAVEMENT PER DETAIL SHEET C4.
- (V) LIGHT POLE, SEE MEP PLANS.
- (W) CANOPY MOUNTED LIGHTS, SEE ARCH/MEP PLANS.
- (X) APPROXIMATE LOCATION UNDERGROUND FUEL TANKS.
- (Y) FUEL CANOPY PER ARCHITECTURAL PLANS.
- (Z) 4" WIDE PAINTED STRIPING (2 COATS)
- (AA) 8' HIGH CMU SCREEN WALL PER DETAIL SHEET C4.
- BB SINGLE 10' WIDE SWING GATE W/ CHAIN LINK/BARBED WIRE TO MATCH ARCHITECTURAL DETAILS.
- DD 10'X12' CONCRETE PAD FOR FLUIDS BUILDING PER HEAVY DUTY CONCRETE DETAIL SHEET C4.
- (EE) TYPE "B" INTEGRAL CURB PER DETAIL SHEET C4.
- (GG) "NO EXIT" SIGN
- (HH) "DO NOT ENTER" SIGN
- (II) "ONE WAY" SIGN
- (JJ) PAINTED DIRECTIONAL ARROWS PER DETAIL SHEET C5.

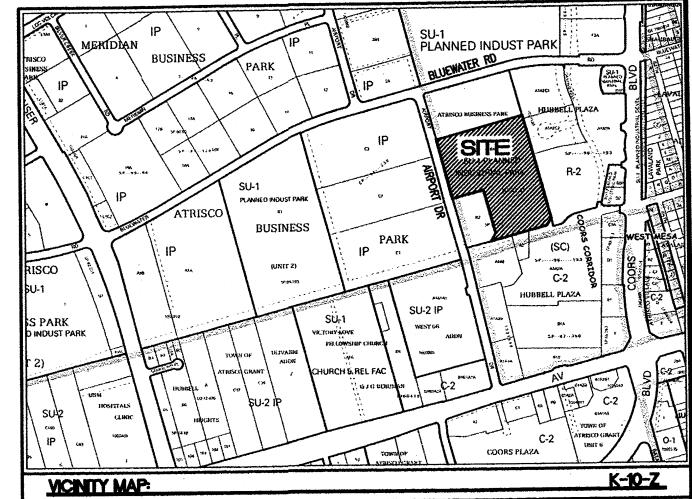

LEGAL DESCRIPTION

TRACT "B-1-B" OF ATRISCO BUSINESS PARK, UNIT ONE, AS THE SAME IS SHOWN AND DESIGNATED ON THE PLAT THEREOF, FILED IN THE OFFICE OF THE COUNTY CLERK OF BERNALILLO COUNTY, NEW MEXICO, ON 02/04/13, AS DOCUMENT NO. 2013012914.

LEGEND	
	CURB & GUTTER
	BOUNDARY LINE
	EASEMENT
	CENTERLINE
	BUILDING
	SIDEWALK
	SCREEN WALL (EAST PROPERTY LINE)
	STRIPING
	EXISTING CURB & GUTTER
	EXISTING BOUNDARY LINE
	EXISTING SIDEWALK
	TUBULAR STEEL FENCE
ooo	CHAIN LINK FENCE WITH 3 STRAND BARBED WIRE
	HEAVY DUTY CONCRETE
**************************************	SITE VISIBILITY AREA

PROJECT NUMBER:

APPLICATION NUMBER

Is an Infrastructure List required? () Yes () No If Yes, then a set of approved DRC plans with a work order is required for any construction within Public Right—of—Way or for construction of public improvements.

DRB SITE DEVELOPMENT PLAN SIGNOFF APPROVAL:

Traffic Engineer, Transportation Division	Date
Water Utility Development	Date
Parks & Recreation Department	Date
City Engineer	Date
* Environmental Health Department (conditional)	Date
Solid Waste Management	Date
DRB Chairperson, Planning Department	Date

^{*} Environmental Health, if necessary

INDEX TO DRAWINGS

C1. SITE PLAN FOR BUILDING PERMIT GRADING AND DRAINAGE PLAN

MASTER UTILITY PLAN

C4. DETAIL SHEET

DETAIL SHEET

C6. DEMOLITION PLAN A2.4 BUILDING ELEVATIONS

LS-3. LANDSCAPING PLAN


A3.1 BUILDING ELEVATIONS

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Schwob

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Final Permit Set: 03-01-13





ODFL Albuquerque, NM - AL

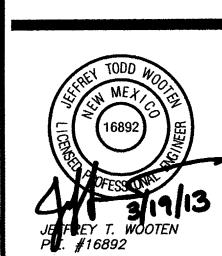
Project No. 12071.00

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Sheet Name: SITE PLAN FOR **BUILDING PERMIT**



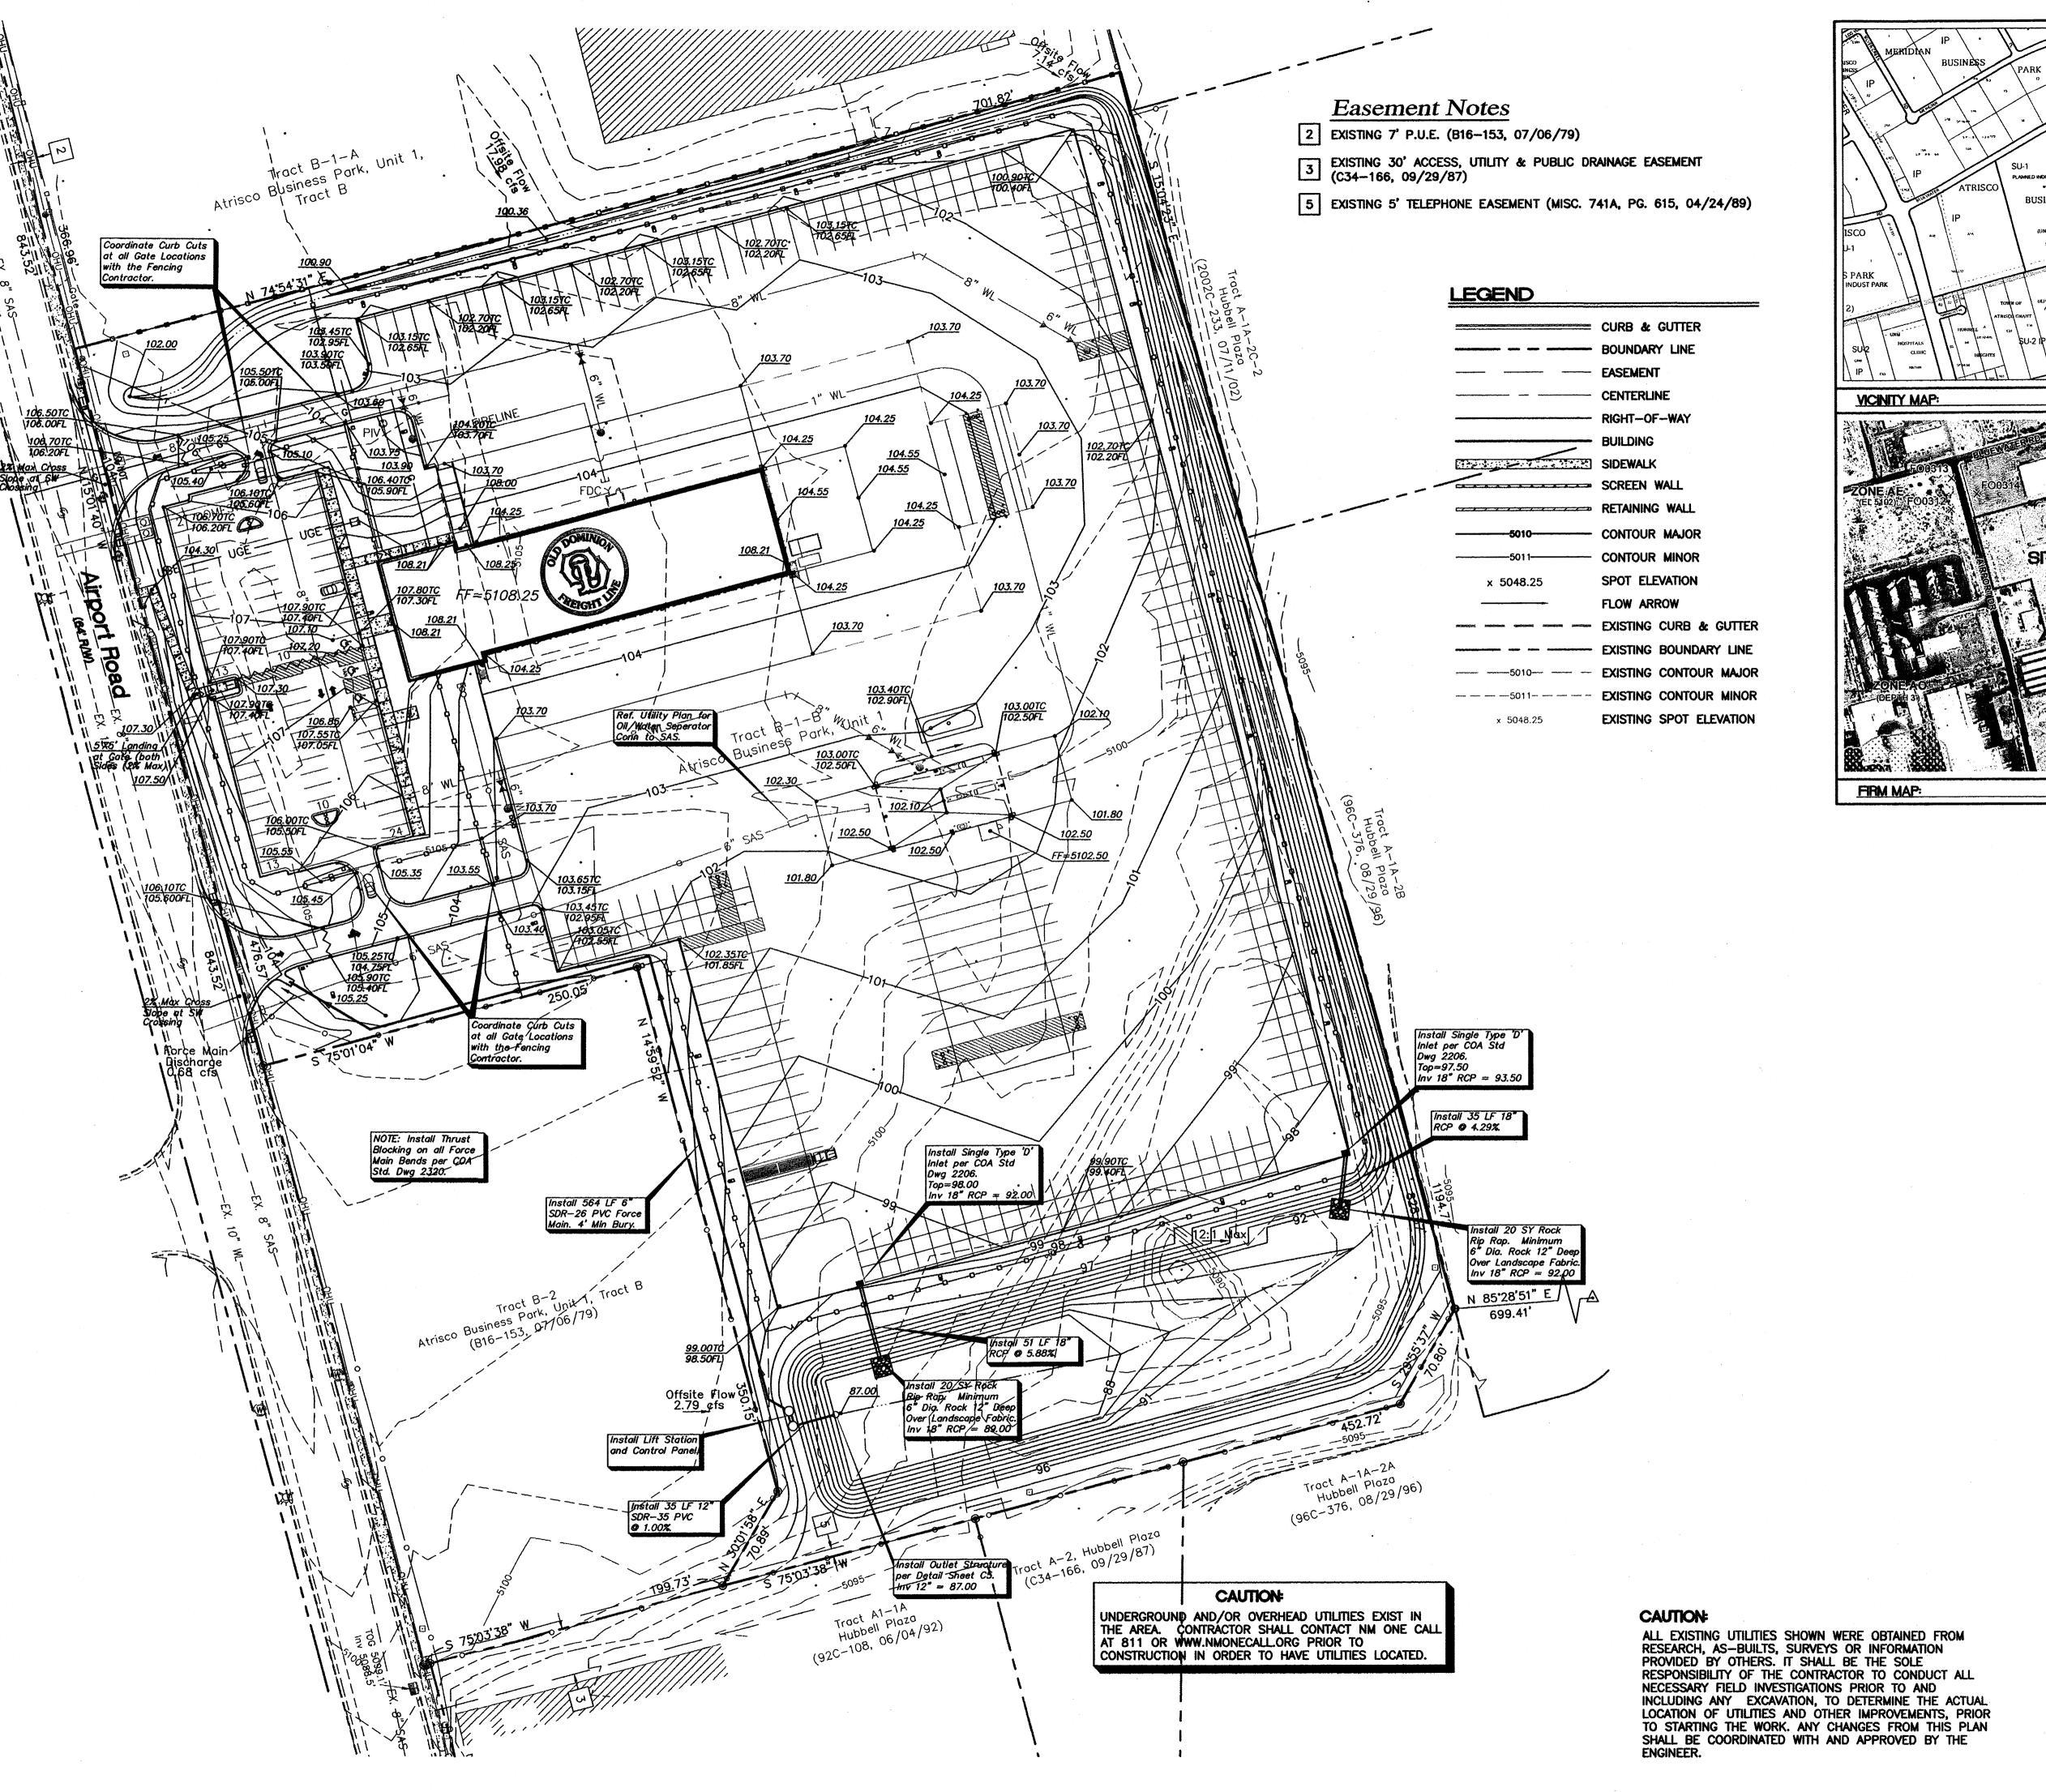

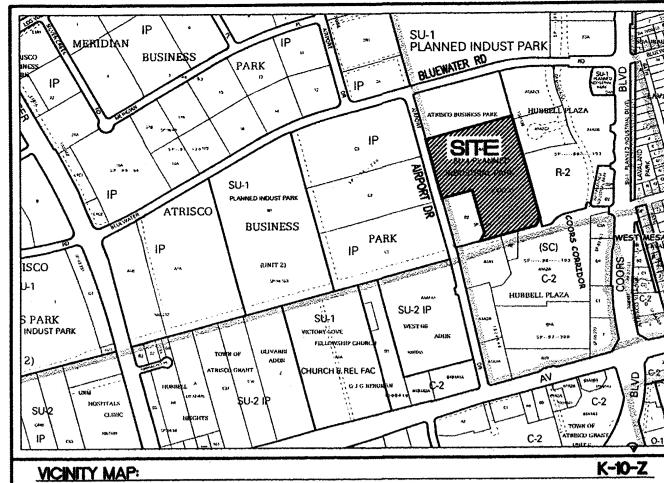


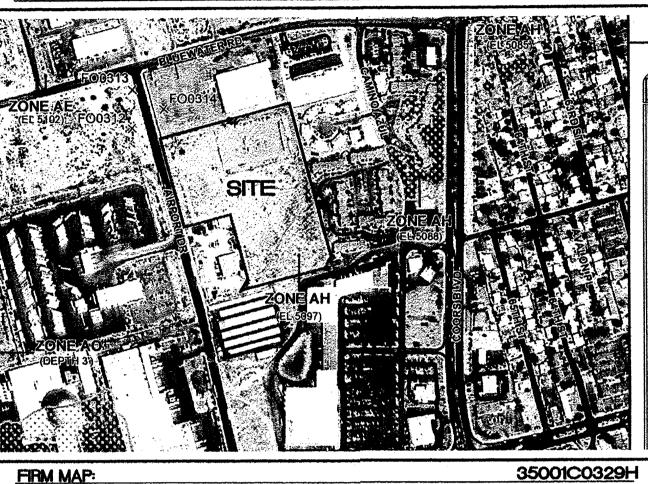Building Colenda Lane TX 75229 Schwar 2349 Dallas

Schwob BUILDING COMPANY, LTD

OLD DOMINION FREIGHT LINE

Final Permit Set: 03-01-13

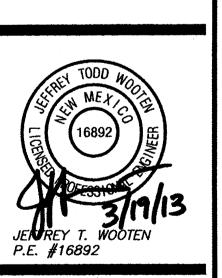

ODFL Albuquerque, NM - ALE


Project No. 12071.00

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Sheet Name: GRADING AND DRAINAGE PLAN

Sheet Number:

SCALE: 1"=50"

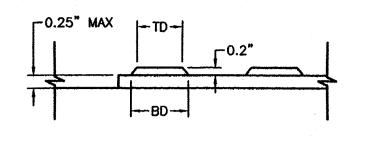


DOME SECTION

BD - BASE DIAMETER 0.9" MIN

TD - TOP DIAMETER 50% OF BD MIN TO


65% OF BD MAX

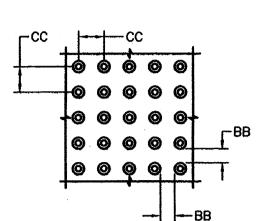


DOME SPACING


CC - CENTER TO CENTER SPACING 2.35"

BB - BASE TO BASE SPACING 1.48" MIN

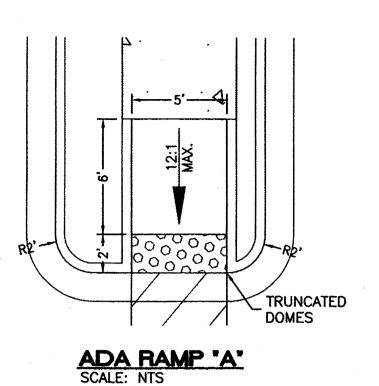

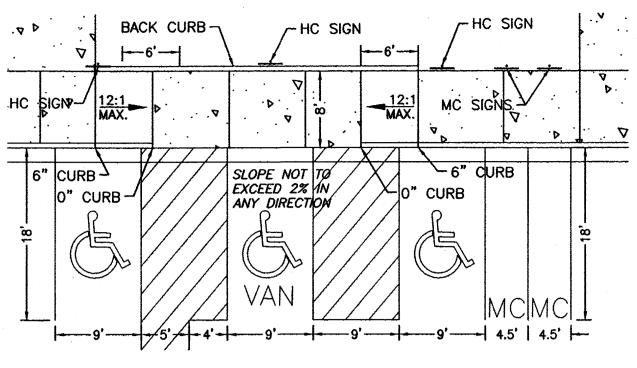

HC PARKING • MAIN BLDG. ENTRANCE SCALE: NTS

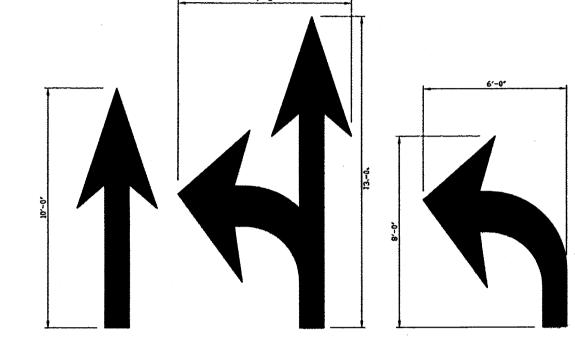


WORDS AND ARROWS SHALL BE APPLIED IN ACCORDANCE WITH SECTION 3B.20 OF THE MANUAL ON UNIFORM TRAFFIC CONTROL DEVICES FOR STREETS AND HIGHWAYS.

THESE WORDS AND ARROWS ARE TO BE PAINTED RETROREFLECTIVE WHITE.


SOLID ARROW MARKINGS USED AT EXITS FROM THE PARKING LOT TO PUBLIC STREETS

PAVEMENT MARKINGS

FOR REFERENCE ONLY

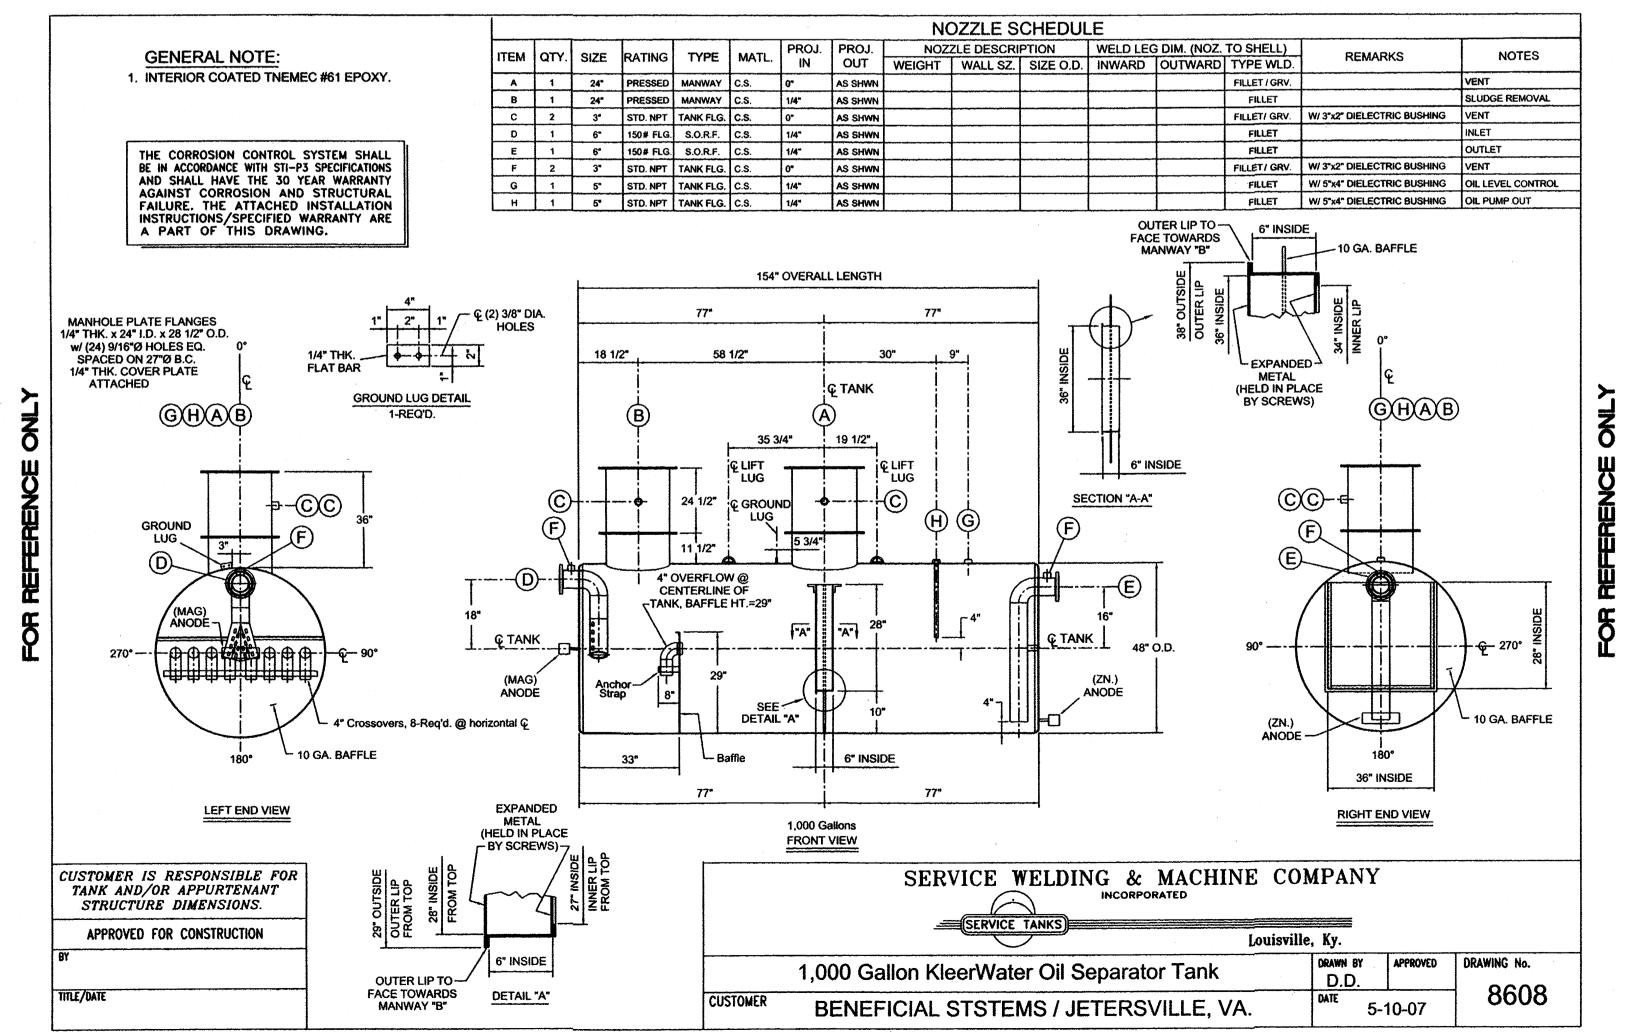

FOR REFERENCE ONLY

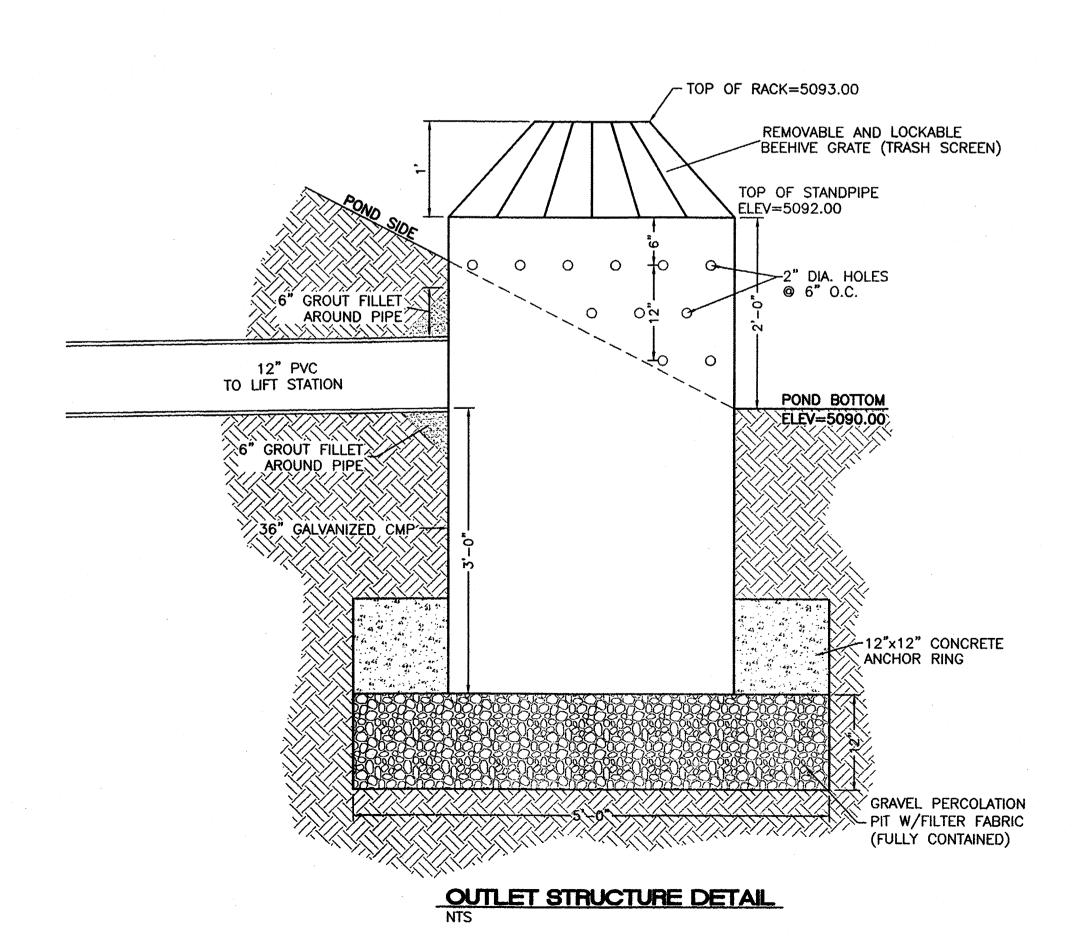




ob Building Co Glenda Lane s, TX 75229 Schwob 2349 Gl Dallas,

Schwob BUILDING COMPANY, LTD

NO DOMINIC EIGHT LINE

Final Permit Set: 03-01-13

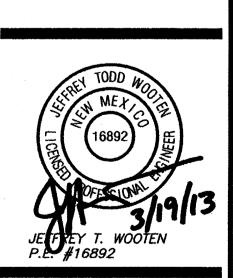


ODFL Albuquerque, NM - ALI


Project No. 12071.00


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Sheet Name: DETAILS

Sheet Number:



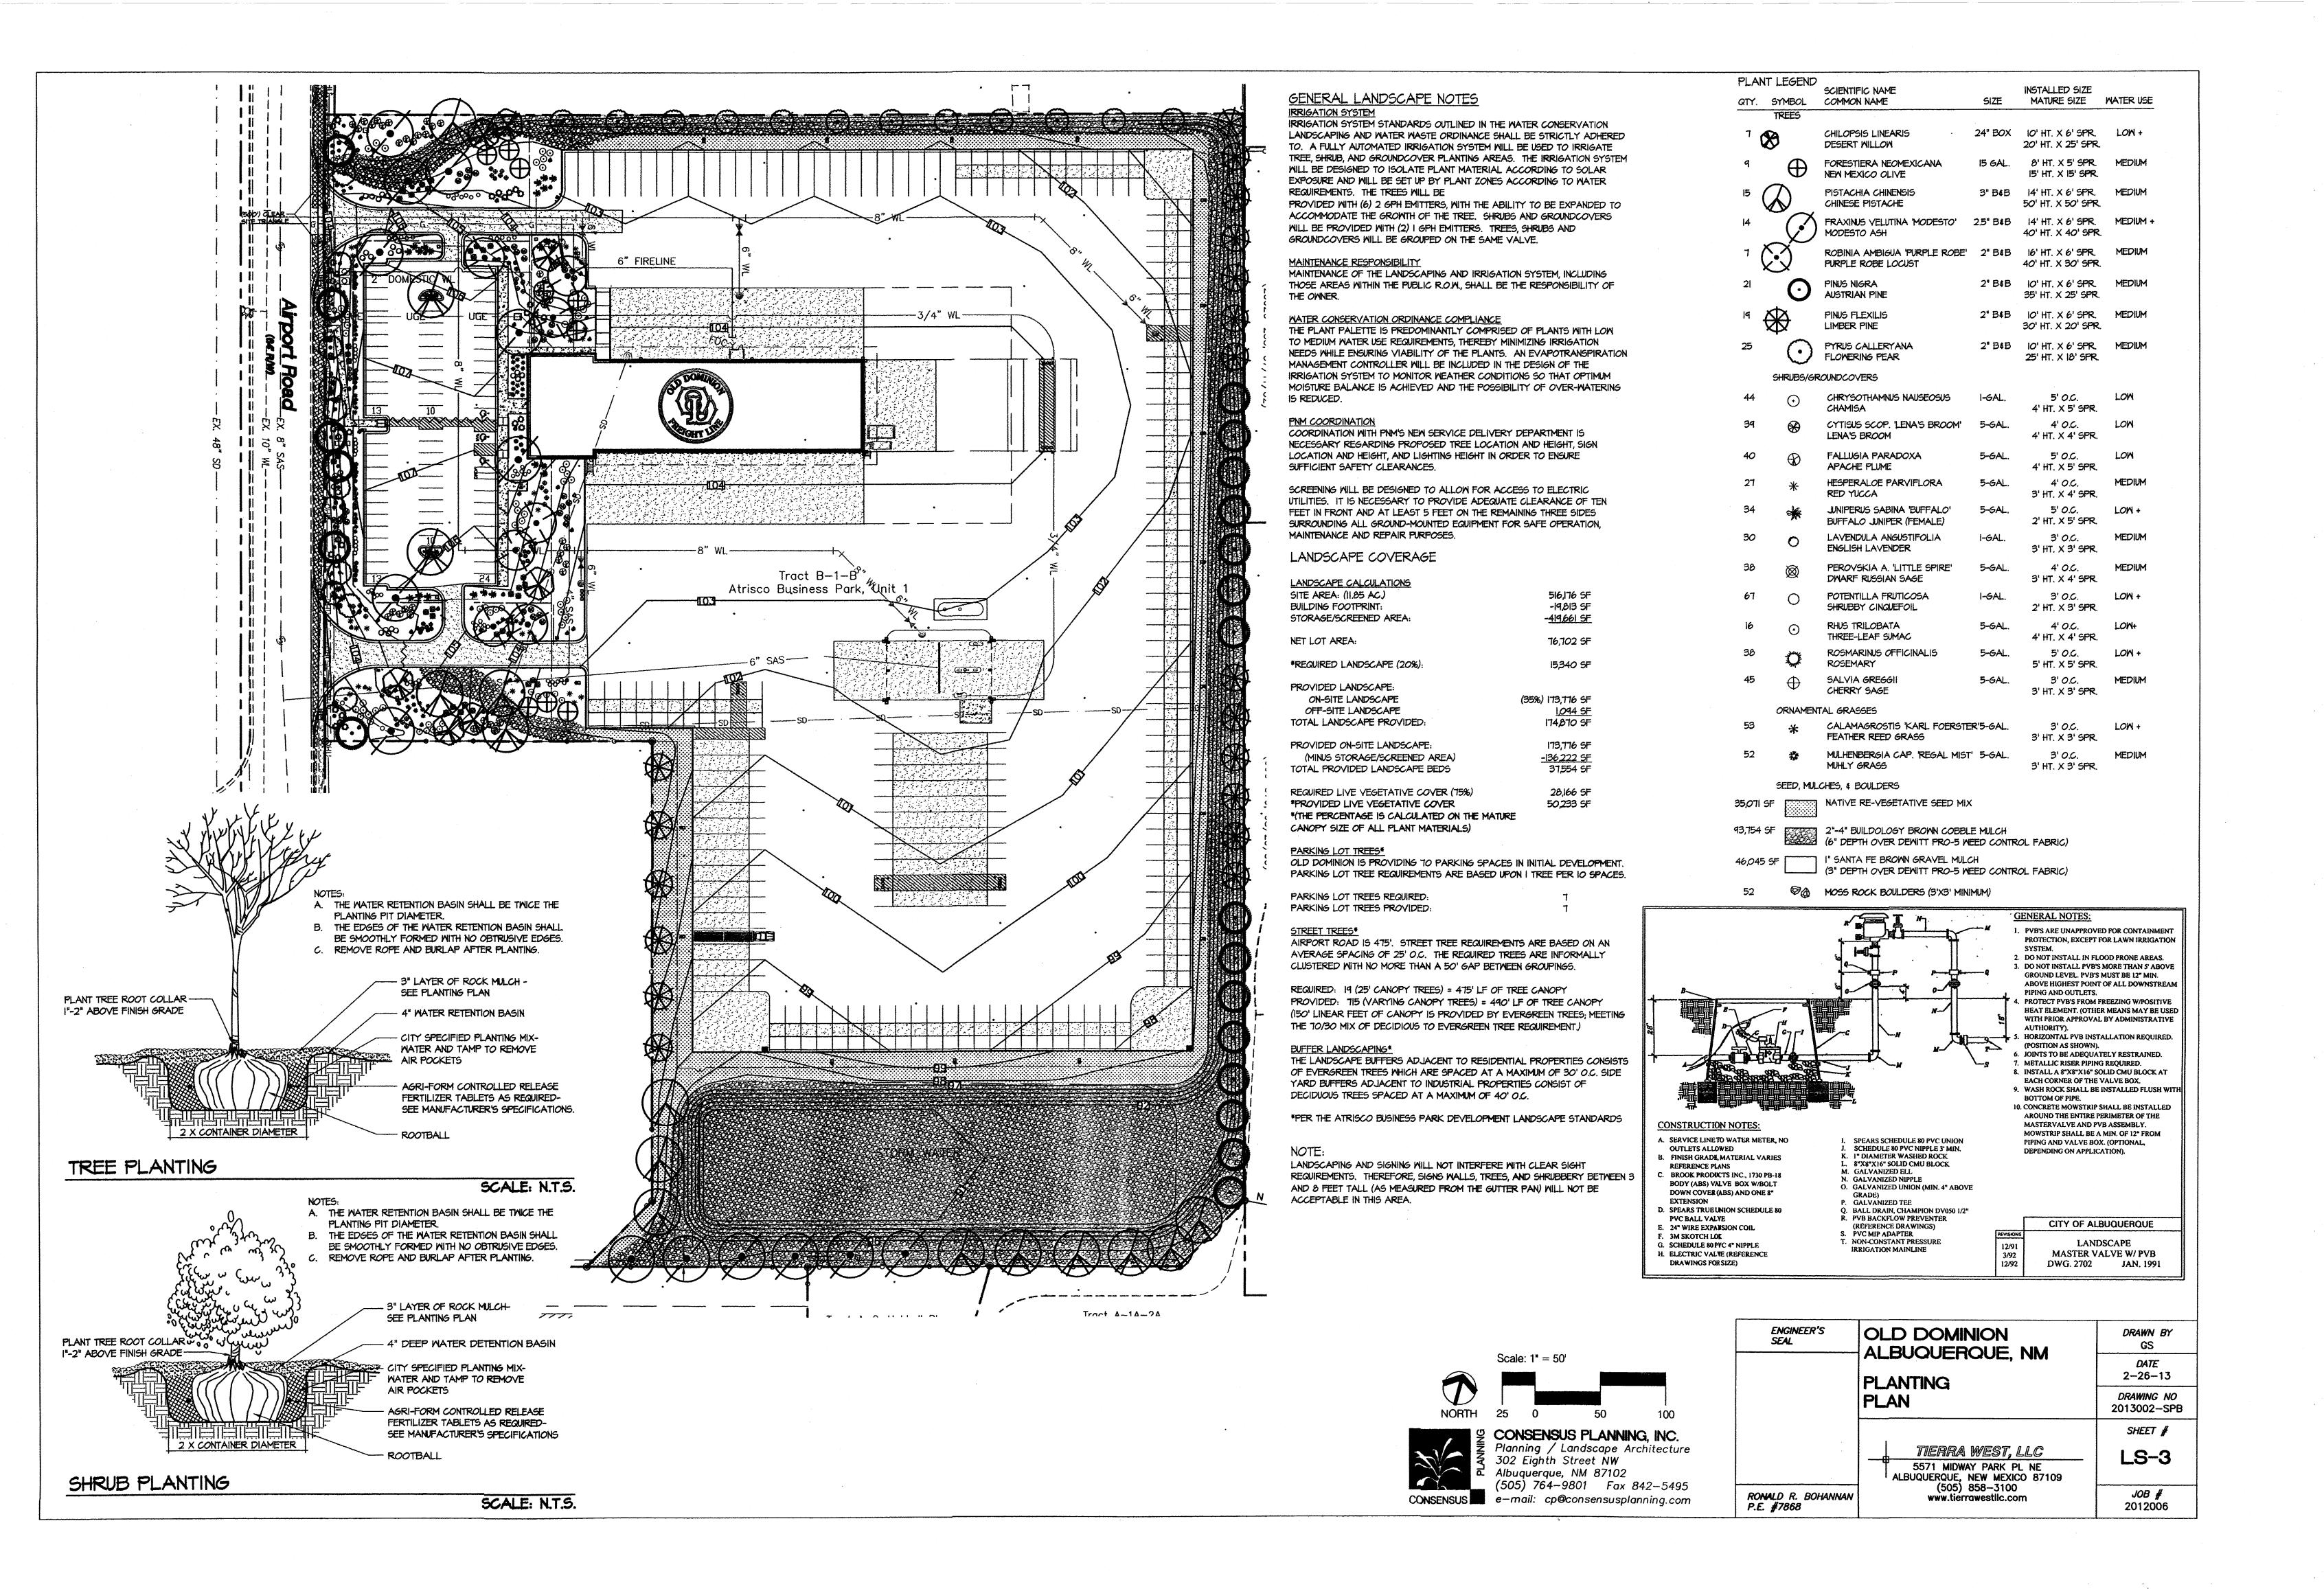

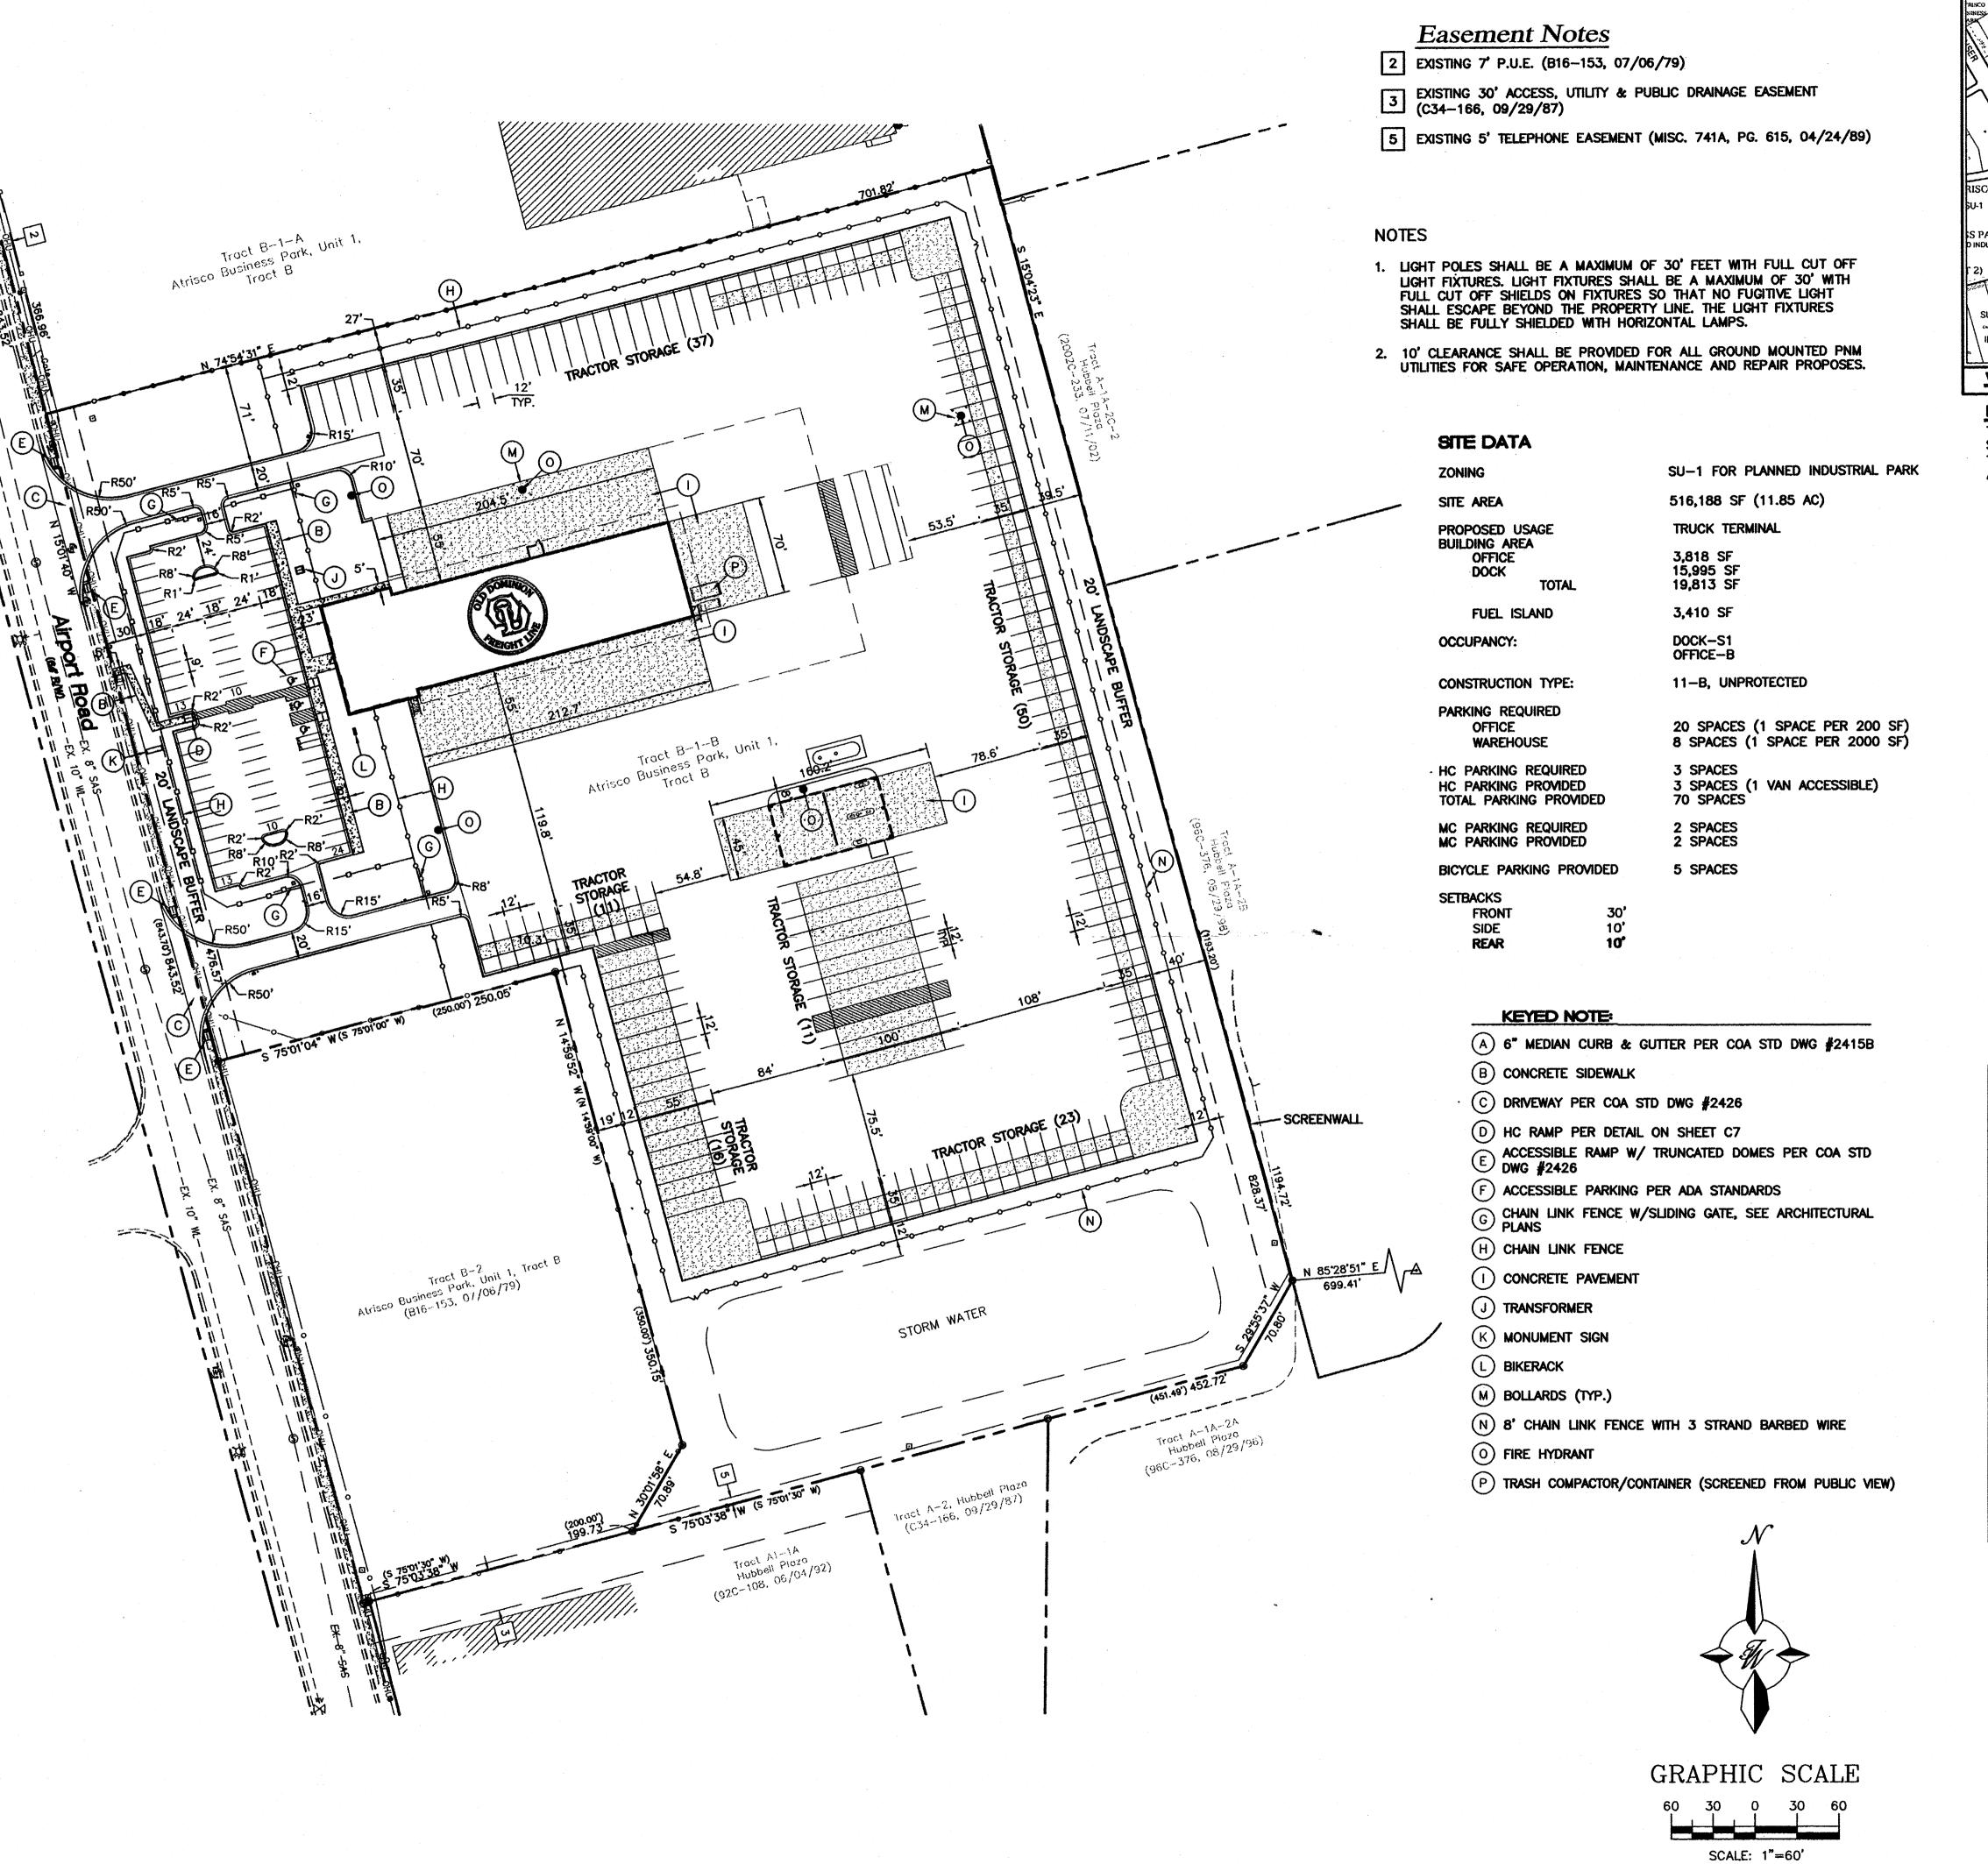

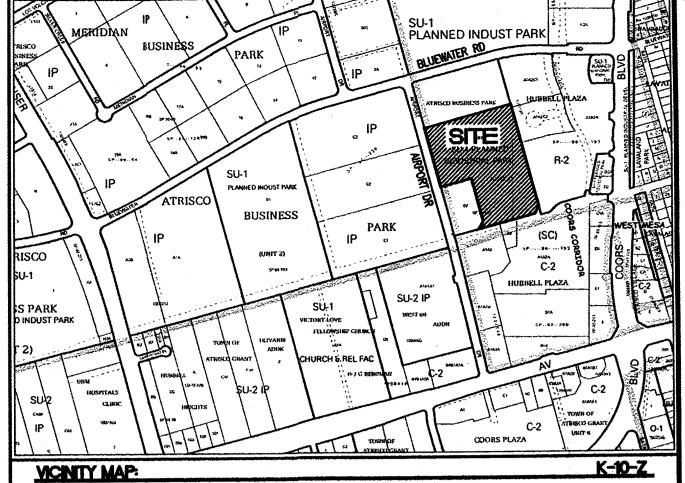LEGAL DESCRIPTION:

TRACT "B-1-B" OF ATRISCO BUSINESS PARK, UNIT ONE, AS THE SAME IS SHOWN AND DESIGNATED ON THE PLAT THEREOF, FILED IN THE OFFICE OF THE COUNTY CLERK OF BERNALILLO COUNTY, NEW MEXICO, ON 02/04/13, AS DOCUMENT NO. 2013012914.

LEGEND BOUNDARY LINE EASEMENT **BUILDING** SIDEWALK SCREEN WALL STREET LIGHTS **EXISTING CURB & GUTTER** ----- EXISTING BOUNDARY LINE EXISTING SIDEWALK ---- EXISTING LANE 3 STRAND BARBED WIRE

PROJECT NUMBER:	
APPLICATION NUMBER:	
This plan is consistent with the specific Site Development Plan ap Environmental Planning Commission (EPC), dated, and and Conditions in the Official Notification of Decision are satisfied.	proved by the the Findings
Is an Infrastructure List required? () Yes () No If Yes, of approved DRC plans with a work order is required for any construction. Public Right—of—Way or for construction of public improvements.	then a set tion within
DRB SITE DEVELOPMENT PLAN SIGNOFF APPROVAL:	
Traffic Engineer, Transportation Division	Date
Water Utility Development	Date
Parks & Recreation Department	Date
City Engineer	Date
* Environmental Health Department (conditional)	Date
doe whate	2763
Solid Waste Management	Date
DRB Chairperson, Planning Department	Date
* Environmental Health, if necessary	/

INDEX TO DRAWINGS

C1. SITE PLAN FOR BUILDING PERMIT GRADING AND DRAINAGE PLAN

MASTER UTILITY PLAN

BUILDING ELEVATIONS DETAIL SHEET

C6. DETAIL SHEET DEMOLITION PLAN L1. LANDSCAPING PLAN

uilding nda Lar (7522 chw 349 alla S 20


Schwob

Approval

Wash

Solid

Issue for Permit: xx-xx-xx

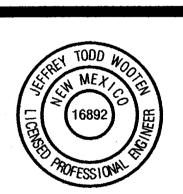

JEFFREY T. WOOTEN P.E. #16892


ODFL Albuquerque, NM - AL


Project No. 12071.00

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Sheet Name: SITE PLAN FOR

BUILDING PERMIT Sheet Number:



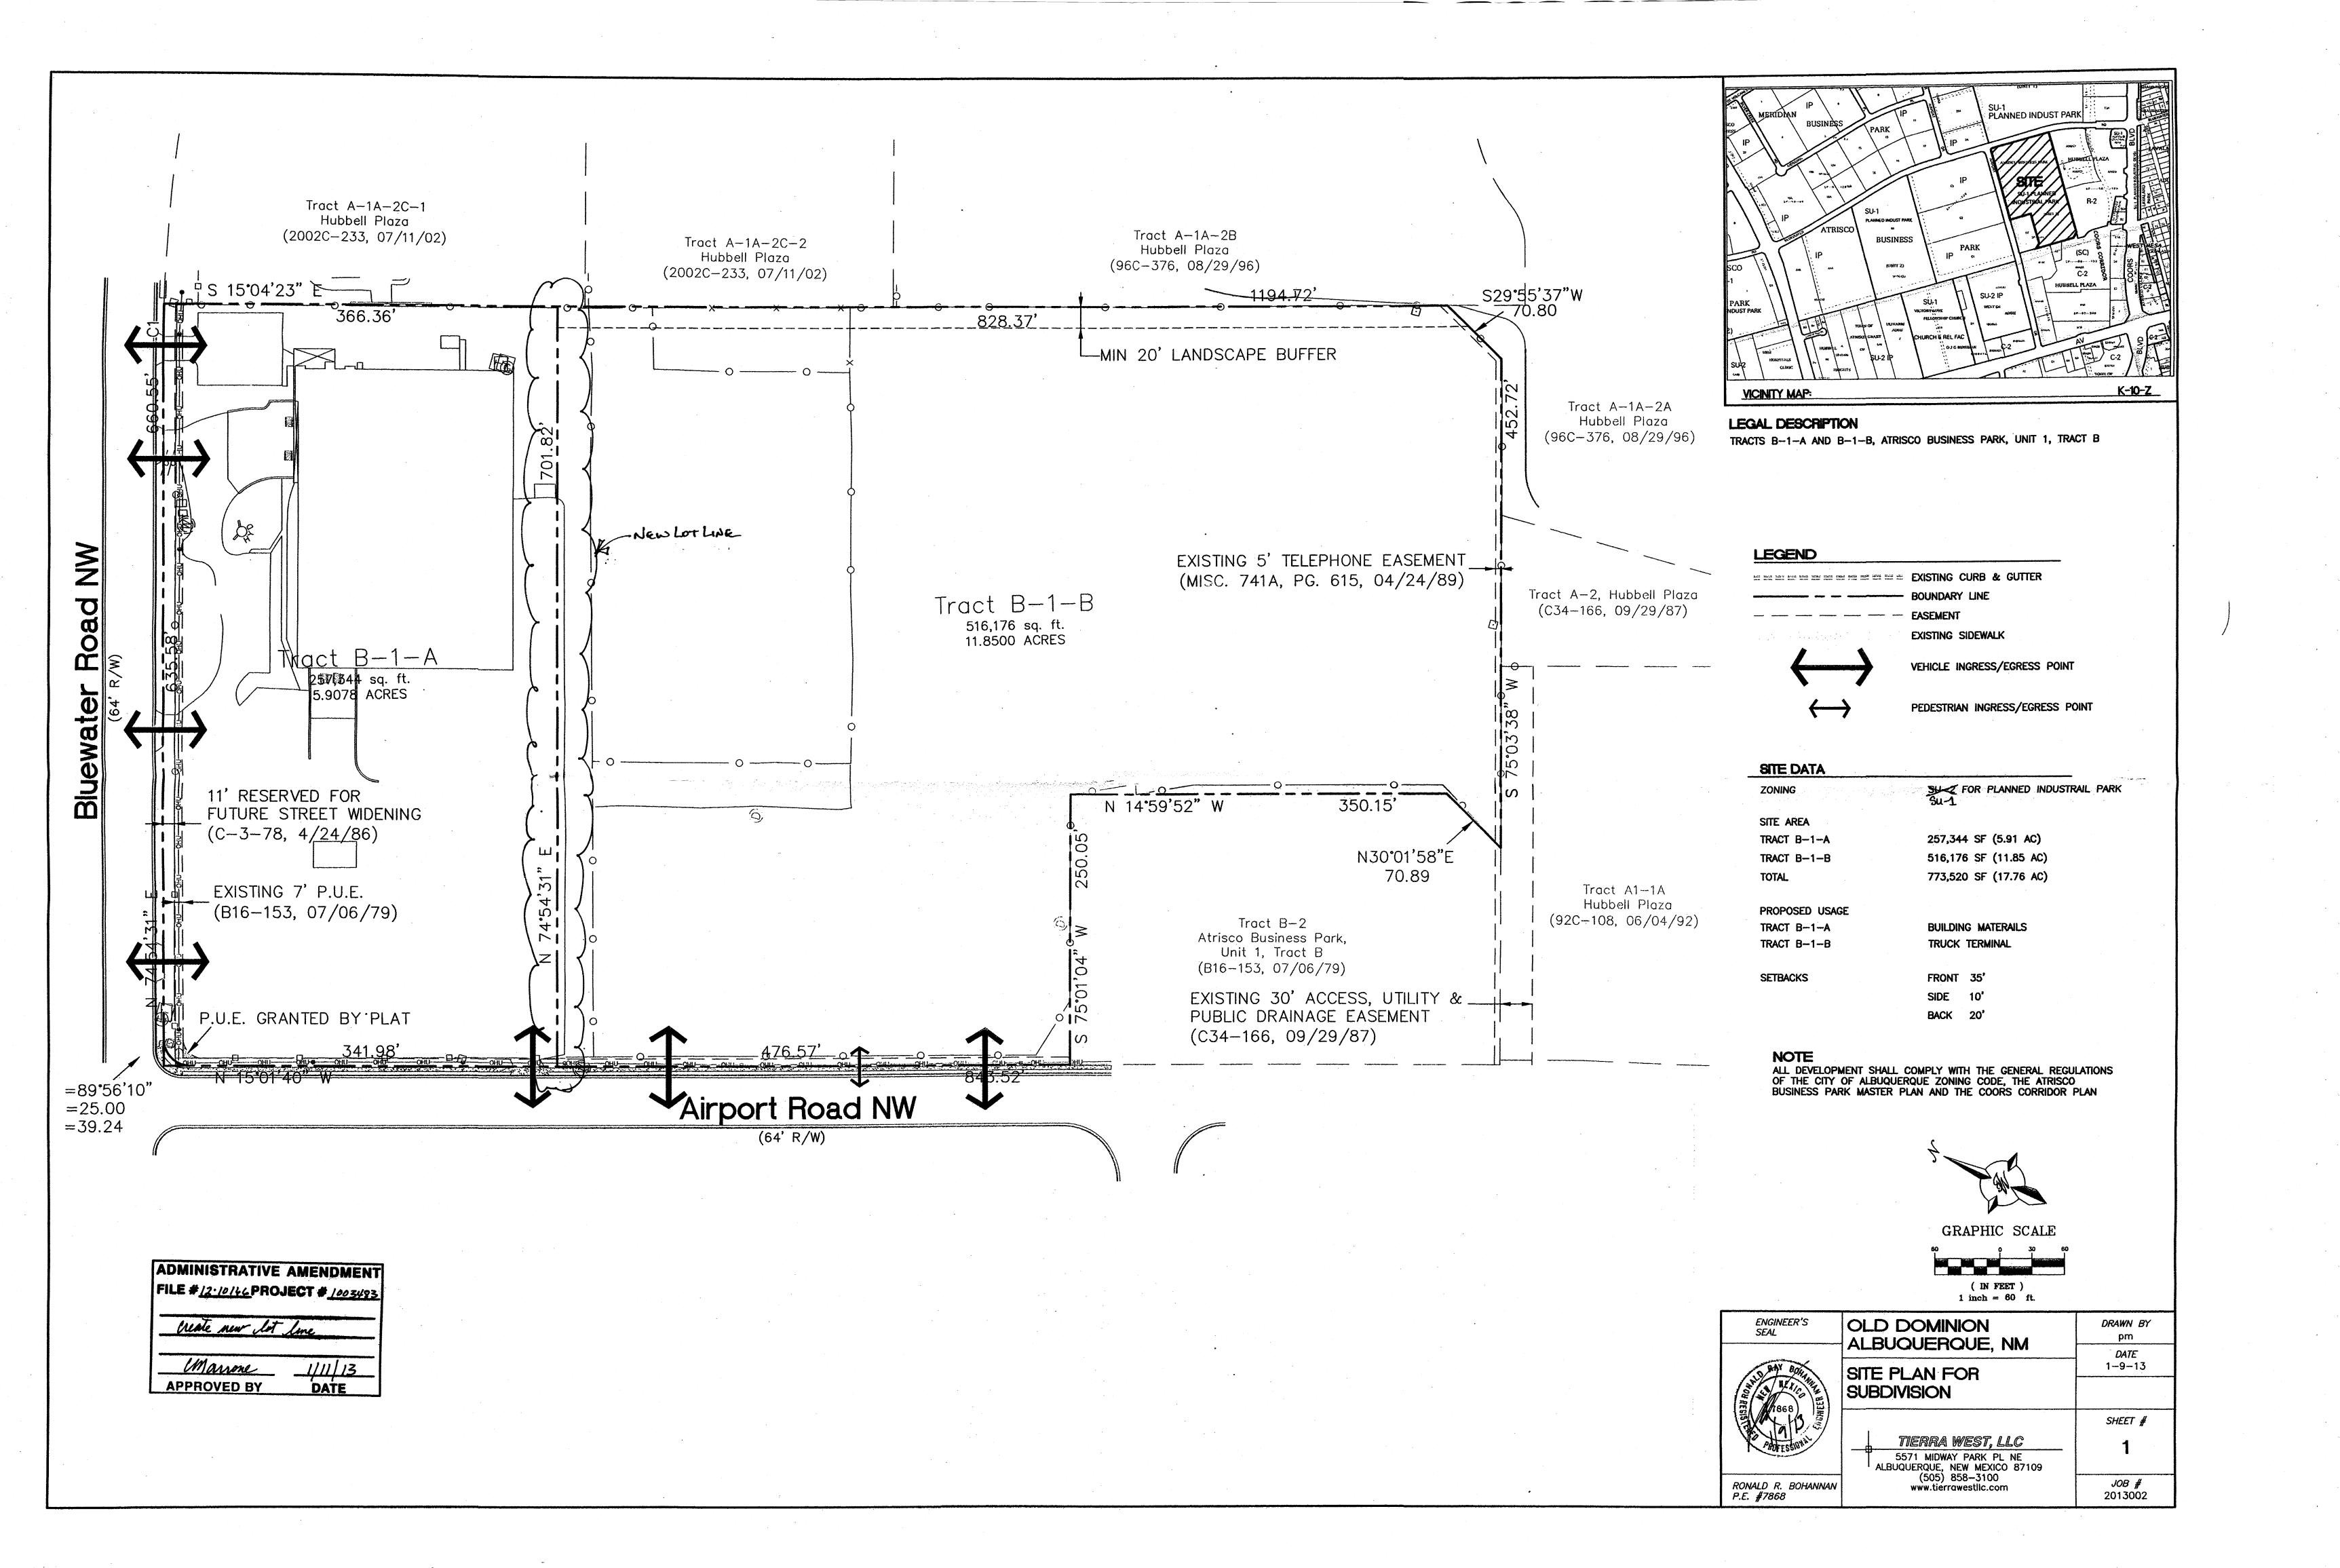

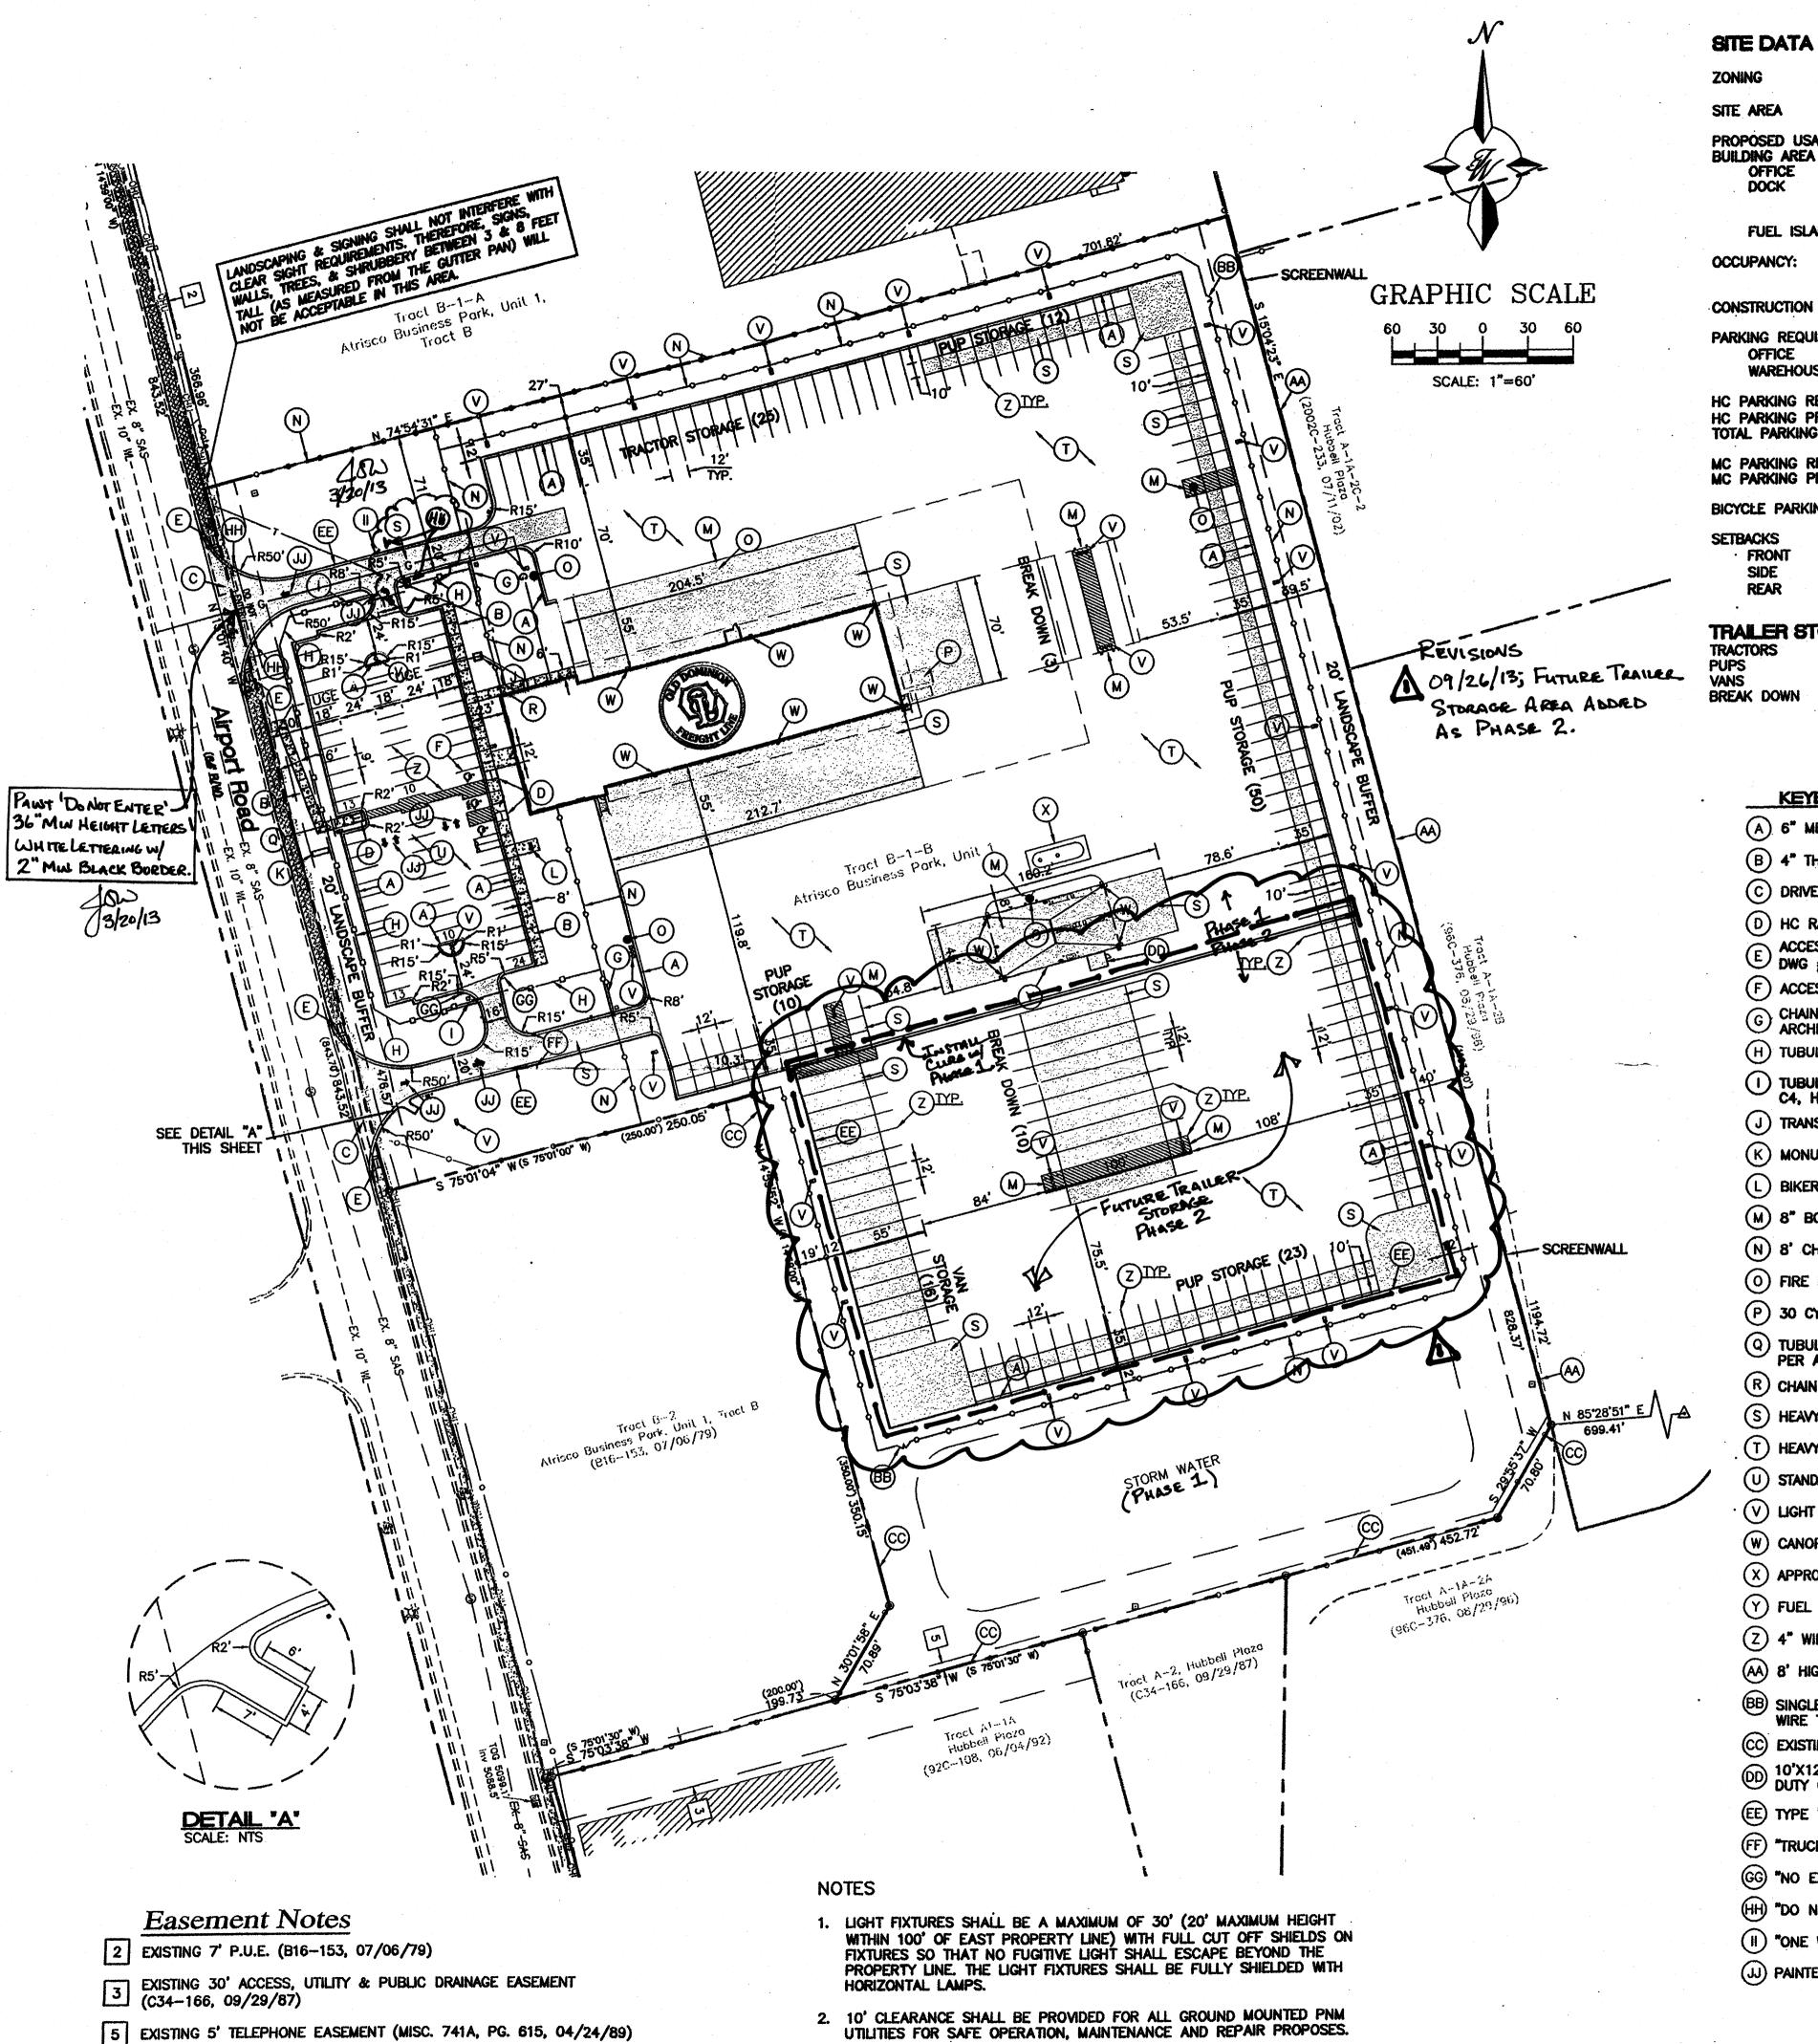SU-1 FOR PLANNED INDUSTRIAL PARK 516,188 SF (11.85 AC)

PROPOSED USAGE BUILDING AREA

TRUCK TERMINAL 3,818 SF 15,995 SF 19,813 SF

3,410 SF

FUEL ISLAND

DOCK-S1 OFFICE-B 11-B, UNPROTECTED CONSTRUCTION TYPE:

PARKING REQUIRED OFFICE WAREHOUSE

20 SPACES (1 SPACE PER 200 SF) 8 SPACES (1 SPACE PER 2000 SF)


HC PARKING REQUIRED 3 SPACES 3 SPACES (1 VAN ACCESSIBLE) 70 SPACES HC PARKING PROVIDED TOTAL PARKING PROVIDED

2 SPACES 2 SPACES MC PARKING REQUIRED MC PARKING PROVIDED 5 SPACES BICYCLE PARKING PROVIDED

TRAILER STORAGE BREAKDOWN


KEYED NOTE:

- (A) 6" MEDIAN CURB & GUTTER PER COA STD DWG #2415B
- (B) 4" THICK CONCRETE SIDEWALK PER COA STD DWG #2430
- (C) DRIVEWAY PER COA STD DWG #2426 (HEAVY DUTY CONCRETE PVMT)
- (D) HC RAMP PER DETAIL ON SHEET C5
- E ACCESSIBLE RAMP W/ TRUNCATED DOMES PER COA STD DWG #2426
- (F) ACCESSIBLE PARKING PER ADA STANDARDS, DETAILS ON C4 & C5
- G CHAIN LINK FENCE W/SLIDING VEHICLE GATE, SEE ARCHITECTURAL & MEP PLANS
- (H) TUBULAR STEEL FENCE PER DETAIL ON C4.
- 1) TUBULAR STEEL FENCE VEHICULAR GATE. FENCE PER DETAIL ON C4, HARDWARE PER ARCH DETAILS.
- J TRANSFORMER, REF MEP PLANS. COORDINATE W/ PNM.
- (K) MONUMENT SIGN PER ARCH DETAILS
- (L) BIKERACK PER DETAIL C4.
- (M) 8" BOLLARDS (4 IN EACH LOCATION TYP.) PER ARCH DETAILS.
- (N) 8' CHAIN LINK FENCE WITH 3 STRAND BARBED WIRE PER ARCH DETAILS.
- (0) FIRE HYDRANT, SEE SHEET C3.
- (P) 30 CY TRASH CONTAINER (SCREENED FROM PUBLIC VIEW BEHIND BLDG)
- Q TUBULAR STEEL MAN GATE. FENCE PER DETAIL ON C4, HARDWARE PER ARCH DETAILS.
- R CHAIN LINK/BARBED WIRE MAN GATE PER ARCH DETAILS.
- S HEAVY DUTY CONCRETE PAVEMENT PER DETAIL SHEET C4.
- (T) HEAVY DUTY ASPHALT PAVEMENT PER DETAIL SHEET C4.
- (U) STANDARD DUTY ASPHALT PAVEMENT PER DETAIL SHEET C4.
- (V) LIGHT POLE, SEE MEP PLANS.
- (W) CANOPY MOUNTED LIGHTS, SEE ARCH/MEP PLANS.
- (X) APPROXIMATE LOCATION UNDERGROUND FUEL TANKS.
- (Y) FUEL CANOPY PER ARCHITECTURAL PLANS.
- (Z) 4" WIDE PAINTED STRIPING (2 COATS)
- (AA) 8' HIGH CMU SCREEN WALL PER DETAIL SHEET C4.
- (BB) SINGLE 10' WIDE SWING GATE W/ CHAIN LINK/BARBED WIRE TO MATCH ARCHITECTURAL DETAILS.
- (CC) EXISTING CHAIN LINK/BARBED WIRE FENCE TO REMAIN.
- DD 10'X12' CONCRETE PAD FOR FLUIDS BUILDING PER HEAVY DUTY CONCRETE DETAIL SHEET C4.
- (EE) TYPE "B" INTEGRAL CURB PER DETAIL SHEET C4.
- (FF) "TRUCKS ONLY" SIGN
- GG "NO EXIT" SIGN
- (HH) "DO NOT ENTER" SIGN
- (II) "ONE WAY" SIGN
- (JJ) PAINTED DIRECTIONAL ARROWS PER DETAIL SHEET C5.

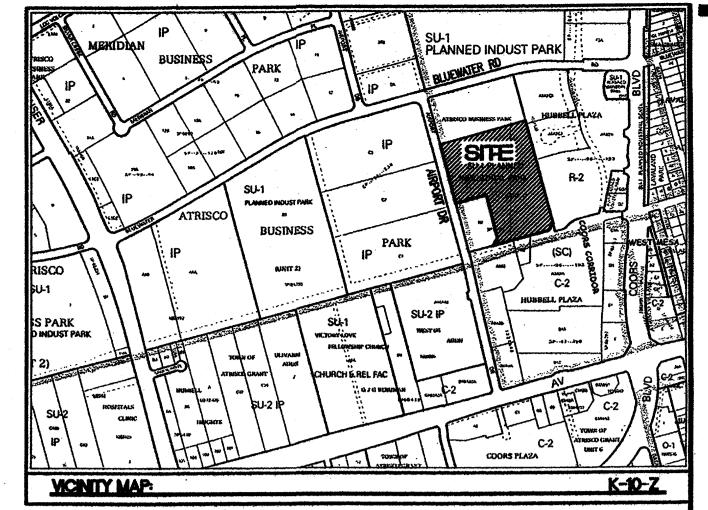

LEGAL DESCRIPTION:

TRACT "B-1-B" OF ATRISCO BUSINESS PARK, UNIT ONE, AS THE SAME IS SHOWN AND DESIGNATED ON THE PLAT THEREOF, FILED IN THE OFFICE OF THE COUNTY CLERK OF BERNALILLO COUNTY, NEW MEXICO, ON 02/04/13, AS DOCUMENT NO. 2013012914.

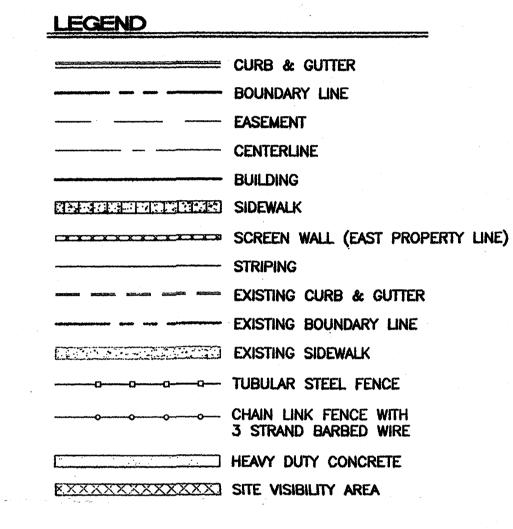

PROJECT NUMBER: 1009544 APPLICATION NUMBER: 13 DRB-70458

DRB SITE DEVELOPMENT PLAN SIGNOFF APPROVAL:

Milo & feleralo-Jernandez	03/20/13
Traffic Engineer, Transportation Division	Date
Allen feter	03/20/1
Water Utility Development	Date
Carol S. Durnont	3-20-13
Parks & Recreation Department	Date
Cuto a Chan	3-20-1
City Engineer	Date
* Environmental Health Department (conditional)	Date
100 whate 3-21-13	
Solid Wests Managers	0-4-

* Environmental Health, if necessary

INDEX TO DRAWINGS SITE PLAN FOR BUILDING PERMIT GRADING AND DRAINAGE PLAN MASTER UTILITY PLAN DETAIL SHEET DETAIL SHEET C6. DEMOLITION PLAN **A2.4 BUILDING ELEVATIONS** A3.1 BUILDING ELEVATIONS

LS-3. LANDSCAPING PLAN

DOMIN GHT LI Is an Infrastructure List required? () Yes () No If Yes, then a set of approved DRC plans with a work order is required for any construction within Public Right—of—Way or for construction of public improvements. Final Permit Set: 03-01-13 13 Date DRB Chairperson, Planning Department Date

ODFL Albuquerque, NM - AL

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Building (enda Lane TX 75229


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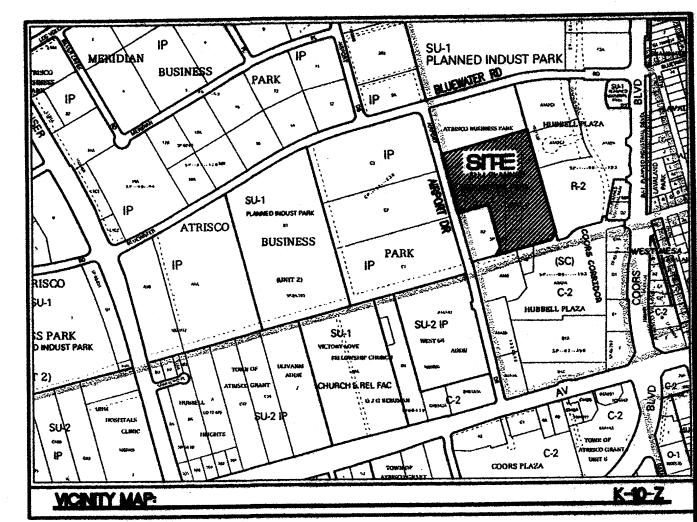
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Project No. 12071.00

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Sheet Name: SITE PLAN FOR **BUILDING PERMIT**





LEGAL DESCRIPTION

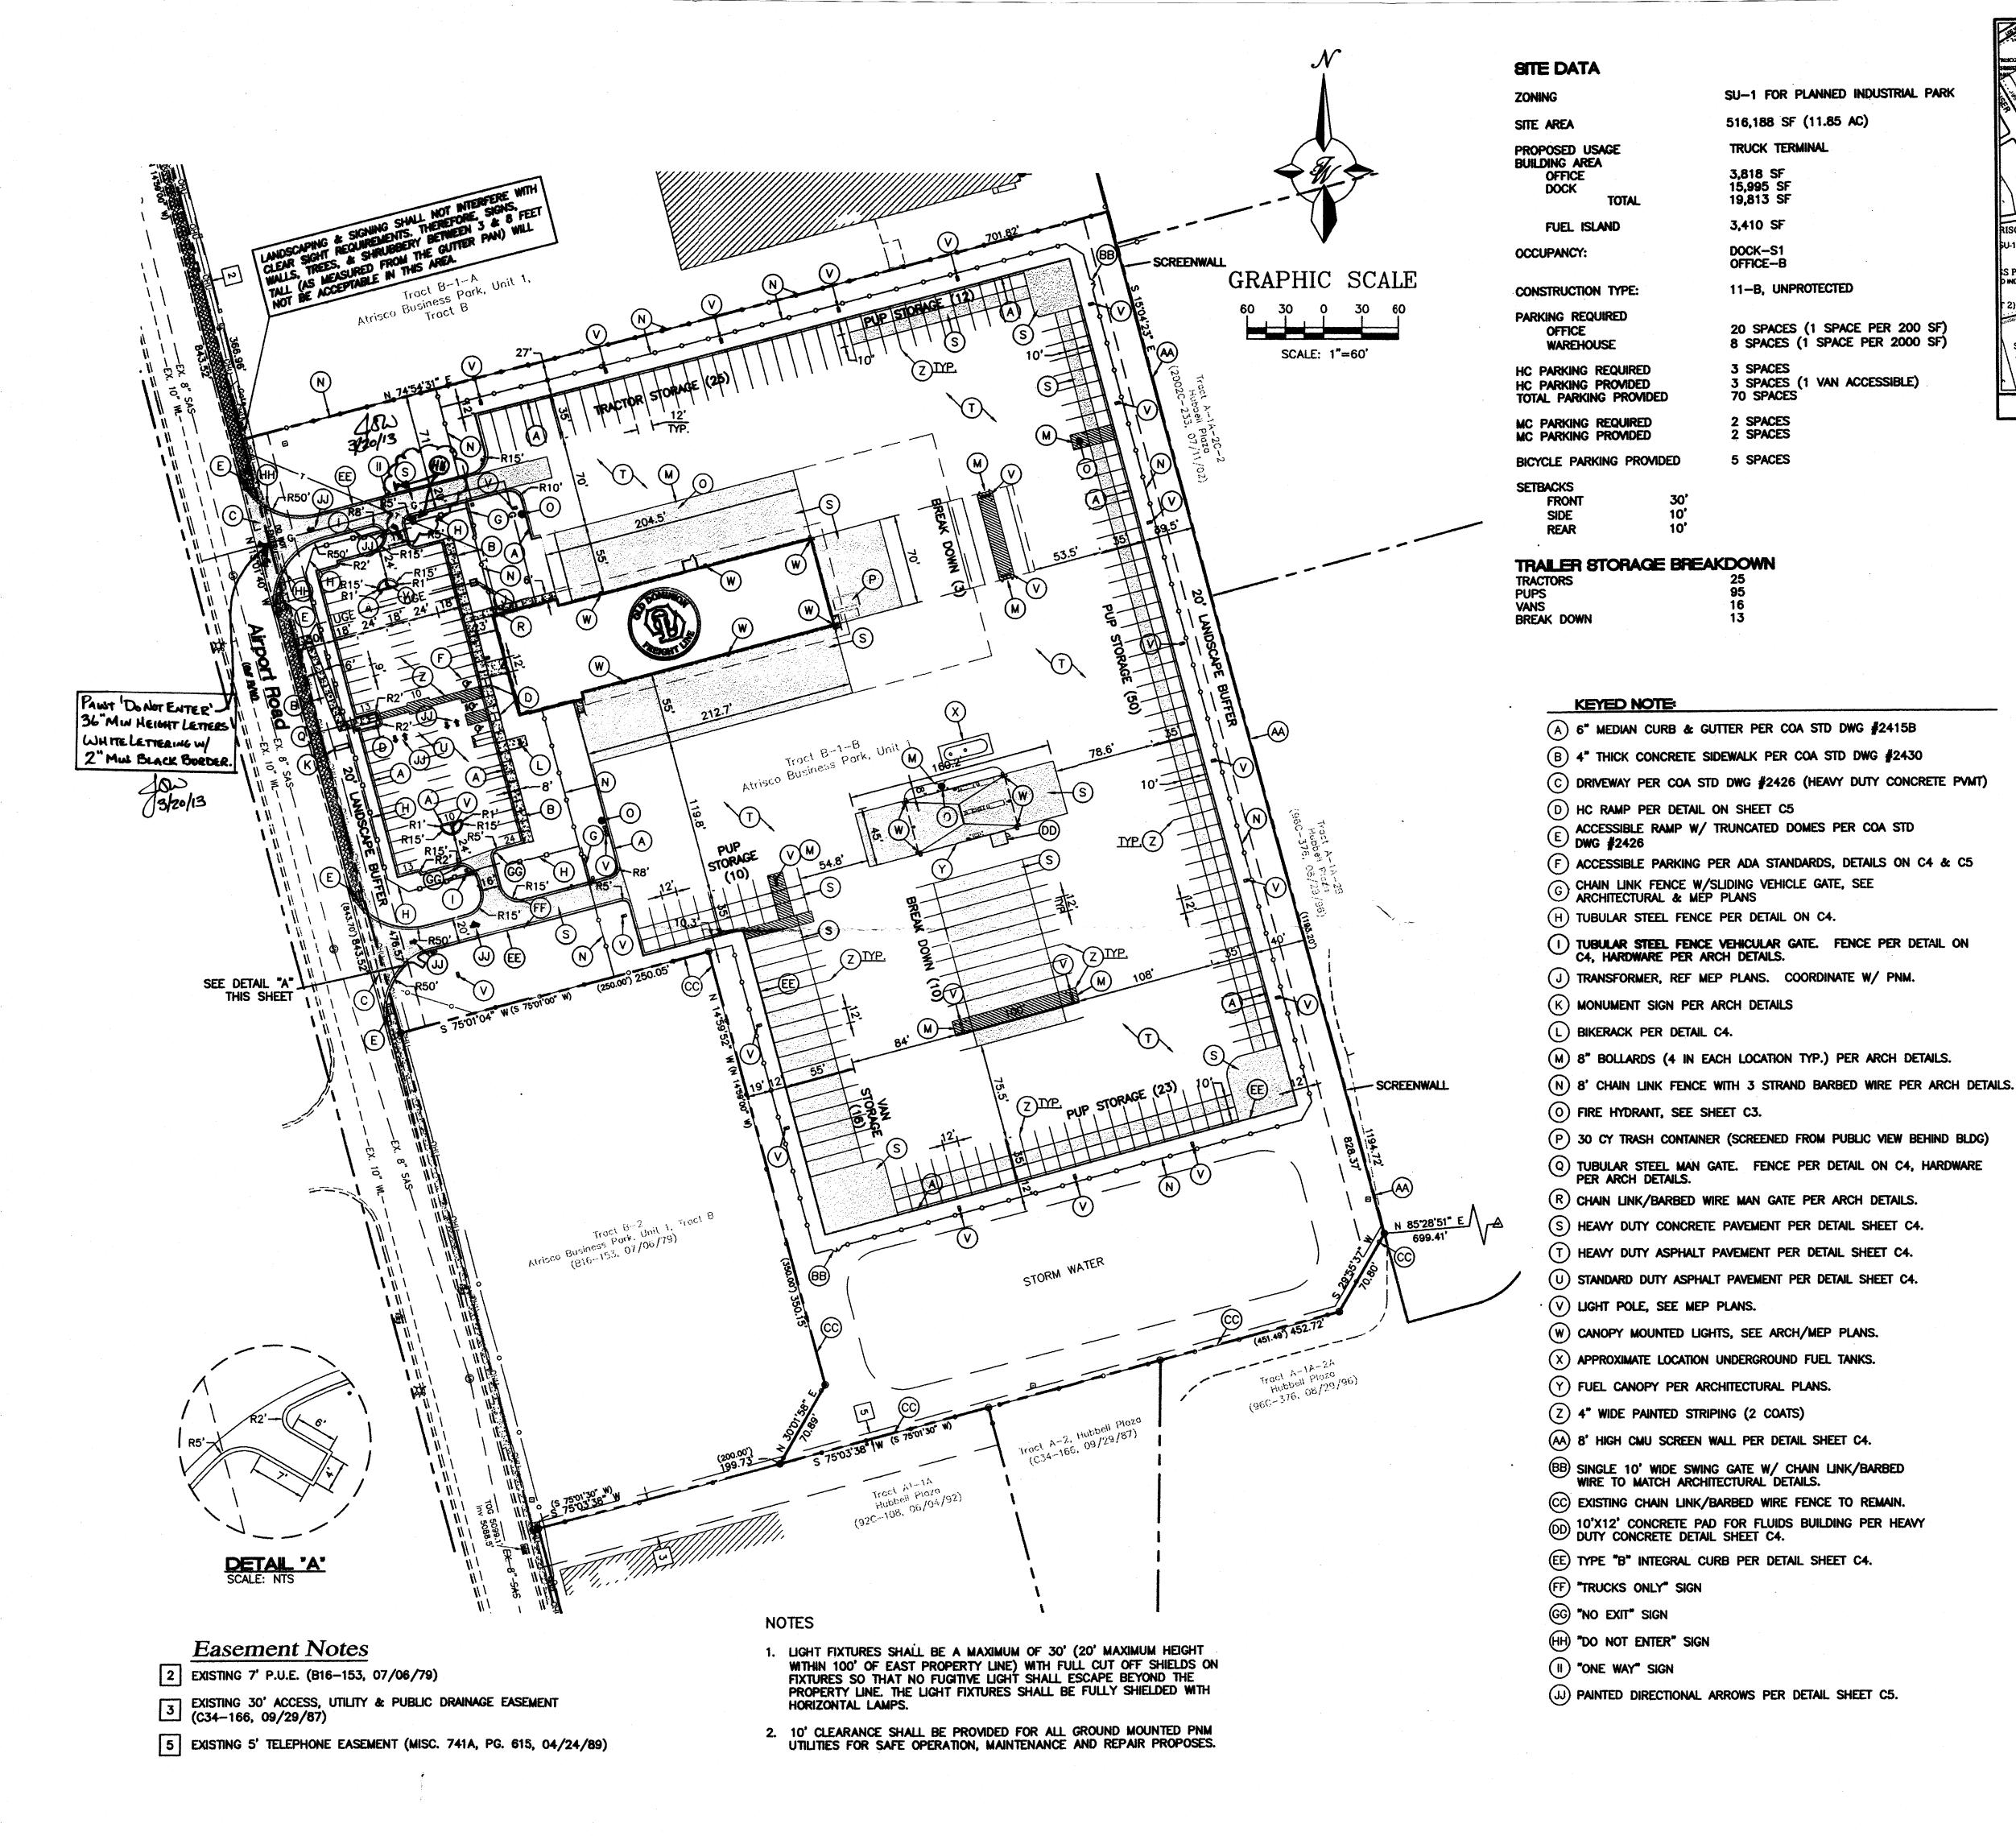SU-1 FOR PLANNED INDUSTRIAL PARK

20 SPACES (1 SPACE PER 200 SF) 8 SPACES (1 SPACE PER 2000 SF)

3 SPACES (1 VAN ACCESSIBLE)

516,188 SF (11.85 AC)

TRUCK TERMINAL

3,818 SF

15,995 SF

19,813 SF

3,410 SF

DOCK-S1

OFFICE-B

3 SPACES

2 SPACES

2 SPACES


5 SPACES

70 SPACES

11-B, UNPROTECTED

TRACT "B-1-B" OF ATRISCO BUSINESS PARK, UNIT ONE, AS THE SAME IS SHOWN AND DESIGNATED ON THE PLAT THEREOF, FILED IN THE OFFICE OF THE COUNTY CLERK OF BERNALILLO COUNTY, NEW MEXICO, ON 02/04/13, AS DOCUMENT NO. 2013012914.

LEGEND BOUNDARY LINE EASEMENT CENTERLINE 開発表現場回回の場合研究 SIDEWALK SCREEN WALL (EAST PROPERTY LINE) EXISTING SIDEWALK 3 STRAND BARBED WIRE HEAVY DUTY CONCRETE

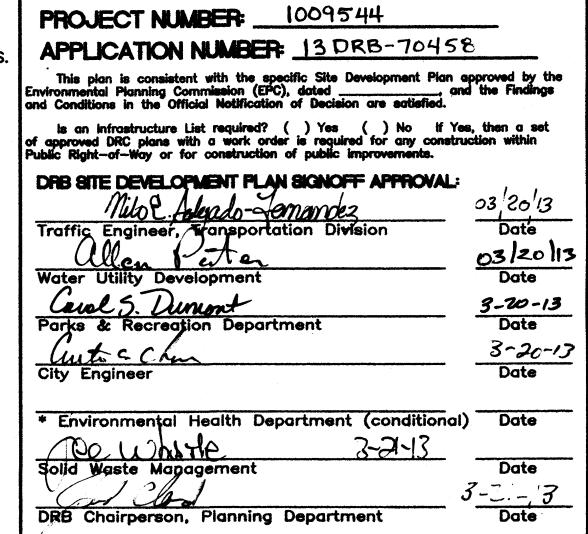

* Environmental Health, if necessary

LS-3. LANDSCAPING PLAN

INDEX TO DRAWINGS SITE PLAN FOR BUILDING PERMIT GRADING AND DRAINAGE PLAN MASTER UTILITY PLAN DETAIL SHEET DETAIL SHEET C6. DEMOLITION PLAN **A2.4 BUILDING ELEVATIONS** A3.1 BUILDING ELEVATIONS

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Final Permit Set: 03-01-13

SNO


Schwob

Sheet Name:

SITE PLAN FOR

Sheet Number:

BUILDING PERMIT

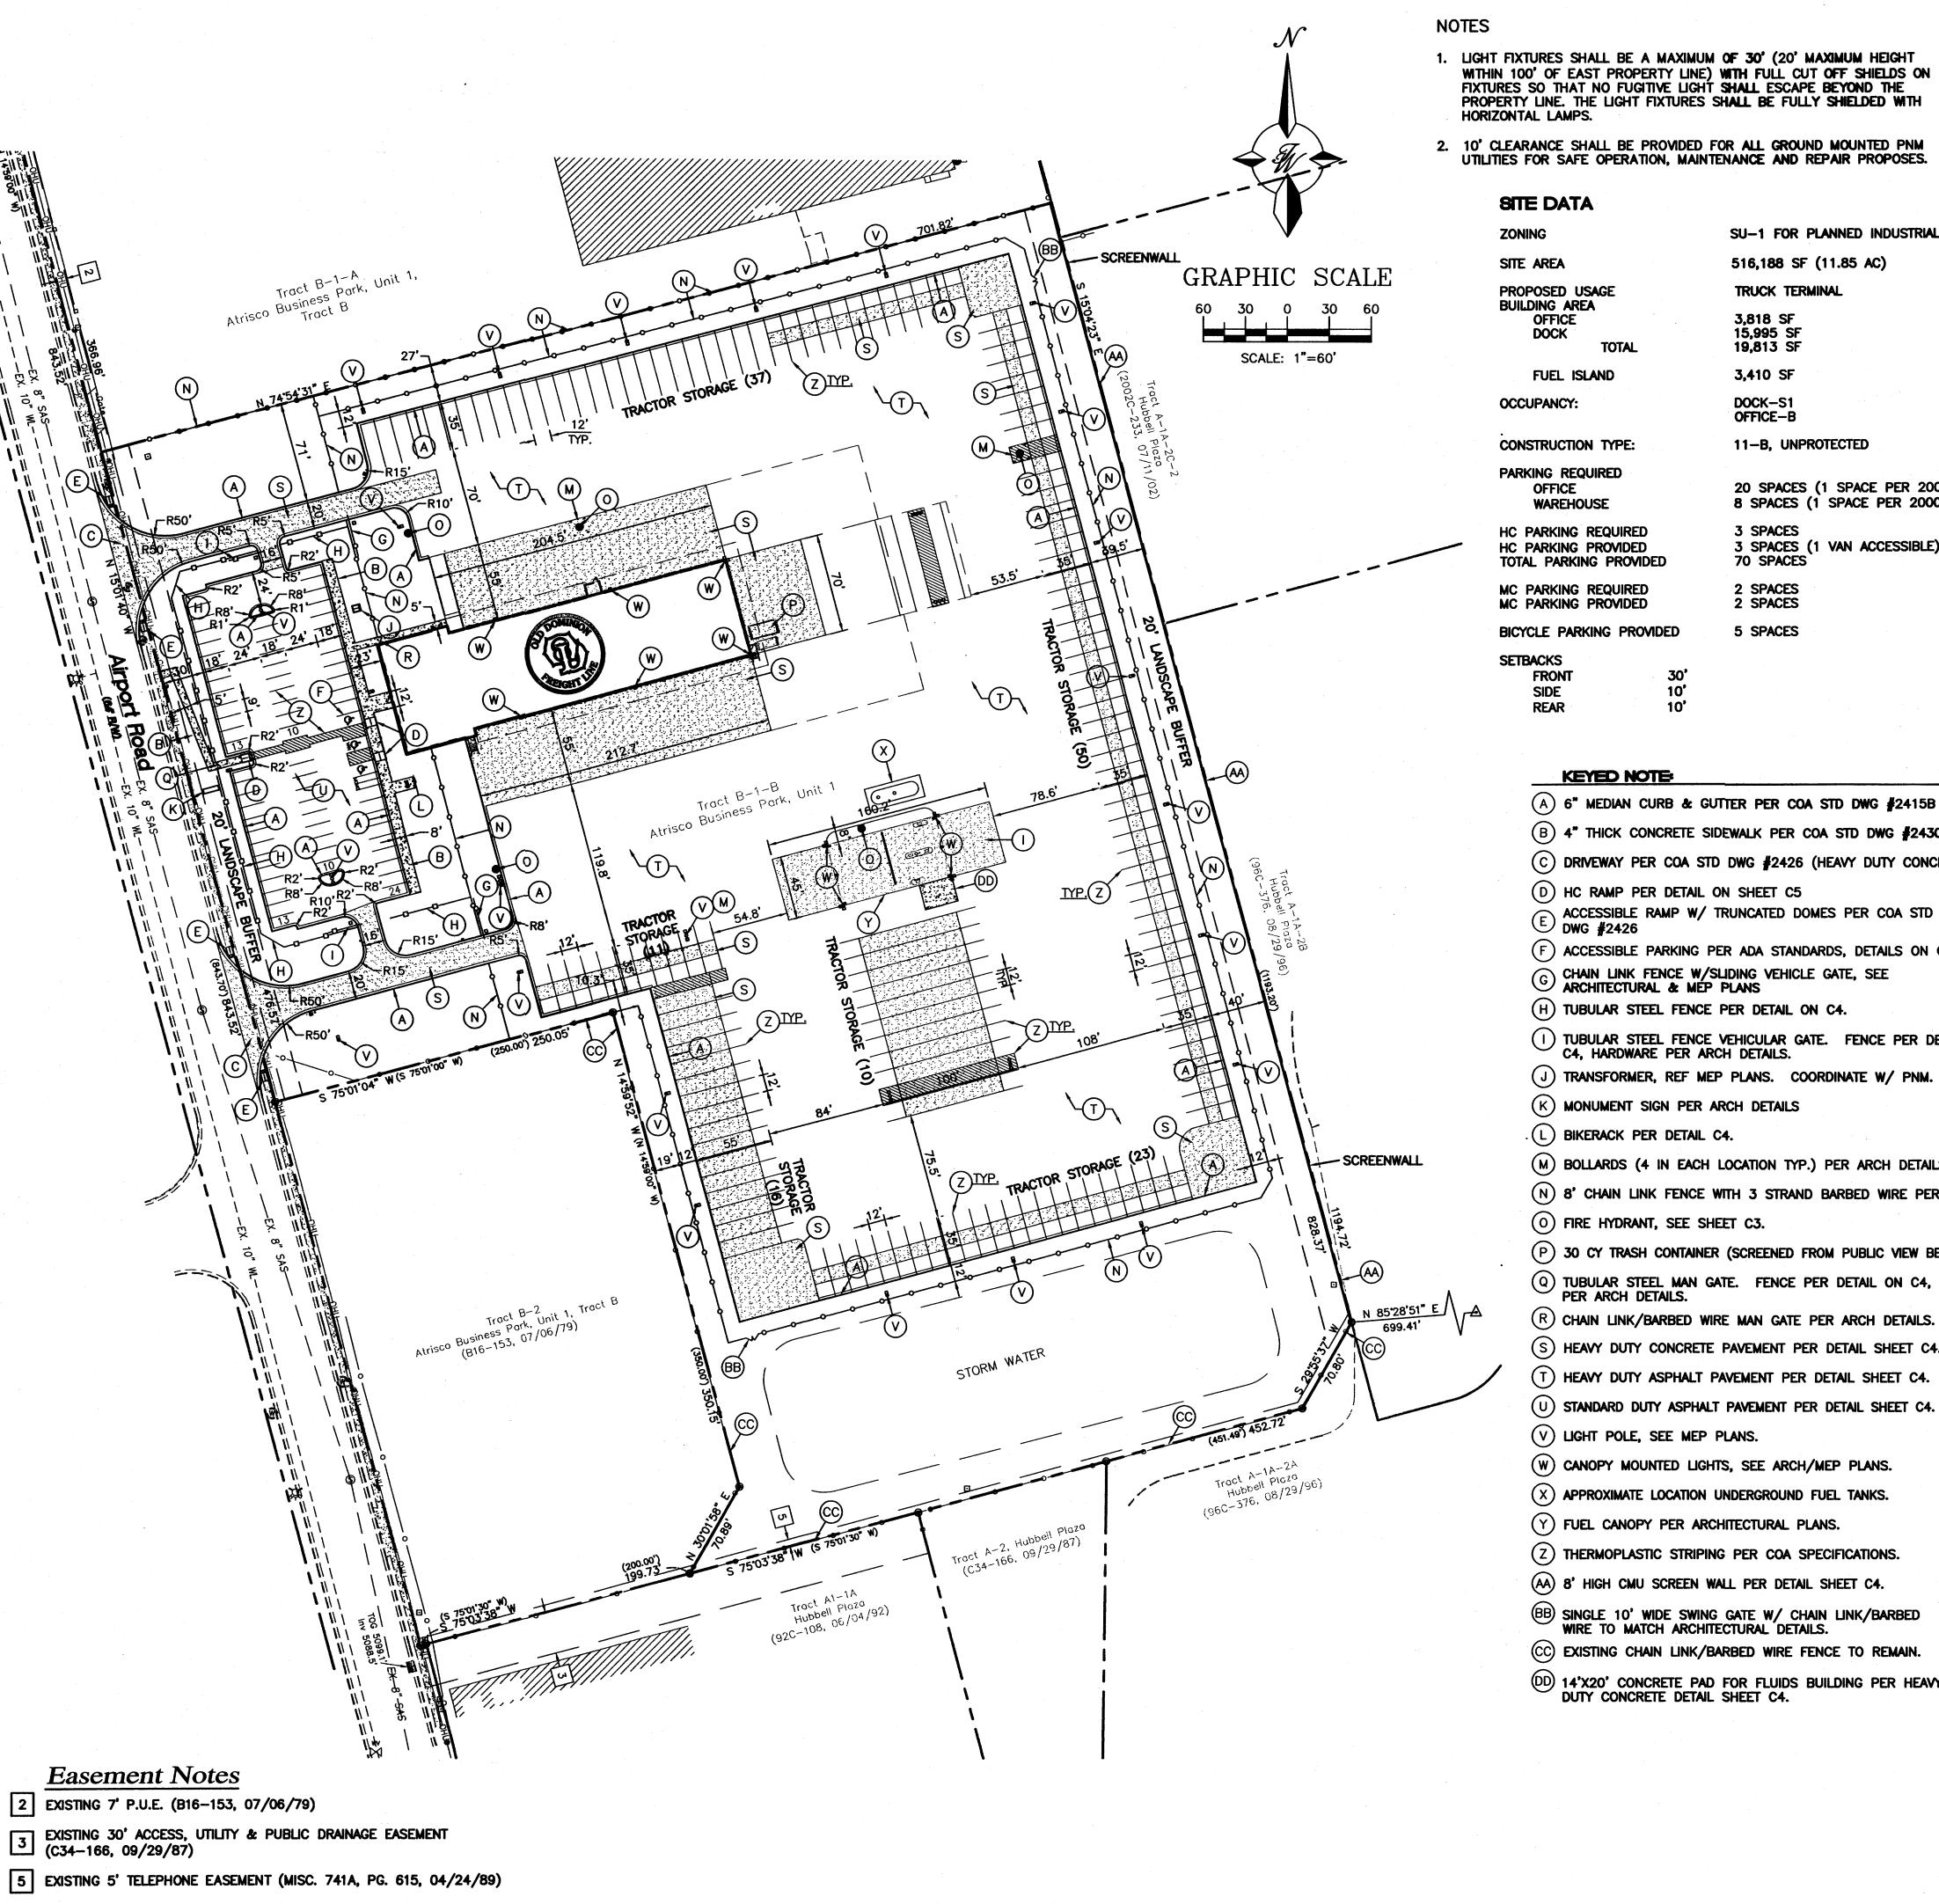

1. LIGHT FIXTURES SHALL BE A MAXIMUM OF 30' (20' MAXIMUM HEIGHT WITHIN 100' OF EAST PROPERTY LINE) WITH FULL CUT OFF SHIELDS ON FIXTURES SO THAT NO FUGITIVE LIGHT SHALL ESCAPE BEYOND THE PROPERTY LINE. THE LIGHT FIXTURES SHALL BE FULLY SHIELDED WITH

2. 10' CLEARANCE SHALL BE PROVIDED FOR ALL GROUND MOUNTED PNM UTILITIES FOR SAFE OPERATION, MAINTENANCE AND REPAIR PROPOSES.

> SU-1 FOR PLANNED INDUSTRIAL PARK 516,188 SF (11.85 AC) TRUCK TERMINAL 3,818 SF 15,995 SF

3,410 SF

11-B, UNPROTECTED

20 SPACES (1 SPACE PER 200 SF) 8 SPACES (1 SPACE PER 2000 SF)

19,813 SF

DOCK-S1


OFFICE-B

3 SPACES (1 VAN ACCESSIBLE) 70 SPACES TOTAL PARKING PROVIDED 2 SPACES 2 SPACES

BICYCLE PARKING PROVIDED 5 SPACES

KEYED NOTE

- (A) 6" MEDIAN CURB & GUTTER PER COA STD DWG #2415B
- (B) 4" THICK CONCRETE SIDEWALK PER COA STD DWG #2430
- (C) DRIVEWAY PER COA STD DWG #2426 (HEAVY DUTY CONCRETE PVMT)
- D HC RAMP PER DETAIL ON SHEET C5
- E ACCESSIBLE RAMP W/ TRUNCATED DOMES PER COA STD DWG #2426
- (F) ACCESSIBLE PARKING PER ADA STANDARDS, DETAILS ON C4 & C5
- G CHAIN LINK FENCE W/SLIDING VEHICLE GATE, SEE ARCHITECTURAL & MEP PLANS
- H TUBULAR STEEL FENCE PER DETAIL ON C4.
- TUBULAR STEEL FENCE VEHICULAR GATE. FENCE PER DETAIL ON C4, HARDWARE PER ARCH DETAILS.
- (J) TRANSFORMER, REF MEP PLANS. COORDINATE W/ PNM.
- (K) MONUMENT SIGN PER ARCH DETAILS
- L BIKERACK PER DETAIL C4.
- (M) BOLLARDS (4 IN EACH LOCATION TYP.) PER ARCH DETAILS.
- (N) 8' CHAIN LINK FENCE WITH 3 STRAND BARBED WIRE PER ARCH DETAILS
- (0) FIRE HYDRANT, SEE SHEET C3.
- (P) 30 CY TRASH CONTAINER (SCREENED FROM PUBLIC VIEW BEHIND BLDG)
- Q TUBULAR STEEL MAN GATE. FENCE PER DETAIL ON C4, HARDWARE PER ARCH DETAILS.
- R CHAIN LINK/BARBED WIRE MAN GATE PER ARCH DETAILS.
- (S) HEAVY DUTY CONCRETE PAVEMENT PER DETAIL SHEET C4.
- (T) HEAVY DUTY ASPHALT PAVEMENT PER DETAIL SHEET C4.
- (V) LIGHT POLE, SEE MEP PLANS.
- (W) CANOPY MOUNTED LIGHTS, SEE ARCH/MEP PLANS.
- (X) APPROXIMATE LOCATION UNDERGROUND FUEL TANKS.
- (Y) FUEL CANOPY PER ARCHITECTURAL PLANS.
- (Z) THERMOPLASTIC STRIPING PER COA SPECIFICATIONS.
- BB SINGLE 10' WIDE SWING GATE W/ CHAIN LINK/BARBED WIRE TO MATCH ARCHITECTURAL DETAILS.
- (CC) EXISTING CHAIN LINK/BARBED WIRE FENCE TO REMAIN.
- DD 14'X20' CONCRETE PAD FOR FLUIDS BUILDING PER HEAVY DUTY CONCRETE DETAIL SHEET C4.

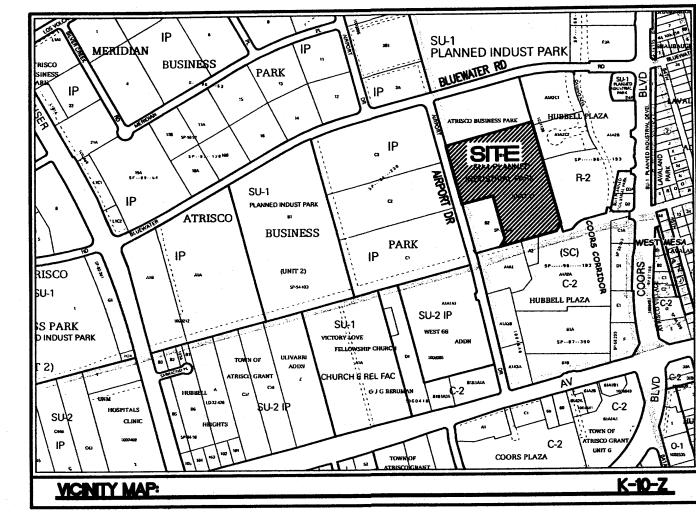

LEGAL DESCRIPTION

TRACT "B-1-B" OF ATRISCO BUSINESS PARK, UNIT ONE, AS THE SAME IS SHOWN AND DESIGNATED ON THE PLAT THEREOF, FILED IN THE OFFICE OF THE COUNTY CLERK OF BERNALILLO COUNTY, NEW MEXICO, ON 02/04/13, AS DOCUMENT NO. 2013012914.

LEGEND

CURB & GUTTER CENTERLINE SIDEWALK SCREEN WALL (EAST PROPERTY LINE) - - EXISTING BOUNDARY LINE EXISTING SIDEWALK

3 STRAND BARBED WIRE

PROJECT NUMBER:

APPLICATION NUMBER:

Is an Infrastructure List required? () Yes () No If Yes, then a set of approved DRC plans with a work order is required for any construction within Public Right—of—Way or for construction of public improvements.

DRB SITE DEVELOPMENT PLAN SIGNOFF APPROVAL:

Traffic Engineer, Transportation Division	Date
Water Utility Development	Date
Parks & Recreation Department	Date
City Engineer	Date
* Environmental Health Department (conditional)	Date
Solid Waste Management	Date

* Environmental Health, if necessary

DRB Chairperson, Planning Department


INDEX TO DRAWINGS

- SITE PLAN FOR BUILDING PERMIT
- C2. GRADING AND DRAINAGE PLAN
- C3. MASTER UTILITY PLAN
- C4. DETAIL SHEET
- C5. DETAIL SHEET
- C6. DEMOLITION PLAN **A2.4 BUILDING ELEVATIONS**
- A3.1 BUILDING ELEVATIONS LS-3. LANDSCAPING PLAN

902 Buildin 72 pp **≥** 0 chw 349 allas 220



Issue for Permit: xx-xx-xx

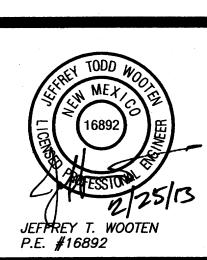

ODFL Albuquerque, NM - ALE

Project No. 12071.00


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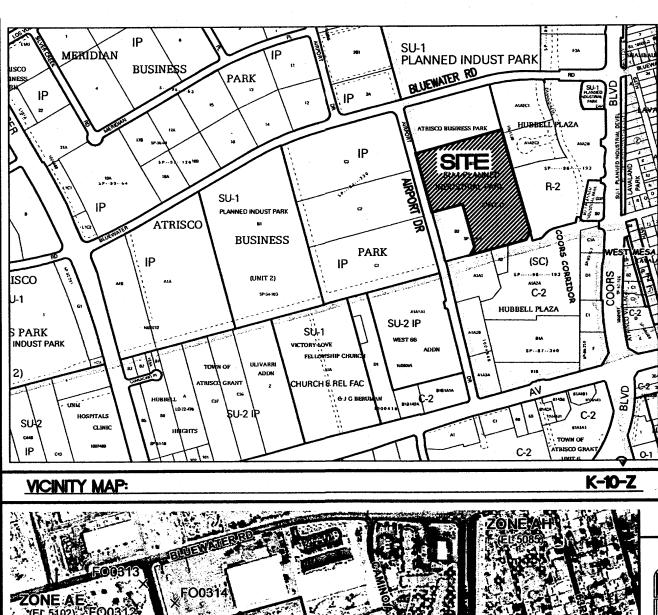
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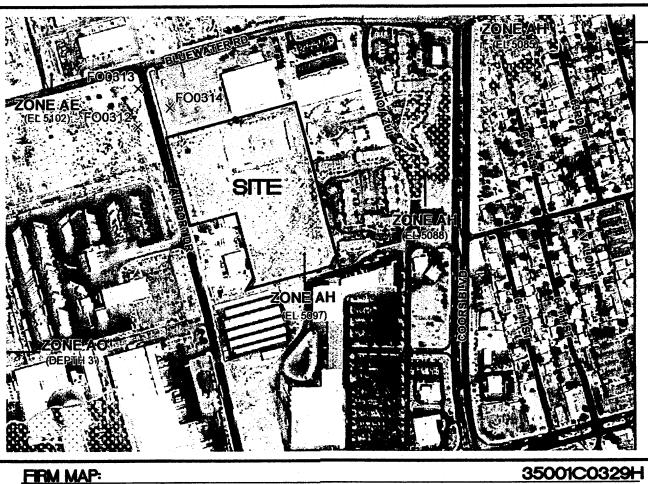
SITE PLAN FOR

BUILDING PERMIT

Sheet Number:





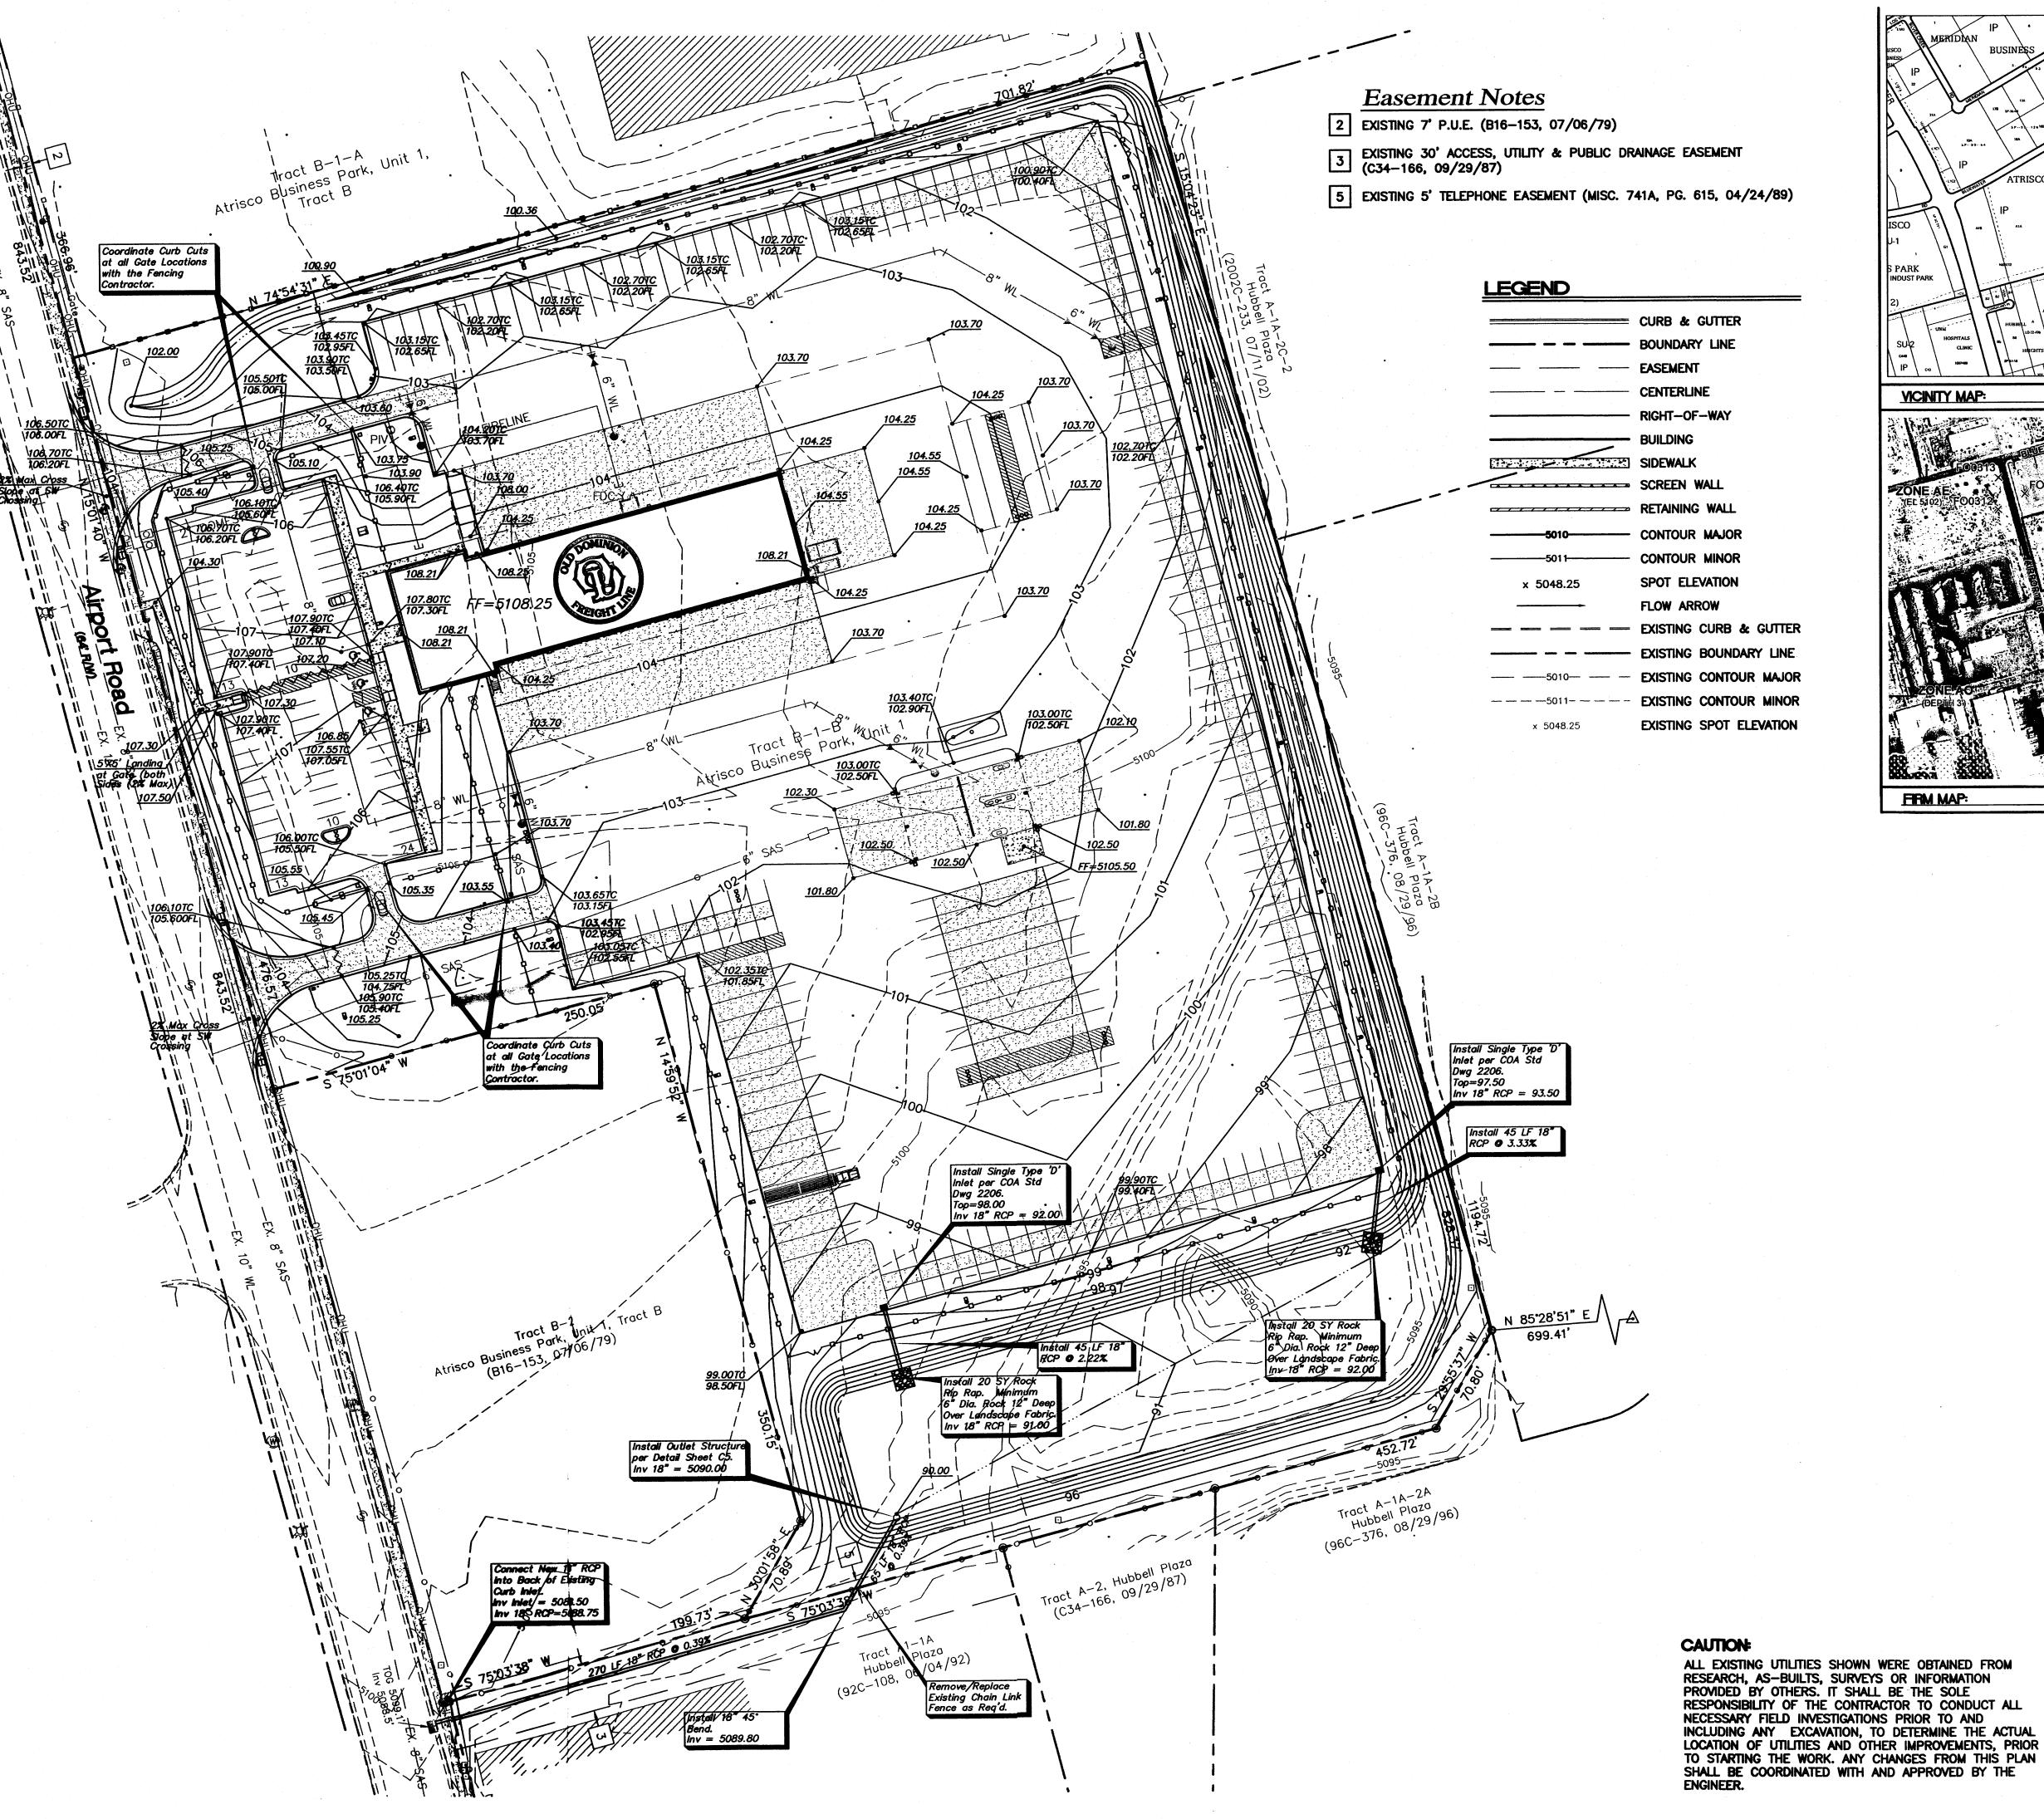

TIERRA WEST, LLC 5571 MIDWAY PARK PL NE ALBUQUERQUE, NEW MEXICO 87109 (505) 858—3100

Schwob Building Co. 2349 Glenda Lane Dallas, TX 75229

OLD DOMINION
-REIGHT LINE
30 Airport Rd NW

Issue for Permit: xx-xx-xx

16892 ESSION 16892

JEFFREY T. WOOTEN
P.E. #16892

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Sheet Name:


GRADING AND

DRAINAGE PLAN

Sheet Number:

GRAPHIC SCALE

SCALE: 1"=50'

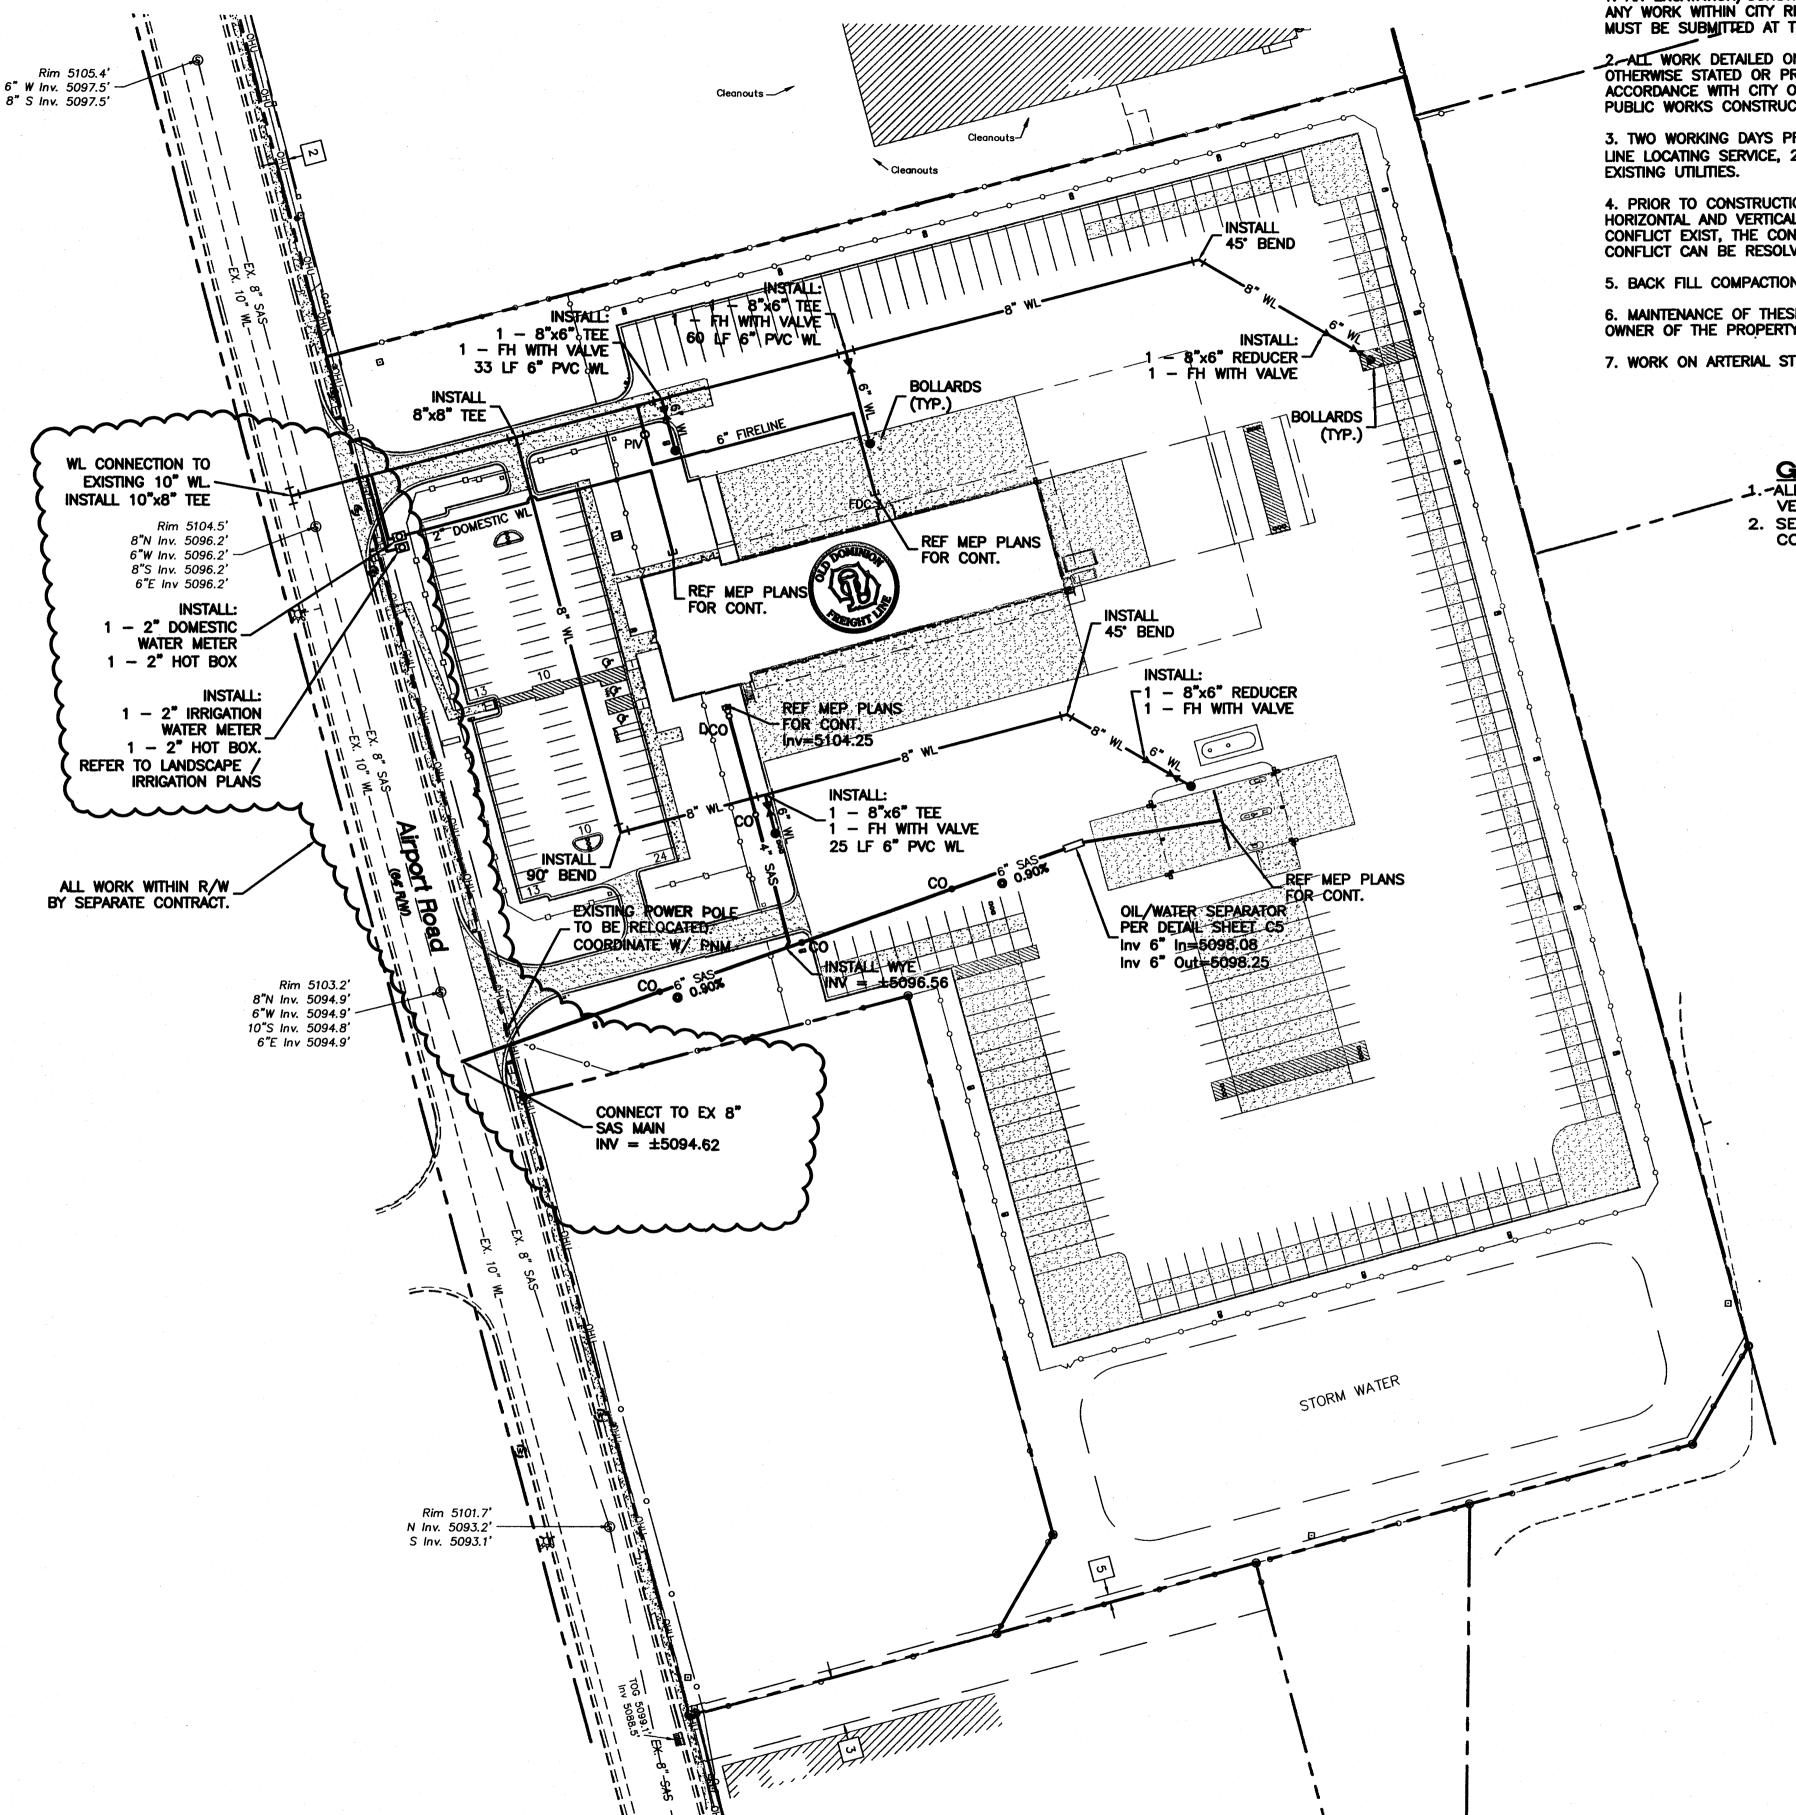

NOTICE TO CONTRACTORS

1. AN EXCAVATION/CONSTRUCTION PERMIT WILL BE REQUIRED BEFORE BEGINNING ANY WORK WITHIN CITY RIGHT-OF-WAY. AN APPROVED COPY OF THESE PLANS MUST BE SUBMITTED AT THE TIME OF APPLICATION FOR THIS PERMIT.

2 ALL WORK DETAILED ON THESE PLANS TO BE PERFORMED, EXCEPT AS OTHERWISE STATED OR PROVIDED HEREON, SHALL BE CONSTRUCTED IN ACCORDANCE WITH CITY OF ALBUQUERQUE INTERIM STANDARD SPECIFICATIONS FOR PUBLIC WORKS CONSTRUCTION, 1985.

3. TWO WORKING DAYS PRIOR TO ANY EXCAVATION, CONTRACTOR MUST CONTACT LINE LOCATING SERVICE, 260-1990 (OR DIAL 811 LOCALLY), FOR LOCATION OF

4. PRIOR TO CONSTRUCTION, THE CONTRACTOR SHALL EXCAVATE AND VERIFY THE HORIZONTAL AND VERTICAL LOCATIONS OF ALL CONSTRUCTIONS. SHOULD A CONFLICT EXIST, THE CONTRACTOR SHALL NOTIFY THE ENGINEER SO THAT THE CONFLICT CAN BE RESOLVED WITH A MINIMUM AMOUNT OF DELAY.

- 5. BACK FILL COMPACTION SHALL BE ACCORDING TO RESIDENTIAL STREET USE.
- 6. MAINTENANCE OF THESE FACILITIES SHALL BE THE RESPONSIBILITY OF THE OWNER OF THE PROPERTY SERVED.
- 7. WORK ON ARTERIAL STREETS SHALL BE PERFORMED ON A 24-HOUR BASIS.

GENERAL NOTES:

1.-ALL STUBS AND UTILITY LOCATIONS MUST BE FIELD VERIFIED PRIOR TO CONSTRUCTION.

2. SEE ARCHITECTURAL/MEP PLANS FOR LIGHTING CONDUITS AND TELÉPHONE LINES.

GENERAL UTILITY NOTES:

- 1. ALL WATER AND SEWER UTILITY WORK TO BE DONE IN ACCORDANCE WITH COA STANDARDS AND SPECIFICATIONS LATEST EDITION.
- 2. 4' MINIMUM BURY REQUIRED FOR ALL UTILITIES UNLESS OTHERWISE NOTED.
- 3. REFERENCE MEP PLANS FOR WATER LINE RISER LOCATIONS.
- 4. CLEAN OUTS ARE TO BE BUILT PER UNIFORM PLUMBING CODE STANDARDS.
- 5. ALL PLUMBING PIPE MATERIAL TO BE USED PER UPC.
- 6. FIRE LINE AND DOMESTIC WATERLINE MUST HAVE BACKFLOW PREVENTORS PER UPC. IF BACKFLOW PREVENTOR IS INSTALLED EXTERIOR OF BUILDING A HOT BOX SHALL BE
- 7. ALL MANHOLES AND CLEANOUTS SHALL HAVE 8" THICK CONCRETE COLLARS POURED AND BE ADJUSTED TO FINISHED GRADE.
- 8. ALL EXCAVATION, TRENCHING AND SHORING ACTIVITIES MUST BE CARRIED-OUT IN ACCORDANCE WITH OSHA 29 CFR 1926.650 SUBPART P.
- 9. PNM HAS NUMEROUS ELECTRIC FACILITIES NEAR THIS SITE CURRENTLY SERVING EXISTING CUSTOMERS. THE APPLICANT SHALL COORDINATE WITH PNM REGARDING THESE EXISTING FACILITIES. ANY RELOCATION, CHANGES OR REALIGNMENT OF EXISTING ELECTRIC UTILITIES WILL BE THE DEVELOPER EXPENSE. IN SOME CASES, RELOCATION OR CHANGES TO EXISTING FACILITIES MAY NOT BE FEASIBLE DUE TO PHYSICAL, USE OR SAFETY CLEARANCE CONSTRAINTS.
- 10. PNM WILL REVIEW ALL TECHNICAL NEEDS, ISSUES AND SAFETY CLEARANCES FOR ITS ELECTRIC POWER SYSTEMS. ANY EXISTING AND PROPOSED PUBLIC UTILITY EASEMENTS SHALL BE INDICATED ON THE SITE PLAN UTILITY SHEET PRIOR TO DRB REVIEW. PNM'S STANDARD FOR PUBLIC UTILITY EASEMENTS IS 10 FEET IN WIDTH TO ENSURE ADEQUATE, SAFE CLEARANCES.
- 11. SCREENING SHALL BE DESIGNED TO ALLOW FOR ACCESS TO UTILITY FACILITIES. IT IS NECESSARY TO PROVIDE ADEQUATE CLEARANCE OF TEN FEET SURROUNDING ALL GROUND-MOUNTED UTILITIES FOR SAFE OPERATION, MAINTENANCE AND REPAIR PURPOSES.

CAUTION

ENGINEER.

ALL EXISTING UTILITIES SHOWN WERE OBTAINED FROM RESEARCH, AS-BUILTS, SURVEYS OR INFORMATION


RESPONSIBILITY OF THE CONTRACTOR TO CONDUCT ALL

SHALL BE COORDINATED WITH AND APPROVED BY THE

INCLUDING ANY EXCAVATION, TO DETERMINE THE ACTUAL LOCATION OF UTILITIES AND OTHER IMPROVEMENTS, PRIOR TO STARTING THE WORK. ANY CHANGES FROM THIS PLAN

PROVIDED BY OTHERS. IT SHALL BE THE SOLE

NECESSARY FIELD INVESTIGATIONS PRIOR TO AND

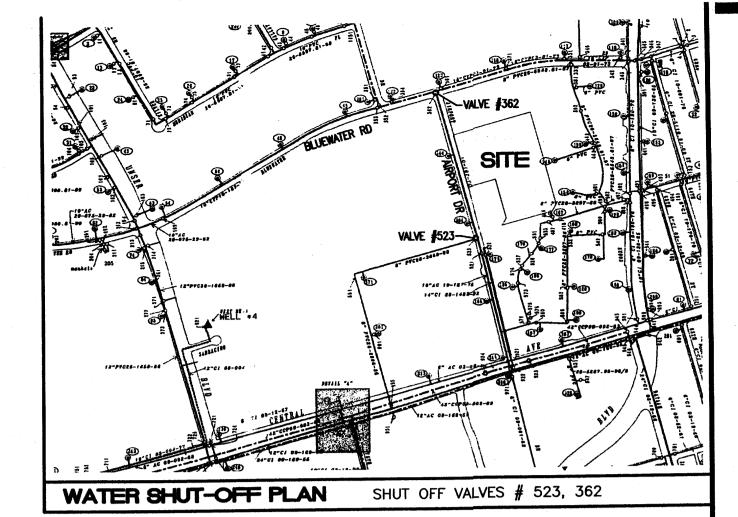

1. ONLY ABCWUA WATER SYSTEMS PERSONNEL ARE AUTHORIZED TO OPERATE

2. THE CONTRACTOR SHALL COORDINATE WITH THE WATER AUTHORITY SEVEN (7) DAYS IN ADVANCE OF PERFORMING WORK THAT WILL AFFECT THE PUBLIC WATER OR SANITARY SEWER INFRASTRUCTURE. WORK REQUIRING SHUTOFF OF FACILITIES DESIGNATED AS MASTER PLAN FACILITIES MUST BE COORDINATED WITH THE WATER AUTHORITY 14 DAYS IN ADVANCE OF PERFORMING SUCH WORK. ONLY WATER AUTHORITY CREWS ARE AUTHORIZED TO OPERATE PUBLIC VALVES. SHUTOFF REQUESTS MUST BE MADE ONLINE AT HTTP://ABCWUA.ORG/CONTENT/VIEW/463/729/.

- 3. APPROXIMATE SHUT OFF TIME WILL BE 24 HOURS.
- 4. SHUTOFF THE VALVES INDICATED IN THE ABOVE PLAN.
- 5. IF REQUIRED, CONTRACTOR SHALL PREPARE AND SUBMIT A DETOUR PLAN FOR APPROVAL PRIOR TO BEGINNING WORK.

LEGEND

CURB & GUTTER ---- CENTERLINE RIGHT-OF-WAY - BUILDING SIDEWALK SCREEN WALL RETAINING WALL --- EXISTING CURB & GUTTER ----- EXISTING BOUNDARY LINE SD----- STORM SEWER LINE S----- SANITARY SEWER LINE ---- WATERLINE SINGLE CLEAN OUT DOUBLE CLEAN OUT EXISTING SD MANHOLE **EXISTING INLET** EXISTING SAS MANHOLE EXISTING FIRE HYDRANT EXISTING WATER METER **EXISTING POWER POLE** EXISTING GAS VALVE - - - U - - EXISTING OVERHEAD UTILITIES ----EX. UGE---- EXISTING UNDERGROUND UTILITIES ----EX. 10" WL--- EXISTING WATER LINE

--- EX. 18" RCP---- EXISTING STORM SEWER LINE

GRAPHIC SCALE

SCALE: 1"=60'


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Issue for Permit: xx-xx-xx




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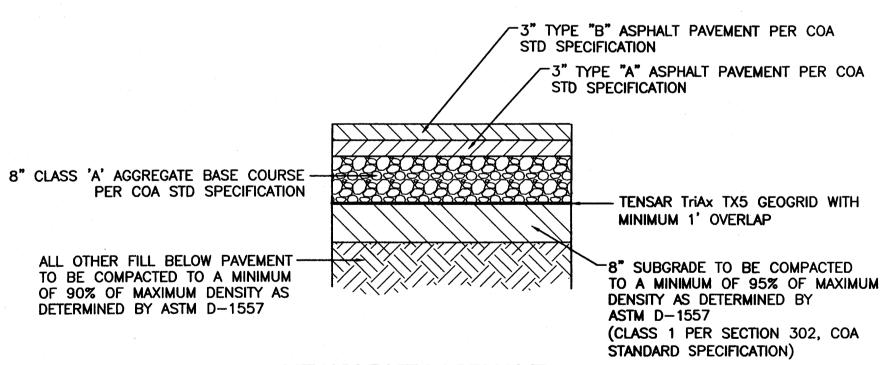
Sheet Name: MASTER UTILITY PLAN

BIKE RACK DETAIL
SCALE: 1/2"=1'

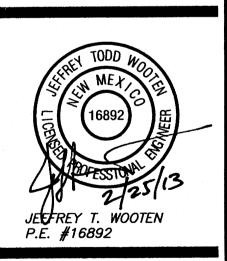


HEAVY DUTY CONCRETE TYPICAL PAVING SECTION

DESIGNATED BY X8E VINYARD.

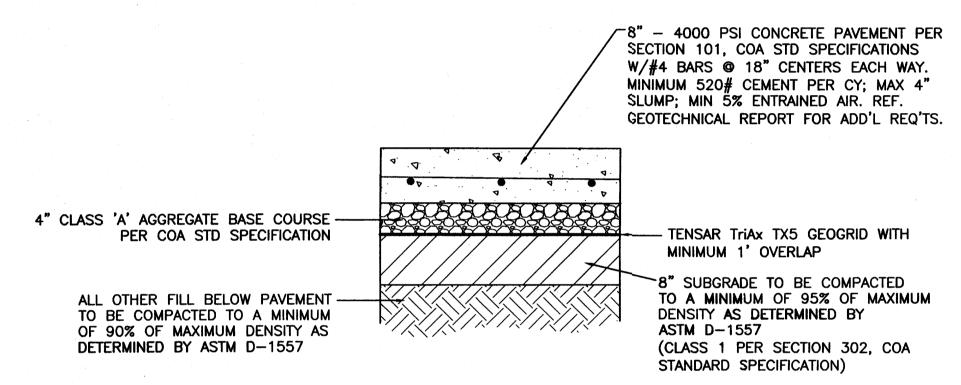


HEAVY DUTY ASPHALT

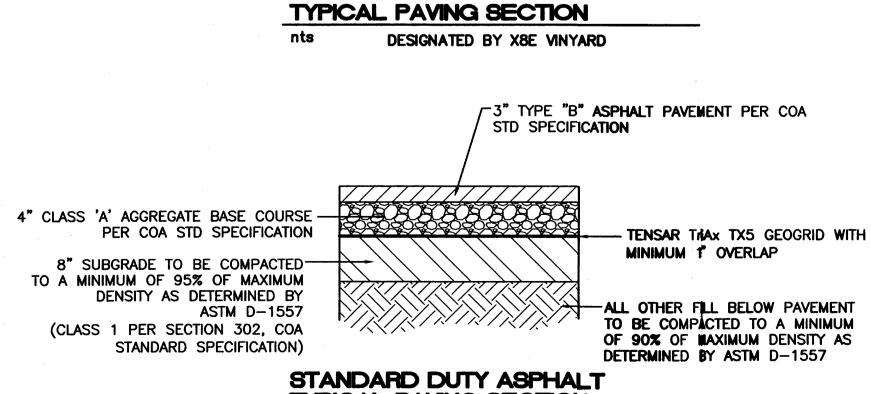



TYPICAL PAVING SECTION

DESIGNATED BY X8E VINYARD

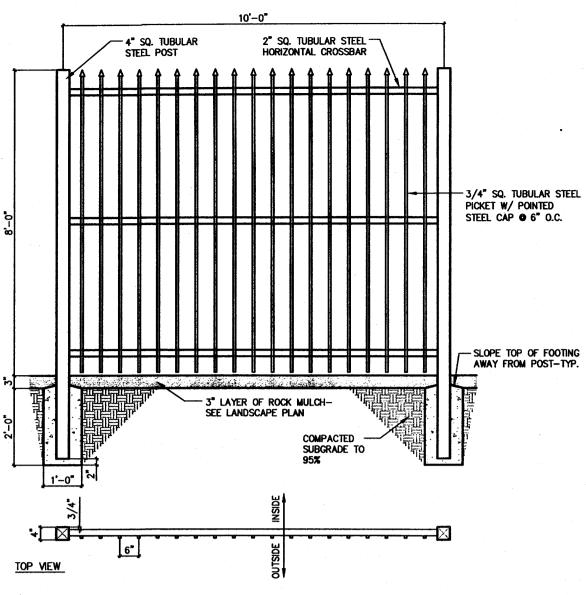

TUBULAR FENCE DETAIL

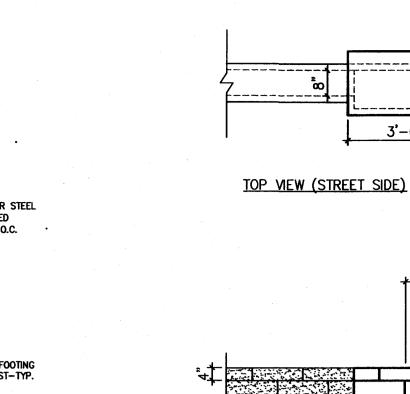

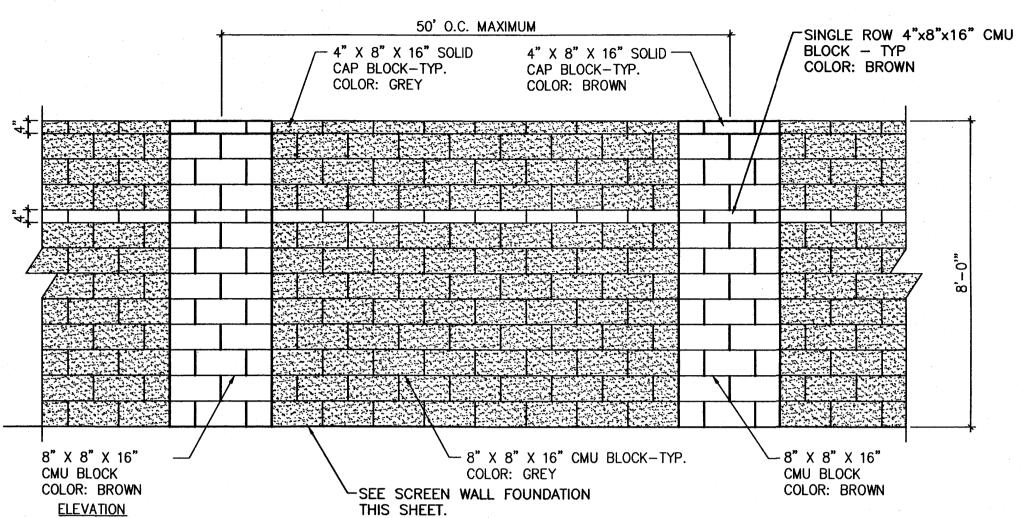


CMU SCREEN WALL DETAIL


GENERAL NOTES:

ALL CONCRETE IS TO BE 3000 PSI @ 28 DAYS. MINIMUM COMPACTION UNDER FOOTINGS IS TO BE 95% PER ASTM. D 1557 FOR A DEPTH OF 12" MOISTURE CONTENT IS

3'-0"

- TO BE \pm 2.0%. 3. BACK FILL AGAINST WALLS IS TO BE HAND-PLACED AND
- COMPACTED.
- 4. ALL BARS ARE TO BE GRADE 60, ASTM 615. TRUSS TYPE DUR-O-WALL EVERY OTHER COURSE.
- DOWELS SHALL BE AT LEAST EQUAL IN SIZE AND SPACING TO V-BARS, SHALL PROJECT A MINIMUM OF 30 BAR DIA. INTO THE FILLED BLOCK CORES, AND SHALL EXTEND TO THE TOE OF THE FOOTING.
- 7. INSTALL EXPANSION JOINTS ON 20' CENTERS.

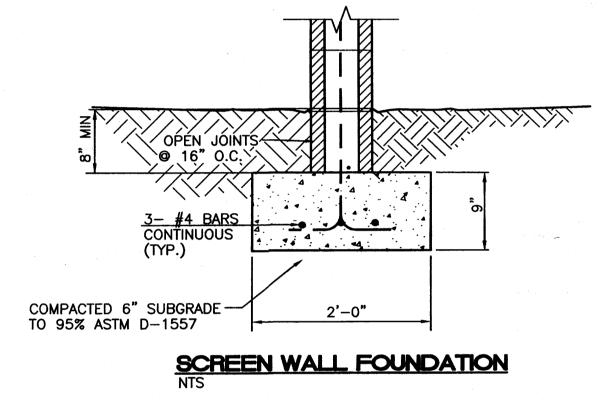

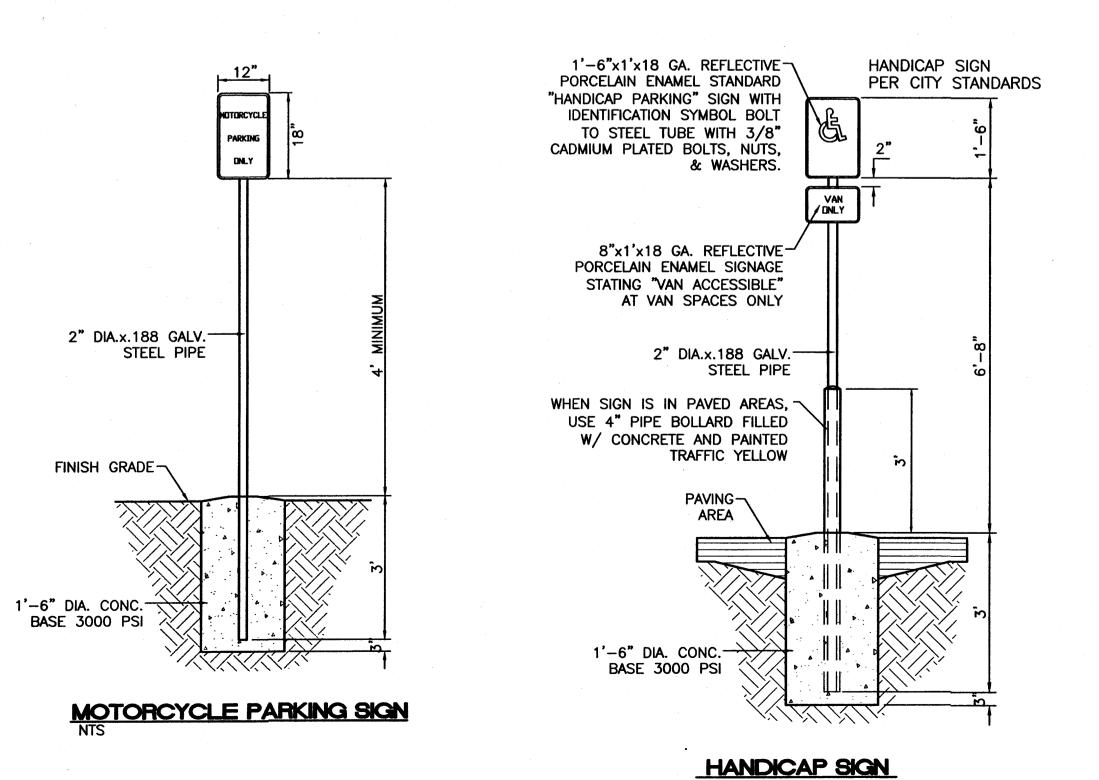



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C4


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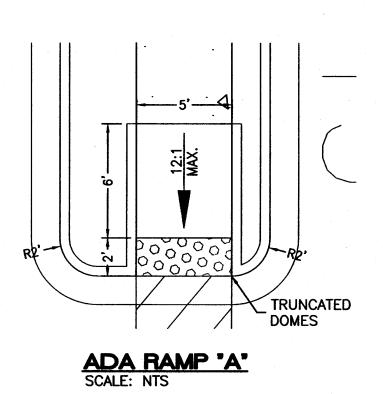
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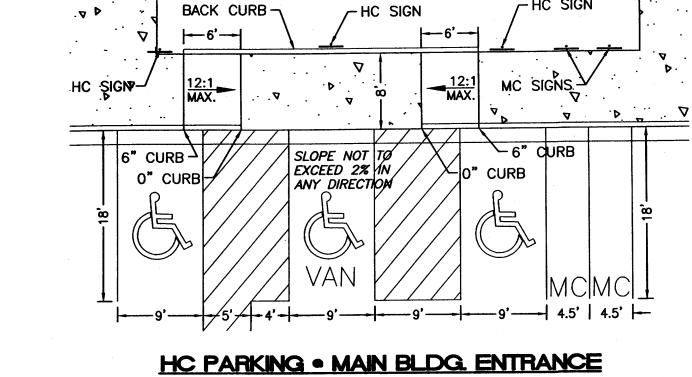
DETAILS


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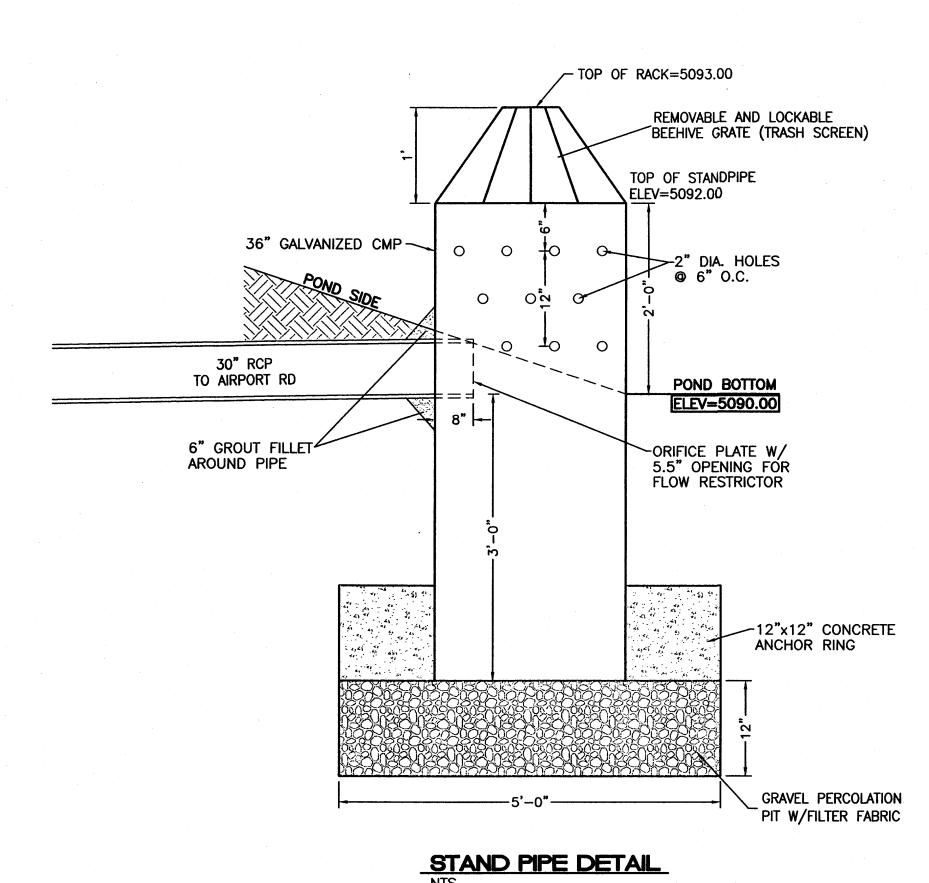
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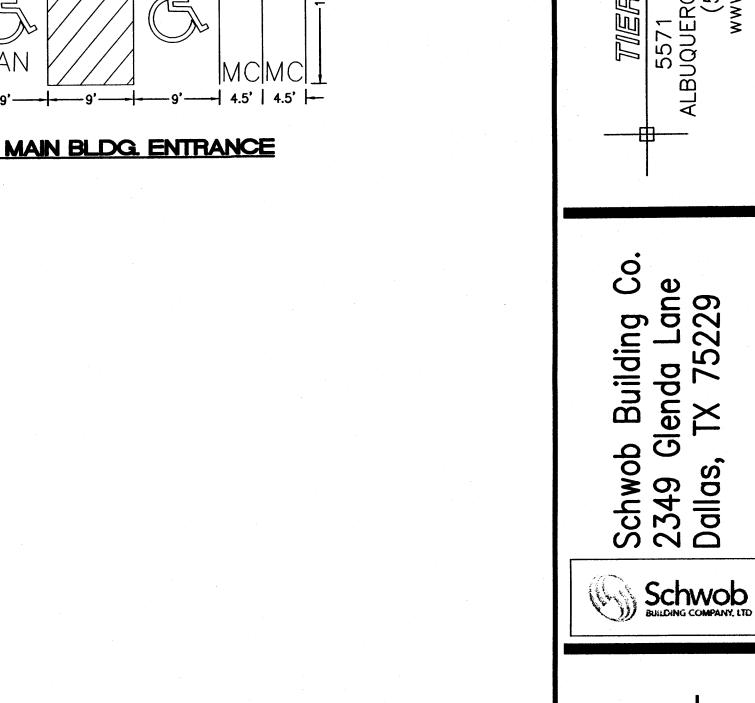









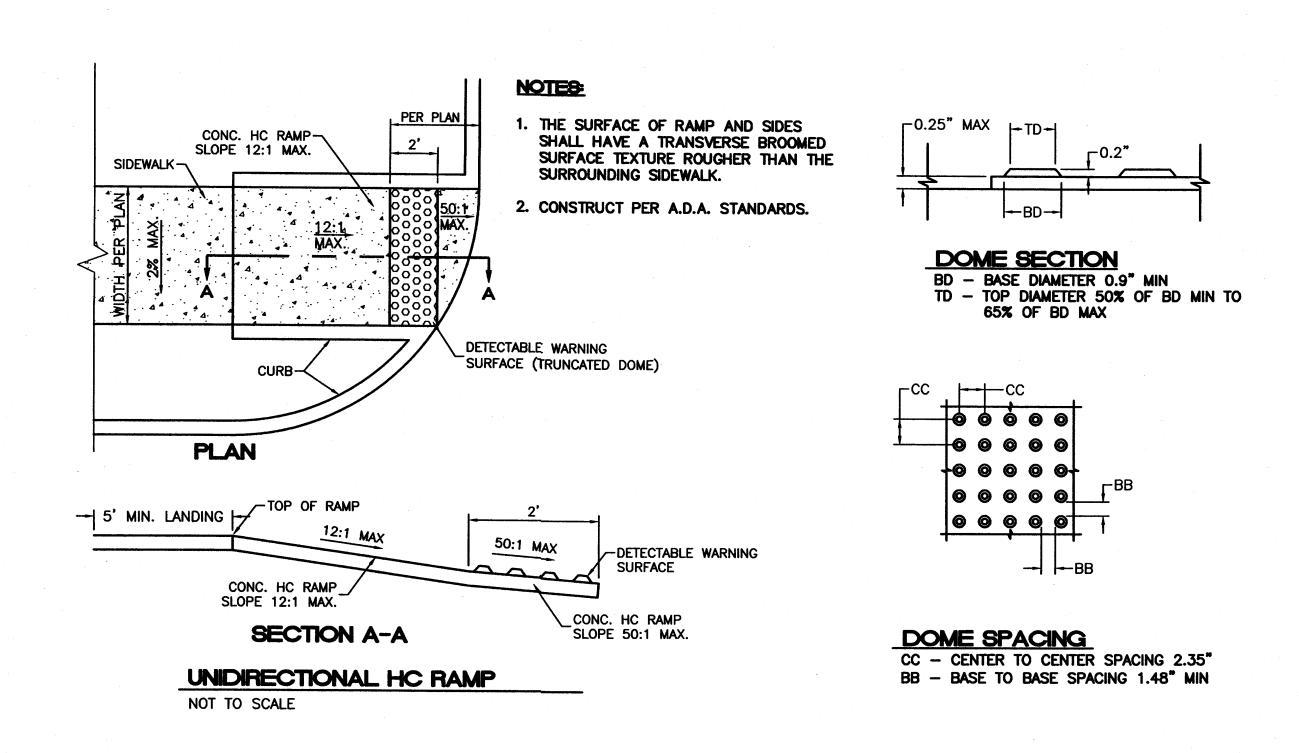

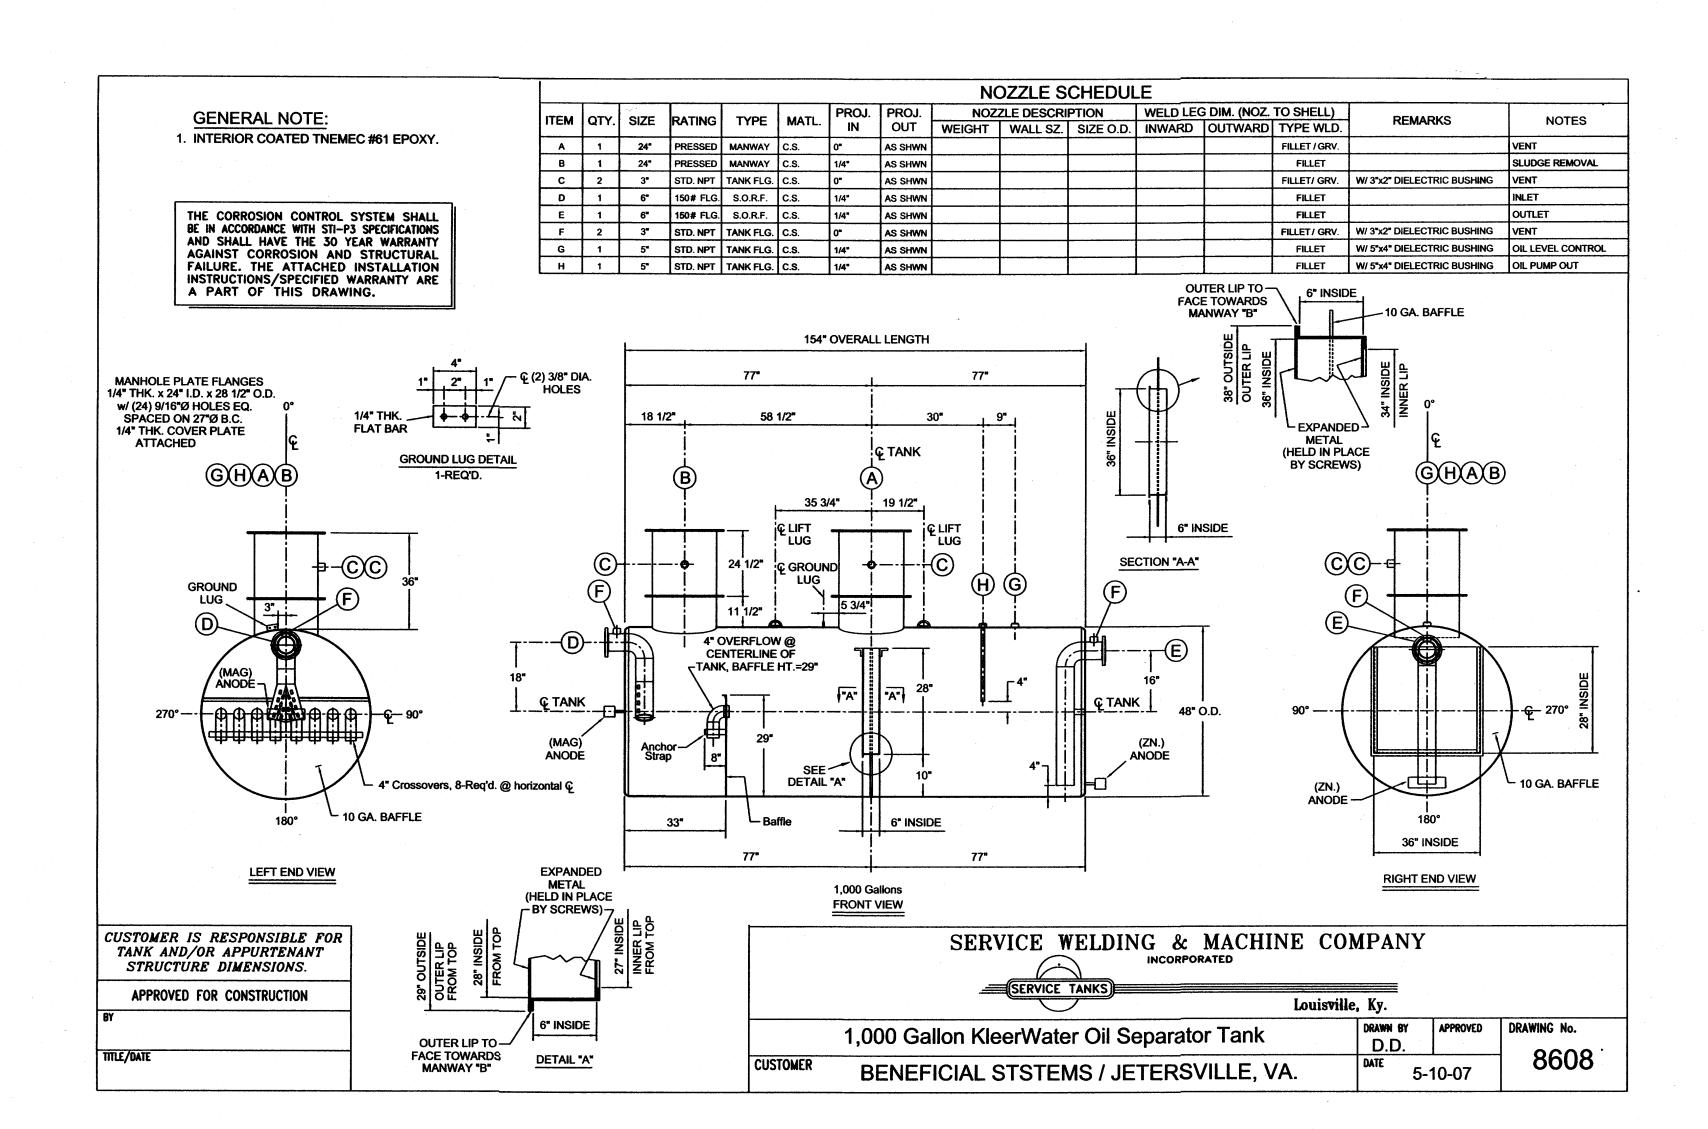

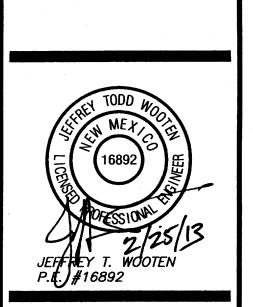

Issue for Permit: xx-xx-xx

OLD DOMINION FREIGHT LINE

330 Airport Rd I Albuquerque, N


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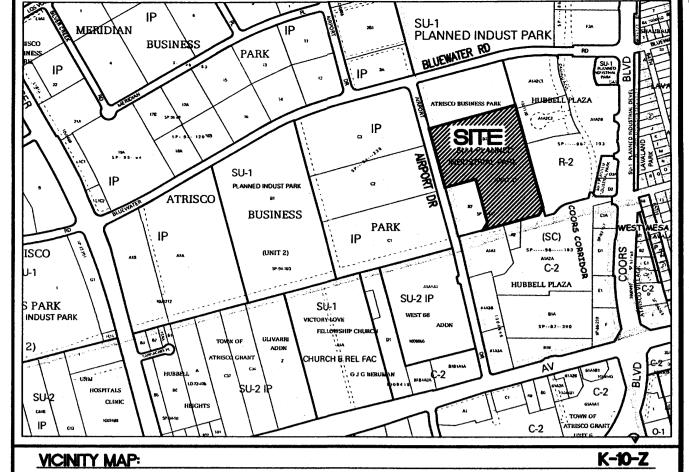
Sheet Name: **DETAILS**

Sheet Number:



CAUTION

ALL EXISTING UTILITIES SHOWN WERE OBTAINED FROM RESEARCH, AS-BUILTS, SURVEYS OR INFORMATION PROVIDED BY OTHERS. IT SHALL BE THE SOLE RESPONSIBILITY OF THE CONTRACTOR TO CONDUCT ALL NECESSARY FIELD INVESTIGATIONS PRIOR TO AND INCLUDING ANY EXCAVATION, TO DETERMINE THE ACTUAL LOCATION OF UTILITIES AND OTHER IMPROVEMENTS, PRIOR TO STARTING THE WORK. ANY CHANGES FROM THIS PLAN SHALL BE COORDINATED WITH AND APPROVED BY THE

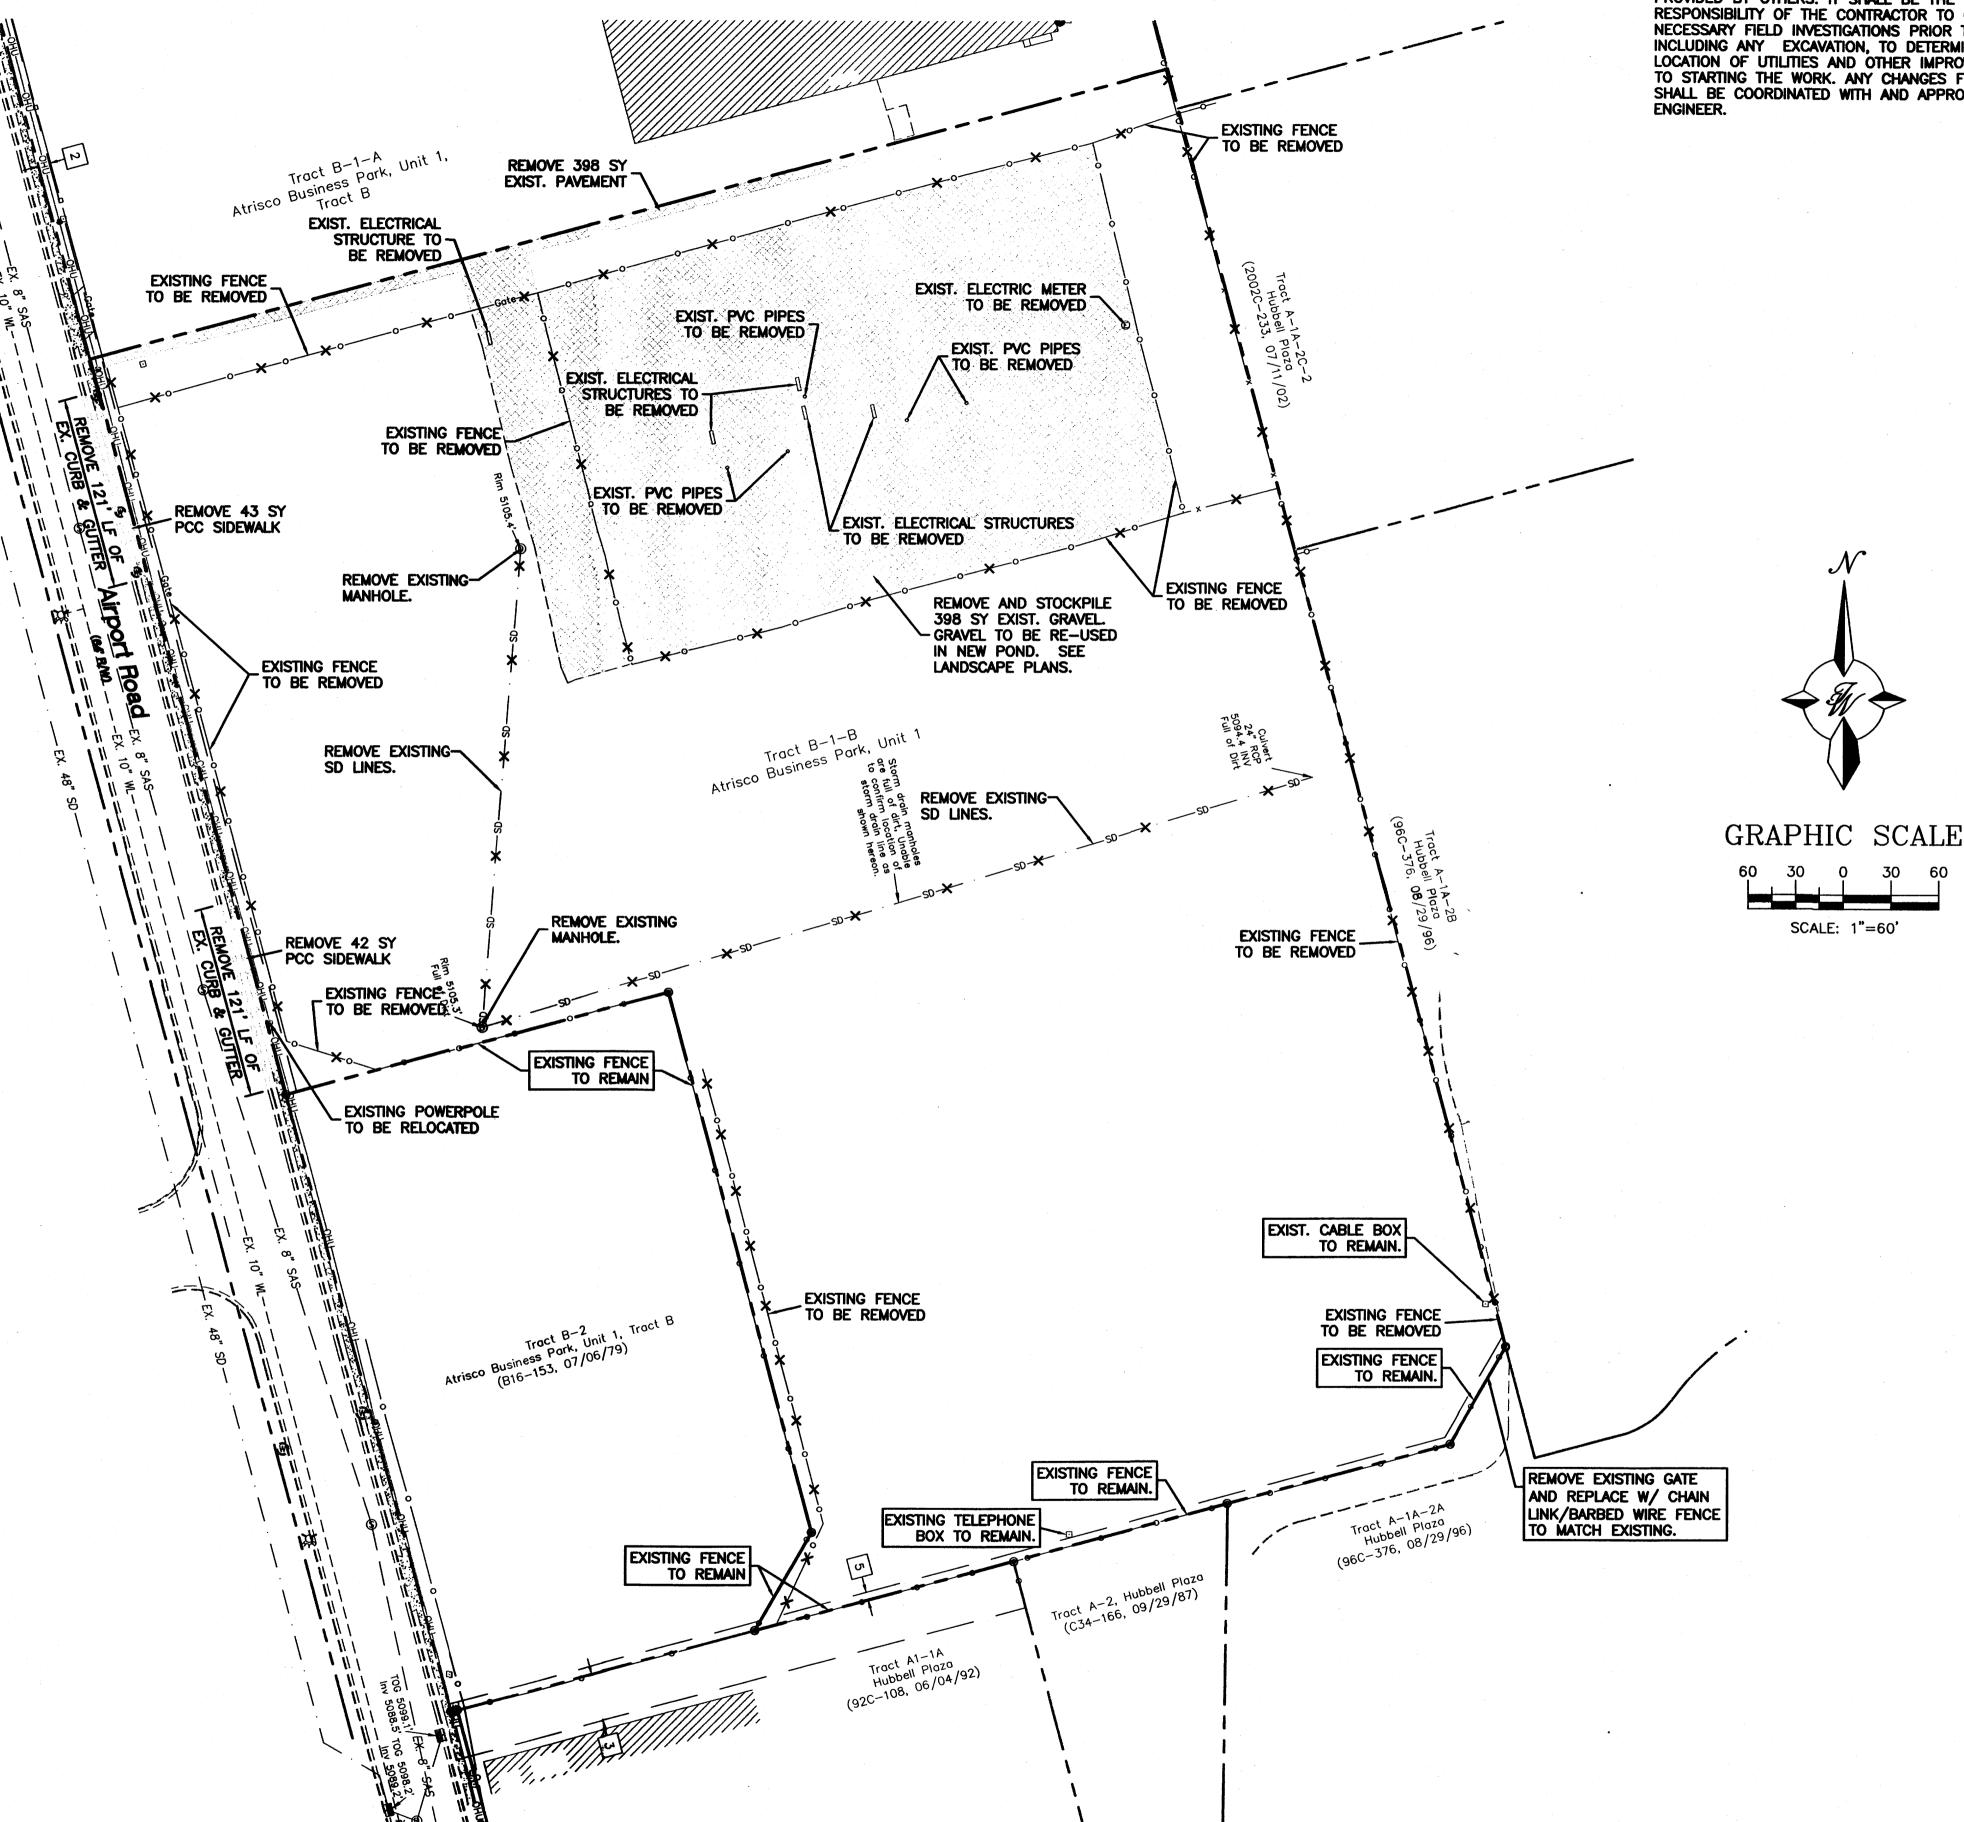

Legend

N 90°00'00" E	MEASURED BEARING AND DISTANCE RECORD INFO PER PLAT OF RECO
(N 90°00'00" E)	(B16–153, 07/06/79)
•	FOUND MONUMENT AS INDICATED
0	SET BATHEY MARKER WITH CAP"LS 14271"
**	FIRE HYDRANT
-OHU-	OVERHEAD UTILITY LINES
•	UTILITY POLE
 0 	CHAINLINK FENCE
	UTILITY PEDESTAL
	GUY WIRE
	SIGN
@	WATER METER
•	GAS METER
©	ELECTRIC METER
T	TRANSFORMER
(STORM DRAIN MANHOLE
Religion	STORM DRAIN INLET
•	TELEPHONE MANHOLE
—— ОНИ —— ——	EXISTING OVERHEAD UTILITIES
— — EX. UGE — — —	EXISTING UNDERGROUND UTILITIES
EX. 2" GAS	EXISTING GAS
— — EX. 8" SAS— —	EXISTING SANITARY SEWER LINE
— — —EX. 10" WL— — —	EXISTING WATER LINE

--- SD --- EXISTING STORM SEWER LINE

Notes

- 1. FIELD SURVEY PERFORMED IN DECEMBER 2012.
- 2. ALL DISTANCES ARE GROUND DISTANCES: U.S. SURVEY FOOT.
- 3. THE BASIS OF BEARINGS REFERENCES NEW MEXICO STATE PLANE COORDINATES (NAD 83-GRID).
- 4. PVC PIPES AS SHOWN HEREON MAY HAVE BEEN USED PREVIOUSLY FOR WATERLINE OR ELECTRICAL CONDUIT.
- 5. ALL EXISTING ONSITE IMPROVEMENTS (INCLUDING LANDSCAPING & PLANTINGS) WITHIN THE LIMITS OF ONSITE DEMOLITION SHALL BE REMOVED AND PROPERLY DISPOSED OF BY THE CONTRACTOR UNLESS OTHERWISE NOTED.
- 6. REFERENCE OFF-SITE IMPROVEMENT PLAN SHEETS FOR ADDITIONAL REMOVALS NOT COVERED BY THIS ON-SITE DEMOLITION PLAN.
- 7. ALL WEATHER ACCESS TO EXISTING BUSINESSES WITHIN THE CENTER SHALL BE MAINTAINED AT ALL TIMES. THE CONTRACTOR SHALL COORDINATE WITH THE EXISTING BUSINESS OWNERS PRIOR TO REMOVALS THAT DIRECTLY AFFECT THEIR PROPERTY OR ACCESS TO THEIR BUSINESS.
- 8. UNDER GROUND UTILITIES MAY EXIST WHERE NONE ARE SHOWN. THE LOCATIONS OF UNDERGROUND UTILITIES SHOWN ARE BASED ON AS-BUILT INFORMATION. EXACT LOCATIONS SHALL BE VERIFIED BY THE CONTRACTOR.
- 9. IT IS RECOMMENDED THAT THE CONTRACTOR VISIT THE SITE PRIOR TO SUBMITTING A BID TO FAMILIARIZE THEMSELVES WITH ALL EXISTING CONDITIONS.
- 10. EXISTING SILT FENCE NOT SHOWN FOR CLARITY
- 11. EXISTING ON-SITE POWER POLES & GUY WIRES TO REMAIN UNLESS OTHERWISE NOTED.


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0 ob Building Co Glenda Lane 3, TX 75229 Ö Buildin Schwol 2349 Dallas,



OMINIO HT LINE OLD DOI FREIGHT 330 Airport Ro

Issue for Permit: xx-xx-xx

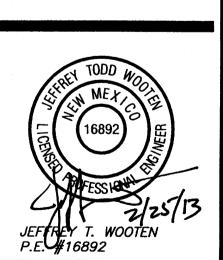



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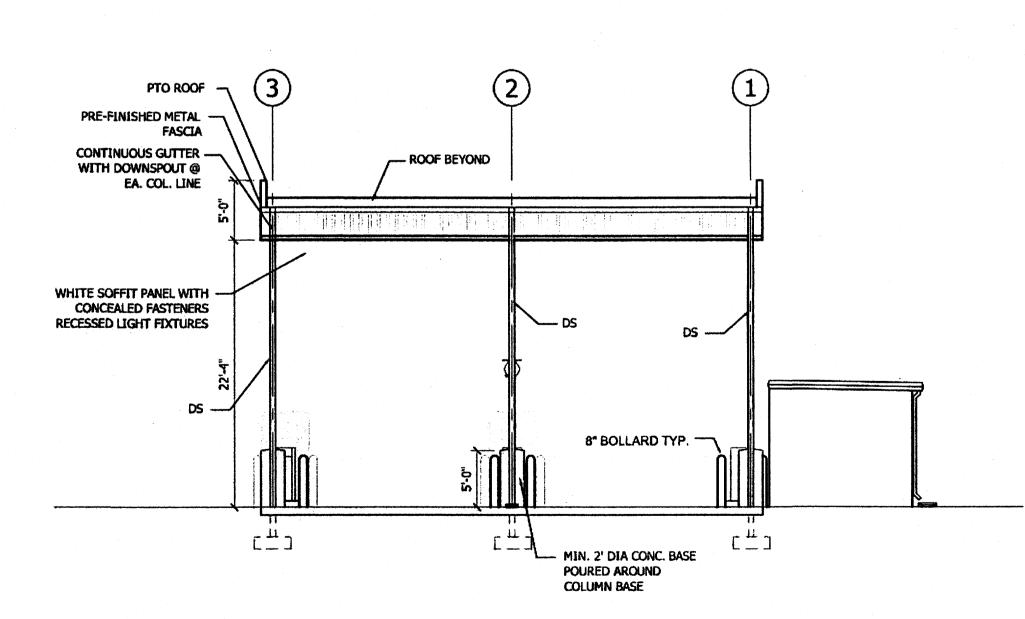
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Sheet Name: DEMOLITION PLAN







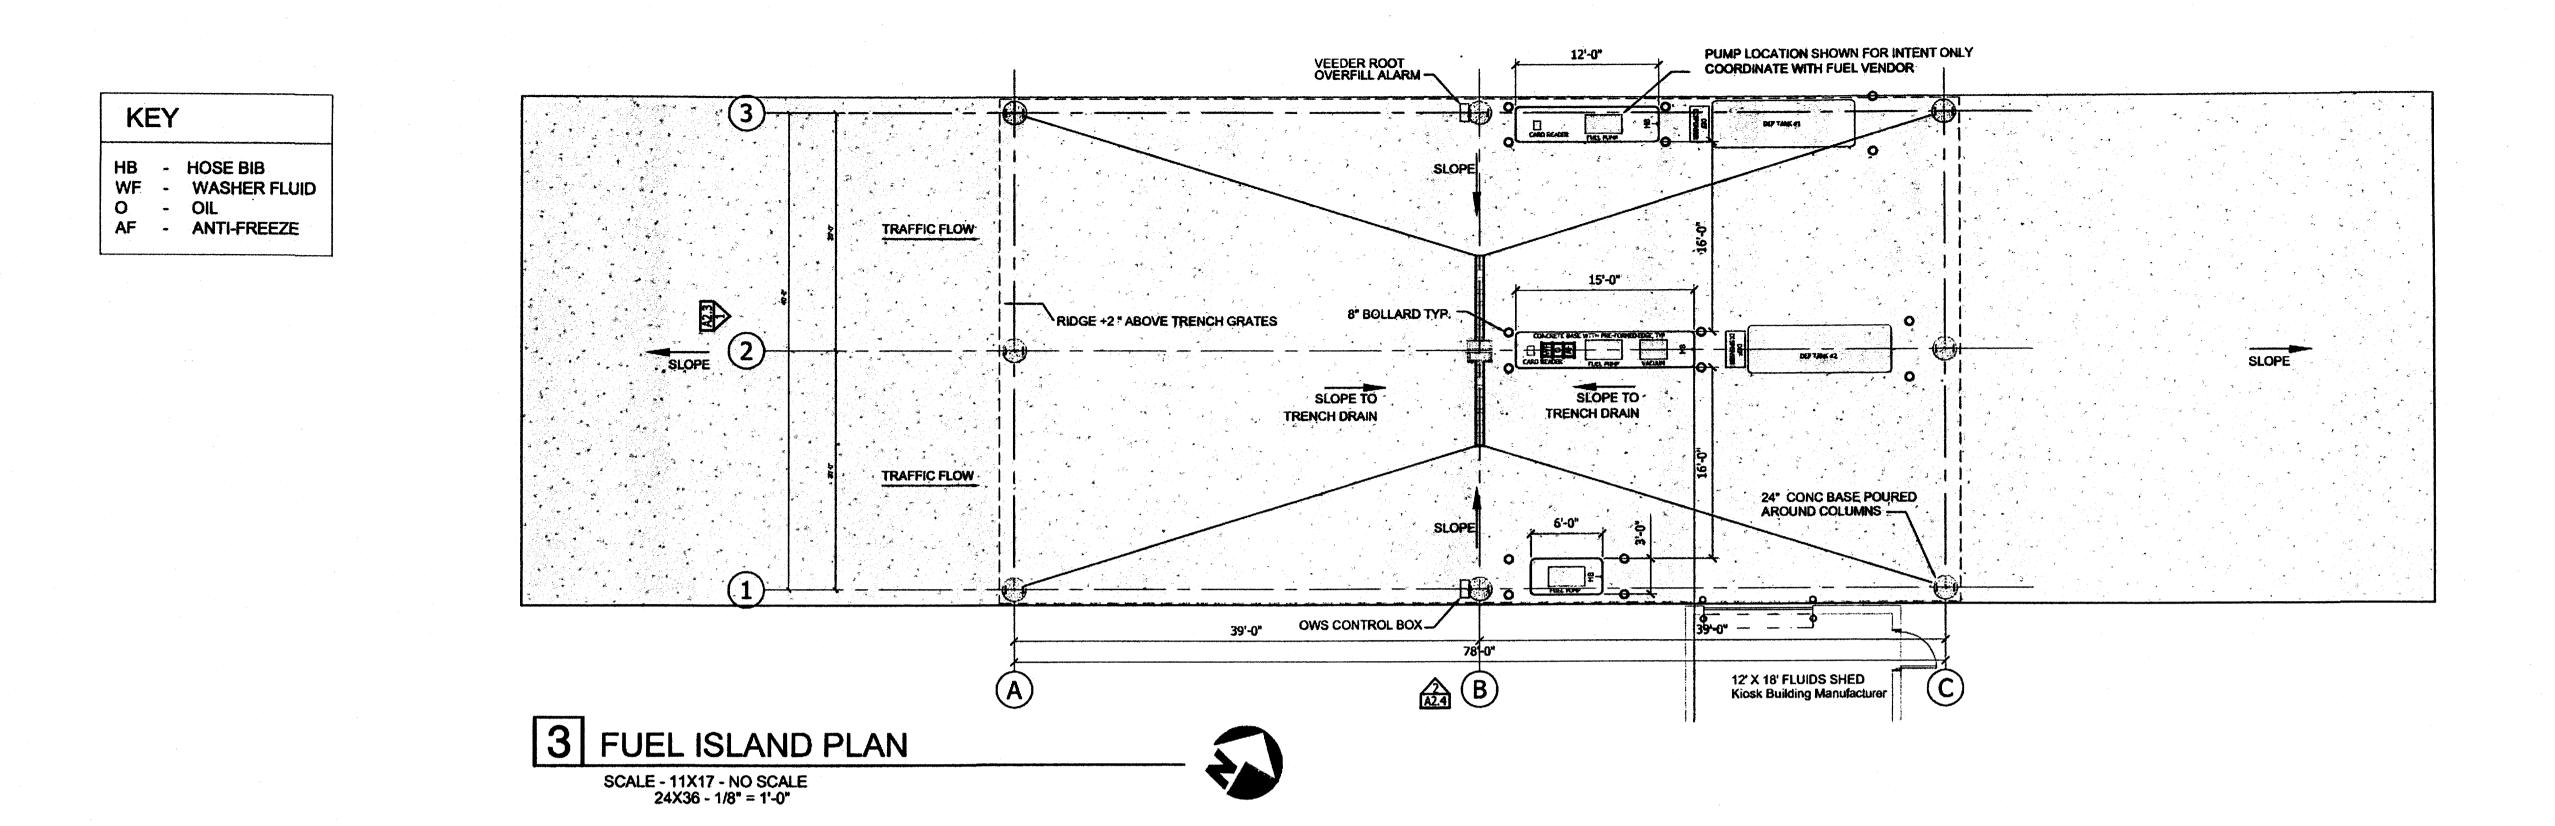

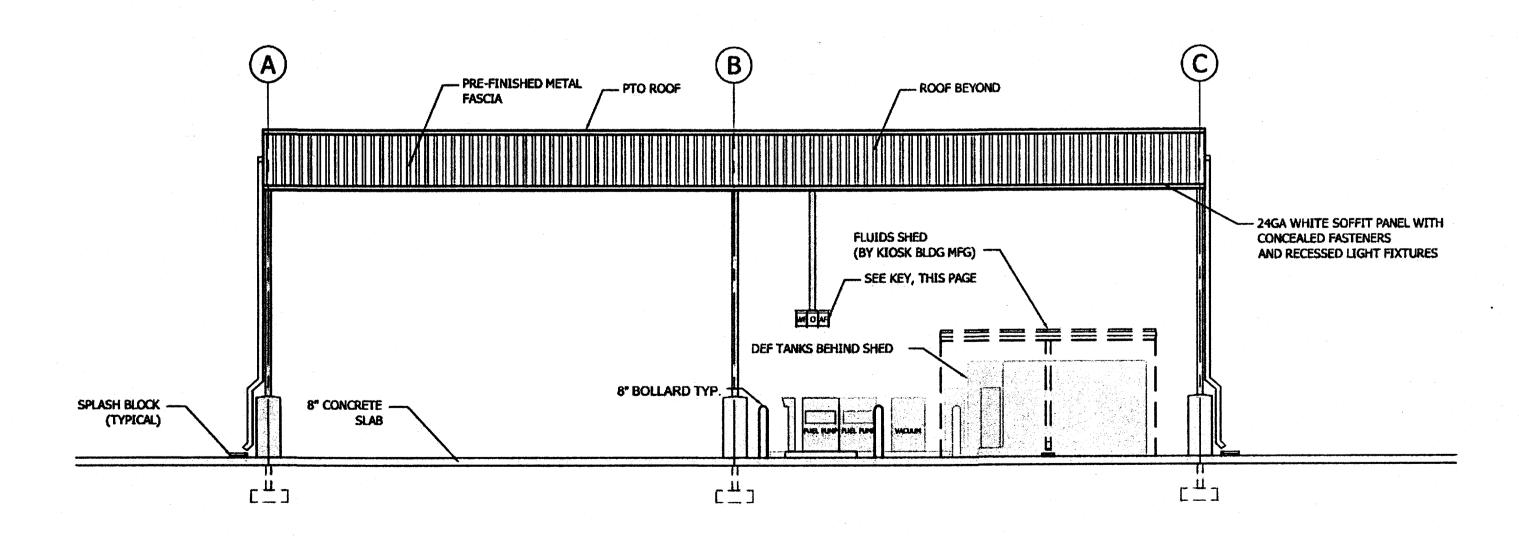1 END ELEVATION

SCALE - 11X17 - NO SCALE
24X36 - 1/8" = 1'-0"

1 44




PREIMINARY TORY
OF PERMITTING
APPROVAL STRUCTION
APPROVAL ON STRUCTION

NM LICENSE #005181 EXP 12-31-2013 Architect: David J. Mollenkopf

> Schwob Building Co. 2349 Glenda Lane Dallas, TX 75229



A NEW TERMINAL FOR:
OLD DOMINION
FREIGHT LINE
330 Airport Road NW
Albuquerque, NM 87121

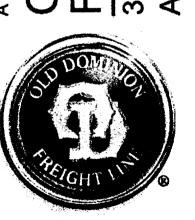

100% Check Set: 02-22-13

ODFL Albuquerque, NM - ABC


Project No.


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Sheet Name: Fuel Island

Sheet Number:

A2.4



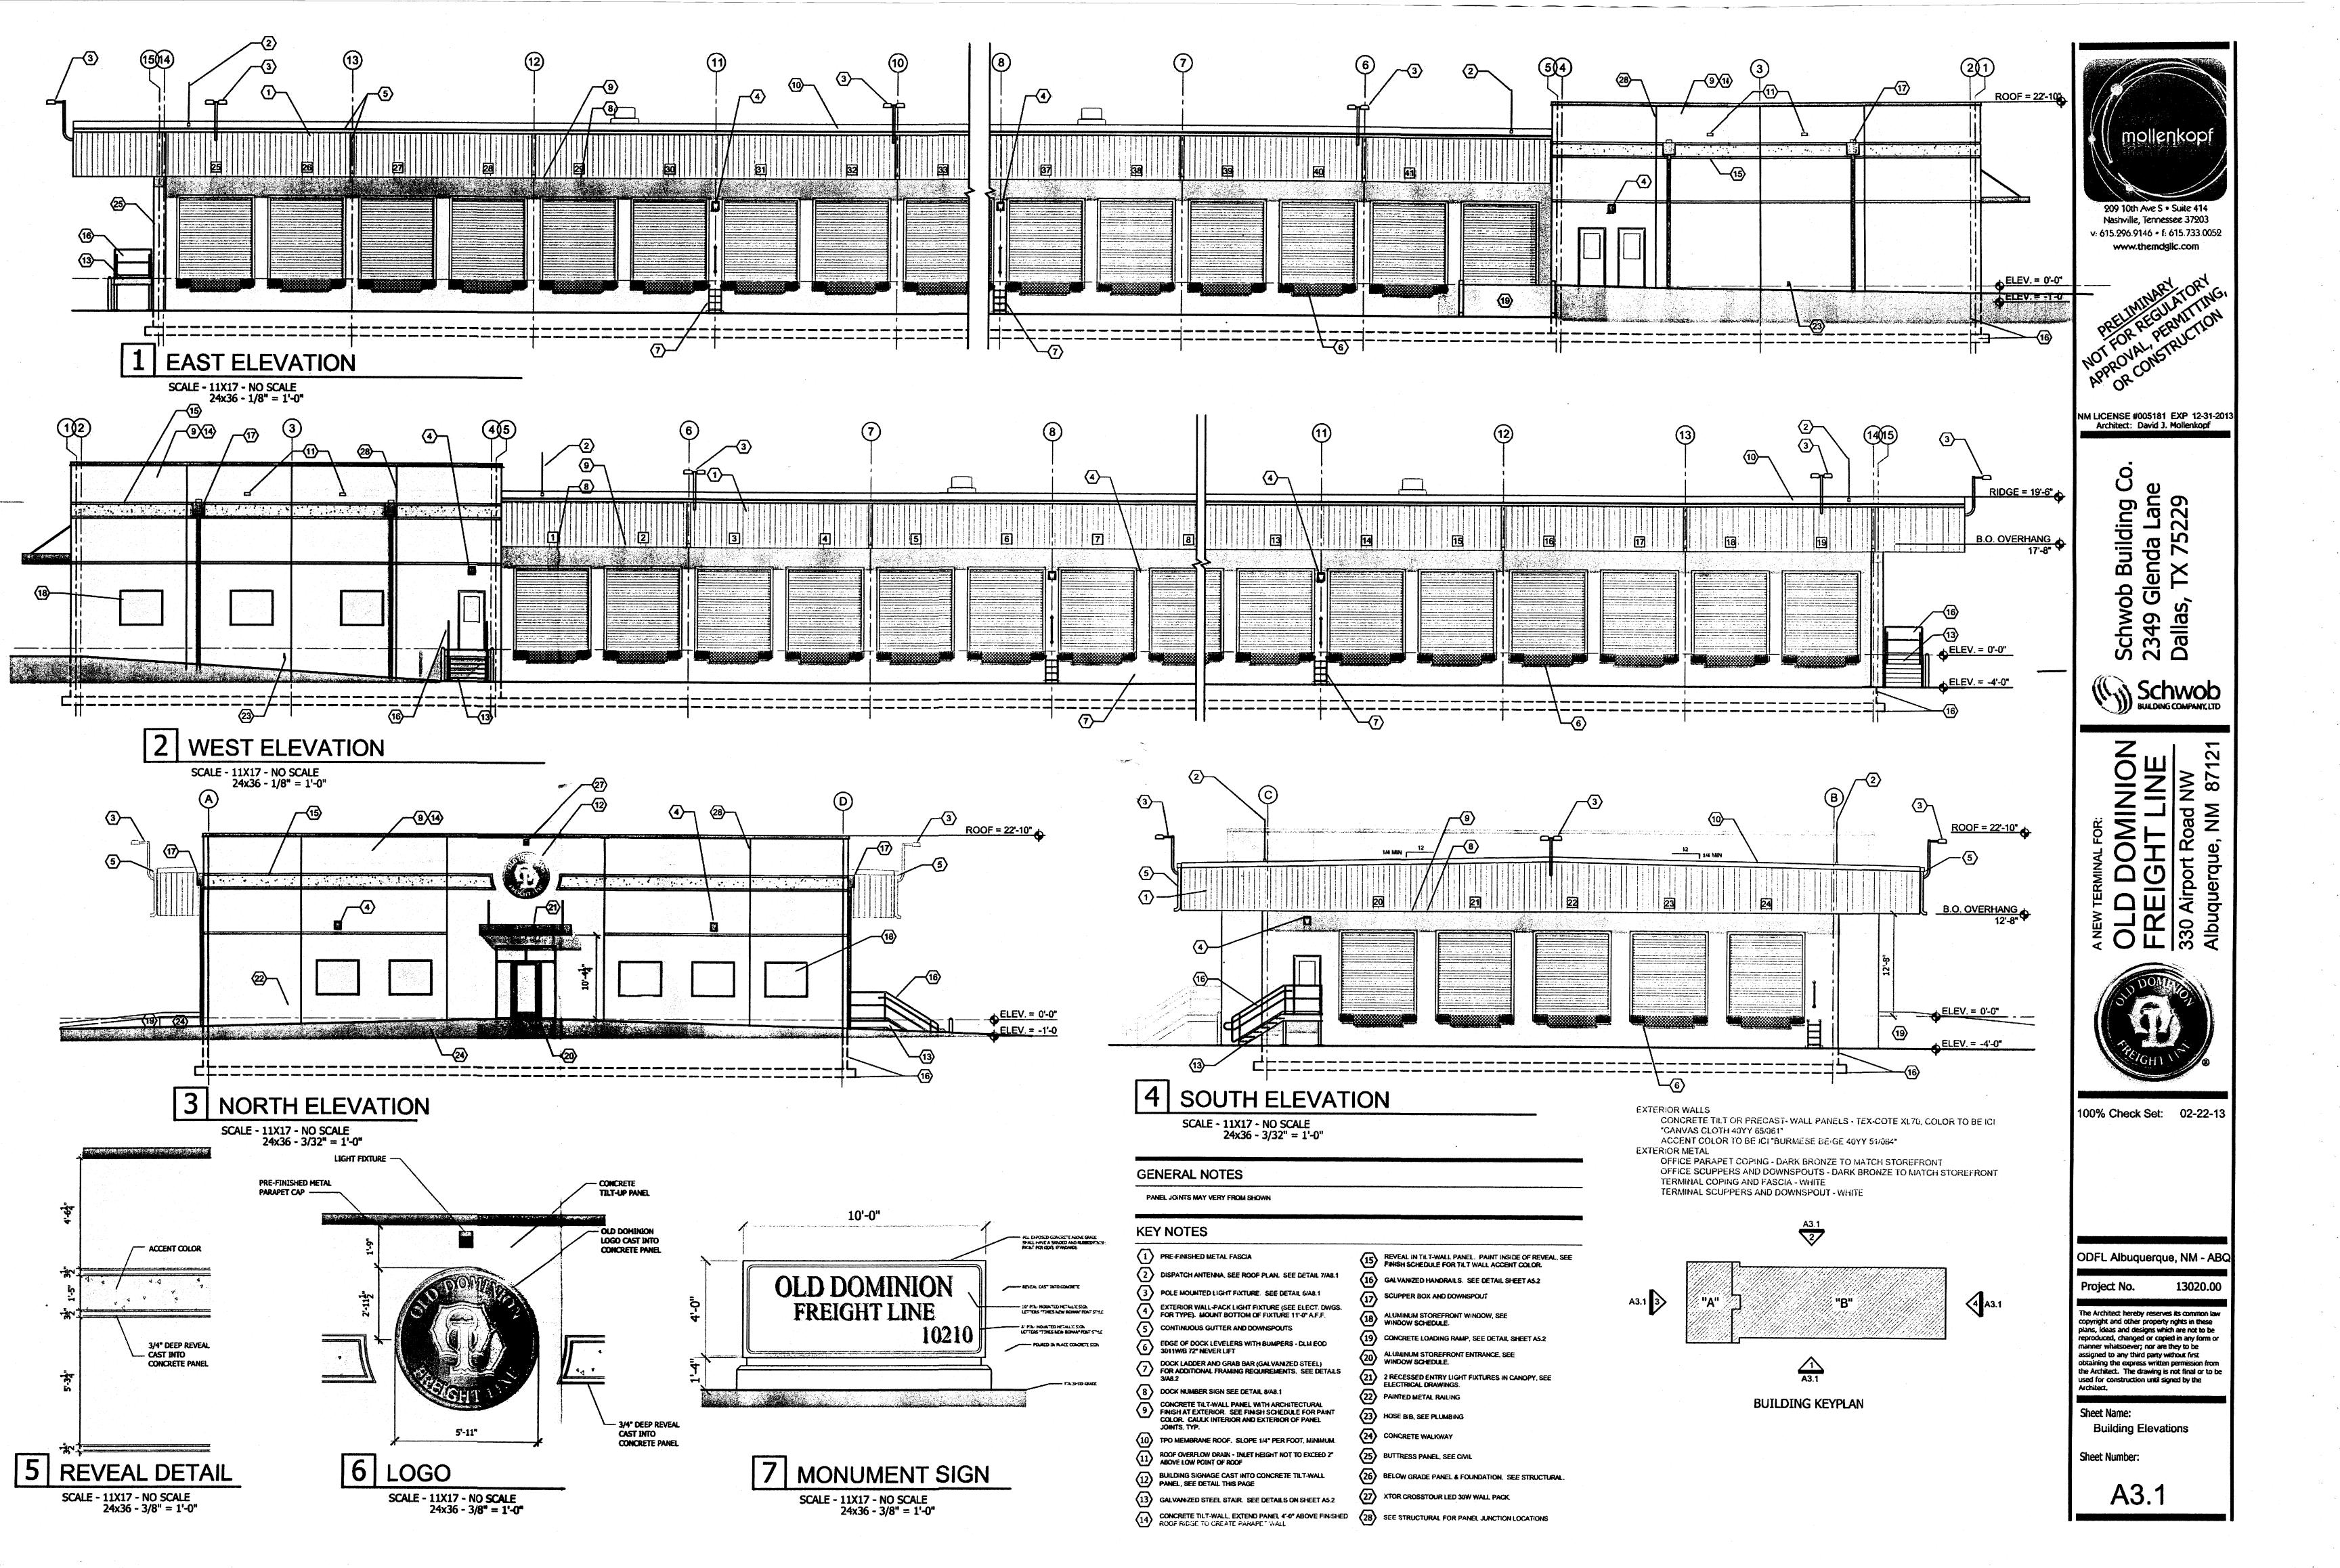

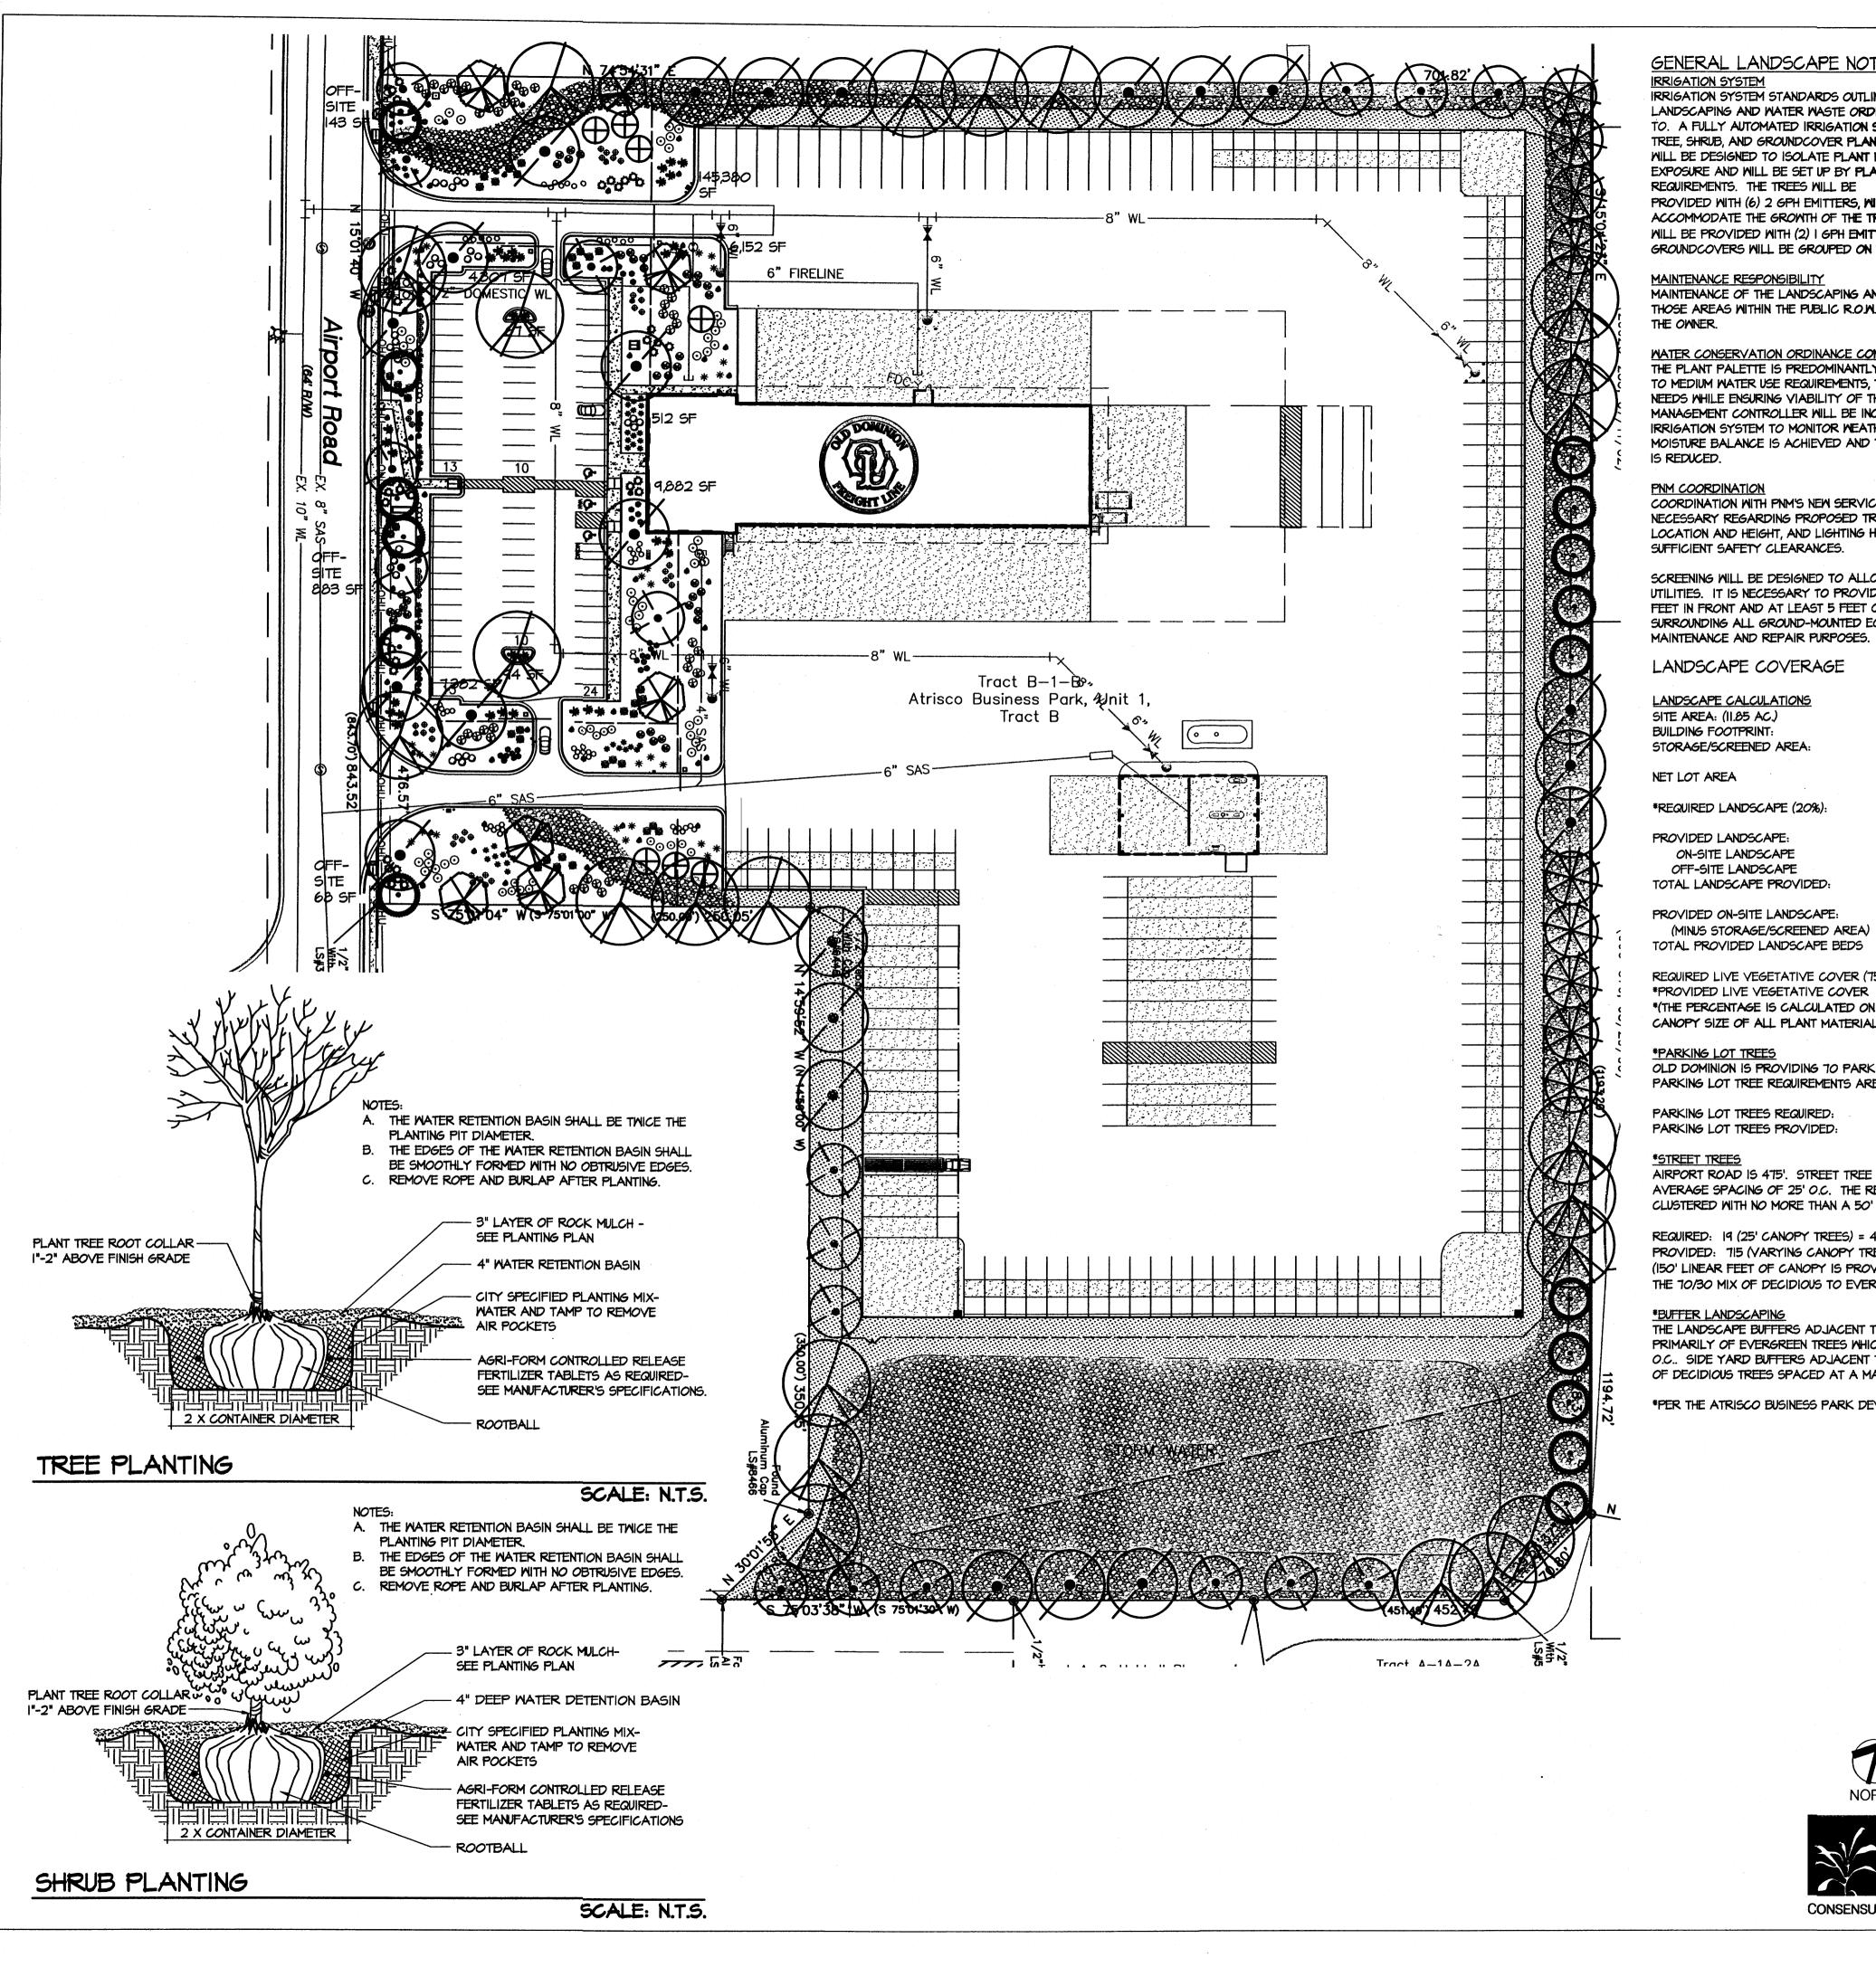GENERAL LANDSCAPE NOTES

IRRIGATION SYSTEM

IRRIGATION SYSTEM STANDARDS OUTLINED IN THE WATER CONSERVATION LANDSCAPING AND WATER WASTE ORDINANCE SHALL BE STRICTLY ADHERED TO. A FULLY AUTOMATED IRRIGATION SYSTEM WILL BE USED TO IRRIGATE TREE, SHRUB, AND GROUNDCOVER PLANTING AREAS. THE IRRIGATION SYSTEM WILL BE DESIGNED TO ISOLATE PLANT MATERIAL ACCORDING TO SOLAR EXPOSURE AND WILL BE SET UP BY PLANT ZONES ACCORDING TO WATER REQUIREMENTS. THE TREES WILL BE

PROVIDED WITH (6) 2 GPH EMITTERS, WITH THE ABILITY TO BE EXPANDED TO ACCOMMODATE THE GROWTH OF THE TREE. SHRUBS AND GROUNDCOVERS WILL BE PROVIDED WITH (2) I GPH EMITTERS. TREES, SHRUBS AND GROUNDCOVERS WILL BE GROUPED ON THE SAME VALVE.

MAINTENANCE RESPONSIBILITY

MAINTENANCE OF THE LANDSCAPING AND IRRIGATION SYSTEM, INCLUDING THOSE AREAS WITHIN THE PUBLIC R.O.M., SHALL BE THE RESPONSIBILITY OF

MATER CONSERVATION ORDINANCE COMPLIANCE

THE PLANT PALETTE IS PREDOMINANTLY COMPRISED OF PLANTS WITH LOW TO MEDIUM WATER USE REQUIREMENTS, THEREBY MINIMIZING IRRIGATION NEEDS WHILE ENSURING VIABILITY OF THE PLANTS. AN EVAPOTRANSPIRATION MANAGEMENT CONTROLLER WILL BE INCLUDED IN THE DESIGN OF THE IRRIGATION SYSTEM TO MONITOR WEATHER CONDITIONS SO THAT OPTIMUM MOISTURE BALANCE IS ACHIEVED AND THE POSSIBILITY OF OVER-WATERING

COORDINATION WITH PNM'S NEW SERVICE DELIVERY DEPARTMENT IS NECESSARY REGARDING PROPOSED TREE LOCATION AND HEIGHT, SIGN LOCATION AND HEIGHT, AND LIGHTING HEIGHT IN ORDER TO ENSURE SUFFICIENT SAFETY CLEARANCES.

SCREENING WILL BE DESIGNED TO ALLOW FOR ACCESS TO ELECTRIC UTILITIES. IT IS NECESSARY TO PROVIDE ADEQUATE CLEARANCE OF TEN FEET IN FRONT AND AT LEAST 5 FEET ON THE REMAINING THREE SIDES SURROUNDING ALL GROUND-MOUNTED EQUIPMENT FOR SAFE OPERATION,

LANDSCAPE COVERAGE

LANDSCAPE CALCULATIONS

516,176 SF SITE AREA: (II.85 AC.) BUILDING FOOTPRINT: 19,813 SF STORAGE/SCREENED AREA: -419,661 SF NET LOT AREA 76,702 SF *REQUIRED LANDSCAPE (20%): 15,340 SF

PROVIDED LANDSCAPE:

(35%) 173,776 SF ON-SITE LANDSCAPE OFF-SITE LANDSCAPE 1,094 SF TOTAL LANDSCAPE PROVIDED: 174,870 SF 173,776 SF

TOTAL PROVIDED LANDSCAPE BEDS REQUIRED LIVE VEGETATIVE COVER (75%)

*PROVIDED LIVE VEGETATIVE COVER *(THE PERCENTAGE IS CALCULATED ON THE MATURE CANOPY SIZE OF ALL PLANT MATERIALS)

*PARKING LOT TREES

OLD DOMINION IS PROVIDING TO PARKING SPACES IN INITIAL DEVELOPMENT. PARKING LOT TREE REQUIREMENTS ARE BASED UPON I TREE PER 10 SPACES.

- 136,222 SF

37,554 SF

28,166 SF

50,233 SF

PARKING LOT TREES REQUIRED: PARKING LOT TREES PROVIDED:


AIRPORT ROAD IS 475'. STREET TREE REQUIREMENTS ARE BASED ON AN AVERAGE SPACING OF 25' O.C. THE REQUIRED TREES ARE INFORMALLY CLUSTERED WITH NO MORE THAN A 50' GAP BETWEEN GROUPINGS.

REQUIRED: 19 (25' CANOPY TREES) = 475' LF OF TREE CANOPY PROVIDED: 715 (VARYING CANOPY TREES) = 490' LF OF TREE CANOPY (150' LINEAR FEET OF CANOPY IS PROVIDED BY EVERGREEN TREES; MEETING THE 70/30 MIX OF DECIDIOUS TO EVERGREEN TREE REQUIREMENT.)

*BUFFER LANDSCAPING

THE LANDSCAPE BUFFERS ADJACENT TO RESIDENTIAL PROPERTIES CONSISTS PRIMARILY OF EVERGREEN TREES WHICH ARE SPACET AT A MAXIMUM OF 30' O.C.. SIDE YARD BUFFERS ADJACENT TO INDUSTRIAL PROPERTIES CONSISTS OF DECIDIOUS TREES SPACED AT A MAXIMUM OF 40' O.C.


*PER THE ATRISCO BUSINESS PARK DEVELOPMENT LANDSCAPE STANDARDS

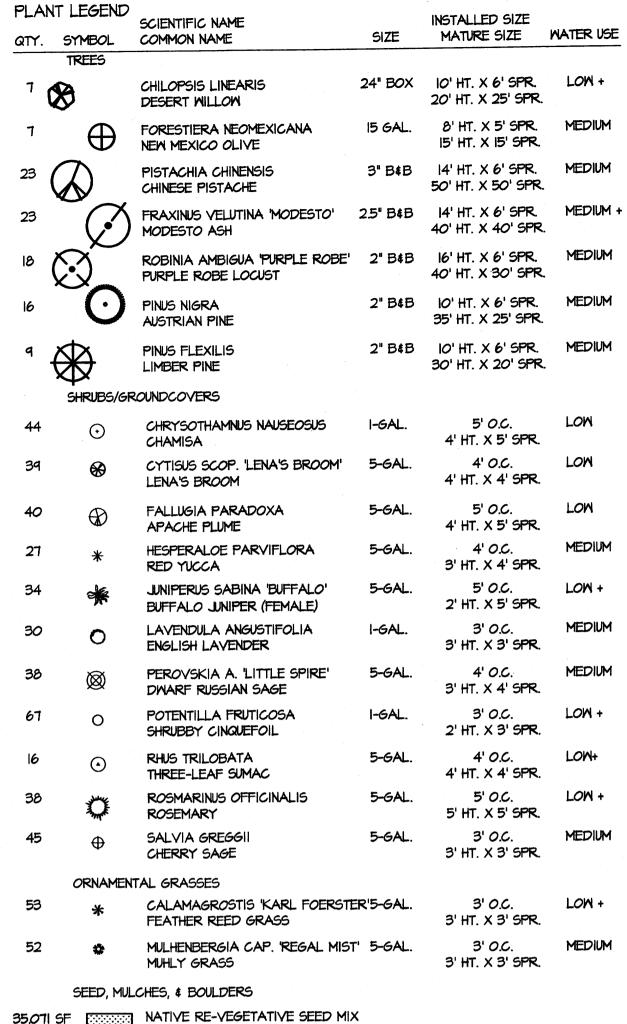

2"-4" BUILDOLOGY BROWN COBBLE MULCH (6" DEPTH OVER DEWITT PRO-5 WEED CONTROL FABRIC)

I" SANTA FE BROWN GRAVEL MULCH

(3" DEPTH OVER DEWITT PRO-5 WEED CONTROL FABRIC) ₩ MOSS ROCK BOULDERS (3'X3' MINIMUM)

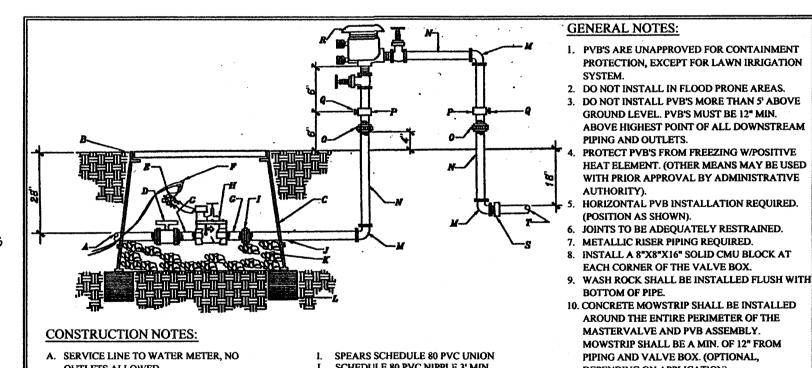

- **OUTLETS ALLOWED**
- B. FINISH GRADE, MATERIAL VARIES REFERENCE PLANS BROOK PRODUCTS INC., 1730 PB-18 BODY (ABS) VALVE BOX W/BOLT
- DOWN COVER (ABS) AND ONE 8" EXTENSION D. SPEARS TRUE UNION SCHEDULE 80 PVC BALL VALVE
- E. 24" WIRE EXPANSION COIL F. 3M SKOTCH LOK G. SCHEDULE 80 PVC 4" NIPPLE H. ELECTRIC VALVE (REFERENCE DRAWINGS FOR SIZE)


SCHEDULE 80 PVC NIPPLE 3' MIN. 1" DIAMETER WASHED ROCK 8"X8"X16" SOLID CMU BLOCK

. GALVANIZED ELL N. GALVANIZED NIPPLE O. GALVANIZED UNION (MIN. 4" ABOVE P. GALVANIZED TEE D. BALL DRAIN, CHAMPION DV050 1/2"

R. PVB BACKFLOW PREVENTER (REFERENCE DRAWINGS) NON-CONSTANT PRESSURE IRRIGATION MAINLINE


AROUND THE ENTIRE PERIMETER OF THE MASTERVALVE AND PVB ASSEMBLY. MOWSTRIP SHALL BE A MIN. OF 12" FROM PIPING AND VALVE BOX. (OPTIONAL, DEPENDING ON APPLICATION).

> CITY OF ALBUQUERQUE LANDSCAPE 3/92 12/92 MASTER VALVE W/ PVB DWG. 2702 JAN. 1991

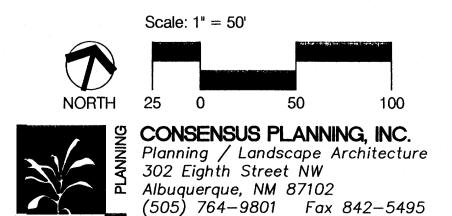

e-mail: cp@consensusplanning.com

ENGINEER'S SEAL	OLD DOMINION ALBUQUERQUE, NM	DRAWN BY GS
	PLANTING	<i>DATE</i> 2-26-13
	PLAN	DRAWING NO 2013002-SPB
		SHEET #
	TIERRA WEST, LLC 5571 MIDWAY PARK PL NE ALBUQUERQUE, NEW MEXICO 87109	LS-3
ONALD R. BOHANNAN .E. #7868	(505) 858-3100 www.tierrawestllc.com	<i>JOB #</i> 2012006

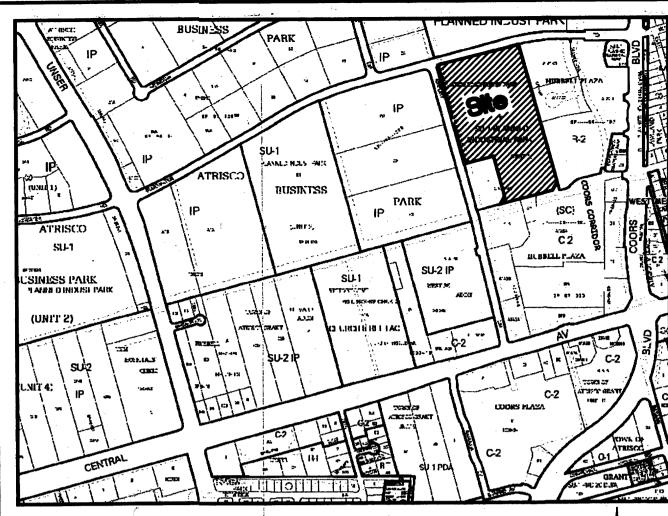

Vicinity Map Zone Atlas K-10-Z

Purpose of Plat

- 1. SUBDIVIDE AS SHOWN HEREON
- 2. GRANT EASEMENTS AS SHOWN HEREON.
 3. DEDICATE RIGHT OF WAY AS SHOWN HEREON.

Subdivision Data

GROSS ACREAGE	
ZONE ATLAS PAGE NO	
NUMBER OF EXISTING LOTS.	
NUMBER OF LOTS CREATED.	
MILES OF FULL WIDTH STREET	ETS
MILES OF HALF WIDTH STRE	ETS
RIGHT-OF-WAY DEDICATION	TO THE CITY OF ALBUQUERQUE
DATE OF SURVEY	DECEMBER 2012

Free Consent & Dedication

THE SUBDIVISION HEREON DESCRIBED IS WITH THE FREE CONSENT AND IN ACCORDANCE WITH THE DESIRES OF THE UNDERSIGNED OWNER(S) AND/OR PROPRIETOR(S) THEREOF DO HEREBY GRANT THE RIGHT TO CONSTRUCT, OPERATE, INSPECT, MAINTAIN FACILITIES THEREIN; AND ALL PUBLIC UTILITIES EASEMENTS SHOWN HEREON FOR THE COMMON AND JOINT USE OF GAS, ELECTRICAL POWER AND COMMUNICATION SERVICE FOR BURIED DISTRIBUTION LINES, CONDUITS AND PIPES FOR UNDERGROUND UTILITIES WHERE SHOWN OR INDICATED, AND INCLUDING THEIR RIGHT OF INGRESS AND EGRESS FOR CONSTRUCTION AND MAINTENANCE, AND THE RIGHT TO TRIM INTERFERING TREES AND SHRUBS. SAID OWNER(S) AND/OR PROPRIETOR(S) DO HEREBY CONSENT TO ALL OF THE FOREGOING AND DOES HEREBY CERTIFY THAT THIS SUBDIVISION IS THEIR FREE ACT AND DEED. SAID OWNER(S) AND/OR PROPRIETOR(S) WARRANT THAT THEY HOLD AMONG THEM COMPLETE AND INDEFEASIBLE TITLE IN FEE SIMPLE TO THE LAND SUBDIVIDED. SAID OWNER(S) AND/OR PROPRIETOR(S) DO HEREBY DEDICATE ADDITIONAL PUBLIC RIGHT OF WAY SHOWN HEREON TO THE CITY OF ALBUQUERQUE IN FEE SIMPLE WITH WARRANTY COVENANTS.

MIKE REID, VICE PRESIDENT

12/21/12 DATE

PRO BUILD REAL ESTATE HOLDINGS, LLC

Acknowledgment

STATE OF Colorado

COUNTY OF Denver

KENNETH DALE
Notary Public
State of Colorado

THIS INSTRUMENT WAS ACKNOWLEDGED BEFORE ME ON 12/21/12

BY: MIKE REID, VICE PRESIDENT, PRO BUILD REAL ESTATE HOLDINGS, LLC

NOTARY PUBLIC

1/4/20(6 MY COMMISSION EXPIRES

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Notes


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DOC# 2013012914

02/04/2013 11:37 MM Page: 1 of 2

1tyPLAT R:\$25.00 B: 2013C P: 0009 M. Toulous Olivere, Bernalillo Cou

Plat for

Tracts B-1-A & B-1-B Atrisco Business Park, Unit 1, Tract B

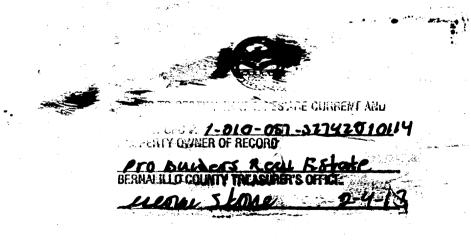Being Comprised of

Tract B-1

Atrisco Business Park, Unit 1, Tract B
City of Albuquerque

Bernalillo County, New Mexico


December 2012

Approved and Accepted by:

APPROVAL AND CONDITIONAL ACCEPTANCE AS SPECIFIED BY THE ALBUQUERQUE SUBDIVISION ORDINANCE, CHAPTER 14 ARTICLE 14 OF THE REVISED ORDINANCES OF ALBUQUERQUE, NEW MEXICO, 1994.

Project Number 1009544

Application Number 12DRB-70399

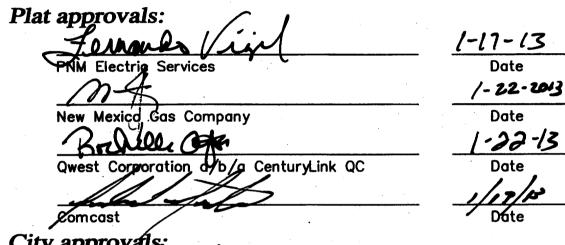

City approxals; 12-28-12 City Surveyor 01/16/13 Traffic Engineer allon Poten 01/16/13 Date Carol S. Dumont 1-16-13 Parks and Recreation Department 1-16-13 cc 2-1-13 1-16-17 2-4-13 DRB Chairperson, Planning Department Date

Surveyor's Certificate

"I, WILL PLOTNER JR., A DULY QUALIFIED REGISTERED PROFESSIONAL LAND SURVEYOR UNDER THE LAWS OF THE STATE OF NEW MEXICO, DO HEREBY CERTIFY THAT THIS PLAT AND DESCRIPTION WERE PREPARED BY ME OR UNDER MY SUPERVISION, SHOWS ALL EASEMENTS AS SHOWN ON THE PLAT OF RECORD OR MADE KNOWN TO ME BY THE OWNERS AND/OR PROPRIETORS OF THE SUBDIVISION SHOWN HEREON, THE UTILITY COMPANIES OR OTHER INTERESTED PARTIES AND MEETS THE MINIMUM REQUIREMENTS FOR MONUMENTATION AND SURVEYS OF THE ALBUQUERQUE SUBDIVISION ORDINANCE, AND FURTHER MEETS THE MINIMUM STANDARDS FOR LAND SURVEYING IN THE STATE OF NEW MEXICO AND IS TRUE AND CORRECT TO THE BEST OF MY KNOWLEDGE AND BELIEF."


MIL PLOTNER JR.
N.M.R.P.S. No. 14271


DATE


DATE

CARTESIAN SURVEYS INC

P.O. BOX 44414 RIO RANCHO, N.M. 87174 Phone (505) 896-3050 Fax (505)891-0244 Sheet 1 of 2

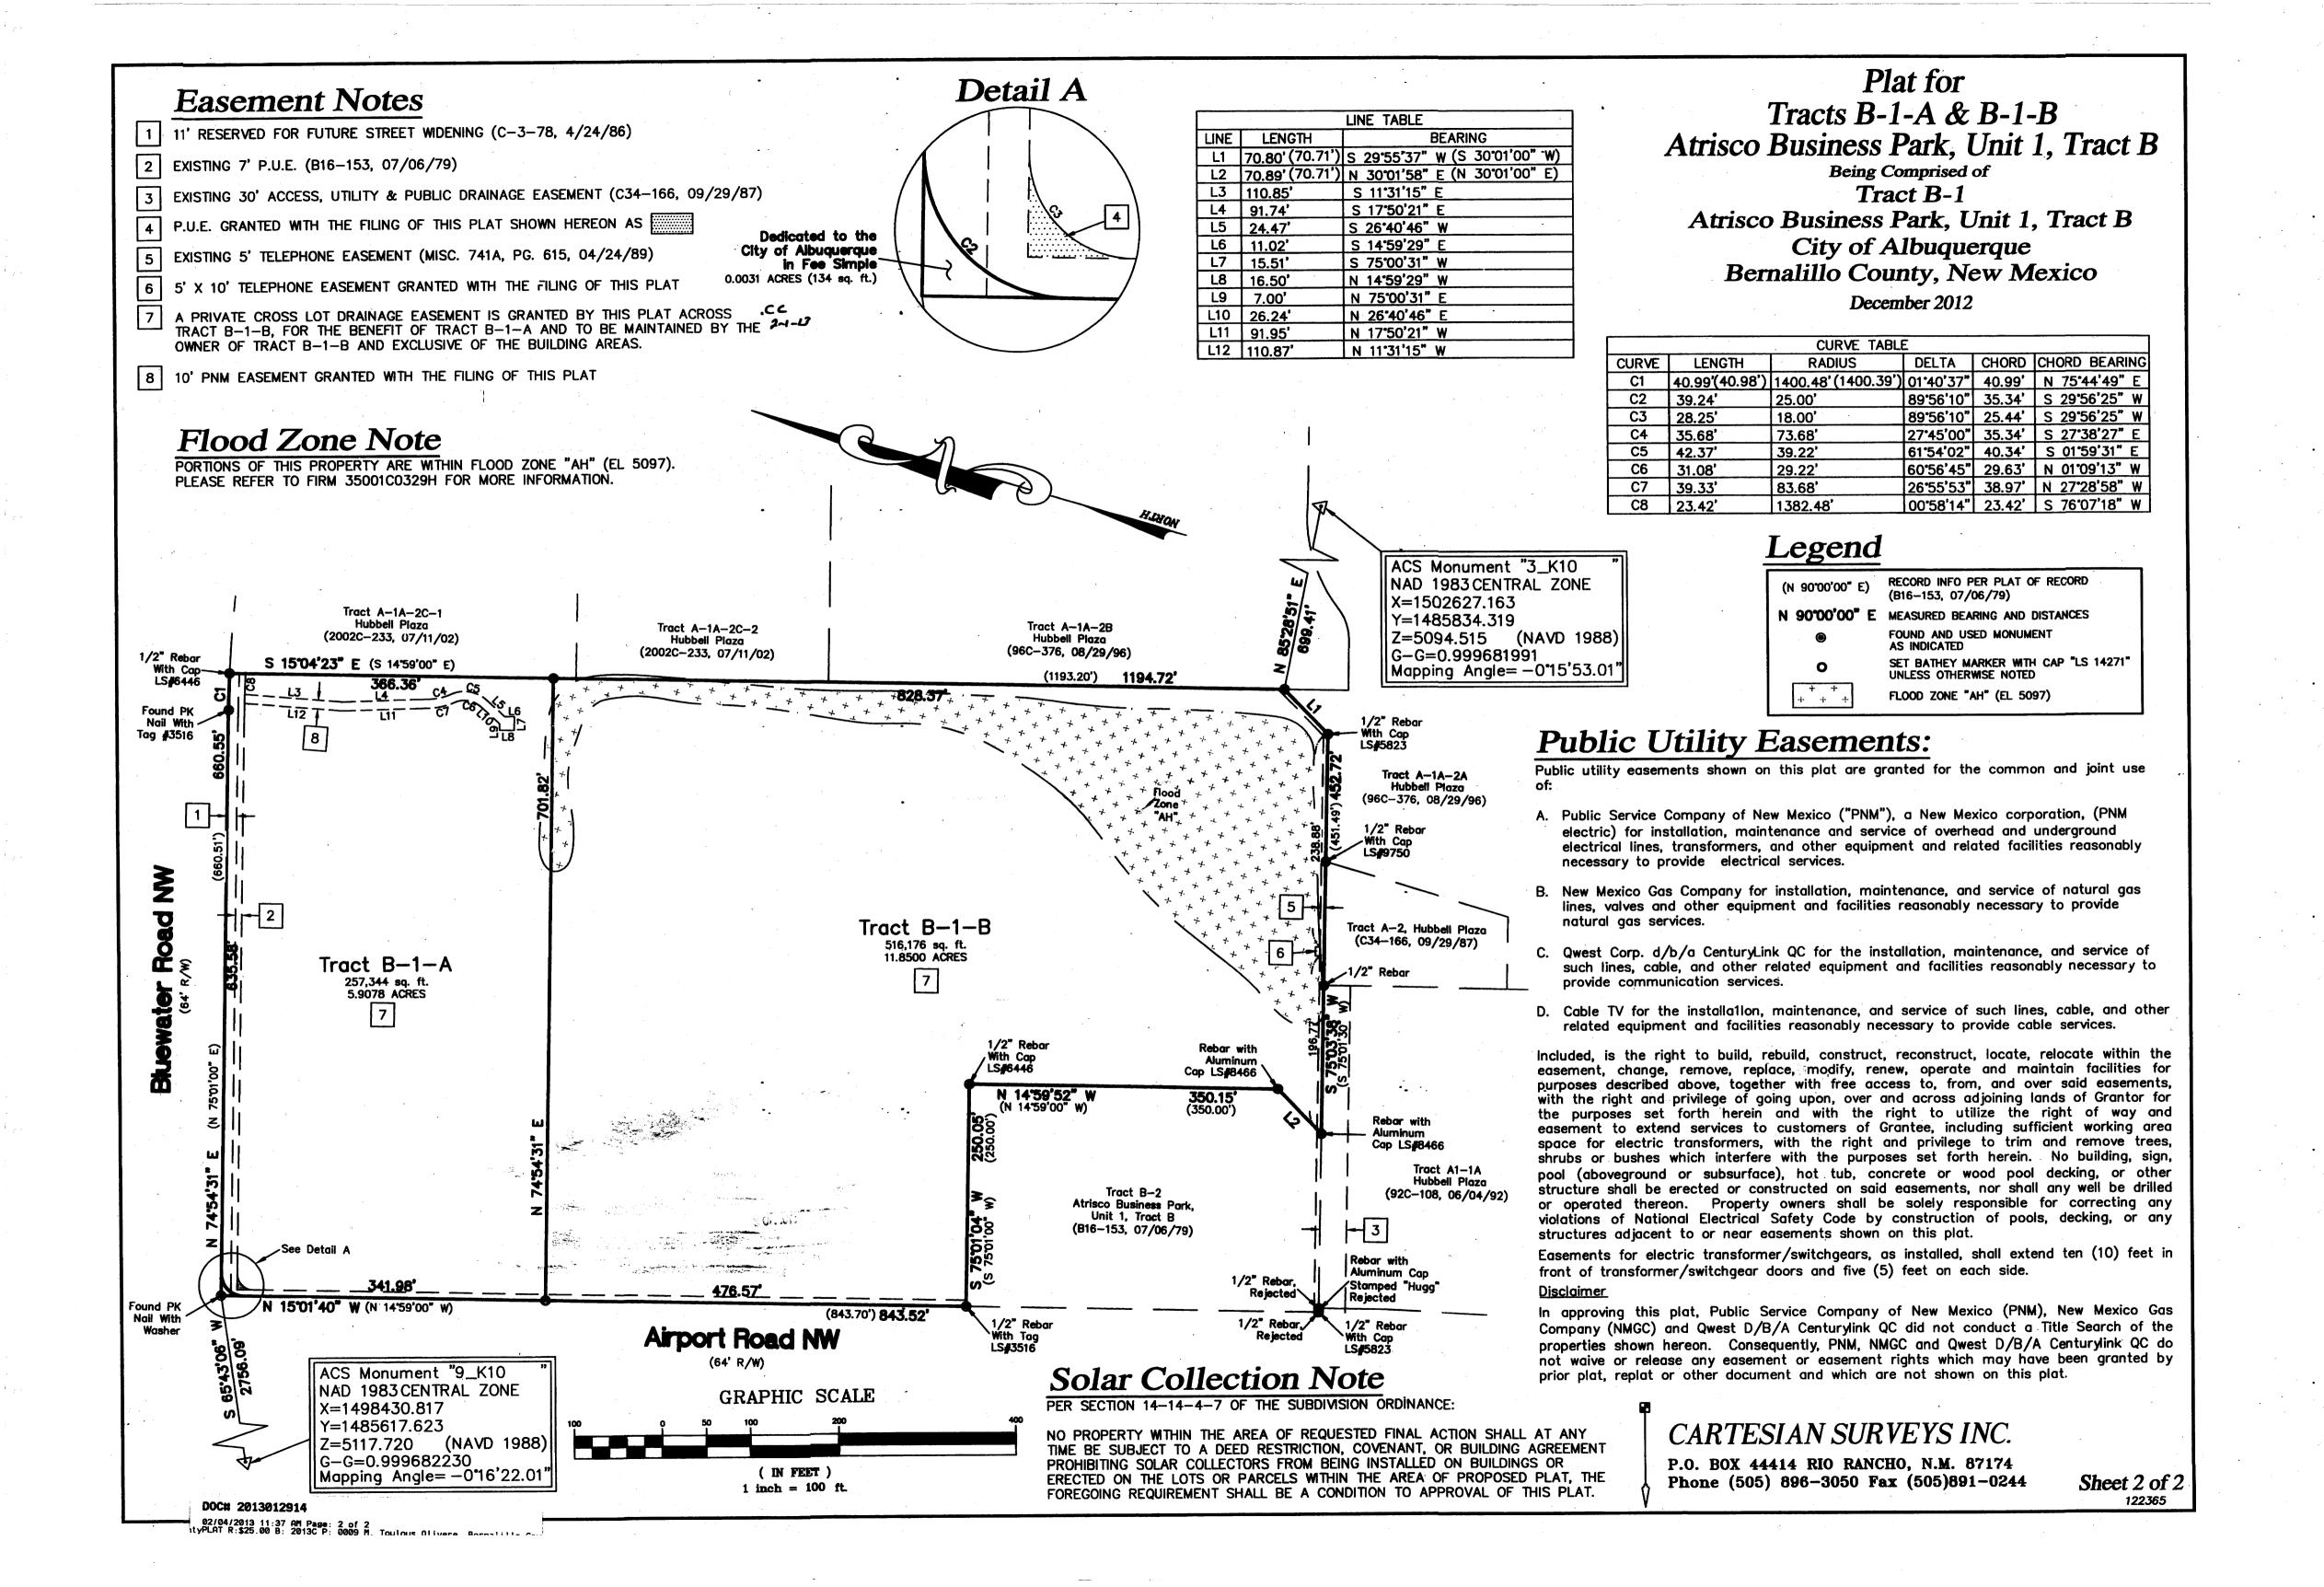

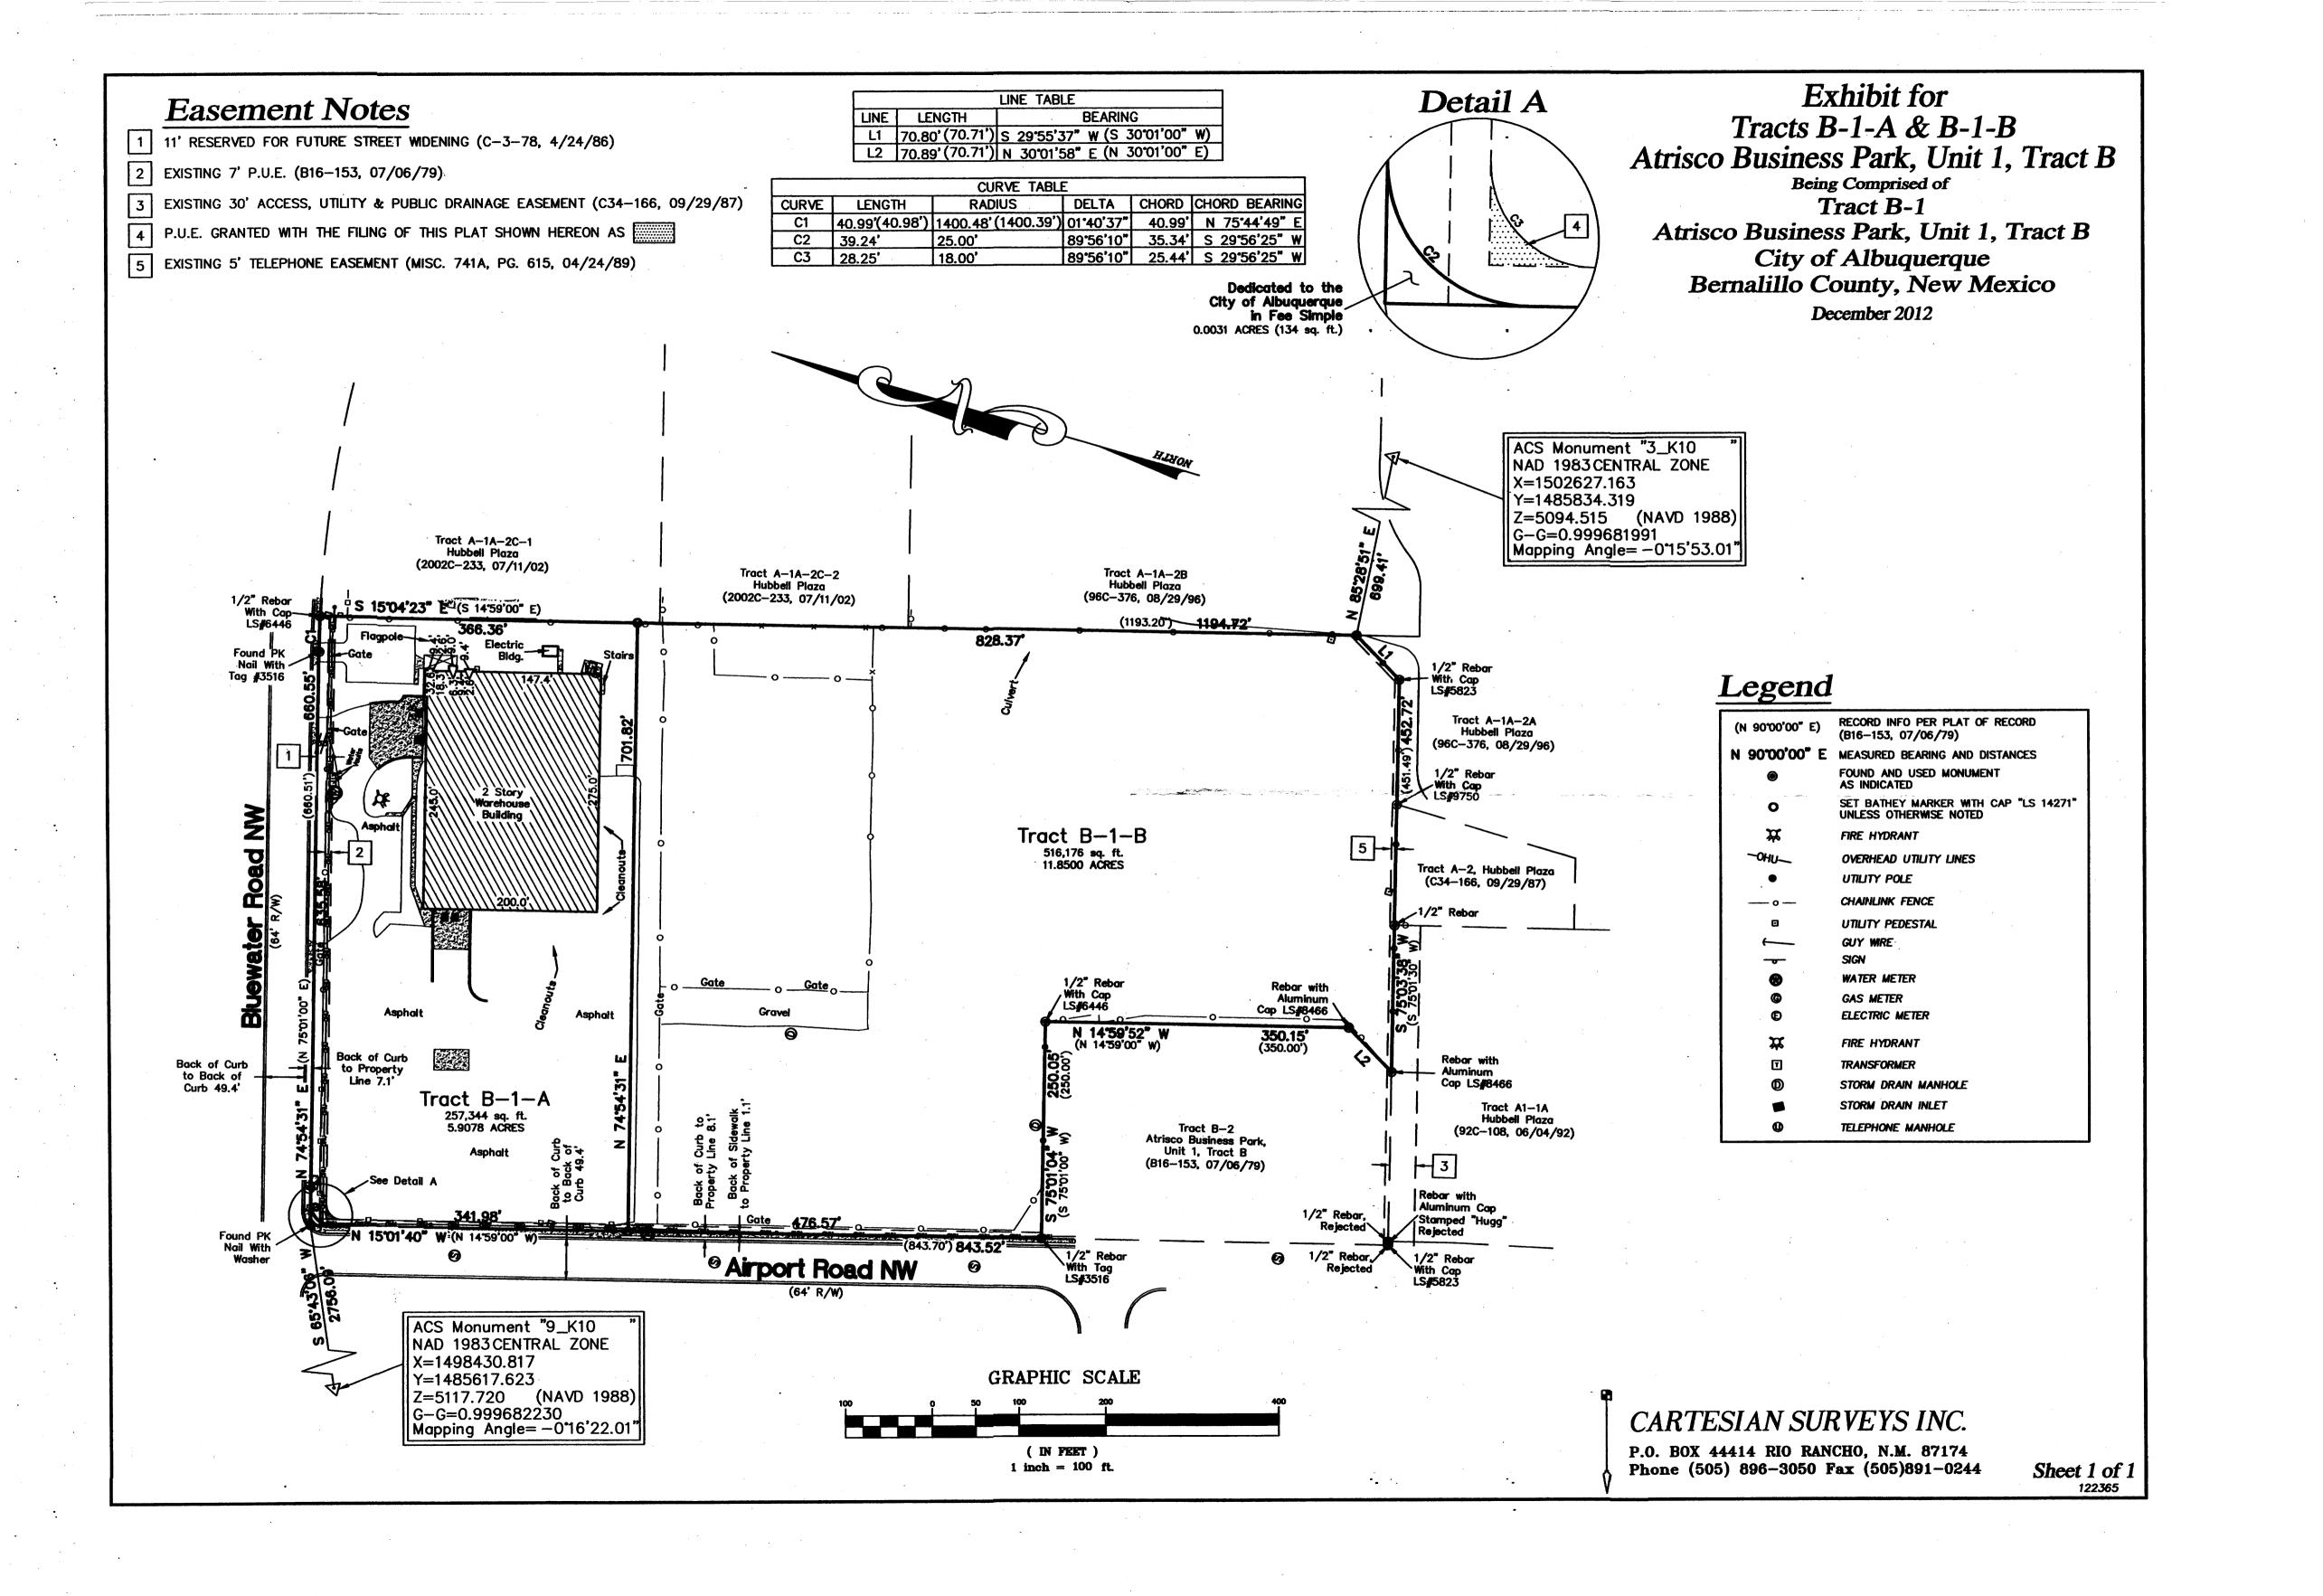

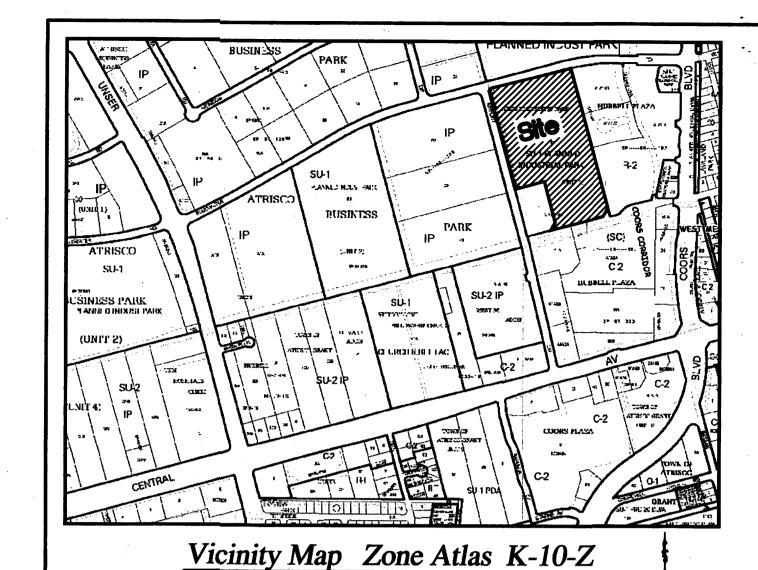

Purpose of Plat

- 1. SUBDIVIDE AS SHOWN HEREON
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MIKE REID, VICE PRESIDENT DATE
PRO BUILD REAL ESTATE HOLDINGS, LLC

Acknowledgment

STATE OF Colorado }

KENNETH DALE
Notary Public
State of Colorado

My Commission Expires January 04, 2016

THIS INSTRUMENT WAS ACKNOWLEDGED BEFORE ME ON $\frac{12/21/12}{}$

BY: MIKE REID, VICE PRESIDENT, PRO BUILD REAL ESTATE HOLDINGS, LLC

NOTARY PUBLIC MY COMMISSION EXPIRES

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Plat for Tracts B-1-A & B-1-B Atrisco Business Park, Unit 1, Tract B Being Comprised of Tract B-1 Atrisco Business Park, Unit 1, Tract B City of Albuquerque

Bernalillo County, New Mexico
December 2012

Approved and Accepted by:

APPROVAL AND CONDITIONAL ACCEPTANCE AS SPECIFIED BY THE ALBUQUERQUE SUBDIVISION ORDINANCE, CHAPTER 14 ARTICLE 14 OF THE REVISED ORDINANCES OF ALBUQUERQUE, NEW MEXICO, 1994.

Project Number	
Application Number	
Plat approvals:	

PNM Electric Services	Date
New Mexico Gas Company	Date
Qwest Corporation d/b/a CenturyLink QC	Date
Comcast	Date

Comcast	Da
approvals:	
a Lant. Proster	12-
City Surveyor—	Da
Traffic Engineer	Da
ABCWUA	Da
Parks and Recreation Department	Da
AMAFCA	Da

Surveyor's Certificate

DRB Chairperson, Planning Department

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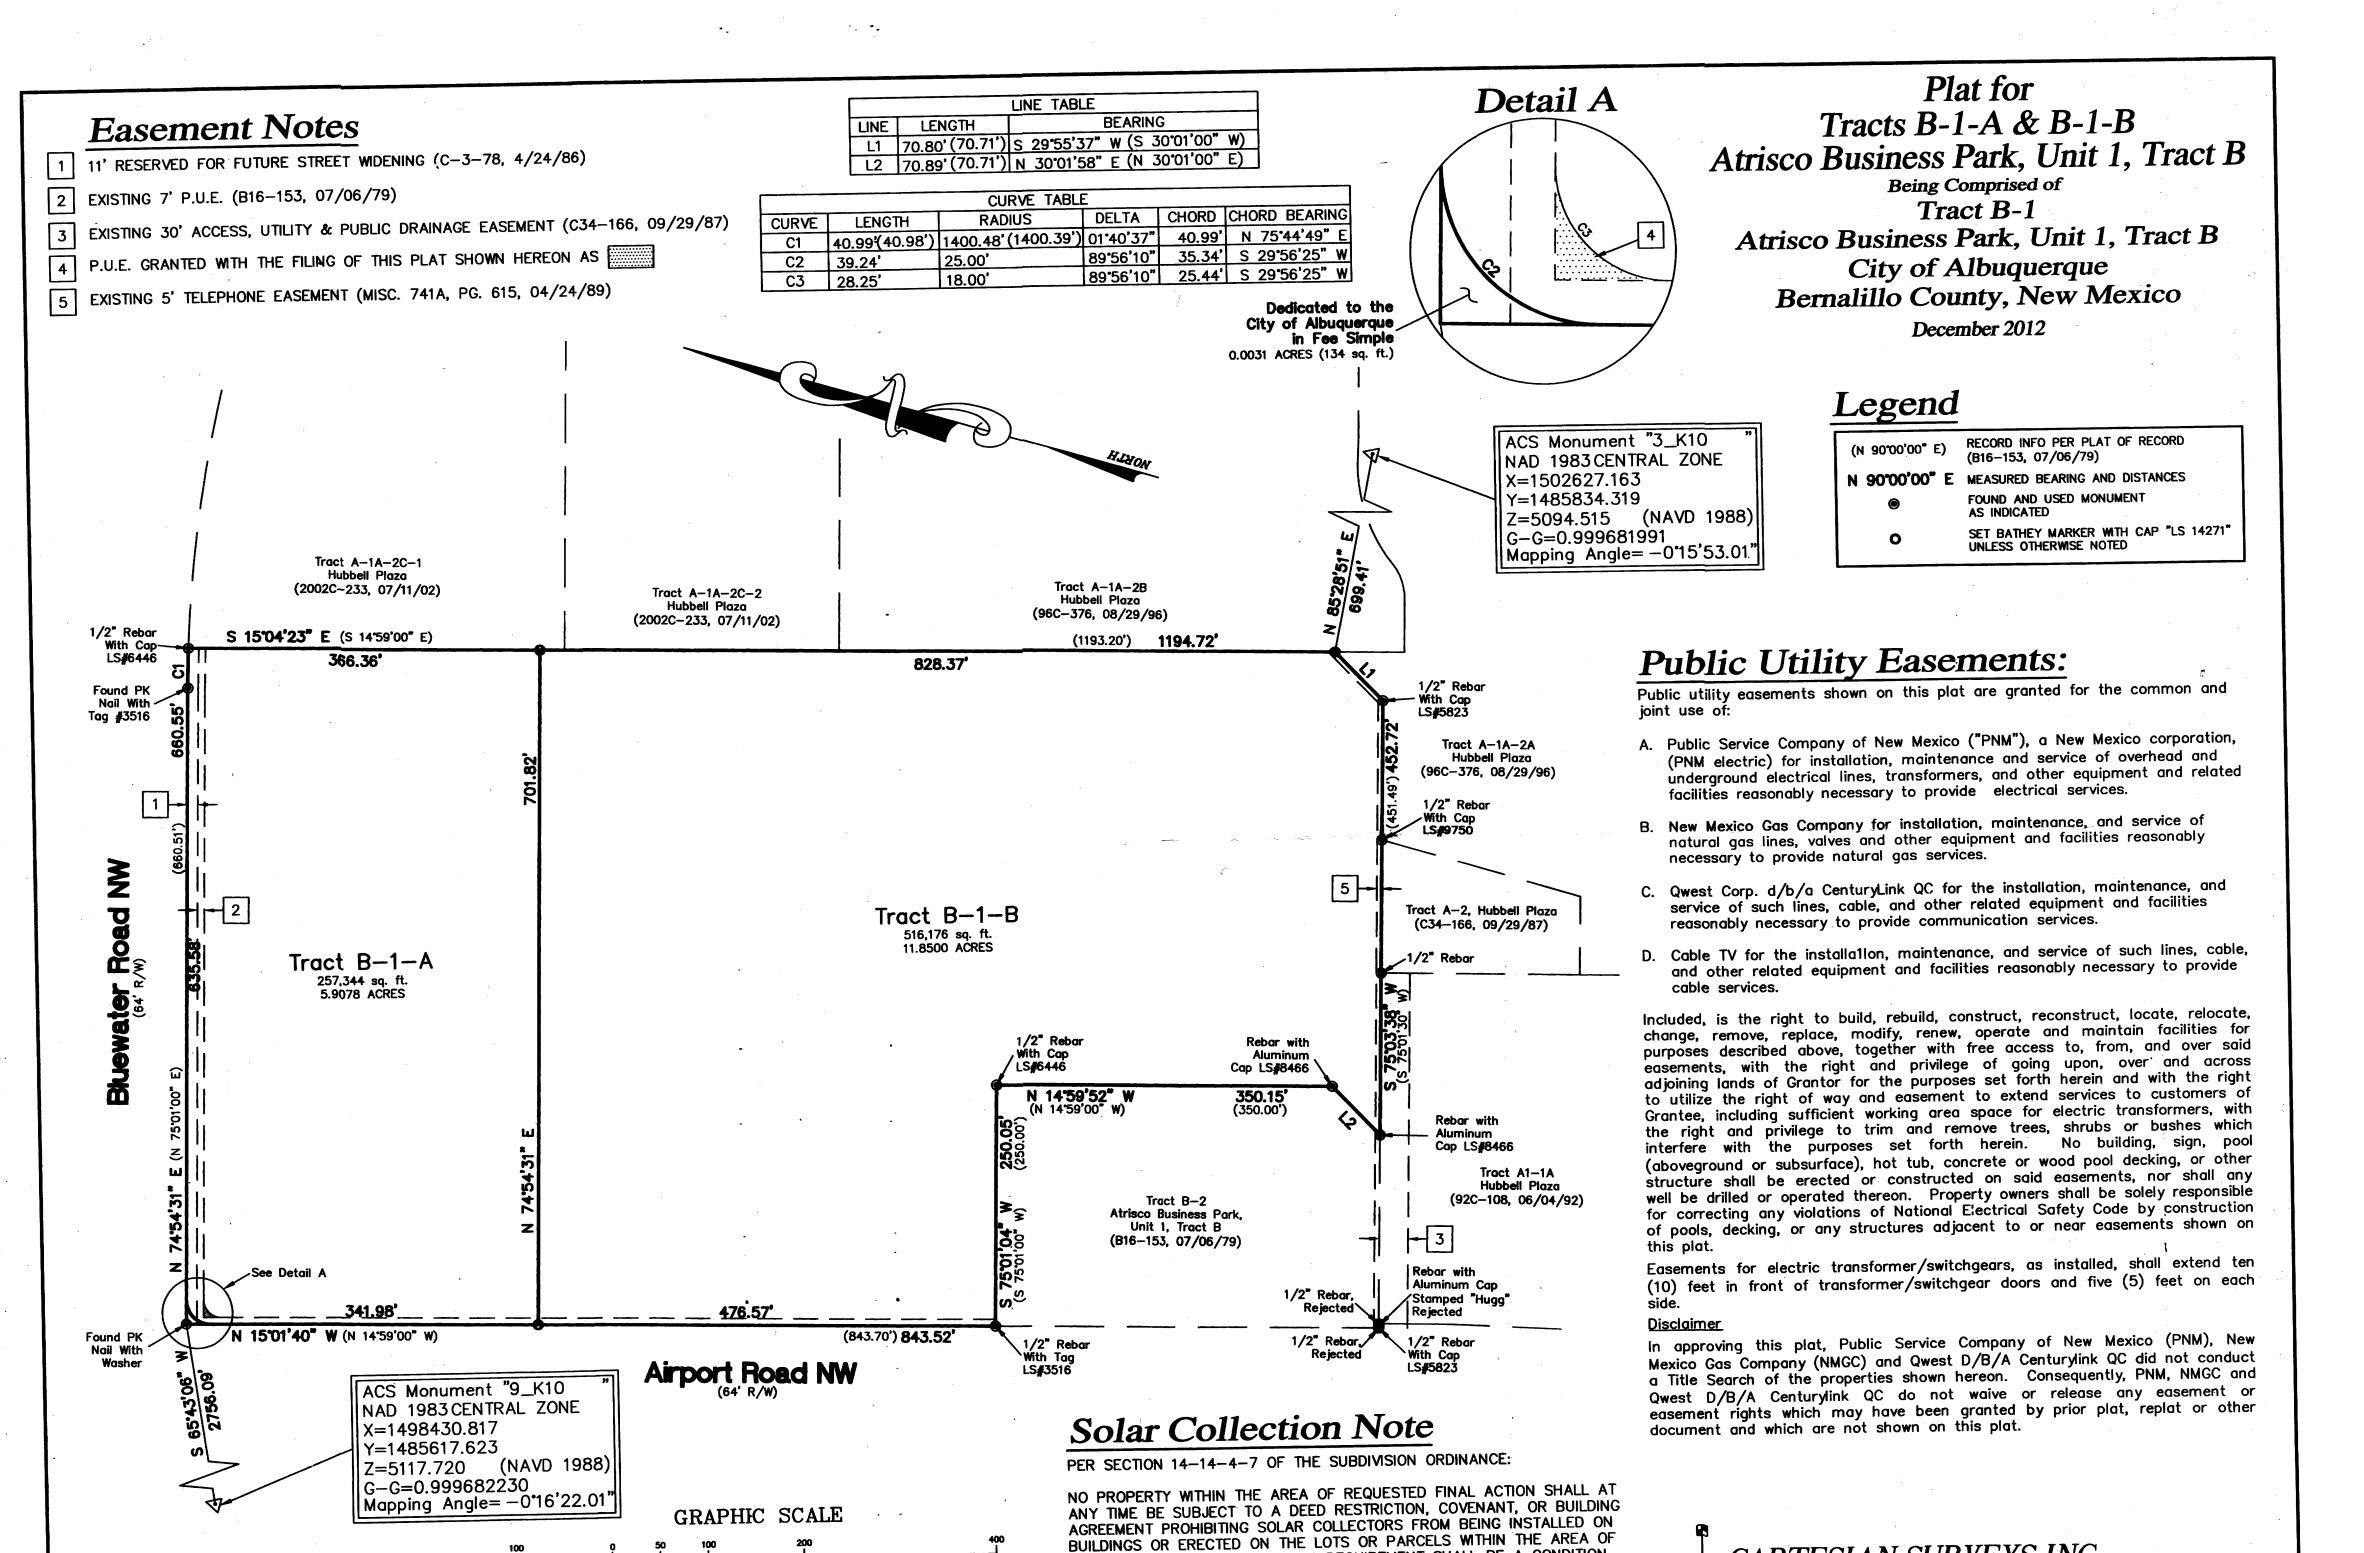
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Sheet 1 of 2



PROPOSED PLAT, THE FOREGOING REQUIREMENT SHALL BE A CONDITION

TO APPROVAL OF THIS PLAT.

(IN FEET)

1 inch = 100 ft.

CARTESIAN SURVEYS INC.

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Sheet 2 of 2

