

DESIGN GUIDELINES:

- PROPOSED ZONING IS SU-1 FOR PRD.
- PERMISSIVE USES:
USES PERMISSIVE IN THE R-1 ZONE.
- LOT SIZE:
TOTAL NUMBER OF PROPOSED LOTS = 8 LOTS.
NUMBER OF PROPOSED TRACTS = 2 TRACTS. (THESE ARE COMMON AREA ONLY.)
MINIMUM LOT AREA FOR CONSTRUCTION SHALL BE 10,000.00 SF.
- SETBACKS:
A. THERE SHALL BE A FRONT YARD SETBACK OF NOT LESS THAN 20.00 FEET, OTHERWISE NOTED.
B. THERE SHALL BE A REAR YARD SETBACK OF NOT LESS THAN 10.00 FEET, OTHERWISE NOTED.
C. THERE SHALL BE A SIDE YARD SETBACK OF NOT LESS THAN 5.00 FEET, OTHERWISE NOTED.
- OFF-STREET PARKING IS PROVIDED ON EACH SITE FOR A MINIMUM OF 2 CARS, IN ADDITION TO 2 PARKING SPACES WITHIN EACH GARAGE FOR A TOTAL OF 4 MINIMUM SPACES PER LOT.
- WATER AND SEWER:
PRIOR TO DEVELOPMENT, CITY OF ALBUQUERQUE WATER AND SANITARY SERVICE TO THE SITE MUST BE VERIFIED AND COORDINATED WITH THE CITY OF ALBUQUERQUE UTILITY DEPARTMENT, VIA AN AVAILABILITY STATEMENT.
- ACCESS:
THE ONLY ACCESS ALLOWED TO THE PROJECT SHALL BE FROM THE ENTRANCE SHOWN ON THE CANDELARIA ROAD NW.
- CURBS AND GUTTERS:
MOUNTABLE CURB AND GUTTER SHALL BE USED THROUGHOUT EXCEPT FOR THOSE AREAS WHERE STANDARD CURB AND GUTTER IS NECESSARY FOR DRAINAGE CONVEYANCE.
- BUILDINGS:
BUILDING HEIGHT:
BUILDING STRUCTURE SHALL NOT EXCEED 26 FEET IN HEIGHT.
BUILDING TYPES:
BUILDINGS SHALL BE TRADITIONAL OR SOUTHWEST STYLE WITH EITHER FLAT OR PITCH ROOF. PITCHED ROOFS SHALL BE EITHER TILED OR METAL. BUILDINGS SHALL BE EITHER STUCCO, BRICK, OR ANY COMBINATION.
BUILDING COLORS:
BUILDING COLORS SHALL BE TAN TO LIGHT BROWN, ACCENTS AND EARTHTONE. THE USE OF DARK COLORS FOR THE ROOF IS PROHIBITED.
OPEN SPACE:
A MINIMUM OF 1200 SF. OF OPEN SPACE FOR EACH DWELLING SHALL BE FURNISHED EITHER ON-SITE OR IN ACCORDANCE WITH SECTION 14-13-3-8A OF THE ZONING CODE IF THERE IS AN ON-LOT DEFICIT.
- THIS SITE SHALL COMPLY WITH THE REQUIREMENTS OF THE STREET TREE ORDINANCE.
- THE LANDSCAPING PLAN SHALL COMPLY WITH THE REQUIREMENTS OF THE WATER CONSERVATION LANDSCAPING AND WATER WASTE ORDINANCE.
- LANDSCAPE MAINTENANCE SHALL BE THE RESPONSIBILITY OF THE PROPERTY OWNER.
- ALL FIXTURES SHALL BE OF A FULL CUT OFF TYPE, TO PREVENT FUGITIVE LIGHT, MOUNTED NO MORE THAN 16" HIGH.
- PROPOSED TRACTS A & B ARE COMMON AREA FOR USE OF ALL THE LOTS AND NO HOUSES SHALL BE CONSTRUCTED ON THESE TWO TRACTS. THE MAINTENANCE OF THESE TRACTS ARE THE RESPONSIBILITY OF ALL THE LOT OWNERS OR HOMEOWNERS ASSOCIATION.
- EACH LOT SHALL SUBMIT A SITE PLAN FOR BUILDING PERMIT TO CITY OF ALBUQUERQUE DEVELOPMENT REVIEW BOARD FOR BUILDING PERMIT APPROVAL.
- THE MAINTENANCE OF PRIVATE ACCESS EASEMENT IS THE RESPONSIBILITY OF ALL THE OWNERS OR HOMEOWNERS ASSOCIATION.
- THE MAINTENANCE OF THE IRRIGATION DITCH IS THE RESPONSIBILITY OF ALL THE OWNERS OR HOMEOWNERS ASSOCIATION.

LEGEND

- BOUNDARY LINE
- PROPOSED LOT LINE
- NEW CURB & GUTTER
- NEW SIDEWALK
- NEW BLOCK WALL
- SETBACK LINE
- EXIST. CURB & GUTTER
- EXISTING LOT LINE
- FIXTURE SITTING WITH PLANTER FOR DECIDUOUS TREE

LOT NO.	GROSS AREA	BUILDABLE LOT AREA
1	11,966.13 SF	6,883.12 SF
2	11,966.85 SF	7,771.20 SF
3	15,777.83 SF	6,933.87 SF
4	9,619.55 SF	6,016.85 SF
5	12,176.16 SF	7,968.19 SF
6	12,631.00 SF	6,387.32 SF
7	10,890.00 SF	7,158.52 SF
8	10,890.00 SF	6,256.49 SF
TOTAL	95,917.52 SF	55,375.56 SF


TRACT NO.	GROSS AREA	LANDSCAPING AREA
A	9,872.66 SF	5,757.38 SF
B	5,251.27 SF	2,277.05 SF
TOTAL	15,123.93 SF	8,034.43 SF

NOTES:

- NEW DRIVE WAY ENTRANCE PER COA STANDARD DRAWING #2426.
- EXISTING CURB AND GUTTER.
- REMOVE EXISTING CURB.
- NEW ASPHALT PAVING AREA.
- NEW MOUNTABLE CURB ESTATE TYPE PER COA STANDARD DRAWING #2415.
- NEW 4' SIDEWALK PER COA STANDARD DRAWING #2430.
- EXISTING 6.00' SIDEWALK.
- NEW UNIDIRECTIONAL WHEELCHAIR RAMP PER COA STD. DWG. #2426.
- PROPOSED 5.00' ADOBE WALL WITH STUCCO.
- 36.00' PRIVATE ACCESS & PUBLIC WATER & SEWER LINE EASEMENT.

LINE	LENGTH	BEARING
L1	15.44	N90°00'00"E
L1	45.95	N14°41'28"E
L2	15.44	S90°00'00"E
L2	24.65	N84°27'00"E
L3	63.91	S71°40'55"E
L4	1.97	S11°13'21"W
L5	23.26	S83°10'30"E
L6	30.85	S12°08'30"W
L7	54.32	N49°25'01"W

CURVE	LENGTH	RADIUS	DELTA	TANGENT	CHORD	CHORD DIRECTION
C1	58.28	42.00	79°30'11"	34.93	53.71	N51°00'36"E
C2	60.70	42.00	82°48'11"	37.03	55.55	N49°21'36"E

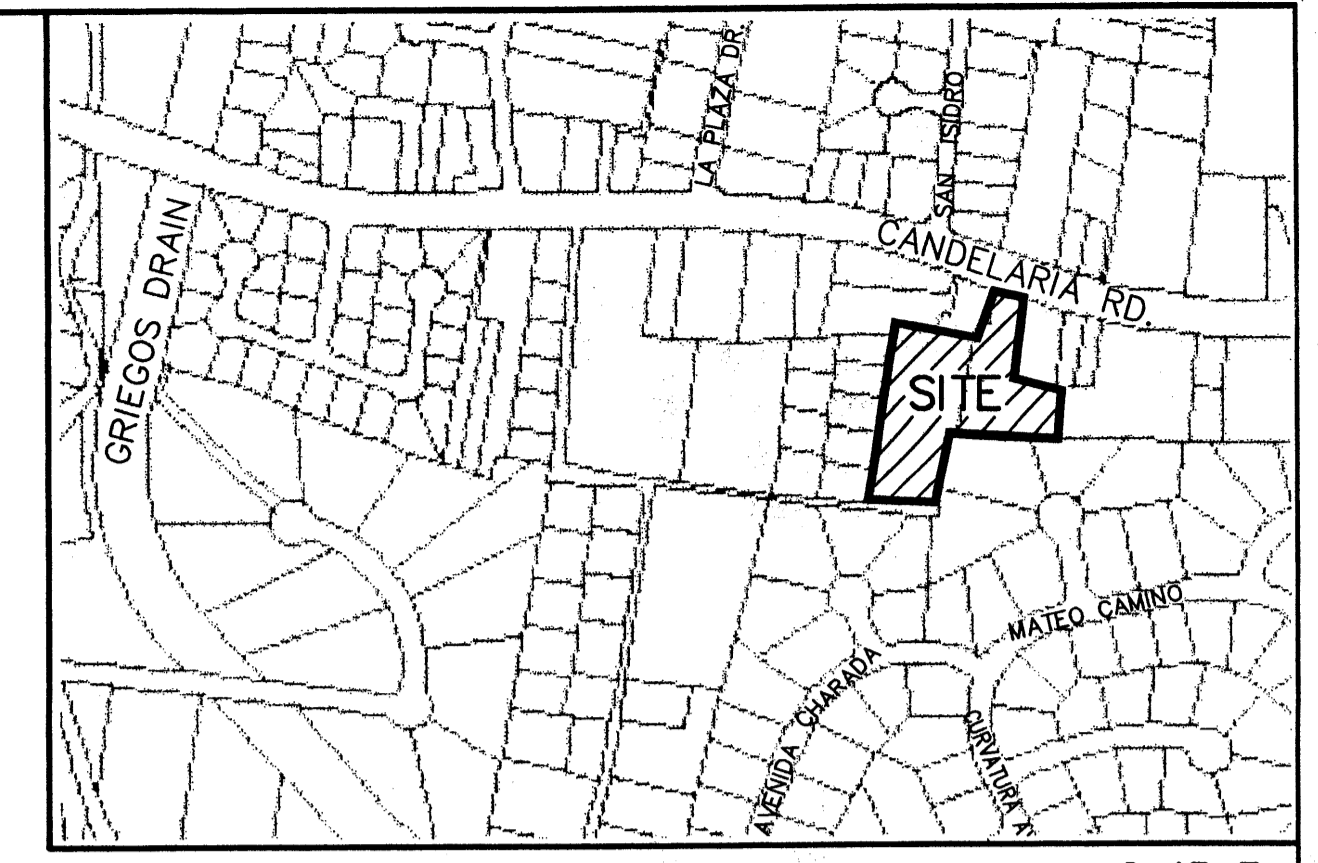

VICINITY MAP: G-13-Z

LEGAL DESCRIPTION:
TRACT A, RIMA ADDITION AND TRACT A-1, LANDS OF CANRADO GARCIA, CONTAINING 2.5492 ACRES MORE OR LESS.

PROJECT #: 1009916
DATE: 12-18-13
APP #: 13-10786
(SBP)

SHEET INDEX

- SITE PLAN
- LANDSCAPING PLAN
- GRADING AND DRAINAGE PLAN
- MASTER UTILITY PLAN



PROJECT NUMBER: 1002198
APPLICATION NUMBER: 07-01009

THIS PLAN IS CONSISTENT WITH THE SPECIFIC SITE DEVELOPMENT PLAN APPROVAL BY THE ENVIRONMENTAL PLANNING COMMISSION (EPC), DATED 7/14/04, AND THE FINDINGS AND CONDITIONS IN THE OFFICIAL NOTIFICATION OF DECISION ARE SATISFIED. IS AN INFRASTRUCTURE LIST REQUIRED? () YES () NO IF YES, THEN A SET OF APPROVED DFC PLANS WITH A WORK ORDER IS REQUIRED FOR ANY CONSTRUCTION WITHIN PUBLIC RIGHT-OF-WAY OR FOR CONSTRUCTION OF PUBLIC IMPROVEMENTS.

DRB SITE DEVELOPMENT PLAN SIGNOFF APPROVAL:

- | | |
|--|-----------------|
| <i>Shahab Biazar</i>
TRAFFIC ENGINEERING, TRANSPORTATION DIVISION | 7-14-04
DATE |
| <i>Roger A. Green</i>
UTILITIES DEVELOPMENT | 7-14-04
DATE |
| <i>David Flores</i>
PARKS AND RECREATION DEPARTMENT | 7-14-04
DATE |
| <i>Brady L. Bigham</i>
CITY ENGINEER | 7/14/04
DATE |
| <i>Michael Helton</i>
SOLID WASTE MANAGEMENT | 6-4-04
DATE |
| <i>Sherran Matson</i>
DRB CHAIRPERSON, PLANNING DEPARTMENT | 7/14/04
DATE |

ZONING

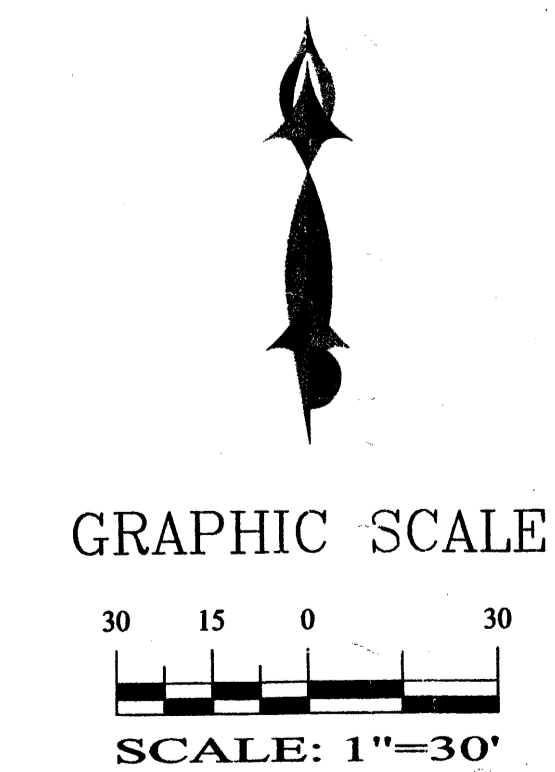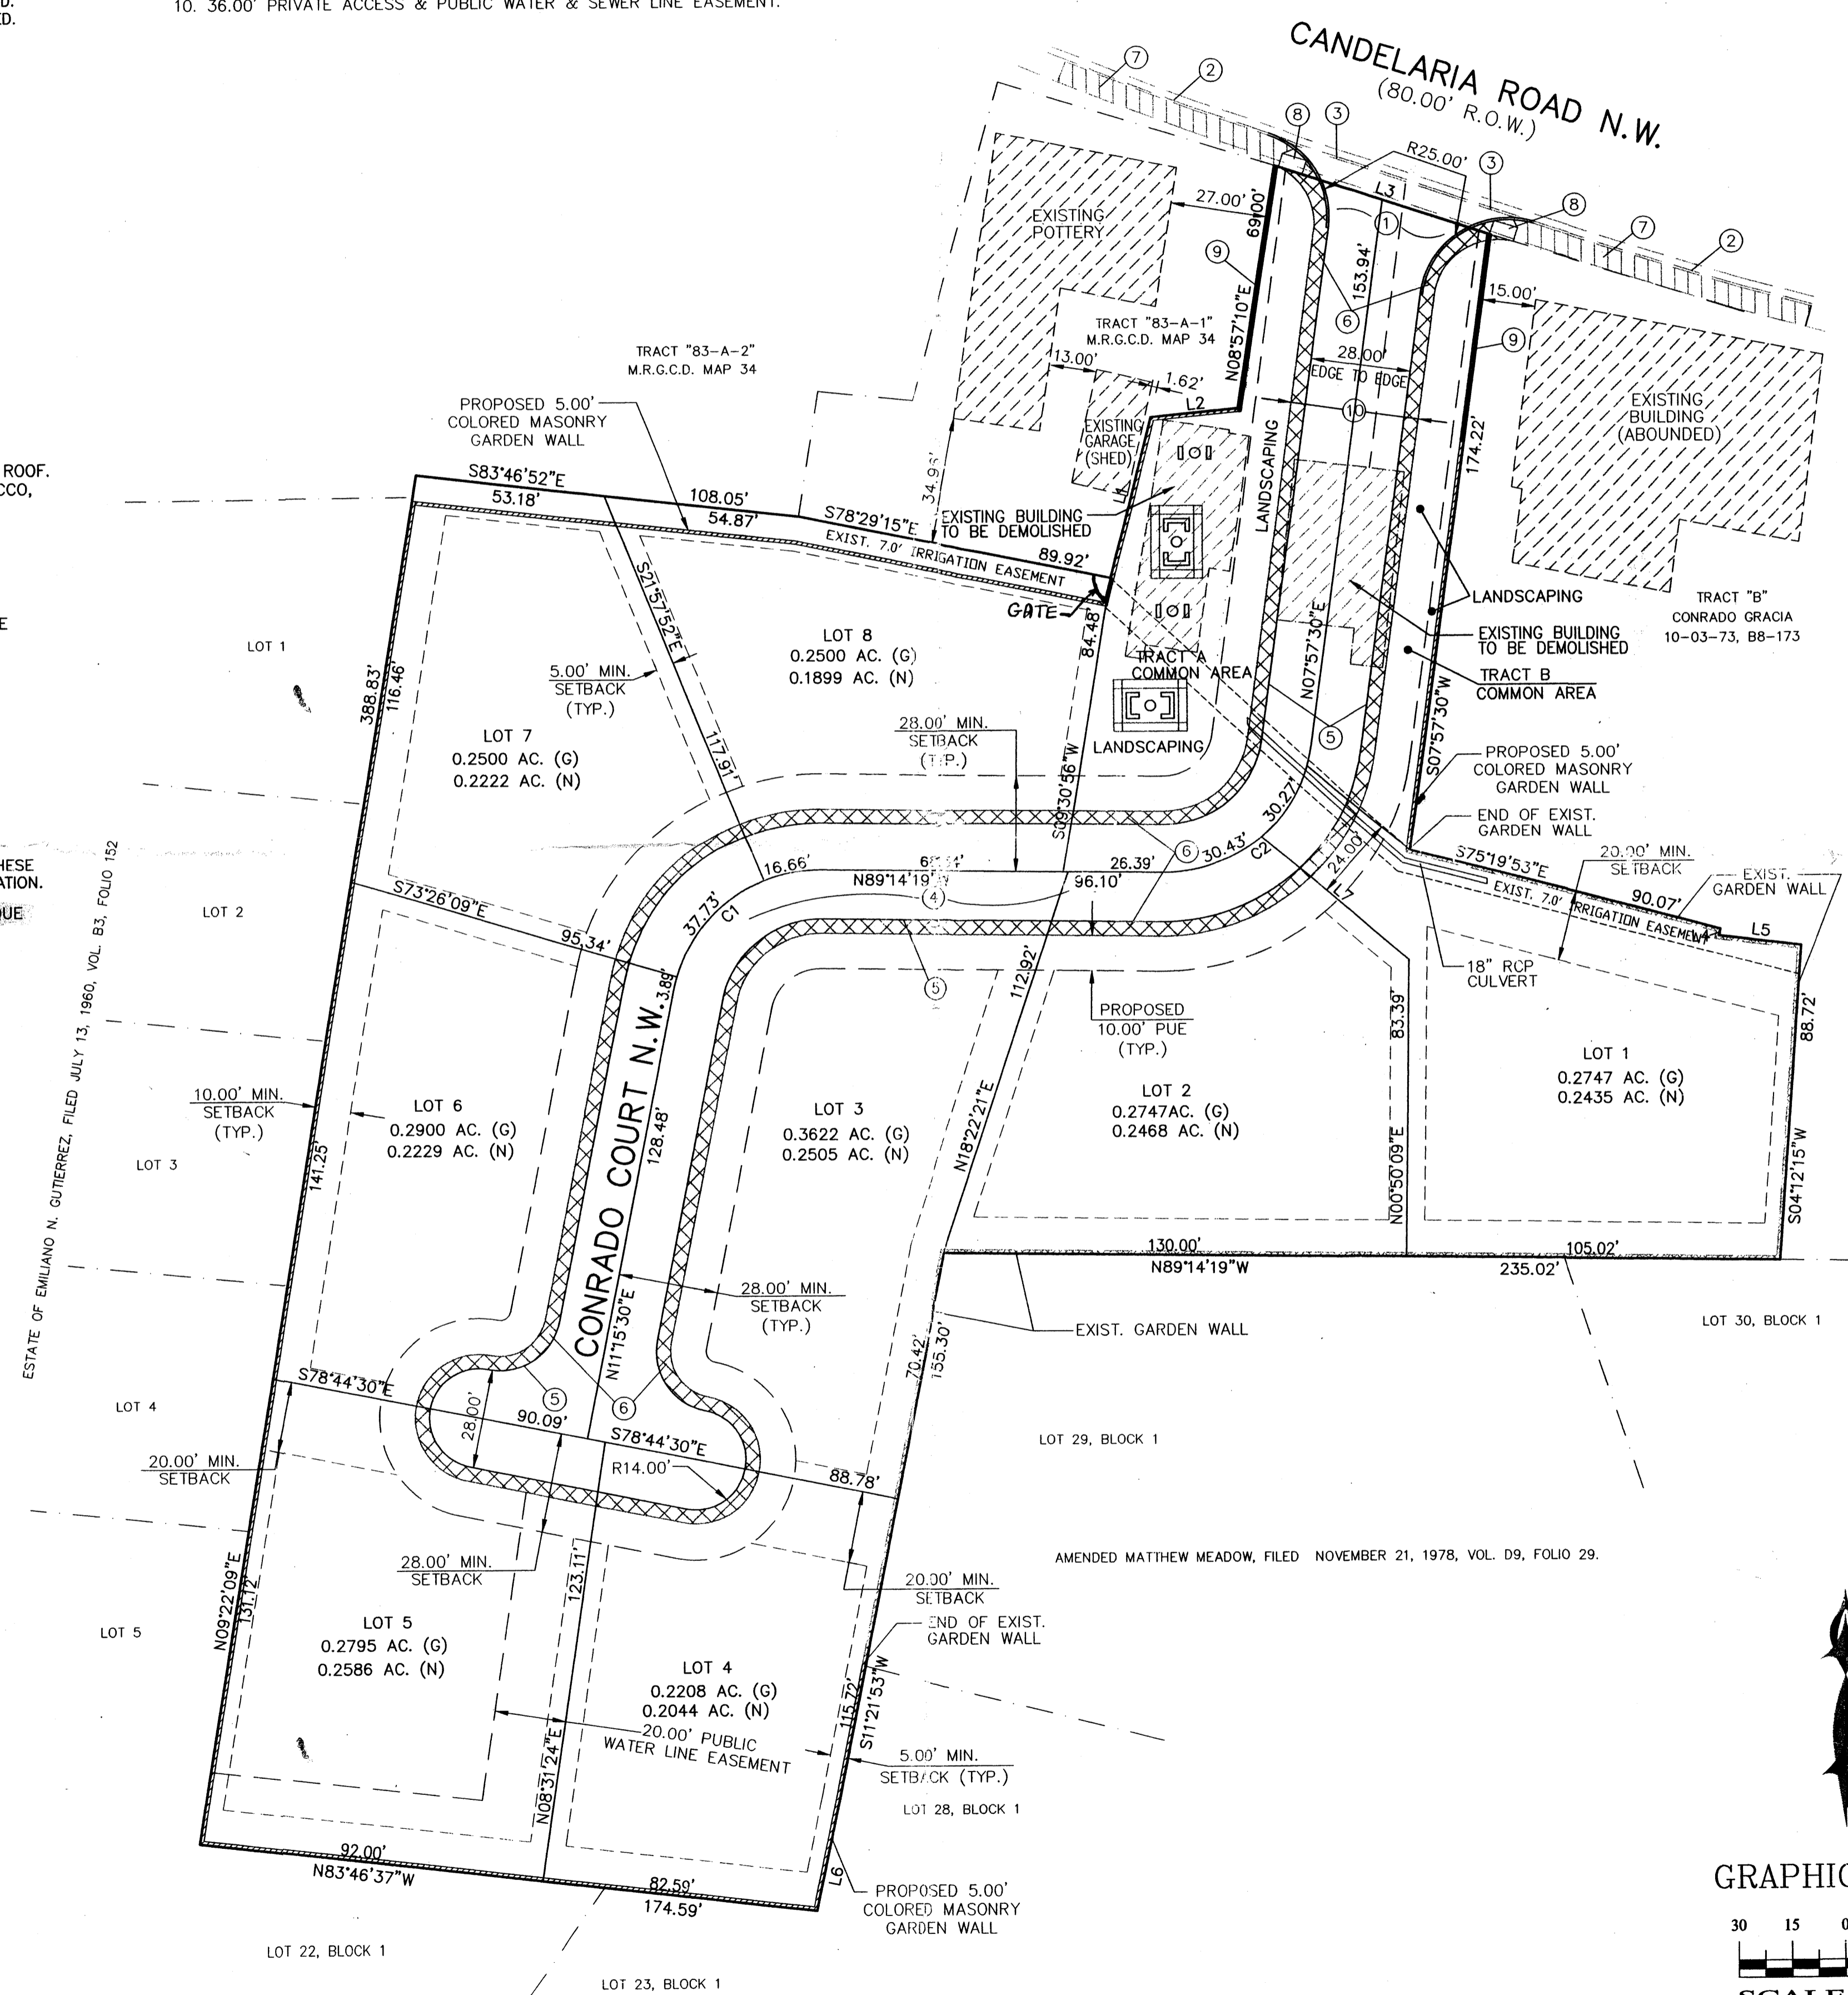



SHAHAB BIAZAR
P.E. #13479

4416 ANAHEIM AVE., NE
ALBUQUERQUE, NEW MEXICO 87113
(505)899-5570

ADVANCED ENGINEERING and CONSULTING, LLC

RANCHO DE CANDELARIA SITE PLAN FOR SUBDIVISION			
DRAWING:	DRAWN BY:	DATE:	SHEET #
200315-ST.DWG	SHH	05-24-04	1 OF 4

LAST REVISION: 11-05-03

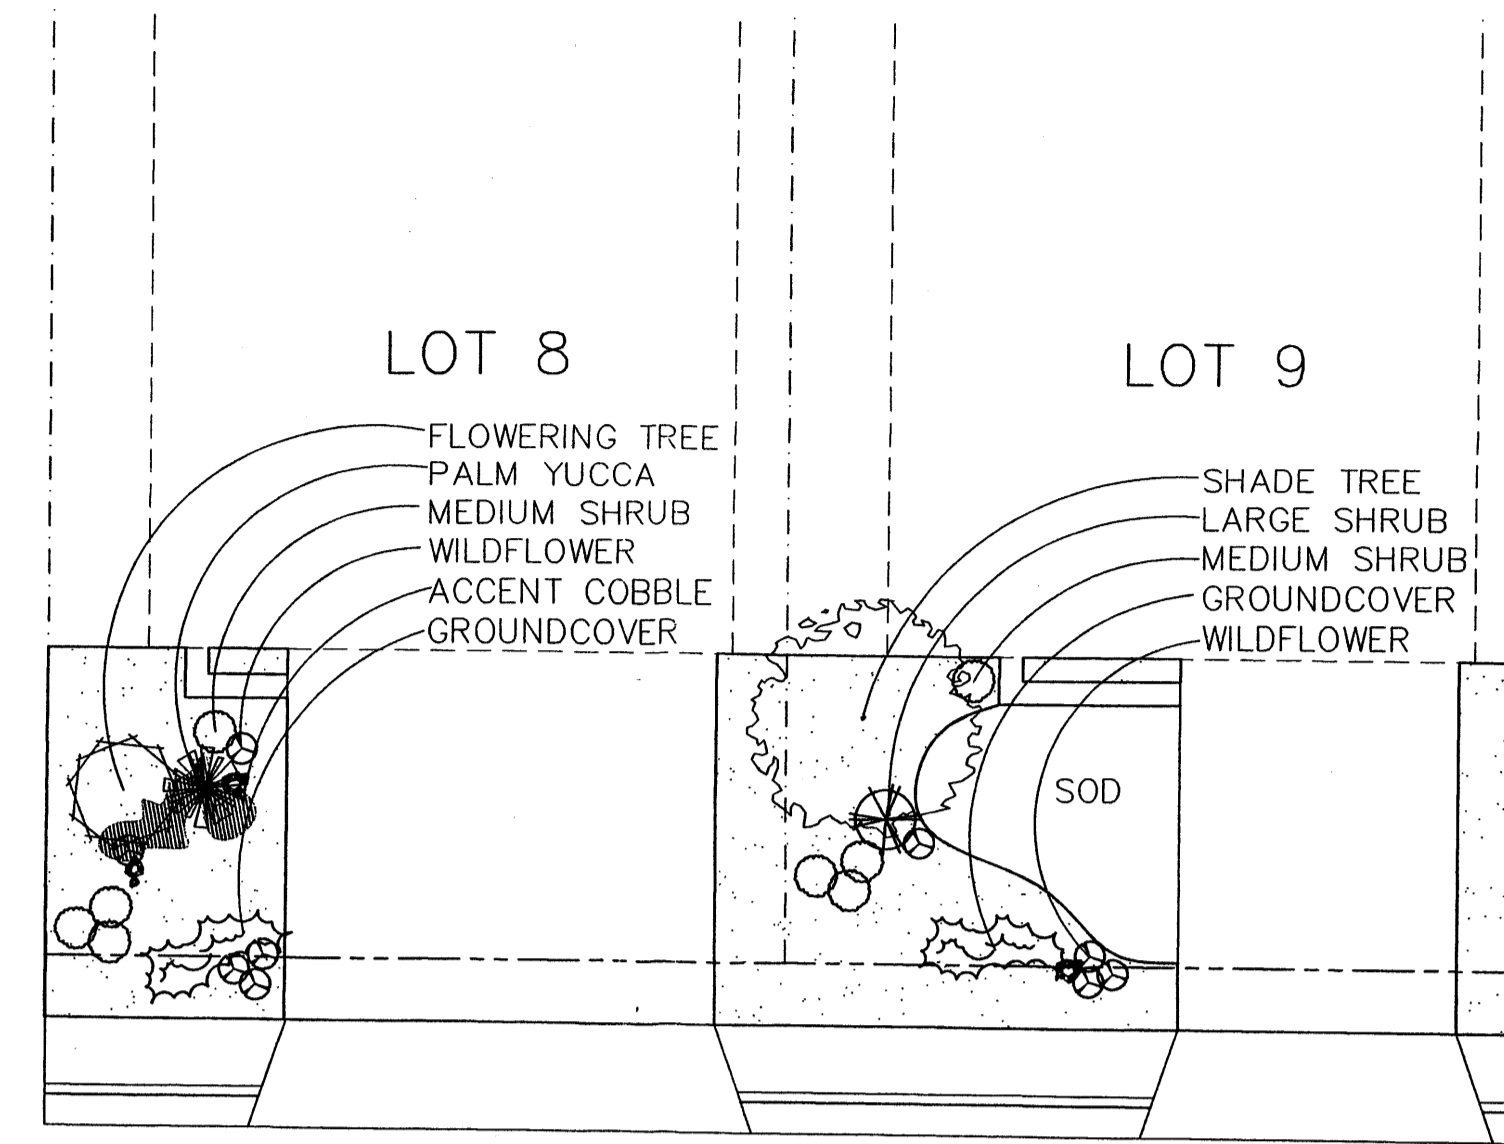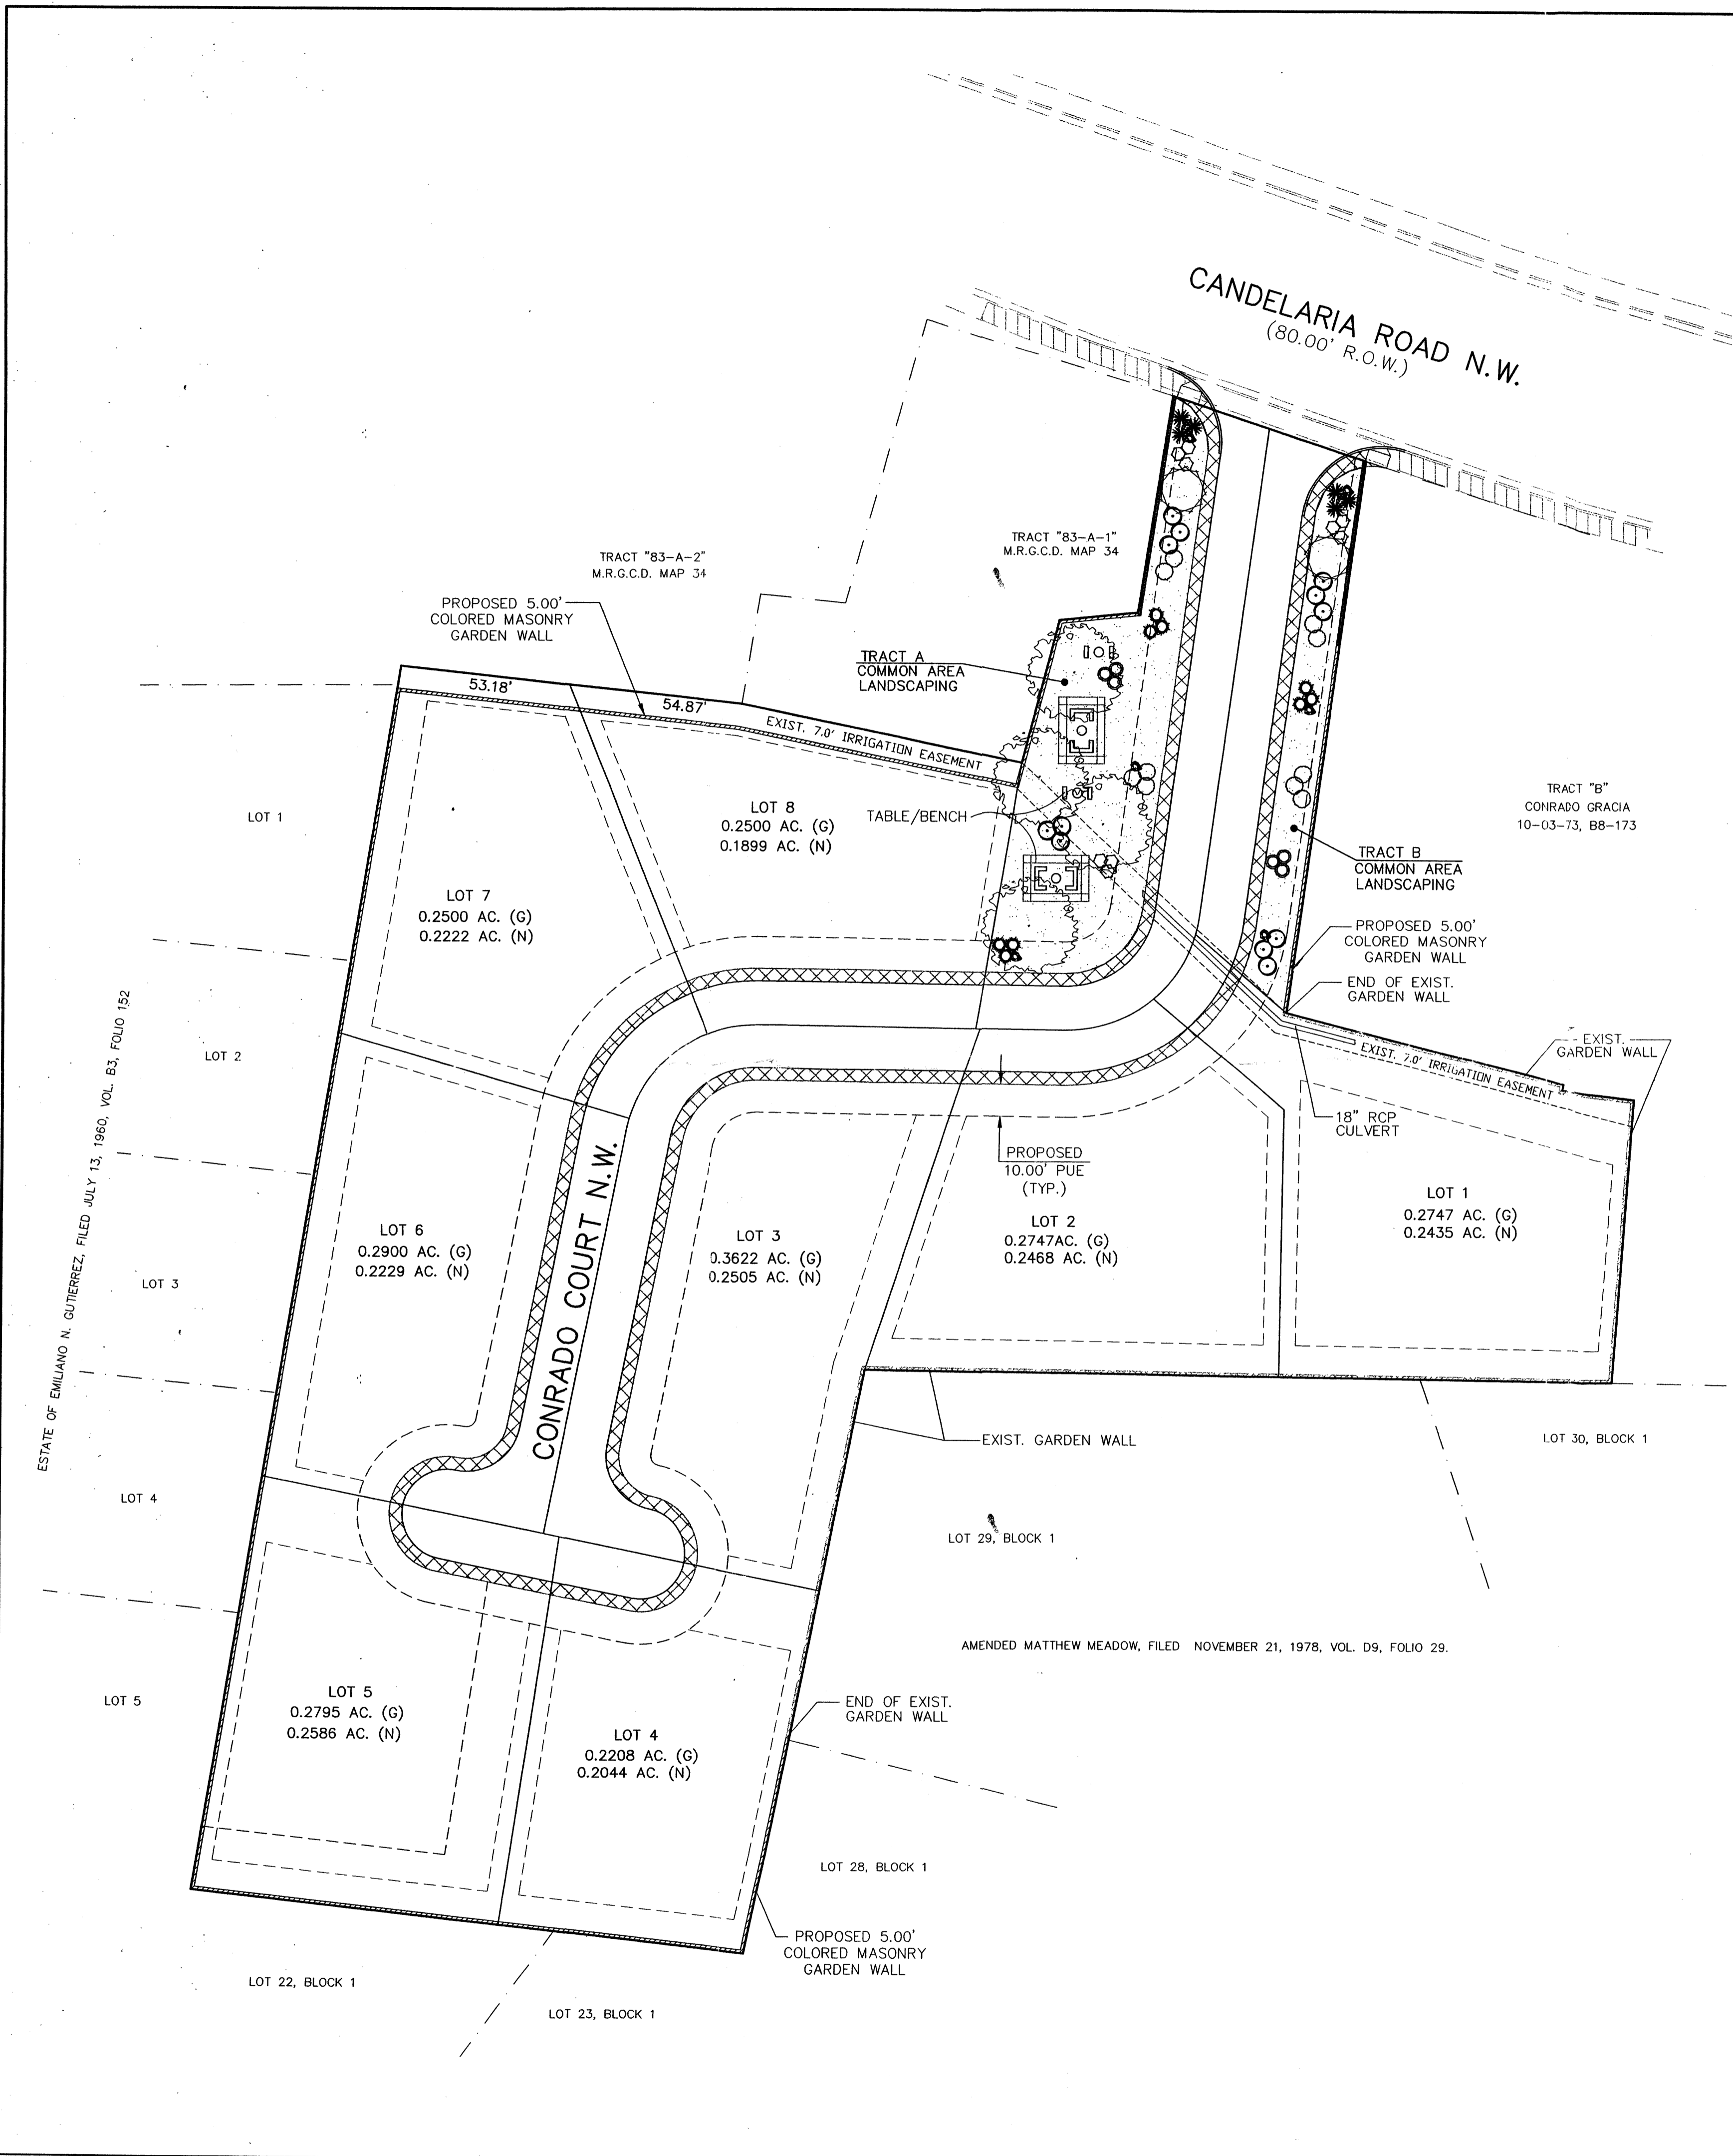

TYPICAL LOT LAYOUT

PLANT LEGEND

- ASH (H) OR HONEY LOCUST (H)
Fraxinus pennsylvanica
Gleditsia triacanthos
2" Gal.
- DESERT WILLOW (L)
Chilopsis linearis
15 Gal.
- RED YUCCA (L)
Hesperaloe parviflora
5 Gal.
- RUSSIAN SAGE (M)
Perovskia atriplicifolia
5 Gal.
- APACHE PLUME (L)
Fallugia paradoxa
5 Gal. 25sf
- LANAS/ SCOTCH BROOM (M)
Cytisus scoparius/
Genista hispanica
5 Gal.
- ROSEMARY (M)
Rosmarinus officinalis
2 Gal. 36sf
- AUTUMN SAGE (M)
Salvia greggii
2 Gal. 9sf
- BOULDERS 6
- SANTA FE BROWN GRAVEL WITH FILTER FABRIC

LANDSCAPE NOTES:

Landscape maintenance shall be the responsibility of the Property Owner.

It is the intent of this plan to comply with the City Of Albuquerque Water Conservation Landscaping and Water Waste Ordinance planting restriction approach.

Approval of this plan does not constitute or imply exemption from water waste provisions of the Water Conservation Landscaping and Water Waste Ordinance. Water management is the sole responsibility of the Property Owner.

All landscaping will be in conformance with the City of Albuquerque Zoning Code, Street Tree Ordinance, Pollen Ordinance, and Water Conservation Landscaping and Water Waste Ordinance. In general, water conservative, environmentally sound landscape principles will be followed in design and installation.

Plant beds shall achieve 75% live ground cover at maturity.

Santa Fe Brown Gravel over Filter Fabric shall be placed in all landscape areas which are not designated to receive native seed.

IRRIGATION NOTES:

Irrigation shall be a complete underground system with Trees to receive (5) 1.0 GPH Drip Emitters and Shrubs to receive (2) 1.0 GPH Drip Emitters. Drip and Bubbler systems to be tied to 1/2" poly pipe with flush caps at each end.

Run time per each drip valve will be approximately 15 minutes per day, to be adjusted according to the season.


Point of connection for irrigation system is unknown at current time and will be coordinated in the field.

Irrigation will be operated by automatic controller. Location of controller to be field determined and power source for controller to be provided by others.

Irrigation maintenance shall be the responsibility of the Property Owner.



LANDSCAPE ARCHITECTS & CONTRACTORS
 Cont. Lic. #26458
 7909 Edith N.E.
 Albuquerque, NM 87184
 Ph. (505) 898-9690
 Fax (505) 898-7737
 cnd@hilltoplandscaping.com
All creative ideas contained herein remain the property of The Hilltop Landscape Architects and Contractors and are protected by copyright laws. This is an original design and must not be released or copied unless applicable fees have been paid or job order placed.

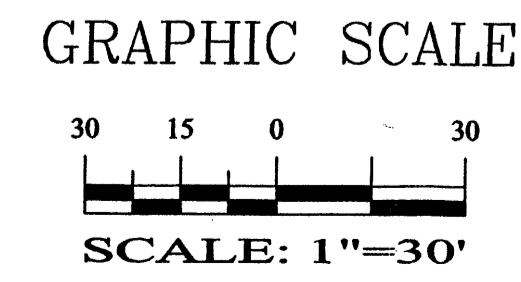

4416 ANAHEIM AVE., NE
 ALBUQUERQUE, NEW MEXICO 87113
 (505)899-5570

RANCHO DE CANDELARIA LANDSCAPING PLAN			
DRAWING:	DRAWN BY:	DATE:	SHEET #
200315-LS.DWG	SHH	05-24-04	2 OF 4



VICINITY MAP
ZONE ATLAS PAGE
G-13-Z
NTS

SITE




FLOOD MAP 35001C0331 E
NOVEMBER 19, 2003
NTS

LEGEND

- EXISTING CONTOURS 0.25'
- EXISTING CONTOURS 1'
- FINISHED GRADE CONTOUR
- PROPERTY LINE
- PROPOSED GARDEN WALL
- EXISTING CMU WALL
- PROPERTY CORNER (PLATED)
- FOUND REBAR
- BUILDING PAD WITH MAX AREA & ELEVATIONS SHOWN
- ▨ CONCRET DRIVE

RETENTION POND AREAS
RETENTION POND
TOP EL. XXX AREA. XXXXX sq ft
BTM EL. XXX AREA. XXXX sq ft
VOL. XXXX cu ft

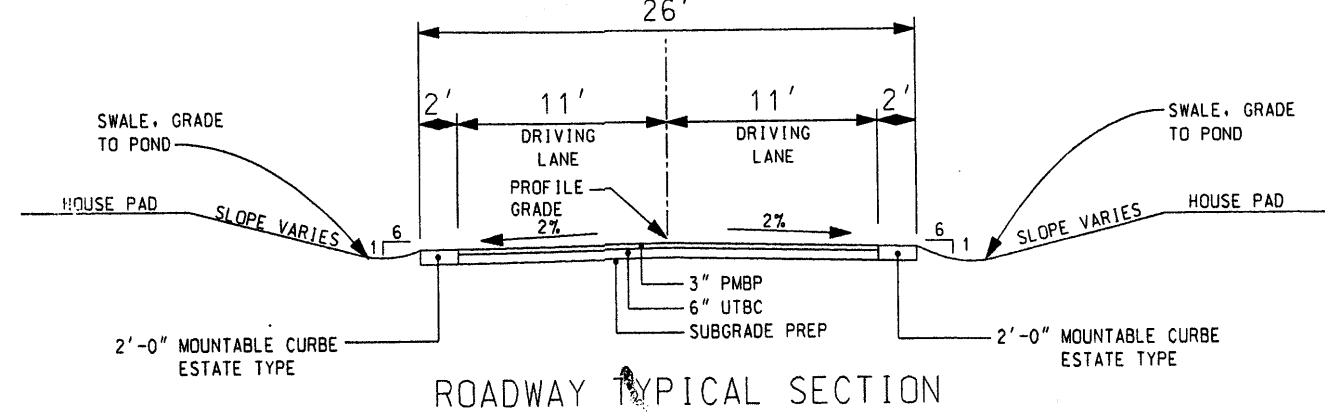


DRAINAGE NOTES

1. RUNOFF GENERATED ON SITE WILL BE RETAINED ON SITE IN INDIVIDUAL LOT RETENTION PONDS.
2. PONDING VOLUMES WERE CALCULATED USING COA DPM CHAPTER 22 METHODS FOR ZONE 2.
3. THE FLAT GRADING SCHEME AS DEFINED IN THE DPM IS BEING USED FOR THIS DEVELOPMENT
4. SEE ATTACHED CALCULATIONS FOR MAXIMUM ALLOWABLE IMPERVIOUS AREAS AND MAXIMUM ALLOWABLE HOUSE PAD AREAS.
5. INDIVIDUAL LOTS TO BE GRADED TO PROVIDE PONDING VOLUMS SHOWN IN TABLE BELOW.
6. REQUIRED PONDING VOLUMS ARE 100 YR 10 DAY STORM VOLUMS.
7. HOUSE PADS SHOWN ARE ONLY APPROXIMATE. GRADES SHOWN ESTABLISH STREET GRADES, BUILDING PAD ELEVATIONS AND GRADING AROUND PADS.
8. NO CROSS LOT DRAINAGE OR PONDING WILL BE ALLOWED.
9. THERE IS NO OFF-SITE DRAINAGE AFFECTING THIS SITE.
10. THIS SITE IS IN ZONE X ACCORDING TO FEMA MAP.
11. TOPO SURVEY WAS PERFORMED BY NMOC ON AUGUST 16, 2003.
12. ELEVATIONS AND CONTOURS SHOWN ARE BASED ON CONTROL STATION 6-G13A RESET THE STATION MARK IS A STANDARD ACS ALUMINUM CAP STAMPED "6-G13A RESET 1980/1995" SET FLUSH WITH THE TOP OF CURB SPIRIT LEVEL ELEVATION (SLD 1929) FEET 4965.73 (2nd ORDER).

DESCRIPTION	LAND USE				TOTAL	RUNOFF VOLUME 6HR-100YR	RUNOFF VOLUME 24HR-100YR	PONDING VOLUME 10DAY-100YR	MAX IMPERVIOUS AREA @ 45%	MAX BUILDING AREA	REMARKS
	A	B	C	D							
EXCESS PRECIPITATION (INCHES) ZONE 2	0.80	1.08	1.46	2.64							
LOT											
1			0.1586 AC	0.1161 AC	0.2747 AC	1,544 ft ³	1,713 ft ³	2,218 ft ³	5,384.76ft ²	3,000 ft ²	
2			0.1672 AC	0.1076 AC	0.2747 AC	1,514 ft ³	1,670 ft ³	2,139 ft ³	5,385.09ft ²	3,000 ft ²	
3			0.1998 AC	0.1624 AC	0.3622 AC	2,063 ft ³	2,299 ft ³	3,006 ft ³	7,100.02ft ²	2,475 ft ²	
4			0.1339 AC	0.1010 AC	0.2350 AC	1,326 ft ³	1,473 ft ³	1,913 ft ³	4,605.75ft ²	3,000 ft ²	
5			0.1641 AC	0.1013 AC	0.2654 AC	1,543 ft ³	1,600 ft ³	2,041 ft ³	5,202.77ft ²	3,000 ft ²	
6			0.1625 AC	0.1275 AC	0.2900 AC	1,641 ft ³	1,826 ft ³	2,381 ft ³	5,683.95ft ²	2,475 ft ²	
7			0.1490 AC	0.1010 AC	0.2500 AC	1,388 ft ³	1,535 ft ³	1,975 ft ³	4,898.78ft ²	3,000 ft ²	
8			0.1419 AC	0.1081 AC	0.2500 AC	1,395 ft ³	1,545 ft ³	1,993 ft ³	4,900.50ft ²	2,700 ft ²	
TRACT A			0.1531 AC	0.0735 AC	0.2266 AC	1,194 ft ³	1,300 ft ³	1,621 ft ³	4,442.70ft ²	0 ft ²	
TRACT B			0.0685 AC	0.0520 AC	0.1205 AC	681 ft ³	757 ft ³	983 ft ³	2,363.07ft ²	0 ft ²	
TOTAL AREAS			1.4986 AC	1.0505 AC	2.5491 AC						

NOTE:
LAND USE C COMPACTED SOIL AREA
LAND USE D BUILDING AREA/PAVEMENT
* REQUIRED PONDING VOLUME

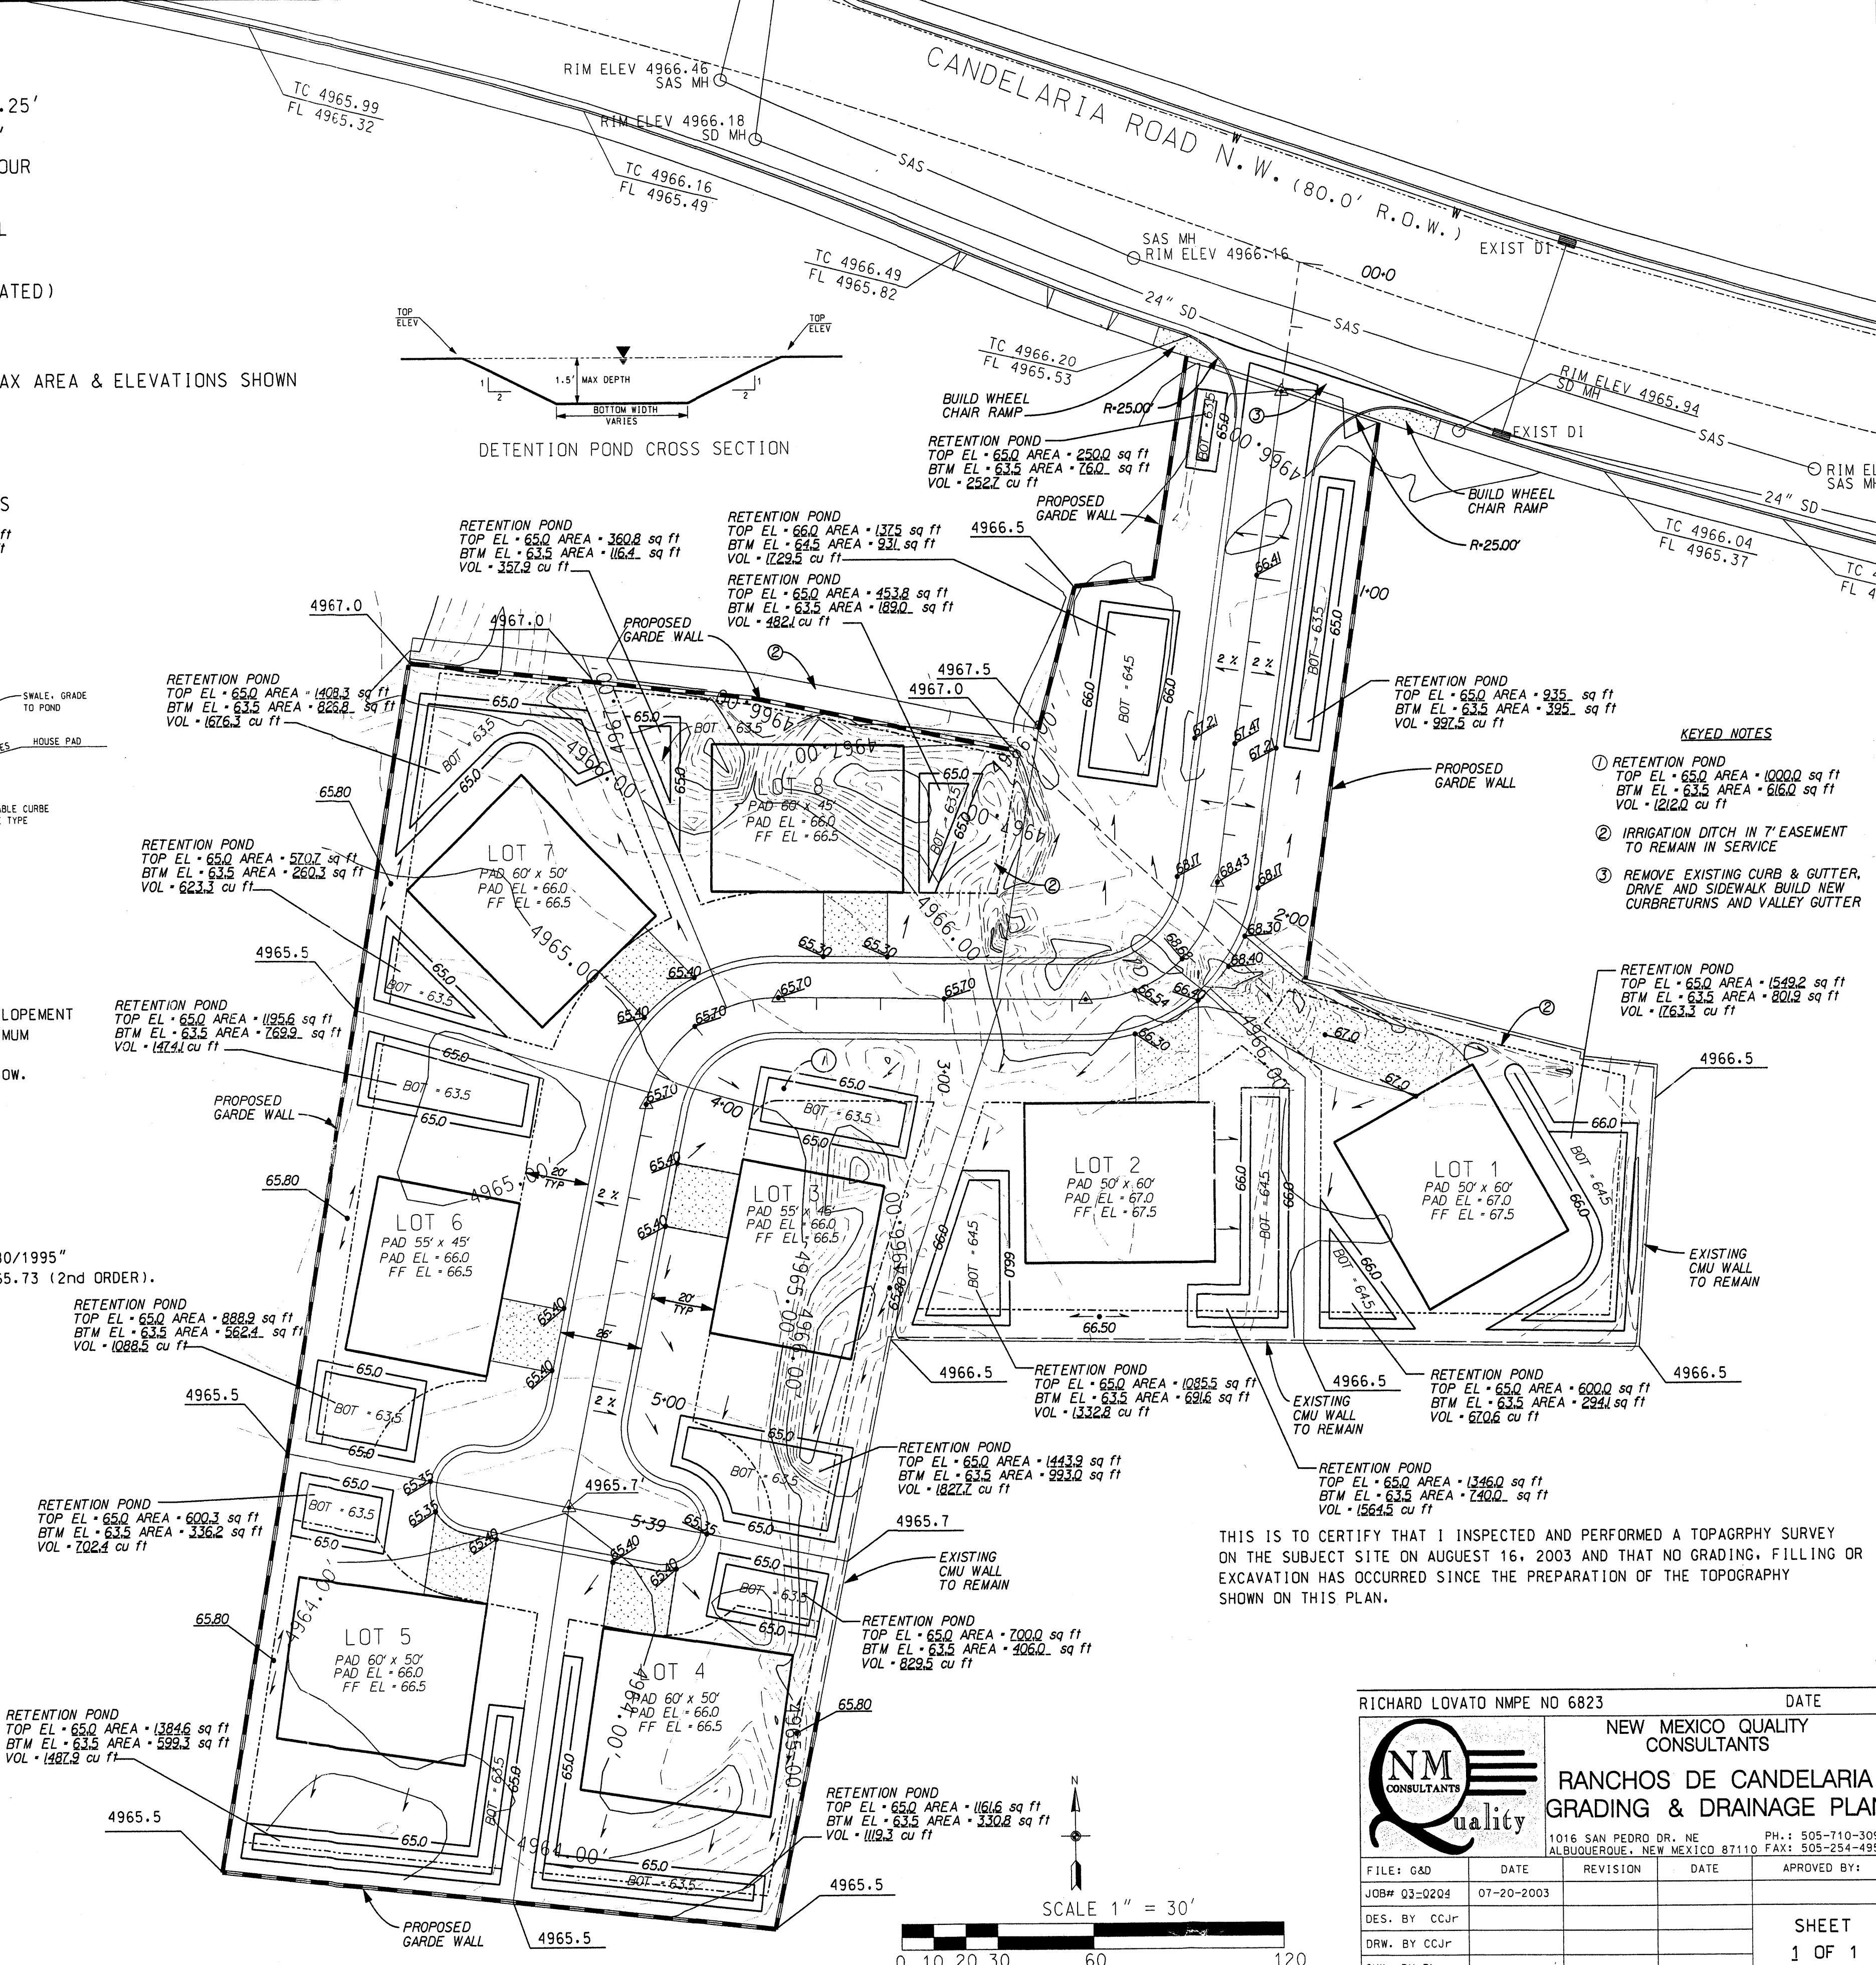

- KEYED NOTES
1. RETENTION POND TOP EL. 65.0 AREA. 1000.0 sq ft BTM EL. 63.5 AREA. 816.0 sq ft VOL. 182.0 cu ft
 2. IRRIGATION DITCH IN 7' EASEMENT TO REMAIN IN SERVICE
 3. REMOVE EXISTING CURB & GUTTER, DRIVE AND SIDEWALK BUILD NEW CURB RETURNS AND VALLEY GUTTER

THIS IS TO CERTIFY THAT I INSPECTED AND PERFORMED A TOPOGRAPHY SURVEY ON THE SUBJECT SITE ON AUGUST 16, 2003 AND THAT NO GRADING, FILLING OR EXCAVATION HAS OCCURRED SINCE THE PREPARATION OF THE TOPOGRAPHY SHOWN ON THIS PLAN.

RICHARD LOVATO NMPE NO 6823 DATE

NEW MEXICO QUALITY CONSULTANTS





















RANCHOS DE CANDELARIA GRADING & DRAINAGE PLAN

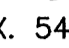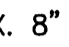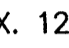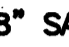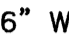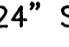1016 SAN PEDRO DR. NE ALBUQUERQUE, NEW MEXICO 87110 PH. 505-710-3099 FAX: 505-254-4952

FILE: CAD	DATE	REVISION	DATE	APPROVED BY:
JOB# Q3-0204	07-20-2003			
DES. BY CCJR				
DRW. BY CCJR				
CHK. BY RL				

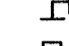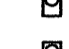
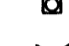
SHEET 1 OF 1

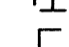LEGEND

-  EXISTING SAS MANHOLE
-  EXISTING SD MANHOLE
-  EXISTING STORM SEWER
-  EXISTING SANITARY SEWER LINE
-  EXISTING WATER LINE
-  NEW SANITARY SEWER LINE
-  NEW WATER LINE
-  NEW STORM SEWER
-  NEW SAS SERVICE
-  NEW WATER SERVICE
-  NEW SAS MANHOLE
-  STORM SEWER MANHOLE
-  BENT
-  SINGLE SERVICE METER
-  DOUBLE SERVICE METER
-  NEW GATE VALVE
-  NEW FIRE HYDRANT
-  TEE
-  CAP (WL)
-  NEW CATCH BASIN

NOTE:

NO PARKING SIGNS SHALL BE INSTALLED ON ONE SIDE OF STREET AND HAMMERHEAD.

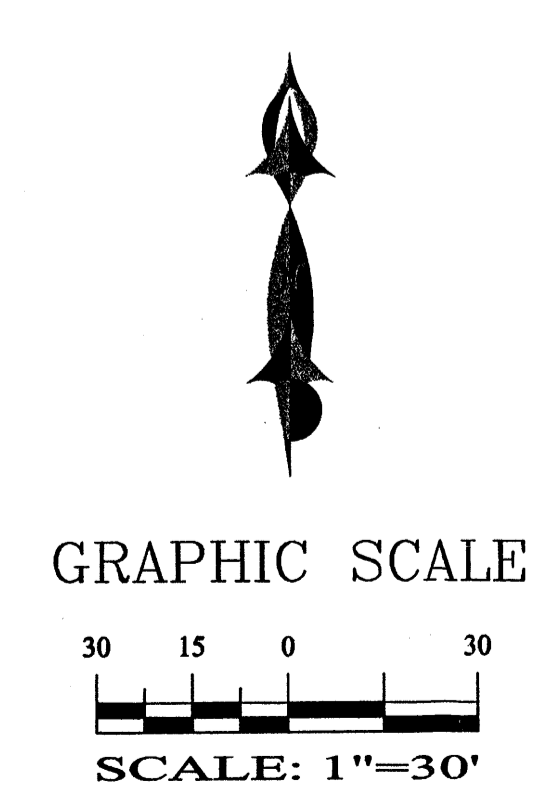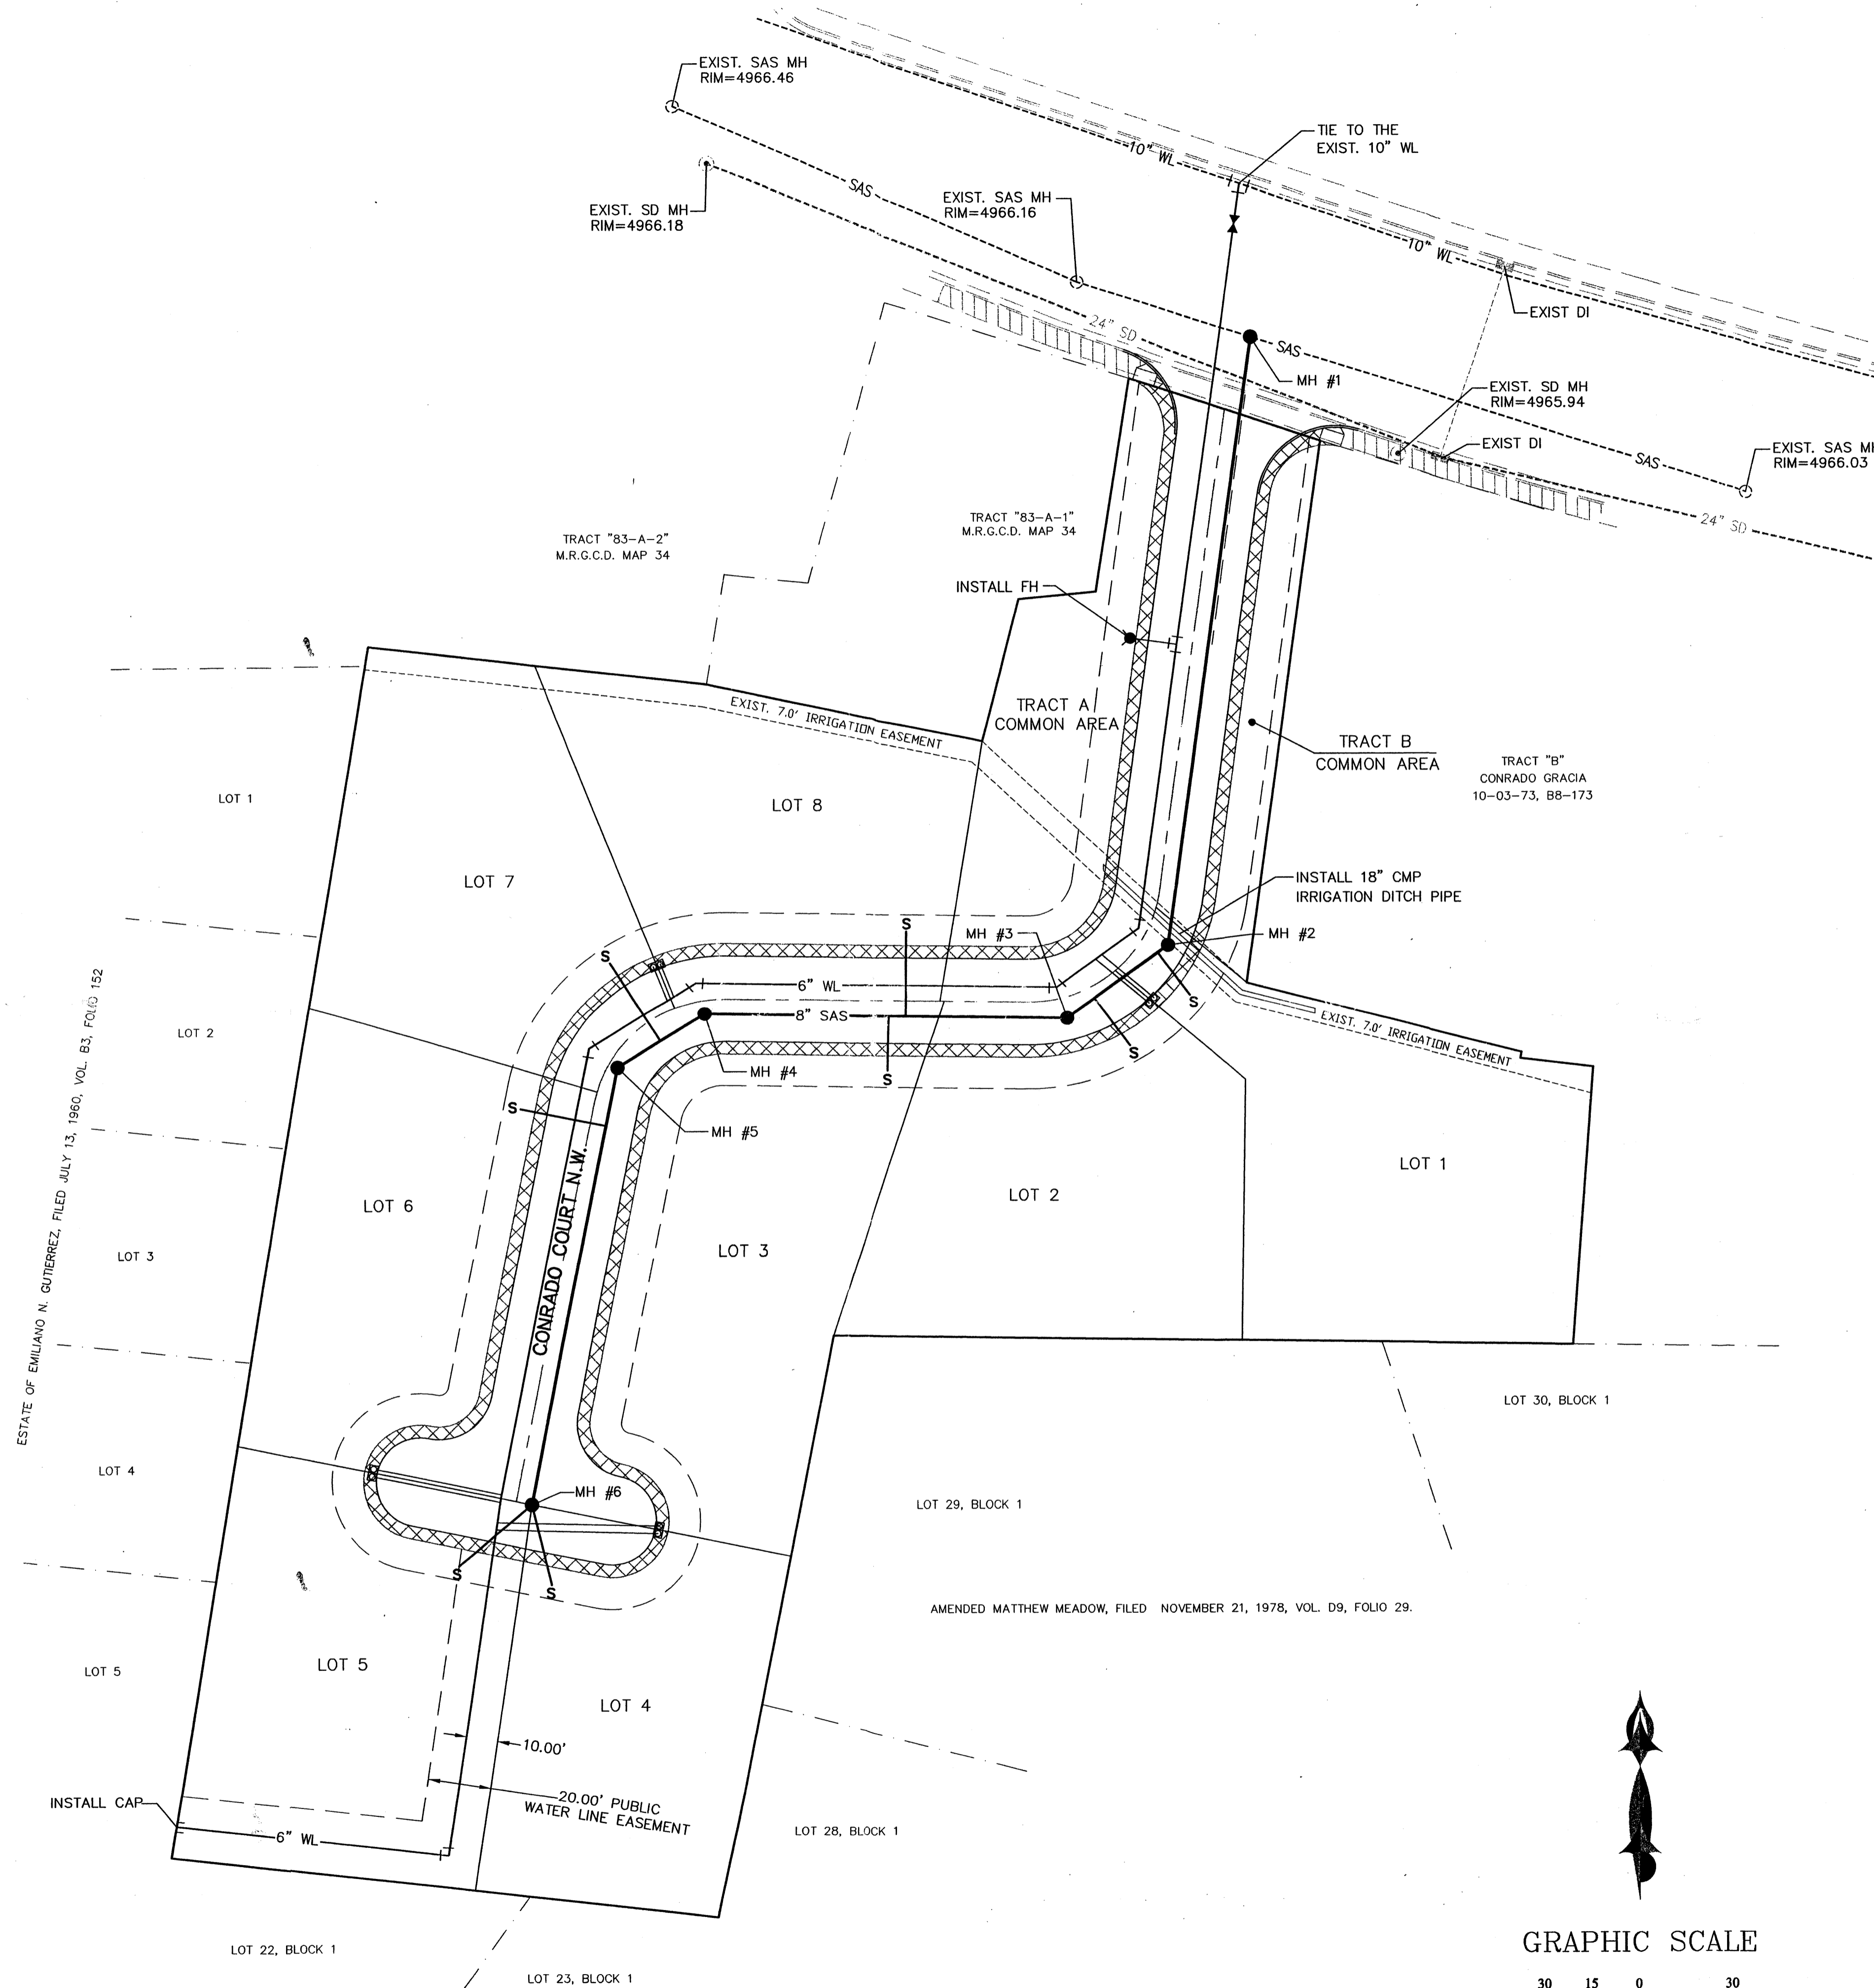

SHAHAB BIAZAR
P.E. #13479

4416 ANAHEIM AVE., NE
ALBUQUERQUE, NEW MEXICO 87113
(505)899-5570

RANCHO DE CANDELARIA MASTER UTILITY PLAN			
DRAWING:	DRAWN BY:	DATE:	SHEET #
200315-MU.DWG	SBB	05-28-2004	4 OF 4

LAST REVISION: 05-28-2004

SITE DEVELOPMENT PLAN FOR BUILDING DEPARTMENT: 3604 CONRADO LANE NW




PROJECT #: 1009916
DATE: 12-18-13 (SBP)

SHEET INDEX


DRB1	VICINITY MAP, SITE PLAN, UTILITY PLAN, DRB SUBMITTAL SIGNOFF APPROVAL
DRB2	PRELIMINARY GRADING AND DRAINAGE PLAN, LANDSCAPE PLAN, BUILDING ELEVATIONS
DRB3	RANCHO DE CANDELARIA SUB DIVISION DEVELOPMENT PLAN PROJECT NUMBER 1002798
SUB DIVISION DEVELOPMENT PLAN	

DEVELOPMENT REVIEW BOARD SIGNOFF APPROVAL

TRAFFIC ENGINEER, TRANSPORTATION DIVISION	DATE
PARKS AND RECREATION	DATE
ABCWJA	DATE
CITY ENGINEER	DATE
ENVIRONMENTAL HEALTH (CONDITIONAL)	DATE
SOLID WASTE MANAGEMENT	DATE
DRB CHAIRPERSON, PLANNING DEPARTMENT	DATE

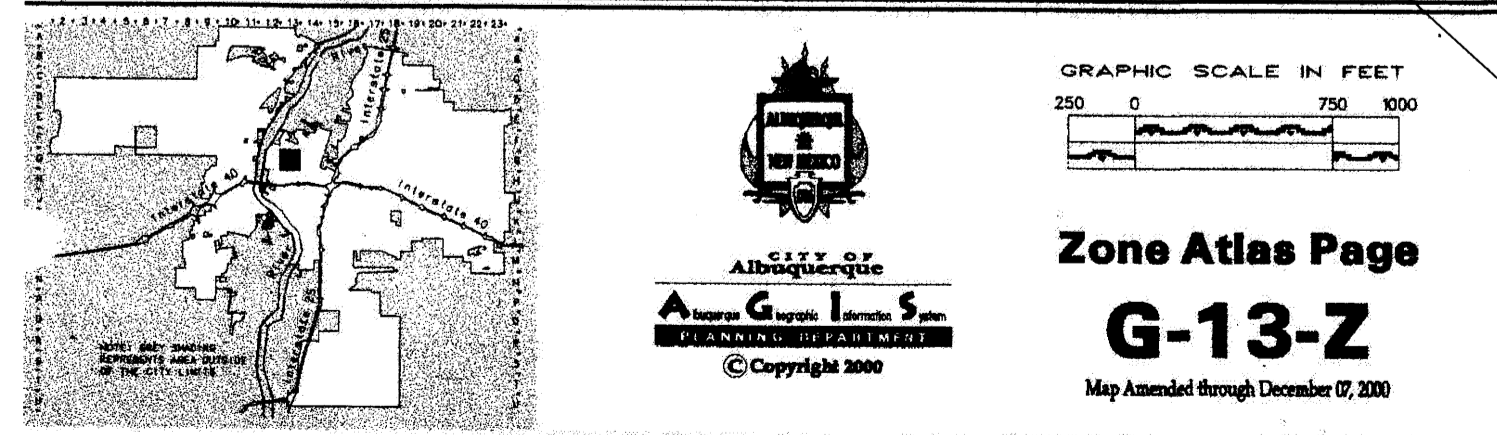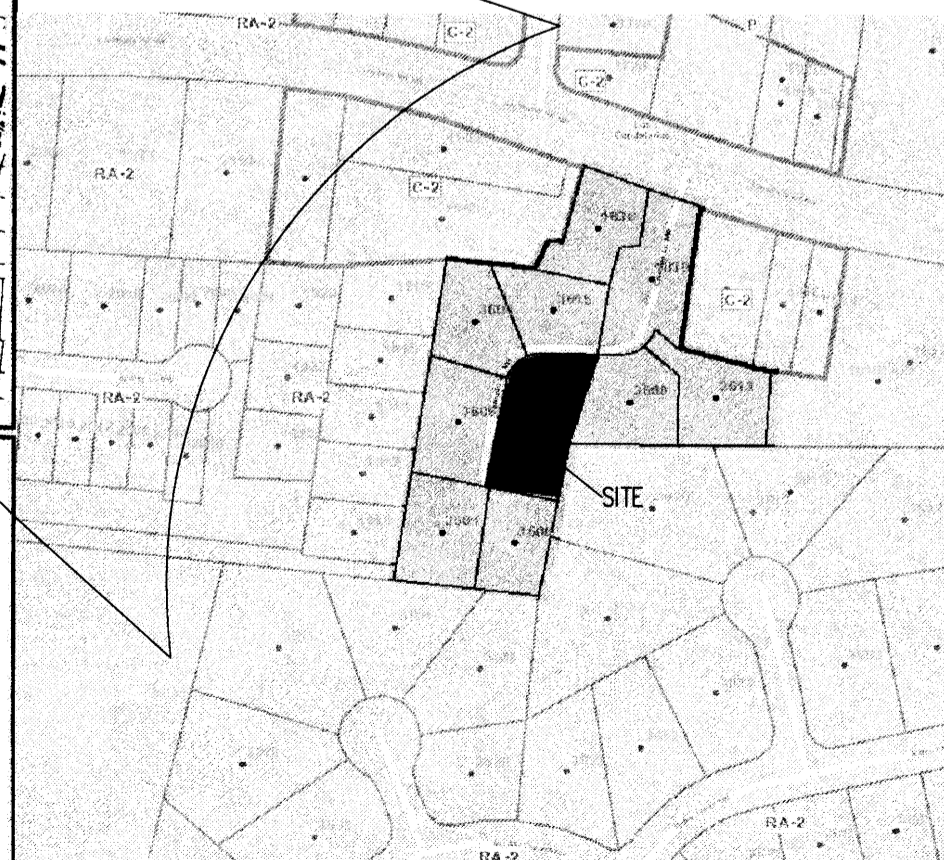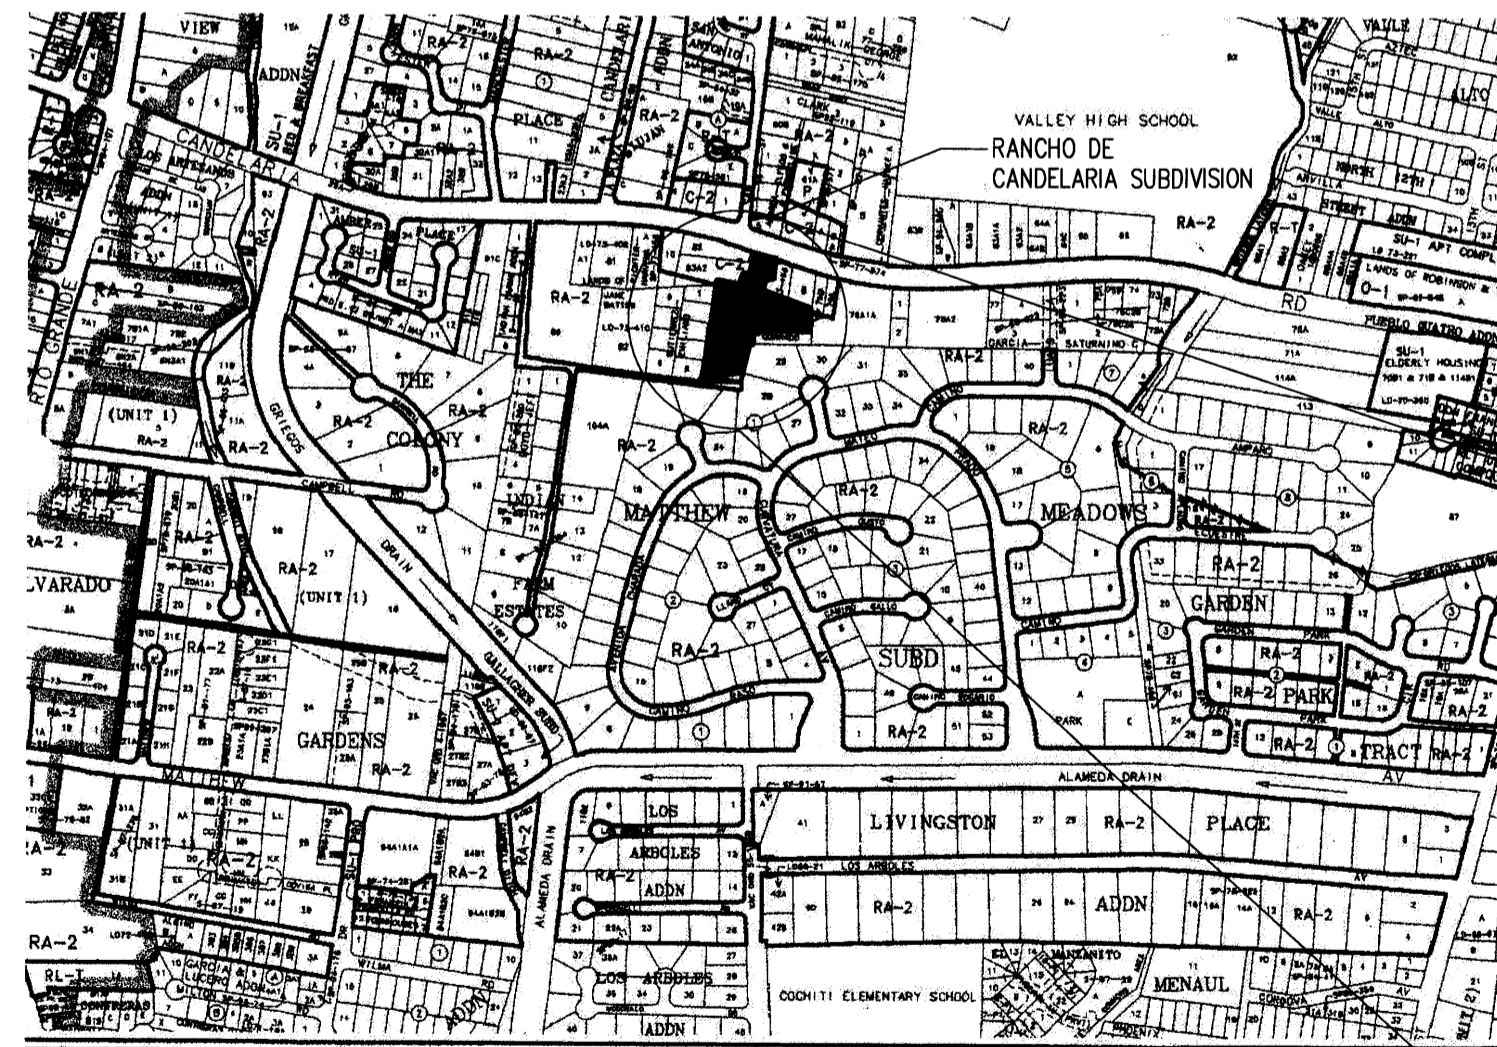

NORTH
A1 ZONING/VICINITY MAP
NTS

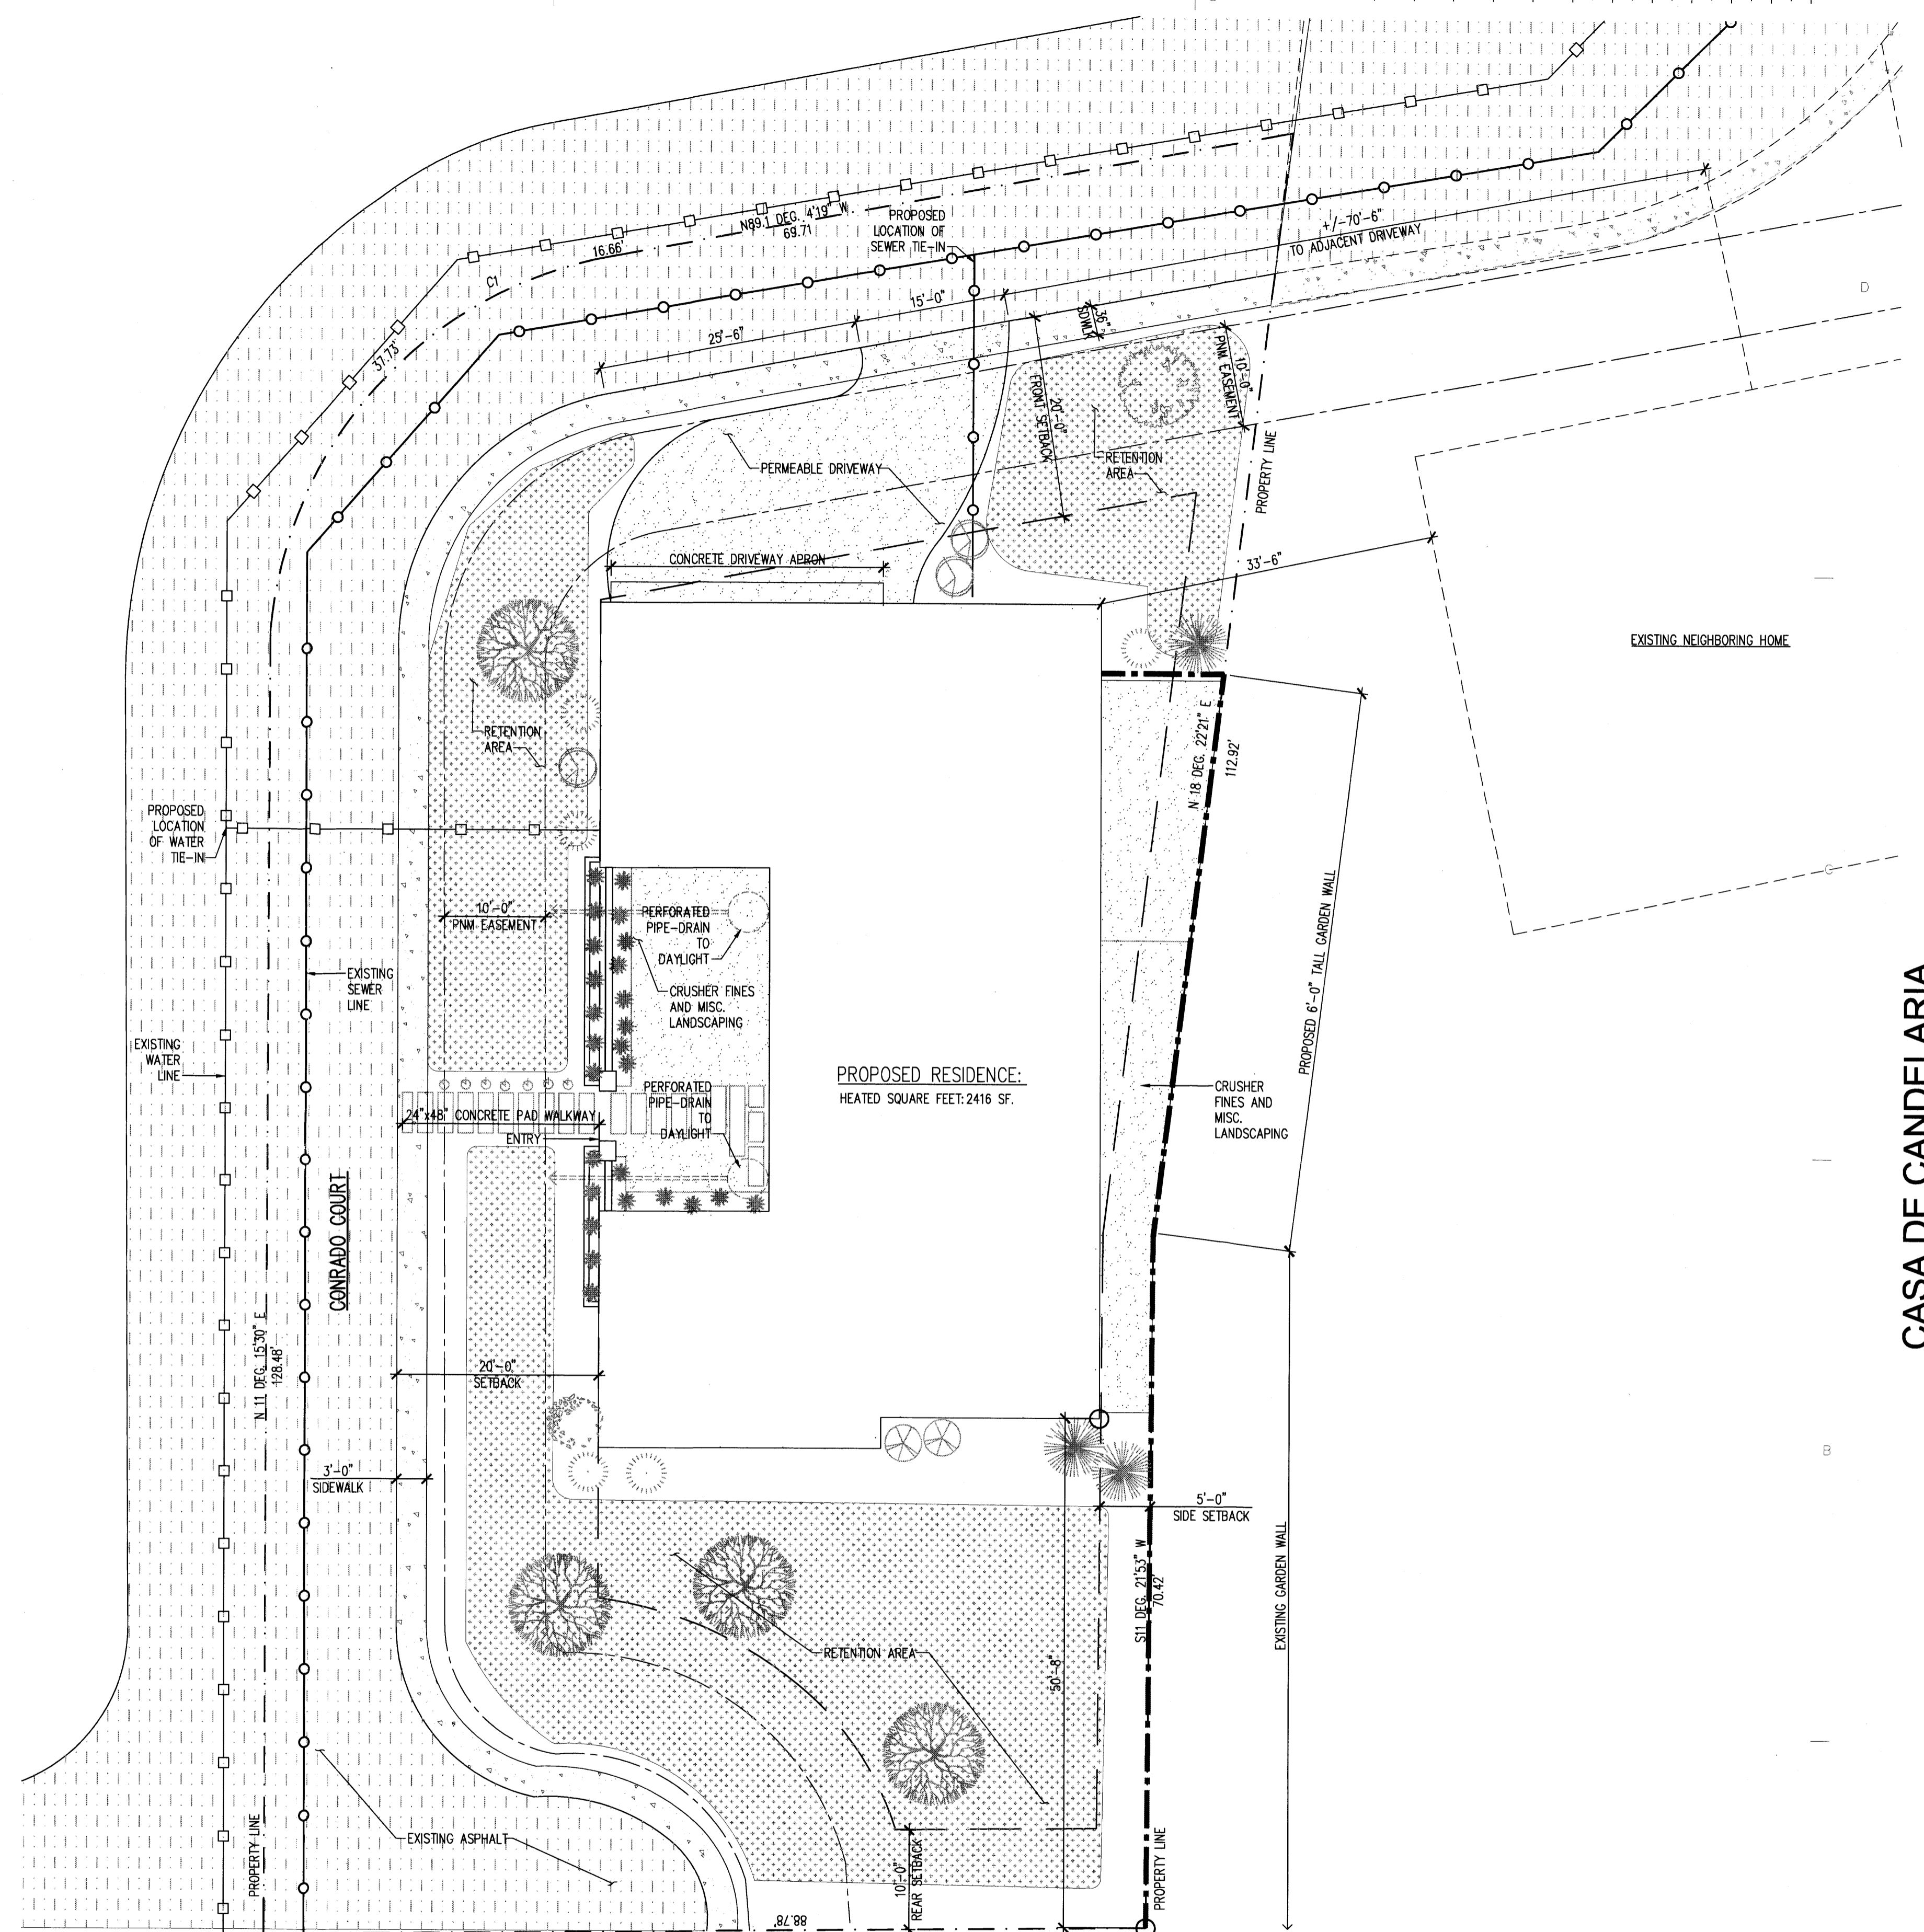


SITE/ UTILITY PLAN GENERAL NOTES

1. LANDSCAPE MAINTENANCE WILL BE THE RESPONSIBILITY OF THE PROPERTY OWNER.
2. SPRINKLER SYSTEM, DRIP SYSTEM, AND BACKFLOW SHALL BE IN ACCORDANCE WITH LOCAL PLUMBING CODES.
3. ALL LIGHT FIXTURES SHALL BE OF FULL CUT OFF TYPE, TO PREVENT FUGITIVE LIGHT, MOUNTED NO HIGHER THAN 16'.
4. FIRE HYDRANT LOCATED 196'-0" FROM PROPOSED HOME.

SITE/UTILITY PLAN- LEGEND

SET BACK LINE	---
PROPERTY LINE	- - - - -
WATER LINE	□ □ □ □ □
SEWER LINE	○ ○ ○ ○ ○
EASEMENT LINE	- · - · -
GARDEN WALL	—●—●—●—

GRAPHIC SCALE

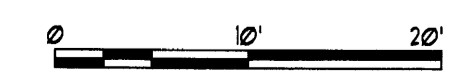


NORTH
A2 SITE/UTILITY PLAN
1"=10'-0"

CASA DE CANDELARIA
3604 CONRADO LANE NW
Albuquerque, NM

ZIPiDESIGN Studio
220 HERMOSA NE.
ALBUQUERQUE, NM 87106
(518) 364-9114

ISSUE: DRB Submittal
DRAWN: [blank]
CHECKED: [blank]
DATE: 12/09/2013
DRB1
0312

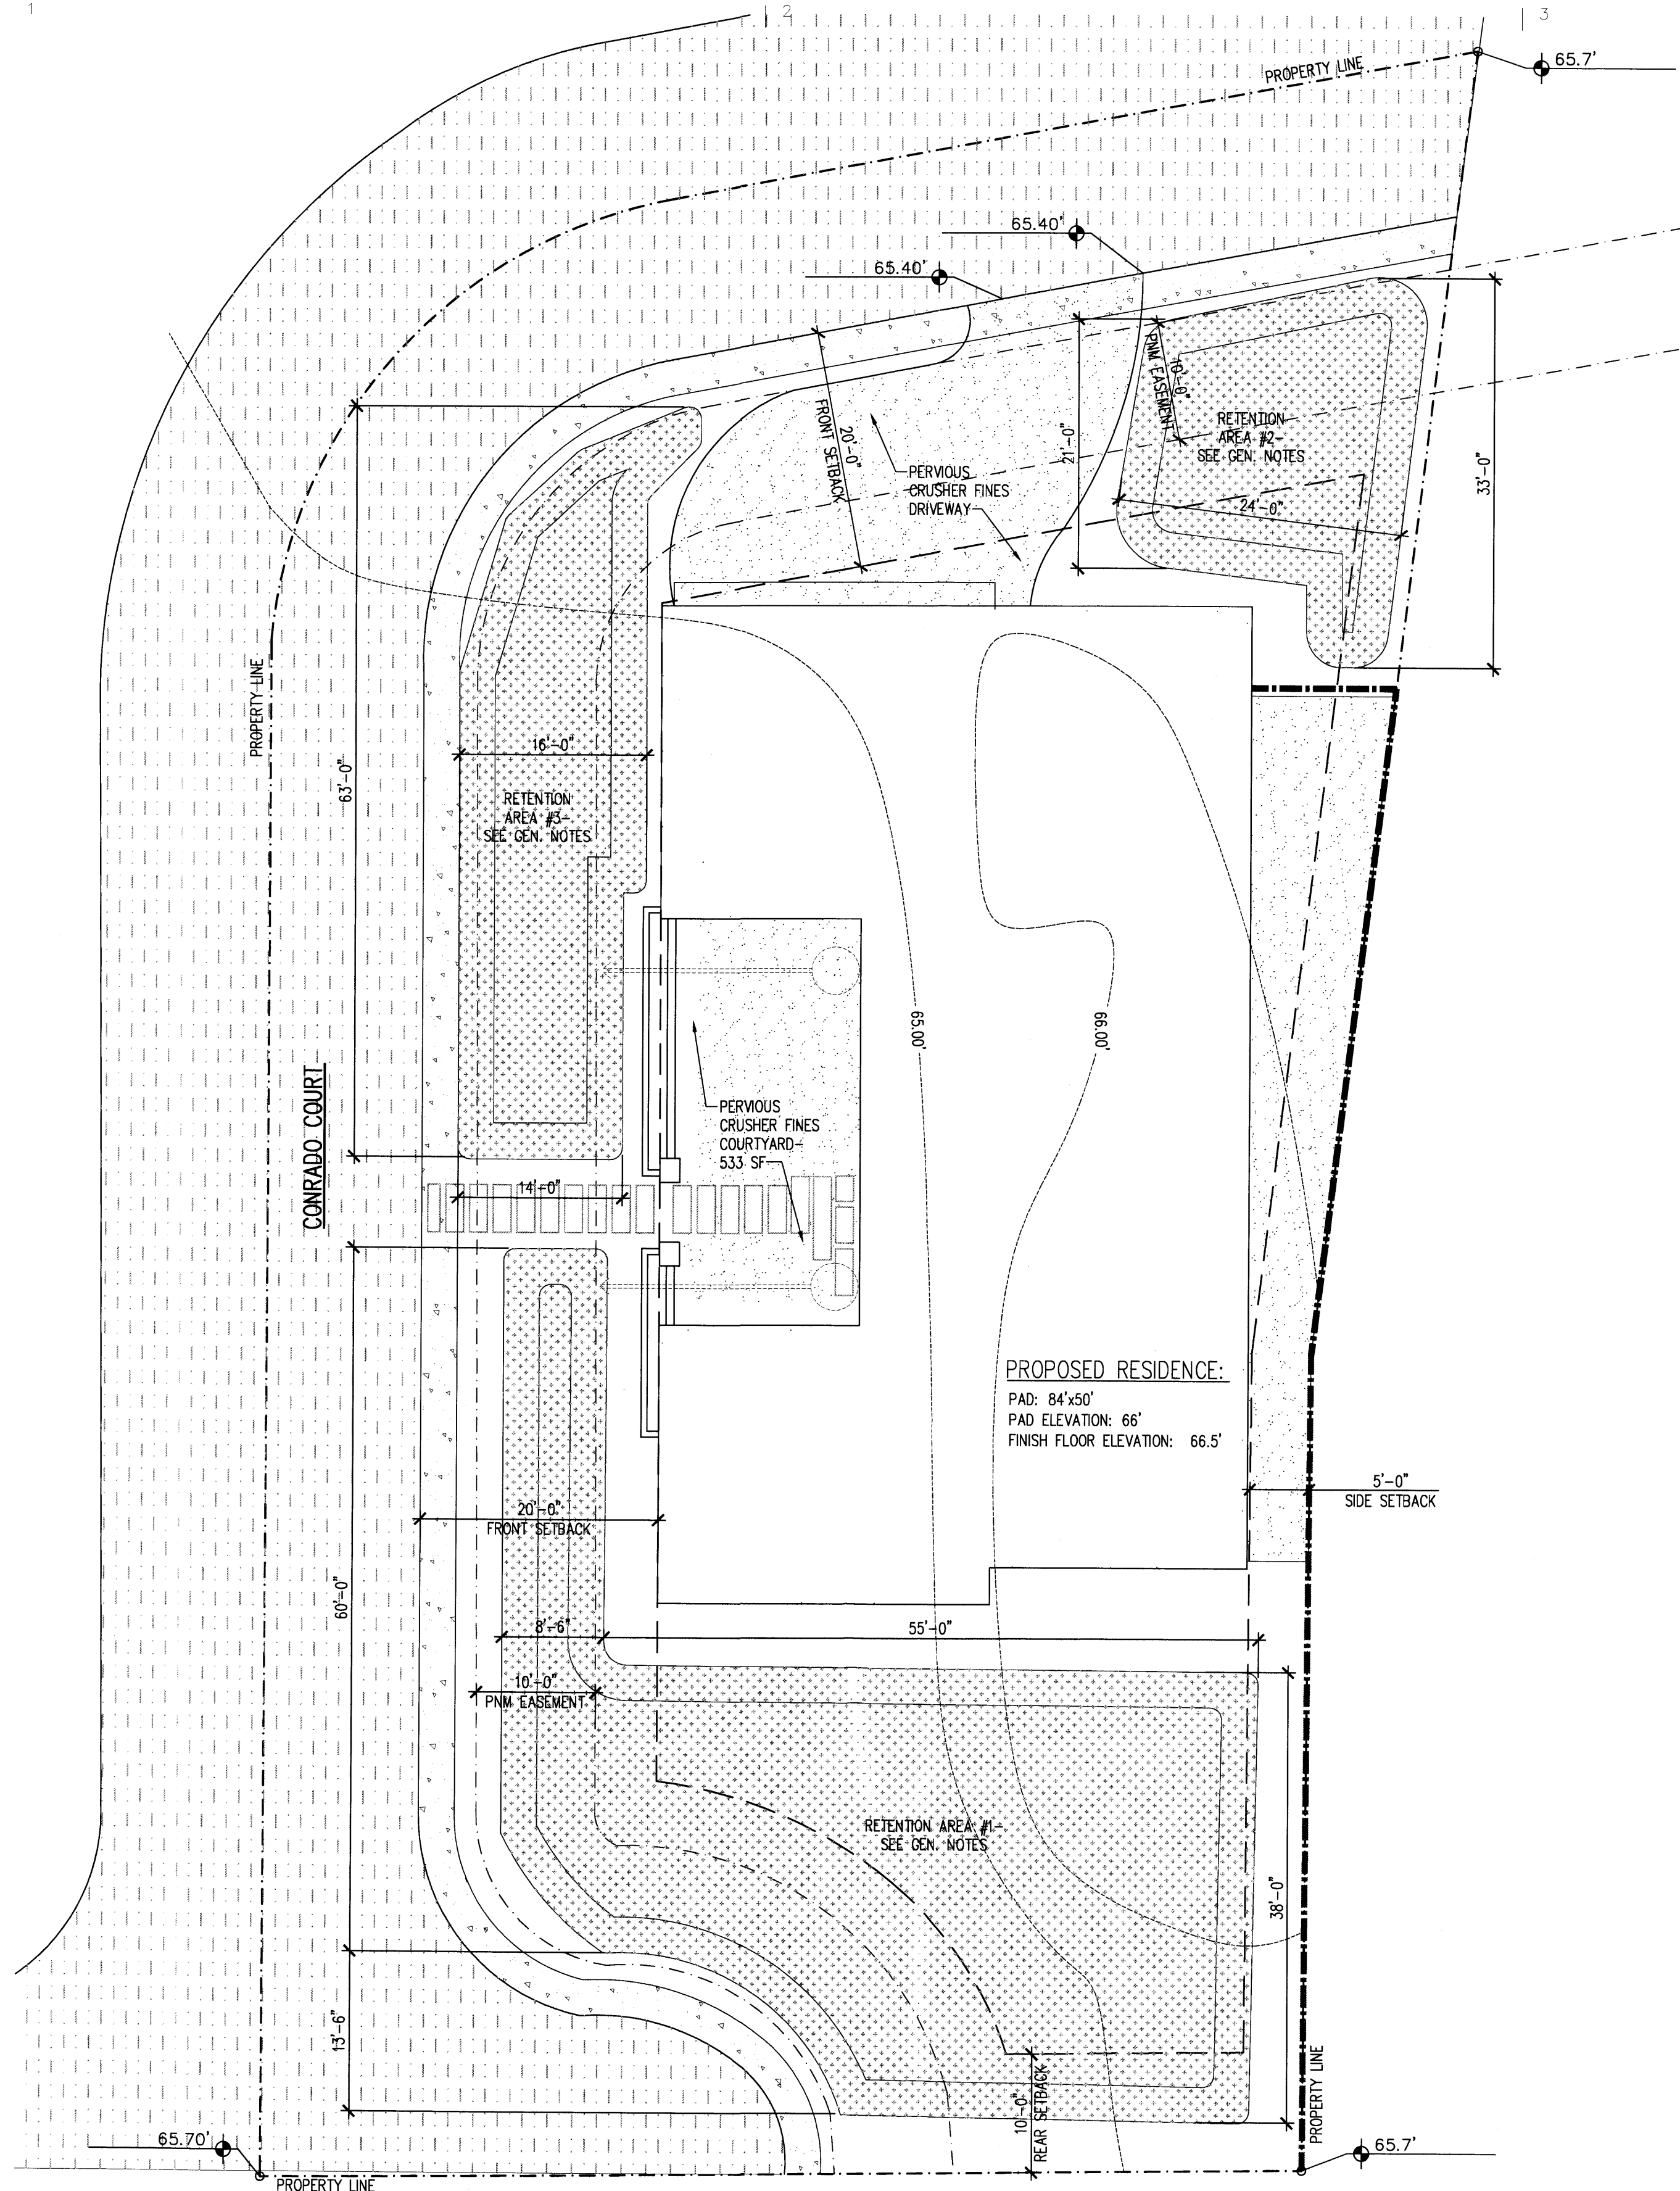

GRADING AND DRAINAGE-NOTES

- SEE ATTACHED COPY OF SUBDIVISION SITE PLAN FOR ADDITIONAL EXISTING TOPOGRAPHY CONDITIONS.
- PROPOSED COURTYARD SURFACE TO BE OF A PERVIOUS MATERIAL- PIPE DRAIN TO RETENTION.
- PROPOSED DRIVEWAY TO BE OF A PERVIOUS CRUSHER FINES MATERIAL.

RETENTION VOLUME CALCULATIONS:


RETENTION AREA#1= TOP ELEV.=65.0' AREA=2,339.6 SF.
 BTM ELEV.=63.5' AREA= 1598.1 SF.
 VOLUME: 2,853.35 CU.FT.

RETENTION AREA#2= TOP ELEV.=65.0' AREA=601 SF.
 BTM ELEV.=63.5' AREA= 325 SF.
 VOLUME: 694.4 CU.FT.

RETENTION AREA#3= TOP ELEV.=65.0' AREA=860.6 SF.
 BTM ELEV.=63.5' AREA= 435.9 SF.
 VOLUME: 972.4 CU.FT.

TOTAL SITE RETENTION CAPACITY: 4620.3 CU.FT.


GRADING AND DRAINAGE-LEGEND

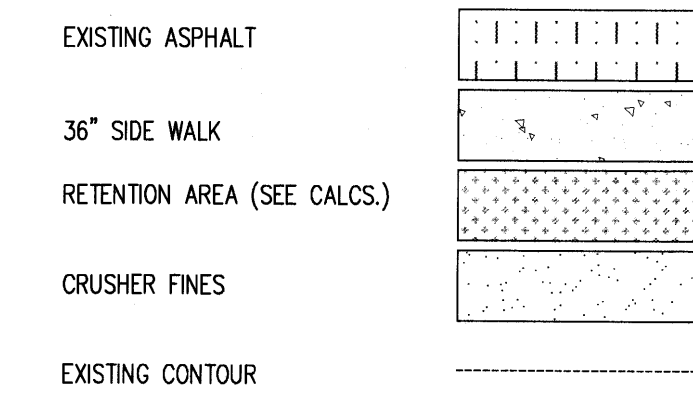

NORTH

A1 PRELIMINARY GRADING AND DRAINAGE PLAN

1"=10'-0"

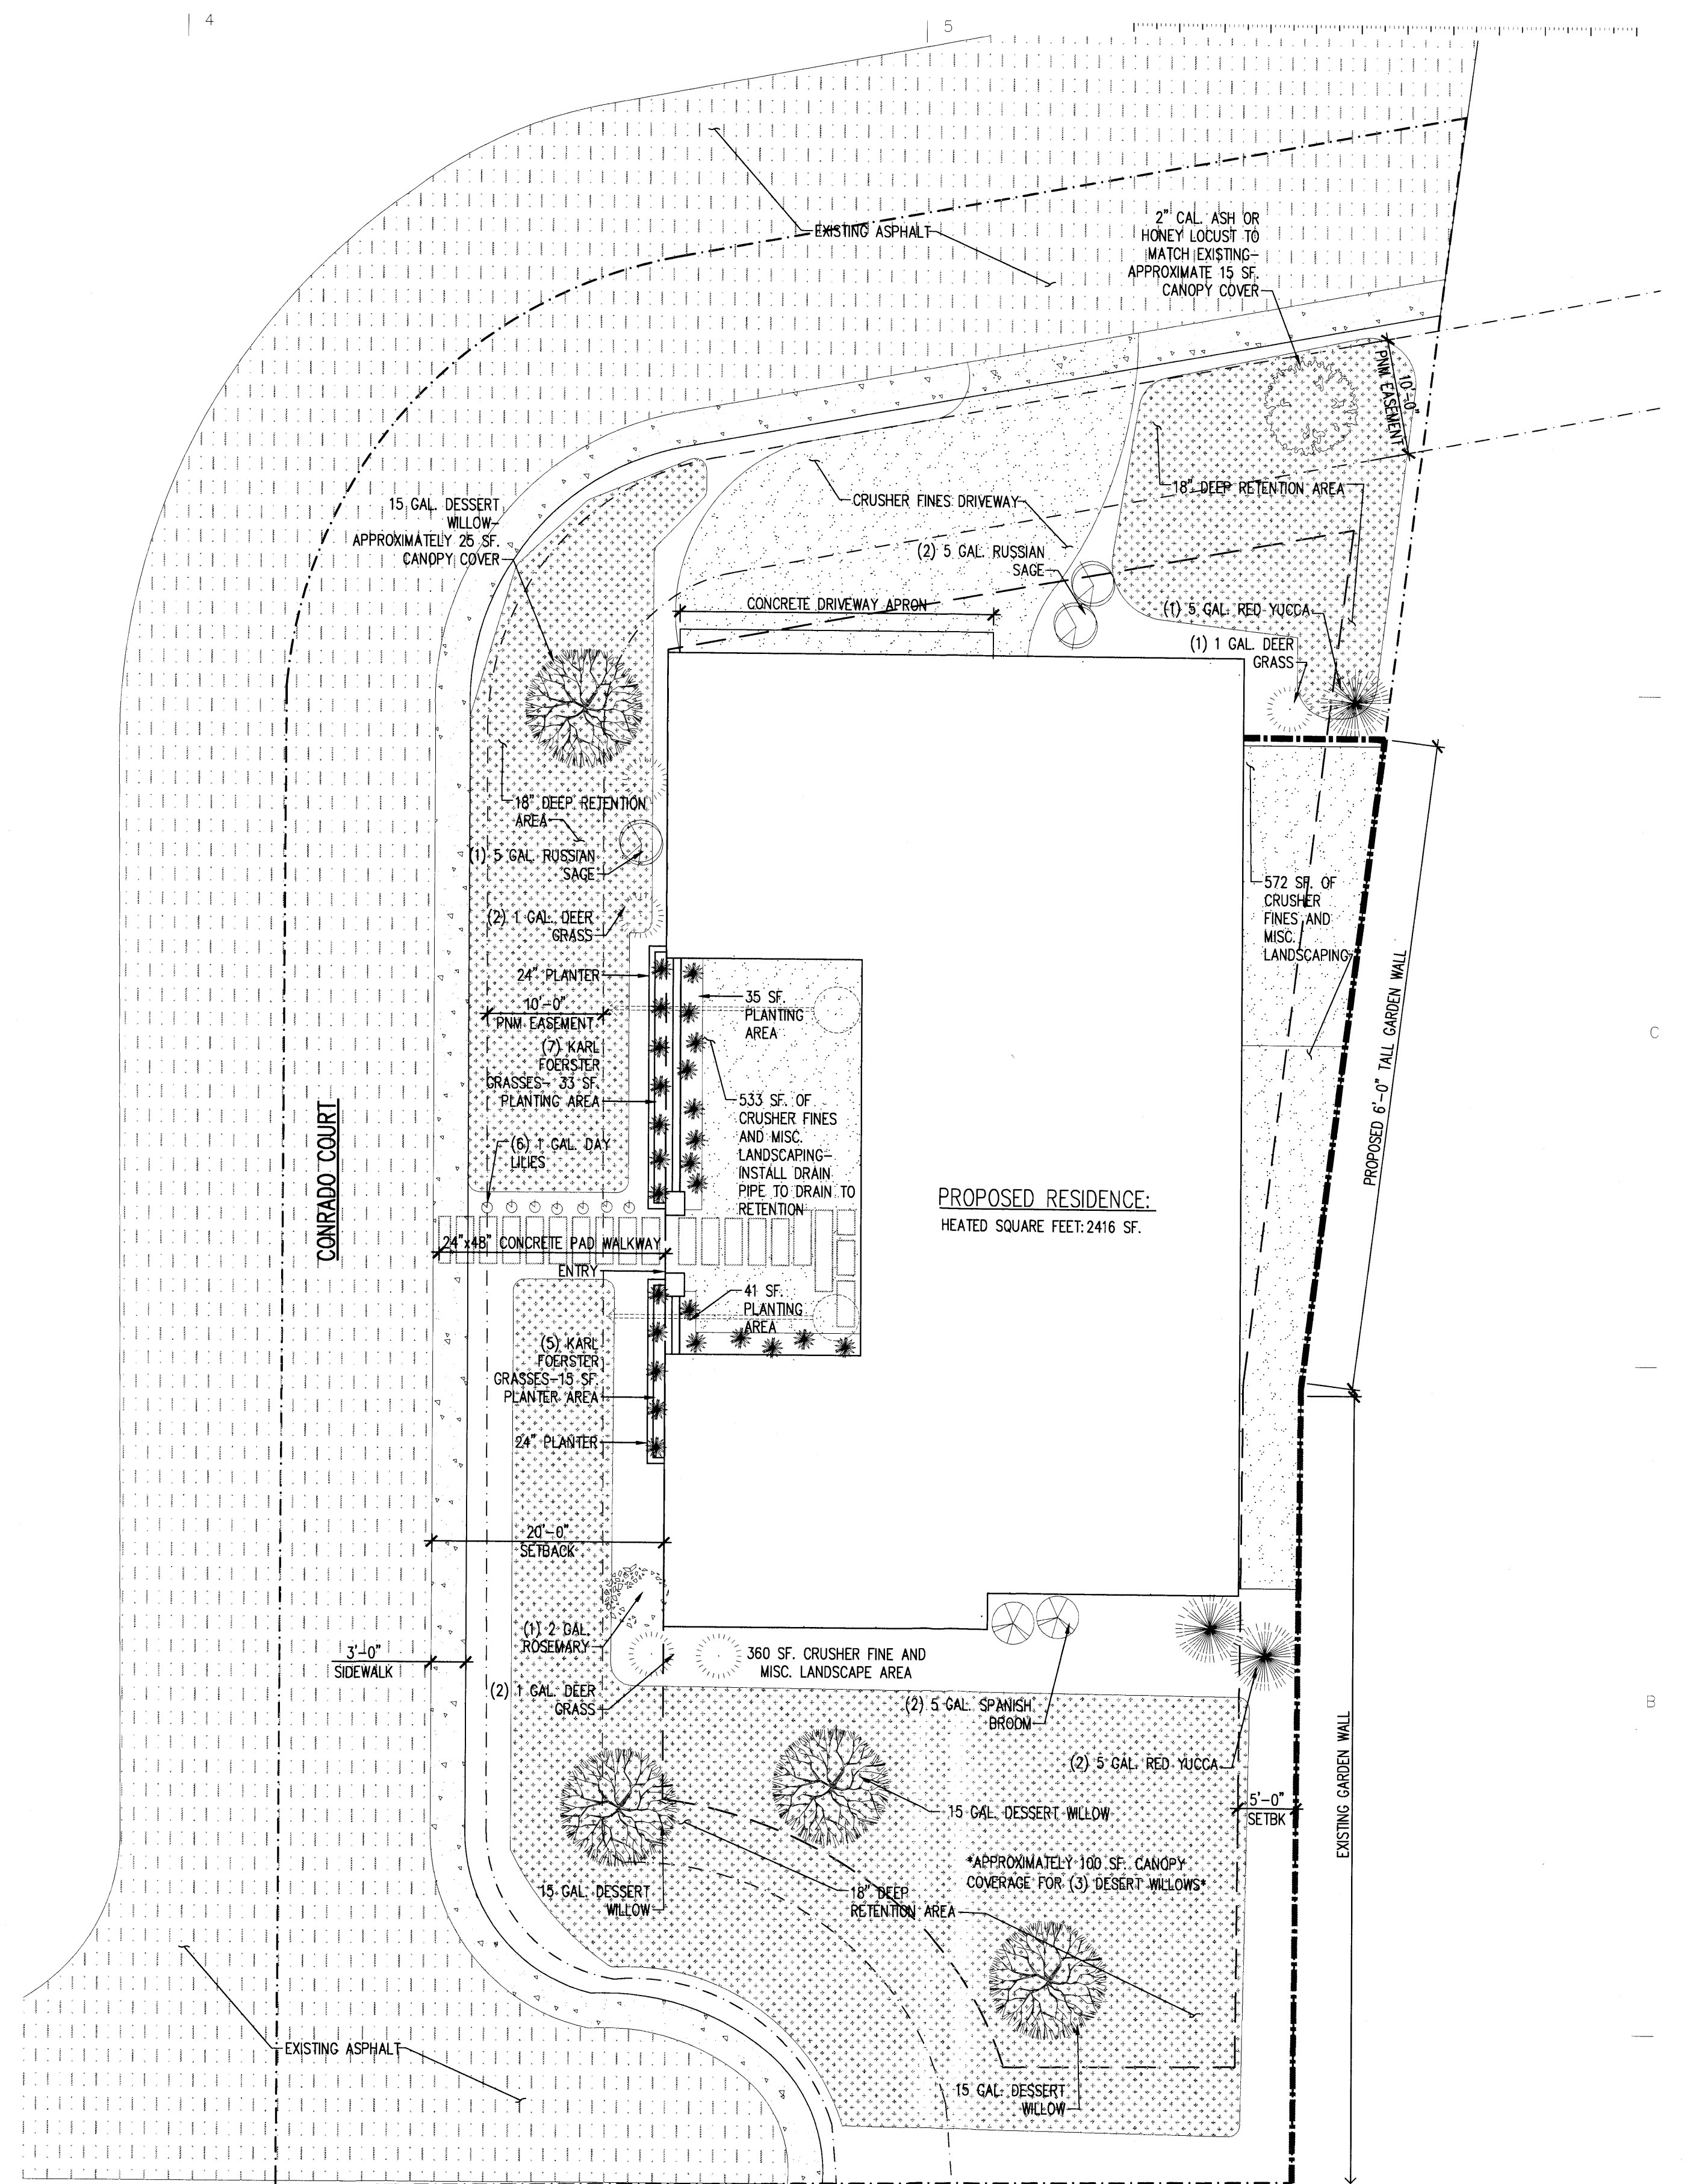

LANDSCAPE -NOTES

- LANDSCAPE MAINTENANCE WILL BE THE RESPONSIBILITY OF THE PROPERTY OWNER.
- SPRINKLER SYSTEM, DRIP SYSTEM, AND BACKFLOW SHALL BE IN ACCORDANCE WITH LOCAL PLUMBING CODES.
- ALL LANDSCAPING TO COMPLY WITH THE REQUIREMENTS OF CITY OF ALBUQUERQUE WATER CONSERVATION AND WASTE WATER ORDINANCE.
- RETENTION AREAS TO BE A MIX OF MISCELLANEOUS DROUGHT TOLERANT GROUND COVER AND GRAVEL (SANTA FE BROWN OR SIMILAR.)
- ALL NON-RETENTION AREA TO BE MIX OF CRUSHER FINES AND MISC. DROUGHT TOLERANT GROUND COVER.

NORTH

A2 LANDSCAPE PLAN

1"=10'-0"

CASA DE CANDELARIA
 3604 CONRADO LANE NW
 Albuquerque, NM

ziptiedesign Studio
 220 HERMOSA, NE.
 ALBUQUERQUE, NM 87108
 (518) 364-9914

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GRAPHIC SCALE




DRB2

0312


GENERAL NOTES - ELEVATIONS

1. STUCCO COLOR #1 TO BE DRYVIT 'STONE GREY' 454A
2. STUCCO COLOR #2 TO BE DRYVIT 'AMARILLO WHITE' 113
3. WINDOWS TO BE PELLA ENDURACLAD COATING- PR0151 BROWN
4. GARAGE DOOR TO MATCH WINDOWS


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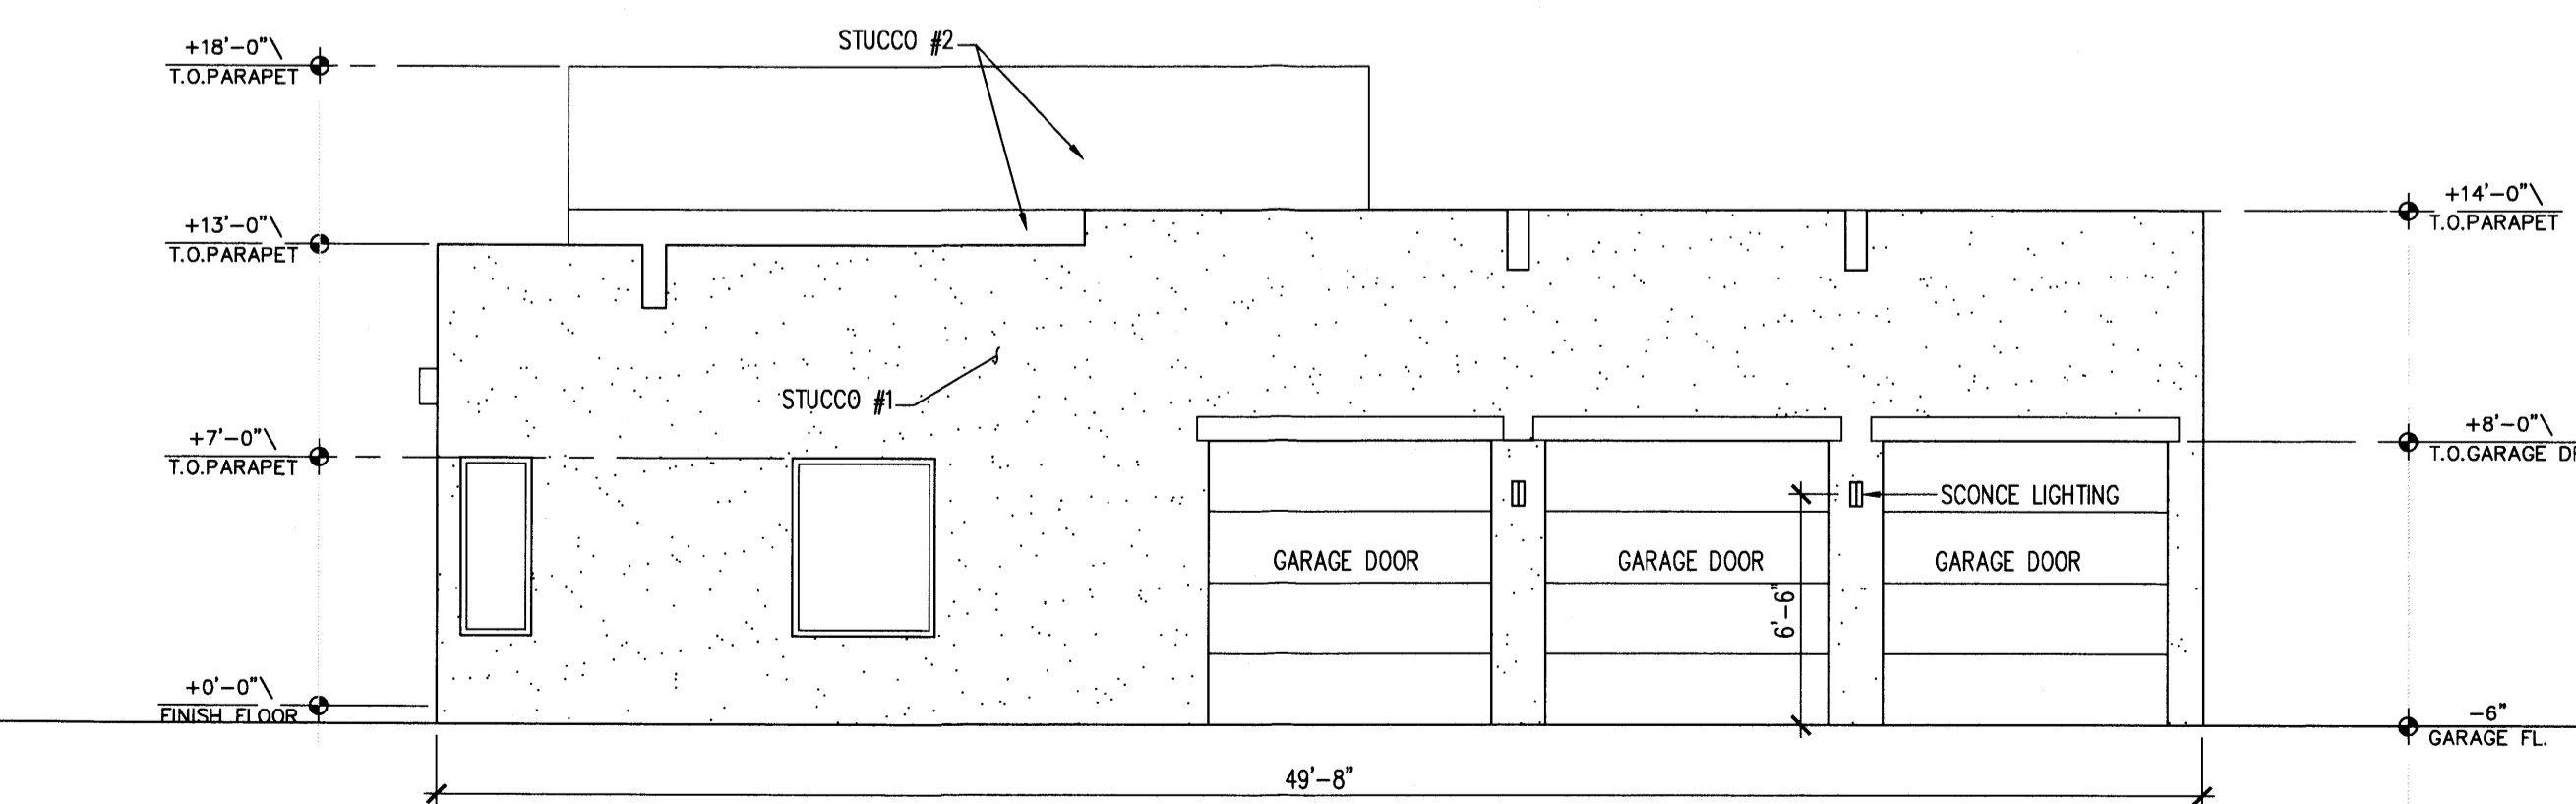
D1 WEST ELEVATION

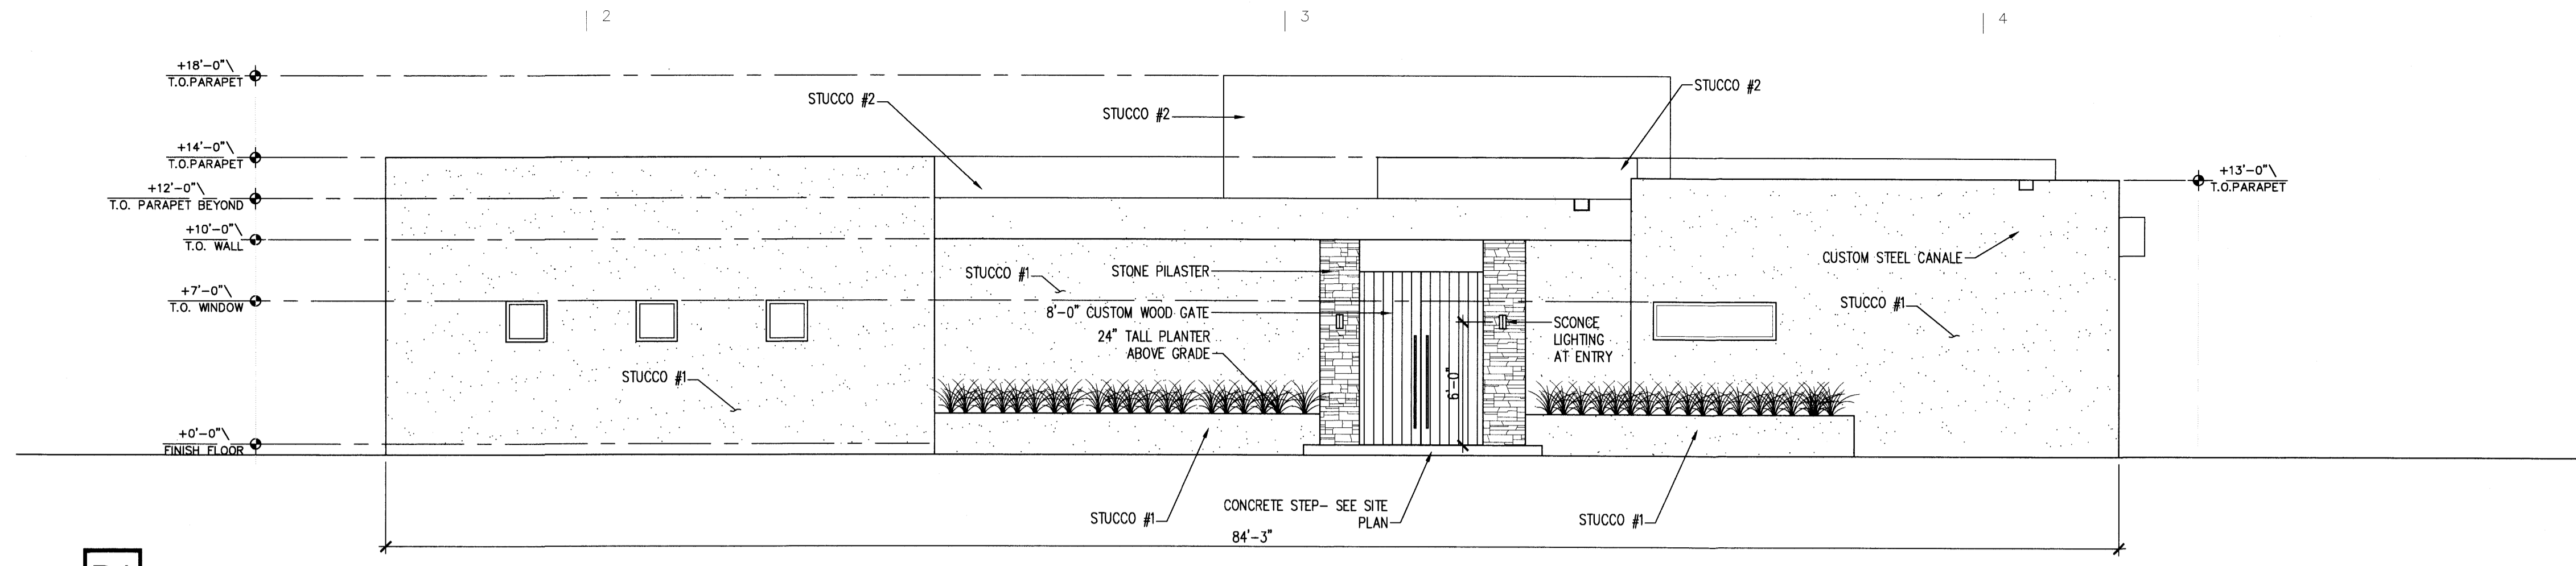

C1 SOUTH ELEVATION

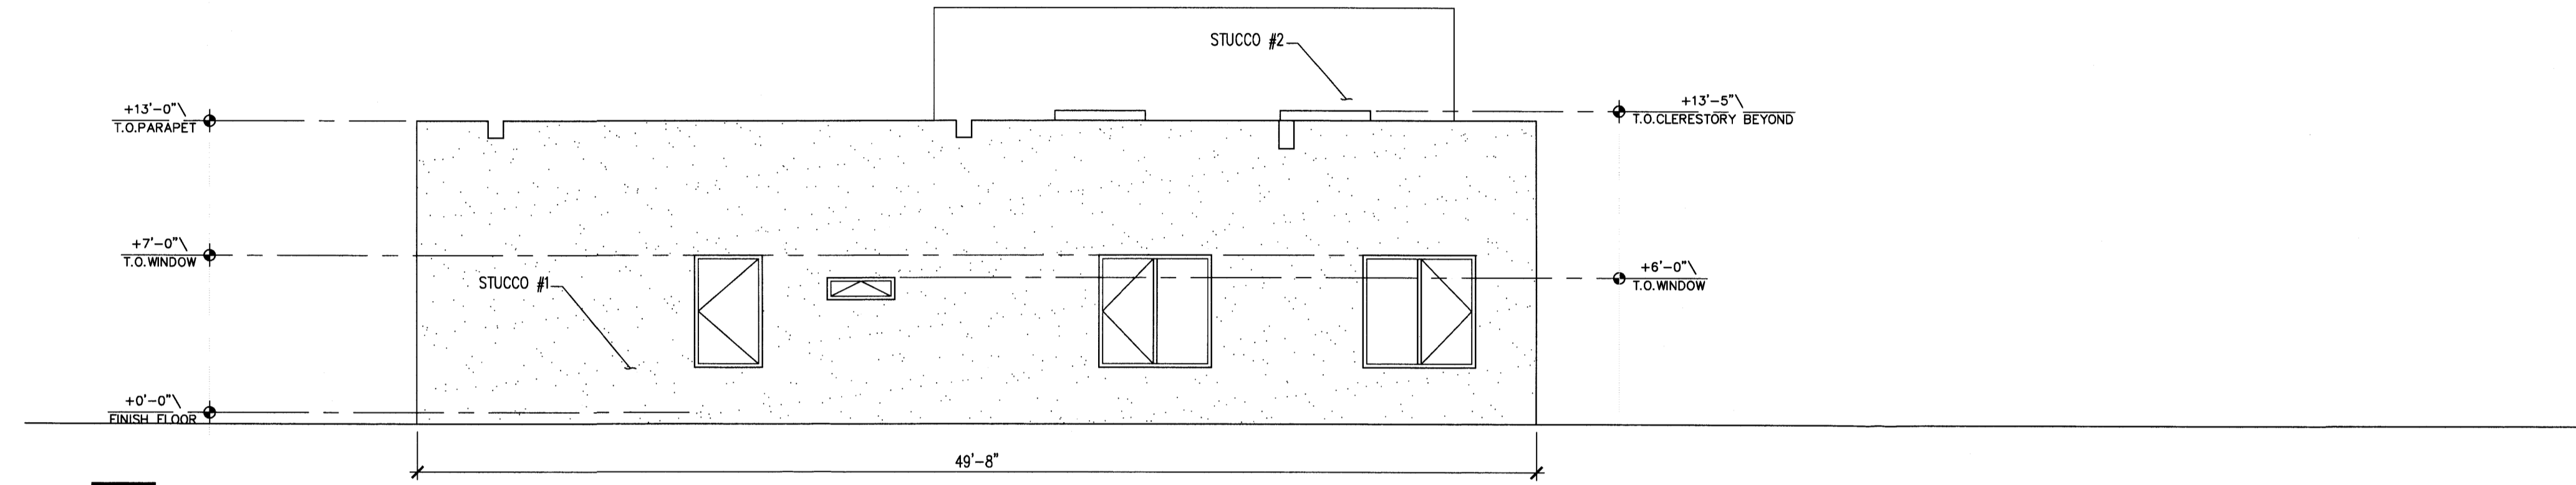

B1 EAST ELEVATION

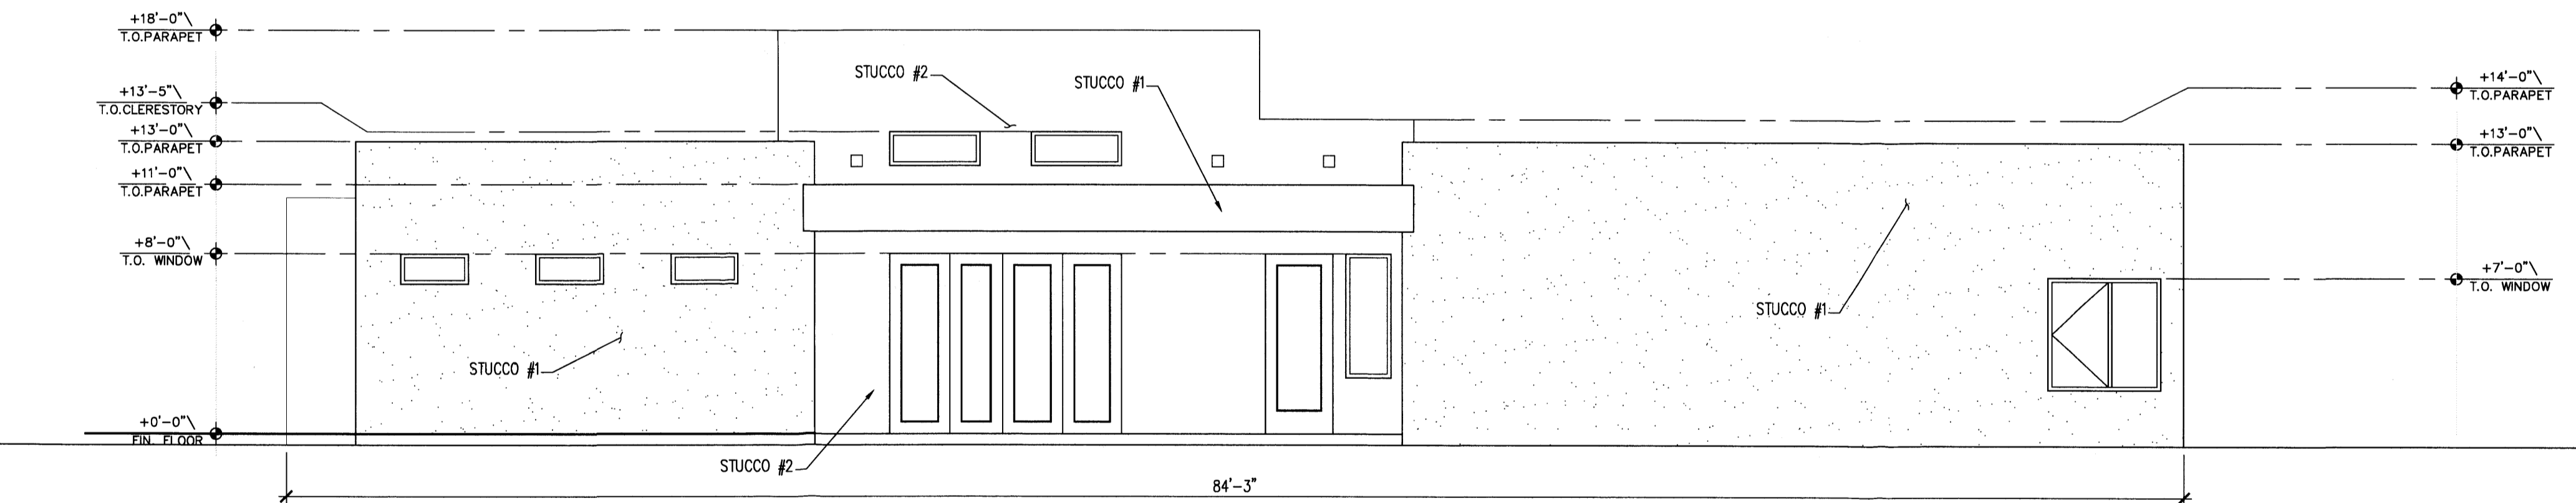

A1 NORTH ELEVATION

CASA DE CANDELARIA
3604 CONRADO LANE NW
Albuquerque, NM

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DRB3
0312



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