ELECTRICAL NORTHRIDGE ELEC. 328 RANCHITOS NW 110 4 Park Ave. SW Albuquerque, NM 87102 505-242-1859 (505) 898-7245

MECHANICAL DSL ASSOCIATES 299 Garcia Rd. NW ALBUQUERQUE, NM 87114 Albuquerque, NM 87114 (505) 980-0238

ADJACENT

BUILDING

ADJACENT

BUILDING

CONTRACTOR KIMCON INC. 405 DARTMOUTH SE ALBUQUERQUE, NM 87106 (505) 620-4993

CLEAR SIGHT TRIANGLE

ONE

CLEAR SIGHT TRIANGLE

TRUMBULL AVENUE SE R/W VARIES

/7 Str. A5-Z W

BELL AVENUE 50'-0" R/W

STACKING

15'-0"

**EXISTING BUILDING** 

PHASE 1

RISE & ROAST

COFFEE

NUSENDA

MEETING RM.

NUSENDA

CREDIT UNION

9 SPACES @ 8'-6" EA

EXISTING 6'-0" W. SIDEWALK

1. EXIST. 6" CONCRETE CURB AND GUTTER 2. EXIST. ASPHALT PAVEMENT

3. EXIST. BICYCLE RACK.

4. EXIST. CONCRETE SIDEWALK.

5. exist. 4" wide white parking stripe as shown, per local city code and STANDARDS.

6. EXIST. HANDICAP ACCESSIBLE AISLE STRIPPING PER LOCAL CITY CODE AND STANDARDS.

7. EXIST. INTERNATIONAL SYMBOL OF ACCESSIBILITY, CENTER IN PARKING SPACE.

8. EXIST. A.D.A. ACCESSIBLE CURB RAMP

9. EXIST. CONCRETE WHEEL STOP.

10. EXIST. HANDICAP PARKING SIGNAGE AT ALL HANDICAP SPACES, 1

11, EXIST. DUMPSTER INCLOSURE APPROVED BY CABQ

12. EXIST. FIRE HYDRANT.

13. EXIST. SITE LIGHT WITH CONCRETE BASE.

14. EXIST. MOTORCYCLE PARKING.

15. NEW 3'-0" HIGH STEEL SCREEN WALL

16. OUTDOOR PATIO WITH ACCESSIBLE PATH TO EXISTING EUBANK SIDEWALK. ALUM. SHADE STRUCTURE TO BE DESIGNED

17. NEW 12'-0" DRIVE-THRU LANE (7) CAR STACKING

18. CANOPY TO BE OPEN, NO ROOF. BEAMS CONNECT STRUCTURE TO BUILDING.

19. NEW WALL MOUNTED MENU-BOARD FOR COFFEE SHOP

20. NEW 3'-0" HIGH C.M.U. SCREEN-WALL ALONG PORTION OF DRIVE-THRU FACING EUBANK

21. 10'-0" MIN. CLEARANCE BAR SIGN

22. LIMIT OF PHASE 2 CONSTRUCTION

23. NEW CONCRETE CURB AND GUTTER

24. SINGLE POLE WITH "STOP" SIGN FACING TOWARDS DRIVE-THRU & "DO NOT ENTER" SIGN FACING TOWARDS DRIVE ISLE, PER CITY OF ALBUQUERQUE STANDARDS, SEE DETAIL 8 SHEET

25. POLE MOUNTED SITE LIGHTING TO MATCH EXISTING ON SITE, SEE DETAIL (4) C-2

26. (4) L.E.D. CAN LIGHTS UNDER CANOPY

27. LANDSCAPING, FENCING AND SIGNAGE WILL NOT INTERFERE WITH CLEAR SIGHT REQUIREMENTS. THEREFORE, SIGNS, WALLS, TREES AND SHRUBBERY BETWEEN 3 AND 8 FEET TALL (AS MEASURED FROM THE GUTTER PAN) WILL NOT BE ACCEPTABLE IN THE CLEAR SIGHT

28. NEW HANDICAPPED ACCESSIBLE AISLE STRIPPING PER LOCAL CITY CODE AND STANDARDS, SEE DETAIL 6 SHEET AS-2

## GENERAL NOTES

- A. PARKING LOT DIMENSIONS ARE FROM FACE OF CURB TO FACE OF CURB
- B. PROVIDE EXPANSION JOINTS IN CONCRETE WALK @ 40' O.C. AND WHERE CONCRETE ABUTS THE BUILDING.
- C. PREMIS IDENTIFICATION SHALL BE MINIMUM 24 INCHES HIGH x .5 INCH WIDE AND SHALL CONTRAST WITH THEIR BACKGROUND AND SHALL BE VISIBLE FROM
- THE STREET OR ROAD FRONTING THE PROPERTY. D. PROPOSED BUILDING TO HAVE FIRE SPRINKLER SYSTEM THROUGHOUT PER 2009
- I.B.C. SECTION 903 AND MANUAL FIRE ALARM SYSTEM PER SECTION 907. FIRE SPRINKLER SYSTEM PLANS TO BE SUBMITTED UNDER SEPARATE PERMIT.
- G.C. TO PROVIDE KEY BOX, KEY BOX TO BE INSTALLED IN AN ACCESSIBLE LOCATION. THE KEY BOX SHALL BE OF AN APPROVED TYPE LISTED IN ACCORDANCE WITH UL 1037, AND SHALL CONTAIN KEYS TO GAIN ACCESS TO
- BUILDING AND FIRE RISER ROOM. G. G.C. TO PROVIDE FIRE EXTINGUISHERS 2A-10-BC, 1 PER EACH 3,000 S.F., REF: FLOOR PLANS FOR QUANTITY AND LOCATIONS.

PROJECT NUMBER:

GODE ENFORMMENT ZZ

1009970

Is an Infrastructure List required? ( ) Yes ( ) No If yes, then a set of approved DRC plans with a work order is required for any construction within Public Right-of-Way or for construction of public improvements.

DRB SITE DEVELOPMENT PLAN APPROVAL:


\* Environmental Health Department (conditional)

NOTE: ALL IMPROVEMENTS LOCATED IN THE RIGHT OF WAY MUST BE INCLUDED ON A PUBLIC WORK ORDER

CLEAR SIGHT TRIANGLE

18'-0'"



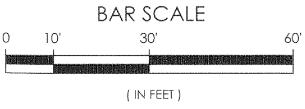

CLEAR SIGHT TRIANGLE

ONE

WAY

EXISTING 14'

POWER POLE

PNM EASEMENT

- EXISTING HIGH VOLTAGE

CLEAR SIGHT TRIANGLE



#### PROJECT DESCRIPTION:

this project consists of the construction of a 5.670 s.f. commercial building on an EXISTING LOT AS PHASE 2 OF A PLANNED SITE DEVELOPMENT. THE EXTENT OF CONSTRUCTION FOR THIS PHASE IS WITHIN THE SOUTHEAST CORNER OF THE SITE, INDICATED WITH DASHED LINE ON PLAN.

#### INTERNATIONAL BUILDING CODE 2015

CUPANCY AND CLASSIFICATION: PE OF CONSTRUCTION (CHAPTER 6): ALLOWABLE BUILDING HEIGHT (TABLE 504.3): ALLOWABLE AREA (TABLE 506.2):

A-2 DONUT SHOP: B - OFFICE V-B (WITH AUTOMATIC FIRE SPRINKLER SYSTEM) TYPE VB: 40'

A-2 OCP. TYPE VB SPRINKLED - 24,000 SF; B OCP. TYPE VB SPRINKLED - 36,000 SF DOUGHNUT SHOP: BUILDING GROUP A-2 1.600 , SEATING AREA 392 SF/15 = 26 OCCPS.

NUSENDA BANK: BUILDING GROUP B 2.503 S.F./100 S.F. PER OCC. = 25 OCCPS.

INTERNATIONAL FIRE CODE 2015 FIRE RESISTANCE RATING REQUIREMENTS FOR BUILDING ELEMENTS (TABLE 601): TYPE VB - NONE

NUSENDA MTNG RM: BUILDING GROUP B 1.516 S.F. /100 S.F. PER OCC. = 15 OCCPS.

FIRE RESISTANCE RATING FOR EXTERIOR WALLS (TABLE 602): OCCUPANCY A-2, B, - NONE

TABLE B105.1 FIRE FLOW PER IFC: V-B, 5,643 SF (4,801 SF-6,200 SF) = 2000 GPM, FLOW DURATION 2 HRS.

TABLE C105.1 NUMBER AND DISTRIBUTION OF FIRE HYDRANTS: 2,000 - 2,500 GPM = 2 HYDRANTS 450' SPACING BETWEEN HYDRANTS, MAX DISTANCE FROM ANY POINT ON STREET OR ROAD FRONTAGE TO HYDRANT - 225'.

DOUGHNUT SHOP: A-2 1,651 S.F. NUSENDA BANK: B OFFICE 2,503 S.F. NUSENDA MEETING RM: A-2 1,516 S.F.

TOTAL ROOF AREA=

TABLE 1021.1 MIN. NO. EXITS PER OCCP. LOAD: (OCCP. LOAD 1-500) = 2 EXITS REQ'D (3 PROVIDED)

TABLE 1016.1 EXIT TRAVEL DISTANCE: A2 OCCP. WITH SPRINKLER SYSTEM = 250 FEET MAX. TABLE 1016.1 EXIT TRAVEL DISTANCE: B OCCP. WITH SPRINKLER SYSTEM = 300 FEET MAX.

SECTION 1005 EGRESS WIDTH REQUIRED: A-2 OCCP, LOAD = 26 x 0.2 = 5.2 INCH EGRESS WIDTH SECTION 1005 EGRESS WIDTH REQUIRED: B OCCP. LOAD = 41 x 0,2 = 8.2 INCH EGRESS WIDTH

EGRESS WIDTHS PROVIDED: A-2 OCCP. (2) 36 INCH EGRESS WIDTH DOORS GRESS WIDTHS PROVIDED: B OCCP. (4) 36 INCH EGRESS WIDTH DOORS

#### DADVING CALCULATIONS 5 6 2 A 2

PARKING CALCULATIONS: 5.6.2.A.2						
NORTH BUILDING						
BUSINESS	PARKING REQ.	PARKING PROV.				
JIMMY JOHNS - 32 SEATS	8 SPACES	8 SPACES				
GYM 1,200 S.F.	8 SPACES	8 SPACES				
GYM 1,200 S.F.	8 SPACES	8 SPACES				
verizon 2,000 s.f.	10 SPACES	10 SPACES				
TOTAL PARKING	34 SPACES	34 SPACES				
SOUTH BUILDING						
DONUTS 24 SEATS	6 SPACES	8 SPACES				
NUSENDA CU 2,503 S.F.	12 SPACES	12 SPACES				
NUSENDA CONF. RM. 1,516 S.F.	8 SPACES	15 SPACES				
TOTAL PARKING	26 SPACES	31 SPACES				

fotal parking on Site

PARKING REQUIRED = 60 SPACES + %10 ALLOWED INCREASE = 66 SPACES

PARKING PROVIDED = 65 SPACES INCLUDING (4) HANDICAPPED


SITE 401


revision date 03-12-18 02-27-18

RICHARDE No. 1240 02-12-18 STERED ARCH

02-12-18

SHEET NUMBER AS-

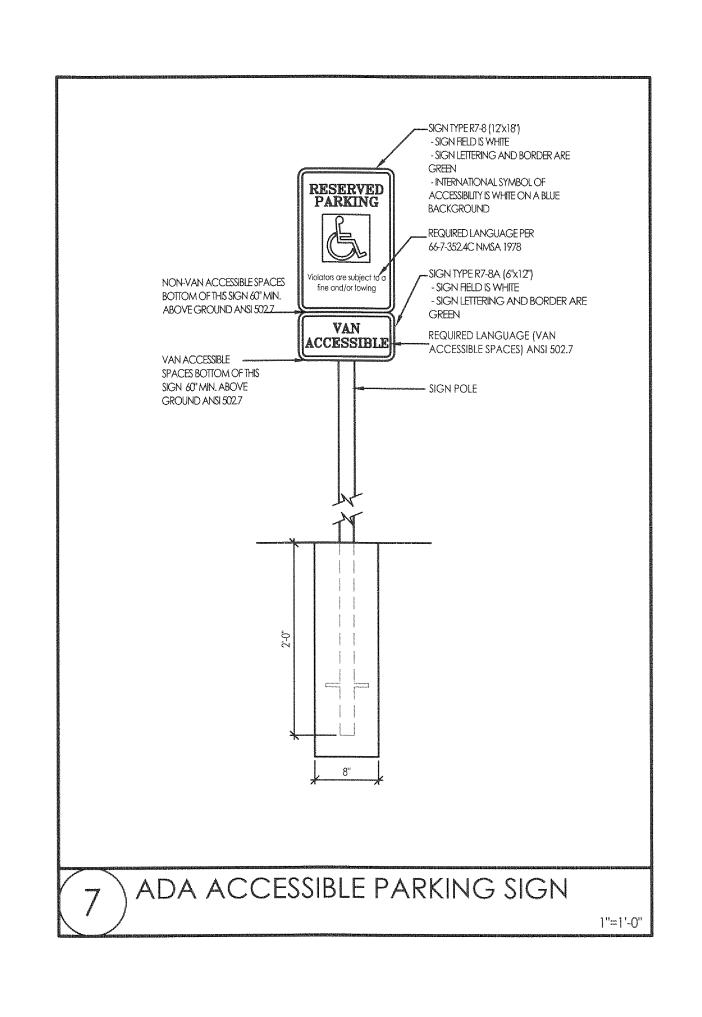


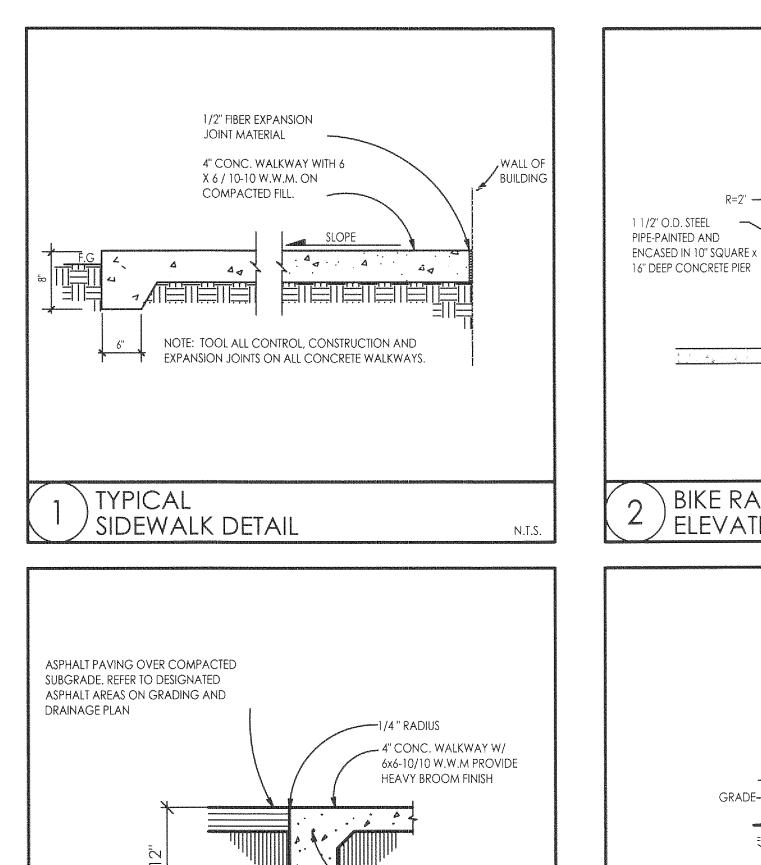



#4 REINFORCING ROD

(CONTINUOUS)

TYPICAL CONCETE CURB & SIDEWALK DETAIL

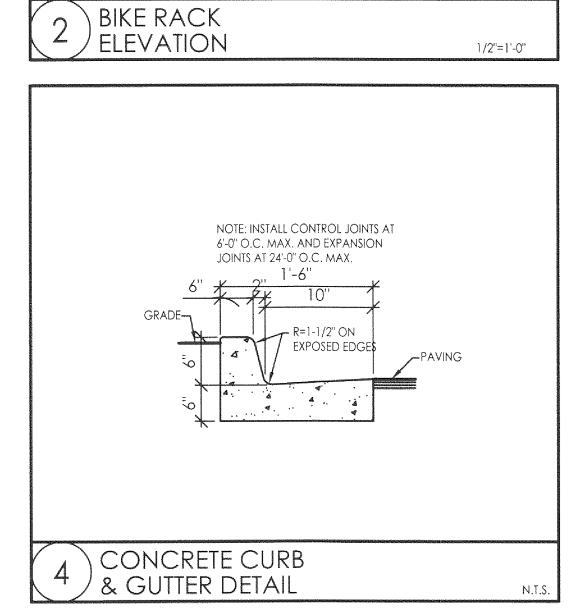

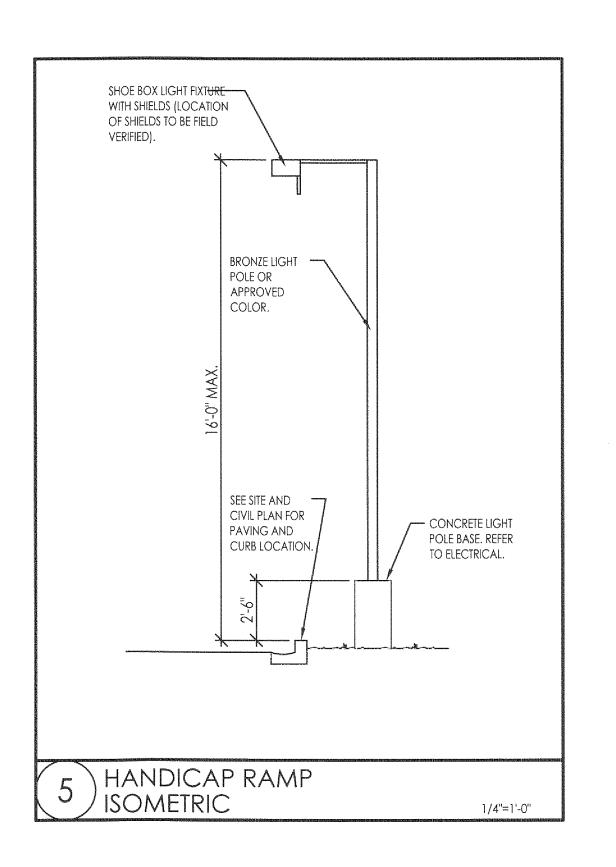

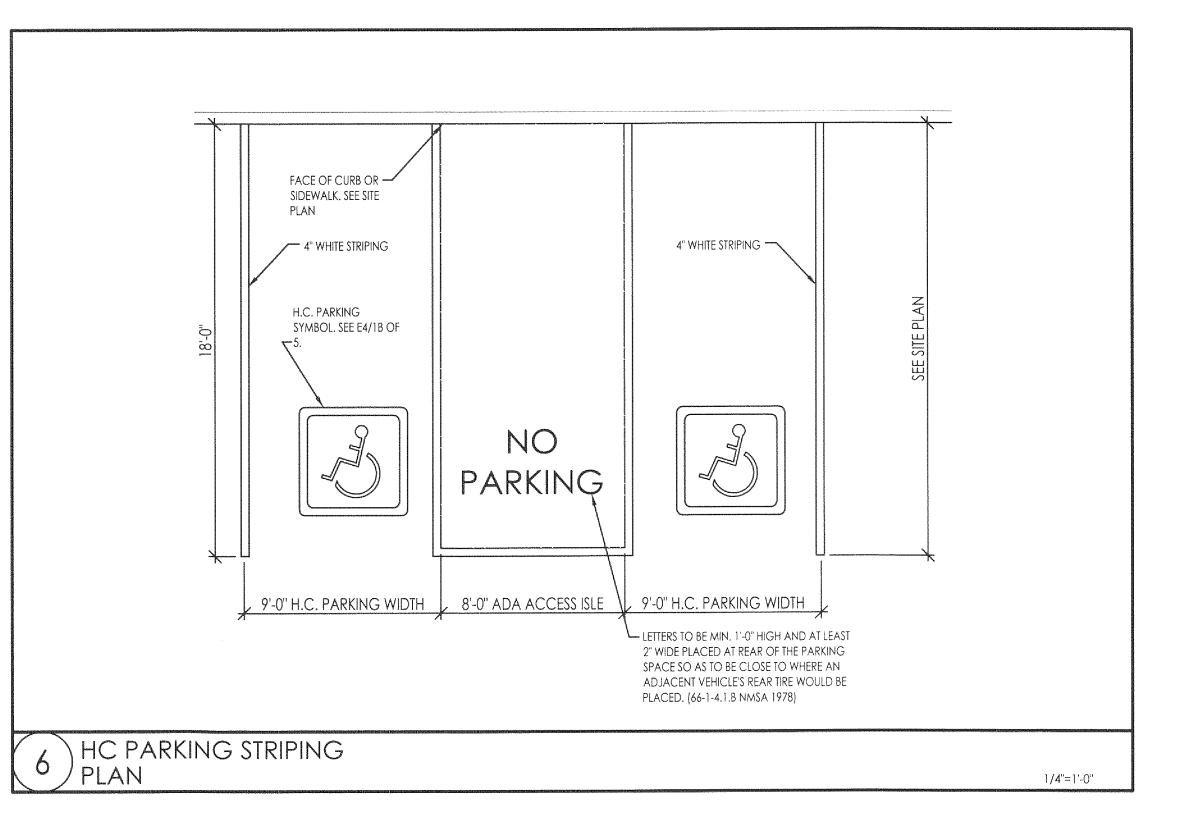




RICHARD PA

02-28-18

AS-2

SHEET NUMBER

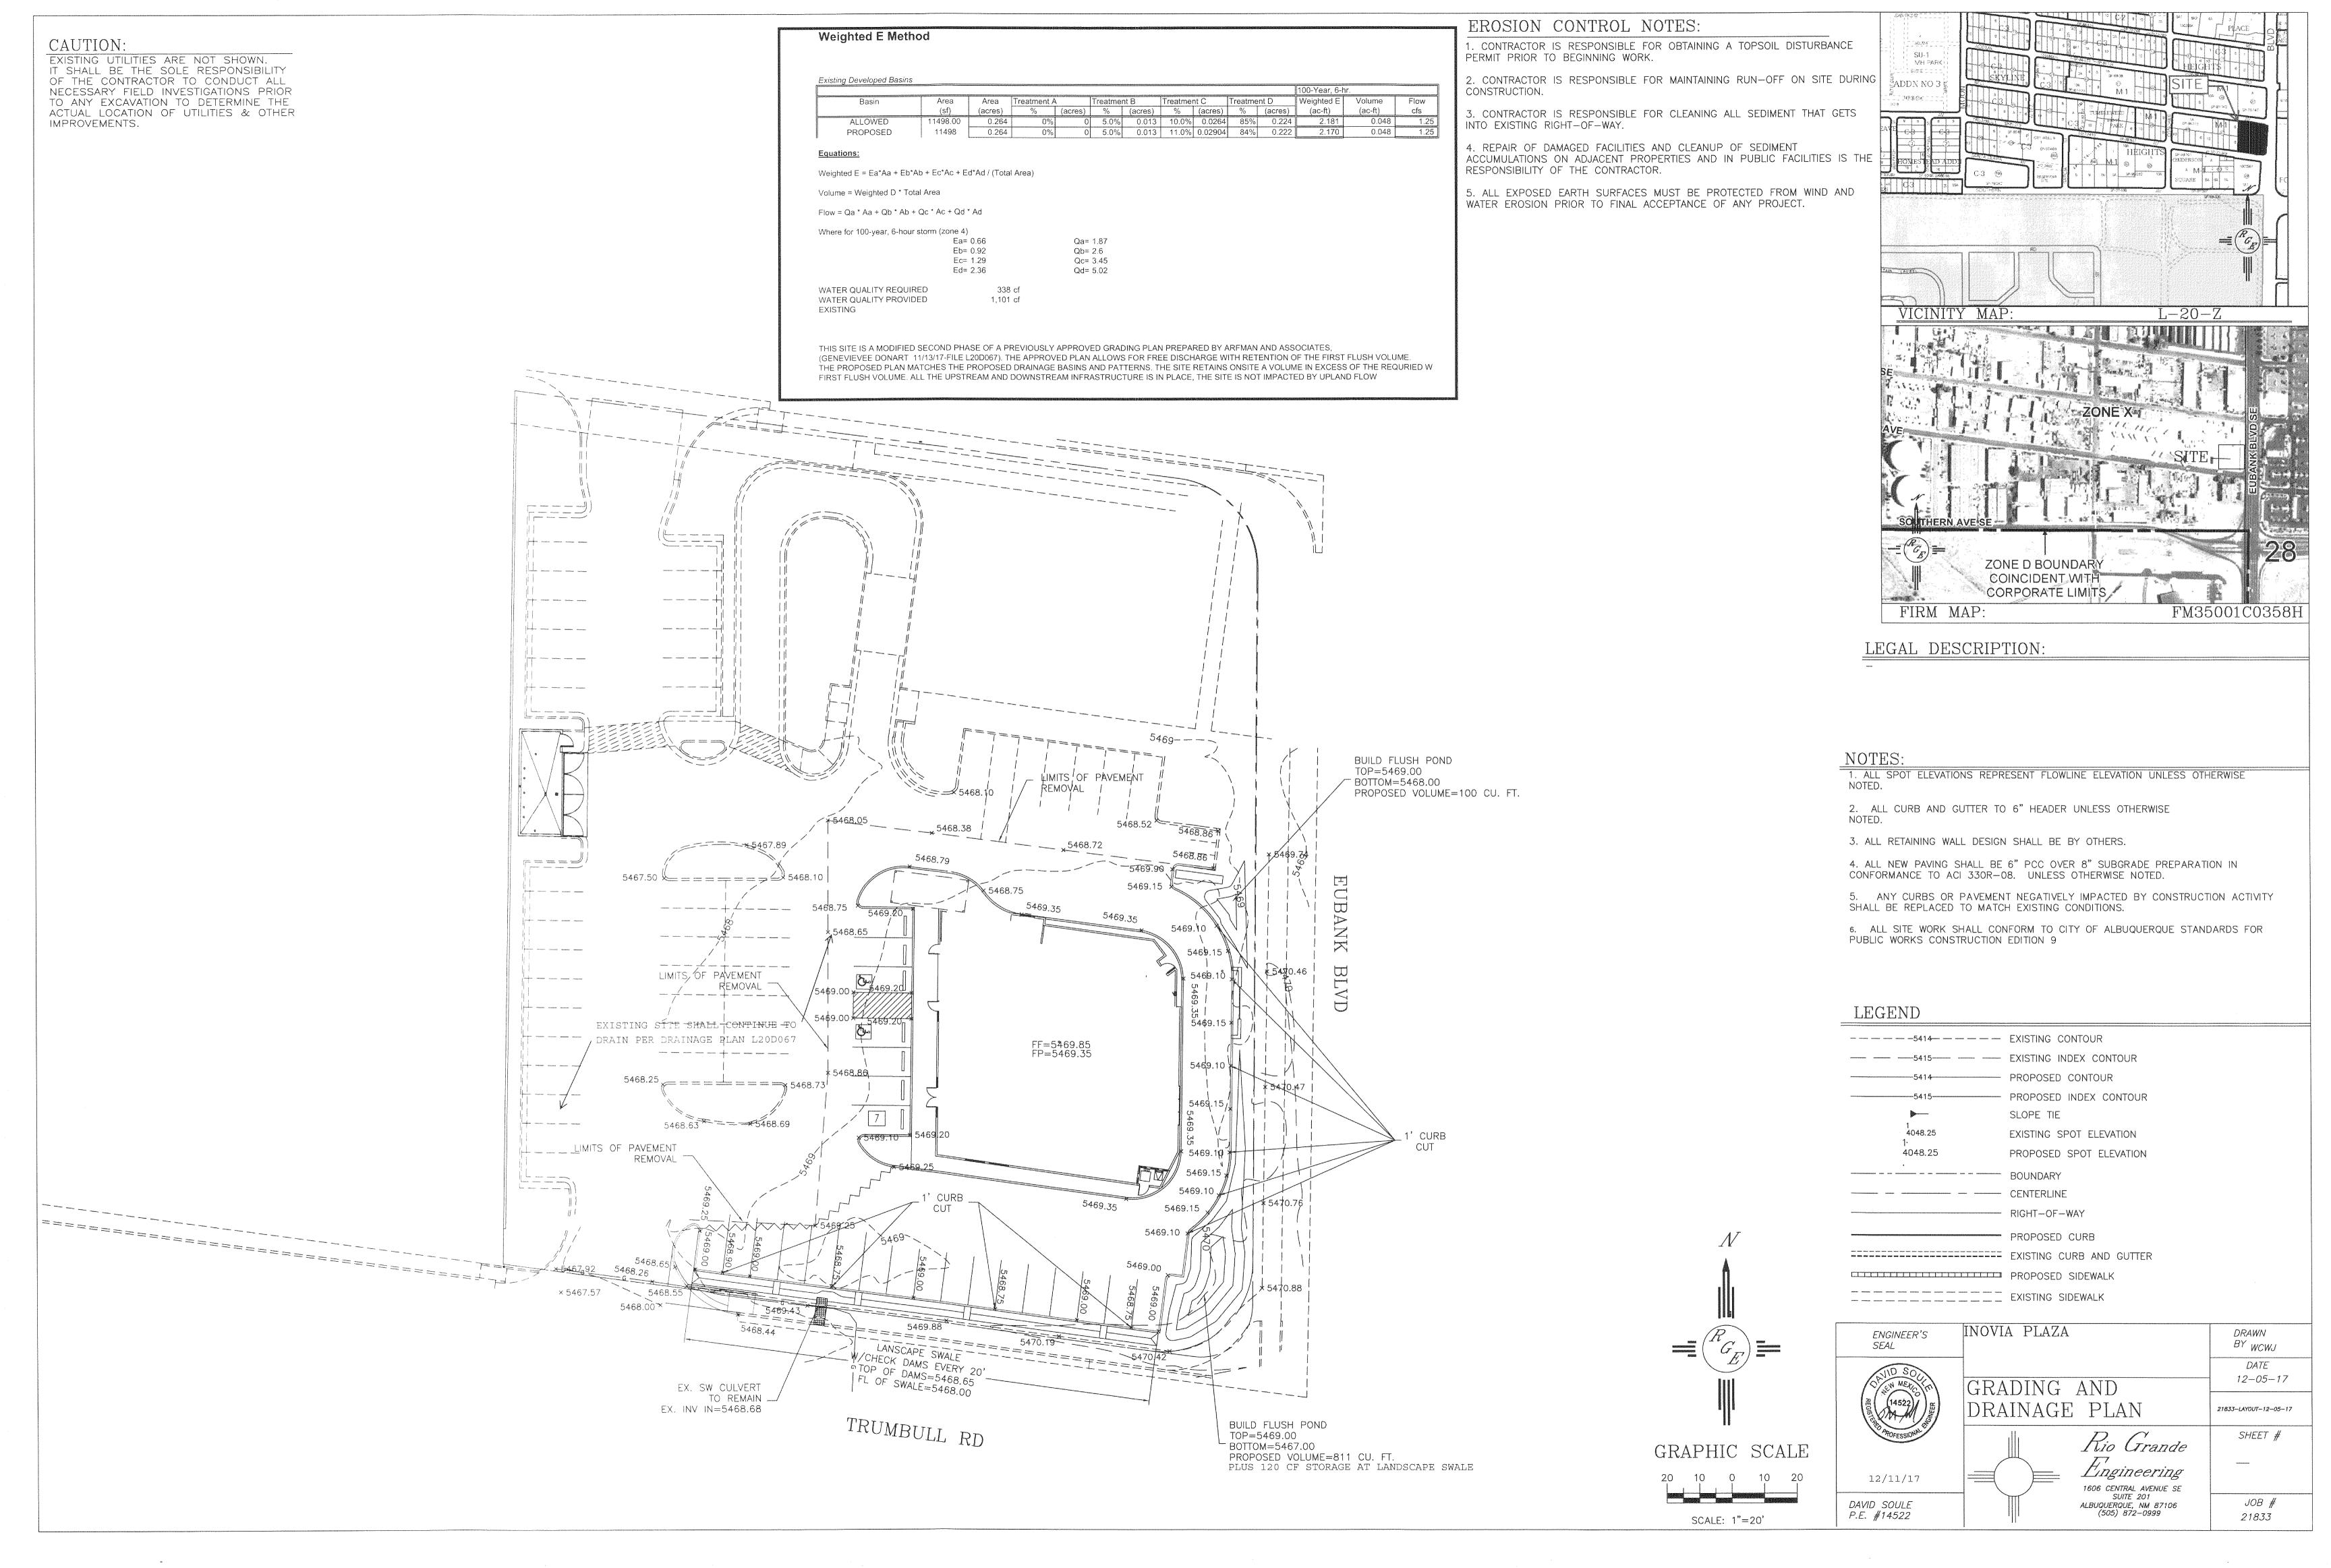

## NOTICE TO CONTRACTORS

1. AN EXCAVATION/CONSTRUCTION PERMIT WILL BE REQUIRED BEFORE BEGINNING ANY WORK WITHIN BERNALILLO COUNTY ROW. AN APPROVED COPY OF THESE PLANS MUST BE SUBMITTED AT THE TIME OFCITY OF ALBUQUERQUE APPLICATION FOR THIS PERMIT. 2. ALL WORK DETAILED ON THESE PLANS TO BE PERFORMED, EXCEPT AS OTHERWISE STATED OR PROVIDED HEREON, SHALL BE CONSTRUCTED IN ACCORDANCE WITH BERNALILLO COUNTY INTERIM STANDARD SPECIFICATIONS FOR PUBLIC WORKS CONSTRUCTION, 1986, INCLUDING UPDATE 8.

3. TWO WORKING DAYS PRIOR TO ANY EXCAVATION, CONTRACTOR MUST CONTACT LINE LOCATING SERVICE, 260-1990, FOR LOCATION OF EXISTING UTILITIES.

4. PRIOR TO CONSTRUCTION, THE CONTRACTOR SHALL EXCAVATE AND VERIFY THE HORIZONTAL AND VERTICAL LOCATIONS OF ALL PERTINENT EXISTING UTILITIES, AND/OR OBSTRUCTIONS. SHOULD A CONFLICT EXIST, THE CONTRACTOR SHALL NOTIFY THE ENGINEER SO THAT THE CONFLICT CAN BE RESOLVED WITH A MINIMUM AMOUNT OF DELAY.

5. BACKFILL COMPACTION SHALL BE ACCORDING TO ARTERIAL STREET USE FOR ALL WORK. . MAINTENANCE OF THESE FACILITIES SHALL BE THE RESPONSIBILITY OF THE OWNER OF THE PROPERTY SERVED.

7. WORK ON ARTERIAL STREETS SHALL BE PERFORMED ON A 24-HOUR BASIS.

8. CONTRACTOR SHALL DETERMINE LOCATION OF ANY UNDERGROUND FACILITY IN OR NEAR WORK AREAS, INCLUDING REQUESTS TO OWNERS/OPERATORS OF SAID FACILITIES PER SECTION 62-14-5 NMSA 1978.

9. CONTRACTOR SHALL PLAN ALL EXCAVATION TO MINIMIZE INTERFERENCE OR DAMAGE OF UNDERGROUND FACILITIES.

10. CONTRACTOR SHALL PROVIDE ADVANCE TELEPHONE NOTICE OF COMMENCEMENT, EXTENT AND DURATION OF ALL EXCAVATION WORK TO THE ONE—CALL NOTIFICATION SYSTEM, OR TO OWNERS/OPERATORS OF ANY EXISTING UNDERGROUND FACILITY IN OR NEAR THAT ARE NOT MEMBERS OF THE MARK LINDERCROUND FACILITY FOR SECTION OWNERS/OPERATORS MAY LOCATE AND MARK UNDERGROUND FACILITY PER SECTION 62-14-5 NMSA 1978 PRIOR TO ANY COMMENCEMENT OF WORK. CONTRACTOR SHALL REQUEST REAFFIRMATION OF LOCATION EVERY TEN (10) WORKING DAYS AFTER INITIAL REQUEST.

11. CONTRACTOR SHALL MAINTAIN EIGHTEEN (18) INCHES BETWEEN EXISTING UNDERGROUND FACILITIES THAT HAVE BEEN PREVIOUSLY IDENTIFIED AND MARKED BY THE OWNERS/OPERATORS OF SAID FACILITIES. CUTTING EDGE OR POINT OF ANY MECHANICAL EXCAVATING EQUIPMENT UTILIZED IN EXCAVATION AREA WILL BE USED IN A MANNER NECESSARY TO PREVENT DAMAGE TO EXISTING UNDERGROUND FACILITIES.

12. CONTRACTOR SHALL PROVIDE SUPPORT FOR EXISTING UNDERGROUND FACILITIES IN OR NEAR EXCAVATION AREA AS NECESSARY TO PREVENT DAMAGE TO SAID FACILITIES.

13. CONTRACTOR SHALL BACKFILL ALL EXCAVATIONS IN A MANNER AND WITH MATERIALS AS MAY BE NECESSARY TO PREVENT DAMAGE TO AND PROVIDE RELIABLE SUPPORT DURING AND FOLLOWING BACK FILLING ACTIVITIES FOR PREEXISTING UNDERGROUND FACILITIES IN OR NEAR

14. CONTRACTOR SHALL IMMEDIATELY NOTIFY BY TELEPHONE THE OWNER/OPERATOR OF ANY UNDERGROUND FACILITY WHICH MAY HAVE BEEN DAMAGED OR DISLODGED DURING

15. CONTRACTOR SHALL NOT MOVE OR OBLITERATE MARKINGS MADE PURSUANT TO CHAPTER 62, ARTICLE 14 NMSA 1978, OR FABRICATE MARKINGS IN A UNMARKED LOCATION FOR THE PURPOSE OF CONCEALING OR AVOIDING LIABILITY FOR VIOLATION OF OR NONCOMPLIANCE WITH THE PROVISIONS OF CHAPTER 62, ARTICLE 11 NMSA 1978.

16. ELECTRONIC MARKER SPHERES (EMS) SHALL BE INSTALLED ON WATER LINE AND SANITARY SEWER LINE FACILITIES PER SECTION 170 OF THE BERNALILLO COUNTY STANDARD SPECIFICATIONS 1986 EDITION AS REVISED THROUGH UPDATE #8, ADMENDMENT 1.

17. THE CONTRACTOR SHALL COORDINATE WITH THE WATER UTILITY AUTHORITY SEVEN (7) DAYS IN ADVANCE OF PERFORMING WORK THAT WILL AFFECT THE PUBLIC WATER OR SANITARY SEWER INFRASTRUCTURE. WORK REQUIRING SHUTOFF OF FACILITIES DESIGNATED AS MASTER PLAN FACILITIES MUST BE COORDINATED WITH THE WATER AUTHORITY 14 DAYS IN ADVANCE OF PERFORMING SUCH WORK. ONLY WATER AUTHORITY CREWS ARE AUTHORIZED TO OPERATE PUBLIC VALVES. SHUTOFF REQUESTS MUST BE MADE ONLINE AT

18. ALL EXCAVATION, TRENCHING, AND SHORING ACTIVITIES MUST BE CARRIED—OUT IN ACCORDANCE WITH OSHA 29 CFR 1926.6150 SUBPART P.

19. ALL IMPACTED STRIPING SHALL BE REPLACED BY CONTRACTOR.

20. MANHOLE STEPS SHALL NOT BE INSTALLED IN SANITARY SEWER MANHOLES.

21. ALL WATER METERS SHALL INCLUDE DUAL CHECK VALVE SETTERS.


22. ALL WATER METER COVERS AND LIDS SHALL BE PER COA STD DWG #2369.

23. ALL C-900 DR18 UTILITY PIPE JOINTS SHALL BE FULLY RESTRAINED DUE TO POSSIBLE DEFLECTION FROM WASTE DEGENERATION.

24. ALL MANHOLES AND VALVES SHALL HAVE GPS INFORMATION RECORDED AS PART OF AS BUILT PLAN SET.

25. CONTRACTOR IS RESPONSIBLE AT ITS OWN COST FOR ANY DAMAGE TO EXISTING UTILITIES.


26. CONTRACTOR SHALL MAINTAIN 1' SEPERATION BETWEEN ELECTRICAL AND SAS CROSSINGS.

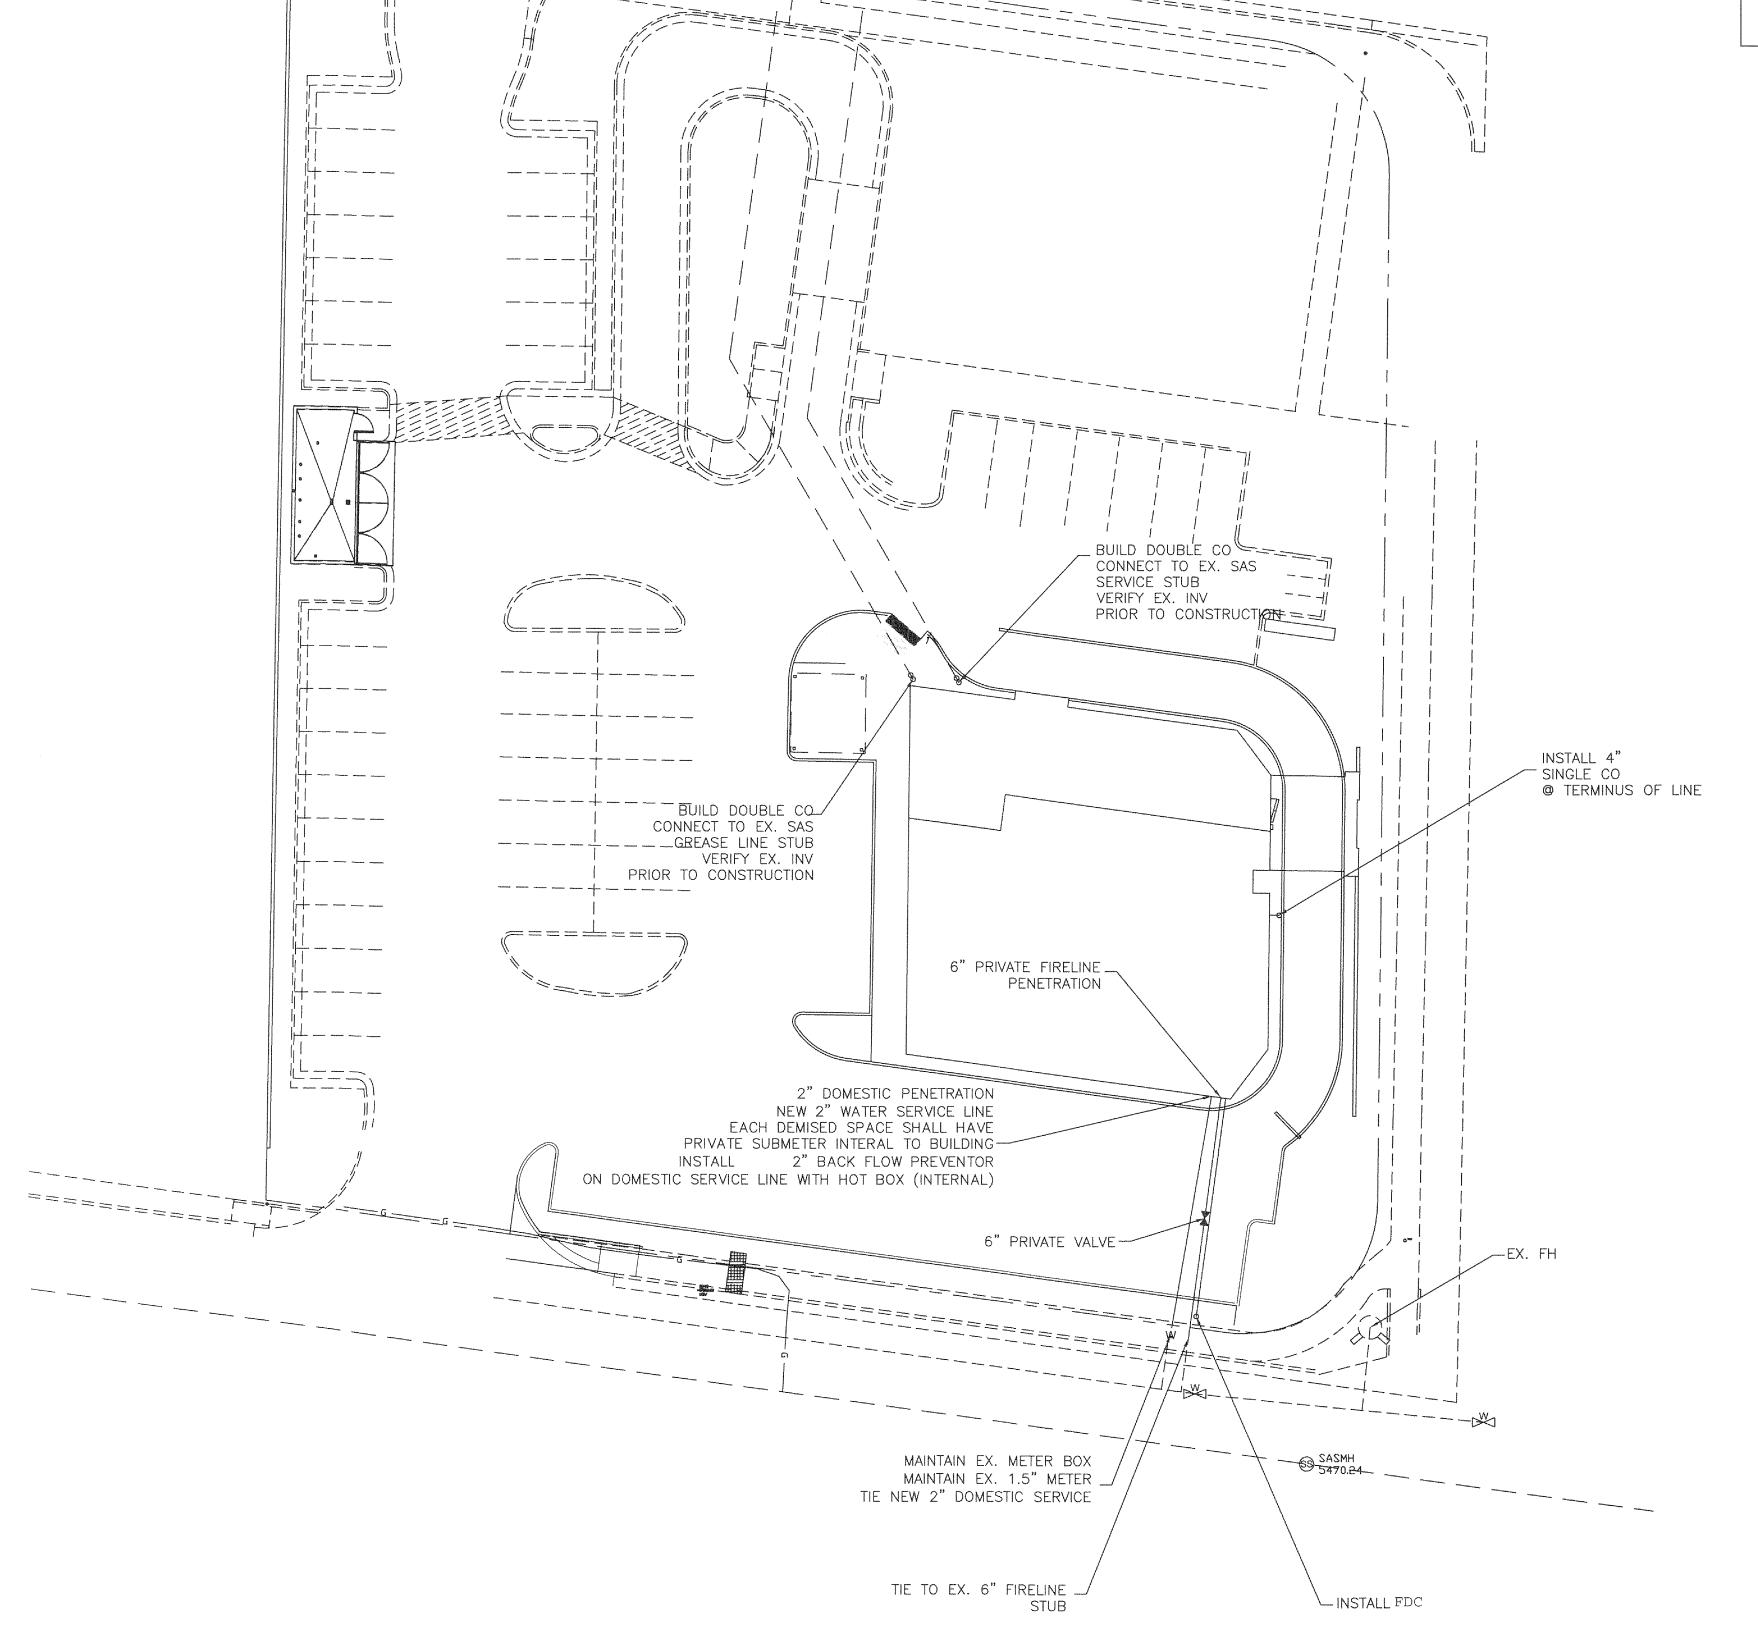


**WATER SHUTOFF NOTES:** 

1. THE CONTRACTOR SHALL COORDINATE WITH THE WATER UTILITY AUTHORITY SEVEN (7) DAYS IN ADVANCE OF PERFORMING WORK THAT WILL AFFECT THE PUBLIC WATER OR SANTARY SEWER INFRASTRUCTURE. WORK REQUIRING SHUTOFF OF FACILITIES DESIGNATED AS MASTER PLAN FACILITIES MUST BE COORDINATED WITH THE WATER AUTHORITY 14 DAYS IN ADVANCE OF PERFORMING SUCH WORK. ONLY WATER AUTHORITY CREWS ARE AUTHORIZED TO OPERATE PUBLIC VALVES. SHUT OFF REQUEST MUST BE MADE ONLINE AT HTTP: //ABCWJA.ORG/WATER\_SHUT\_OFF\_AND\_TURN\_ON\_PROCEDURES.

2. VALVES SHALL BE OPERATED BY ABOWLA EMPLOYEES ONLY.

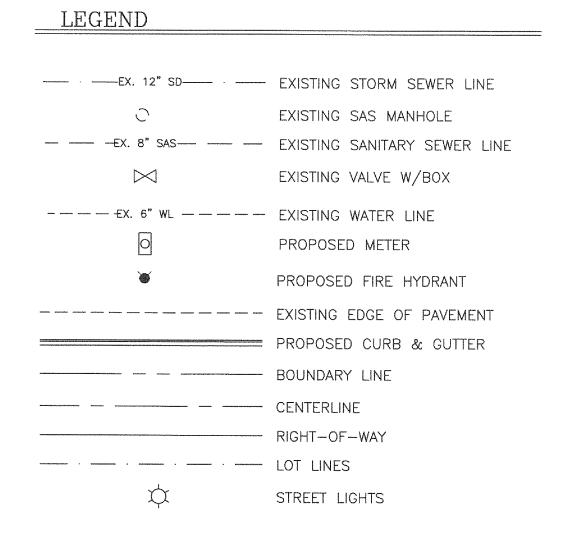


CONTRACTOR SHALL REMOVE AND REPLACE PAVING PER COA STD DWG #2465 (COLLECTOR).

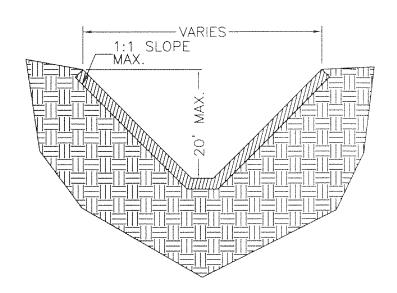


#### SUPPLEMENTAL TRENCH DETAIL

NTS-PER FIGURE V:2-13 OSHA STANDARD SPECIFICATIONS NOTE: ENTIRE TRENCH PRISM SHALL BE COMPACTED AT 95% ASTM D1557 INCLUDING ALL UTILITY MAIN LINES, WATER METER BOXES AND SERVICES, SAS SERVICES.

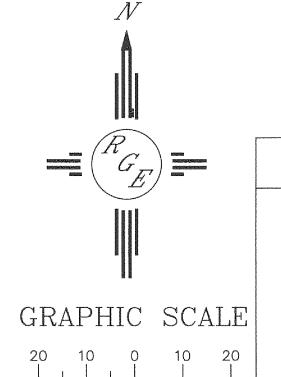

SCALE: 1"=20'

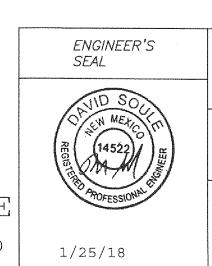

DAVID SOULE

P.E. #14522

INNOVA PLAZA MASTER UTILITY PLAN

Rio Grande Lingineering 1606 CENTRAL AVENUE SE SUITE 201 ALBUQUERQUE, NM 87106

DRAWN

BY WCWJ


DATE 1-25-18

21833-LAYOUT-12-05-17

SHEET #

JOB #

21833

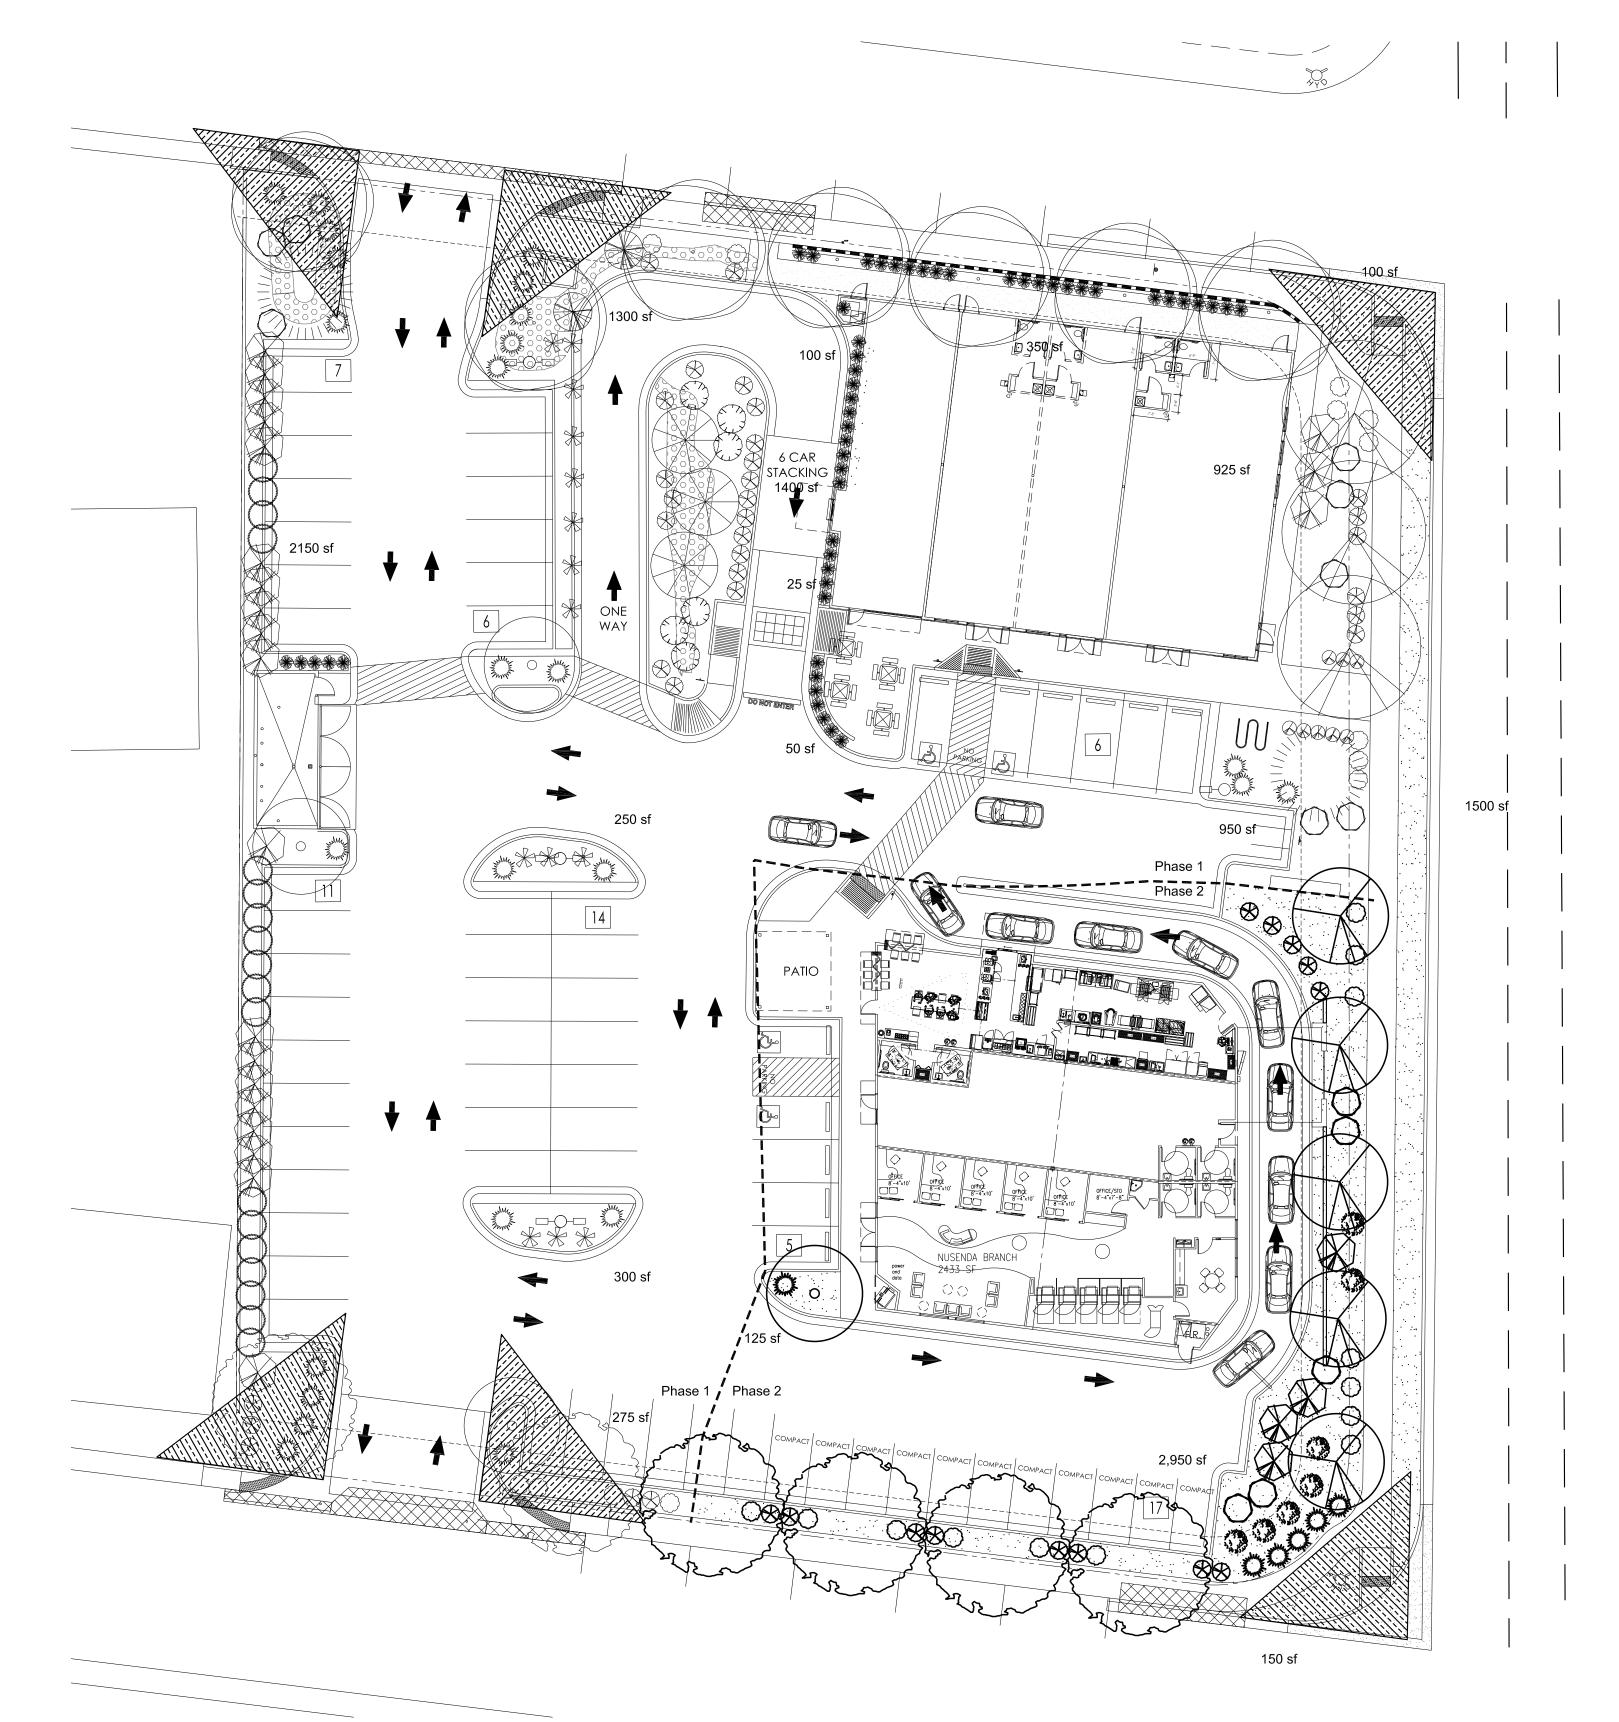

# PLANT LEGEND/Phase 1 (completed)

		Scientific Name					_	
Qty.	Symbol	Common Name	Size		e Landscape	Water Use	Drip / Emitters	Allergeni
	Trees			Ht./ Sp	o. Coverage		Emmers	rotentia
7		Gleditsia Shademaster Honey Lo	2" Cal ocust	50'/45'	50 sf=350 sf	Medium+ (see note)	6-2 gph	Low
2		Pistacia Chinese Pistache	2" Cal	60'/60'	50 sf=100 sf	Medium	6-2 gph	Low
3		Fraxinus velutina Arizona Ash	2" Cal	40'/35'	50 sf=150 sf	Medium (see note)	6-2 gph	Low
2		Pinus nigra Austrian Pine	6' Ht.	35'/25'	50 sf=100 sf	Low +	6-2 gph	Low
3	0	Pyrus Flowering Pear	15-Gal	25'/15'	50 sf=150 sf	Medium+	6-2 gph	Low
3		Vitex Chaste Tree	15-Gal	20'/20'	50 sf=150 sf	Low	4-2 gph	Low
	Grasses							
52		Calamagrotis Karl Foerster Grass	5-Gal	3'/2'	10 sf=520 sf	Medium	2-2 gph	Low
31	$\bigotimes$	Ericameria	5-Gal	3'/4'	40 sf=1240 sf	Low	2-2 gph	Low
0	34797333 3-3-3573 3-3-3573	Turpentine Bush Caryopteris Blue Mist	1-Gal	2'/6'	30 sf=0 sf	Medium	2-2 gph	
							0.	Low
14	*	Hesperaloe parviflora Red Yucca	5-Gal	3'/4'	20 sf=280 sf	Low+	2-1 gph	
14 25	A month	Hesperaloe parviflora	5-Gal 1-Gal	3'/4' 1'/5'	20 sf=280 sf 30 sf=750 sf	Low+		Low
		Hesperaloe parviflora Red Yucca Baccharis					2-1 gph	Low Low
25	**************************************	Hesperaloe parviflora Red Yucca Baccharis Coyote Brush Rhus aromatica	1-Gal	1'/5'	30 sf=750 sf	Low +	2-1 gph 2-2 gph	Low Low Low
25 13		Hesperaloe parviflora Red Yucca Baccharis Coyote Brush Rhus aromatica Gro Low Sumac Chamaebatieria	1-Gal 1-Gal	1'/5' 2'/6' 5'/6'	30 sf=750 sf 40 sf=520 sf	Low+ Low+ Low+	2-1 gph 2-2 gph 2-1 gph	Low Low Low
<ul><li>25</li><li>13</li><li>2</li></ul>		Hesperaloe parviflora Red Yucca Baccharis Coyote Brush Rhus aromatica Gro Low Sumac Chamaebatieria Fernbush Vauquelinia	1-Gal 1-Gal 5-Gal	1'/5' 2'/6' 5'/6'	30 sf=750 sf 40 sf=520 sf 50 sf=100 sf	Low+ Low+ Low+	2-1 gph 2-2 gph 2-1 gph 2-1 gph	Low Low Low Low Low
25 13 2 22		Hesperaloe parviflora Red Yucca Baccharis Coyote Brush Rhus aromatica Gro Low Sumac Chamaebatieria Fernbush Vauquelinia Rosewood Rhus trilobata	1-Gal 1-Gal 5-Gal 5-Gal	1'/5' 2'/6' 5'/6' 12'/10'	30 sf=750 sf 40 sf=520 sf 50 sf=100 sf 100 sf=2200 sf	Low+ Low+ Low+	2-1 gph 2-2 gph 2-1 gph 2-1 gph 2-1 gph	Low Low Low Low

5-Gal 3'/4' 20 sf=160 sf Medium 2-2 gph Low

5-Gal 8'/8' 20 sf=360 sf Medium+ 2-2 gph

Total landscape coverage= 7,586 sf

## PLANT LEGEND/Phase 2

Qty. Symbol Common Name

Scientific Name

Shademaster Honey Locust

		Orladernaster Floricy Loc						
4	$\bigcirc$	Pistacia Chinese Pistache	2" Cal	60'/60'	50 sf=200 sf	Medium	6-2 gph	Low
5		Chilopsis Desert Willow	2" Cal	20'/20'	50 sf=250 sf	Low	6-1 gph	Low
0	The state of the s	Pinus nigra Austrian Pine	6' Ht.	35'/25'		Low +	6-2 gph	Low
1	$\odot$	Pyrus Flowering Pear	15-Gal	25'/15'	50 sf=50 sf	Medium+	6-2 gph	Low
0	$\Re$	Vitex Chaste Tree	15-Gal	20'/20'		Low	4-2 gph	Low
	Grasses							
0	*	Calamagrotis Karl Foerster Grass	5-Gal	3'/2'	10 sf=0 sf	Medium	2-2 gph	Low
Shruk	os/Groundco	overs						
13	$\otimes$	Ericameria Turpentine Bush	5-Gal	3'/4'	40 sf=520 sf	Low	2-2 gph	L
7		Caryopteris Blue Mist	1-Gal	2'/6'	30 sf=210 sf	Medium	2 <b>-</b> 2 gph	L
0	*	Hesperaloe parviflora Red Yucca	5-Gal	3'/4'	20 sf=0 sf	Low+	2-1 gph	L
6	The state of the s	Baccharis Coyote Brush	1-Gal	1'/5'	30 sf=180 sf	Low +	2-2 gph	L
13	$\bigcirc$	Rhus aromatica Gro Low Sumac	1-Gal	2'/6'	40 sf=520 sf	Low+	2-1 gph	L
0		Chamaebatieria Fernbush	5-Gal	5'/6'	50 sf=0 sf	Low+	2-1 gph	Lo
4	<b>X</b>	Vauquelinia Rosewood	5-Gal	12'/10'	100 sf=400 sf	Low+	2-1 gph	L
0		Rhus trilobata 3 Leaf Sumac	1-Gal	6'/6'	36 sf=0 sf	Low	2-1 gph	L
0	$\bigcirc$	Fallugia Apache Plume	1-Gal	6'/7'	49 sf=0 sf	Low	2-1 gph	L
5	$\bigcirc$	Buddleia Butterfly Bush	5-Gal	5'/5'	30 sf=150 sf	Medium	2-2 gph	L
0	$\otimes$	Raphiolepis Princess India Hawthorn	5-Gal	3'/4'	20 sf=0 sf	Medium	2-2 gph	Lo
0	0	Photinia Red Leaf Photinia	5-Gal _	8'/8'	sf=00 sf	Medium+	2-2 gph	Lo
			To	tal lands	cape coverage	e= 2,480 sf		

Size Mature Landscape Water Use Drip Allergenic

Medium+ 6-2 gph Low

### NOTE

MAINTENANCE OF LANDSCAPE PROVIDED BY OWNER

Raphiolepis

Photinia

Princess India Hawthorn

Red Leaf Photinia

PLANTINGS TO BE WATERED BY AUTO. DRIP IRRIGATION SYSTEM WITH REDUCED PRESSURE BACKFLOW PREVENTER PER CITY OF ALBUQUERQUE

WATER MANAGEMENT IS THE SOLE RESPONSIBILITY OF THE PROPERTY OWNER

THIS PLAN IS TO COMPLY WITH C.O.A. LANDSCAPE AND WATER WASTE ORDINANCE 6-1-1. PLANTING RESTRICTIONS APPROACH

IT IS THE INTENT OF THIS PLAN TO PROVIDE MIN. 75% LIVE GROUNDCOVER OF LANDSCAPE AREAS AT MATURITY PER ORDINANCE 14-16-3-10

LANDSCAPE AREAS TO BE MULCHED WITH GRAVEL MULCH AT 2" DEPTH

APPROVAL OF THE LANDSCAPE PLAN DOES NOT CONSTITUTE OR IMPLY COMPLIANCE WITH, OR EXEMPTION FROM, THE C.O.A LANDSCAPE AND WATER WASTE ORDINANCE 6-1-1.

NO PARKING SPACE SHALL BE MORE THEN 100' FROM A TREE.


STREET TREES TO CONFORM TO STREET TREE ORDINANCE

LANDSCAPE PLAN TO CONFORM TO ZONING REGULATIONS ORDINANCE 14-16-3-10.

IRRIGATION SYSTEM: AN AUTOMATIC UNDERGROUND IRRIGATION SYSTEM WILL BE UTILIZED TO PROVIDE EVEN AND ADEQUATE WATER LEVELS TO ALL PLANT MATERIAL. WATER USE SHALL BE DONE IN SUCH A MANNER AS TO CONSERVE ITS USE AND PREVENT ANY AND ALL RUNOFF FROM LANDSCAPE MATERIALS. IRRIGATION SHALL BE RESTRICTED TO EARLY MORNING HOURS TO CONSERVE THIS LIMITED RESOURCE.

STREETSCAPE LANDSCAPING SHALL CONSIST PRIMARILY OF SHRUBS AND DECIDUOUS TREES IN A SETBACK AREA BETWEEN THE RIGHT-OF-WAY OF THE STREET AND THE FACE OF THE CURB OF AN ADJACENT PARKING AREA. CLEAR-SIGHT TRIANGLE REQUIREMENTS MUST BE MET.

LANDSCAPING AND SIGNING WILL NOT INTERFERE WITH CLEAR SIGHT REQUIREMENTS. THEREFORE, SIGNS, WALLS, | \\ TREES AND SHRUBBERY BETWEEN 3 AND 8 FEET TALL (AS MEASURED FROM THE GUTTER PAN) WILL NOT BE ACCEPTABLE IN THIS AREA.

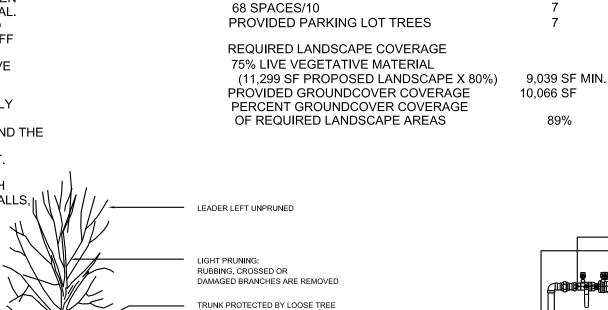

GUARD, REMOVED AFTER ONE YEAR

ALL ROPES REMOVED, TOP HALF

OF BURLAP AND WIRE BASKET

REMOVED, BURLAP SLIT FOR

PLANTING HOLE 2-3 TIMES ROOT BALL WIDTH, DEPTH SAME AS ROOT BALL

 2"-3" DEPTH ORGANIC MULCH APPLIED WELL AWAY FROM TRUNK

(NO BLACK PLASTIC) ONLY USE EXISTING

ROOT EXTENSION

FOR ROOTBALL BASE

MATERIALS LEGEND

SITE DATA

LESS BUILDING(Phase 1)

REQUIRED LANDSCAPE

15% OF NET LOT AREA

PROPOSED LANDSCAPE

HIGH WATER USE TURF

PERCENT OF NET LOT AREA

REQUIRED STREET TREES

PROVIDED STREET TREES

1 PER 10 SPACES

MAX. 20% OF LANDSCAPE AREA

PERCENT OF LANDSCAPE AREA

REQUIRED PARKING LOT TREES

PROPOSED HIGH WATER USE TURF

1 PER 30 L.F. OF STREET FRONTAGE

LESS BUILDING(Phase 2)

GROSS LOT AREA

NET LOT AREA

BROWN CRUSHER FINES

2"-4" BLUE SAIS COBBLESTONE AT 4" DEPTH

<u>56,532</u> SF

\_\_\_\_\_11,299 SF

COBBLESTONE PER CIVIL DRAWINGS

SLIP X THREAD MALE ADAPTER

GAL, COUPLING ----

GAL. 12" NIPPLE -

LANDSCAPE CONTRACTORS P.O. BOX 10597 Albuquerque, NM 87184 505 898 9615 505.898.2105 (fax)
design@hulc.com
www.headsuplandscape.com

GALVANIZED MALE ADAPTER
(1 OF 2)
GALVANIZED UNION
(1 OF 2)
GALVANIZED STREET 90\*
(1 OF 4)

GAL. 30" NIPPLE --GAL. 30" NIPPLE

NOTE:

1. INSTALL BACKFLOW PREVENTER AS REQUIRED BY LOCAL CODES AND HEALTH DEPARTMENT. VERIFY LOCAL REQUIREMENTS PRIOR TO INSTALLATION.

RP BACKFLOW/MASTER VALVE DETAIL

AUTO DRAIN VALVE WITH GAL. TEE (TYP.)
GAL.CLOSE NIPPLE (TYP.)
GAL UNION (TYP.)
PVC SLEEVE THROUGH CONCRETE (TYP.)


— AUTO VALVE

**REVISION DATE** 

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IDSC EUB,

40

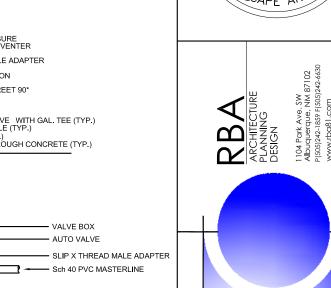

DATE 01-19-2018

SHEET NUMBER

L-1.0

TREE PLANTING DETAIL