

NOTE: THIS IMAGE IS CONCEPTUAL IN NATURE AND MAY NOT REFLECT THE REQUIREMENTS OF THESE DOCUMENTS.

PROJECT TEAM

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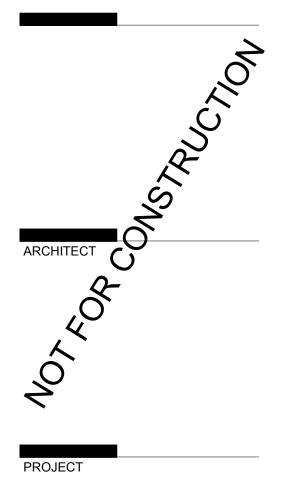
2440 LOUISIANA

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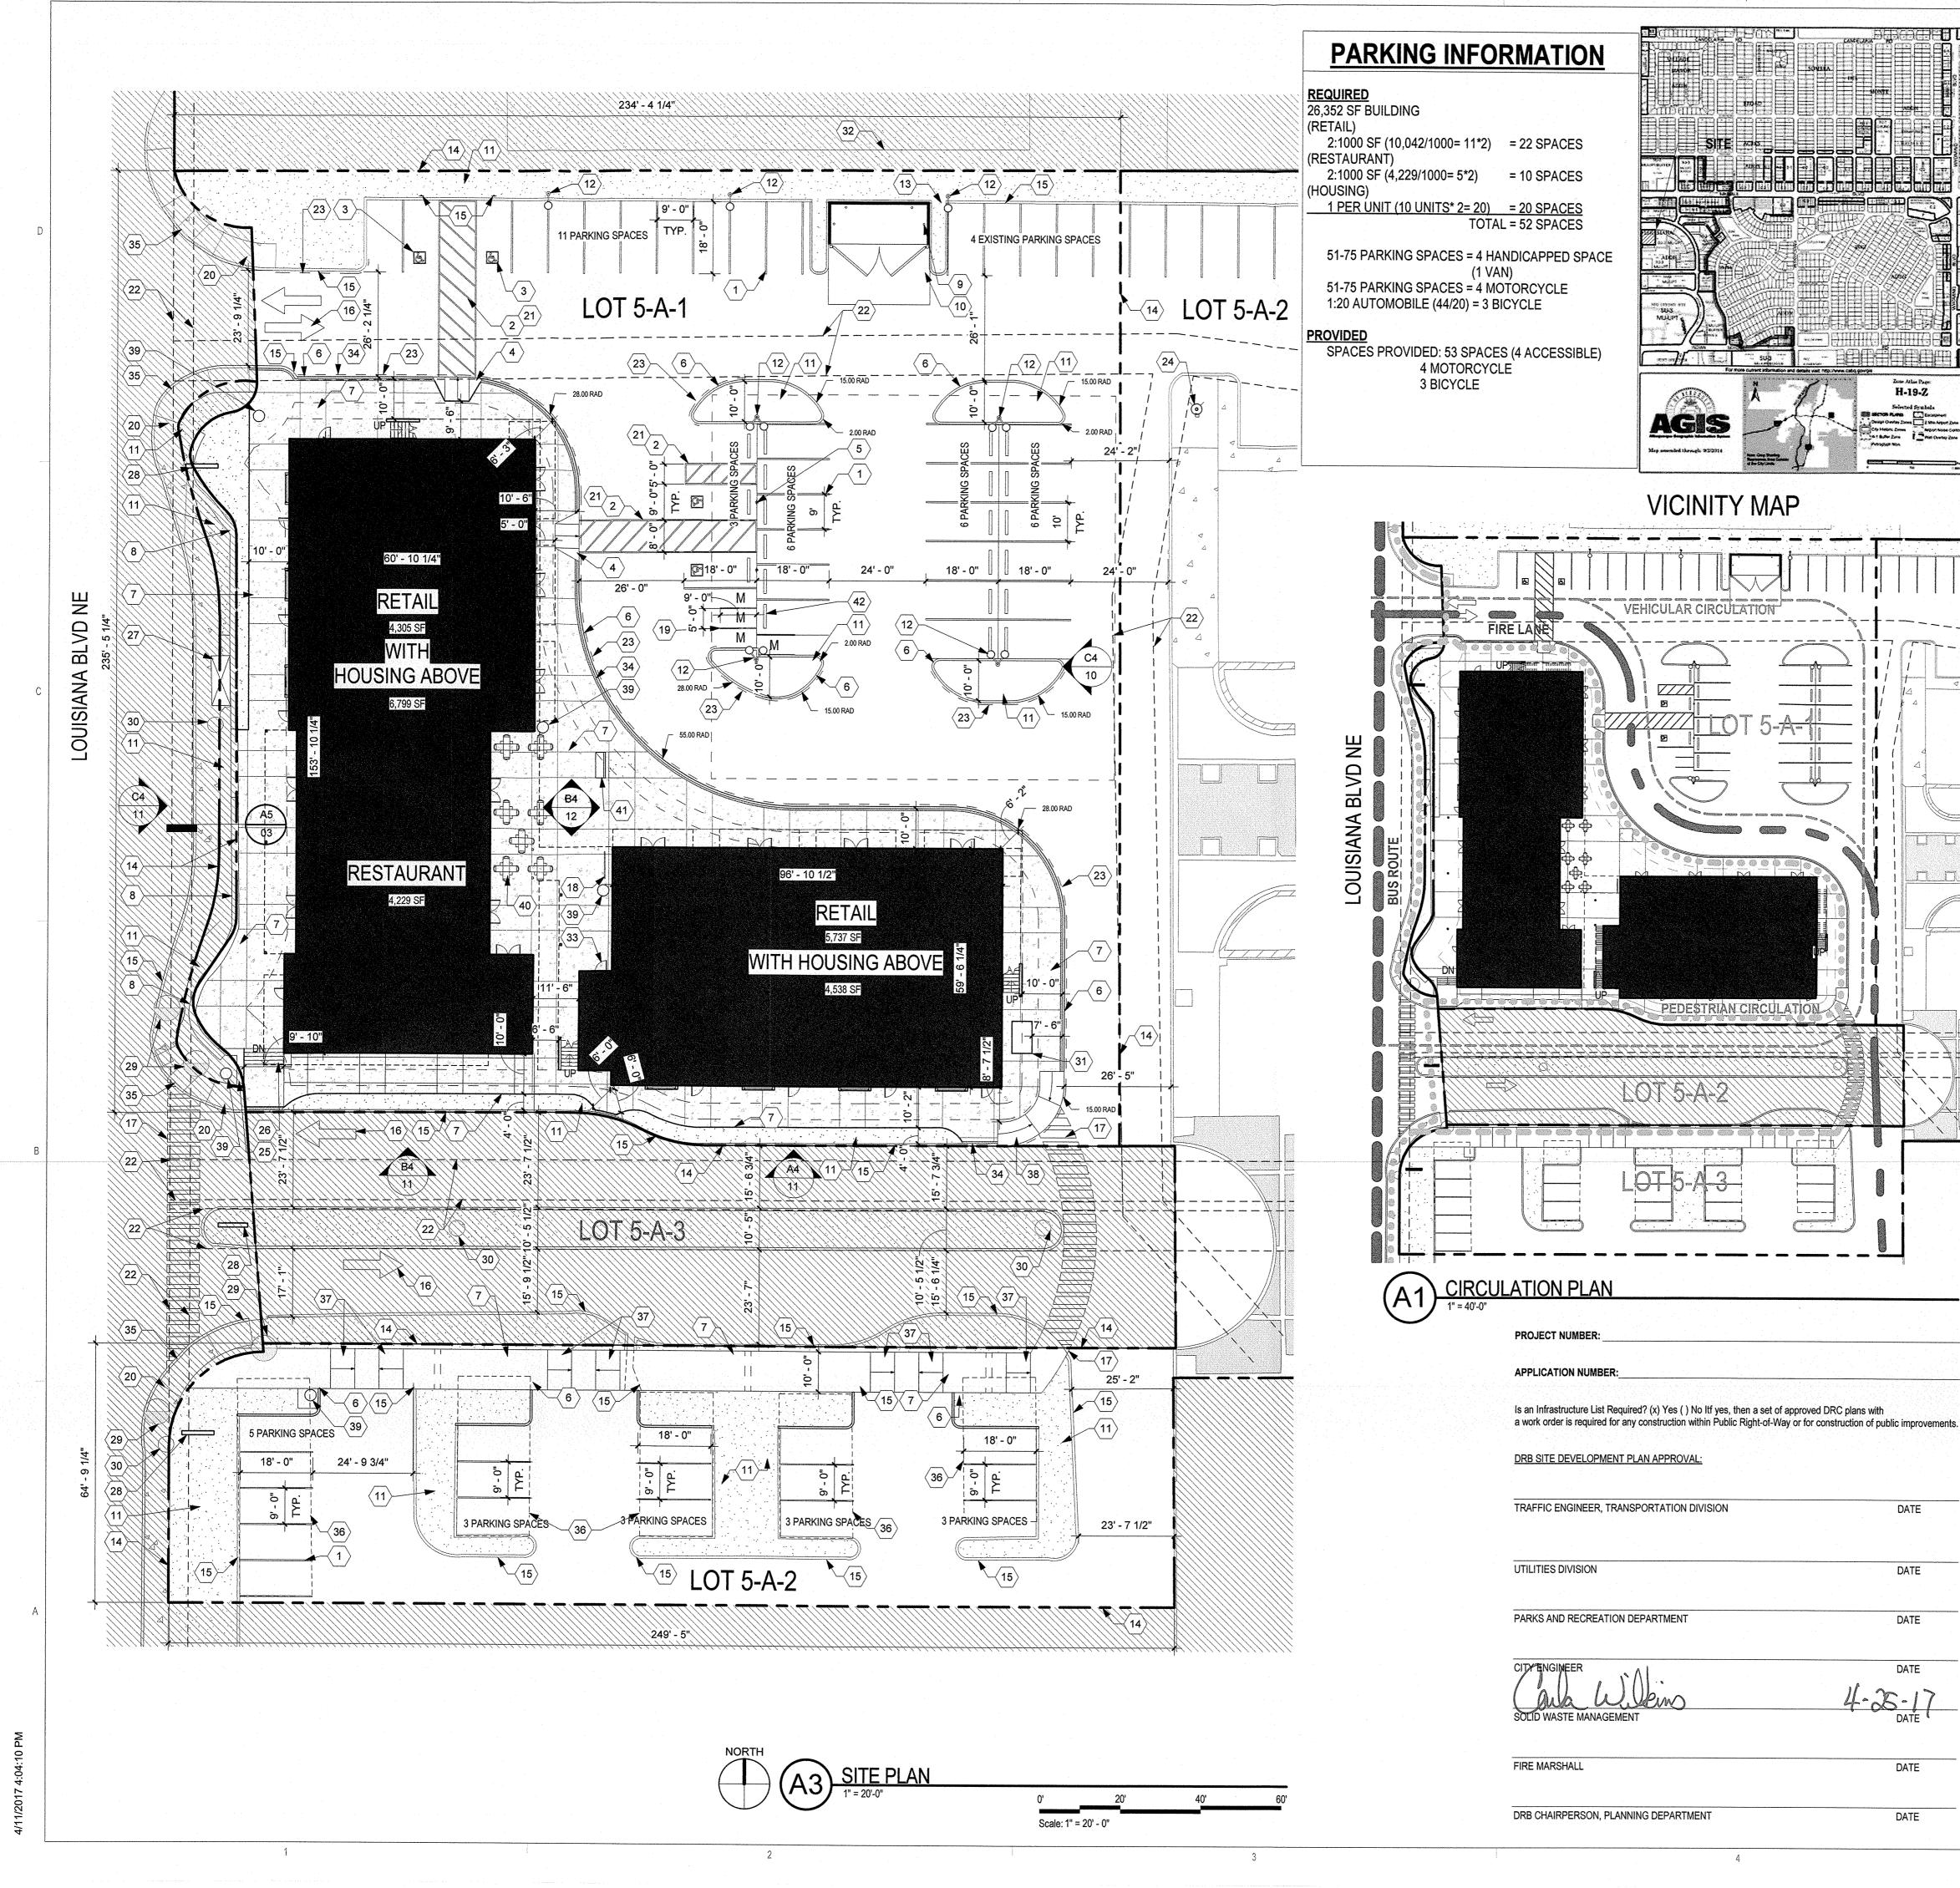
- SITE DEVELOPMENT PLAN 01 SITE SECTIONS AND DETAILS 02 SITE SECTIONS AND DETAILS 03 LEVEL 1 FLOOR PLAN 04 LEVEL 2 FLOOR PLAN PLANTING PLAN
- PLANTING SCHEDULE AND DETAILS 07
- GRADING PLAN 08
- UTILITY PLAN EXTERIOR ELEVATIONS
- EXTERIOR ELEVATIONS
- EXTERIOR ELEVATIONS EXTERIOR ELEVATIONS (COLOR)
- RENDERINGS 14
- FIRE1 15
- SPSD 16


10 2440 Louisiana Blvd. NE ALBUQUERQUE, NM 871 LOUISIANA 2440


DATE	04.07.2017
PROJECT NO:	14-0087


ISSUE PURPOSE






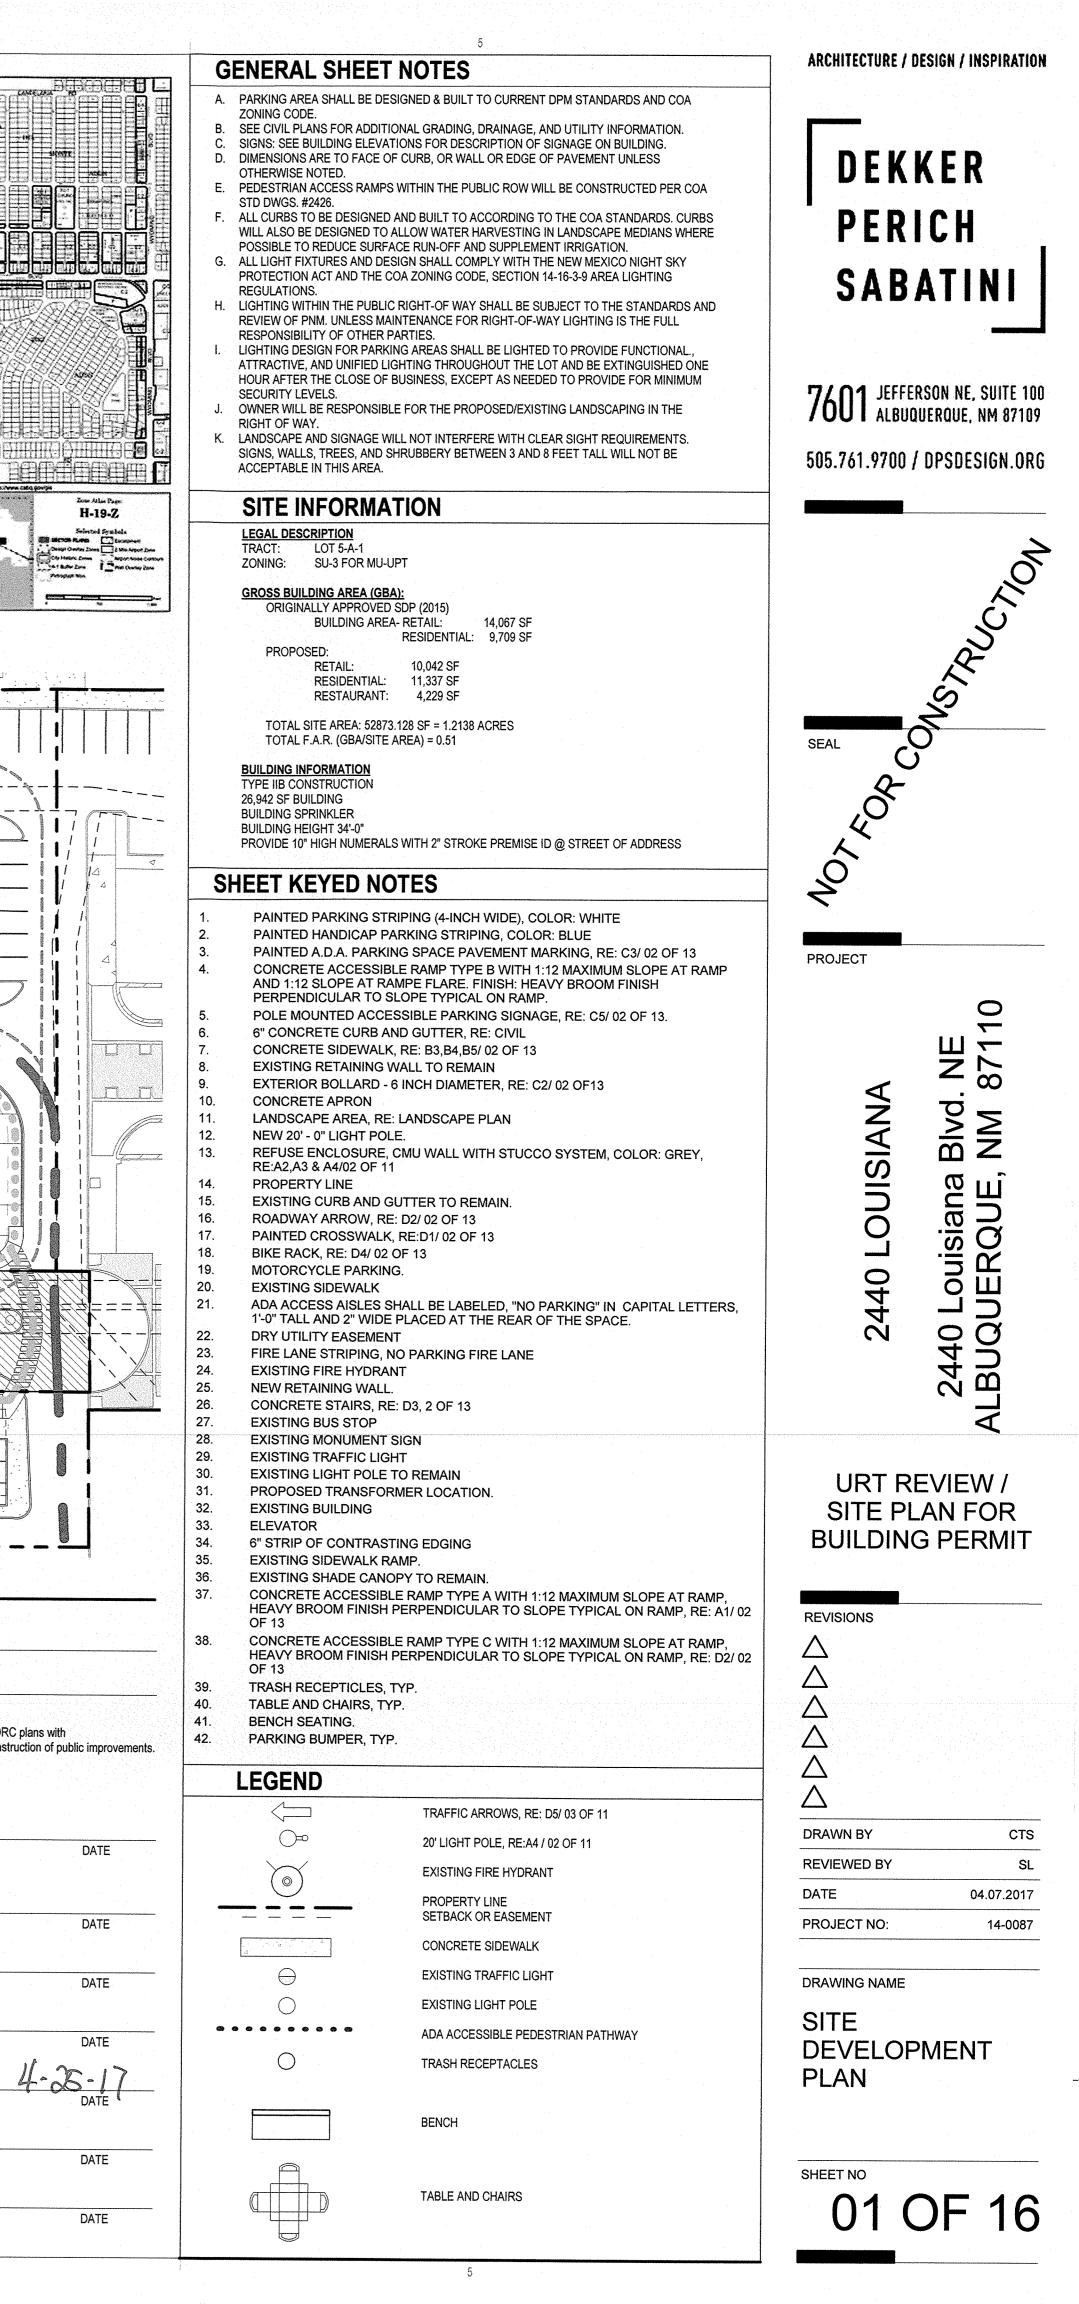


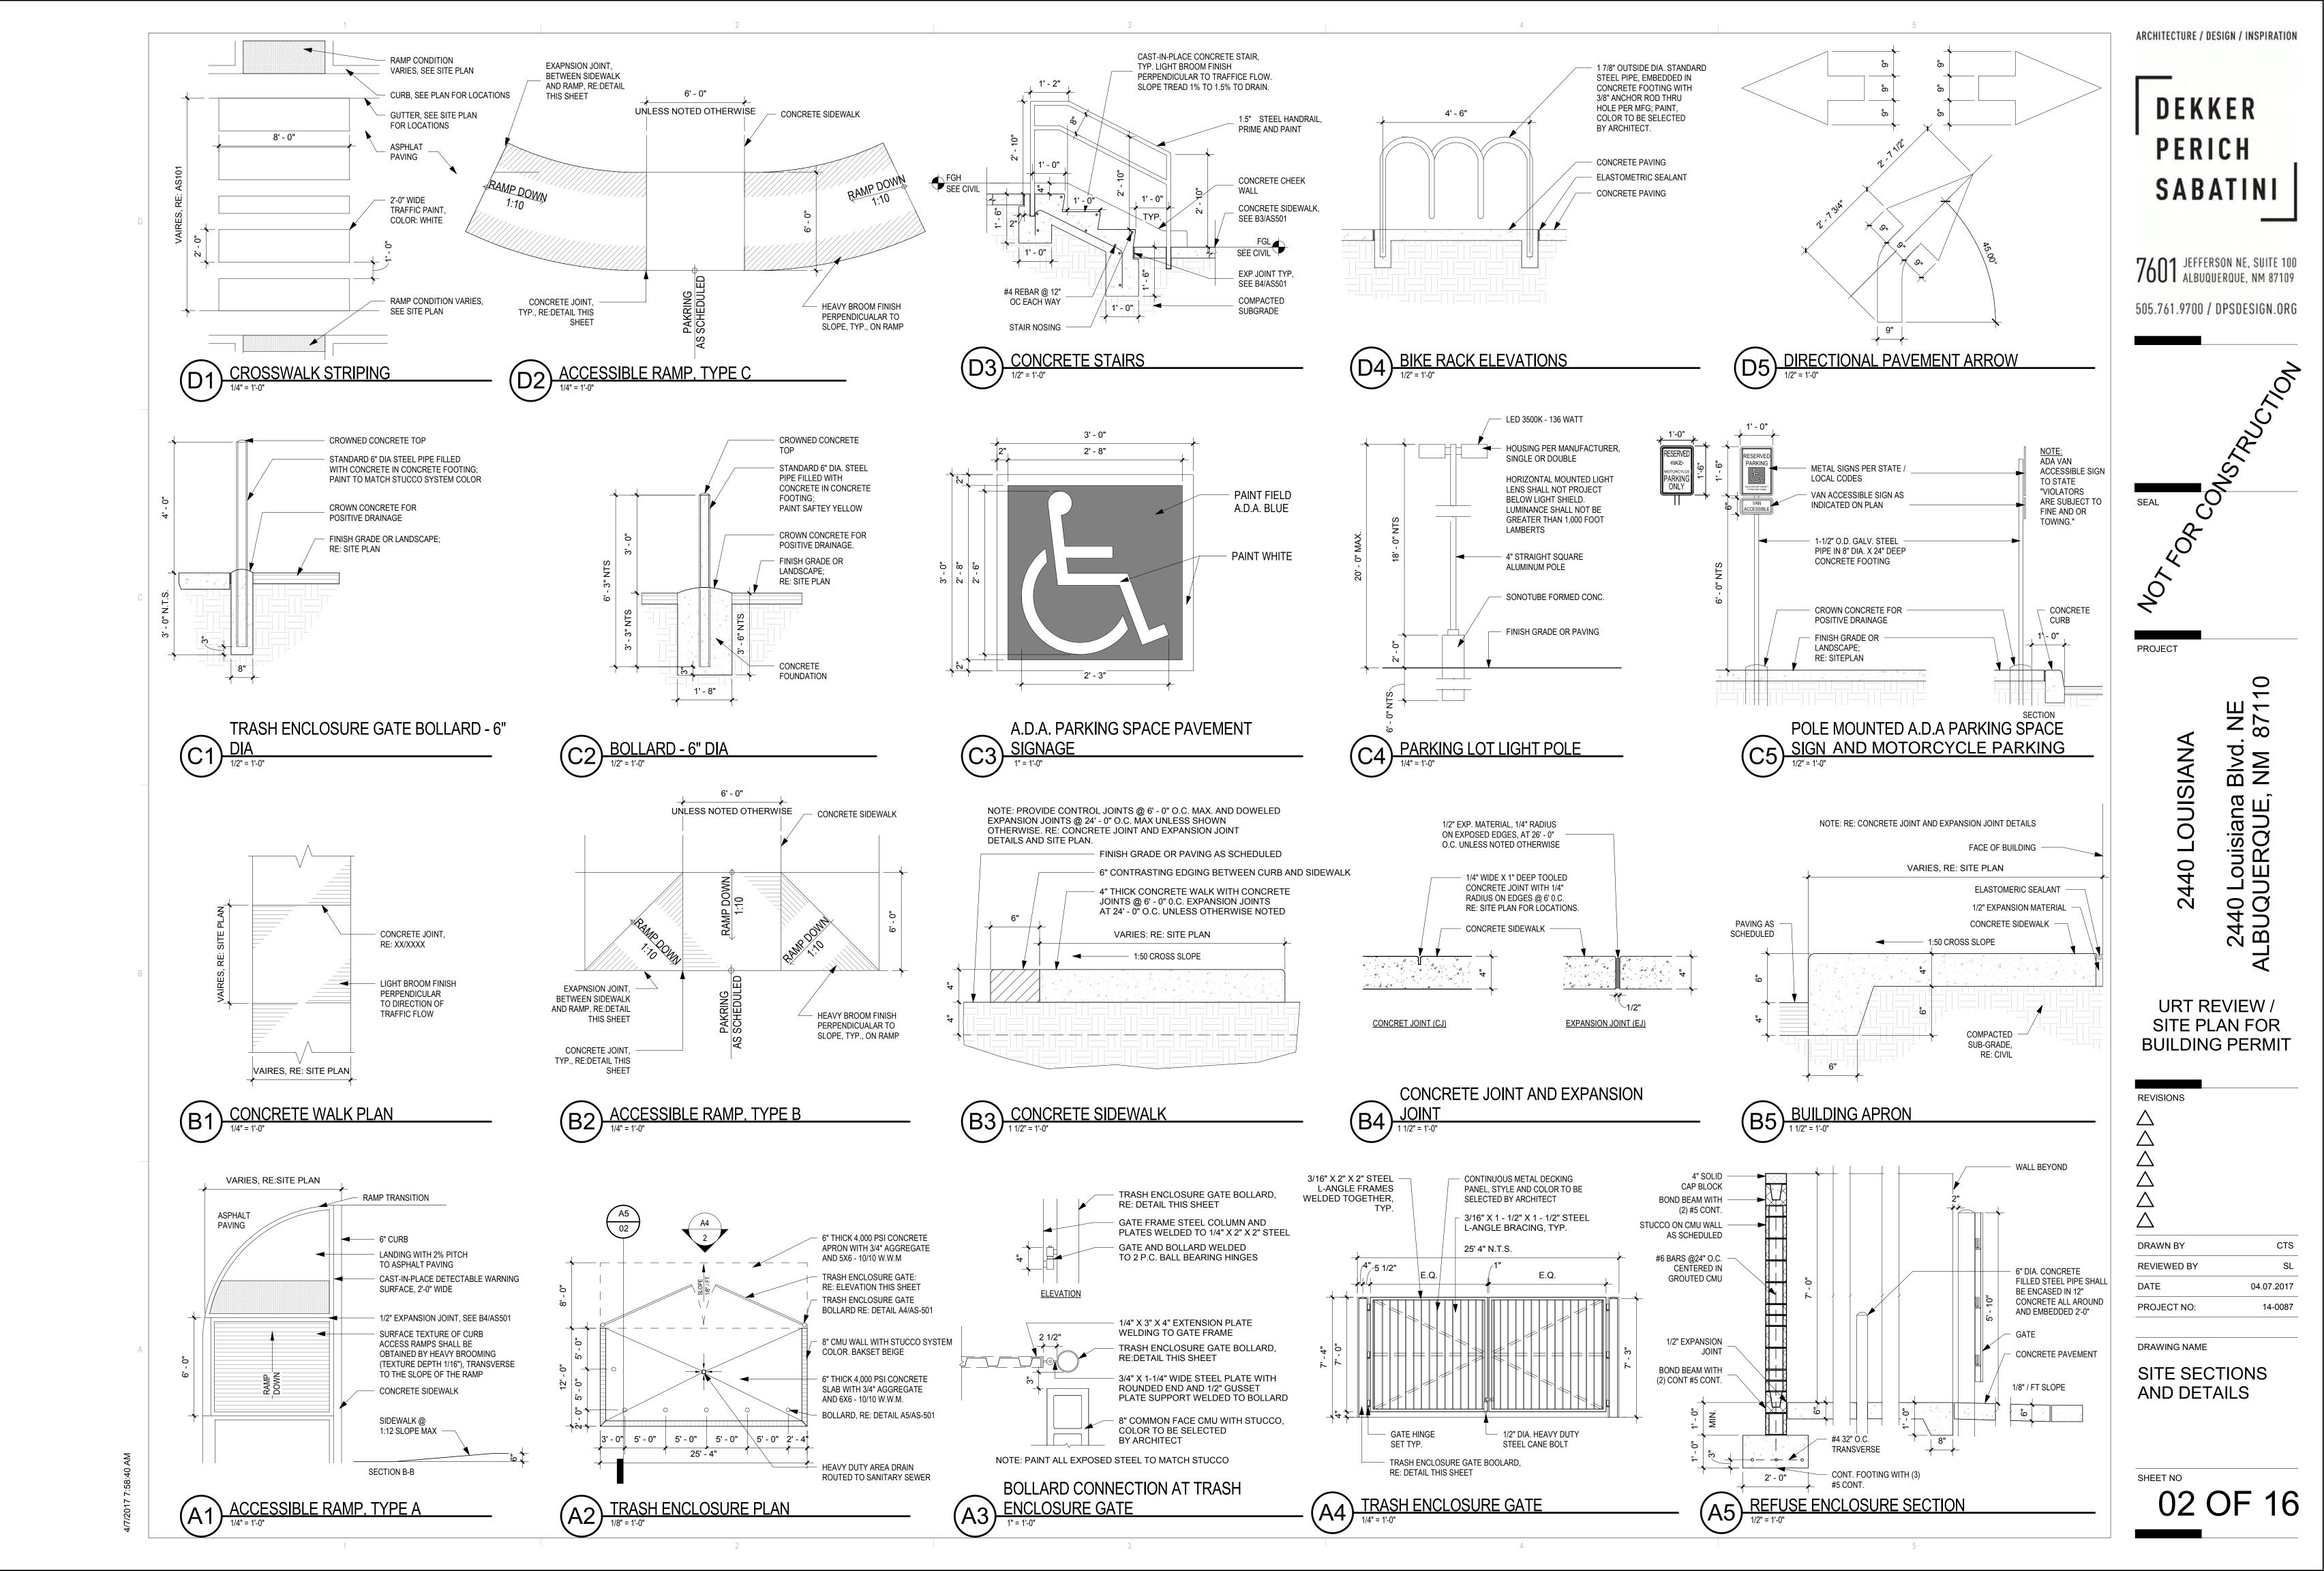


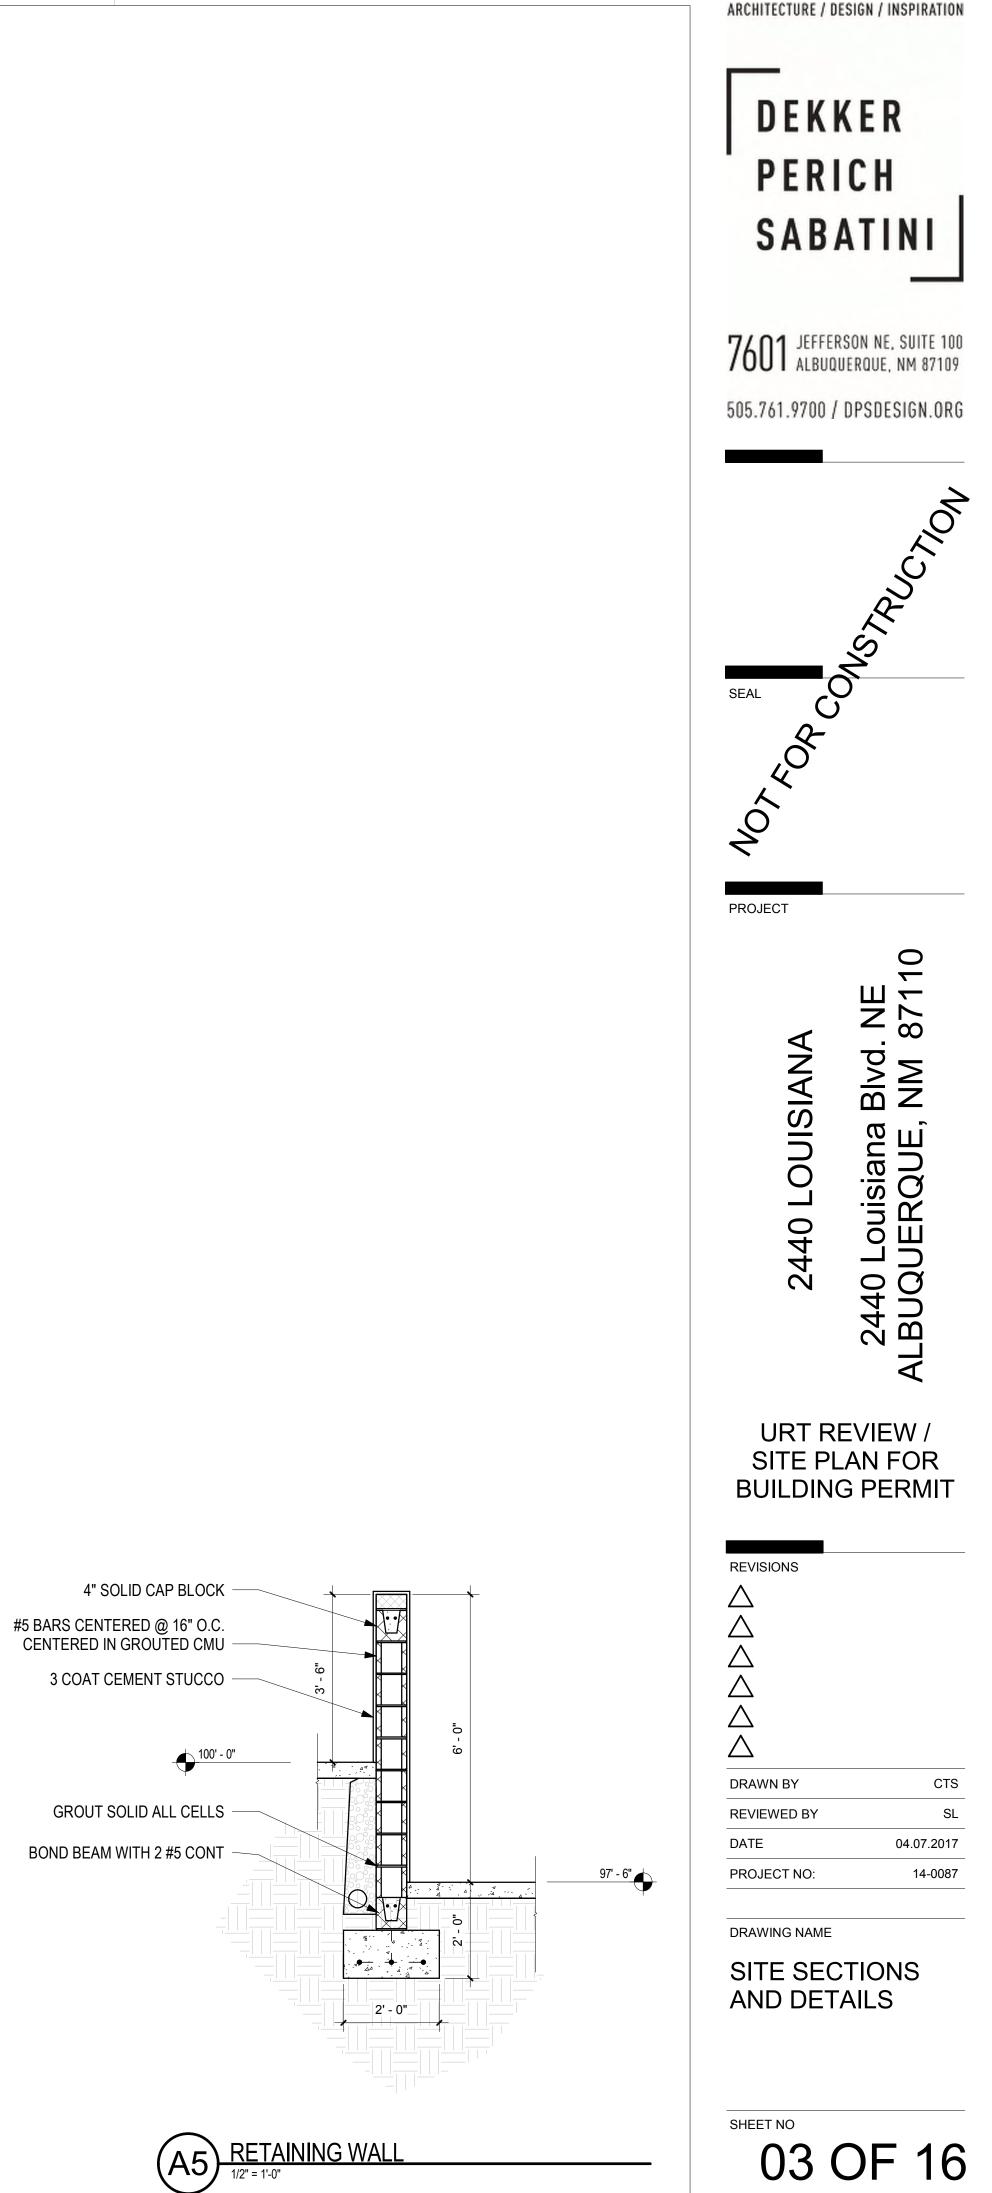

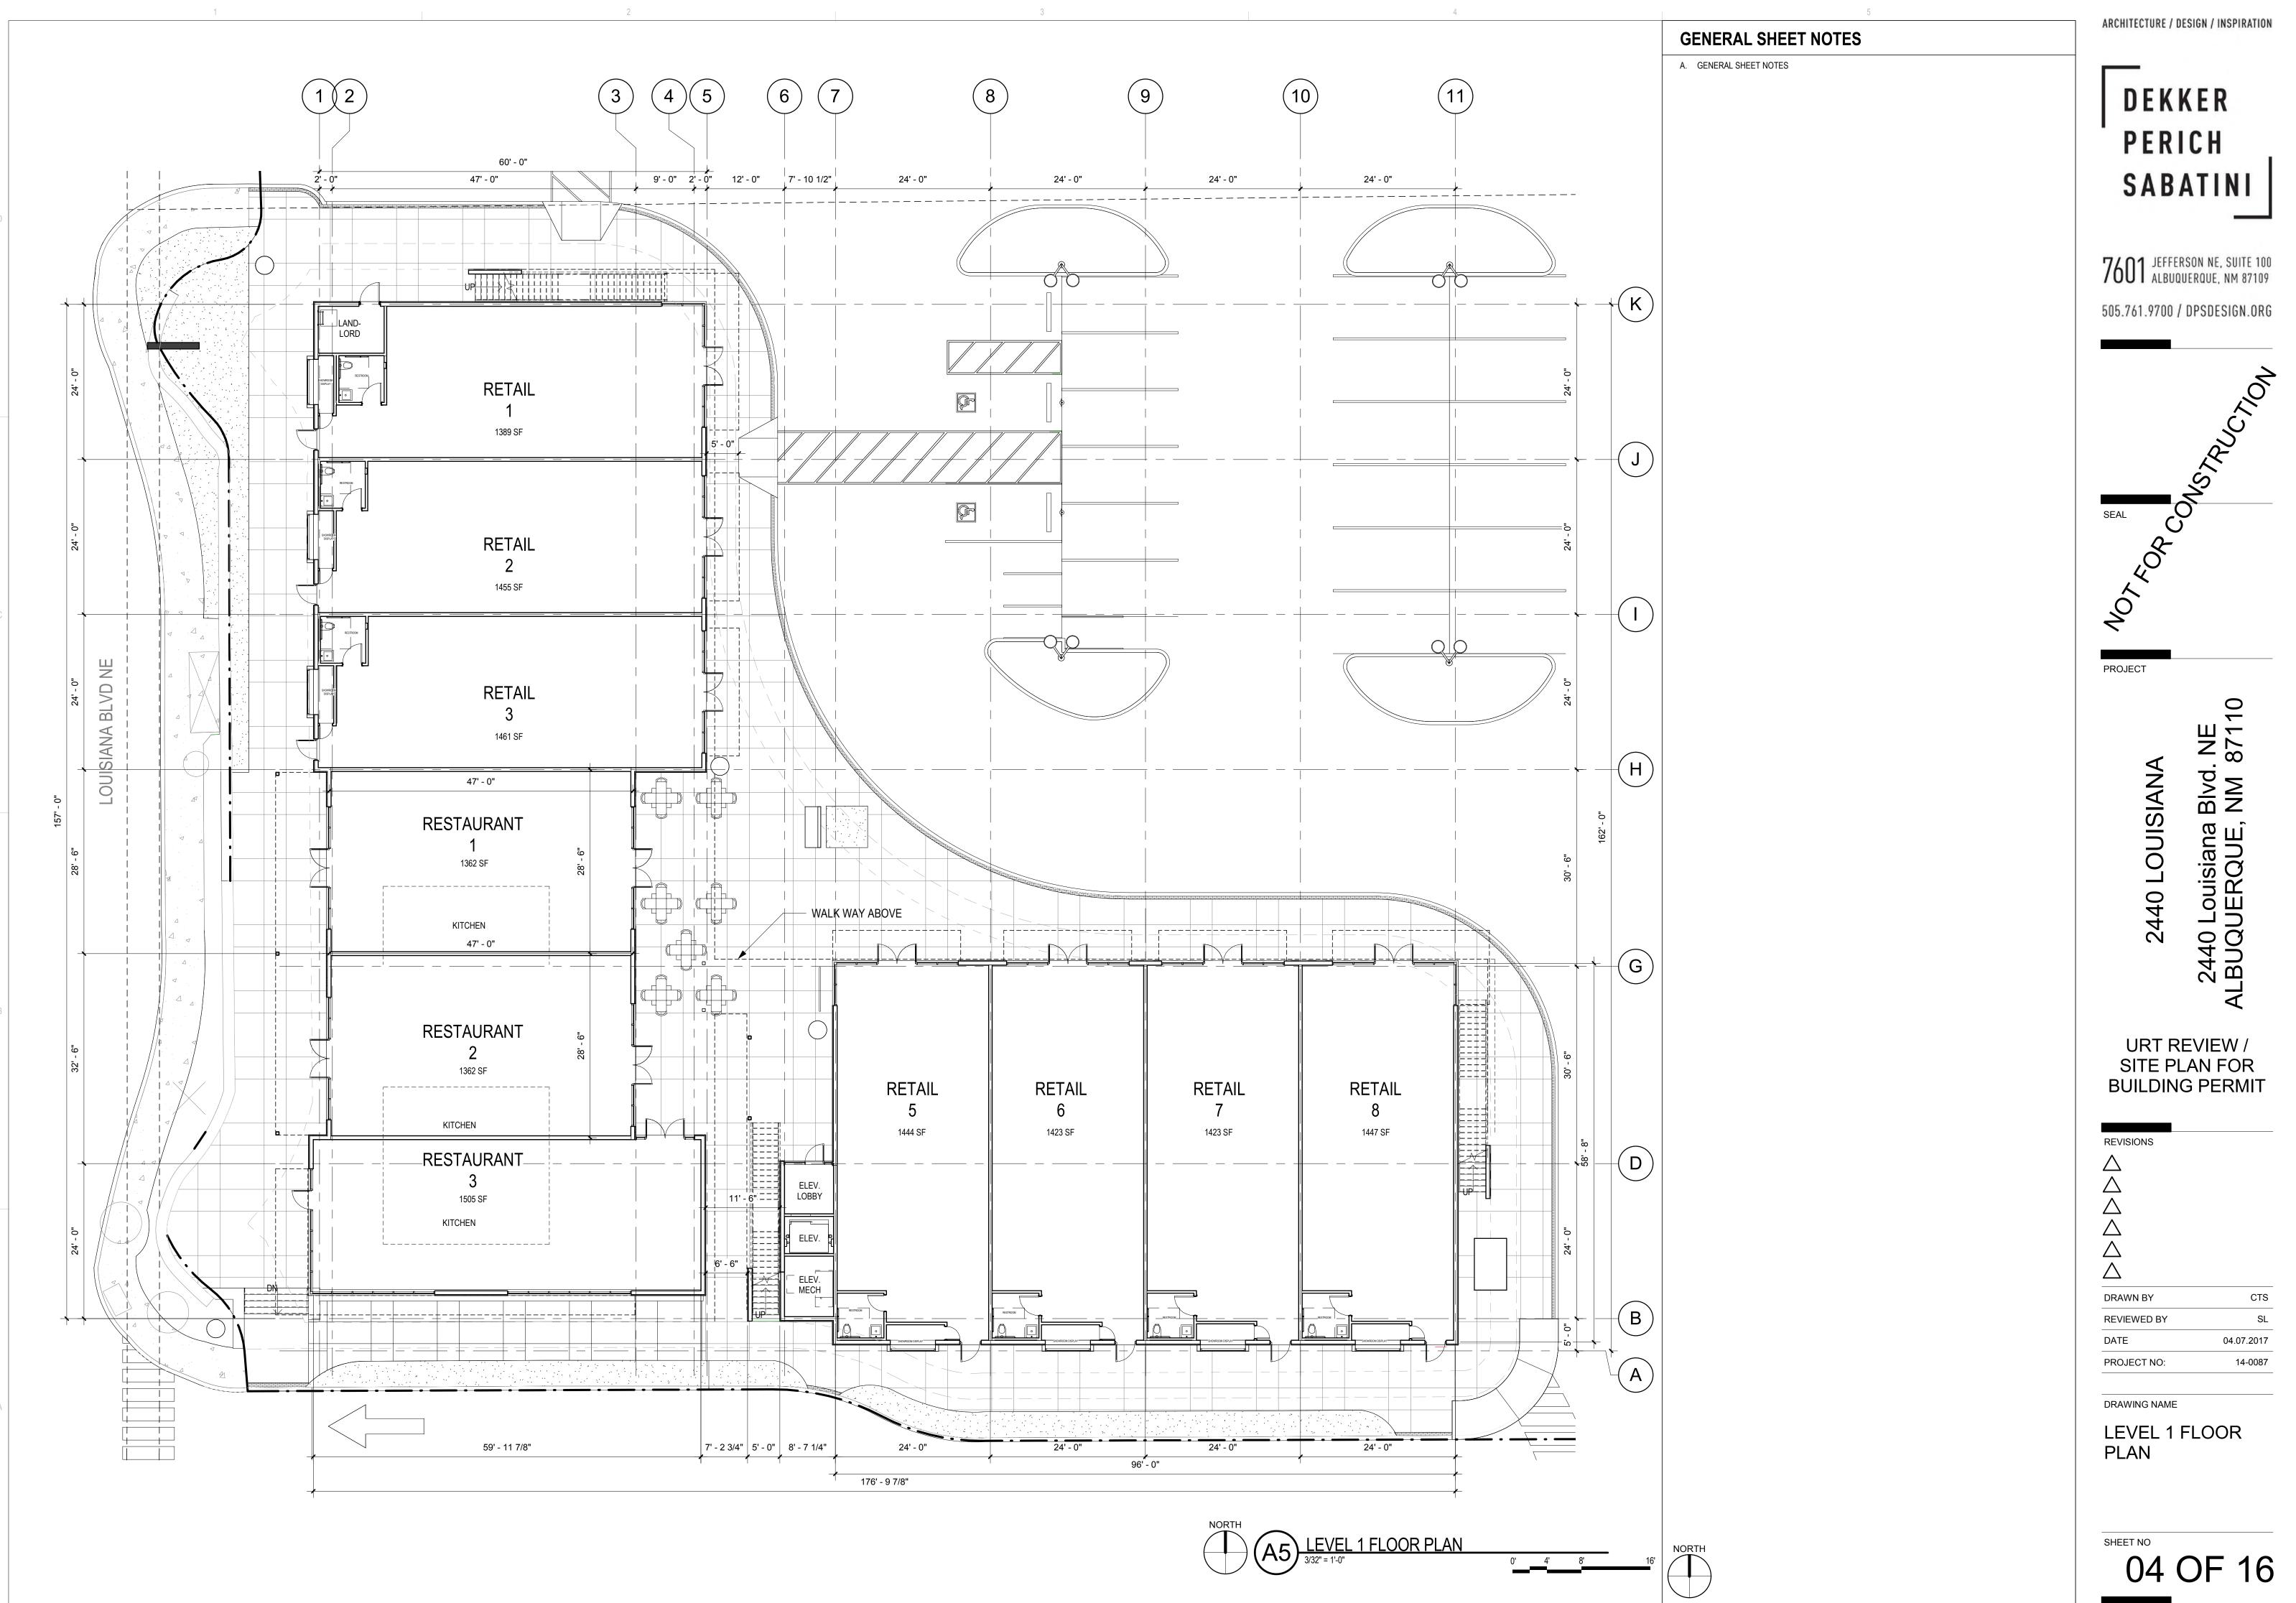



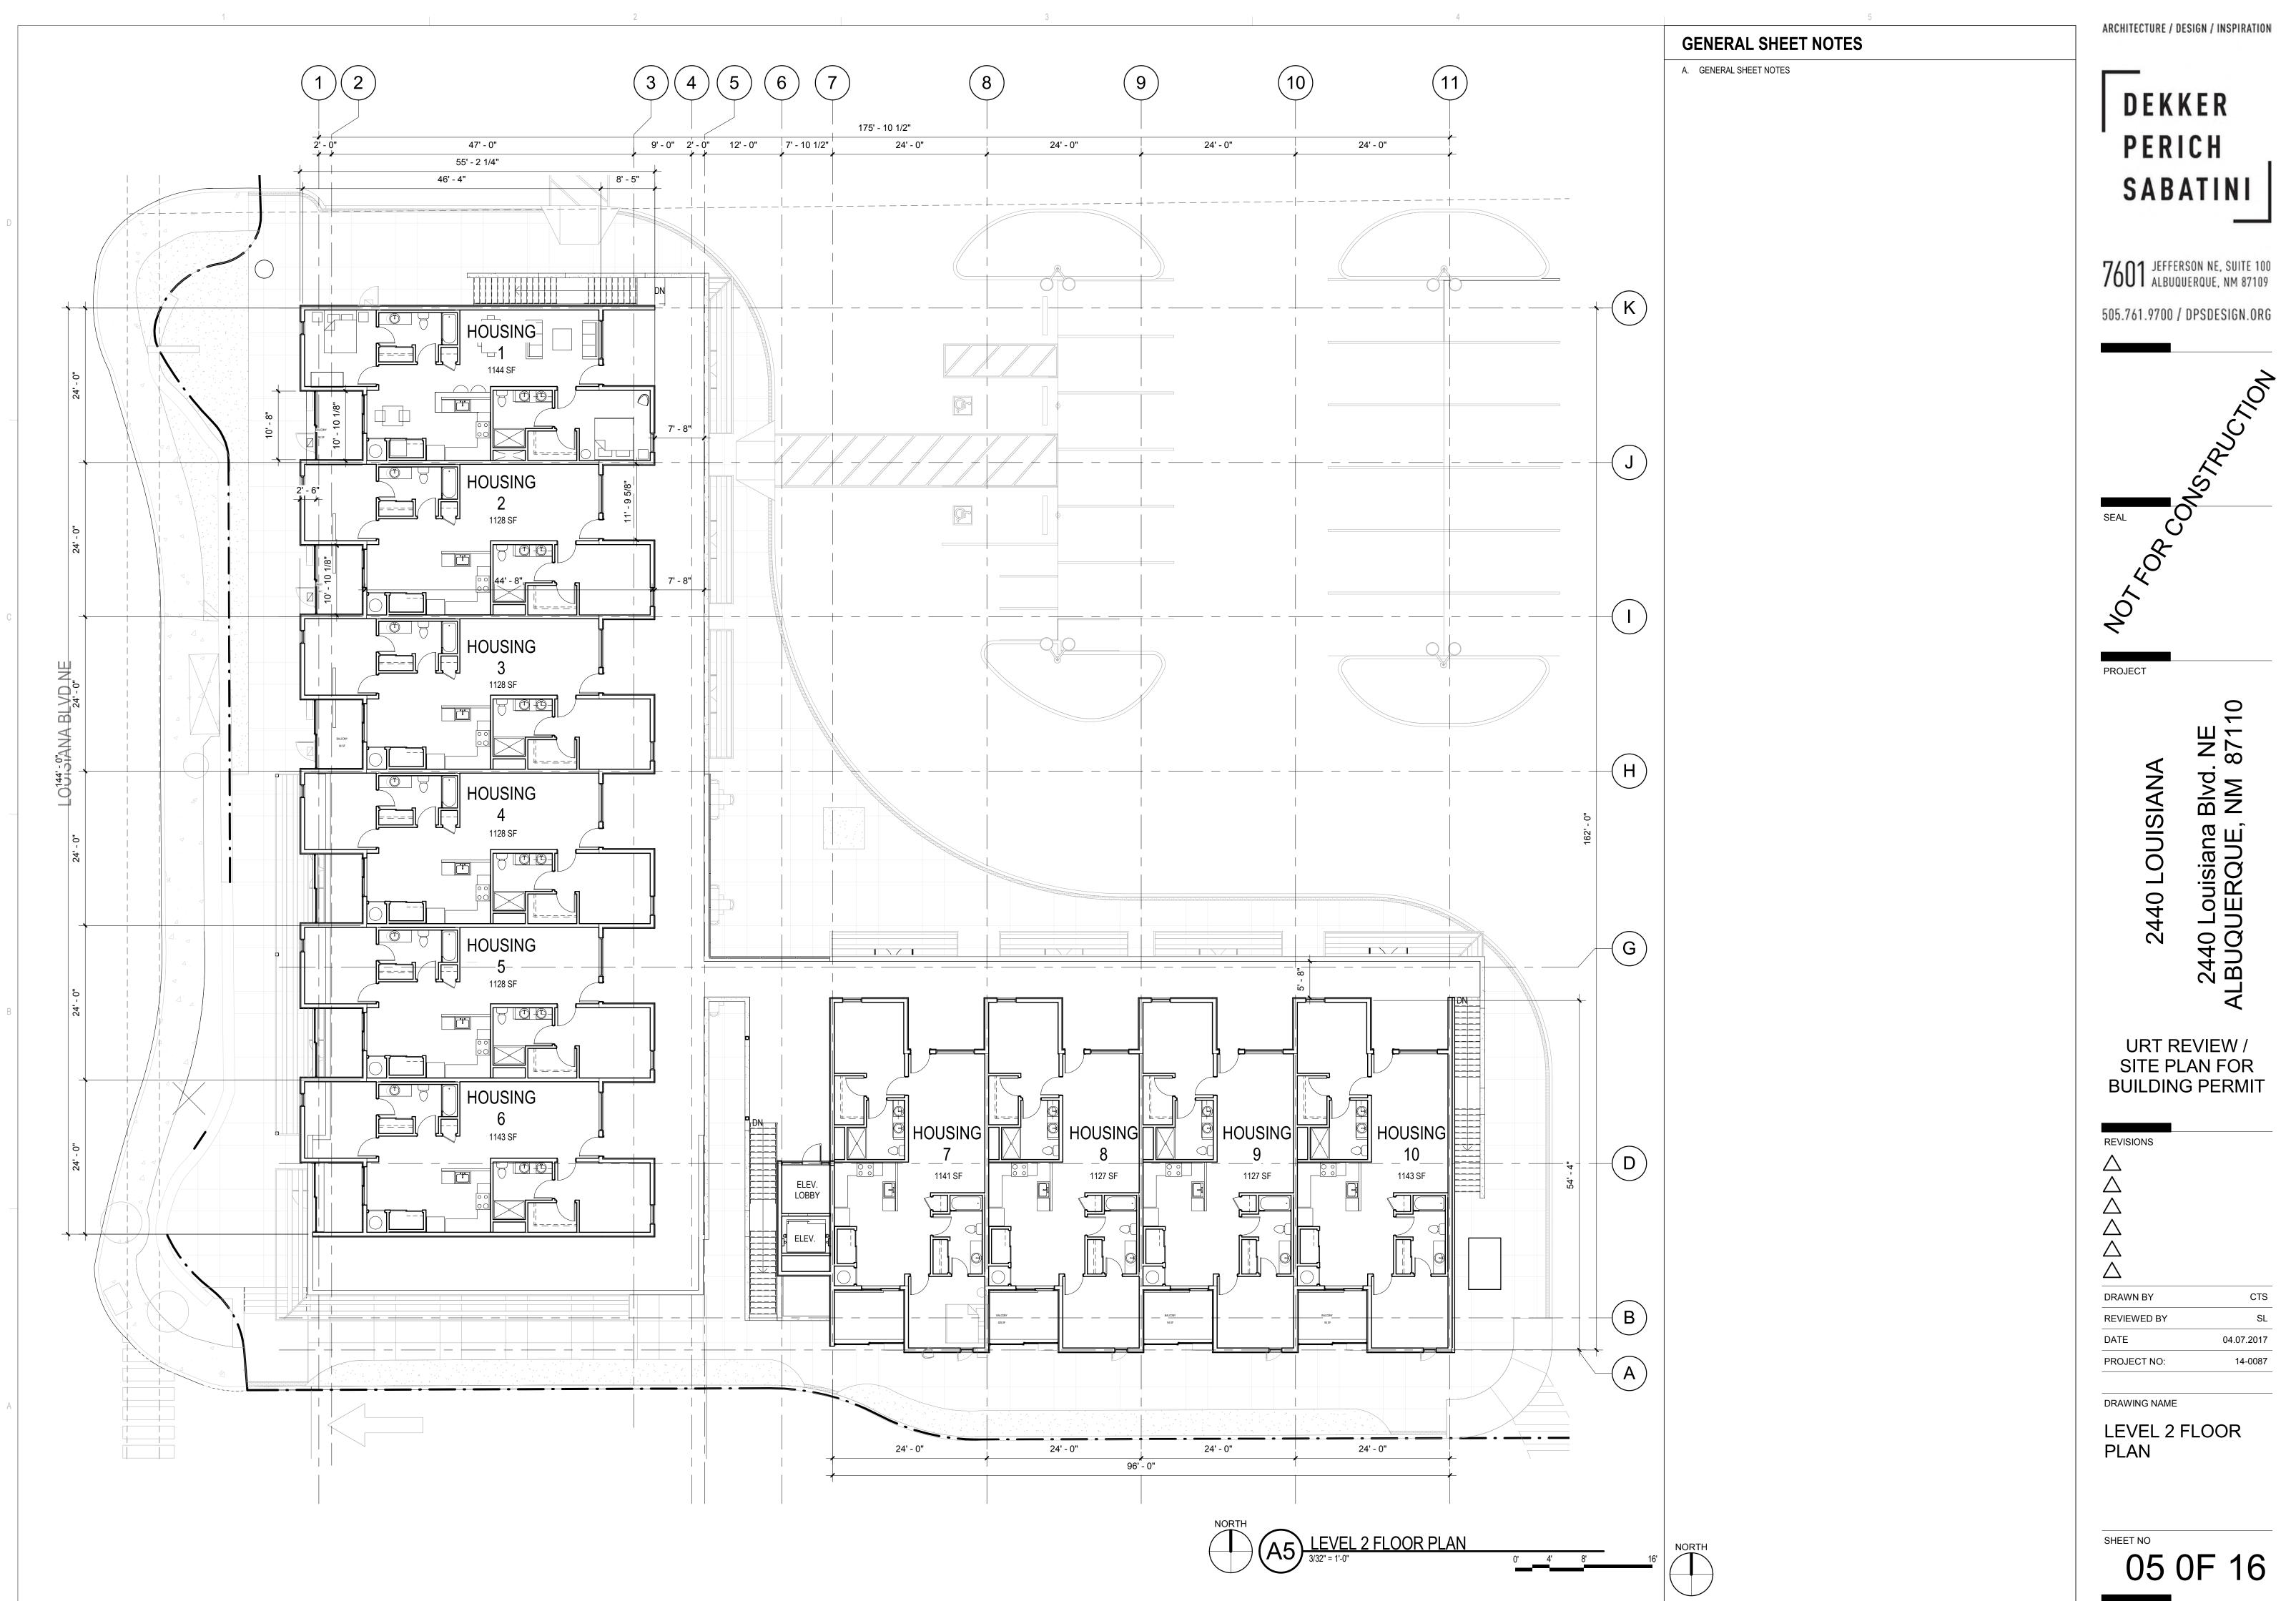

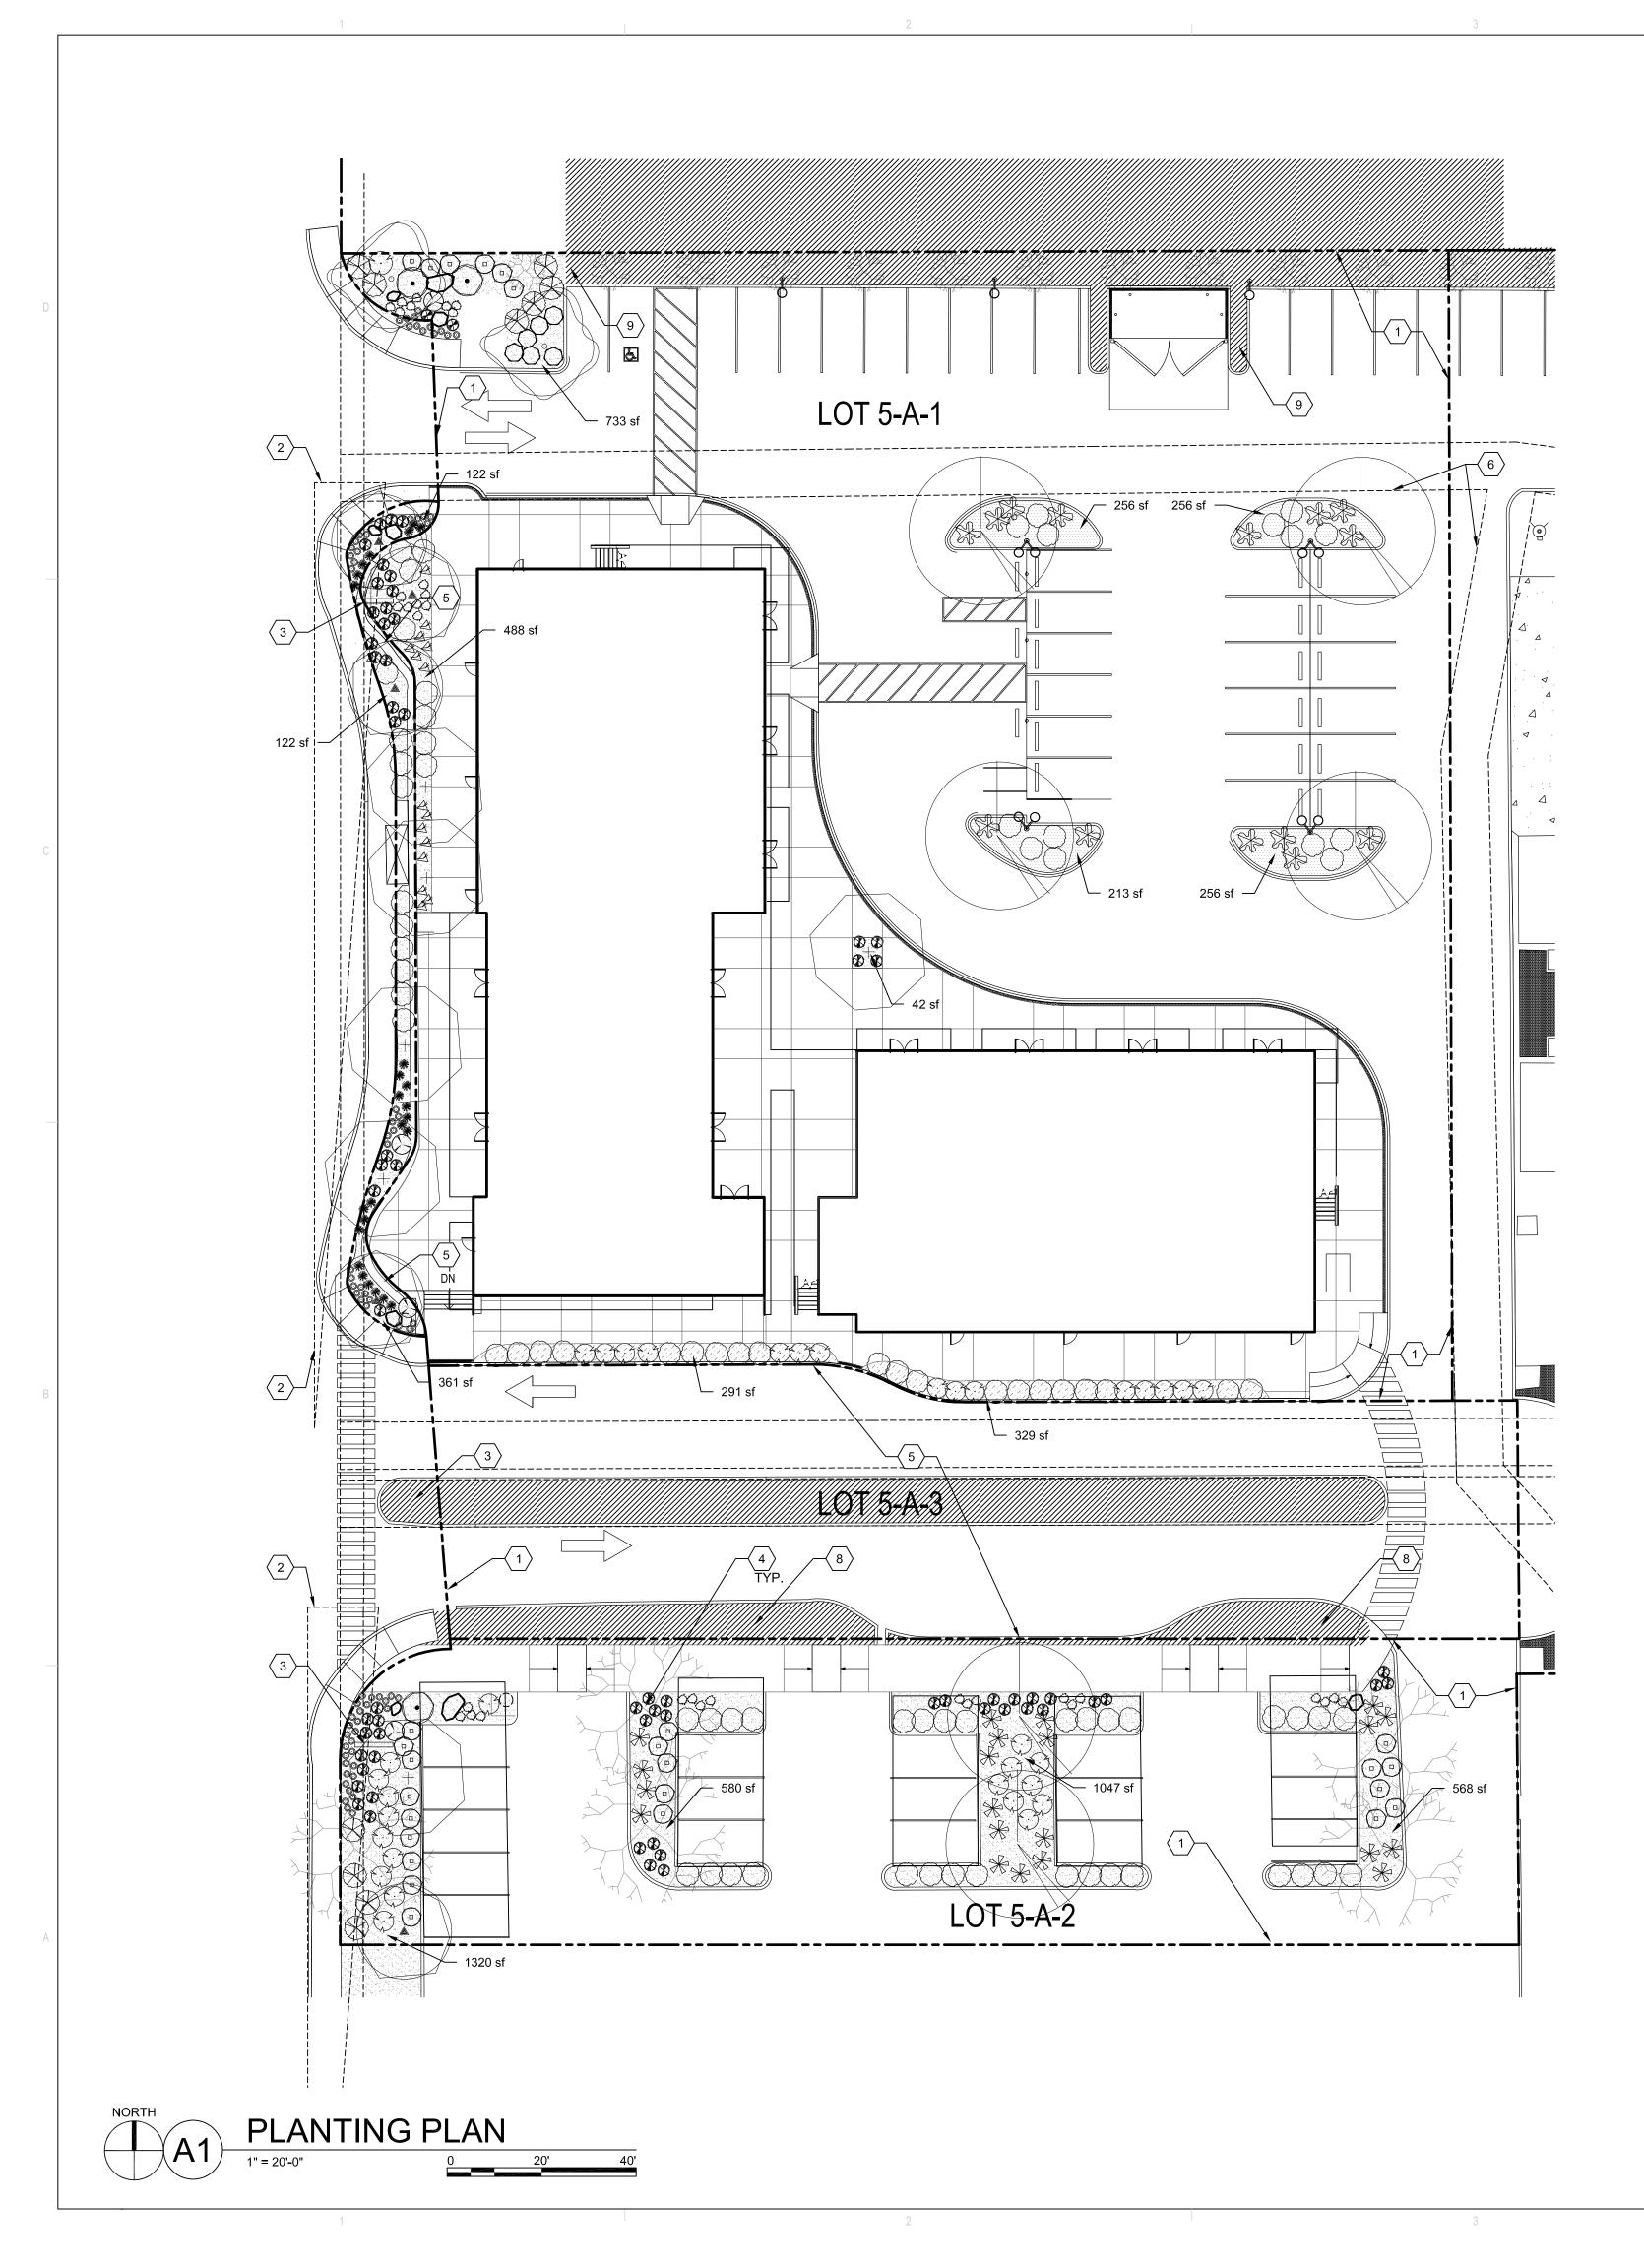

LANDSCAPE CALCUL


- TOTAL SITE AREA AREA, BOTH PROPERTIES TOTAL LANDSCAPE AREA REQUIRED;
- TOTAL LANDSCAPE BED PROVIDED:
- TOTAL LIVE GROUNDCOVER REQUIRED 75%: TOTAL LIVE GROUNDCOVER PROVIDED:
- TOTAL PARKING SPACES PROVIDED:
- TOTAL PARKING LOT TREES REQUIRED (1 PER 8 SPAC • TOTAL PARKING LOT TREES PROVIDED:
- TOTAL STREET TREES REQUIRED ON LOUISIANA (25' (TOTAL STREET TREES PROVIDED
- TOTAL STREET AND PARKING LOT TREES REQUIRED TOTAL STREET AND PARKING LOT TREES PROVIDED

* PLANT MATERIAL PROVIDED TO MEET 10% FLOWERING

- TOTAL NUMBER OF SHRUBS/PLANTS PROVIDED
- TOTAL NUMBER OF FLOWERING SHRUBS/PLANTS REQUIRED (10%)
- TOTAL NUMBER OF FLOWERING SHRUBS/PLANTS PROVIDED

KEY NOTES

- 1. PROPERTY LINE/LIMIT OF WORK LINE
- 2. SITE TRIANGLE 3. EXISTING SIGNAGE
- 4. EXISTING TREE
- 5. EXISTING RETAINING WALL 6. EXISTING EASEMENT
- 7. NOT PART OF THIS PROJECT, SEE NOTE 15 OF PLANTING NOTES THIS SHEET
- 8. EXISTING LANDSCAPE; COORDINATE WITH ADJACENT PROPERTY OWNERS FOR LANDSCAPE IMPROVEMENTS IN THIS AREA.
- 9. EXISTING LANDSCAPE TO REMAIN (SQUARE FOOTAGE AND PLANT MATERIAL NOT
- INCLUDED IN THE ABOVE CALCULATIONS). LOT 5-A-1 \Box P 60' - 10 1/4" RETAIL WITH HOUSING ABOVE 6,716 SF 923 SF RESTAURANT RETAIL WITH HOUSING ABOVE LOT 5-A-3 LOT 5-A-2 NORTH

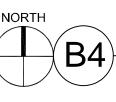

OPEN SPACE DIAGRAM 1" = 40'-0"

CHAPTER V, SECTION D. OPEN SPACE

TOTAL SITE AREA:						
LOT 5-A-1:	52,873 SF					
<u>LOT 5-A-3:</u>	16,000 SF					
TOTAL:	68,873 SF					

DPEN SPACE	
REQUIRED	
· • · · · •	

(SITE AREA*0.10) = 6,887 SF

PROVIDED LOT 5-A-1: <u>LOT 5-A-2:</u> TOTAL: 4,648 SF + 2,365 SF 7,013 SF

REQUIRED (OPEN SPACE REQUIRED* 0.40) = 2,755 SF PROVIDED LOT 5-A-1: 3,101 SF LOT 5-A-2: 2,365 SF TOTAL: 5,466 SF

LANDSCAPE AREA:

SHADED LANDSCAPE AREA REQUIRED: (LANDSCAPE AREA REQUIRED *0.15) = 413 SF

OPEN SPACE LEGEND

OPEN SPACE
LANDSCAPE

_A	TIONS	G	Ε
	68,873 SQFT	A.	F
	2,755 SQFT 6,984 SQFT	A. B.	R
	2,066 SQFT 3,445 SQFT	Ρ	
	54		L/
CES):	7 12 (4 EX./8 NEW)	1.	TH ALI
O.C.)	15 12 (1 EX./11 NEW)	2.	WA LAI
	22 24 (5 EX./19 NEW)	3.	INS OC AF
		4. 5.	PR TH LAI SH
SHRU	JB/FLOWER REQUIREMENT 415	6. 7.	CA NO LAI
	42 259 (62%)	8.	IF [TH FO
	200 (02 %)	9.	IT I UN IRF
		10.	MIN PL/
		11.	LA



E AREA AREA

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ENERAL SHEET NOTES

FOR GRADING AND DRAINAGE INFORMATION, SEE CIVIL DRAWINGS. DO NOT RELY ON LANDSCAPE DRAWINGS FOR GRADING INFORMATION. FOR ADDITIONAL INFORMATION ON SITE ELEMENTS, SEE SITE PLAN.

ANTING NOTES

- E LANDSCAPE DESIGN SHALL COMPLY WITH THE INTENT OF THE CITY OF BUQUERQUE WASTE WATER CONSERVATION, LANDSCAPING AND WATER ASTE ORDINANCE.
- NDSCAPING SHALL BE INSTALLED ACCORDING TO THE APPROVED PLAN; STALLATION SHALL BE COMPLETE WITHIN 60 DAYS OF THE RELATED BUILDING'S CCUPANCY. TER SUBSTANTIAL COMPLETION, THE INSTALLATION AND MAINTENANCE OF
- NDSCAPING AND IRRIGATION SHALL BE THE RESPONSIBILITY OF THE ROPERTY OWNER. IS PLAN ALSO SERVES AS THE PROJECTS STREET TREE PLAN . NDSCAPING SHALL HAVE ADEQUATE MAINTENANCE. LANDSCAPING WHICH DIES
- ALL BE REPLACED BY THE OWNER AS EXPEDITIOUSLY AS POSSIBLE , BUT IN NO ASE LONGER THAN 60 DAYS AFTER NOTIFICATION. TURF IS BEING PROPOSED IN THIS PROJECT.
- NDSCAPE AREAS SHALL BE COVERED WITH MULCH. SEE PLANTING LEGEND. DISCREPANCIES OCCUR BETWEEN THE DRAWINGS AND THE SITE CONDITIONS, E LANDSCAPE CONTRACTOR SHALL NOTIFY THE OWNER'S REPRESENTATIVE OR CLARIFICATION PRIOR TO PROCEEDING ON THAT PORTION OF WORK.
- IS THE LANDSCAPE CONTRACTOR'S RESPONSIBILITY TO LOCATE ALL NDERGROUND UTILITIES PRIOR TO COMMENCEMENT OF PLANTING AND RIGATION OPERATIONS. NIMUM INSTALLATION SIZES FOR PLANT MATERIAL VARY BY SPECIES. SEE
- ANT LEGEND. NDSCAPE ARCHITECT SHALL APPROVE ALL PLANT MATERIAL PRIOR TO PLANTING, AND RESERVES THE RIGHT TO REFUSE ANY PLANT MATERIAL DEEMED
- UNACCEPTABLE. 12. ALL PLANT MATERIAL MUST BE NURSERY GROWN, AND ALL PLANTS SHALL BEAR SAME RELATION TO FINISHED GRADE AS IN ORIGINAL NURSERY CONDITION.
- 13. NATIVE SOILS MAY BE USED FOR LANDSCAPE INSTALLATION, BUT SHALL BE BLENDED WITH IMPORTED TOPSOIL BLEND AND/OR COMPOST. 14. WHERE MULCH IS ADJACENT TO CONCRETE, FINISH GRADE OF MULCH TO BE
- APPROXIMATELY 1/2" BELOW TOP OF CONCRETE. 15. A MINIMUM OF 10% OF ALL LANDSCAPED AREA SHALL CONTAIN FLOWERING
- PLANTS AND FLOWERING SHRUBS. 16. NO PARKING SPACE SHALL BE MORE THAN SIXTY (60) FEET FROM A TREE TRUNK.

IRRIGATION NOTES

- THE IRRIGATION SYSTEM DESIGN SHALL COMPLY WITH ALL CITY WATER
- CONSERVATION LANDSCAPE AND WASTE WATER ORDINANCES. A FULLY AUTOMATED IRRIGATION SYSTEM WILL BE USED TO IRRIGATE TREES, SHRUBS, AND GROUNDCOVER PLANTING AREAS.
- THE IRRIGATION SYSTEM SHALL BE CONNECTED TO CITY WATER. THE POINT OF CONNECTION SHALL CONSIST OF A WATER METER, BACKFLOW PREVENTER AND MASTER VALVE, SEE COA STD DETAIL 2701.
- 4. THE IRRIGATION SYSTEM SHALL BE DESIGNED WITH SEPARATE ZONES ACCORDING TO PLANT WATER REQUIREMENTS. . EACH TREE SHALL RECEIVE THREE (3) - TWO (2) GPH EMITTERS. EACH
- SHRUB/PERENNIAL SHALL RECEIVE TWO (2) TWO (2) GPH EMITTERS. 6. THE MAINTENANCE OF THE IRRIGATION SYSTEM SHALL BE THE RESPONSIBILITY OF THE PROPERTY OWNER.


PLANTING LEGEND * PLANT MATERIAL PROVIDED TO MEET 10% FLOWERING SHRUB/FLOWER REQUIREMENT						
SYMBOL	SCIENTIFIC NAME/	COMMON NAME				
TREES - SE	E A1-LP501					
+	Robinia pseudoacacia 'Purple Robe'	PURPLE ROBE LOCUST				
	Platanus wrightii	ARIZONA SYCAMORE				
•	Zelkova serrata	GREEN VASE ZELKOVA				
	Ulmus parviflora 'Emer II'	Allee Elm				
SHRUB - SE	E A2-LP501					
	 Buddleia davidii nanhoensis 'Nanho Purple' 	DWARF PURPLE BUTTERFLY BUSH				
\bigcirc	* Rosa 'Seafoam'	SEAFOAM ROSE				
\odot	Pinus mugo pumilio	DWARF MUGO PINE				
\bigcirc	* Rhaphiolepis 'Blueberry muffin'	BLUEBERRY INDIAN HAWTHORN				
×	* Prunus besseyi 'Pawnee Buttes'	CREEPING SAND CHERRY				
PERENNIAL	S - SEE A2-LP501					
	* Salvia darcyi 'Pscarl'	VERMILLION BLUFFS MEXICAN SAGE				
\odot	* Lavandula angustifolia 'Hidcote'	DEEP BLUE LAVENDER				
GROUNDCO	OVERS - SEE A2-LP501					
\bigotimes	Juniperus horizont alis 'Wiltonii'	BLUE RUG JUNIPER				
$\mathbf{\hat{\mathbf{x}}}$	* Ericameria larcifolia	TURPENTINE BUSH				
Æ	* Euphorbia rigida	SPURGE				
ACCENTS 8	GRASSES - SEE A2-LP501					
*	Calamagrostis acutiflora 'Karl Foerster'	KARL FOERSTER REED GRASS				
\Re	* Hesperaloe parviflora	RED YUCCA				
\bigcirc	Bouteloua 'Blonde Ambition'	BLONDE AMBITION BLUE GRAMA				
\bigcirc	Muhlenbergia rigens	DEER GRASS				
	ES AND MULCH - SEE SPECS					
SYMBOL JU YHJ	DESCRIPTION					
	EXISTING VEGETATION TO REMAIN					
	3" DEPTH 1-1/2" GRAVEL OVER FILTER FABRIC, COLOR: BUILDOLOGY BROWN					
	3" DEPTH, 7/16" GRAVEL OVER FILT BUILDOLOGY BROWN	ER FABRIC, COLOR:				
	4" DEPTH, 2-4" STONE PLATING OVER FILTER FABRIC, COLOR: SANGRIA					

MOSSROCK BOULDERS, SIZES RANGE FROM 2'x2'x2' to 4'x4'x4'

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PROJECT




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URT REVIEW

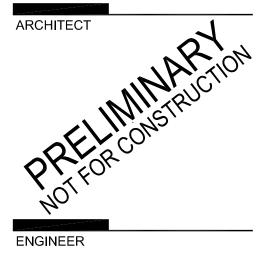

DRAWN BY

DATE

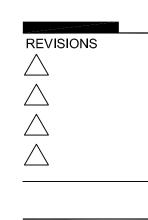REVIEWED BY


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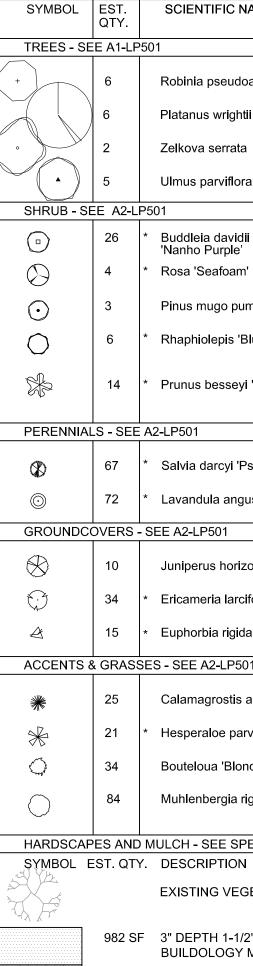
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CD KR/MB 04.04.2017 14-0087

PLANTING PLAN

SHEET NO 06 OF 16




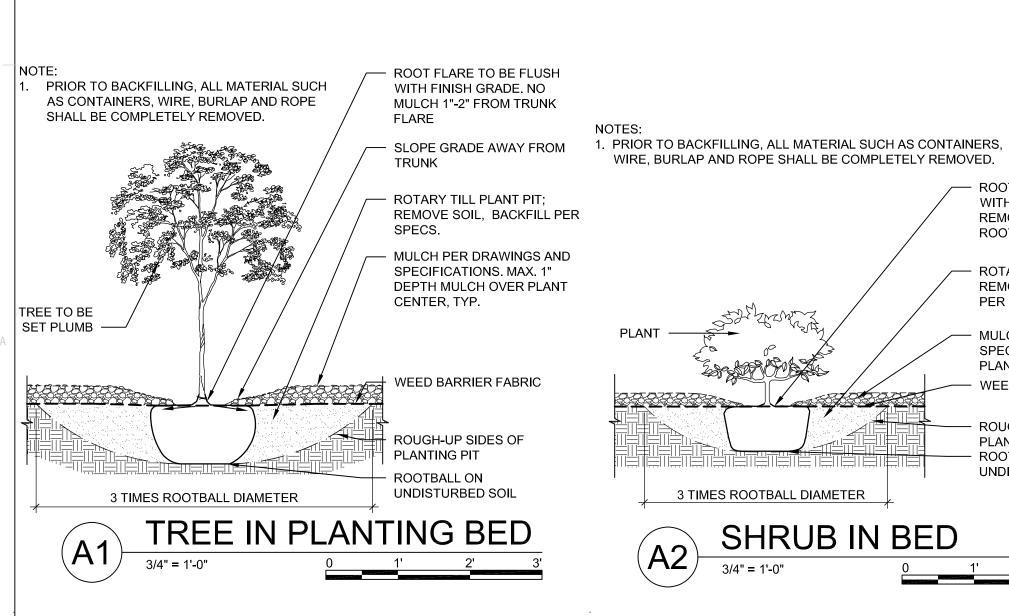

ROOT FLARE TO BE FLUSH WITH FINISH GRADE. REMOVE SOIL TO EXPOSE ROOT FLARE NOTES:

V.I.T. PRODUCTS - 800-729-1314


- ROTARY TILL PLANT PIT; REMOVE SOIL. BACKFILL PER SPECS.
- MULCH PER DWGS. AND SPECS - 1" DEPTH OVER PLANT CENTER TYP. WEED BARRIER FABRIC
- ROUGH-UP SIDES OF PLANTING PIT - ROOTBALL ON UNDISTURBED SOIL

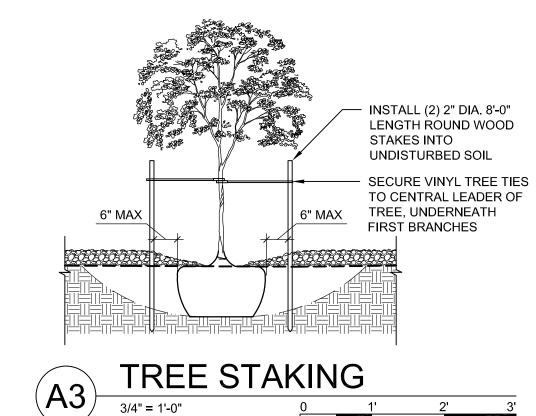


1. VINYL TREE TIES TO BE CINCH-TIE 32" OR APPROVED EQUAL, AVAILABLE FROM

2. STAKING TO BE REMOVED AT THE END OF WARRANTY PERIOD

NOTES: 1. BOULDER SELECTION AND PLACEMENT SHALL BE COORDINATED WITH ARCHITECT PRIOR TO INSTALLATION. 2. BOULDER SIZES:

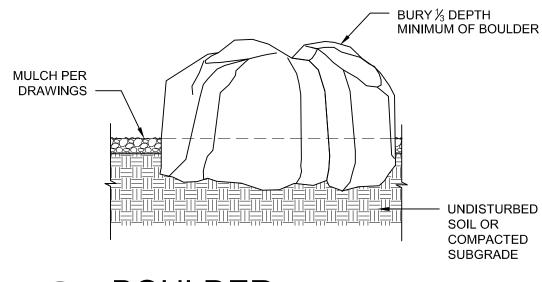

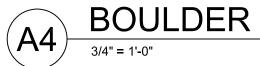




			5				
PLANTING SCHEDULE * PLANT MATERIAL PROVIDED TO MEET 10% Flowering shrub/flower requirement							
SYMBOL	EST. QTY.	SCIENTIFIC NAME/	COMMON NAME	INSTALL SIZE	MA ⁻ HT.	TURE DIA.	
TREES - SE	E A1-LF	2501			·		
+	6	Robinia pseudoacacia 'Purple Robe'	PURPLE ROBE LOCUST	2" CAL.	45.00	30.00	
$\overline{\langle}$	6	Platanus wrightii	ARIZONA SYCAMORE	2" CAL.	40.00	35.00	
•	2	Zelkova serrata	GREEN VASE ZELKOVA	2" CAL.	35.00	25.00	
	5	Ulmus parviflora 'Emer II'	ALLEE ELM	2" CAL.	50.00	35.00	
SHRUB - SE	E A2-L	P501		ı	. <u> </u>		
	26	* Buddleia davidii nanhoensis 'Nanho Purple'	DWARF PURPLE BUTTERFLY BUSH	5-GAL	5.00	4.00	
\bigcirc	4	* Rosa 'Seafoam'	SEAFOAM ROSE	5-GAL	3.00	4.00	
\odot	3	Pinus mugo pumilio	DWARF MUGO PINE	5-GAL	4.00	7.00	
\bigcirc	6	* Rhaphiolepis 'Blueberry muffin'	BLUEBERRY INDIAN HAWTHORN	5-GAL	4.00	4.00	
	14	* Prunus besseyi 'Pawnee Buttes'	CREEPING SAND CHERRY	5-GAL	2.00	6.00	
PERENNIAL	_S - SEE	A2-LP501		I	·		
$\langle\!\!\!\langle$	67	* Salvia darcyi 'Pscarl'	VERMILLION BLUFFS MEXICAN SAGE	1-GAL	3.00	2.00	
\odot	72	72 * Lavandula angustifolia 'Hidcote' DEEP BLUE LAVENDER		1-GAL	1.50	1.50	
GROUNDC	JVERS	- SEE A2-LP501		ı			
\otimes	10	Juniperus horizont alis 'Wiltonii'	BLUE RUG JUNIPER	5-GAL	0.75	8.00	
Ċ	34	* Ericameria larcifolia	TURPENTINE BUSH	5-GAL	4.00	4.00	
	15	∗ Euphorbia rigida	SPURGE	1-GAL	2.00	2.00	
ACCENTS &	& GRAS	I I I I I I I I I I I I I I I I I I I		J			
₩	25	Calamagrostis acutiflora 'Karl Foerster'	KARL FOERSTER REED GRASS	5-GAL	4.00	2.00	
×	21	* Hesperaloe parviflora	RED YUCCA	5-GAL	4.00	4.00	
\bigcirc	34	Bouteloua 'Blonde Ambition'	BLONDE AMBITION BLUE GRAMA	1-GAL	2.00	2.00	
\bigcirc	84	Muhlenbergia rigens	DEER GRASS	5-GAL	5.00	5.00	
HARDSCAF	'ES ANE	 D MULCH - SEE SPECS (QUANTITIES BEL	 OW ARE GENERAL ONLY)]	<u> </u>		

ARCHITECTURE / DESIGN / INSPIRATION

DEKKER PERICH SABATINI

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PROJECT

NICO XICO **A** LOUISIAN 2440 Louisiana Blvd BUQUERQUE, NEW ME 2440

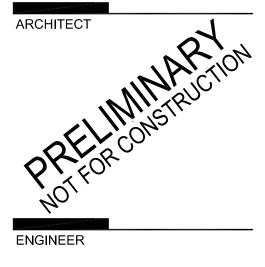
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URT REVIEW

REVISIONS \bigtriangleup \triangle \triangle


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DRAWING NAME PLANTING SCHEDULE AND DETAILS

SHEET NO 07 OF 16



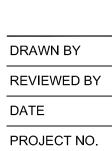

EXISTING VEGETATION TO REMAIN

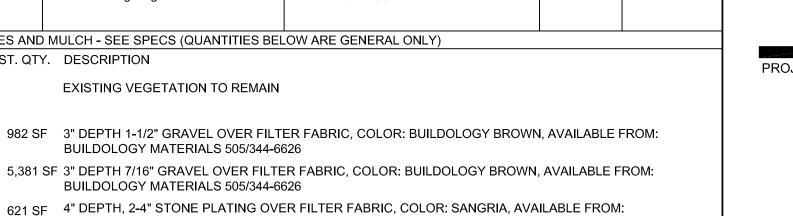BUILDOLOGY MATERIALS 505/344-6626


BUILDOLOGY MATERIALS 505/344-6626

BUILDOLOGY MATERIALS 505/344-6626

10 COLOR: AS LOCALLY AVAILABLE

MOSSROCK BOULDERS, SIZES RANGE FROM 2'x2'x2' to 4'x4'x4'

MINIMUM OF BOULDER

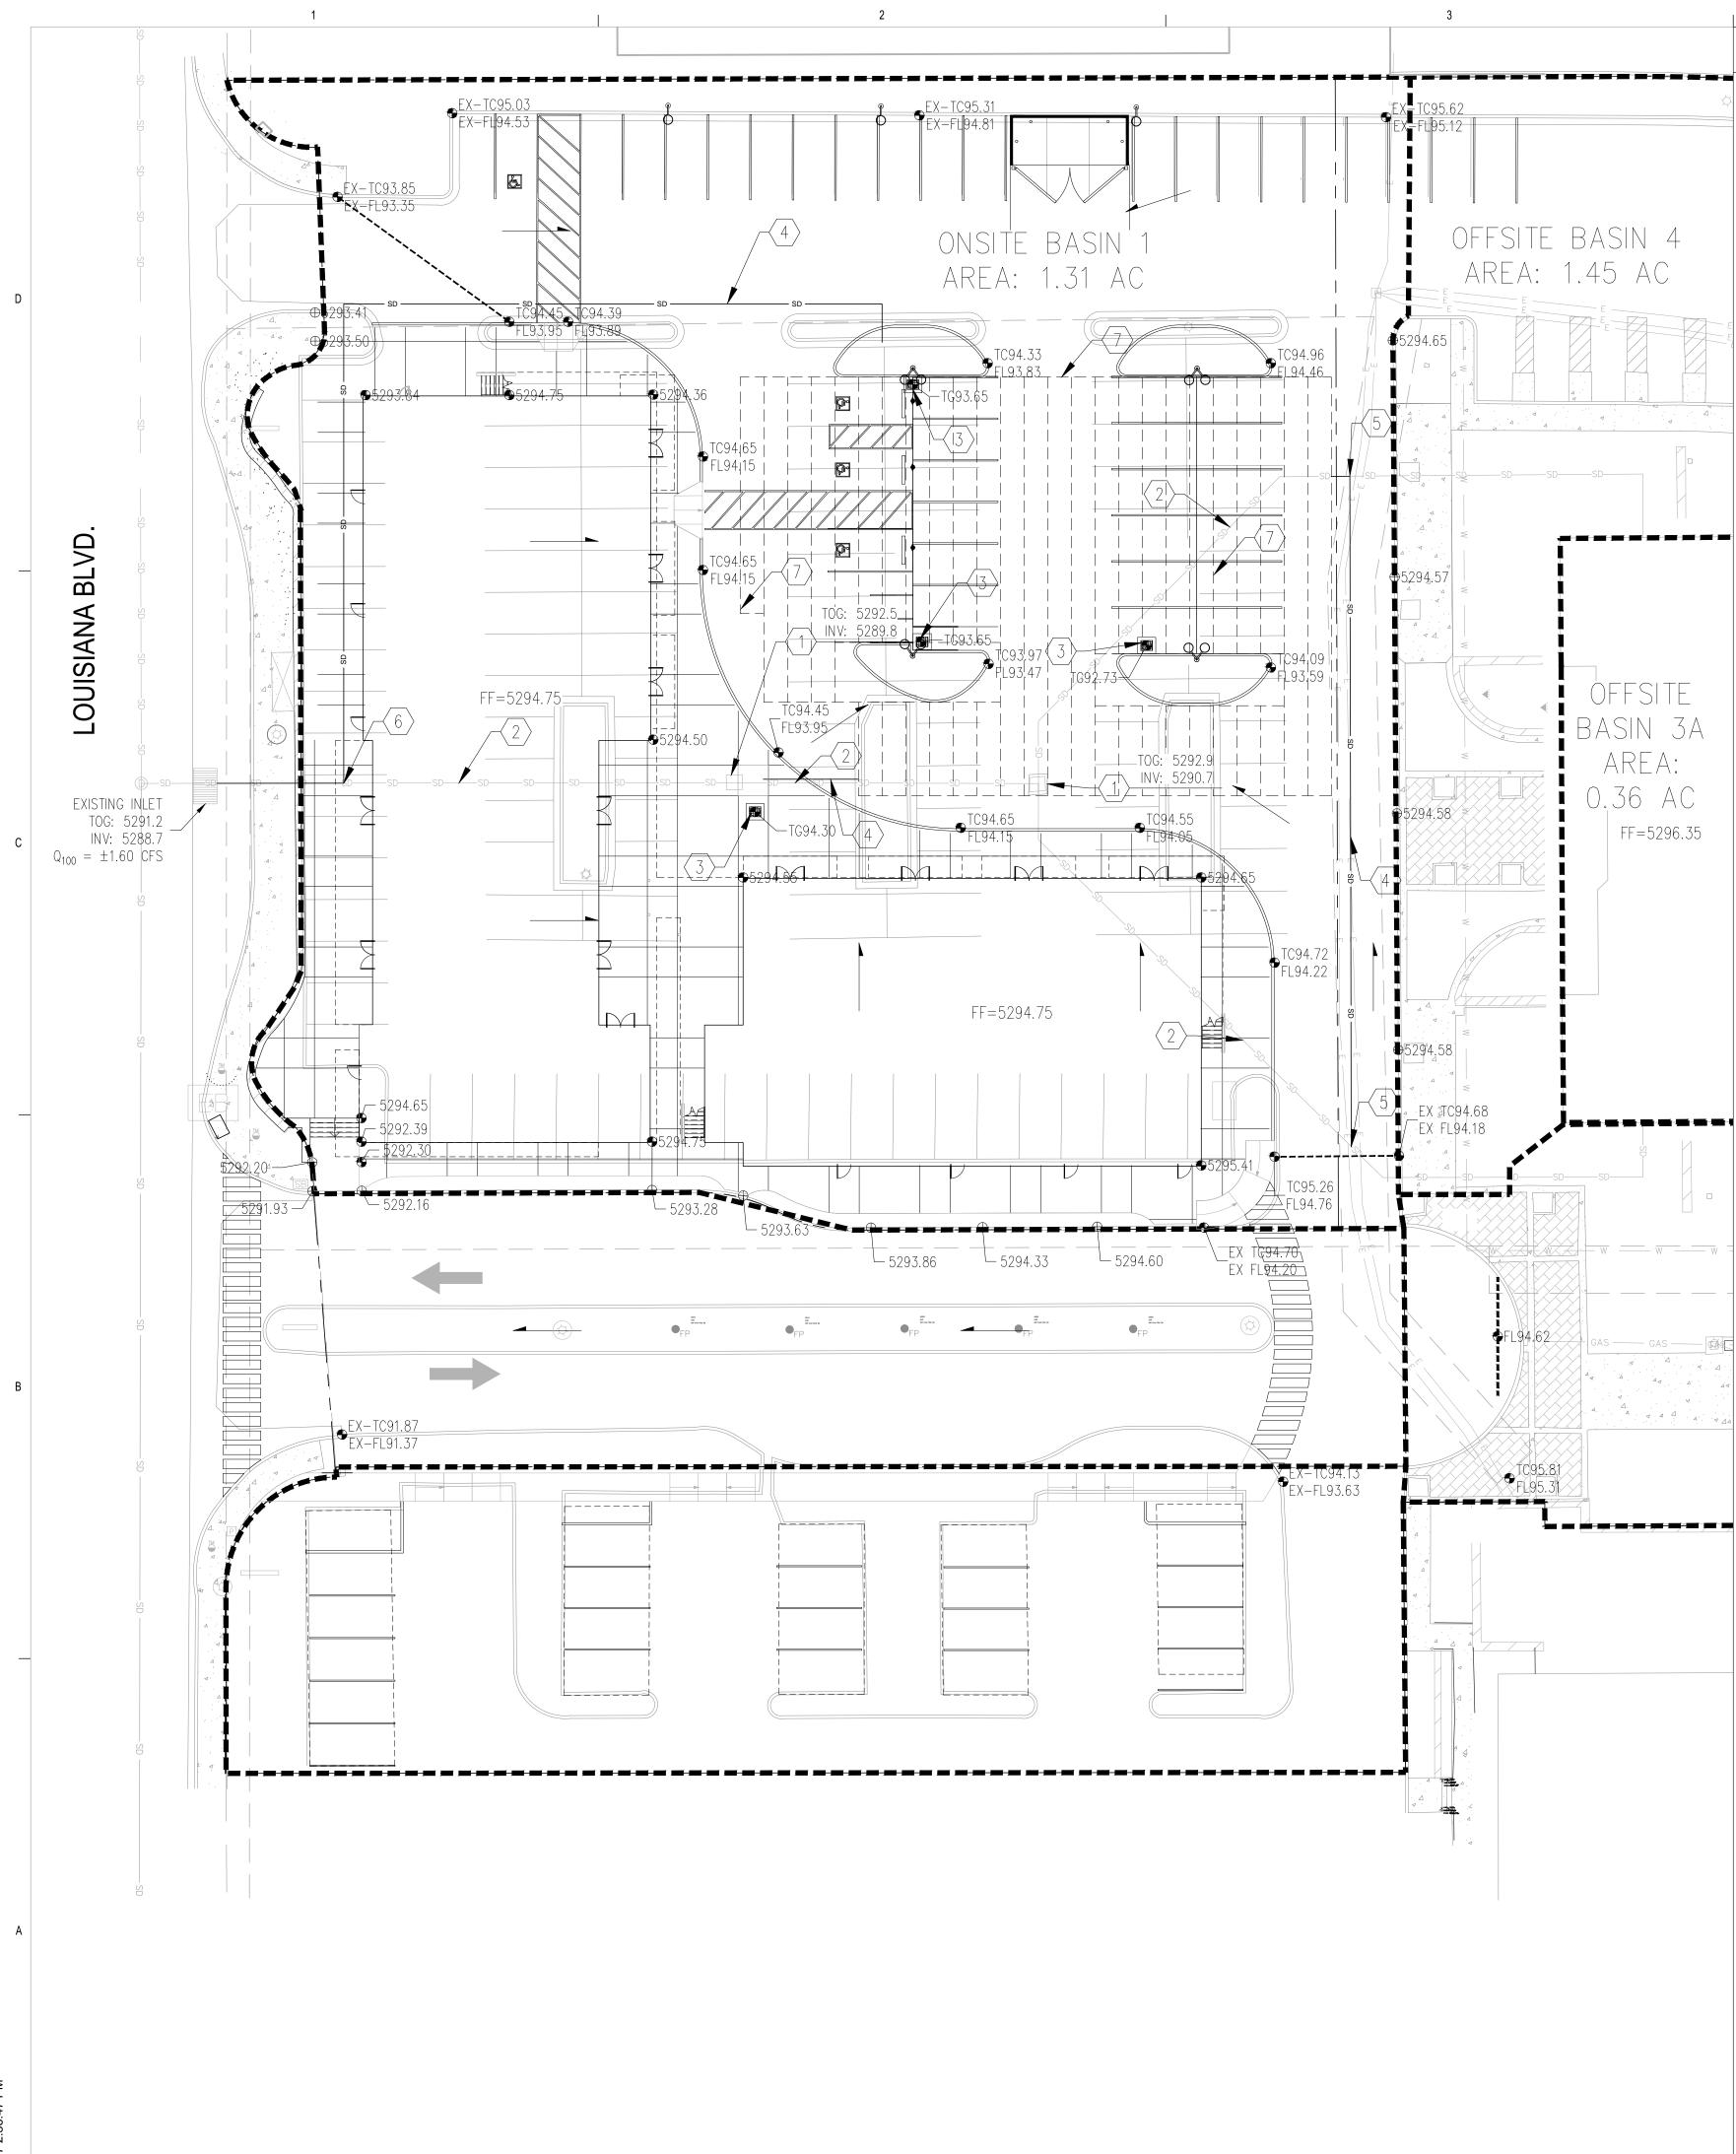

3

1

DRAINAGE NARRATIVE

EXISTING CONDITIONS:

THE SITE IS LOCATED NEAR THE INTERSECTION OF LOUISIANA BLVD AND CUTLER AVE, EAST OF CORONADO MALL. THE SITE IS ADJACENT TO AN EXISTING 7 STORY BUILDING. THE CURRENT CONDITIONS OF THE SITE ARE FAIRLY FLAT.

REVIEW OF THE CITY HYDROLOGY FILES (COA HYDROLOGY FILE #H19-D1) AND THE EXISTING TOPOGRAPHIC SURVEY SHOWS THERE IS AN EXISTING INLET LOCATED WEST OF THE SITE WHICH DISCHARGE INTO THE PUBLIC RIGHT OF WAY. ALL THE DRAINAGE FROM THE SITE APPEARS TO ENTER THE EXISTING 60" STORM DRAIN LOCATED WITHIN LOUISIANA BLVD VIA A DIRECT STORM DRAIN CONNECTION AS WELL AS TO A SERIES OF EXISTING INLETS ONSITE. EXISTING SURFACE PARKING PONDS HELP TO MITIGATE THESE FLOWS AS NECESSARY.

A MORE RECENT GRADING AND DRAINAGE PLAN PREPARED BY LARRY READ AND APPROVED ON JANUARY 11, 2002 FOR PAVING PERMIT AND SITE PLAN FOR BUILDING PERMIT, CONSTRUCTED ADDITIONAL ONSITE PARKING. ACCORDING TO THIS PLAN, THE SITE UTILIZES THE PARKING LOTS AS DETENTION PONDS DURING LARGER STORM EVENTS. THESE PONDS AND OTHER ONSITE DRAINAGE IMPROVEMENTS WERE VERIFIED BY THE TOPOGRAPHIC SURVEY.


PER FEMA MAP PANEL #35001C0352H (SEE ABOVE), THE SITE IS NOT LOCATED WITHIN A KNOWN FLOOD ZONE.

PROPOSED CONDITIONS:

THE DEVELOPED FLOWS FOR THE SITE WILL MAINTAIN THE REDUCED DISCHARGE TO THE SURROUNDING RIGHT OF WAY. THE SITE WILL NOT DEVIATE SIGNIFICANTLY FROM HISTORIC FLOW PATHS. DUE TO THE PROPOSED BUILDINGS AND THE SITE SLOPE CONSTRAINTS, UNDERGROUND PONDING WILL BE REQUIRED TO ASSIST IN THE FIRST FLUSH REQUIREMENTS AS WELL AS HELP TO DETAIN THE PEAK DISCHARGE TO MEET THE ALLOWABLE DISCHARGE RATES .

THE SITE, ALONG LOUISIANA BOULEVARD INCLUDING THE EXISTING LEWIS UNIVERSITY BUILDING, AND ASSOCIATED PARKING TO THE EAST WILL CONTINUE TO DISCHARGE TO THE 60" STORM DRAIN IN LOUISIANA BASED ON THE HISTORIC OFFSITE BASINS. UNDERGROUND PONDING WILL BE REQUIRED TO MAINTAIN THE ALLOWABLE DISCHARGE (±1.6CFS) AND TO RETAIN THE FIRST FLUSH VOLUME.

GIVEN THE ABOVE INFORMATION, THE SITE WILL MAINTAIN HISTORICAL FLOWPATHS AND FLOWS VIA ONSITE STORM DRAIN SYSTEMS AND UNDERGROUND PONDING. WITH THIS SUBMITTAL, WE ARE SEEKING SITE PLAN FOR SUBDIVISION APPROVAL.

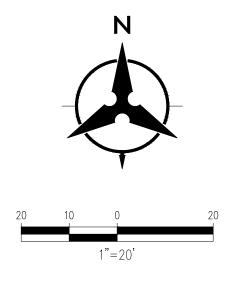


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ARCHITECTURE / DESIGN / INSPIRATION

DEKKER

PERICH

SABATINI

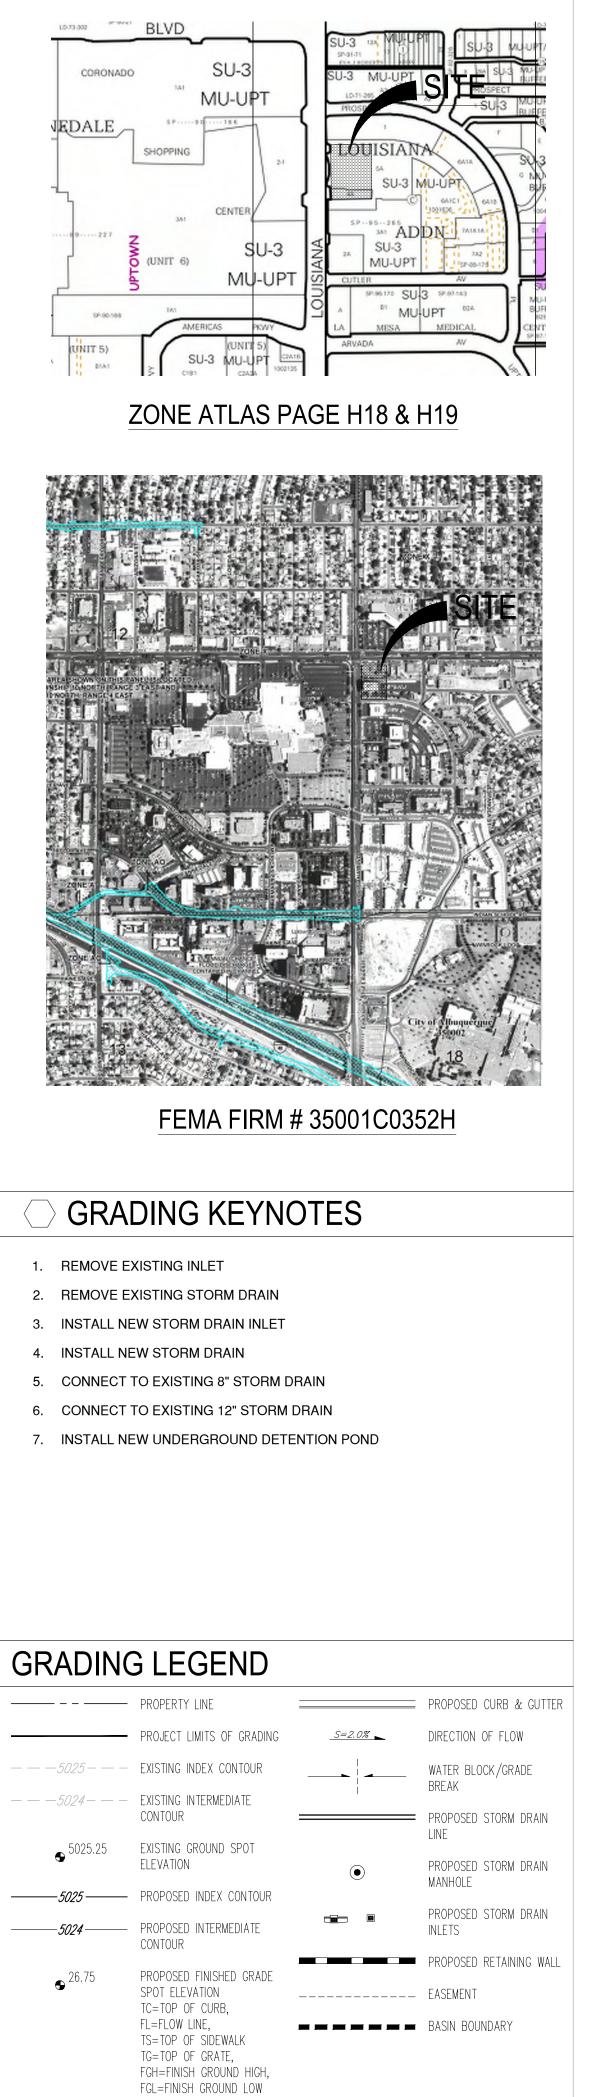

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PROJECT

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URT REVIEW / SITE PLAN FOR **BUILDING PERMIT**

REVISIONS \triangle \triangle \bigtriangleup DRAWN BY REVIEWED BY 03.08.2017 DATE PROJECT NO: 14-0087


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DRAWING NAME

CONCEPTUAL **GRADING PLAN**

SHEET NO 08 OF 16



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○ UTILITY KEYNOTES

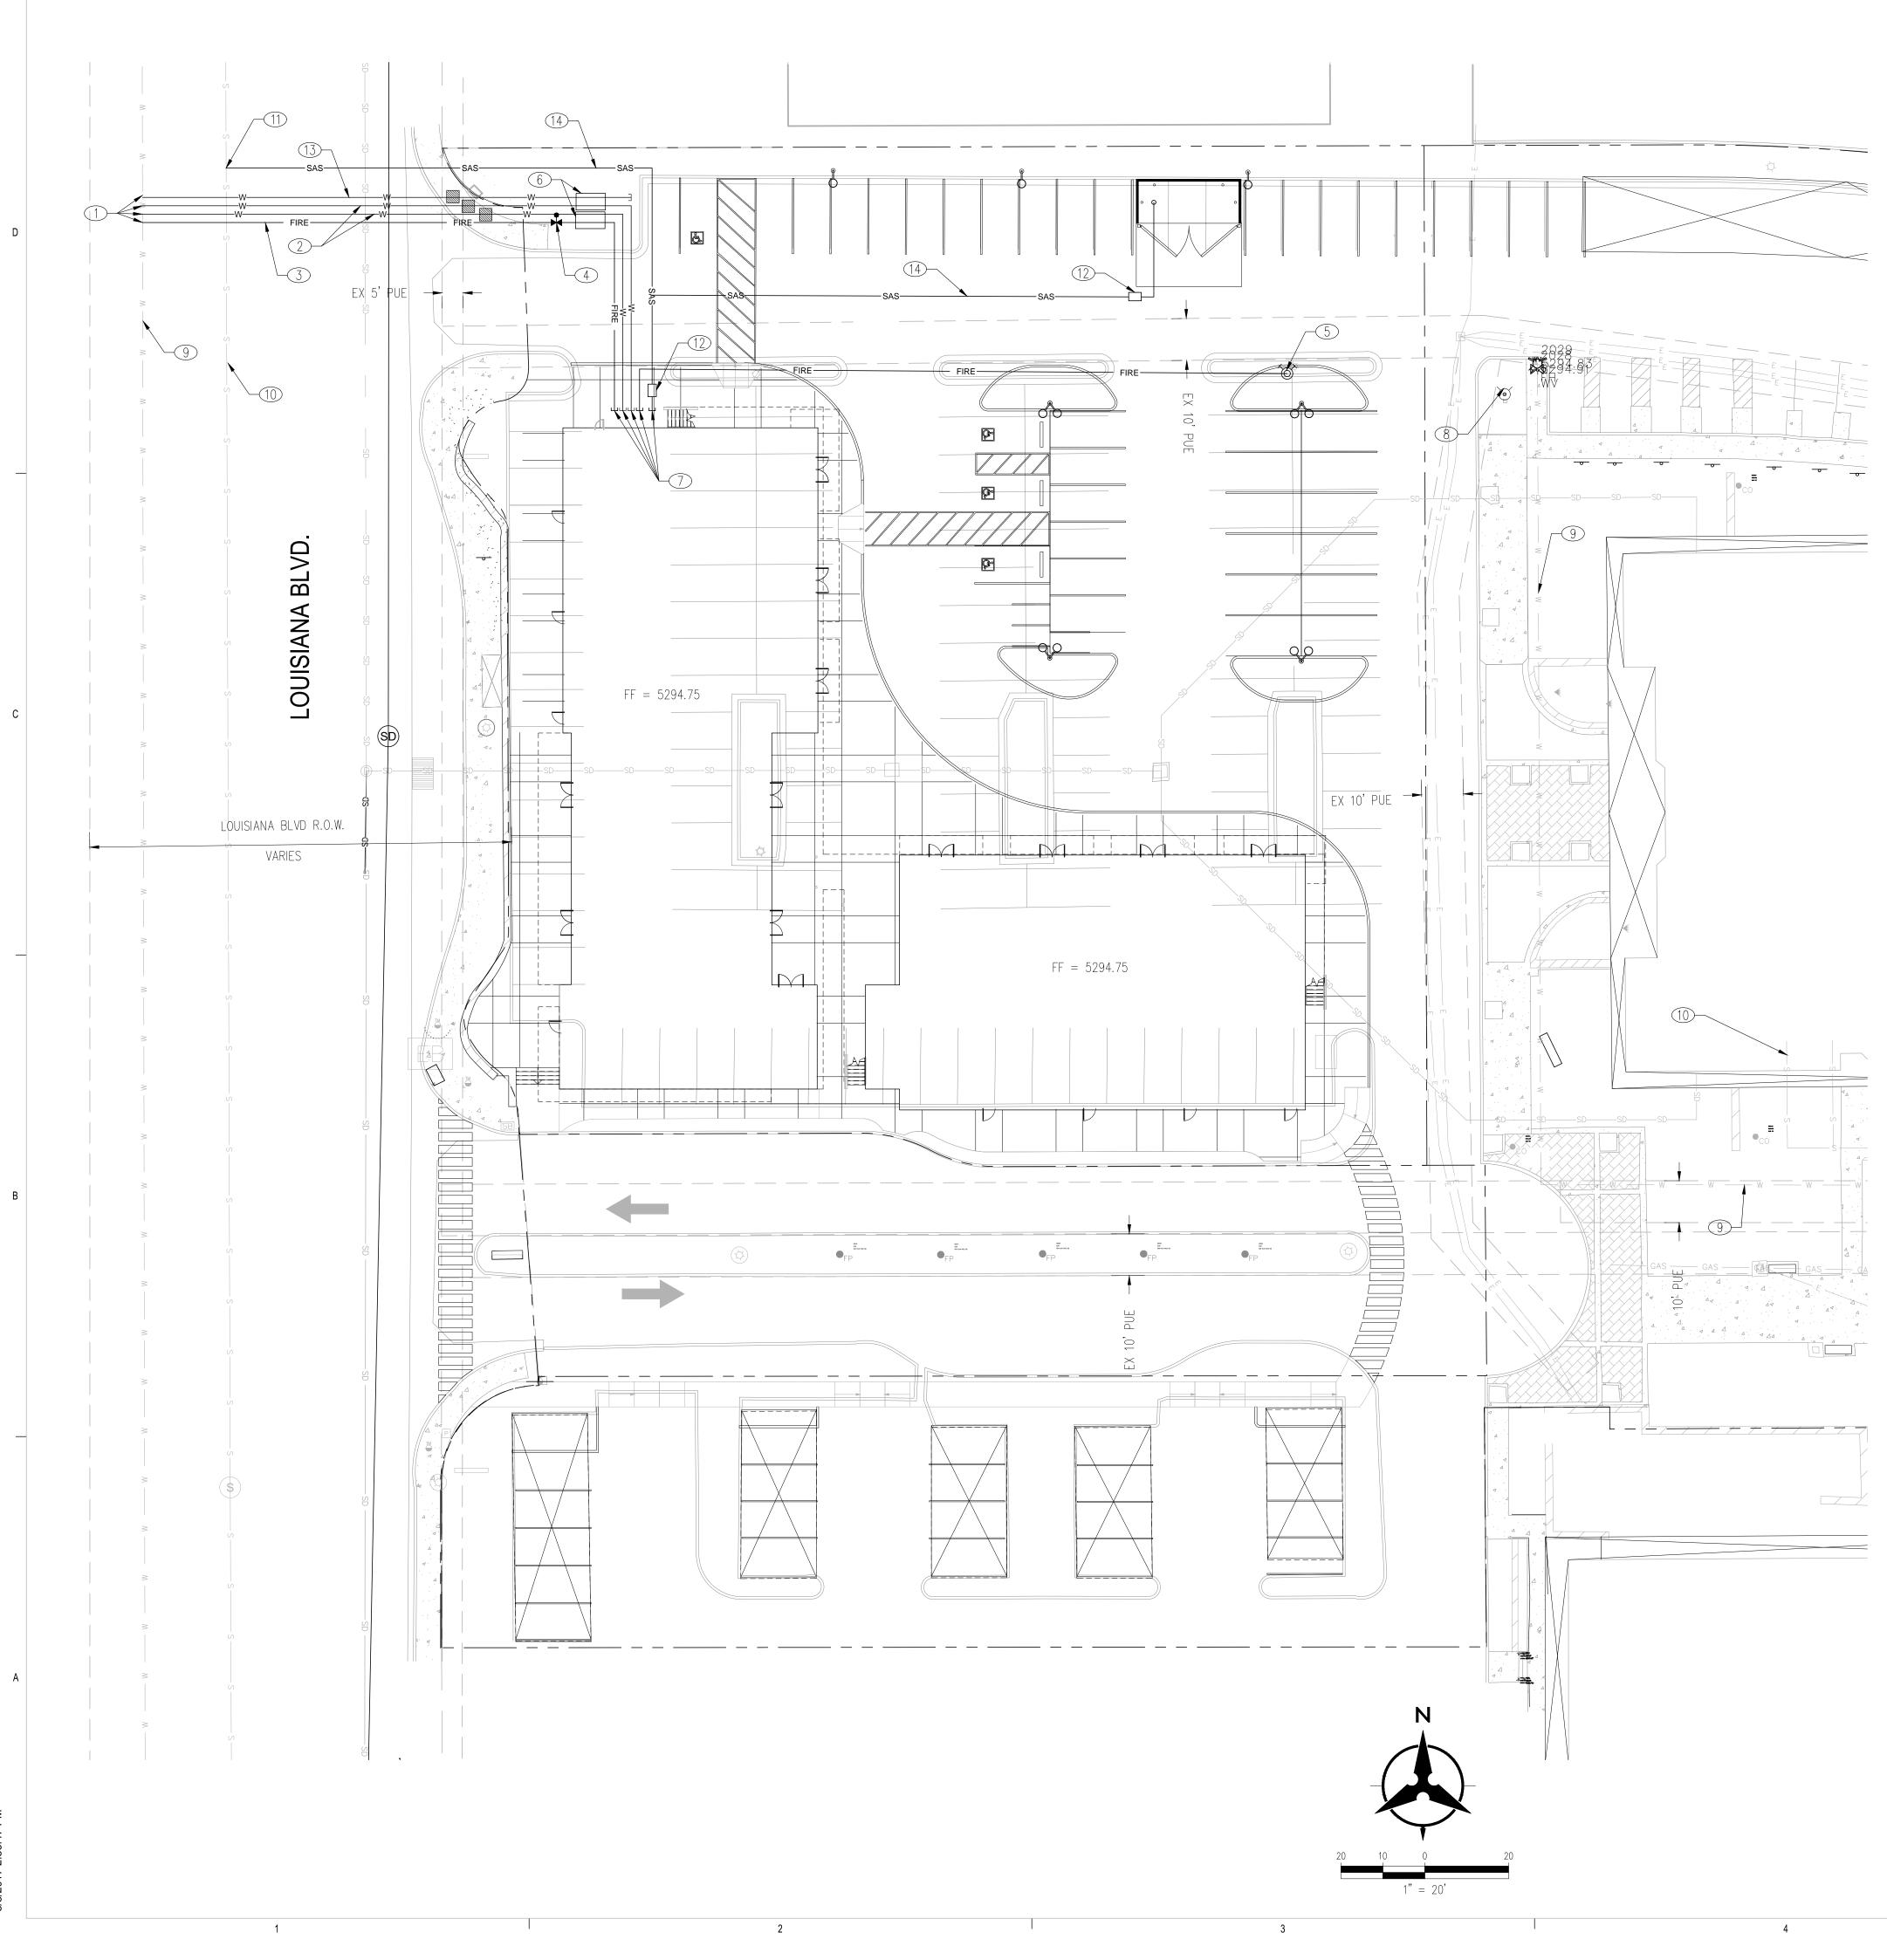- 1. CONNECT TO EXISTING WATER LINE
- 2. INSTALL NEW 2" DOMESTIC SERVICE WATER LINE
- 3. INSTALL NEW FIRE PROTECTION LINE
- 4. INSTALL NEW POST INDICATOR VALVE
- 5. INSTALL NEW FDC

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- 6. INSTALL NEW HEATED ENCLOSURE FOR DOMESTIC REDUCED BACKFLOW PREVENTION
- 7. STUB TO WITHIN 5' OF BUILDING
- 8. EXISTING FIRE HYDRANT
- 9. EXISTING WATER LINE
- 10. EXISTING SANITARY SEWER LINE
- 11. CONNECT TO EXISTING SANITARY SEWER LINE
- 12. INSTALL NEW GREASE TRAP
- 13. INSTALL NEW $\frac{3}{4}$ " LANDSCAPE WATER LINE
- 14. INSTALL NEW SANITARY SEWER LINE



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SEAL CONSCIONED



2440 LOUISIANA 2440 Louisiana Blvd. NE ALBUQUERQUE, NM 871

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URT REVIEW / SITE PLAN FOR BUILDING PERMIT

REVISIONS	
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DRAWN BY	EGN
REVIEWED BY	MJB
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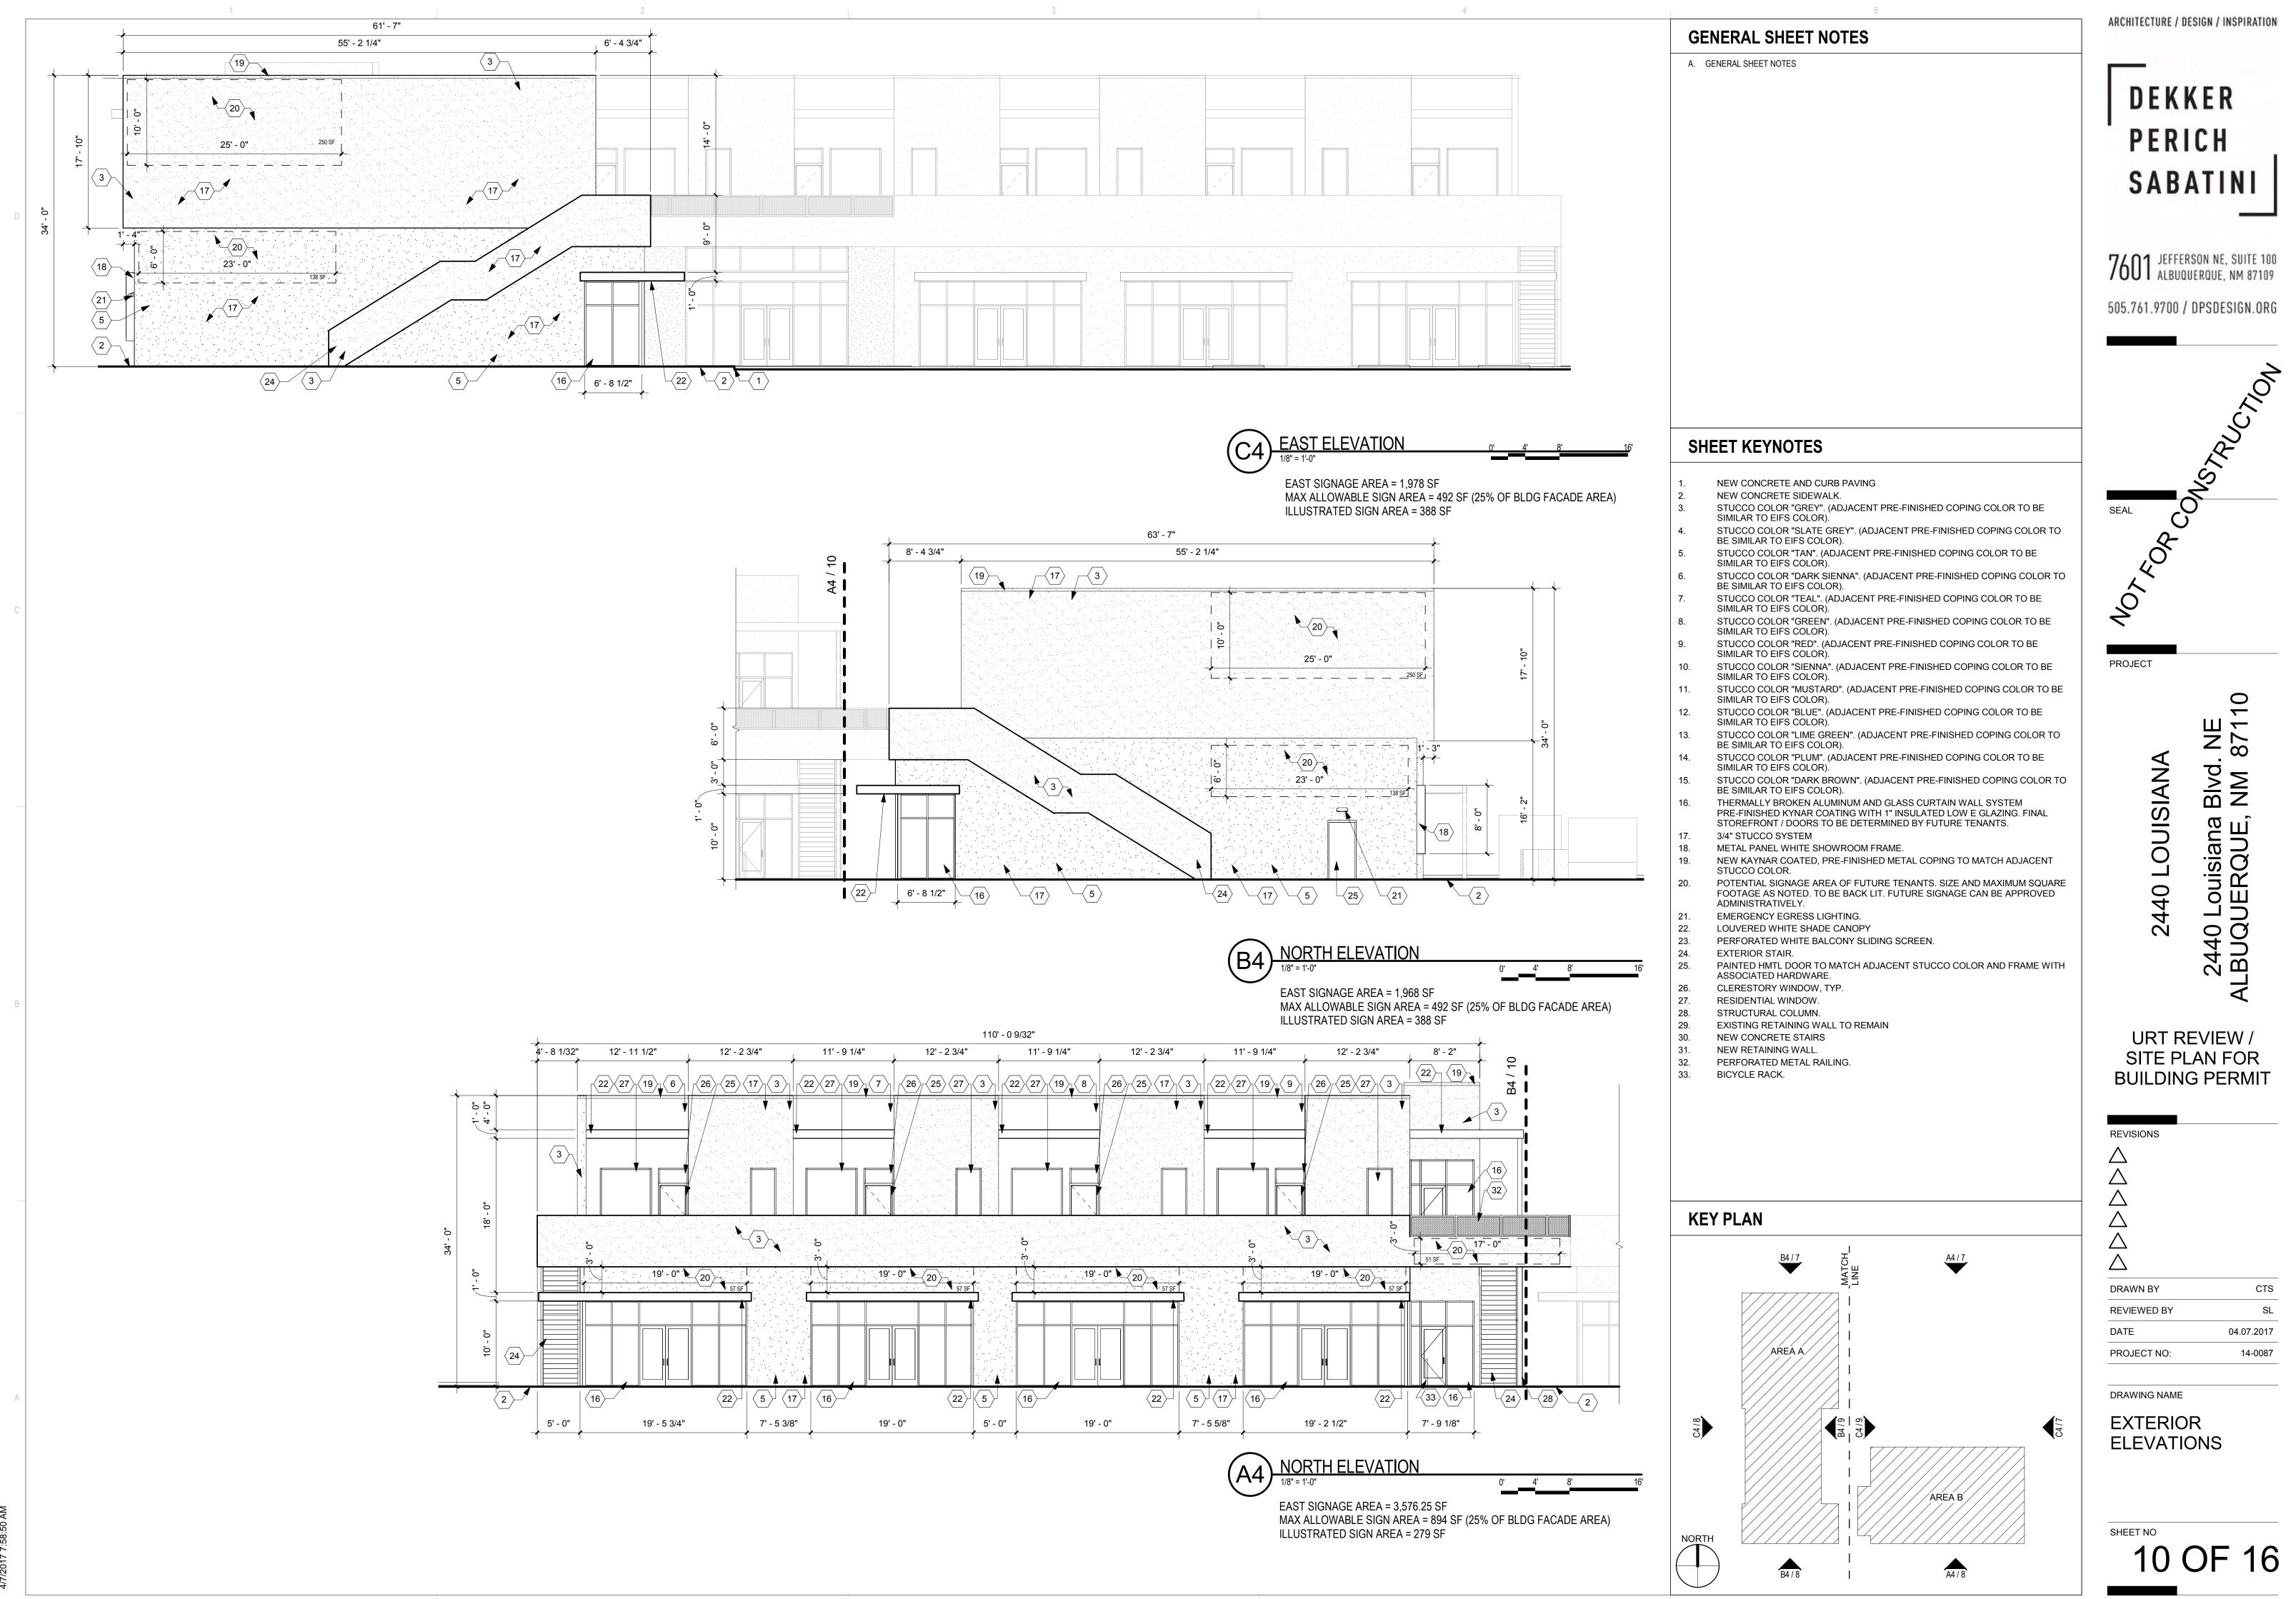
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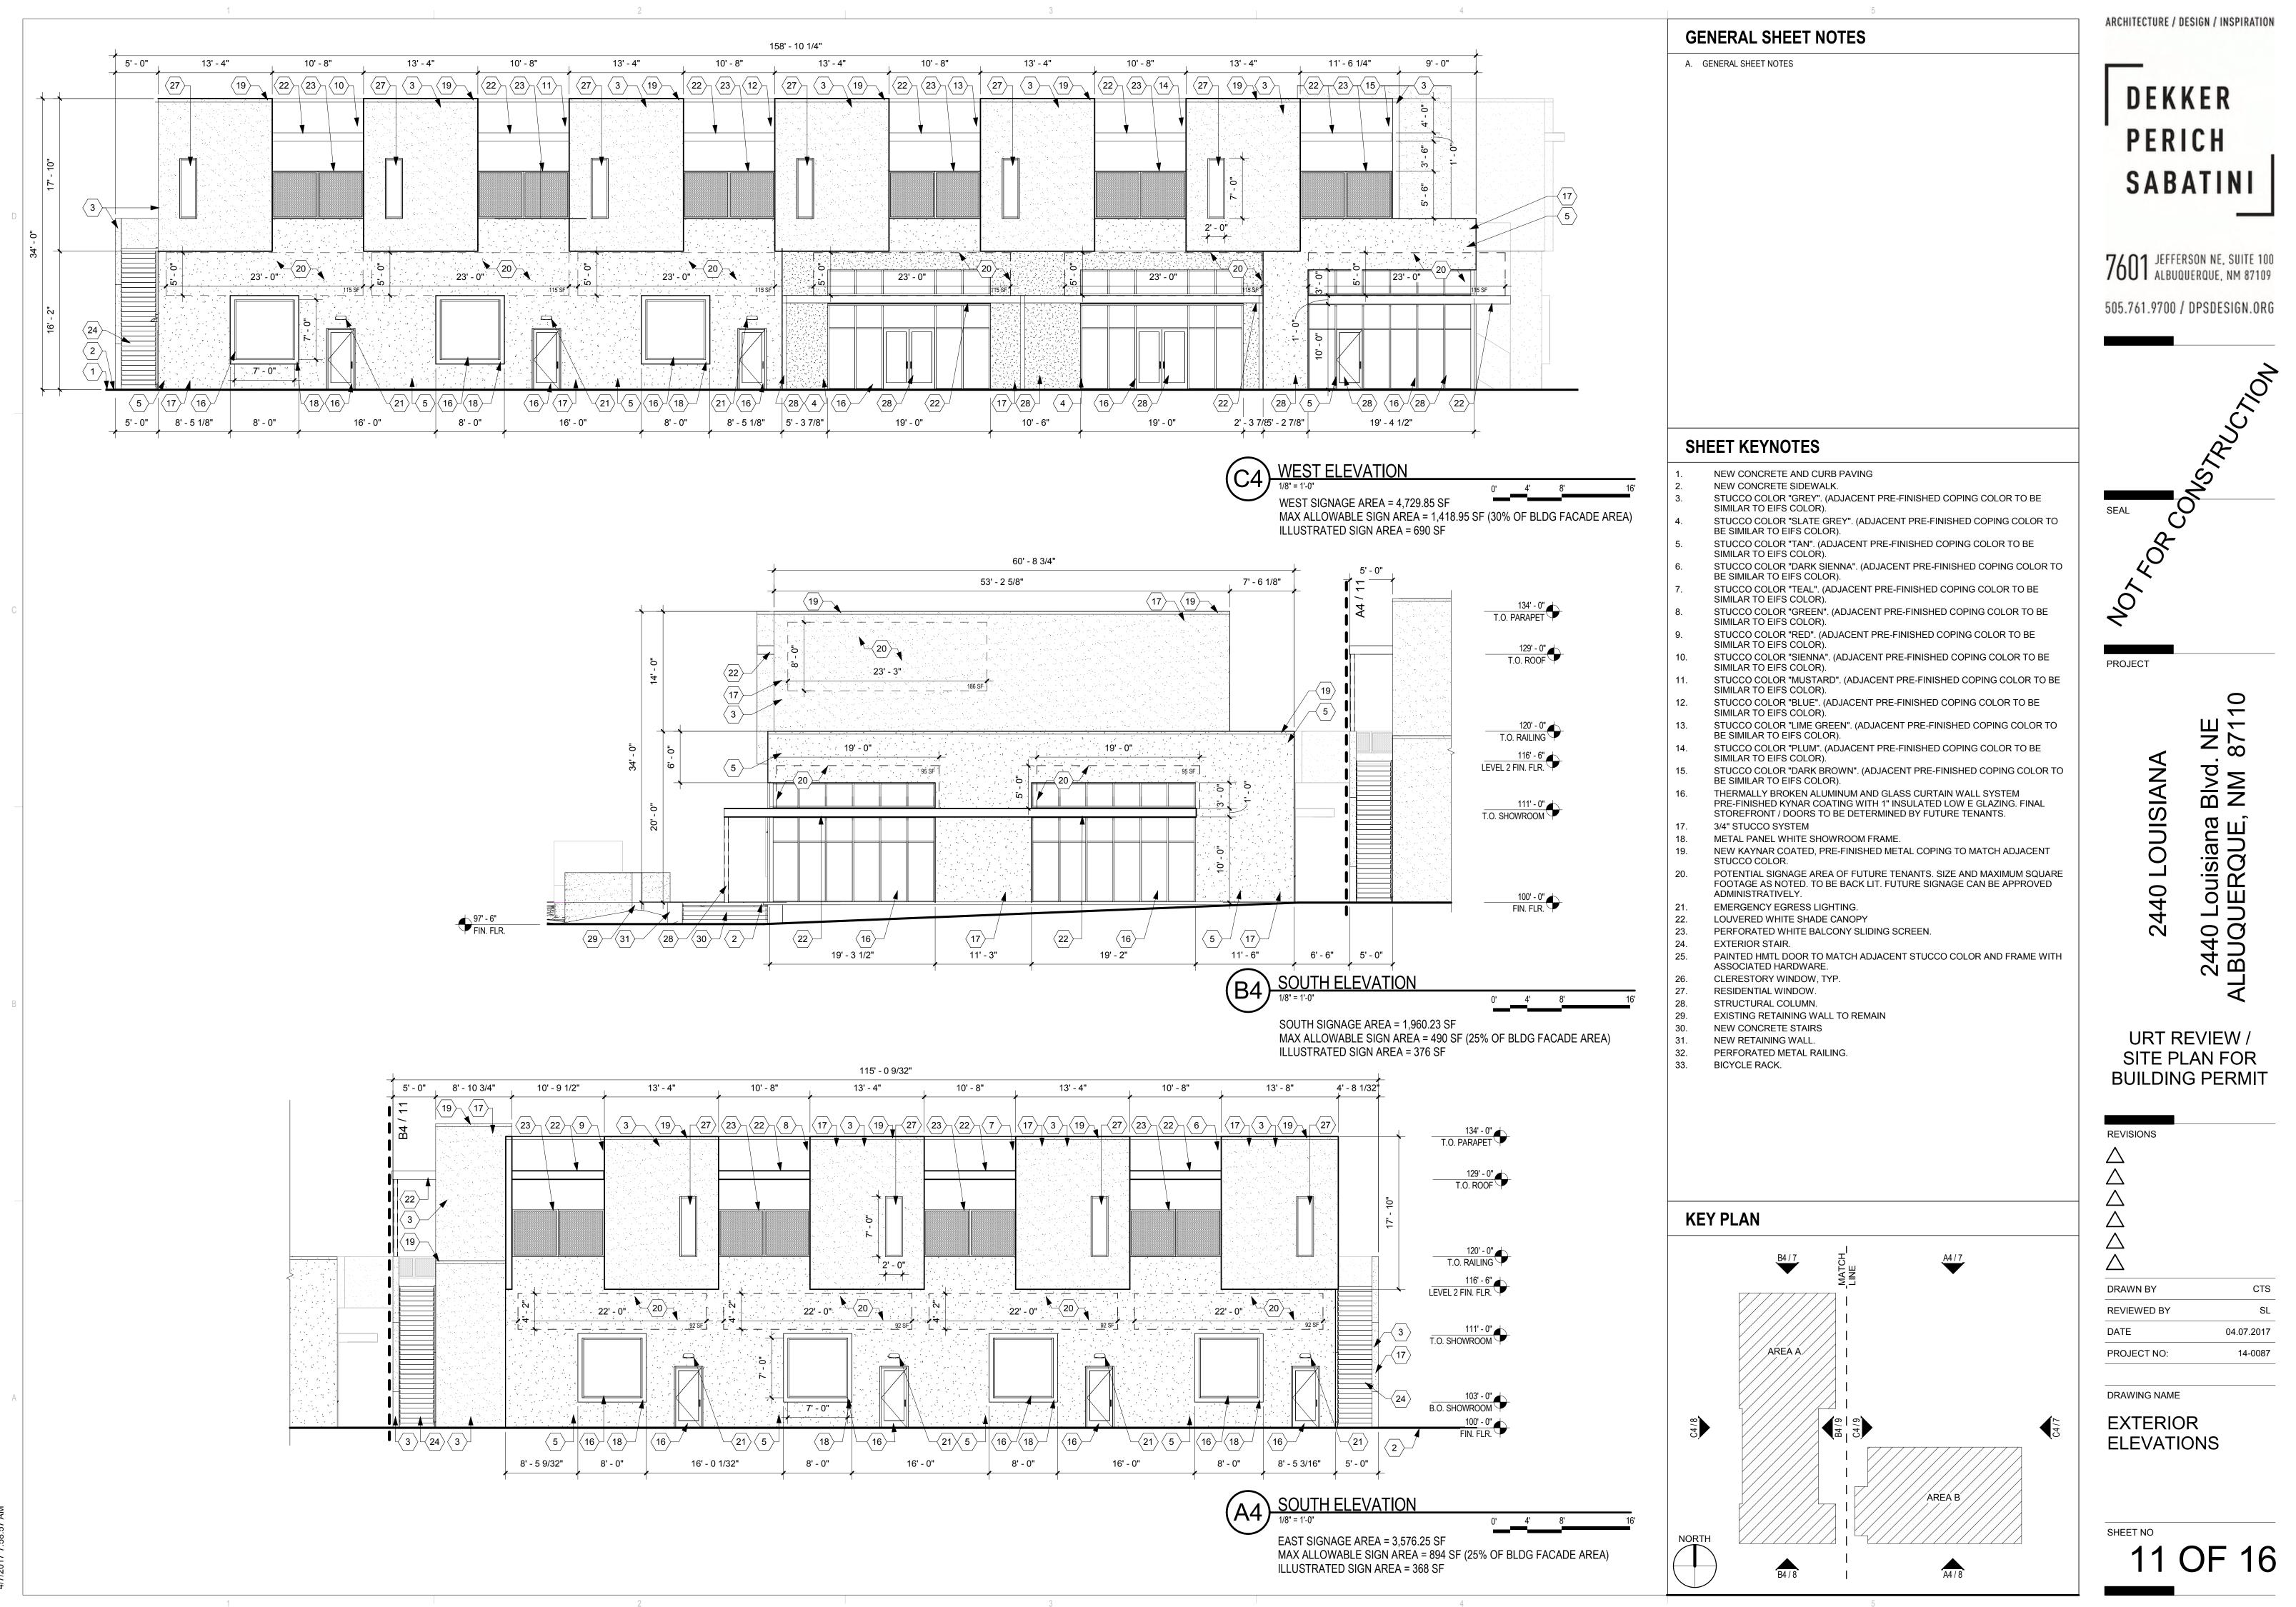





UTILITY LEGEND


	- PROPERTY LINE		- PROPOSED EASEMENT
	EXISTING EASEMENT	SAS	PROPOSED SANITARY SEWER LINE
SAS	EXISTING SANITARY SEWER	•	PROPOSED SANITARY
WL	EXISTING WATER LINE		SEWER MANHOLE
	EXISTING WATER METER	٠	PROPOSED CLEANOUT
		WL	– PROPOSED WATER LINE
	EXISTING CAP	м	PROPOSED VALVE
	EXISTING VALVE		
õ	EXISTING FIRE HYDRANT	FL	PROPOSED FIRE WATER LINE
0	EXISTING SANITARY	Ŭ	PROPOSED HYDRANT
	SEWER MANHOLE		PROPOSED CAP
\odot	EXISTING STORM DRAIN MANHOLE		PROPOSED WATER METER
	EXISTING INLET	*	PROPOSED PIV
		6	REMOTE FIRE DEPARTMENT CONNECTION





10017 7.58.57 AM

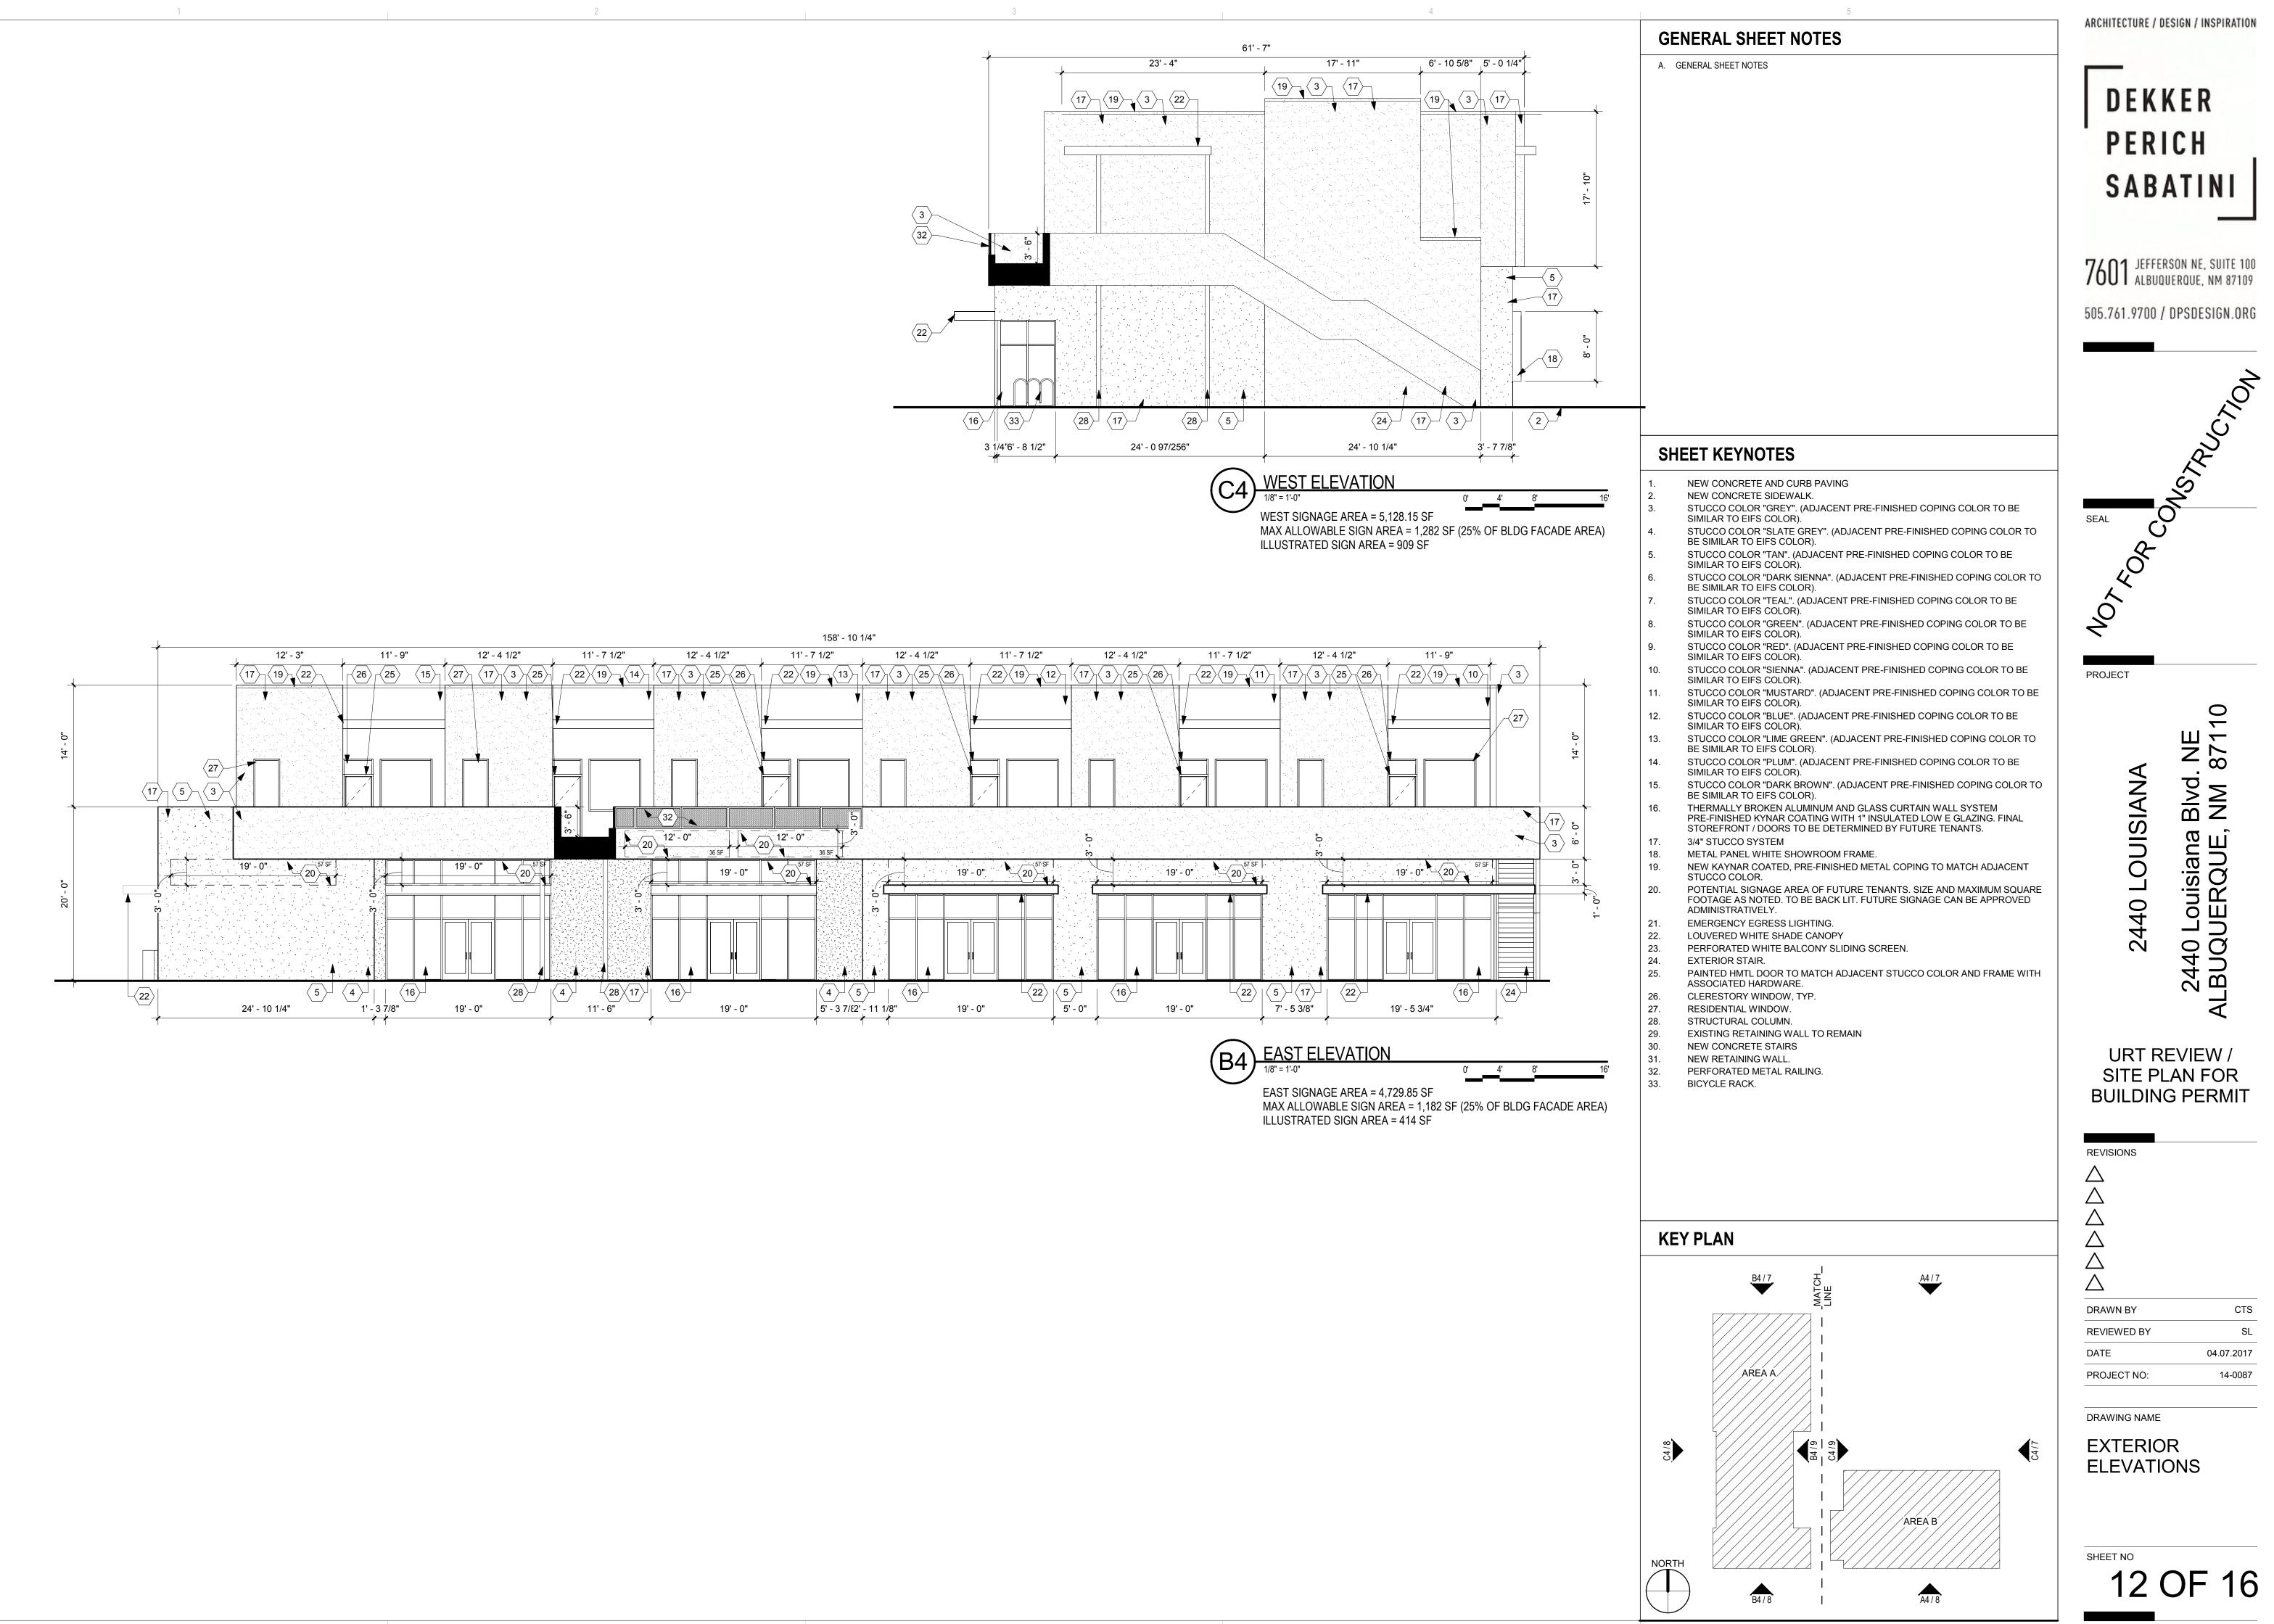

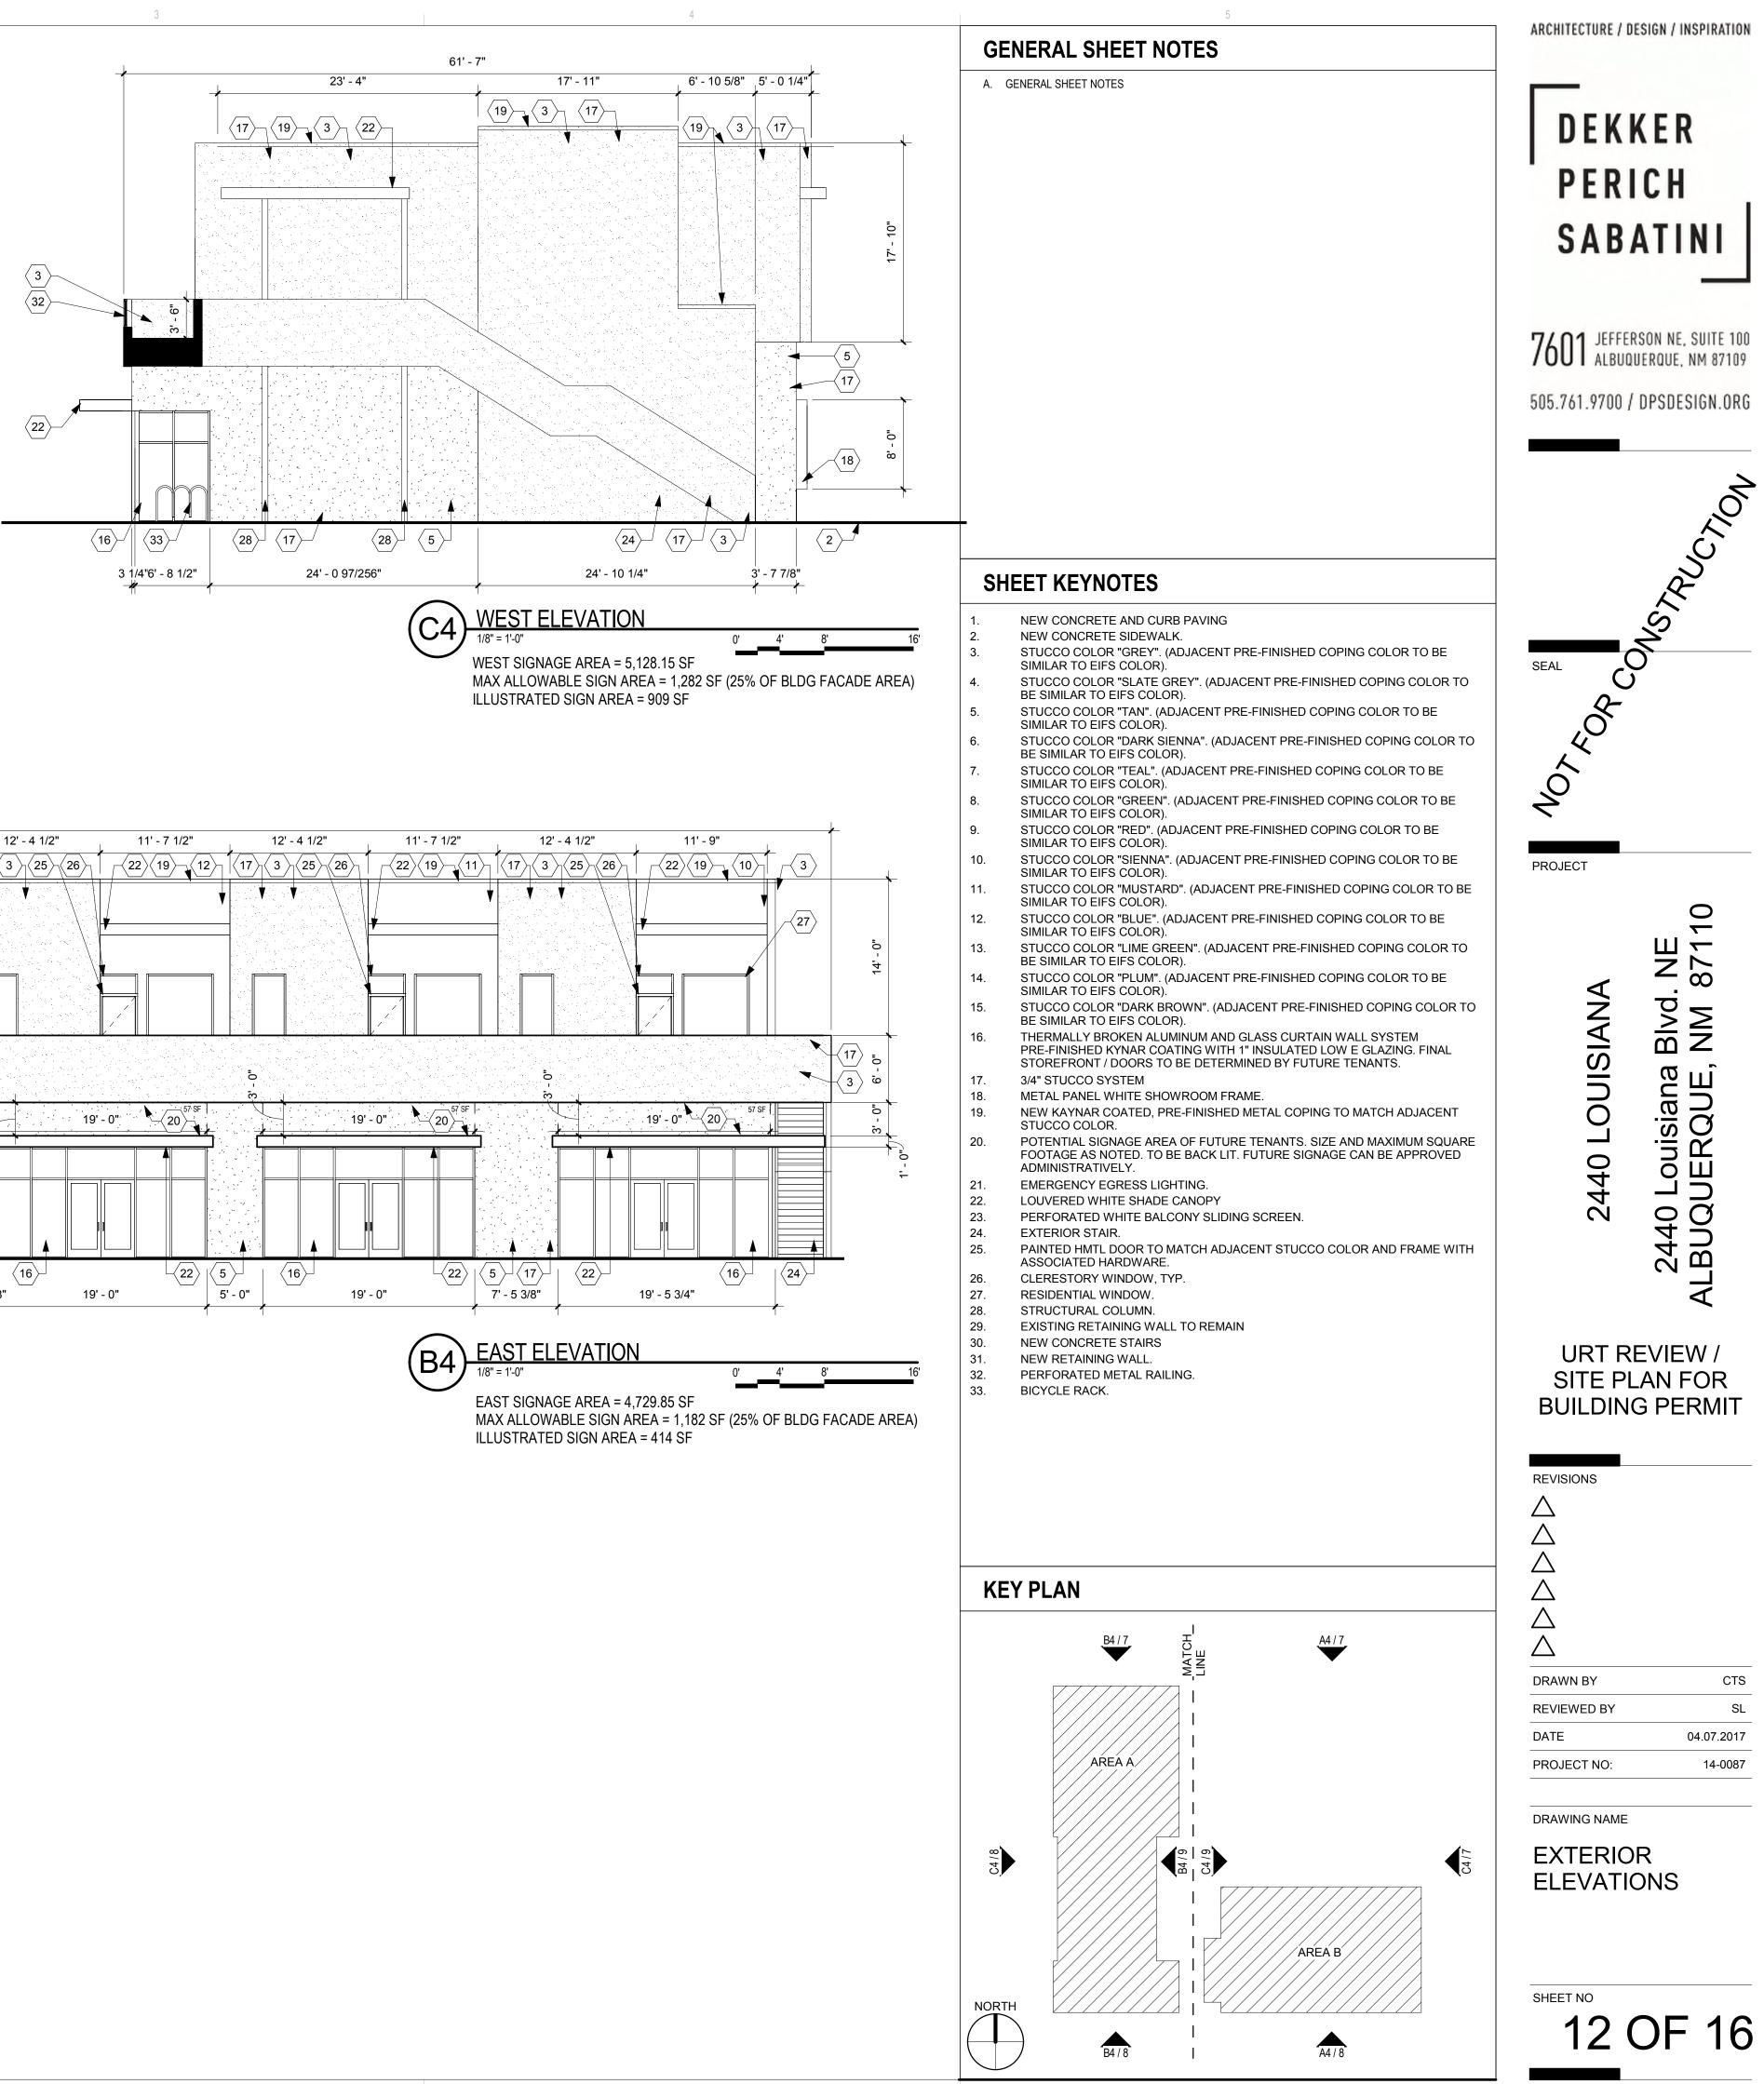



	(B3) EAST ELEV	/ATION		0' 8'
• • • • •				
******			an a	, ¹



AERIAL VIEW, LOOKING NORTHEAST



2

PERSPECTIVE VIEW, LOOKING SOUTHWEST



AERIAL VIEW, LOOKING SOUTHWEST



4


PERSPECTIVE VIEW, LOOKING SOUTHEAST

3

ARCHITECTURE / DESIGN / INSPIRATION


DEKKER PERICH SABATINI

7601 JEFFERSON NE, SUITE 100 ALBUQUERQUE, NM 87109 505.761.9700 / DPSDESIGN.ORG

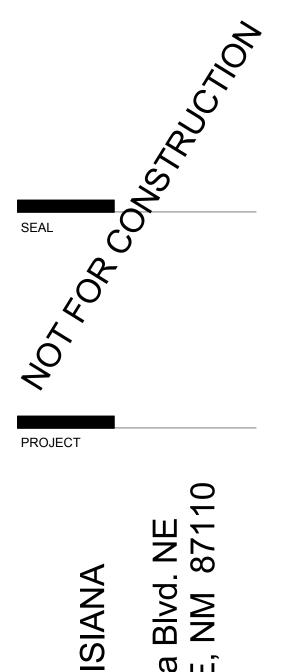



URT REVIEW / SITE PLAN FOR BUILDING PERMIT

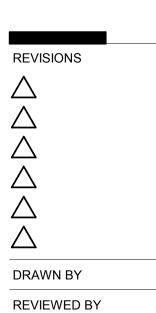

DATE

PROJECT NO:

DRAWING NAME

SHEET NO

5

RENDERINGS

14 OF 16

CTS SL 04.07.2017 14-0087

FIRE CHIEF David Downey 11500 Sunset Gardens Rd SW Albuquerque, NM 87121

THE ALBUQUERQUE FIRE DEPARTMENT FIRE MARSHAL'S OFFICE

FIRE MARSHAL Jason Garcia 724 Silver SW Albuquerque, NM 87102

FIRE DEPARTMENT HYDRANT AND ACCESS PERMIT REVIEW CHECKLIST

Projec	t Name		Address and/or Legal Description PRT Number	Case Number
			2440 LOWISIANA	1260-17
SHEP.	LAN OF	EØKIIS		
Pass Pass	rainain Fail	N/A	RECUREMENT	
	0		Sprinkler Systems installed at the Project shall be indicated on the Plans	CODEREFERENCE
jer-	: 0	0		IFC 901.2
.œ			Construction Type: 116 Square Footage: 14936 Fire Flow: 2500/2	IFC Appendix B
0B			Number of Hydrants Required and Spacing Number of Hydrants: 1150	
v	• .		Average Spacing Between Hydrants: Maximum Distance from any Point on Road:	IFC Appendix C
.₫ <			Apparatus Access shall extend to within 150 feet of all portions of the first floor of the facility.	IFC 503.1.1
gr .			Fire Apparatus Road Dimensions shall have an unobstructed width not less than 20 feet and an	IFC 503.2.1
			unobstructed height not less than 13 feet 6 inches. Fire apparatus access roads shall have an	100 000.211
			unobstructed width not less than 26 feet in width when fire department access road exceeds 300 feet.	
	0	D -,	Dead End Apparatus access roads which exceed 150 feet require an approved turn around area	IFC 503.2.5
ü			Security Gates across fire apparatus access roads shall have an approved means of operation.	IFC 503.6
1		ū	Fire Lanes Roads 20 feet to 26 feet a fire lane shall be marked fire lane on both sides. Roads 26 feet to	IFC D103.6.1 and
	_		32 feet wide shall be marked fire lane on one side.	IFC D103.6.2
-E1	q	Ċ	Sprinkler Fire Department Connection (FDC) shall be located within 100 feet of a hydrant.	CITY ORD 912.2.1
oran kananan Anananan Anananan Anananan Ananan Anana Anana An	<u>ت</u>		Sprinkler FDC The FDC shall be unobstructed from any object for a minimum distance of 3 feet.	IFC 912
- <u>C</u>		--	Standpipe FDC The FDC shall be located within 100 feet of a hydrant.	NFPA 14.6.4.5.4
Ø	0	0	Premise ID Buildings shall have approved address numbers or building identification placed in a position	IFC 505
o		-	plainly legible and visible from the street or the road fronting the property.	
al.		D	A Knox Box is required if access to the building is necessary for life safety or firefighting purposes	IFC 506
	a	0	Access and Loading, approved fire apparatus access roads shall have an approved driving surface	APP D Sec D102.
<i>a.</i>			capable of supporting the imposed load of fire apparatus weighing at least 75,000 pounds	
-13 -13	<u>í</u>		Access road width with a Hydrant. Where a fire hydrant is located on a fire apparatus access road, the	APP D Sec D103.
	۰.		minimum road width shall be 26 feet, exclusive of shoulders.	
<u>م</u>			Grade. Fire apparatus access roads shall not exceed 10 percent in grade.	APP D Sec D103.
19. 19.			Turning Radius. The minimum turning radius shall be 28 feet as determined by the fire code official.	APP D Sec D103.
	0		Buildings Exceeding Three Stories or 30 feet in Height. Buildings or facilities exceeding 30 feet or three	APP D Sec D104.
			stories in height shall have at least two means of fire apparatus access for each structure.	
	0		Buildings exceeding 62,000 gross square feet shall be provided with two separate and approved fire	APP D Sec D104.
			apparatus access roads. Exception: Projects having a gross building area of up to 124,000 square feet	
	· ·	· · ·	that have a single approved fire apparatus access road when all buildings are equipped throughout with	
	ĺ		approved automatic sprinkler systems.	
0	0	Cl	Remoteness. Where two access roads are required; they shall be placed a distance apart equal to not	APP D Sec D104.
			less than one half of the length of the maximum overall diagonal dimension of the property.	
,p			Aerial Apparatus Road Dimensions Buildings which exceed 30 feet in height require unobstructed	APP D Sec D105.
			aerial apparatus access roads not less than 26 feet in width. Access is required on two sides of the	
		· ·	structure and overhead obstructions are prohibited.	
0	p –	D	Multiple Family Residential Projects having more than 100 dwelling units shall be equipped	D 106.1
			throughout with two separate and approved fire apparatus access roads. Exception: Projects having up	•
			to 200 dwelling units may have a single approved fire apparatus access road when all buildings,	-
	1		including nonresidential occupancies, are equipped throughout with approved automatic sprinkler	
		j	systems installed in accordance with Section 903.3.1.1 or 903.3.1.2.	
₫~	B	-	One- or two-Family Dwelling Residential Developments where units exceed 30 shall be provided with	D 107.1
		 	separate and approved fire apparatus access roads and shall meet the requirements of Section D104.3.	
1 7 1		0	The Post or Wall Indicator Valve (PIV or WIV) shall be located on the Plans as per NFPA 13	IFC 901.2

RECEIVING PARTY SIGNATURE:


DATE


- Proposed PIV 🖂 _ EX MEDIAN CURB & GUTTER UP HIMAN -----BLVD OUISIANA (sp BUILDING 1


EX CURB & GUTTER TO REMAIN (\$

UP

P:\20160384\CDP\Plans\General\20160384F—One01BLDG1.dwg, Layout1 January 31, 2017 — 9:43am Plotted by: ENEWMAN

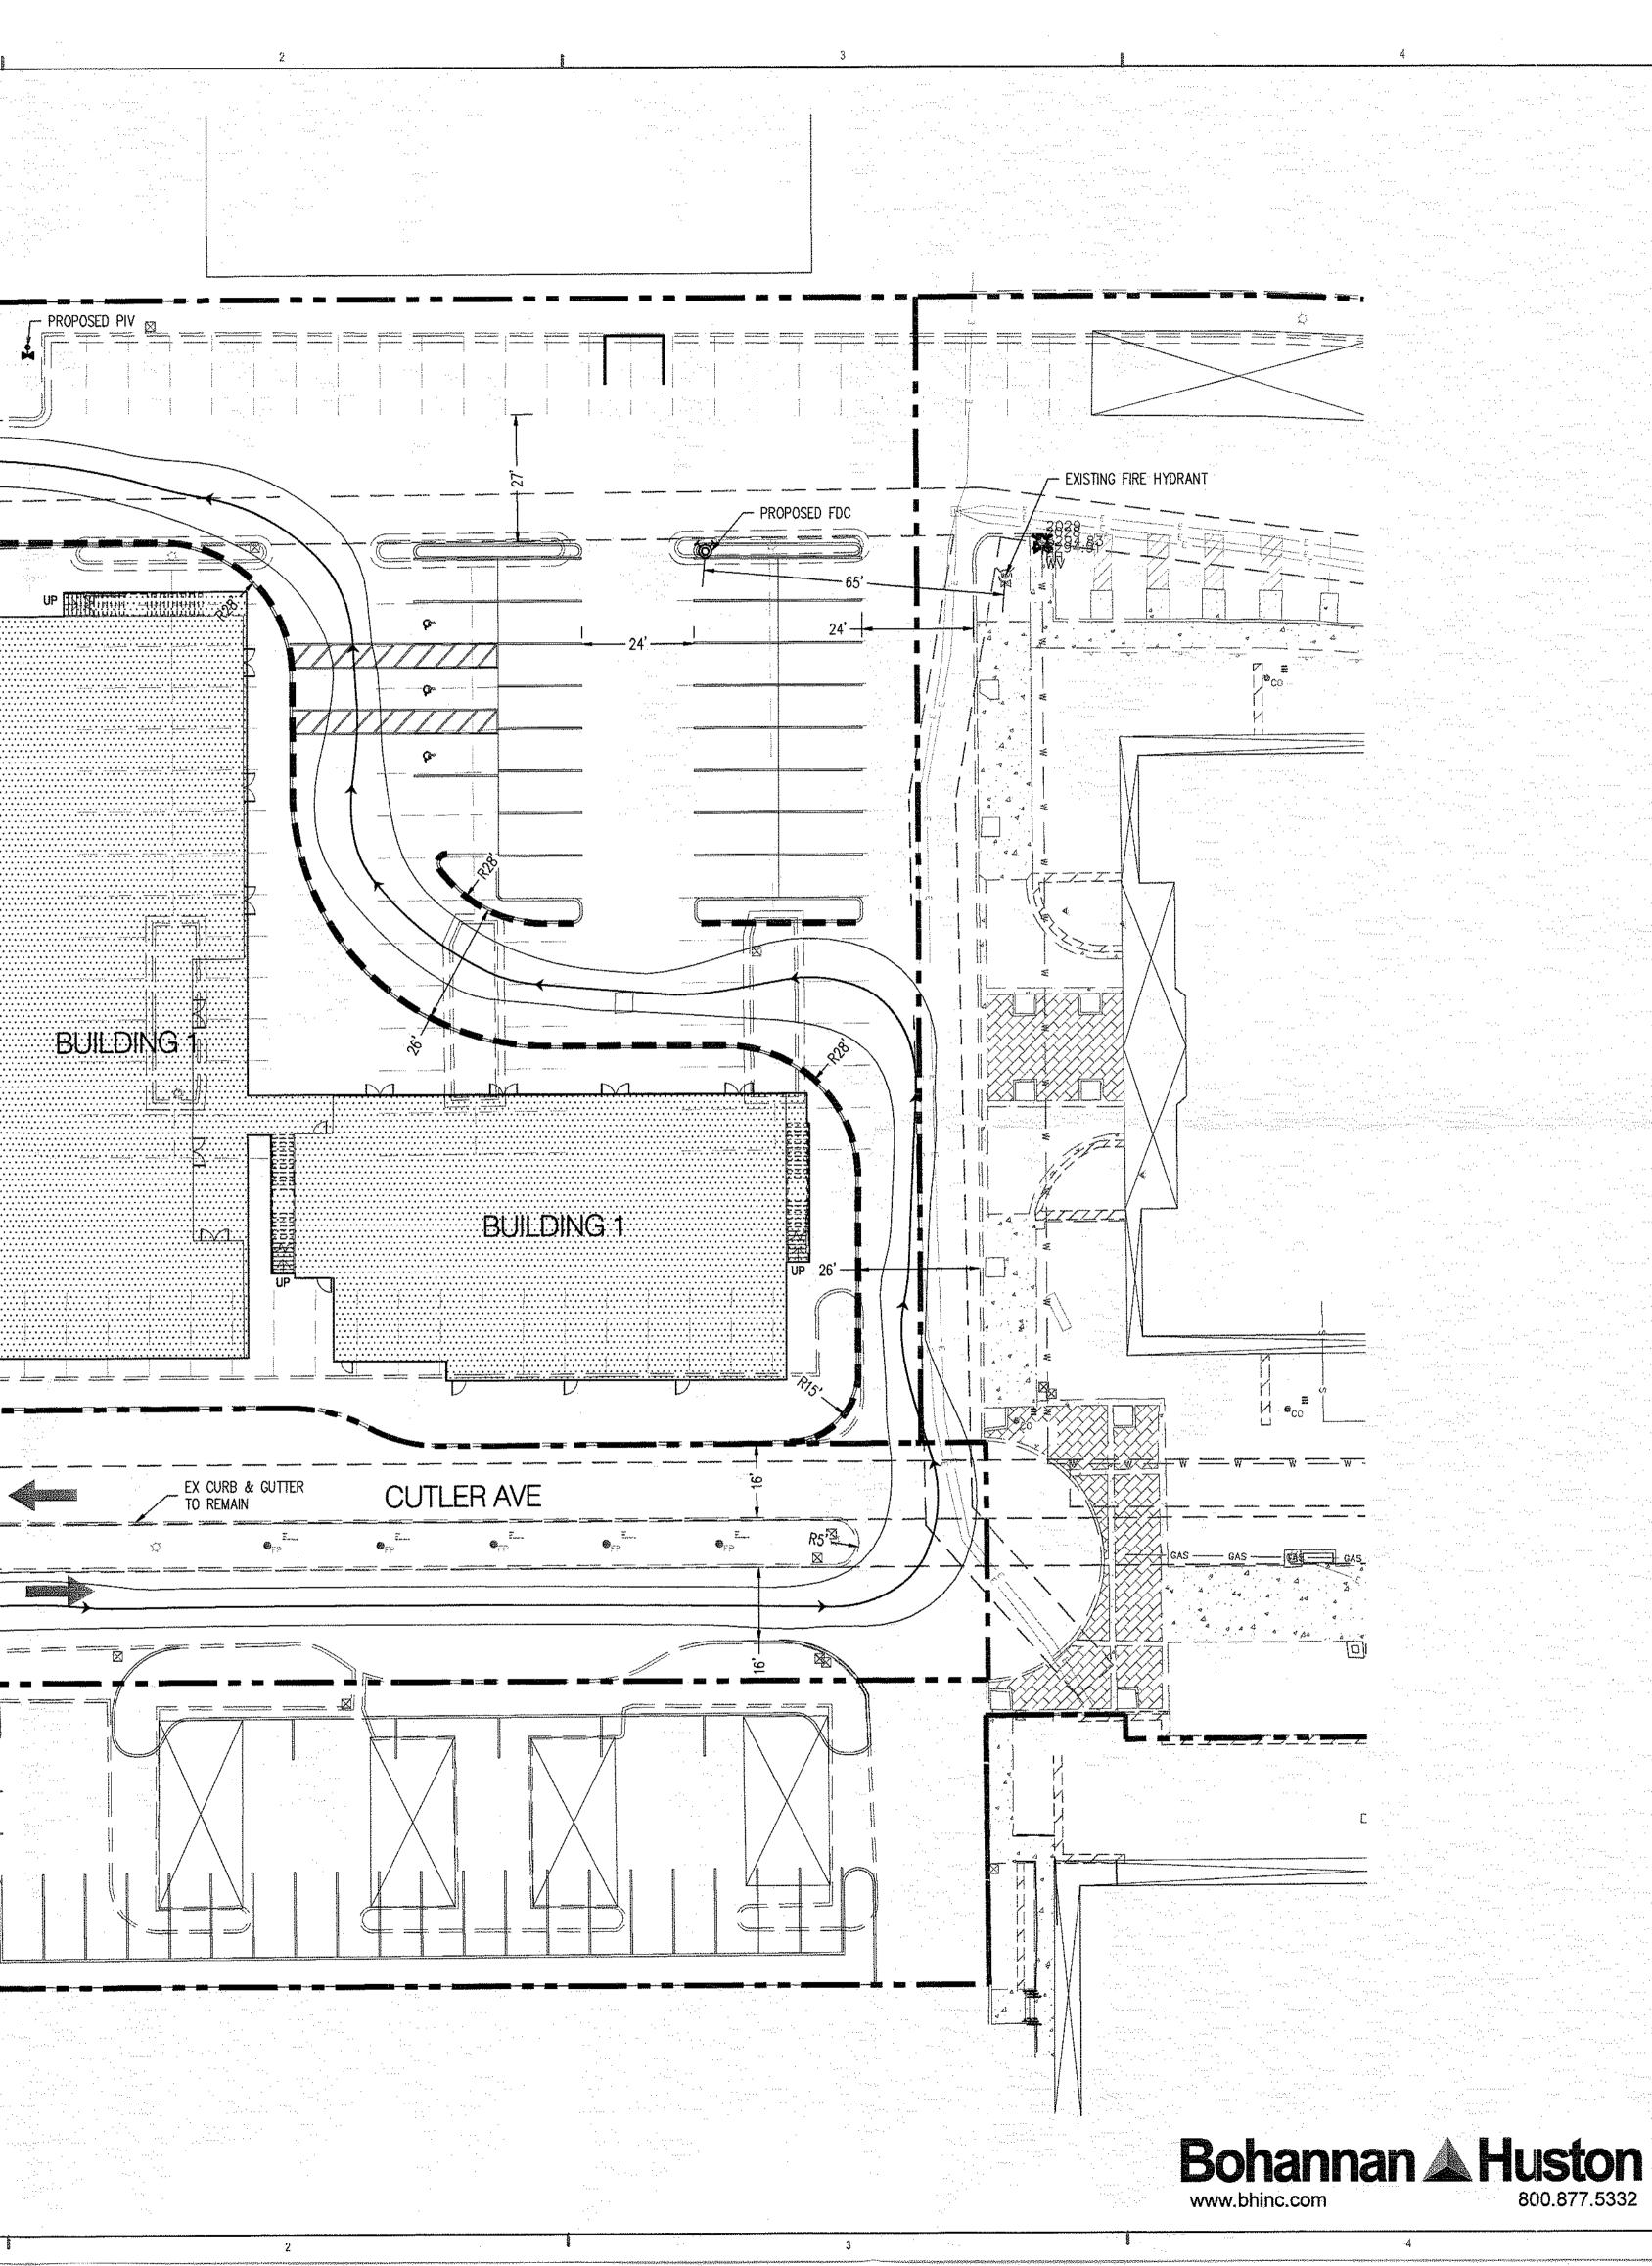

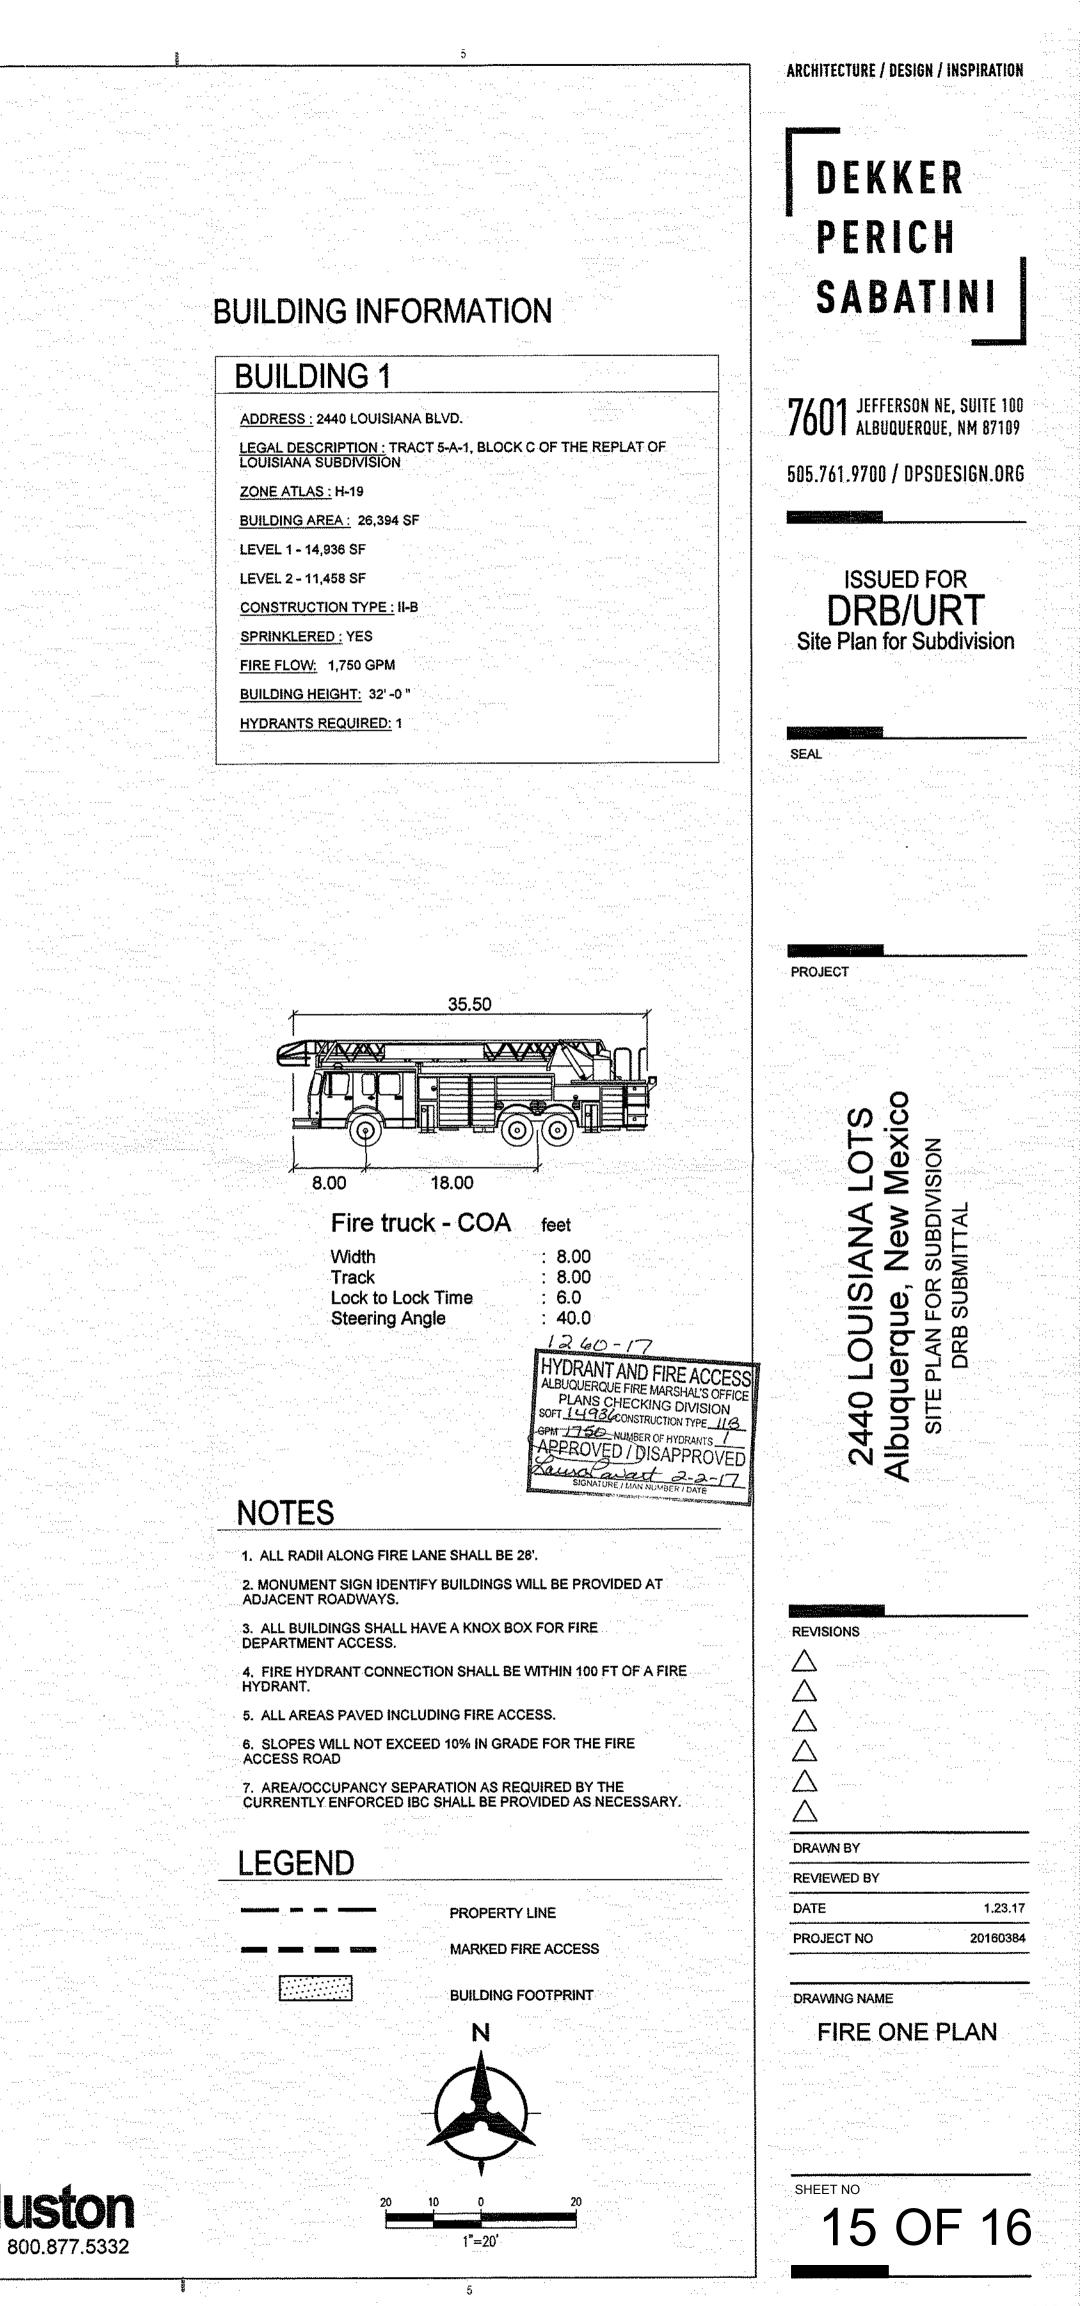

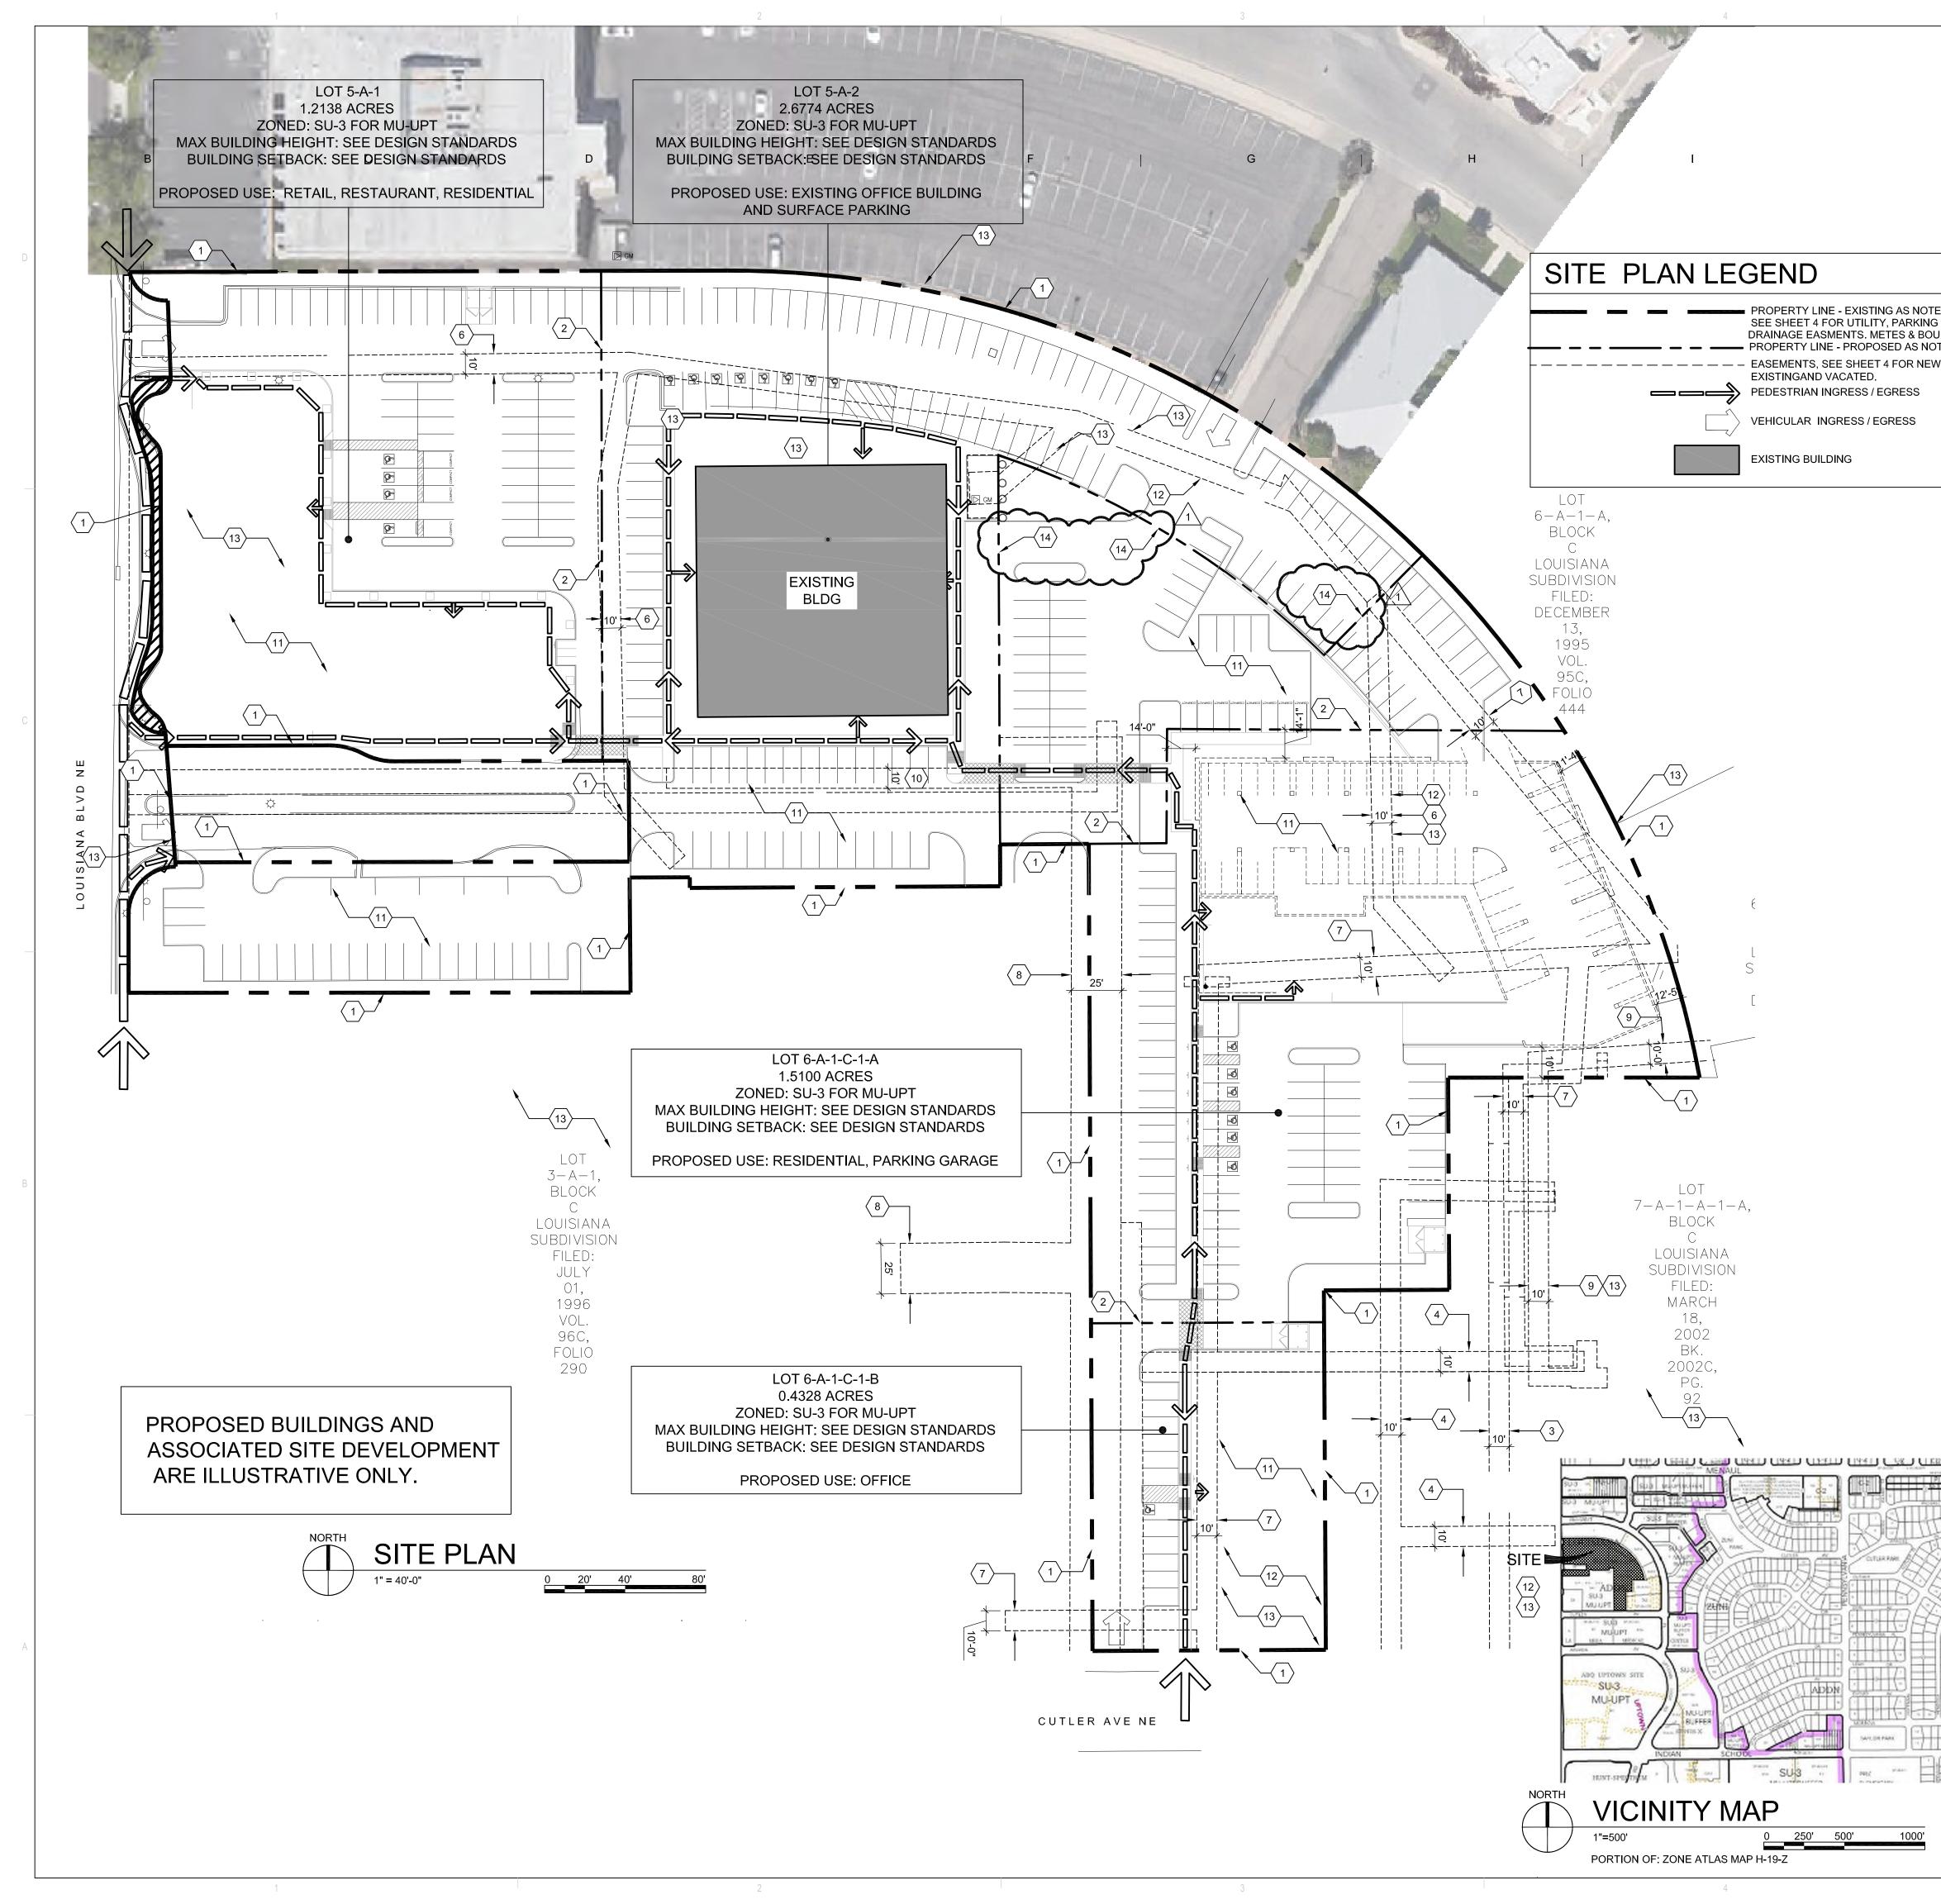

	GENER	AL SHE	ET NO	TES		ARCHITECTURE / DESIGN / INSPIRATION
	A. APPLICABLE PLA B. PROPOSED USES					
	HOUSING C. REFER TO CIVIL I	DEKKER				
	⊖ SHEET KEYED NOTES					PERICH
	 EXISTING PROPE PROPOSED PROI 10' PRIVATE WAT 	PERTY LINE ER LINE EASEMEN				SABATINI
	 4. 10' PRIVATE SAN 5. EXISTING 5' P.U.E 6. EXISTING 10' UNE 			ST&T		
ED G &		F&T UNDERGROUN WER, WATER MAIN LINE FASEMENT		ECTION EASEN	IENT	7601 JEFFERSON NE, SUITE 100 ALBUQUERQUE, NM 87109
UNDS. DTED W,	10. PORTION OF ORI 11. PROPOSED BUILI ONLY	GINAL EASEMENT			E ILLUSTRATIVE	505.761.9700 / DPSDESIGN.ORG
	12. EXISTING RECIPF (8.14.89, C39-140)	BLANKET IN NATU	JRE.			
	13. EXISTING PRIVAT	NE TO BE RE-PLAT	•	,		
	SITE DA		216720007			ISSUED FOR DRB/URT
	<u>SITE ADDRESS</u> : 2440 <u>LEGAL DESCRIPTION</u> CONT3.2997 AC AND BLOCK C LOUISIANA C LOUSIANA SUBDIV ACRES: EXISTING 3.2	LOUISIANA BLVD, <u>I</u> : LOT 5-A BLK C L LOT 6-A-1-C-1 BLK SUBDIVISION COM ISION CONT 2.559	ALBUQUERQUE, OUISIANA SUBD (/ C PLAT OF LOTS //PRISED O F LOTS	A REPL OF LT 6-A-1-C-1 & 7-	A-1-A-1-A	Site Plan for Subdivision
	SECTOR DEVELOPM COMPREHENSIVE PL ZONE: SU-3 FOR MU	ENT PLANS: UPTO AN DESIGNATION		RBAN		SEAL
	BUILDING AREA: LOT 5-A-1					· · · · ·
		RETAIL RESIDENTIAL FAR	14,067 SF 9,709 SF (1 0.45	I STORY ABC	VE RETAIL)	
	LOT 5-A-2:	EXISTING OFFI	CE 93,799 SF	(7 STORY)		PROJECT
	LOT 6-A-1-C-1-A:	RESIDENTIAL FAR	54,000 SF 0.82	(5 STORY)		
	LOT 6-A-1-C-1-B:	OFFICE FAR	5,015 SF (1 0.27	I STORY)		
	FUTURE SITE DEVE DESIGN STANDARE DEVELOPMENT PL/ ZONING AND DESIG STREET REALM / L/ OPEN SPAC PLAZAS LANDSCAPE TREES WALKWAYS LANDSCAPE LANDSCAPE BUILDING DESIGN: HEIGHT / SE REGULATION	DS AS DESCRIBE AN: <u>ON REGULATION</u> ANDSCAPING: E C C E C E C E C E C C E DUFFERS C E PLAN C TBACK C	D WITHIN THE UI	PTOWN SEC D (pgs 51 - 53 E (pgs 54 - 55 F (pgs 55 - 57 G (pgs 57 - 60 F (pgs 60 - 61 I (pgs 61 - 62 K (pgs 65 - 66 s G & H (pgs	FOR 3) 5) 5) 7) 7) 7) 7) 7) 7) 7) 7) 7) 7) 7) 7) 7)	2440 LOUISIANA LOTS 2440 LOUISIANA LOTS Albuquerque, New Mexico SITE PLAN FOR SUBDIVISION DRB SUBMITTAL DRB SUBMITTAL
	SIGNAGE: REGULATIO	NS (Chapter V Section	L (pgs 66 - 73)	
	SITE DESIGN: PARKING REGULATIO	NS C	Chapter V Section Chapter V Section Chapter V Section Chapter VI Section	B (pg 50) Scre C (pg 51) Fen	ening	REVISIONS
	PROJECT NUMB	······	0 (00) 5 DPR	42	7	
	a work order is requ	List Required? ()			approved DRC plar /ay or for constructi	
	public improvemen SITE DEVEL		LAN APPRO)VAL:		
EX	A				3/2/16	DRAWN BY DKM REVIEWED BY AMA
A	TRAFFIC ENGIN	EER, TRANSPOR	TATION DIVISIO	N	ÓATE	DATE 10/18/2016 PROJECT NO 14-0087.001
14	ABCWUA	<u> </u>	<u>lre</u>		<u>01/03/16</u> DATE	
	Carrol	Dum	ent		9-3-16 DATE	DRAWING NAME
	PARKS AND REC	REATION DEPA	RIMENT		8-3-16	PLAN FOR
	CITY ENGINEER				DATE 18-26-1/	SUBDIVISION REV. PER DRB/URT
	SOLID WASTE M	IANAGEMENT	01		DATE	
	DRB CHAIRFERS	SON, PLANNING	DEPARTMENT		10-20-18 DATE	16 OF 16