

DISCLOSURE STATEMENT:

THE PURPOSE OF THIS PLAT IS TO SUBDIVIDE TWO LOTS INTO ONE LOT, AND GRANT ANY EASEMENTS AS SHOWN.

GENERAL NOTES:

- 1: UNLESS NOTED, NO.4 REBAR WITH CAP STAMPED P.S. #9801 WERE SET AT ALL PROPERTY CORNERS.
- 2: THIS PLAT SHOWS ALL EASEMENTS OF RECORD.
- 3: BEARINGS ARE NEW MEXICO STATE PLANE GRID BEARINGS, CENTRAL ZONE, NAD 1983, AND ARE BASED ON ALBUQUERQUE CONTROL MONUMENT DOUGLAS.
- 4: BEARINGS ARE GRID, DISTANCES ARE GROUND.
- 5: SITE DATA: ZONING IS C-1.
- 6: NUMBER OF EXISTING TRACTS/LOTS......2 LOT
- 7: NUMBER OF TRACTS/LOTS CREATED...... LOTS
- 8: NO PROPERTY WITHIN THE AREA OF REQUESTED FINAL ACTION SHALL AT ANY TIME BE SUBJECT TO DEED RESTRICTION, COVENANT, OR BINDING AGREEMENT PROHIBITING SOLAR COLLECTORS FROM BEING INSTALLED ON BUILDINGS OR ERECTED ON THE LOTS OR PARCELS WITHIN THE AREA OF PROPOSED PLAT. THE FOREGOING REQUIREMENT SHALL BE A CONDITION TO APPROVAL OF THIS PLAT OR SITE DEVELOPMENT PLAN FOR SUBDIVISION.

THIS IS TO CERTIFY THAT TAXES ARE CURRENT AND PAID ON UPC # 101466/15/08350603 - 10/406/15708230604 PROPERTY OWNER OF RECORD: Hobakes in6

BERNALILLU CO. IREASURER'S OFFICE: 218-15

LEGAL DESCRIPTION:

LOTS NUMBERED THREE (3) AND FOUR! (4). IN BLOCK NUMBERED TWO (2) OF SANDIA PLAZA, A SUBDIVISION OF A TRACT OF LAND IN SCHOOL DISTRICT NO. 22, IN BERNALILLO COUNTY, NEW MEXICO. AS THE SAME IS SHOWN AND DESIGNATED ON THE PLAT OF SAID ADDITION FILED IN THE OFFICE OF THE COUNTY CLERK OF BERNALILLO COUNTY, NEW MEXICO ON AUGUSTI 28 1941, IN BOOK D, PAGE 33. CONTAINING 0.3519 ACRE (15,329.81 SF) MORE OR LESS

FREE CONSENT

THE SUBDIVISION HEREON DESCRIBED IS WITH THE FREE CONSENT IN ACCORDANCE WITH THE DESIRES OF THE UNDERSIGNED OWNERS AND PROPRIETOR THEREOF. SAID OWNER(S) AND/OR PROPRIETOR(S) WARRANT THAT THEY HOLD AMONG THEM COMPLETE AND INDEFEASIBLE TITLE IN FEE SIMPLE TO THE LAND SUBDIVIDED. SAID OWNER(S) / PROPRIETOR(S) DO HEREBY DEDICATE PUBLIC RIGHT-OF-WAY SHOWN HEREON (323.58 SF., 0.0074 AC.) TO THE CITY OF ALBUQUERQUE IN FEE SIMPLE WITH WARRANTY COVENANTS AND DO HEREBY GRANT ANY AND ALL EASEMENTS AS MAY BE CREATED BY THIS PLAT

OWNER(S) SIGNATURE:

DATE: 01-14-2015

OPPICIAL LIN

Ay Commission Exact 4/23/16

SHAHFIAM DIJLAM NOT MYTTULE

OWNER(S) PRINT NAME: NANCY JO AFCHER, PRESIDENT FOR HOGARES, INC.

ACKNOWLEDGMENT

STATE OF NEW MEXICO

COUNTY OF BERNALILLO)

THIS INSTRUMENT WAS ACKNOWLEDGED BEFORE ME THIS ___14th__ DAY OF __JANUARY_

NANCY JO ARCHER PRESIDENT FOR HOGARES, INC

MY COMMISSION EXPIRES:

Comments of

ACT STATE

and the last

Markey.

10.77 1994

what she Section !

4....

44 may 14

- William

PLAT OF LOT 3-A, BLOCK 2 SANDIA PLAZA

TOWN OF ALBUQUERQUE GRANT PROJECTED SECTION 32, T. 11 N., R. 3 E., N.M.P.M. CITY OF ALBUQUERQUE BERNALILLO COUNTY, NEW MEXICO JANUARY, 2015

PROJECT NO. <u>1011082</u>	
APPLICATION NO. 15-70025	
UTILITY APPROVALS:	
PONT ÉLECTRIC SERVICES	2-10-15
	DATE 2/2/18 DATE
NEW MEXICO GOS COMPANY	2/2/15
OWEST CORPORATION D/B/A CENTURYLINK OC	DATE
COMCAST CABLE COMMUNICATION, INC.	DATE
APPROVALS:	
CITY SURVEYOR	DATE
NEL	02-11-15
TRAFFIC ENGINEERING TRANSPORTATION DIVISION	02/11/)5
Carol S. Durnont	DATE # 11/15
PARKS AND RECREATION DEPARTMENT	DATE
ALBUQUERQUE METROPOLITAN ARROYO FLOOD CONTROL A	AUTHORITY DATE
City ENGINEER	2-11-15 DATE
(12/1	7 -11-15

SURVEYORS CERTIFICATE:

DRB CHAIRPERSON, PLANNING DEPARTMENT

I. LEONARD MARTINEZ. A DULY PROFESSIONAL LICENSED LAND SURVEYOR. UNDER THE LAWS OF THE STATE OF NEW MEXICO, DO HEREBY CERTIFY THAT THE PLAT WAS PREPARED UNDER MY DIRECT SUPERVISION AND MEETS THE REQUIREMENTS FOR MONUMENTATION AND SURVEY OF THE ALBUQUERQUE SUBDIVISION ORDINANCE AND ALSO MEETS THE MINIMUM STANDARDS FOR LAND SURVEYS IN NEW MEXICO AS ADOPTED BY THE NEW MEXICO STATE BOARD OF LICENSURE FOR PROFESSIONAL ENGINEERS AND LAND SURVEYORS AND IS TRUE AND CORRECT TO THE BEST OF MY KNOWLEDGE AND BELIEF.

LEONARD MARTINEZ P.S. # 9801

01-14-2015 DATE

DOC# 2015012928

02/18/2015 10 04 AM Page 1 of 2 d,P101 R 125 00 B 2015C P 0012 M (oulous Ulivere, Bernalillo Cou

SBS CONSTRUCTION AND ENGINEERING, LLC

> 10209 SNOWFLAKE CT., NW ALBUQUERQUE, NEW MEXICO 87114 (505)804-5013

> > SHEET 1 OF 2

EASEMENTS:

- EXISTING 5' PUBLIC UTILITY EASEMENT (8/28/41, D-33) & RESTRICTIVE COVENANTS (8/28/41, BK. "P" MISC., PG. 111)
- 5' PUBLIC UTILITY EASEMENT GRANTED BY THIS PLAT.
- 6' ROAD WAY EASEMENT GRANTED TO CITY OF ALBUQUERQUE

* NOTE- ANY LANDSCAPING IN R.O.W. IS TO BE MANTAINED BY ADDRENT PROPERTY OWNER

PLAT OF LOT 3-A, BLOCK 2 SANDIA PLAZA

TOWN OF ALBUQUERQUE GRANT PROJECTED SECTION 32, T. 11 N., R. 3 E., N.M.P.M. CITY OF ALBUQUERQUE BERNALILLO COUNTY, NEW MEXICO JANUARY, 2015

SBS CONSTRUCTION

AND ENGINEERING, LLC

P. O. BOX 10264 ALBUQUERQUE, NEW MEXICO 87184 (505)899-5570

SHEET 2 OF 2

CURVE TABLE CORD DIRECTION LENGTH RADIUS TANGAN CORD DELTA N**71°**29'02"E 13.38 23.60' 24'57'56" 25.00 24.57

Hamphone Manie

3. 3 A . 3

PUBLIC UTILITY EASEMENTS PUBLIC UTILITY EASEMENTS SHOWN ON THIS PLAT ARE GRANTED FOR THE COMMON AND JOINT USE OF A. PUBLIC SERVICE COMPANY OF NEW MEXICO ("PNM"), A NEW MEXICO CORPORATION, (PNM ELECTRIC) FOR INSTALLATION, MAINTENANCE, AND SERVICE OF OVERHEAD AND UNDERGROUND ELECTRICAL LINES. TRANSFORMERS, AND OTHER EQUIPMENT AND RELATED FACILITIES REASONABLY NECESSARY TO PHOVIDE

CURVE


B NEW MEXICO GAS COMPANY FOR INSTALLATION, MAINTENANCE, AND SERVICE OF NATURAL GAS LINES VALVES AND OTHER EQUIPMENT AND FACILITIES HEASONABLY NECESSARY TO PROVIDE NATURAL GAS

C. QWEST FOR THE INSTALLATION, MAINTENANCE, AND SERVICE OF SUCH LINES, CABLE, AND OTHER RELATED EQUIPMENT AND FACILITIES REASONABLY NECESSARY TO PROVIDE COMMUNICATION SERVICES. D. CABLE TV FOR THE INSTALLATION, MAINTENANCE, AND SERVICE OF SUCH LINES, CABLE, AND OTHER RELATED EQUIPMENT AND FACILITIES REASONABLY NECESSARY TO PROVIDE CABLE SERVICES

INCLUDED, IS THE RIGHT TO BUILD, REBUILD, CONSTRUCT, RECONSTRUCT, LOCATE, RELOCATE, CHANGE, REMOVE, REPLACE, MODIFY, RENEW, OPERATE AND MAINTAIN FACILITIES FOR PURPOSES DESCRIBED ABOVE, TOGETHER WITH FREE ACCESS TO FHOM, AND OVER SAID FASEMENTS, WITH THE HIGHT AND PHIVILEGE OF GOING UPON, OVER AND ACROSS ADJOINING LANDS OF GRANTOR FOR THE PURPOSES SET FORTH HEREIN AND WITH THE RIGHT TO UTILIZE THE RIGHT OF WAY AND EASEMENT TO EXTEND SERVICES TO CUSTOMERS OF GRANTEE, INCLUDING SUFFICIENT WORKING AREA SPACE FOR ELECTRIC TRANSFORMERS WITH THE RIGHT AND PRIVILEGE TO TRIM AND REMOVE TREES. SHRUBS OR BUSHES WHICH INTERFERE WITH THE PURPOSES SET FORTH HEREIN. NO BUILDING, SIGN, POOL (ABOVEGROUND OR SUBSURFACE), HOT TUB, CONCRETE OR WOOD POOL DECKING, OR OTHER STRUCTURE SHALL BE ERECTED OR CONSTRUCTED ON SAID EASEMENTS, NOR SHALL ANY WELL BE DRILLED OR OPERATED THEREON PROPERTY OWNERS SHALL BE SOLELY RESPONSIBLE FOR CORRECTING ANY VIOLATIONS OF NATIONAL ELECTRICAL SAFETY CODE BY CONSTRUCTION OF POOLS, DECKING, OR ANY STRUCTURES ADJACENT TO OR NEAR FASEMENTS SHOWN ON

EASEMENTS FOR ELECTRIC TRANSFORMER/SWITCHGEARS, AS INSTALLED, SHALL EXTEND TEN (10) FEET IN FRONT OF TRANSFORMER/SWITCHGEAR DOORS AND FIVE (5) FEET ON EACH SIDE

IN APPROVING THIS PLAT, PUBLIC SERVICE COMPANY OF NEW MEXICO (PNM) AND NEW MEXICO GAS COMPANY (NMGC) DID NOT CONDUCT A TITLE SEARCH OF THE PROPERTIES SHOWN HEREON CONSEQUENTLY, PNM AND NMGC DO NOT WAIVE OR RELEASE ANY EASEMENT OR EASEMENT RIGHTS WHICH MAY HAVE BLEN GRANTED BY PRIOR PLAT, REPLAT OR OTHER DOCUMENT AND WHICH ARE NOT SHOWN ON THIS PLAT

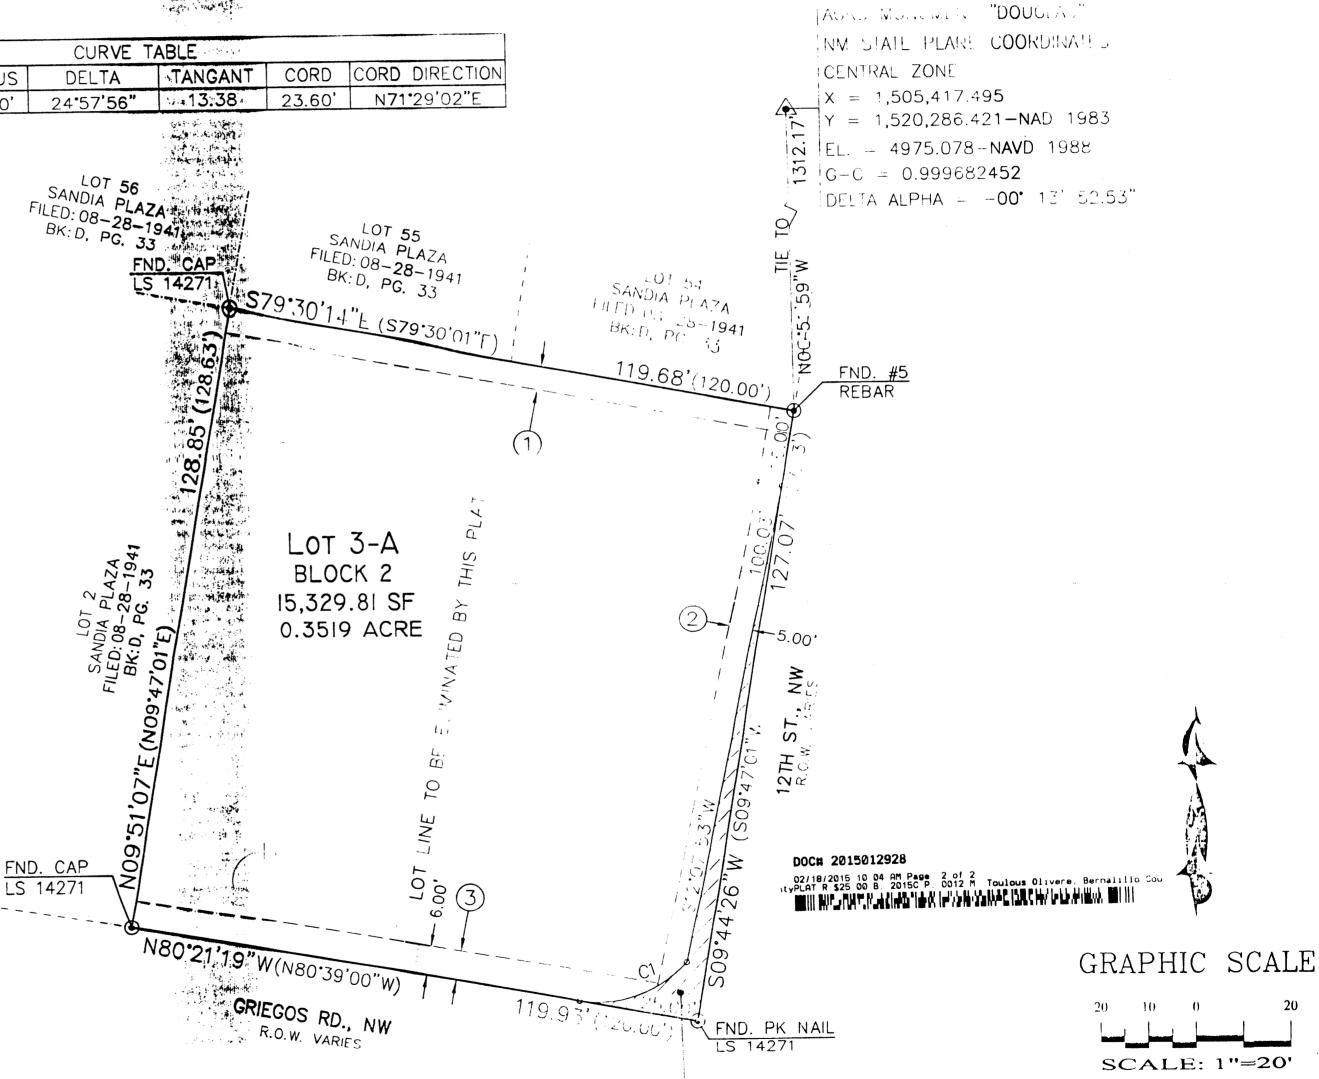


0.0074 AC.


COVENANTS.

DEDICATED TO THE CITY

OF ALBUQUERQUE IN FEE SIMPLE WITH WARRANTY

DRAWING: 201418 PLAT DRAWN BY SHH DATE: 02-03-2015

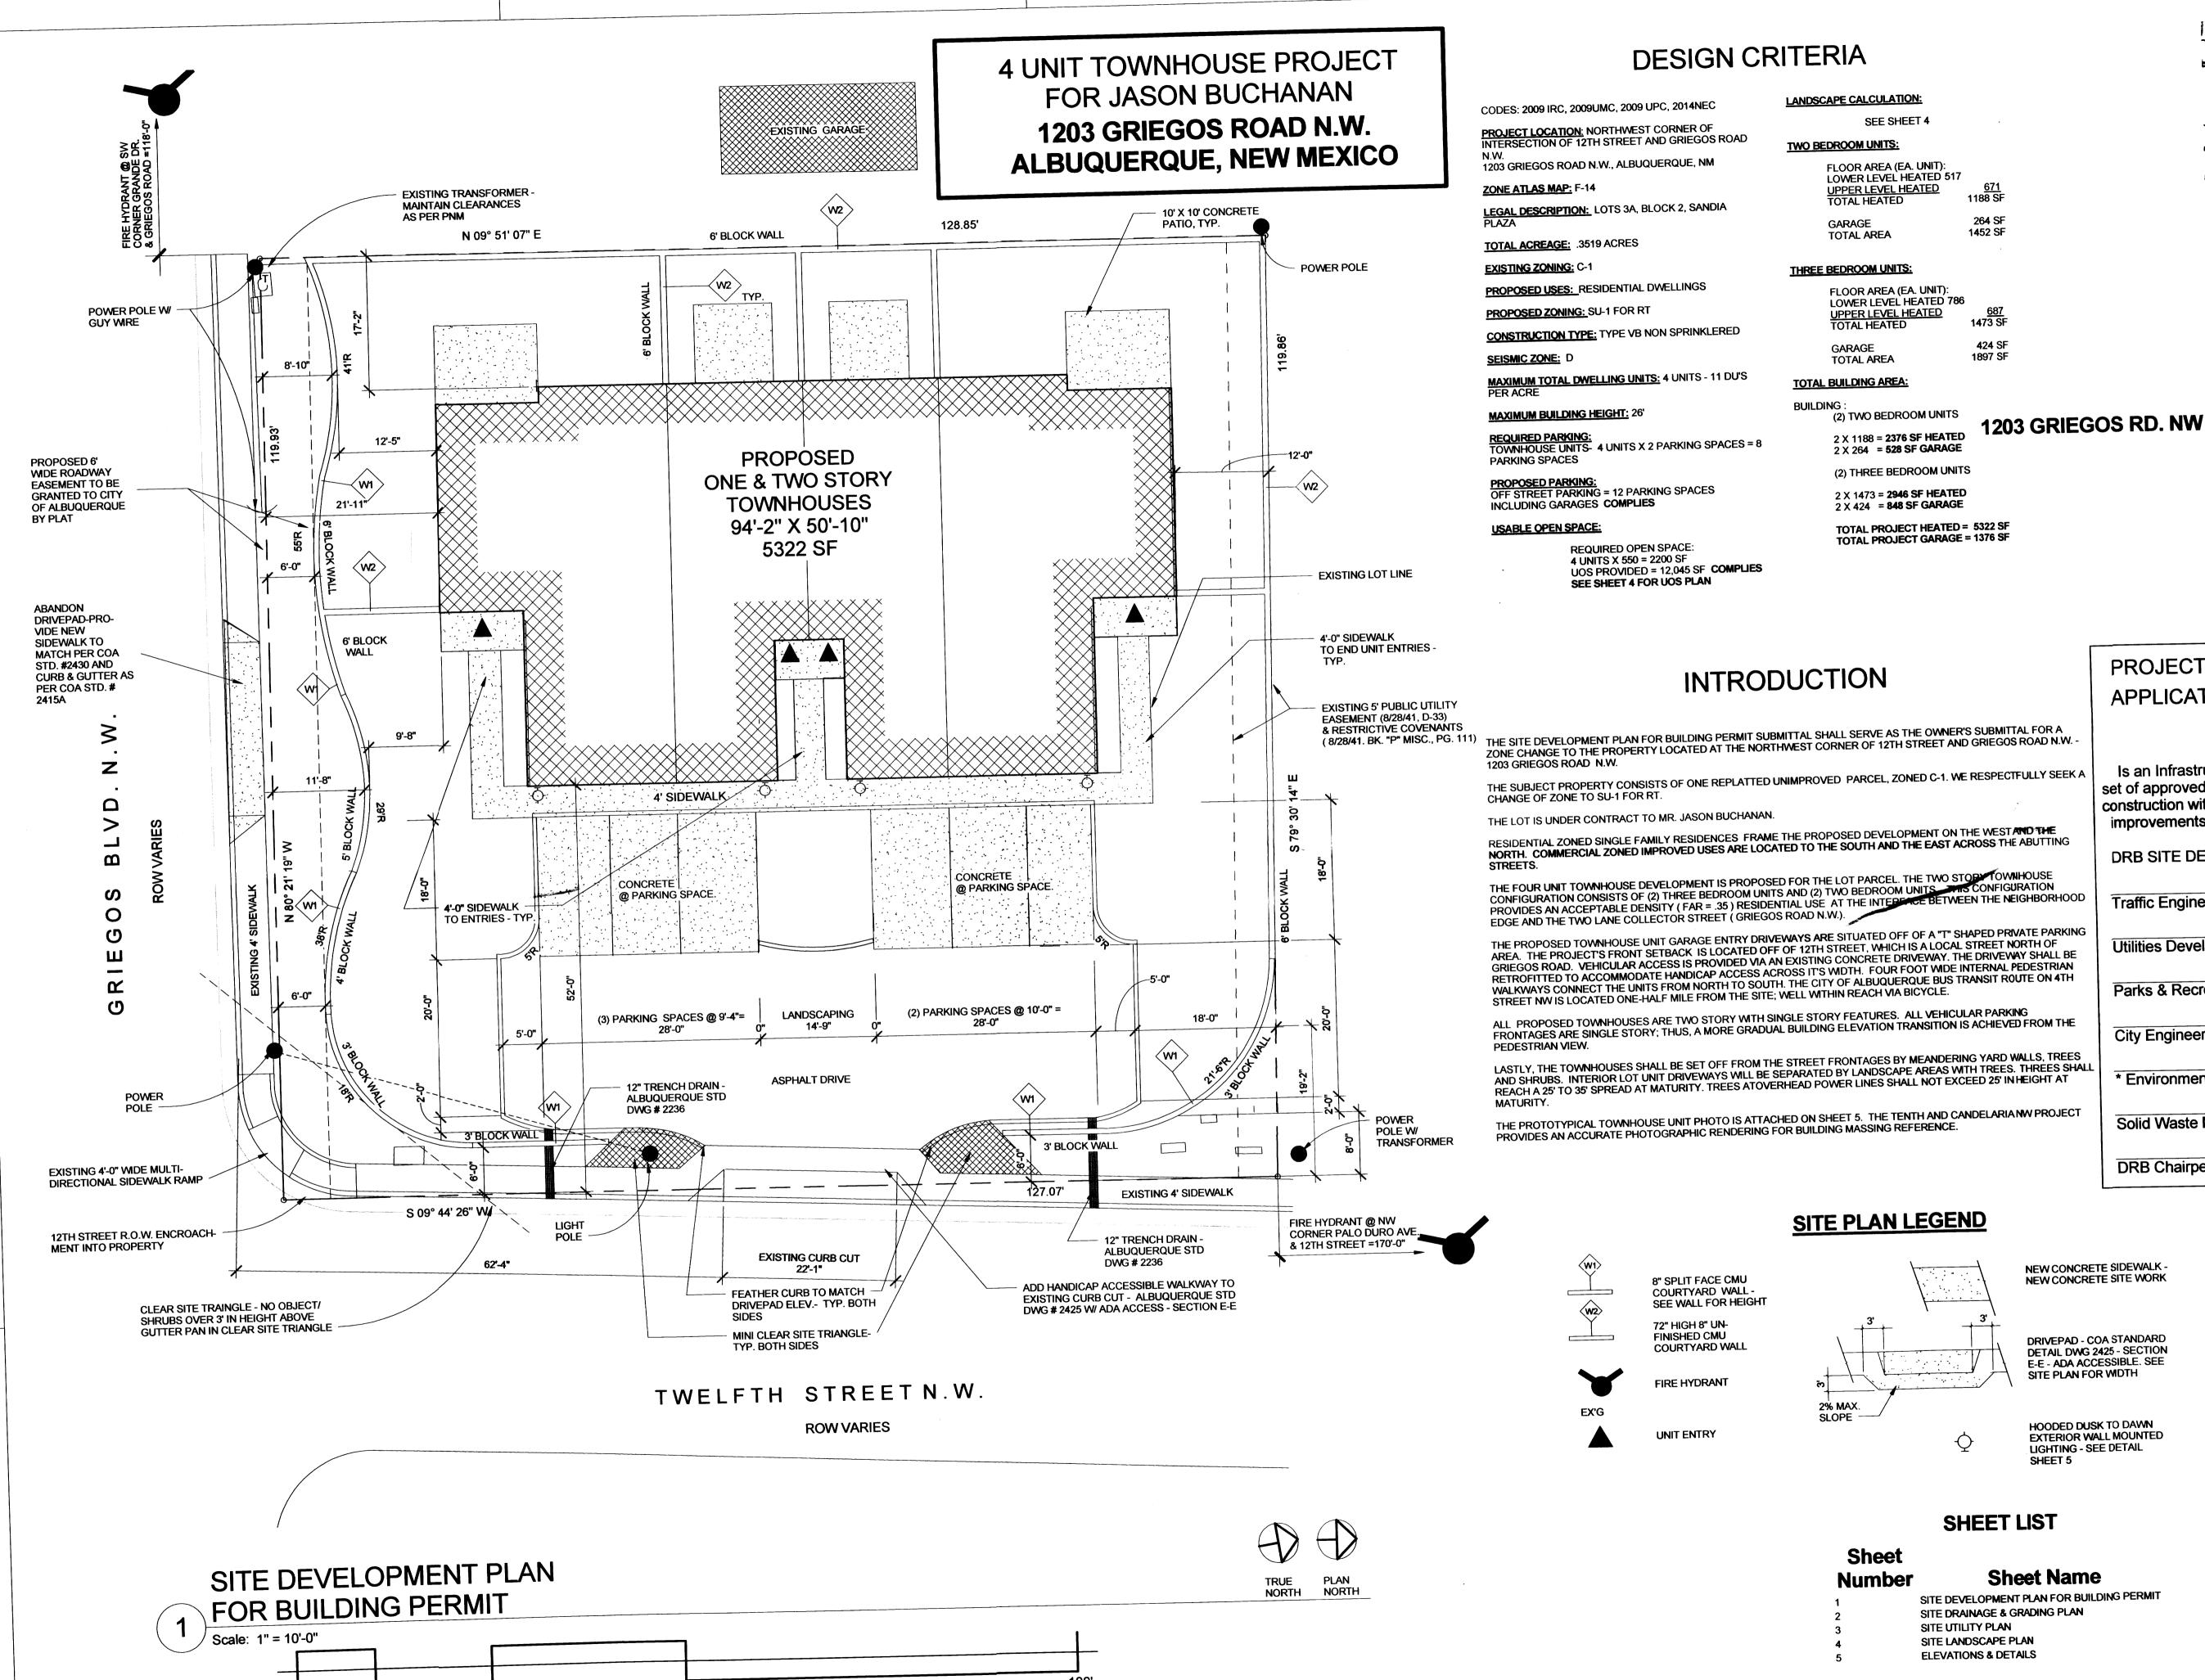

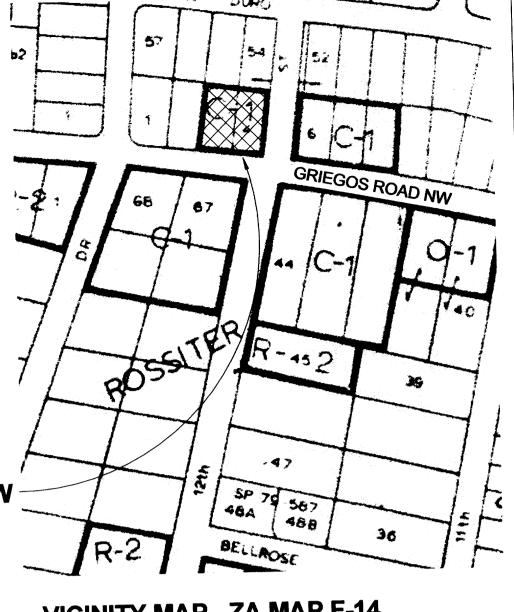

VICINITY MAP - ZA MAP F-14

THE SITE DEVELOPMENT PLAN FOR BUILDING PERMIT SUBMITTAL SHALL SERVE AS THE OWNER'S SUBMITTAL FOR A ZONE CHANGE TO THE PROPERTY LOCATED AT THE NORTHWEST CORNER OF 12TH STREET AND GRIEGOS ROAD N.W. -

THE SUBJECT PROPERTY CONSISTS OF ONE REPLATTED UNIMPROVED PARCEL, ZONED C-1. WE RESPECTFULLY SEEK A

RESIDENTIAL ZONED SINGLE FAMILY RESIDENCES FRAME THE PROPOSED DEVELOPMENT ON THE WEST AND THE NORTH. COMMERCIAL ZONED IMPROVED USES ARE LOCATED TO THE SOUTH AND THE EAST ACROSS THE ABUTTING

THE FOUR UNIT TOWNHOUSE DEVELOPMENT IS PROPOSED FOR THE LOT PARCEL. THE TWO STOPY TOWNHOUSE CONFIGURATION CONSISTS OF (2) THREE BEDROOM UNITS AND (2) TWO BEDROOM UNITS PROVIDES AN ACCEPTABLE DENSITY (FAR = .35) RESIDENTIAL USE AT THE INTERFACE BETWEEN THE NEIGHBORHOOD

GRIEGOS ROAD. VEHICULAR ACCESS IS PROVIDED VIA AN EXISTING CONCRETE DRIVEWAY. THE DRIVEWAY SHALL BE RETROFITTED TO ACCOMMODATE HANDICAP ACCESS ACROSS IT'S WIDTH. FOUR FOOT WIDE INTERNAL PEDESTRIAN WALKWAYS CONNECT THE UNITS FROM NORTH TO SOUTH. THE CITY OF ALBUQUERQUE BUS TRANSIT ROUTE ON 4TH

FRONTAGES ARE SINGLE STORY; THUS, A MORE GRADUAL BUILDING ELEVATION TRANSITION IS ACHIEVED FROM THE

AND SHRUBS. INTERIOR LOT UNIT DRIVEWAYS WILL BE SEPARATED BY LANDSCAPE AREAS WITH TREES. THREES SHALL REACH A 25' TO 35' SPREAD AT MATURITY. TREES ATOVERHEAD POWER LINES SHALL NOT EXCEED 25' IN HEIGHT AT

THE PROTOTYPICAL TOWNHOUSE UNIT PHOTO IS ATTACHED ON SHEET 5. THE TENTH AND CANDELARIANW PROJECT


PROJECT NUMBER: #1010182 **APPLICATION NUMBERS:**

SDP FOR BP: #15DRB-70024

Is an Infrastructure List required? () Yes () No If Yes, then a set of approved DRC plans with a work order is required for any construction within Public Right-of-Way or for construction of public improvements.

DRB SITE DEVELOPMENT PLAN APPROVAL:

Traffic Engineer, Transportation Division	Date
Utilities Development	Date
Parks & Recreation Department	Date
City Engineer	Date
* Environmental Health Department (conditional)	Date
Solid Waste Management	Date
DRB Chairperson, Planning Department	Date

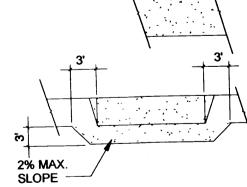


NEW CONCRETE SIDEWALK -NEW CONCRETE SITE WORK

DRIVEPAD - COA STANDARD DETAIL DWG 2425 - SECTION E-E - ADA ACCESSIBLE. SEE SITE PLAN FOR WIDTH

HOODED DUSK TO DAWN EXTERIOR WALL MOUNTED LIGHTING - SEE DETAIL

ALBUQUERQUE, NEW MEXICO **DRAWING TITLE:** SITE DEVELOPMENT PLAN FOR

ARCHITECTS

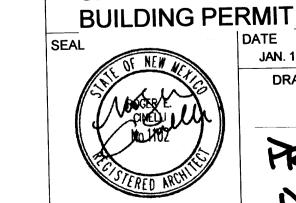

PROJECT NO. BUCH 6D JAN. 1, 2015 DRAWING NO.

PROJECT: 1010182 DATE: APP:

Roger Cinelli & Assoc. 2418 Manuel Torres Lane N.W.

Albuquerque, New Mexico 87107

(505) 243-8211

4 UNIT TOWNHOUSE DEV.

FOR JASON BUCHANAN

1203 GRIEGOS ROAD N.W.

SHEET LIST

Sheet Name

SITE DEVELOPMENT PLAN FOR BUILDING PERMIT SITE DRAINAGE & GRADING PLAN SITE UTILITY PLAN SITE LANDSCAPE PLAN **ELEVATIONS & DETAILS**

NOTICE TO CONTRACTORS

1. AN EXCAVATION/CONSTRUCTION PERMIT WILL BE REQUIRED BEFORE BEGINNING ANY

2. ALL WORK DETAILED ON THESE PLANS TO BE PERFORMED, EXCEPT AS OTHERWISE STATED OR PROVIDED HEREON, SHALL BE CONSTRUCTED IN ACCORDANCE WITH CITY OF ALBUQUERQUE INTERIM STANDARD SPECIFICATIONS FOR PUBLIC WORKS CONSTRUCTION,

3. TWO WORKING DAYS PRIOR TO ANY EXCAVATION, CONTRACTOR MUST CONTACT NEW MEXICO ONE CALL FOR LOCATING SERVICE, 260-1990 OR "811", FOR LOCATION

4. PRIOR TO CONSTRUCTION, THE CONTRACTOR SHALL EXCAVATE AND VERIFY THE HORIZONTAL AND VERTICAL LOCATIONS OF ALL CONSTRUCTIONS. SHOULD A CONFLICT EXIST. THE CONTRACTOR SHALL NOTIFY THE ENGINEER SO THAT THE CONFLICT CAN BE RESOLVED WITH A MINIMUM AMOUNT OF DELAY.

5. BACKFILL COMPACTION SHALL BE ACCORDING TO TRAFFIC/STREET USE. 6. MAINTENANCE OF THESE FACILITIES SHALL BE THE RESPONSIBILITY OF THE OWNER

7. WORK ON ARTERIAL STREETS SHALL BE PERFORMED ON A 24-HOUR BASIS.

APPROVALS	NAME	DATE
INSPECTOR		

Lots 3 and 4, Block 2, Sandia Plaza, contains +/- 0.3519 acres and is loated at 203 Griegos Rd. N.W. See attached portion of the Vicinity Map for exact location.

The purpose of this drainage report is to present a grading and drainage solution to replace existing improvements with this new

Existing Drainage Conditions

There is undeveloped. This site is fairly flat, and it drains to Griegos Road and 12th Street N.W. No offiste runoff enters the site. Based on the FIRM Map 35001C0119G (revised September 26, 2008) the site does not fall within a 100-year floodplain.

Proposed Conditions and On-Site Drainage Management Plan
The runoff generated from this site will be retained on-site. Several Ponds (A through D) are designed to hold nearly twice the volume of the 100-yr/6-day volume under the proposed conditions minus 100-yr/6-day volume under the historical conditions. Then when the ponds exceed their capacity the runoff will overflow into the parking lot and then to public street via sidewalk culverts. The allowable discharge in the Valley is 2.75 cf/acre meaning a retention volume requirement of 0.50 inches times the area (638.74 cf). The 90th Percentile/First Flush ponding requirement is 0.34 inches times the impervious area (282.32 cf). Total retention volume provided (2.631.83 cf) far exceeds the ponding requirement in the Valley (638.741 cf) and First Flush (282.32 cf).

City of Albuquerque, Development Process Manuel, Section 22.2, Hydrology Section, was used for runoff calculations. See this plan for AHYMO input and Summary output files.

* ZONE 2

100-YEAR, 6-HR STORM (UNDER EXISITNG CONDITIONS)

RAINFALL

TYPE=1 RAIN QUARTER=0.0 IN RAIN DAY=2.75 IN DT=0.03333 HR

* ON-SITE COMPUTE NM HYD

ID=1 HYD NO=100.0 AREA=0.000550 SQ MI PER A=0.00 PER B=100.00 PER C=0.00 PER D=0.00 TP=0.1333 HR MASS RAINFALL=-1

10-YEAR, 6-HR STORM (UNDER EXISTING CONDITIONS)

START

TIME=0.0TYPE=1 RAIN QUARTER=0.0 IN

RAINFALL

RAIN ONE=1.34 IN RAIN SIX=1.57 IN RAIN DAY=1.83 IN DT=0.03333 HR

* ON-SITE

COMPUTE NM HYD

ID=1 HYD NO=110.0 AREA=0.000550 SQ MI PER A=0.00 PER B=100.00 PER C=0.00 PER D=0.00

TP=0.1333 HR MASS RAINFALL=-1 ***** 100-YEAR, 6-HR STORM (UNDER PROPOSED CONDITIONS)

START

TYPE=1 RAIN QUARTER=0.0 IN RAINFALL RAIN ONE=2.01 IN RAIN SIX=2.35 IN RAIN DAY=2.75 IN DT=0.03333 HR

* ON-SITE

ID=1 HYD NO=100.1 AREA=0.000550 SQ MI COMPUTE NM HYD PER A=0.00 PER B=10.00 PER C=15.00 PER D=65.00

TP=0.1333 HR MASS RAINFALL=-1

10-YEAR, 6-HR STORM (UNDER PROPOSED CONDITIONS) ******

START RAINFALL

TYPE=1 RAIN QUARTER=0.0 IN

* ON-SITE

RAIN ONE=1.34 IN RAIN SIX=1.57 IN RAIN DAY=1.83 IN DT=0.03333 HR

ID=1 HYD NO=110.1 AREA=0.000550 SQ MI COMPUTE NM HYD PER A=0.00 PER B=10.00 PER C=15.00 PER D=65.00

TP=0.1333 HR MASS RAINFALL=-1

FINISH

FINISH

AHYMO PROGRAM INPUT FILE = 12	I SUMMARY TAB th.txt	LE (AH)	YMO_97	7) –	– V	ERSION: 199 [°]		JN DATE (N R NO.= AH			
COMMAND	HYDROGRAP IDENTIFICATION	FROM H ID NO.	TO ID NO.	AREA (SQ MI)	PEAK DISCHARGE (CFS)	RUNOFF VOLUME (AC-FT)	RUNOFF (INCHES) (H	TIME TO PEAK IOURS)	CFS PER ACRE	PAGE NOTATION	
START RAINFALL TYPE: COMPUTE NM HY START		0 –	1	.00055	.81	.023	.77821	1.533	2.301 F	TIME= RAIN6= PER IMP= TIME=	.00 2.350 .00 .00
RAINFALL TYPE: COMPUTE NM HY START		0 –	1	.00055	.33	.008	.27828	1.533	.945	RAIN6= PER IMP= TIME=	1.570 .00 .00
RAINFALL TYPE: COMPUTE NM HY START	Ɗ 100.1	0 –	1	.00055	1.48	.053	1.79770	1.500	4.216 F	RAIN6= PER IMP= TIME=	2.350 72.22 .00
RAINFALL TYPE: COMPUTE NM HY		0 –	1	.00055	.93	.032	1.07842	1.500	2.650	RAIN6= PER IMP=	1.570 72.22

DEPRESS LANDSCAPING AREA TOP=72.50 (867.76 SF) BOTTOM=71.00 (236.73 SF) VOLUME=815.72 CF POND A 5 ∞ 28. 73.80 × HIGH POINT DEPRESS LANDSCAPING ARE TOR=72.90 (225.19 SF) BOTTOM=71.90 (80.33 SF) VOLUME=152.76 CF POND B HH 000. 27 PROPOSED 6.00'
ROADWAY EASEMENT TO BE GRANTED TO CITY OF ALBUQUERQUE EXIST. DW EXIST. DW GRIEGOS BLVD. N.W. R.O.W. VARIES DEPRESS LANDSCAPING AREA DEPRESS LANDSCAPING AREA TOP = 72.50 (702.12 SF)TOP=72.60 (1,049.82 SF) BOTTOM = 71.50 (102.70 SF)BOTTOM=71.10 (363.16 SF) VOLUME=603.62 CF VOLUME=1059.74 CF POND C POND D

O NOTES:

- 1. PROVIDE 12" CURB OPENING
- 2. 12" SIDEWALK CULRVET PER CITY STD DWG 2236 (TACK WELD PLATE AT THE BOLT)
- 3. 6" WALL OPENING (OR TURN TWO BLOCKS)

POND CALCULATION TOTAL POND AREA PROVIDED = POND A + B + C + D = 2,631.83 CF TOTAL PONDING VOLUME REQUIRED = VOL. PROPOSED CONDITIONS - VOL. EXISTING CONDITIONS

= 0.053 - 0.023 = 0.03 AC-FT = 1,306.80 CFTOTAL PONDING VOLUME REQUIRED (VALLEY)= 0.5 INCHES x AREA = $(0.5/12 \times 15,329.81) = 638.74$ CF TOTAL PONDING VOLUME REQUIRED (90TH PERCENTILE/FIRST FLUSH) = 0.34 IMCHES x IMPERVIOUS AREA = $(0.34/12 \times 9,964.38) = 282.32$ CF



LOTS 3 AND 4, BLOCK 2, SANDIA PLAZA

CONTAINING 15,329.81 S.F. (0.3519 ACRE) **ZONING: C-1 USES**

ADDRESS:

1203 GRIEGOS ROAD N.W.

GENERAL NOTES: 1: CONTOUR INTERVAL IS HALF (0.50) FOOT.

2: ELEVATIONS ARE BASED ON CITY OF ALBUQUERQUE CONTROL STATION DOUGLAS, HAVING AN ELEVATION OF 4975.078 FEET ABOVE SEA LEVEL.

- 3: UTILITIES SHOWN HEREON ARE IN THEIR APPROXIMATE LOCATION BASED ONLY ON ABOVE GROUND EVIDENCE FOUND IN THE FIELD AND AS-BUILT INFORMATION PROVIDED BY THE CLIENT. UTILITIES SHOWN HEREON, WHETHER INDICATED AS ABANDONED OR NOT, SHALL BE VERIFIED BY OTHERS FOR EXACT LOCATION AND/ OR DEPTH PRIOR TO EXCAVATION OR DESIGN CON-
- 4: THIS IS NOT A BOUNDARY SURVEY, BEARINGS ARE ASSUMED, DISTANCES AND FOUND PROPERTY CORNERS ARE FOR INFORMATIONAL PURPOSES ONLY. 5: SLOPES ARE AT 3:1 MAXIMUM.

NOTICE TO CONTRACTORS

1. AN EXCAVATION/CONSTRUCTION PERMIT WILL BE REQUIRED BEFORE BEGINNING ANY WORK WITHIN CITY RIGHT-OF-WAY.

2. ALL WORK DETAILED ON THESE PLANS TO BE PERFORMED, EXCEPT AS OTHERWISE STATED OR PROVIDED HEREON, SHALL BE CONSTRUCTED IN ACCORDANCE WITH CITY OF ALBUOUERQUE INTERIM STANDARD SPECIFICATIONS FOR PUBLIC WORKS CONSTRUCTION.

3. TWO WORKING DAYS PRIOR TO ANY EXCAVATION, CONTRACTOR MUST CONTACT LINE LOCATING SERVICE, 765-1234, FOR LOCATION OF EXISTING UTILITIES.

4. PRIOR TO CONSTRUCTION, THE CONTRACTOR SHALL EXCAVATE AND VERIFY THE HORIZONTAL AND VERTICAL LOCATIONS OF ALL CONSTRUCTIONS. SHOULD A CONFLICT EXIST, THE CONTRACTOR SHALL NOTIFY THE ENGINEER SO THAT THE CONFLICT CAN BE RESOLVED WITH A MINIMUM AMOUNT OF DELAY.

5. BACKFILL COMPACTION SHALL BE ACCORDING TO TRAFFIC/STREET USE. 6. MAINTENANCE OF THESE FACILITIES SHALL BE THE RESPONSIBILITY OF THE OWNER OF THE PROPERTY SERVED.

7. WORK ON ARTERIAL STREETS SHALL BE PERFORMED ON A 24-HOUR BASIS.

LEGEND — — 5100— EXISTING CONTOUR (MAJOR) BOUNDARY LINE

PROPOSED SPOT ELEVATION X 85.46 EXISTING GRADE \times 5265.16

PROPOSED RETAINING WALL

BOTTOM OF CHANEL BC = 89.08

× 5284.43

TRW=91.50 TOP OF RETAINING WALL TF=88.00 TOP OF FOOTING

HIGH POINT

EXISTING FLOWLINE ELEVATION



P.E. #11814 GRAPHIC SCALE


LAST REVISION: 12/22/2014

SCALE: 1"=10'

REZA AFAGHPOUR 10209 SNOWFLAKE CT., NW **ALBUQUERQUE, NEW MEXICO 87114** (505)899-5570

> **4 UNIT TOWNHOUSE DEVELOPMENT GRADING AND DRAINAGE PLAN**

DRAWN BY: DRAWING: DATE: SHEET# 201418-GR.DWG SH-B 12-22-2014

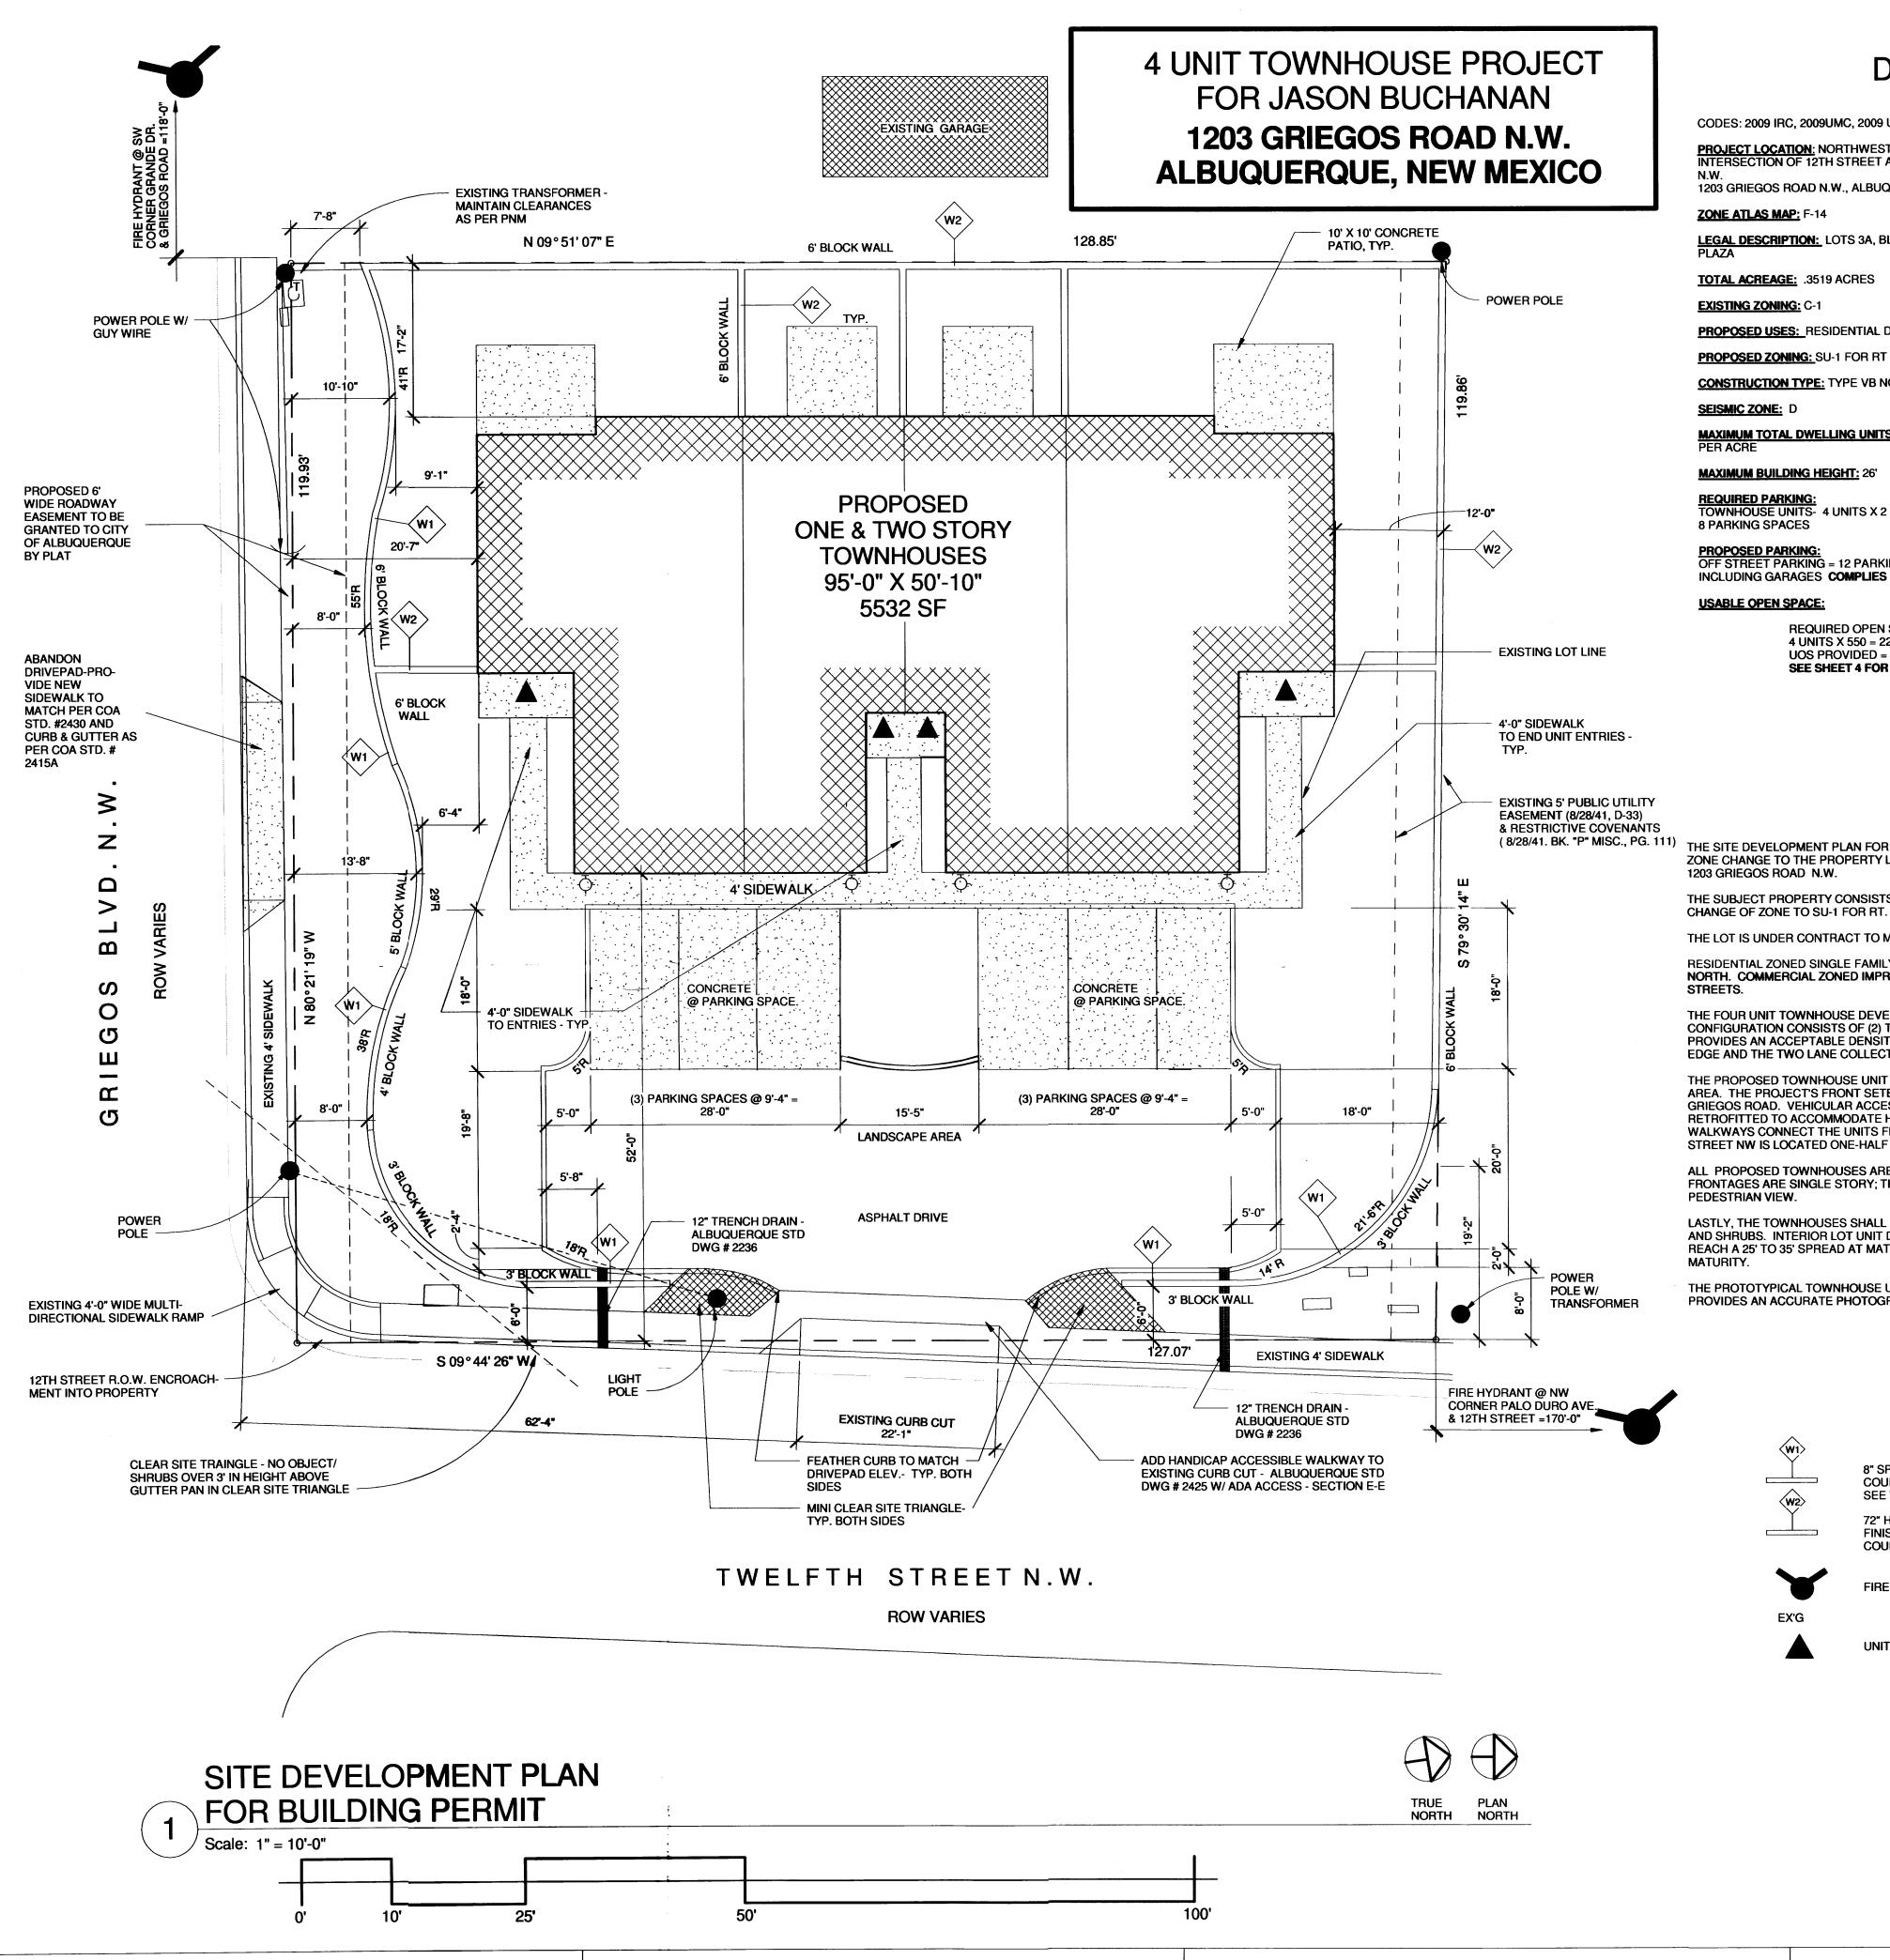

DESIGN CRITERIA

CODES: 2009 IRC, 2009UMC, 2009 UPC, 2014NEC

PROJECT LOCATION: NORTHWEST CORNER OF INTERSECTION OF 12TH STREET AND GRIEGOS ROAD

1203 GRIEGOS ROAD N.W., ALBUQUERQUE, NM

ZONE ATLAS MAP: F-14

LEGAL DESCRIPTION: LOTS 3A, BLOCK 2, SANDIA

TOTAL ACREAGE: .3519 ACRES

EXISTING ZONING: C-1

PROPOSED USES: RESIDENTIAL DWELLINGS

CONSTRUCTION TYPE: TYPE VB NON SPRINKLERED

MAXIMUM TOTAL DWELLING UNITS: 4 UNITS - 11 DU'S PER ACRE

MAXIMUM BUILDING HEIGHT: 26'

REQUIRED PARKING:
TOWNHOUSE UNITS- 4 UNITS X 2 PARKING SPACES = 8 PARKING SPACES

PROPOSED PARKING:
OFF STREET PARKING = 12 PARKING SPACES INCLUDING GARAGES COMPLIES

USABLE OPEN SPACE:

REQUIRED OPEN SPACE: 4 UNITS X 550 = 2200 SF UOS PROVIDED = 7,721 SF **COMPLIES** SEE SHEET 4 FOR UOS PLAN

LANDSCAPE CALCULATION:

SEE SHEET 4

TWO BEDROOM UNITS:

FLOOR AREA (EA. UNIT): LOWER LEVEL HEATED UPPER LEVEL HEATED
TOTAL HEATED

264 SF **GARAGE TOTAL AREA** 1557 SF

THREE BEDROOM UNITS:

FLOOR AREA (EA. UNIT): LOWER LEVEL HEATED UPPER LEVEL HEATED TOTAL HEATED

1897 SF

TOTAL AREA TOTAL BUILDING AREA:

(2) TWO BEDROOM UNITS

2 X 1293 = **2586 SF HEATED** 2 X 264 = **528 SF GARAGE**


(2) THREE BEDROOM UNITS

2 X 1473 = **2946 SF HEATED**

2 X 424 = **848 SF GARAGE**

TOTAL PROJECT HEATED = 5532 SF

TOTAL PROJECT GARAGE = 1376 SF

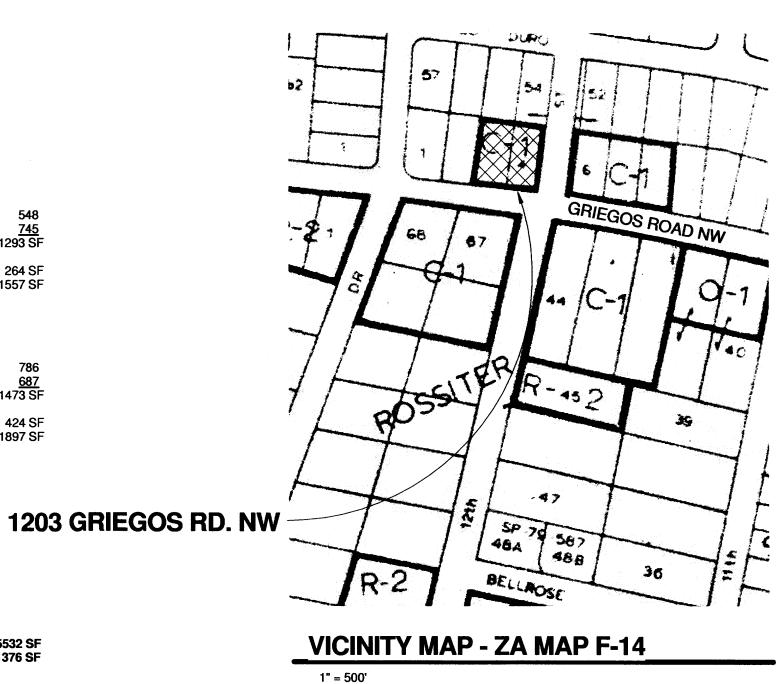

INTRODUCTION

(8/28/41. BK. "P" MISC., PG. 111) THE SITE DEVELOPMENT PLAN FOR BUILDING PERMIT SUBMITTAL SHALL SERVE AS THE OWNER'S SUBMITTAL FOR A

THE SUBJECT PROPERTY CONSISTS OF ONE REPLATTED UNIMPROVED PARCEL, ZONED C-1. WE RESPECTFULLY SEEK A

THE LOT IS UNDER CONTRACT TO MR. JASON BUCHANAN

RESIDENTIAL ZONED SINGLE FAMILY RESIDENCES FRAME THE PROPOSED DEVELOPMENT ON THE WEST AND THE NORTH, COMMERCIAL ZONED IMPROVED USES ARE LOCATED TO THE SOUTH AND THE EAST ACROSS THE ABUTTING

THE FOUR UNIT TOWNHOUSE DEVELOPMENT IS PROPOSED FOR THE LOT PARCEL. THE TWO STORY TOWNHOUSE CONFIGURATION CONSISTS OF (2) THREE BEDROOM UNITS AND (2) TWO BEDROOM UNITS. THIS CONFIGURATION PROVIDES AN ACCEPTABLE DENSITY (FAR = .35) RESIDENTIAL USE AT THE INTERFACE BETWEEN THE NEIGHBORHOOD EDGE AND THE TWO LANE COLLECTOR STREET (GRIEGOS ROAD N.W.).

THE PROPOSED TOWNHOUSE UNIT GARAGE ENTRY DRIVEWAYS ARE SITUATED OFF OF A "T" SHAPED PRIVATE PARKING AREA. THE PROJECT'S FRONT SETBACK IS LOCATED OFF OF 12TH STREET, WHICH IS A LOCAL STREET NORTH OF GRIEGOS ROAD. VEHICULAR ACCESS IS PROVIDED VIA AN EXISTING CONCRETE DRIVEWAY. THE DRIVEWAY SHALL BE RETROFITTED TO ACCOMMODATE HANDICAP ACCESS ACROSS IT'S WIDTH. FOUR FOOT WIDE INTERNAL PEDESTRIAN WALKWAYS CONNECT THE UNITS FROM NORTH TO SOUTH. THE CITY OF ALBUQUERQUE BUS TRANSIT ROUTE ON 4TH STREET NW IS LOCATED ONE-HALF MILE FROM THE SITE; WELL WITHIN REACH VIA BICYCLE.

ALL PROPOSED TOWNHOUSES ARE TWO STORY WITH SINGLE STORY FEATURES. ALL VEHICULAR PARKING FRONTAGES ARE SINGLE STORY; THUS, A MORE GRADUAL BUILDING ELEVATION TRANSITION IS ACHIEVED FROM THE

LASTLY, THE TOWNHOUSES SHALL BE SET OFF FROM THE STREET FRONTAGES BY MEANDERING YARD WALLS, TREES AND SHRUBS. INTERIOR LOT UNIT DRIVEWAYS WILL BE SEPARATED BY LANDSCAPE AREAS WITH TREES. THREES SHALL REACH A 25' TO 35' SPREAD AT MATURITY. TREES ATOVERHEAD POWER LINES SHALL NOT EXCEED 25' IN HEIGHT AT

THE PROTOTYPICAL TOWNHOUSE UNIT PHOTO IS ATTACHED ON SHEET 5. THE TENTH AND CANDELARIA NW PROJECT PROVIDES AN ACCURATE PHOTOGRAPHIC RENDERING FOR BUILDING MASSING REFERENCE.

PROJECT NUMBER: #1010182

APPLICATION NUMBERS: SDP FOR BP: #15DRB-70024

Is an Infrastructure List required? () Yes () No If Yes, then a set of approved DRC plans with a work order is required for any construction within Public Right-of-Way or for construction of public


DRB SITE DEVELOPMENT PLAN APPROVAL:

Traffic Engineer, Transportation Division Date **Utilities Development** Date Parks & Recreation Department **Date** City Engineer Date * Environmental Health Department (conditional)

Solid Waste Management

DRB Chairperson, Planning Department

SITE PLAN LEGEND

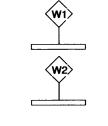


COURTYARD WALL-SEE WALL FOR HEIGHT 72" HIGH 8" UN-FINISHED CMU **COURTYARD WALL**

8" SPLIT FACE CMU



UNIT ENTRY

FIRE HYDRANT

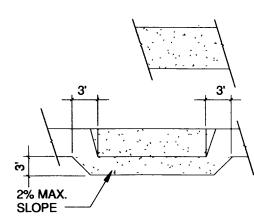

NEW CONCRETE SIDEWALK -NEW CONCRETE SITE WORK

DRIVEPAD - COA STANDARD DETAIL DWG 2425 - SECTION E-E - ADA ACCESSIBLE. SEE SITE PLAN FOR WIDTH

HOODED DUSK TO DAWN EXTERIOR WALL MOUNTED LIGHTING - SEE DETAIL

SHEET LIST

Sheet


Number **Sheet Name**

SITE DEVELOPMENT PLAN FOR BUILDING PERMIT SITE DRAINAGE & GRADING PLAN SITE UTILITY PLAN SITE LANDSCAPE PLAN **ELEVATIONS & DETAILS**

Roger Cinelli & Assoc. 2418 Manuel Torres Lane N.W. Albuquerque, New Mexico 87107 ARCHITECTS (505) 243-8211

4 UNIT TOWNHOUSE DEV. FOR JASON BUCHANAN 1203 GRIEGOS ROAD N.W. ALBUQUERQUE, NEW MEXICO

SITE DEVELOPMENT PLAN FOR **BUILDING PERMIT**

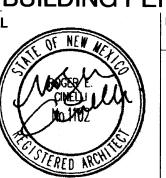

2/12/15


PROJECT NO. FEB. 12, 2015 **BUCH 6E** DRAWING NO.

Date

Date


Date


EXISTING GARAGE

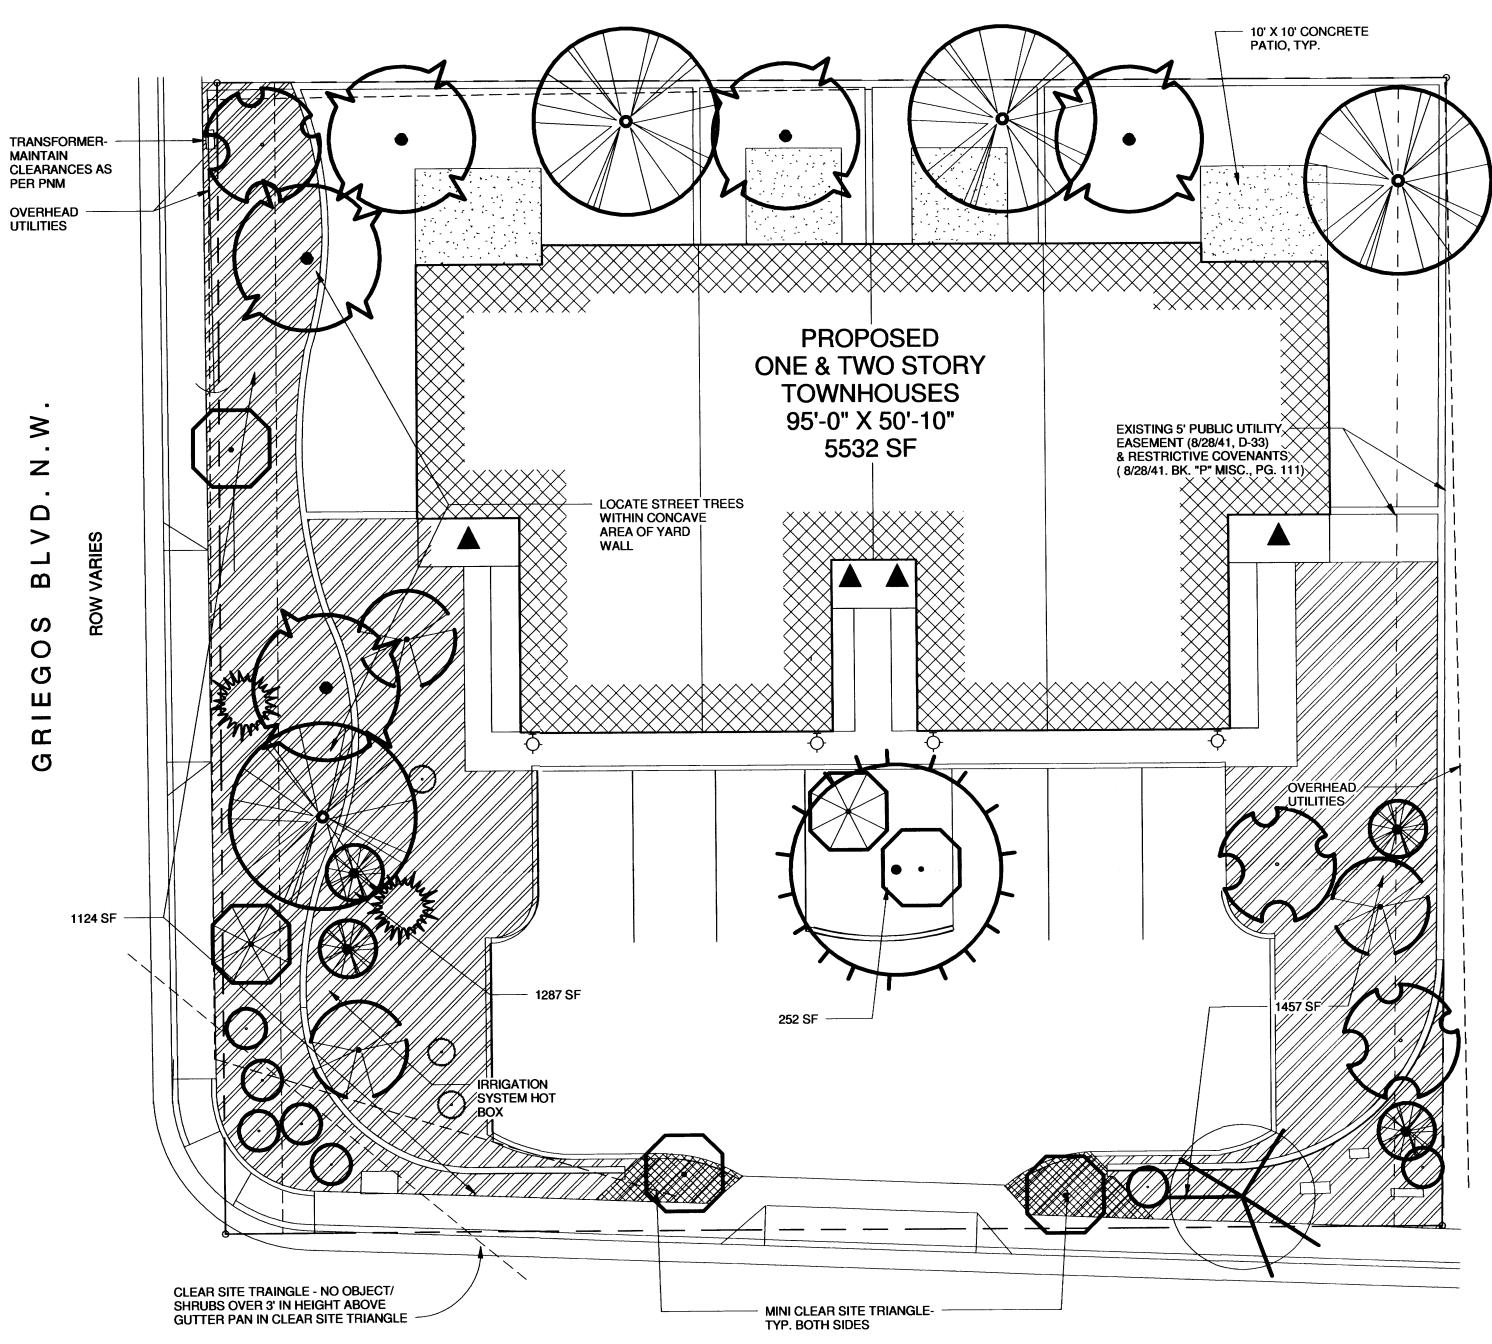


TWELFTH STREET N.W.

ROW VARIES

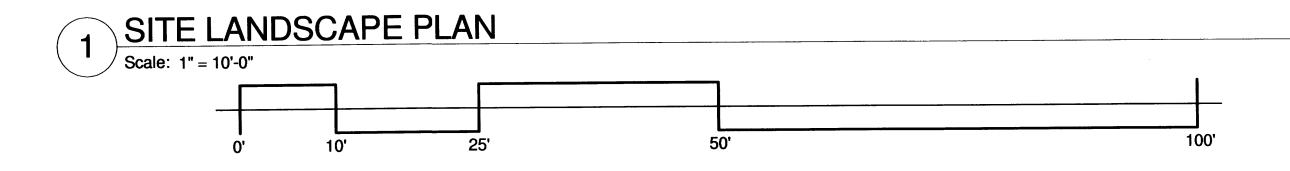

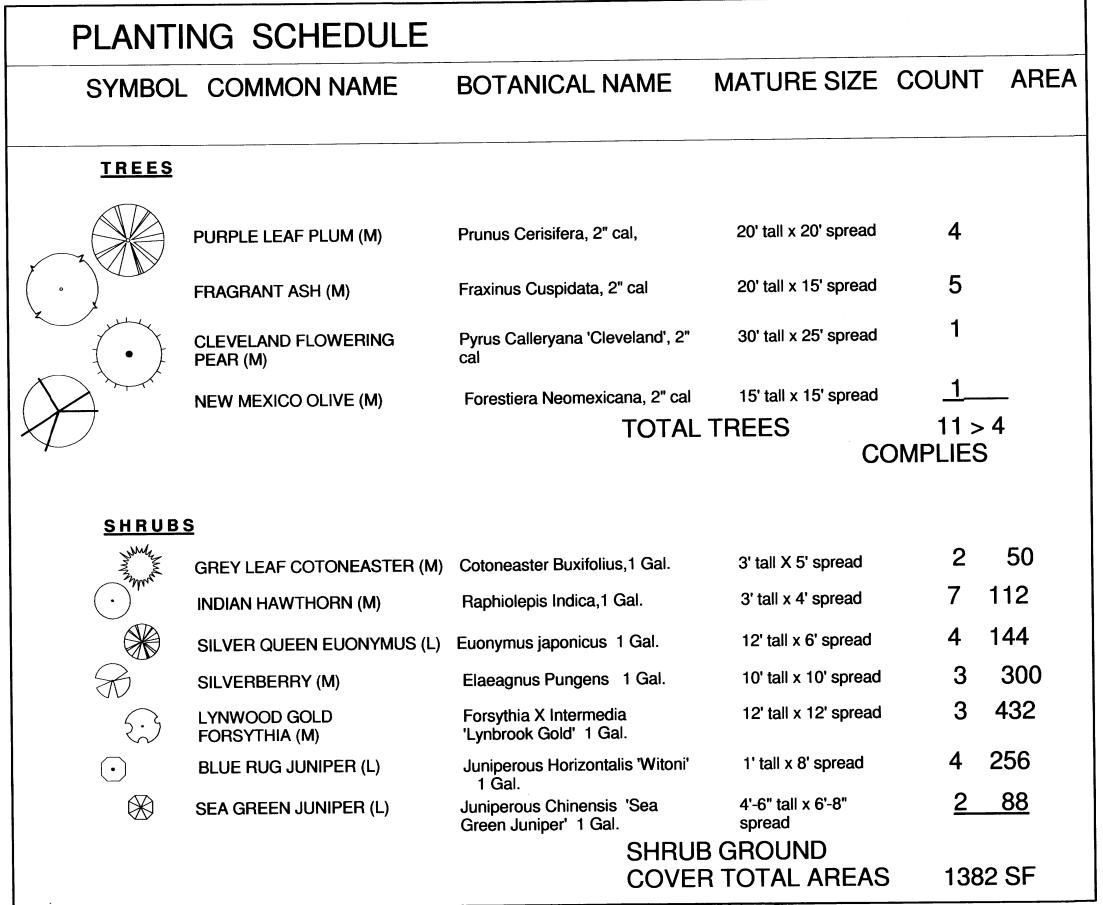

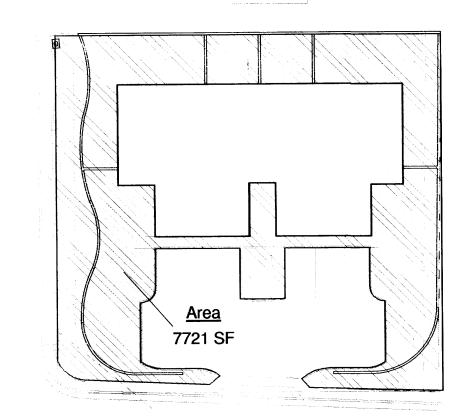

USABLE OPEN SPACE -1203 GRIEGOS RD. NW

OPEN SPACE

HOT BOX INSULATED BACKFLOW DEVICE ENCLOSURE

USABLE OPEN SPACE: REQUIRED OPEN SPACE: 4 UNITS X 550 = 2,200 SF UOS PROVIDED = 7721 SF **COMPLIES**

BACKFLOW PREVENTION DETAIL



LANDSCAPE CALCULATION:

LOT: .3519A X 43560 = 15,329 SF (BUILDINGS: NET LOT AREA 11,232 SF REQUIRED LANDSCAPING: 11,232 X 15% = 1685 SF

LANDSCAPING (HATCHED, EXCLUSIVE OF REAR YARDSPROVIDED: 4120 SF COMPLIES

REQUIRED 75% VEGETATIVE GROUND COVER = .75 X 1685 SF = 1264 SF VEGETATIVE GROUND COVER PROVIDED: 1382 SF COMPLIES

PLANT WATERING SHALL BE PROVIDED BY A DRIP IRRIGATION SYSTEM. CONTROLLERS SHALL BE PROVIDED IN THE NUMBER AND SPACING REQUIRED BY ZONE SPECIFICATION AND LOCATION. CONTROLLERS SHALL BE INSTALLED ON OWNERS HOUSE ELECTRICAL

ALL LANDSCAPING, INCLUDING LANDSCAPING IN THE RIGHT OF WAY, SHALL BE MAINTAINED AND REPLACED, IF NECESSARY, BY THE OWNER. LANDSCAPING AND SIGNING SHALL NOT INTERFERE WITH CLEAR SITE REQUIREMENTS, THEREFORE SIGNS, TREES AND SHRUBS BETWEEN 3' AND 8' TALL (AS MEASURED FROM THE GUTTER PAN) SHALL NOT BE


THE PROJECT SHALL COMPLY WITH THE "WATER CON-SERVATION AND WATER WASTE ORDINANCE" - ARTICLE


THE PROJECT SHALL COMPLY WITH THE CITY OF ALBUQUERQUE ZONING ORDINANCE - 14-16-3-10, GENERAL LANDSCAPE REGULATIONS

HATCH LEGEND

4" CONCRETE SIDEWALK, DRIVEWAY AND COMMONS AREA SLABS



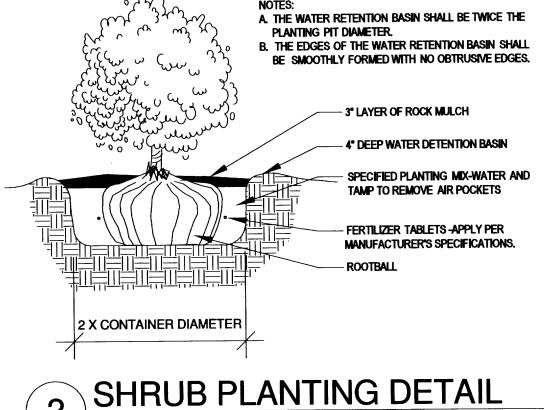

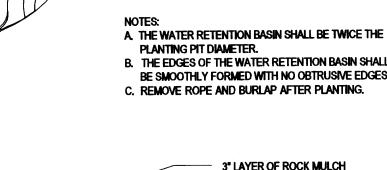

3" LAYER OF ROCK MULCH ORIGINAL GRADE OF SLOPE SPECIFIED PLANTING MIX -WATER & TAMP TO REMOVE AIR POCKETS FERTILIZER TABLETS AND H20 POLYMER CRYSTALS AS REQUIRED BY MIFGR


TREE PLANTING WELL

/ Scale: 1 1/2" = 1'-0"

Roger Cinelli & Assoc. 2418 Manuel Torres Lane N.W. Albuquerque, New Mexico 87107 **ARCHITECTS** (505) 243-8211


4 UNIT TOWNHOUSE DEV. FOR JASON BUCHANAN 1203 GRIEGOS ROAD N.W. ALBUQUERQUE, NEW MEXICO

DRAWING TITLE: SITE LANDSCAPE PLAN

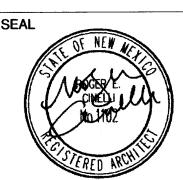

PROJECT NO. FEB. 12, 2015 BUCH 6E DRAWING NO.

GRAVEL AREAS @ UNIT ENTRY ALCOVES ARE NOT INCLUDED IN PROPOSED LANDSCAPE AREAS

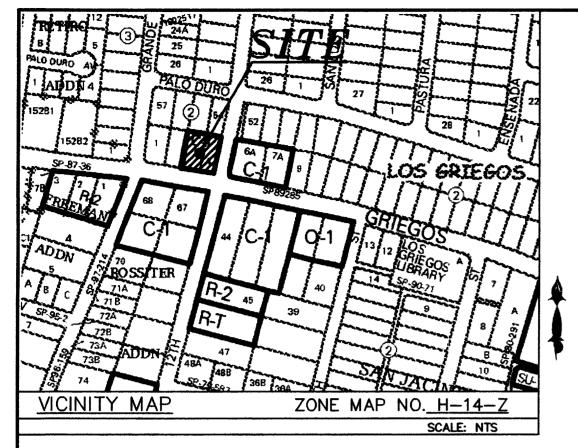

DISCLOSURE STATEMENT:

THE PURPOSE OF THIS PLAT IS TO SUBDIVIDE TWO LOTS INTO ONE LOT, AND GRANT ANY EASEMENTS AS SHOWN.

GENERAL NOTES:

- 1: UNLESS NOTED, NO.4 REBAR WITH CAP STAMPED P.S. #9801 WERE SET AT ALL PROPERTY CORNERS.
- 2: THIS PLAT SHOWS ALL EASEMENTS OF RECORD.
- 3: BEARINGS ARE NEW MEXICO STATE PLANE GRID BEARINGS, CENTRAL ZONE, NAD 1983, AND ARE BASED ON ALBUQUERQUE CONTROL MONUMENT DOUGLAS.
- 4: BEARINGS ARE GRID, DISTANCES ARE GROUND.
- 5: SITE DATA: ZONING IS C-1.
- 6: NUMBER OF EXISTING TRACTS/LOTS......2 LOT
- 7: NUMBER OF TRACTS/LOTS CREATED...... 1 LOTS
- 8: NO PROPERTY WITHIN THE AREA OF REQUESTED FINAL ACTION SHALL AT ANY TIME BE SUBJECT TO DEED RESTRICTION, COVENANT, OR BINDING AGREEMENT PROHIBITING SOLAR COLLECTORS FROM BEING INSTALLED ON BUILDINGS OR ERECTED ON THE LOTS OR PARCELS WITHIN THE AREA OF PROPOSED PLAT. THE FOREGOING REQUIREMENT SHALL BE A CONDITION TO APPROVAL OF THIS PLAT OR SITE DEVELOPMENT PLAN FOR SUBDIVISION.

LEGAL DESCRIPTION:

LOTS NUMBERED THREE (3) AND FOUR (4), IN BLOCK NUMBERED TWO (2) OF SANDIA PLAZA, A SUBDIVISION OF A TRACT OF LAND IN SCHOOL DISTRICT NO. 22, IN BERNALILLO COUNTY, NEW MEXICO, AS THE SAME IS SHOWN AND DESIGNATED ON THE PLAT OF SAID ADDITION FILED IN THE OFFICE OF THE COUNTY CLERK OF BERNALILLO COUNTY, NEW MEXICO ON AUGUST 28, 1941, IN BOOK D, PAGE 33. CONTAINING 0.3519 ACRE (15,329.81 SF) MORE OR LESS.

PROJECT: 1010182 DATE: 1-28-15 APP:

FREE CONSENT

THE SUBDIVISION HEREON DESCRIBED IS WITH THE FREE CONSENT IN ACCORDANCE WITH THE DESIRES OF THE UNDERSIGNED OWNERS AND PROPRIETOR THEREOF. SAID OWNER(S) AND/OR PROPRIETOR(S) WARRANT THAT THEY HOLD AMONG THEM COMPLETE AND INDEFEASIBLE TITLE IN FEE SIMPLE TO THE LAND SUBDIVIDED. SAID OWNER(S) / PROPRIETOR(S) DO HEREBY DEDICATE PUBLIC RIGHT—OF—WAY SHOWN HEREON (323.58 SF., 0.0074 AC.) TO THE CITY OF ALBUQUERQUE IN FEE SIMPLE WITH WARRANTY COVENANTS AND DO HEREBY GRANT ANY AND ALL EASEMENTS AS MAY BE CREATED BY THIS PLAT.

OWNER(S) PRINT NAME: NANCY JO AFCHER, PRESIDENT FOR HOGARES, INC.

ACKNOWLEDGMENT

STATE OF NEW MEXICO)
COUNTY OF BERNALILLO)
S.S.

THIS INSTRUMENT WAS ACKNOWLEDGED BEFORE ME THIS 14th DAY OF JANUARY,

20_15_, BY___NANCY JO ARCHER, PRESIDENT FOR HOGARES, INC.



PLAT OF LOT 3-A, BLOCK 2 SANDIA PLAZA

TOWN OF ALBUQUERQUE GRANT
PROJECTED SECTION 32, T. 11 N., R. 3 E., N.M.P.M.
CITY OF ALBUQUERQUE
BERNALILLO COUNTY, NEW MEXICO
JANUARY, 2015

PROJECT NO. 1011082

DA
DA
DA
DA
1/20/

SURVEYORS CERTIFICATE:

DRB CHAIRPERSON, PLANNING DEPARTMENT

TRAFFIC ENGINEERING, TRANSPORTATION DIVISION

ALBUQUERQUE METROPOLITAN ARROYO FLOOD CONTROL AUTHORITY

PARKS AND RECREATION DEPARTMENT

ABCWUA

CITY ENGINEER

I, LEONARD MARTINEZ, A DULY PROFESSIONAL LICENSED LAND SURVEYOR, UNDER THE LAWS OF THE STATE OF NEW MEXICO, DO HEREBY CERTIFY THAT THE PLAT WAS PREPARED UNDER MY DIRECT SUPERVISION AND MEETS THE REQUIREMENTS FOR MONUMENTATION AND SURVEY OF THE ALBUQUERQUE SUBDIVISION ORDINANCE AND ALSO MEETS THE MINIMUM STANDARDS FOR LAND SURVEYS IN NEW MEXICO AS ADOPTED BY THE NEW MEXICO STATE BOARD OF LICENSURE FOR PROFESSIONAL ENGINEERS AND LAND SURVEYORS AND IS TRUE AND CORRECT TO THE BEST OF MY KNOWLEDGE AND BELIEF.



01-14-2015 DATE

DATE

DATE

DATE

DATE

DATE

DATE

SBS CONSTRUCTION AND ENGINEERING, LLC

10209 SNOWFLAKE CT., NW ALBUQUERQUE, NEW MEXICO 87114 (505)804-5013

SHEET 1 OF 2

THIS	s is to	CERTIFY	THAT	TAXES	ARE	CURRENT	AND	PAID	ON
UPO	#								
PRO	PERTY	OWNER C	F REC	ORD:					
BER	RNALILLO	CO. TRE	ASURI	er's of	FICE:				

EASEMENTS:


DISCLAIMER


PLAT.

1 EXISTING 5' PUBLIC UTILITY EASEMENT (8/28/41, D-33) & RESTRICTIVE COVENANTS (8/28/41, BK. "P" MISC., PG. 111)

PLAT OF LOT 3-A, BLOCK 2 SANDIA PLAZA

TOWN OF ALBUQUERQUE GRANT PROJECTED SECTION 32, T. 11 N., R. 3 E., N.M.P.M. CITY OF ALBUQUERQUE BERNALILLO COUNTY, NEW MEXICO JANUARY, 2015

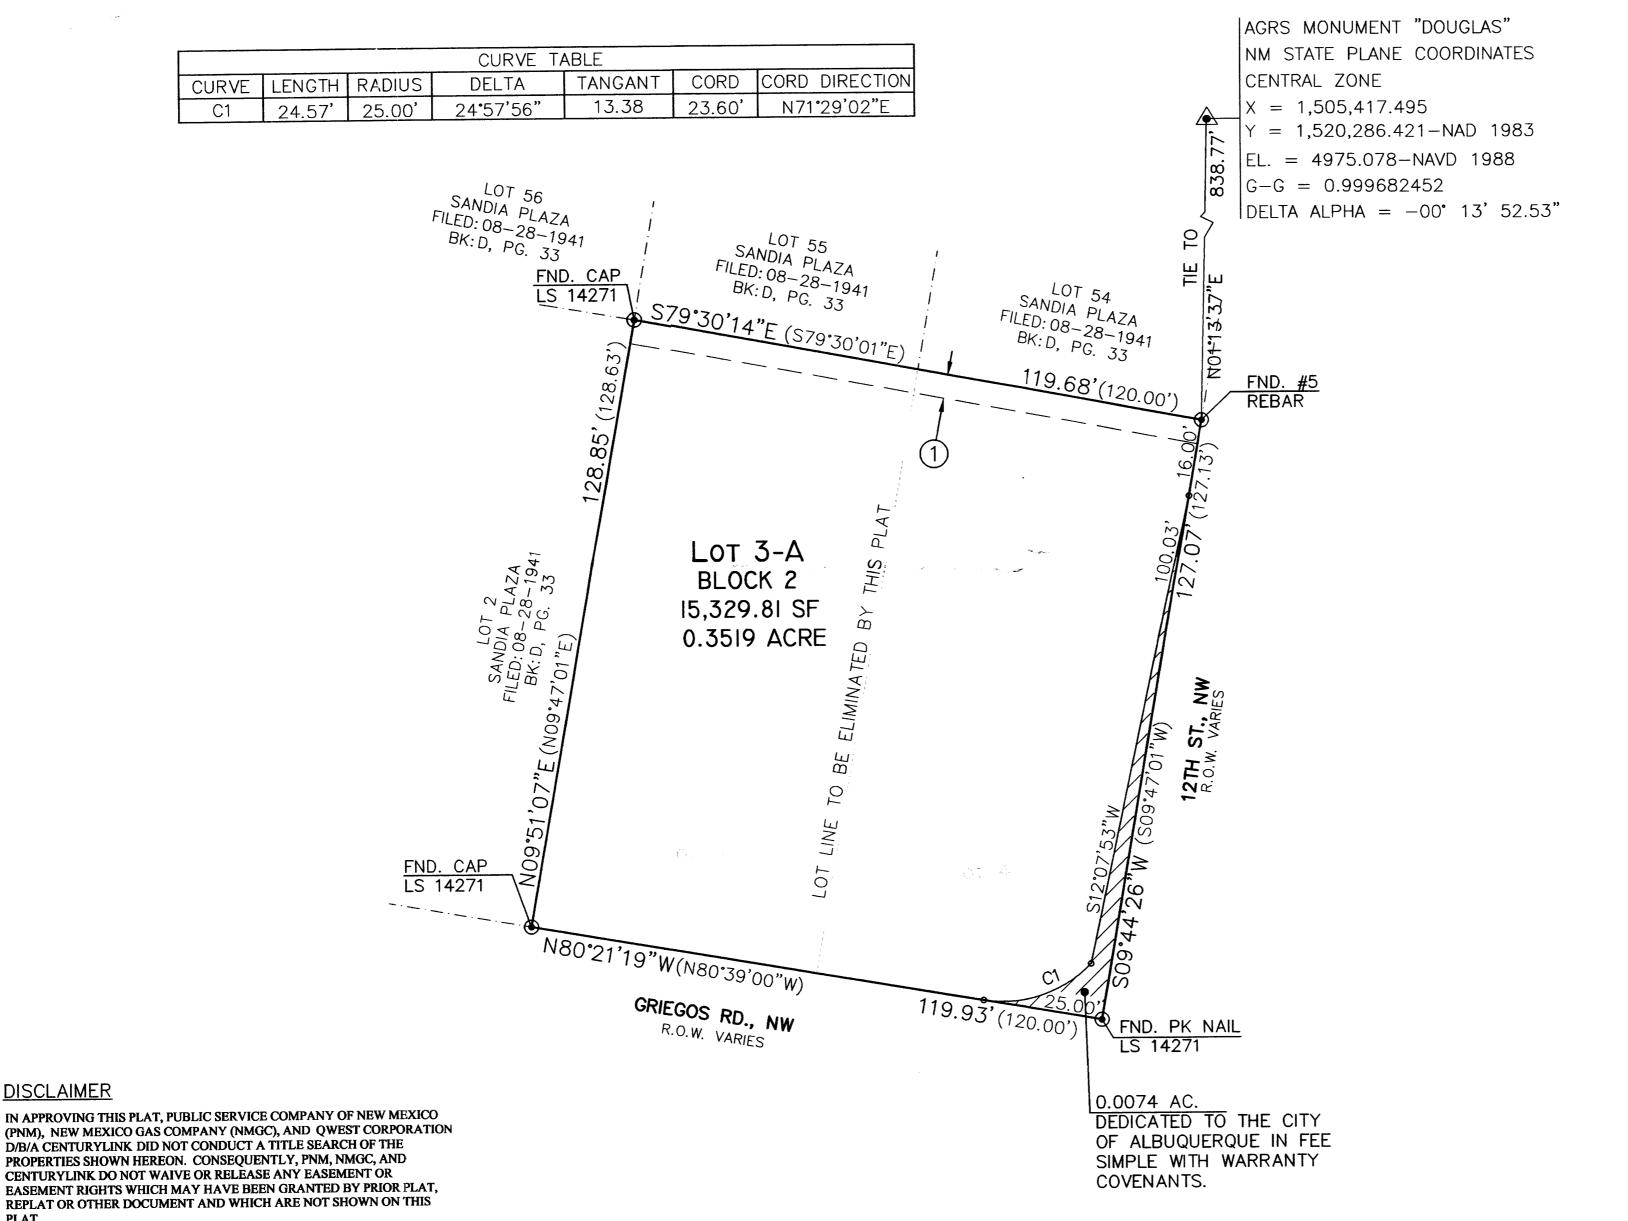

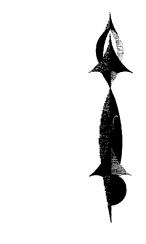

GRAPHIC SCALE



SBS CONSTRUCTION AND ENGINEERING, LLC

P. O. BOX 10264 ALBUQUERQUE, NEW MEXICO 87184 (505)899-5570

SHEET 2 OF 2 DRAWING: 201302-PLAT | DRAWN BY: SHH | DATE: 05-14-2013

3F-96.2 72A R- 72B 73A ADDN € 48A 8 74 \$£.28	52 28 1 27 1 6A 7A 8 CC-
VICINITY MAP	ZONE MAP NO. H-14-Z
	SCALE: NTS

DISCLOSURE STATEMENT:

THE PURPOSE OF THIS PLAT IS TO SUBDIVIDE TWO LOTS INTO ONE LOT, AND GRANT ANY EASEMENTS AS SHOWN.

GENERAL NOTES:

- 1: UNLESS NOTED, NO.4 REBAR WITH CAP STAMPED P.S. #9801 WERE SET AT ALL PROPERTY CORNERS.
- 2: THIS PLAT SHOWS ALL EASEMENTS OF RECORD.
- 3: BEARINGS ARE NEW MEXICO STATE PLANE GRID BEARINGS, CENTRAL ZONE, NAD 1983, AND ARE BASED ON ALBUQUERQUE CONTROL MONUMENT DOUGLAS.
- 4: BEARINGS ARE GRID, DISTANCES ARE GROUND.
- 5: SITE DATA: ZONING IS C-1.
- 6: NUMBER OF EXISTING TRACTS/LOTS.....2 LOT
- 7: NUMBER OF TRACTS/LOTS CREATED...... 1 LOTS
- 8: NO PROPERTY WITHIN THE AREA OF REQUESTED FINAL ACTION SHALL AT ANY TIME BE SUBJECT TO DEED RESTRICTION, COVENANT, OR BINDING AGREEMENT PROHIBITING SOLAR COLLECTORS FROM BEING INSTALLED ON BUILDINGS OR ERECTED ON THE LOTS OR PARCELS WITHIN THE AREA OF PROPOSED PLAT. THE FOREGOING REQUIREMENT SHALL BE A CONDITION TO APPROVAL OF THIS PLAT OR SITE DEVELOPMENT PLAN FOR SUBDIVISION.

LEGAL DESCRIPTION:

LOTS NUMBERED THREE (3) AND FOUR (4), IN BLOCK NUMBERED TWO (2) OF SANDIA PLAZA, A SUBDIVISION OF A TRACT OF LAND IN SCHOOL DISTRICT NO. 22, IN BERNALILLO COUNTY, NEW MEXICO, AS THE SAME IS SHOWN AND DESIGNATED ON THE PLAT OF SAID ADDITION FILED IN THE OFFICE OF THE COUNTY CLERK OF BERNALILLO COUNTY, NEW MEXICO ON AUGUST 28, 1941, IN BOOK D, PAGE 33. CONTAINING 0.3519 ACRE (15,329.81 SF) MORE OR LESS.

FREE CONSENT

OWNER(S) SIGNATURE:_

THE SUBDIVISION HEREON DESCRIBED IS WITH THE FREE CONSENT IN ACCORDANCE WITH THE DESIRES OF THE UNDERSIGNED OWNERS AND PROPRIETOR THEREOF. SAID OWNER(S) AND/OR PROPRIETOR(S) WARRANT THAT THEY HOLD AMONG THEM COMPLETE AND INDEFEASIBLE TITLE IN FEE SIMPLE TO THE LAND SUBDIVIDED. SAID OWNER(S) / PROPRIETOR(S) DO HEREBY DEDICATE PUBLIC RIGHT—OF—WAY SHOWN HEREON (323.58 SF., 0.0074 AC.) TO THE CITY OF ALBUQUERQUE IN FEE SIMPLE WITH WARRANTY COVENANTS AND DO HEREBY GRANT ANY AND ALL EASEMENTS AS MAY BE CREATED BY THIS PLAT.

OWNER(S) PRINT NAME: NANCY JO ARCHER, PRESIDENT FOR HOGARES, INC.

ACKNOWLEDGMENT

_DATE: <u>01-14-2015</u>

STATE OF NEW MEXICO) S.S.

	MY	COMMISSION	EXPIRES:
NOTARY			

THIS	IS	то	CERTIF	Y TH	٩T	TAXES	ARE	CURRENT	AND	PAID	C
UPC	#										_
PROF	PER	TY	OWNER	OF R	EC	ORD:					
BERN	IAL	ILLO	CO. T	REASI	JRE	R'S OF	FICE:				


PLAT OF LOT 3-A, BLOCK 2 SANDIA PLAZA

TOWN OF ALBUQUERQUE GRANT
PROJECTED SECTION 32, T. 11 N., R. 3 E., N.M.P.M.
CITY OF ALBUQUERQUE
BERNALILLO COUNTY, NEW MEXICO
JANUARY, 2015

PROJECT NO. <u>1011082</u>	
APPLICATION NO	
UTILITY APPROVALS:	
PNM ELECTRIC SERVICES	DATE
NEW MEXICO GAS COMPANY	DATE
QWEST CORPORATION D/B/A CENTURYLINK QC	DATE
COMCAST CABLE COMMUNICATION, INC.	DATE
APPROVALS:	
CITY SURVEYOR	DATE
TRAFFIC ENGINEERING, TRANSPORTATION DIVISION	DATE
ABCWUA	DATE
PARKS AND RECREATION DEPARTMENT	DATE
ALBUQUERQUE METROPOLITAN ARROYO FLOOD CONTROL AUTHORITY	DATE
CITY ENGINEER	DATE
DRB CHAIRPERSON, PLANNING DEPARTMENT	DATE

SURVEYORS CERTIFICATE

I, LEONARD MARTINEZ, A DULY PROFESSIONAL LICENSED LAND SURVEYOR, UNDER THE LAWS OF THE STATE OF NEW MEXICO, DO HEREBY CERTIFY THAT THE PLAT WAS PREPARED UNDER MY DIRECT SUPERVISION AND MEETS THE REQUIREMENTS FOR MONUMENTATION AND SURVEY OF THE ALBUQUERQUE SUBDIVISION ORDINANCE AND ALSO MEETS THE MINIMUM STANDARDS FOR LAND SURVEYS IN NEW MEXICO AS ADOPTED BY THE NEW MEXICO STATE BOARD OF LICENSURE FOR PROFESSIONAL ENGINEERS AND LAND SURVEYORS AND IS TRUE AND CORRECT TO THE BEST OF MY KNOWLEDGE AND BELIEF.

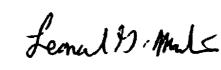

LEONARD MARTINEZ P.S. # 9801

01-14-2015 DATE

SBS CONSTRUCTION AND ENGINEERING, LLC

10209 SNOWFLAKE CT., NW ALBUQUERQUE, NEW MEXICO 87114 (505)804-5013


SHEET 1 OF 2

EASEMENTS:

- EXISTING 5' PUBLIC UTILITY EASEMENT (8/28/41, D-33) & RESTRICTIVE COVENANTS (8/28/41, BK. "P" MISC., PG. 111)
- 5' PUBLIC UTILITY EASEMENT GRANTED BY THIS PLAT.
- 6' ROAD WAY EASEMENT GRANTED TO CITY OF ALBUQUERQUE

PLAT OF LOT 3-A, BLOCK 2 SANDIA PLAZA

TOWN OF ALBUQUERQUE GRANT PROJECTED SECTION 32, T. 11 N., R. 3 E., N.M.P.M. CITY OF ALBUQUERQUE BERNALILLO COUNTY, NEW MEXICO JANUARY, 2015

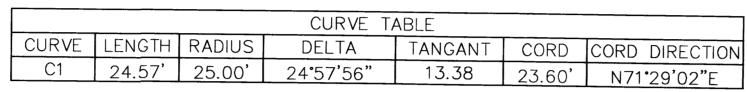

PUBLIC UTILITY EASEMENTS

PUBLIC UTILITY EASEMENTS SHOWN ON THIS PLAT ARE GRANTED FOR THE COMMON AND JOINT USE OF: A. PUBLIC SERVICE COMPANY OF NEW MEXICO ("PNM"), A NEW MEXICO CORPORATION, (PNM ELECTRIC) FOR INSTALLATION, MAINTENANCE, AND SERVICE OF OVERHEAD AND UNDERGROUND ELECTRICAL LINES, TRANSFORMERS, AND OTHER EQUIPMENT AND RELATED FACILITIES REASONABLY NECESSARY TO PROVIDE **ELECTRICAL SERVICES.**


B. <u>NEW MEXICO GAS COMPANY</u> FOR INSTALLATION, MAINTENANCE, AND SERVICE OF NATURAL GAS LINES, VALVES AND OTHER EQUIPMENT AND FACILITIES REASONABLY NECESSARY TO PROVIDE NATURAL GAS

C. QWEST FOR THE INSTALLATION, MAINTENANCE, AND SERVICE OF SUCH LINES, CABLE, AND OTHER RELATED EQUIPMENT AND FACILITIES REASONABLY NECESSARY TO PROVIDE COMMUNICATION SERVICES. D. CABLE TV FOR THE INSTALLATION, MAINTENANCE, AND SERVICE OF SUCH LINES, CABLE, AND OTHER RELATED EQUIPMENT AND FACILITIES REASONABLY NECESSARY TO PROVIDE CABLE SERVICES.


INCLUDED, IS THE RIGHT TO BUILD, REBUILD, CONSTRUCT, RECONSTRUCT, LOCATE, RELOCATE, CHANGE, REMOVE, REPLACE, MODIFY, RENEW, OPERATE AND MAINTAIN FACILITIES FOR PURPOSES DESCRIBED ABOVE TOGETHER WITH FREE ACCESS TO, FROM, AND OVER SAID EASEMENTS, WITH THE RIGHT AND PRIVILEGE OF GOING UPON, OVER AND ACROSS ADJOINING LANDS OF GRANTOR FOR THE PURPOSES SET FORTH HEREIN AND WITH THE RIGHT TO UTILIZE THE RIGHT OF WAY AND EASEMENT TO EXTEND SERVICES TO CUSTOMERS OF GRANTEE, INCLUDING SUFFICIENT WORKING AREA SPACE FOR ELECTRIC TRANSFORMERS, WITH THE RIGHT AND PRIVILEGE TO TRIM AND REMOVE TREES, SHRUBS OR BUSHES WHICH INTERFERE WITH THE PURPOSES SET FORTH HEREIN. NO BUILDING, SIGN, POOL (ABOVEGROUND OR SUBSURFACE), HOT TUB, CONCRETE OR WOOD POOL DECKING, OR OTHER STRUCTURE SHALL BE ERECTED OR CONSTRUCTED ON SAID EASEMENTS, NOR SHALL ANY WELL BE DRILLED OR OPERATED THEREON. PROPERTY OWNERS SHALL BE SOLELY RESPONSIBLE FOR CORRECTING ANY VIOLATIONS OF NATIONAL ELECTRICAL SAFETY CODE BY CONSTRUCTION OF POOLS, DECKING, OR ANY STRUCTURES ADJACENT TO OR NEAR EASEMENTS SHOWN ON

EASEMENTS FOR ELECTRIC TRANSFORMER/SWITCHGEARS, AS INSTALLED, SHALL EXTEND TEN (10) FEET IN FRONT OF TRANSFORMER/SWITCHGEAR DOORS AND FIVE (5) FEET ON EACH SIDE. DISCLAIMER

IN APPROVING THIS PLAT, PUBLIC SERVICE COMPANY OF NEW MEXICO (PNM) AND NEW MEXICO GAS COMPANY (NMGC) DID NOT CONDUCT A TITLE SEARCH OF THE PROPERTIES SHOWN HEREON. CONSEQUENTLY, PNM AND NMGC DO NOT WAIVE OR RELEASE ANY EASEMENT OR EASEMENT RIGHTS WHICH MAY HAVE BEEN GRANTED BY PRIOR PLAT, REPLAT OR OTHER DOCUMENT AND WHICH ARE NOT SHOWN ON THIS PLAT

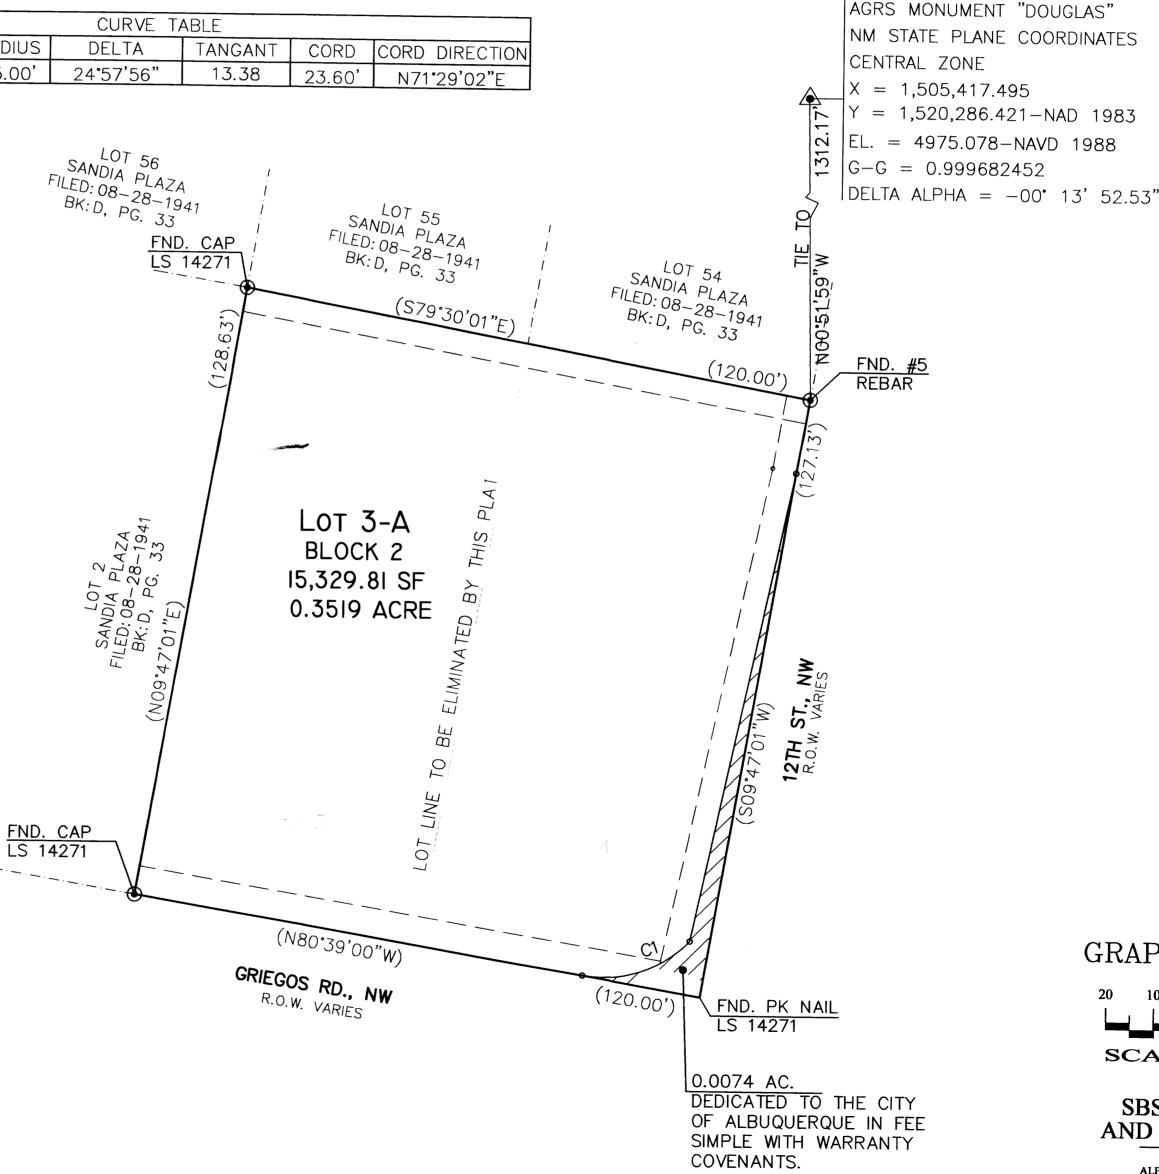

GRAPHIC SCALE

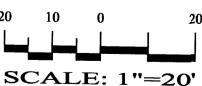


SBS CONSTRUCTION AND ENGINEERING, LLC

P. O. BOX 10264 ALBUQUERQUE, NEW MEXICO 87184 (505)899-5570

DRAWING: 201418-PLAT | DRAWN BY: SHH | DATE: 02-03-201:

SHEET 2 OF 2

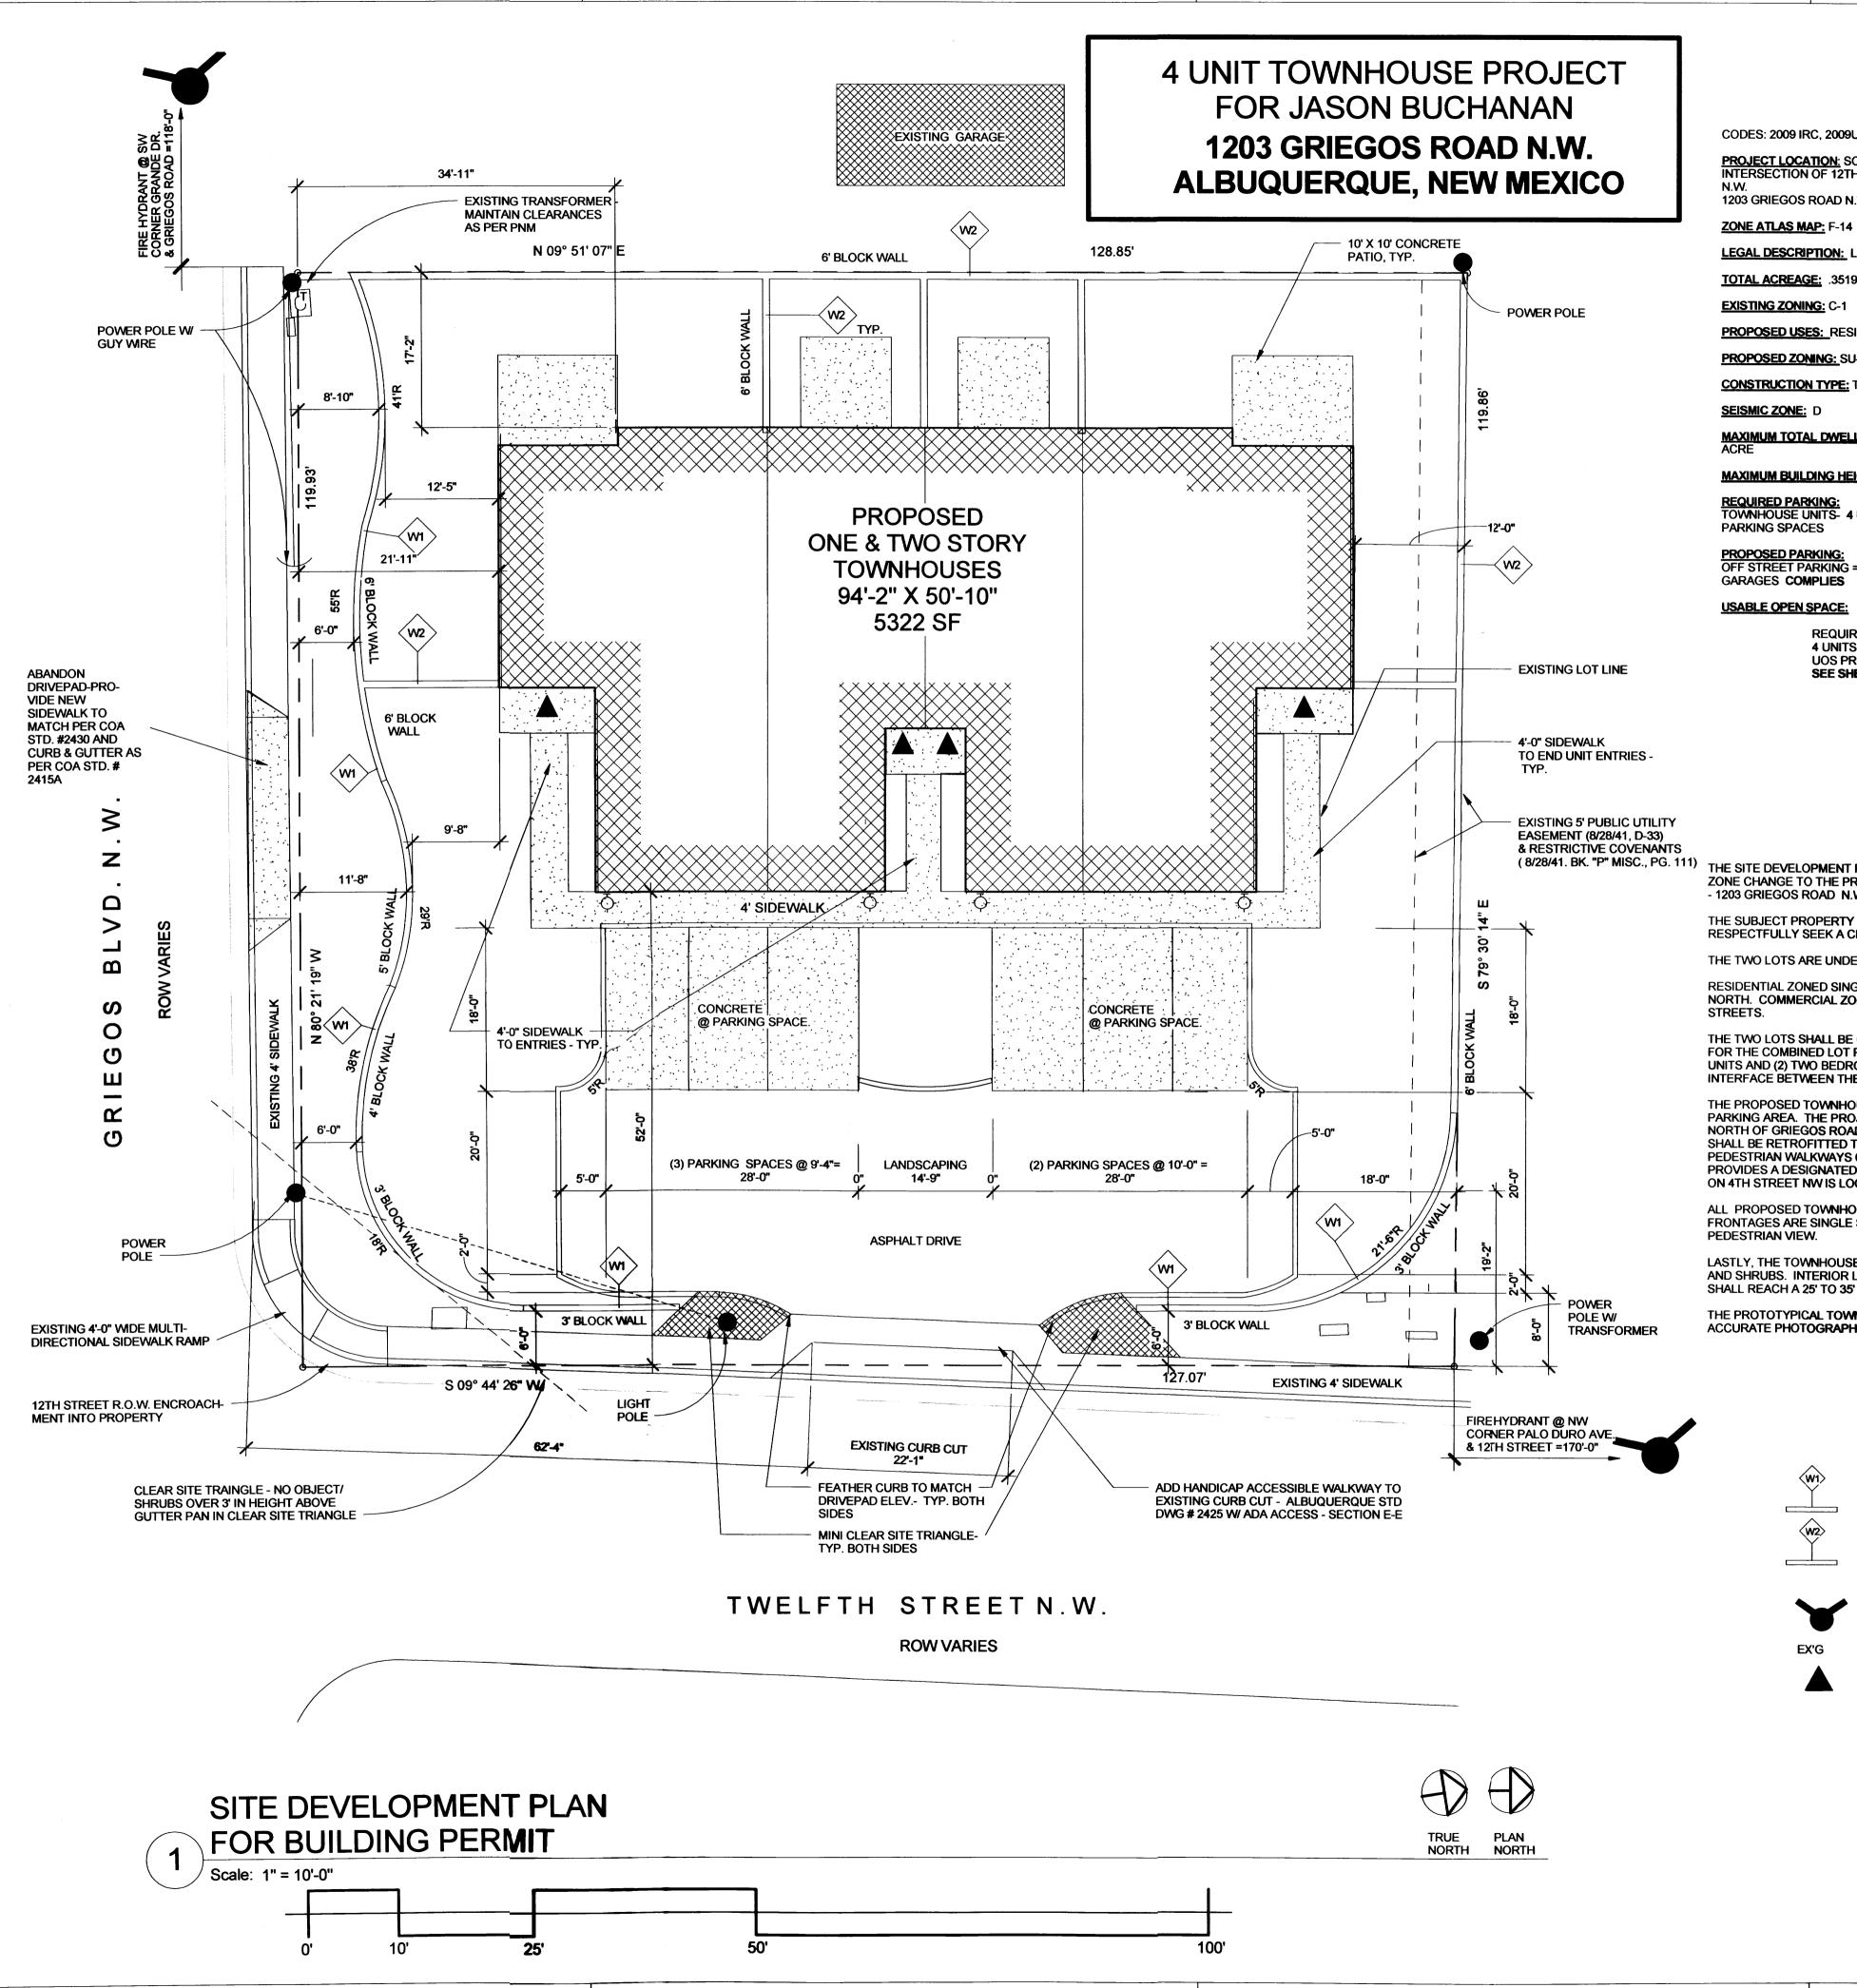

DESIGN CRITERIA

CODES: 2009 IRC, 2009 UMC, 2009 UPC, 2014NEC

<u>PROJECT LOCATION:</u> SOUTHEAST CORNEOF INTERSECTION OF 12TH STREET AND GRIEGOS ROAD

1203 GRIEGOS ROAD N.W., ALBUQUERQUE, NM

LEGAL DESCRIPTION: LOTS 3A, BLOCK 2, SANDIA PLAZA

TOTAL ACREAGE: .3519 ACRES

PROPOSED USES: RESIDENTIAL DWELLINGS

PROPOSED ZONING: SU-1 FOR RT

CONSTRUCTION TYPE: TYPE VB NON SPRINKLERED

MAXIMUM TOTAL DWELLING UNITS: 4 UNITS - 11 DU'S PER

MAXIMUM BUILDING HEIGHT: 26'

REQUIRED PARKING:
TOWNHOUSE UNITS- 4 UNITS X 2 PARKING SPACES = 8 PARKING SPACES

PROPOSED PARKING:
OFF STREET PARKING = 12 PARKING SPACES INCLUDING GARAGES COMPLIES

USABLE OPEN SPACE:

REQUIRED OPEN SPACE: 4 UNITS X 550 = 2200 SF UOS PROVIDED = 12,045 SF COMPLIES SEE SHEET 4 FOR UOS PLAN

LANDSCAPE CALCULATION:

SEE SHEET 4

TWO BEDROOM UNITS: FLOOR AREA (EA. UNIT): LOWER LEVEL HEATED 517 UPPER LEVEL HEATED **TOTAL HEATED**

THREE BEDROOM UNITS:

GARAGE

TOTAL AREA

FLOOR AREA (EA. UNIT): LOWER LEVEL HEATED 786 UPPER LEVEL HEATED

264 SF

1452 SF

424 SF

1897 SF

GARAGE TOTAL AREA

TOTAL BUILDING AREA:

BUILDING: (2) TWO BEDROOM UNITS

1203 GRIEGOS RD. NW 2 X 1188 = **2376 SF HEATED** 2 X 264 = **528 SF GARAGE**

(2) THREE BEDROOM UNITS 2 X 1473 = **2946 SF HEATED** 2 X 424 = **848 SF GARAGE**

TOTAL PROJECT HEATED = 5322 SF TOTAL PROJECT GARAGE = 1376 SF

AFD PLANS CHECKING OFFICE 924-3611 APPROVED/DISAPPROVED HYDRANT(S) OMLY

SIGNATURE & DATE OF 20-15 INTRODUCTION

THE SUBJECT PROPERTY CONSISTS OF TWO ADJACENT UNIMPROVED PARCELS, BOTH OF WHICH ARE ZONED C-1. WE RESPECTFULLY SEEK A CHANGE OF ZONE TO SU-1 FOR RT.

THE TWO LOTS ARE UNDER CONTRACT TO MR. JASON BUCHANAN

RESIDENTIAL ZONED SINGLE FAMILY RESIDENCES FRAME THE PROPOSED DEVELOPMENT ON THE WEST AND THE NORTH. COMMERCIAL ZONED IMPROVED USES ARE LOCATED TO THE SOUTH AND THE EAST ACROSS THE ABUTTING

THE TWO LOTS SHALL BE COMBINED INTO ONE PARCEL. THE FOUR UNIT TOWNHOUSE DEVELOPMENT'S PROPOSED FOR THE COMBINED LOT PARCEL. THE TWO STORY TOWNHOUSE CONFIGURATION CONSISTS OF (2) THREE BEDROOM UNITS AND (2) TWO BEDROOM UNITS. PROVIDES AN ACCEPTABLE DENSITY (FAR = .35) RESIDENTIAL USE AT THE INTERFACE BETWEEN THE NEIGHBORHOOD EDGE AND THE TWO LANE COLLECTOR STREET PRIEGOS ROAD N.W.).

THE PROPOSED TOWNHOUSE UNIT GARAGE ENTRY DRIVEWAYS ARE SITUATED OFF OF A "T" SHAPED PRIVATE PARKING AREA. THE PROJECT'S FRONT SETBACK IS LOCATED OFF OF 12TH STREET, WHICH IS A LOCAL STREET NORTH OF GRIEGOS ROAD. VEHICULAR ACCESS IS PROVIDED VIA AN EXISTING CONCRETE DRIVEWAY. THE DRIVEWAY SHALL BE RETROFITTED TO ACCOMMODATE HANDICAP ACCESS ACROSS IT'S WIDTH. FOUR FOOT WIDE INTERNAL PEDESTRIAN WALKWAYS CONNECT THE UNITS FROM NORTH TO SOUTH. THE BICYCLE LANE ON GRIEGOS ROAD PROVIDES A DESIGNATED VEHICULAR LANE FOR OCCUPANT'S USE. THE CITY OF ALBUQUERQUE BUS TRANSIT ROUTE ON 4TH STREET NW IS LOCATED ONE-HALF MILE FROM THE SITE; WELL WITHIN REACH VIA BICYCLE.

ALL PROPOSED TOWNHOUSES ARE TWO STORY WITH SINGLE STORY FEATURES. ALL VEHICULAR PARKING FRONTAGES ARE SINGLE STORY; THUS, A MORE GRADUAL BUILDING ELEVATION TRANSITION IS ACHIEVED FROM THE

LASTLY, THE TOWNHOUSES SHALL BE SET OFF FROM THE STREET FRONTAGES BY MEANDERING YARD WALLS, TREES AND SHRUBS. INTERIOR LOT UNIT DRIVEWAYS WILL BE SEPARATED BY LANDSCAPE AREAS WITH TREES. THREES SHALL REACH A 25' TO 35' SPREAD AT MATURITY.

THE PROTOTYPICAL TOWNHOUSE UNIT PHOTO IS ATTACHED. THE TENTH AND CANDELARIA NW PROJECT PROVIDES AN ACCURATE PHOTOGRAPHIC RENDERING FOR REFERENCE.

GRIEGOS ROAD NW

-47

VICINITY MAP - ZA MAP F-14

PROJECT NUMBER: **APPLICATION NUMBERS:**


Is an Infrastructure List required? () Yes () No If Yes, then a set of approved DRC plans with a work order is required for any construction within Public Right-of-Way or for construction of public improvements.

DRB SITE DEVELOPMENT PLAN APPROVAL:

DRB Chairperson, Planning Department

Traffic Engineer, Transportation Division	Date
Utilities Development	Date
Parks & Recreation Department	Date
City Engineer	Date
* Environmental flealth Department (conditional)	Date
	_1-20-13
Solid Waste Mahagement	Date

SITE PLAN LEGEND

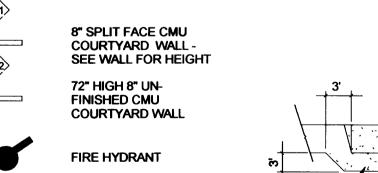

UNIT ENTRY

NEW CONCRETE SIDEWALK -**NEW CONCRETE SITE WORK**

DRIVEPAD - COA STANDARD **DETAIL DWG 2425 - SECTION** E-E - ADA ACCESSIBLE. SEE SITE PLAN FOR WIDTH

HOODED DUSK TO DAWN **EXTERIOR WALL MOUNTED** LIGHTING - SEE DETAIL

SHEET LIST

Sheet Number

Sheet Name

SITE DEVELOPMENT PLAN FOR BUILDING PERMIT

Albuquerque, New Mexico 87107 ARCHITECTS (505) 243-8211


4 UNIT TOWNHOUSE DEV. FOR JASON BUCHANAN 1203 GRIEGOS ROAD N.W. ALBUQUERQUE, NEW MEXICO

DRAWING TITLE: SITE DEVELOPMENT PLAN FOR **BUILDING PERMIT**



PROJECT NO. JAN. 1, 2015 BUCH 6D DRAWING NO.

Date

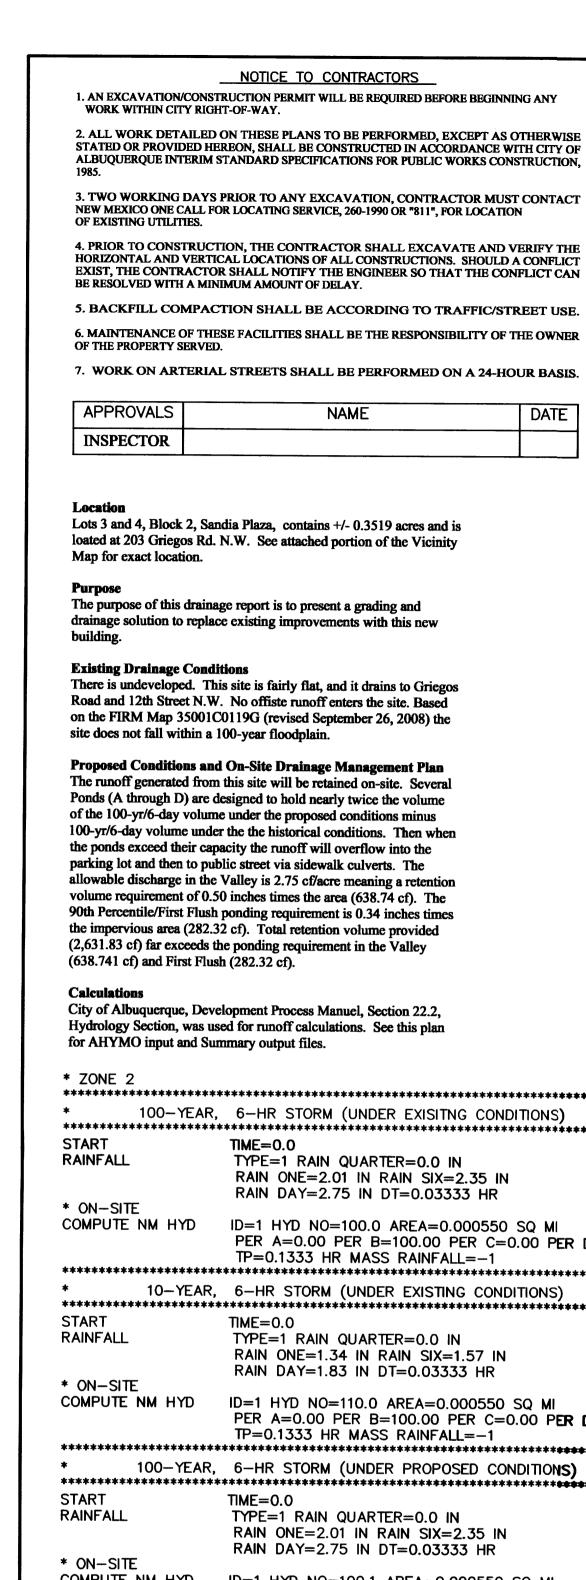

100-YEAR, 6-HR STORM (UNDER EXISITING CONDITIONS) RAIN ONE=2.01 IN RAIN SIX=2.35 IN RAIN DAY=2.75 IN DT=0.03333 HR ID=1 HYD NO=100.0 AREA=0.000550 SQ MI PER A=0.00 PER B=100.00 PER C=0.00 PER D=0.00 TP=0.1333 HR MASS RAINFALL=-1 10-YEAR, 6-HR STORM (UNDER EXISTING CONDITIONS) RAIN ONE=1.34 IN RAIN SIX=1.57 IN RAIN DAY=1.83 IN DT=0.03333 HR ID=1 HYD NO=110.0 AREA=0.000550 SQ MI PER A=0.00 PER B=100.00 PER C=0.00 PER D=0.00 TP=0.1333 HR MASS RAINFALL=-1 100-YEAR, 6-HR STORM (UNDER PROPOSED CONDITIONS) RAIN ONE=2.01 IN RAIN SIX=2.35 IN RAIN DAY=2.75 IN DT=0.03333 HR ID=1 HYD NO=100.1 AREA=0.000550 SQ MI COMPUTE NM HYD PER A=0.00 PER B=10.00 PER C=15.00 PER D=65.00 TP=0.1333 HR MASS RAINFALL=-1 ********* 10-YEAR, 6-HR STORM (UNDER PROPOSED CONDITIONS) **START** TIME=0.0RAINFALL TYPE=1 RAIN QUARTER=0.0 IN RAIN ONE=1.34 IN RAIN SIX=1.57 IN RAIN DAY=1.83 IN DT=0.03333 HR * ON-SITE COMPUTE NM HYD ID=1 HYD NO=110.1 AREA=0.000550 SQ MI PER A=0.00 PER B=10.00 PER C=15.00 PER D=65.00 TP=0.1333 HR MASS RAINFALL=-1 **FINISH**

AHYMO PROGRAM SUMMARY TABLE (AHYMO_97) -RUN DATE (MON/DAY/YR) =12/22/2014INPUT FILE = 12th.txt USER NO.= AHYMÓ-I-9702c01000R31-AH FROM TO PEAK CFS PAGE = 1HYDROGRAPH ID ID AREA DISCHARGE VOLUME RUNOFF PEAK COMMAND IDENTIFICATION NO. NO. (SQ MI) (CFS) (AC-FT) (INCHES) (HOURS) ACRE START RAINFALL TYPE= 1 RAIN6= 2.350 COMPUTE NM HYD 100.00 .00055 1.533 2.301 PER IMP= .00 START RAINFALL TYPE= 1 RAIN6= 1.570 COMPUTE NM HYD 110.00 .00055 .**0**08 1.533 .945 PER IMP= .00 START RAINFALL TYPE= 1 RAIN6= 2.350 COMPUTE NM HYD 100.10 .00055 1.500 4.216 PER IMP= 72.22 START RAINFALL TYPE= RAIN6= COMPUTE NM HYD 110.10 .00055 1.500 2.650 PER IMP= 72.22 FINISH

DEPRESS LANDSCAPING AREA TOP=72.50 (867.76 SF) BOTTOM=71.00 (236.73 SF) VOLUME=815.72 CF POND A 72.70 5 ∞ V 73.80 × 73230 HIGH POINT-73.20 DEPRESS LANDSCAPING ARE TOR=72.90 (225.19 SF) BOTTOM=71.90 (80.33 SF) VOLUME=152.76 CF POND B 5 Ó 73.80 BLOCK WALL EXIST. DW RP AS BLOCK WALL EXIST. DW GRIEGOS BLVD. N.W. R.O.W. VARIES DEPRESS LANDSCAPING AREA DEPRESS LANDSCAPING AREA TOP=72.50 (702.12 SF) TOP=72.60 (1,049.82 SF) BOTTOM=71.50 (102.70 SF) BOTTOM=71.10 (363.16 SF) VOLUME=603.62 CF VOLUME=1059.74 CF POND C POND D

O NOTES:

- 1. PROVIDE 12" CURB OPENING
- 2 12" SIDEWALK CULRVET PER CITY STD DWG 2236 (TACK WELD PLATE AT THE BOLT)
- 3. 6" WALL OPENING (OR TURN TWO BLOCKS)

POND CALCULATION

TOTAL POND AREA PROVIDED = POND A + B + C + D = 2,631.83 CF TOTAL PONDING VOLUME REQUIRED = VOL. PROPOSED CONDITIONS - VOL. EXISTING CONDITIONS = 0.053 - 0.023 = 0.03 AC-FT = 1,306.80 CF

TOTAL PONDING VOLUME REQUIRED (VALLEY)= 0.5 INCHES x AREA = $(0.5/12 \times 15,329.81) = 638.74$ CF TOTAL PONDING VOLUME REQUIRED (90TH PERCENTILE/FIRST FLUSH) = 0.34 IMCHES x IMPERVIOUS AREA = (0.34/12 x 9,964.38) = 282.32 CF





10209 SNOWFLAKE CT., NW ALBUQUERQUE, NEW MEXICO 87114

4 UNIT TOWNHOUSE DEVELOPMENT

GRADING AND DRAINAGE PLAN DRAWN BY: DATE: 201418-GR.DWG 2 3 12-22-2014


MCINITY MAP: F-14-Z LEGAL DESCRIPTION: LOTS 3 AND 4, BLOCK 2, SANDIA PLAZA CONTAINING 15,329.81 S.F. (0.3519 ACRE) **ZONING: C-1 USES ADDRESS:** 1203 GRIEGOS ROAD N.W. **GENERAL NOTES:** 1: CONTOUR INTERVAL IS HALF (0.50) FOOT.

2: ELEVATIONS ARE BASED ON CITY OF ALBUQUERQUE CONTROL STATION DOUGLAS, HAVING AN ELEVATION OF 4975.078 FEET ABOVE SEA LEVEL.

- 3: UTILITIES SHOWN HEREON ARE IN THEIR APPROXIMATE LOCATION BASED ONLY ON ABOVE GROUND EVIDENCE FOUND IN THE FIELD AND AS-BUILT INFORMATION PROVIDED BY THE CLIENT. UTILITIES SHOWN HEREON, WHETHER INDICATED AS ABANDONED OR NOT, SHALL BE VERIFIED BY OTHERS FOR EXACT LOCATION AND/ OR DEPTH PRIOR TO EXCAVATION OR DESIGN CON-SIDERATIONS.
- 4: THIS IS <u>NOT</u> A BOUNDARY SURVEY, BEARINGS ARE ASSUMED, DISTANCES AND FOUND PROPERTY CORNERS ARE FOR <u>INFORMATIONAL PURPOSES ONLY.</u> 5: SLOPES ARE AT 3:1 MAXIMUM.

NOTICE TO CONTRACTORS

- 1. AN EXCAVATION/CONSTRUCTION PERMIT WILL BE REQUIRED BEFORE BEGINNING ANY WORK WITHIN CITY RIGHT-OF-WAY.
- 2. ALL WORK DETAILED ON THESE PLANS TO BE PERFORMED, EXCEPT AS OTHERWISE STATED OR PROVIDED HEREON, SHALL BE CONSTRUCTED IN ACCORDANCE WITH CITY OF ALBUQUERQUE INTERIM STANDARD SPECIFICATIONS FOR PUBLIC WORKS CONSTRUCTION,
- 3. TWO WORKING DAYS PRIOR TO ANY EXCAVATION, CONTRACTOR MUST CONTACT LINE LOCATING SERVICE, 765-1234, FOR LOCATION OF EXISTING UTILITIES.
- 4. PRIOR TO CONSTRUCTION, THE CONTRACTOR SHALL EXCAVATE AND VERIFY THE HORIZONTAL AND VERTICAL LOCATIONS OF ALL CONSTRUCTIONS. SHOULD A CONFLICT EXIST, THE CONTRACTOR SHALL NOTIFY THE ENGINEER SO THAT THE CONFLICT CAN BE RESOLVED WITH A MINIMUM AMOUNT OF DELAY.
- 5. BACKFILL COMPACTION SHALL BE ACCORDING TO TRAFFIC/STREET USE.
- 6. MAINTENANCE OF THESE FACILITIES SHALL BE THE RESPONSIBILITY OF THE OWNER OF THE PROPERTY SERVED.
- 7. WORK ON ARTERIAL STREETS SHALL BE PERFORMED ON A 24-HOUR BASIS.

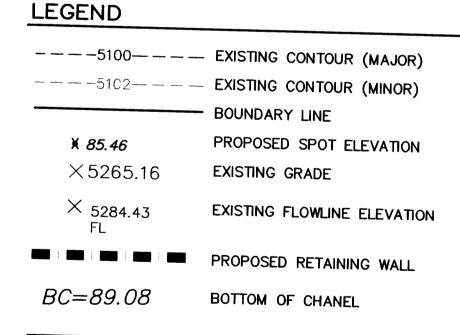

TRW = 91.50TOP OF RETAINING WALL TF=88.00 TOP OF FOOTING


HIGH POINT

P.E. #11814

10 5 0

SCALE: 1"=10'

GRAPHIC SCALE DRAWING:

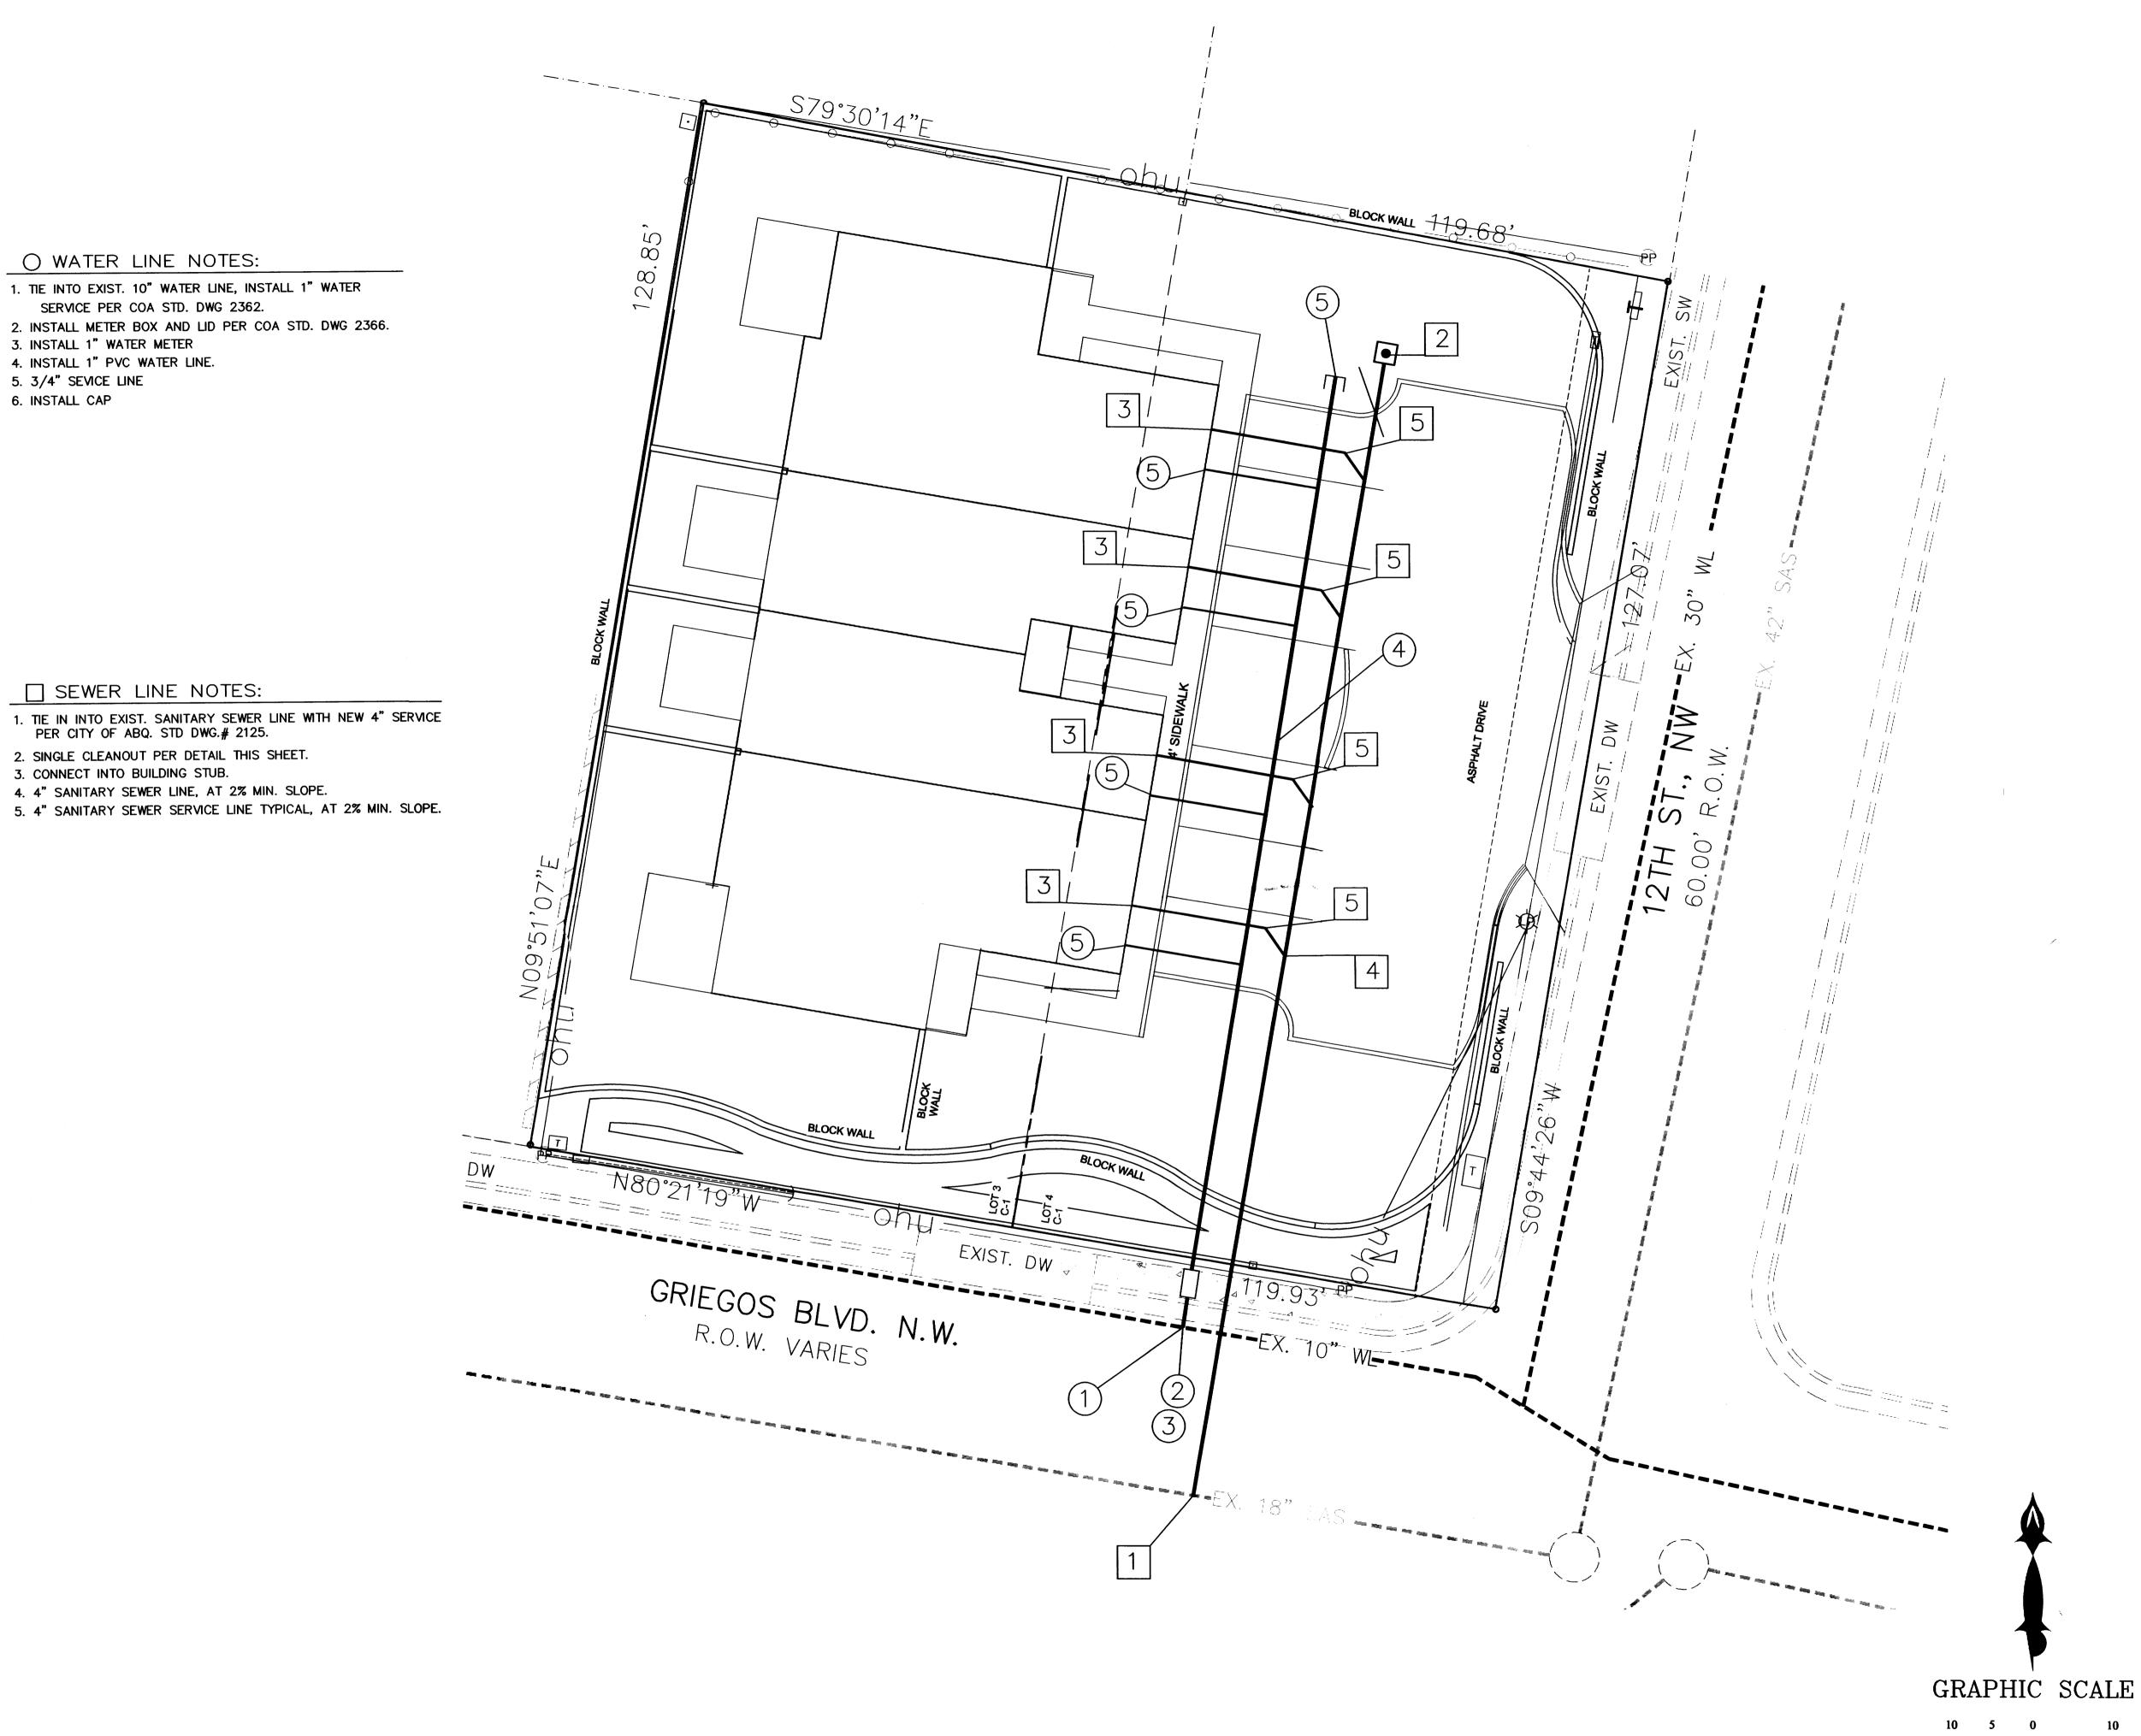

O WATER LINE NOTES:

☐ SEWER LINE NOTES:

3. CONNECT INTO BUILDING STUB.

2. SINGLE CLEANOUT PER DETAIL THIS SHEET.


4. 4" SANITARY SEWER LINE, AT 2% MIN. SLOPE.


3. INSTALL 1" WATER METER 4. INSTALL 1" PVC WATER LINE.

5. 3/4" SEVICE LINE

6. INSTALL CAP

SERVICE PER COA STD. DWG 2362.

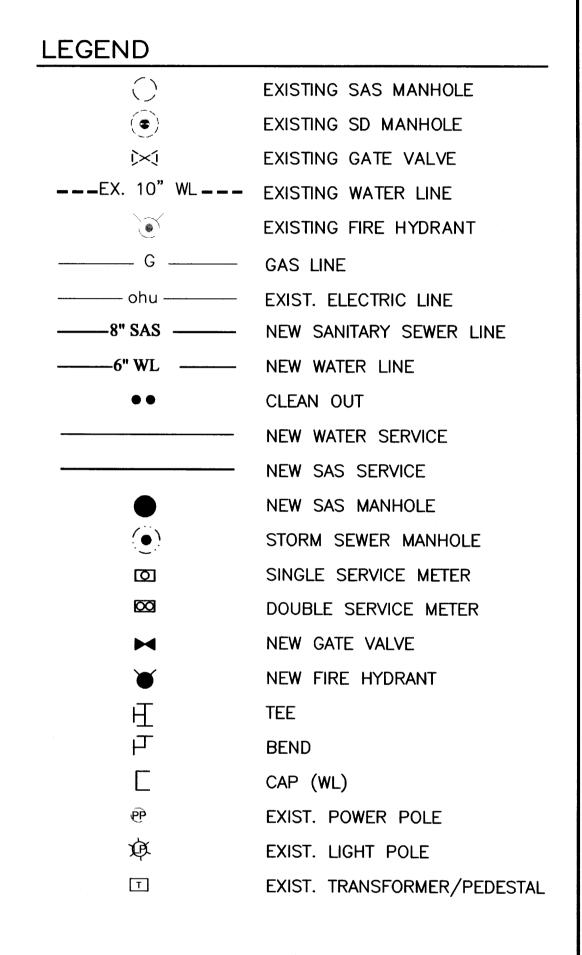

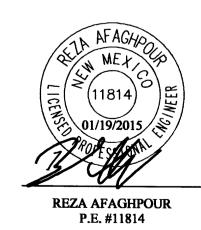


SCALE: 1"=10'


SBS CONSTRUCTION AND ENGINEERING, LLC


10209 SNOWFLAKE CT., NW ALBUQUERQUE, NEW MEXICO 87114 (505)899-5570

4	UNIT TOWNH	OUSE DEV	ELOPMENT
MASTER UTILITY PLAN			
NG:	DRAWN BY	DATE	QUEET#


DRAWING: 3 **4** 201418-MU-2.DWG 07-27-2014

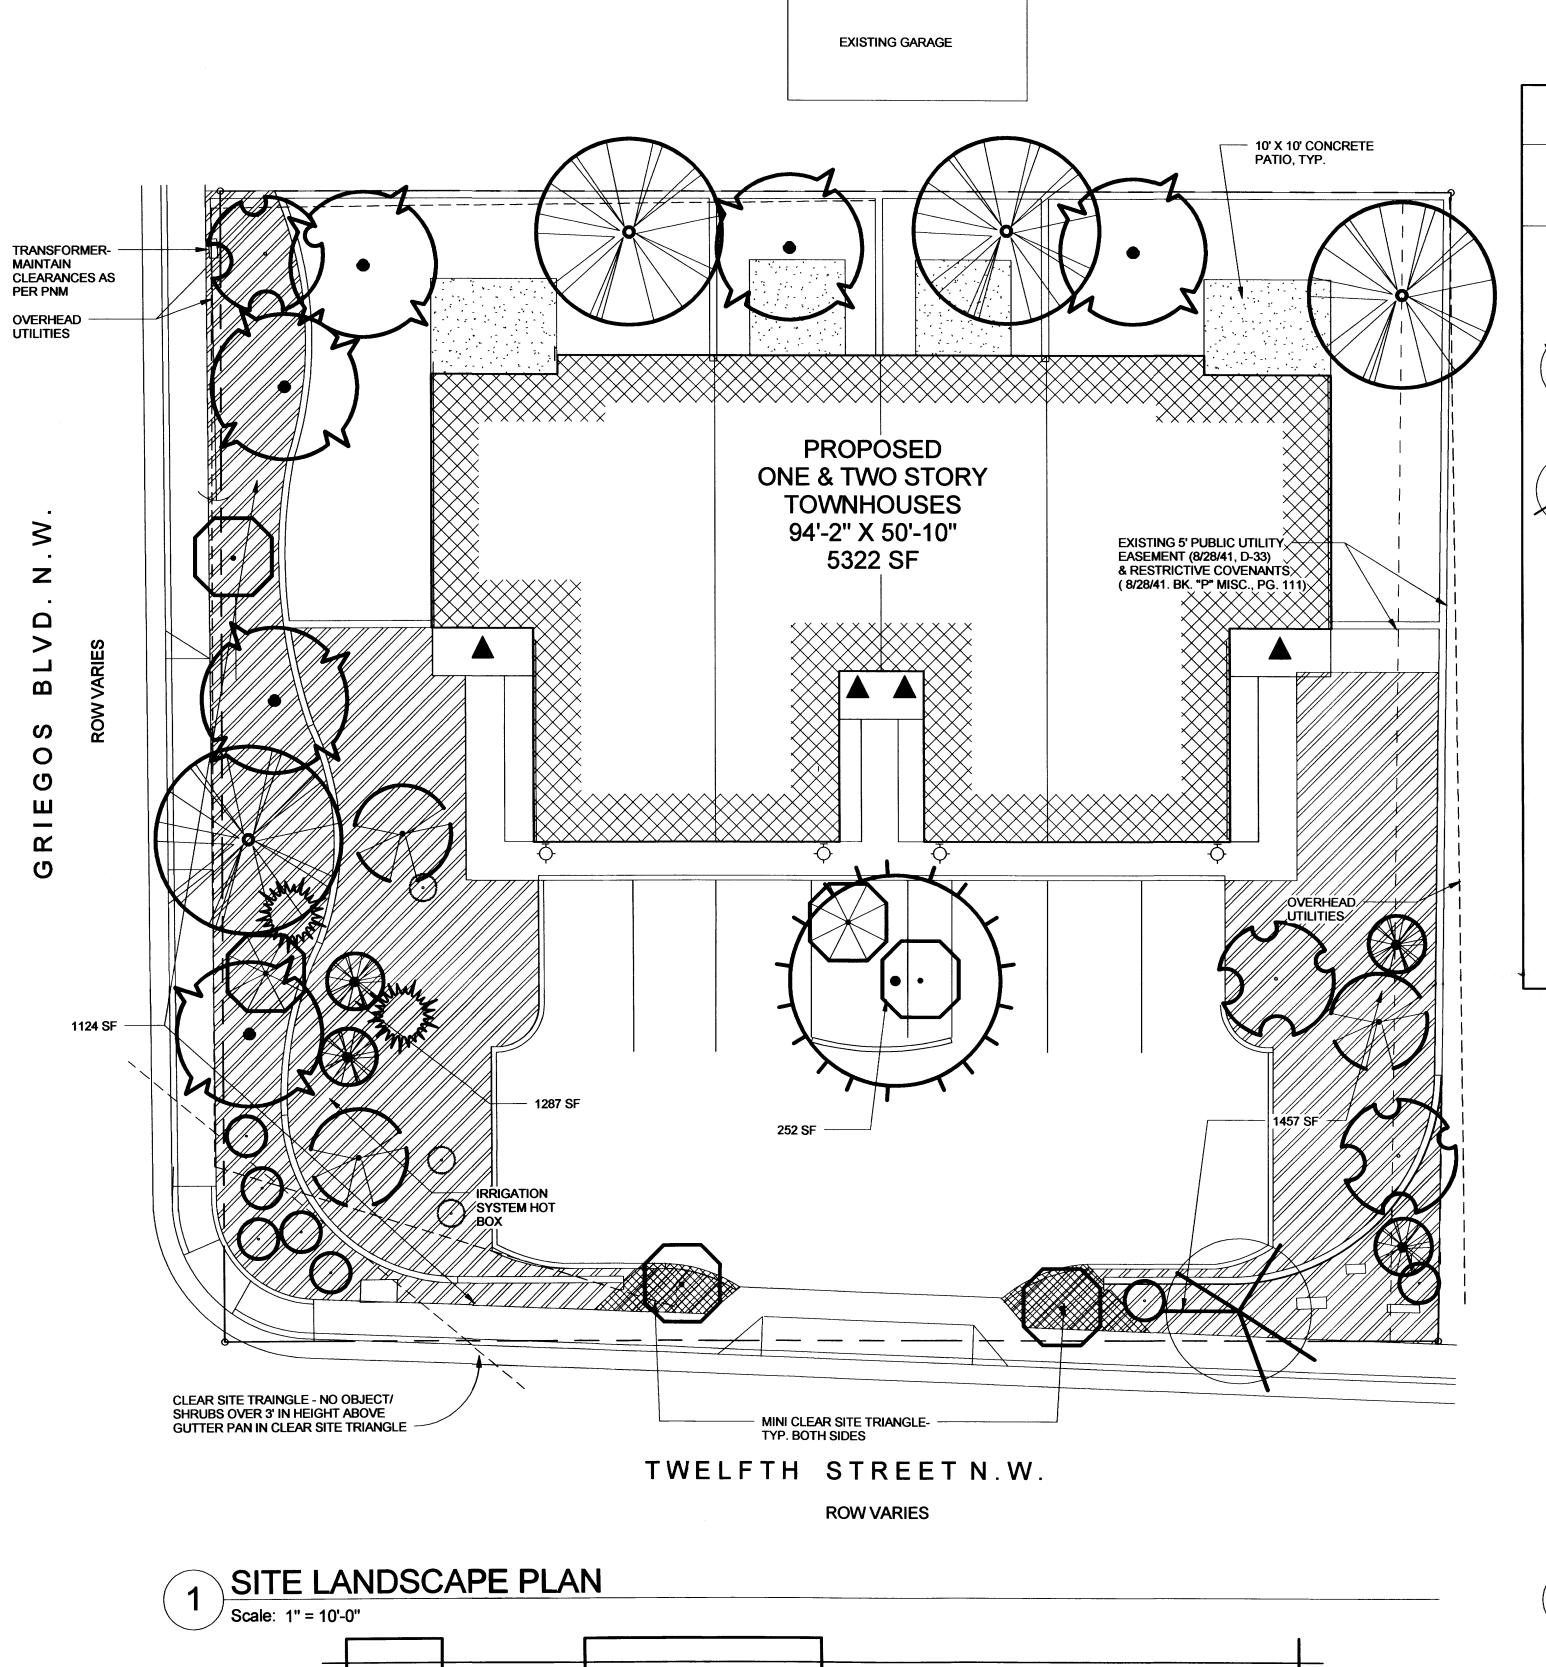

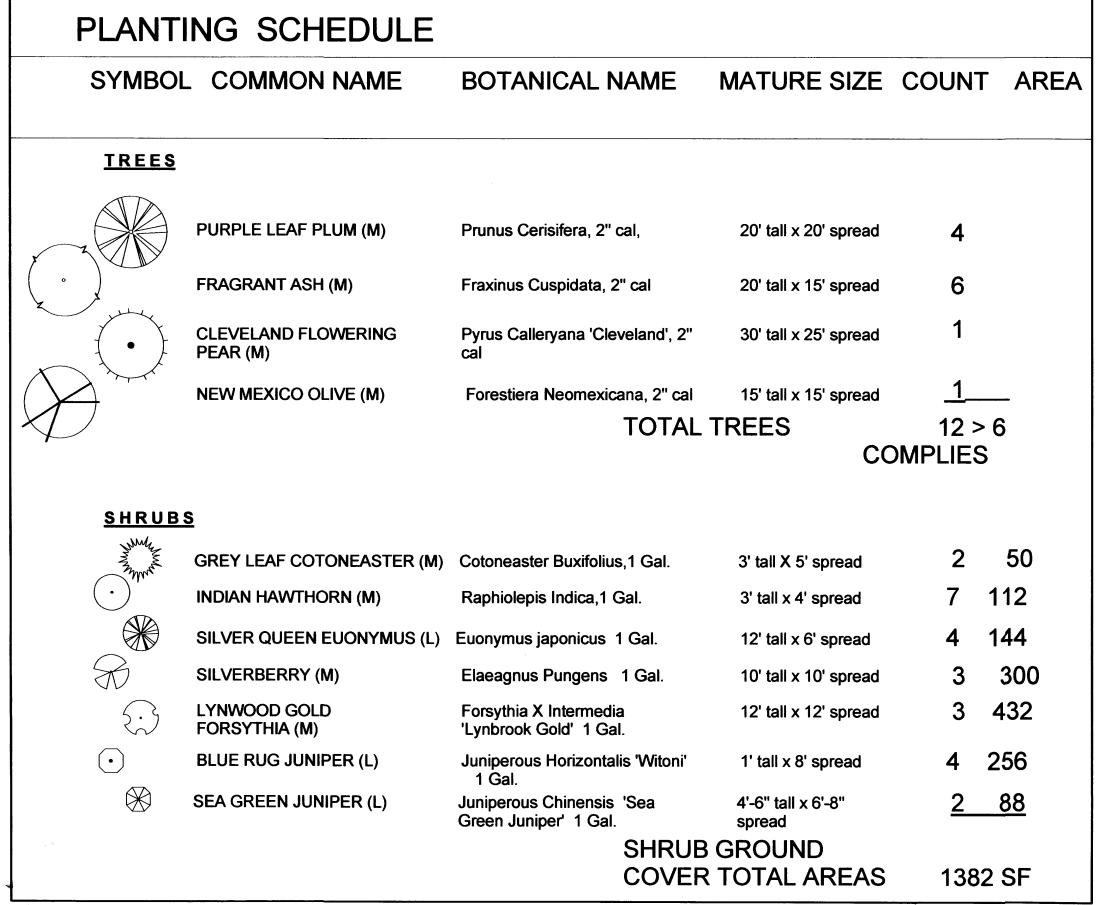

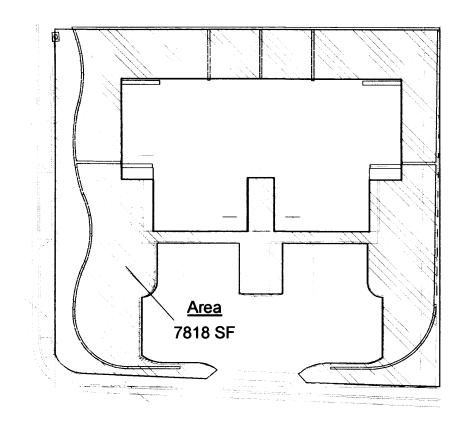


USABLE OPEN SPACE -1203 GRIEGOS RD. NW

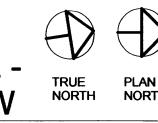

OPEN SPACE


HOT BOX INSULATED BACKFLOW DEVICE ENCLOSURE

USABLE OPEN SPACE: REQUIRED OPEN SPACE: 4 UNITS X 550 = 2,200 SF UOS PROVIDED = 7818 SF **COMPLIES**

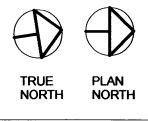



4" CONCRETE SIDEWALK, DRIVEWAY AND COMMONS AREA SLABS

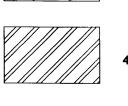

4" DEPTH OF 3/4" SANTA ANA TAN DECORATIVE GRAVEL ON 6 MIL VISQUEEN

GRAVEL AREAS @ UNIT ENTRY ALCOVES ARE <u>NOT</u> INCLUDED IN PROPOSED LANDSCAPE AREAS

LANDSCAPING

& NOTES

LOT: .3519A X 43560 = 15,329 SF

REQUIRED LANDSCAPING: 11,232 X 15% = 1685 SF

REQUIRED 75% VEGETATIVE GROUND COVER =

BY ZONE SPECIFICATION AND LOCATION. CONTROLLERS SHALL BE

VEGETATIVE GROUND COVER PROVIDED: 1382 SF COMPLIES

PLANT WATERING SHALL BE PROVIDED BY A DRIP IRRIGATION SYSTEM.
CONTROLLERS SHALL BE PROVIDED IN THE NUMBER AND SPACING REQUIRED

ALL LANDSCAPING SHALL BE MAINTAINED AND REPLACED, IF NECESSARY, BY

LANDSCAPING AND SIGNING SHALL NOT INTERFERE WITH CLEAR SITE REQUIREMENTS, THEREFORE SIGNS, TREES AND SHRUBS BETWEEN 3' AND 8' TALL (AS MEASURED FROM THE GUTTER PAN) SHALL NOT BE

THE PROJECT SHALL COMPLY WITH THE CITY OF ALBUQUERQUE ZONING ORDINANCE - 14-16-3-10, GENERAL LANDSCAPE REGULATIONS

THE PROJECT SHALL COMPLY WITH THE "WATER CON-SERVATION AND WATER WASTE ORDINANCE" - ARTICLE

HATCH LEGEND


LANDSCAPE CALCULATION:

4120 SF COMPLIES

ACCEPTABLÈ IN THIS AREA.

.75 X 1685 SF = 1264 SF

INSTALLED ON OWNERS HOUSE ELECTRICAL

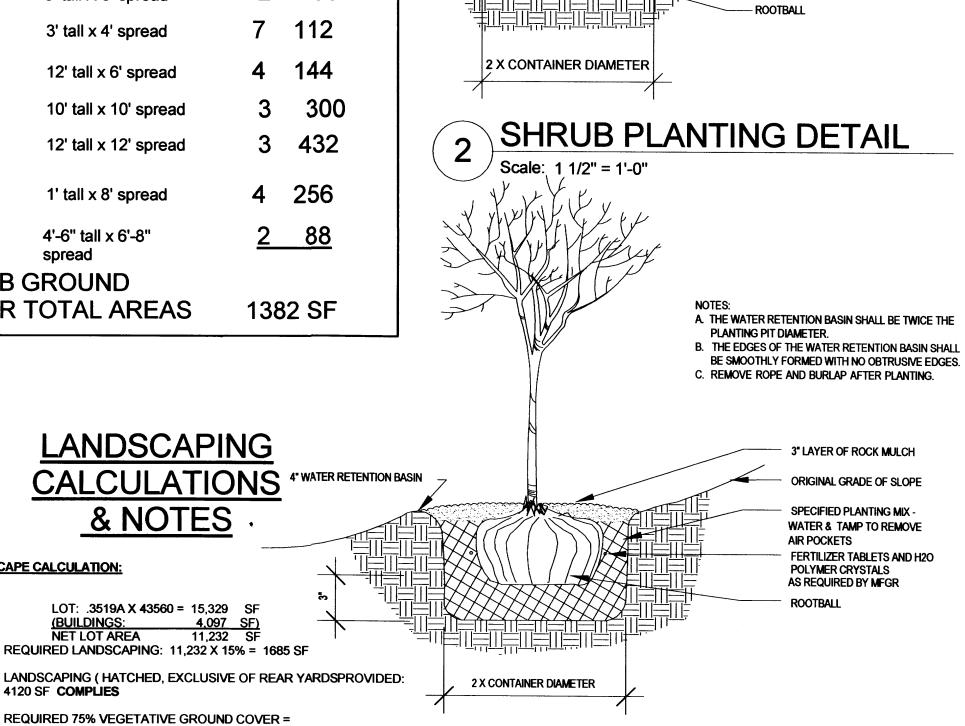

A. THE WATER RETENTION BASIN SHALL BE TWICE THE

B. THE EDGES OF THE WATER RETENTION BASIN SHALL

BE SMOOTHLY FORMED WITH NO OBTRUSIVE EDGES.

- 3" LAYER OF ROCK MULCH

- 4" DEEP WATER DETENTION BASIN

TAMP TO REMOVE AIR POCKETS

FERTILIZER TABLETS -APPLY PER

MANUFACTURER'S SPECIFICATIONS.

SPECIFIED PLANTING MIX-WATER AND


PLANTING PIT DIAMETER.

Albuquerque, New Mexico 87107 ARCHITECTS (505) 243-8211 4 UNIT TOWNHOUSE DEV. FOR JASON BUCHANAN 1203 GRIEGOS ROAD N.W. ALBUQUERQUE, NEW MEXICO

TREE PLANTING WELL

Scale: 1 1/2" = 1'-0"

SITE LANDSCAPE PLAN

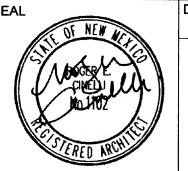

PROJECT NO. JAN. 1, 2015 **BUCH 6D** DRAWING NO.

Roger Cinelli & Assoc. 2418 Manuel Torres Lane N.W.


BACKFLOW PREVENTION DETAIL




PERSPECTIVE - 10TH & CANDELARIA PROTOTYPE




9 WALL MOUNTED DAWN TO DUSK LIGHT FIXTURE
NOT TO SCALE"

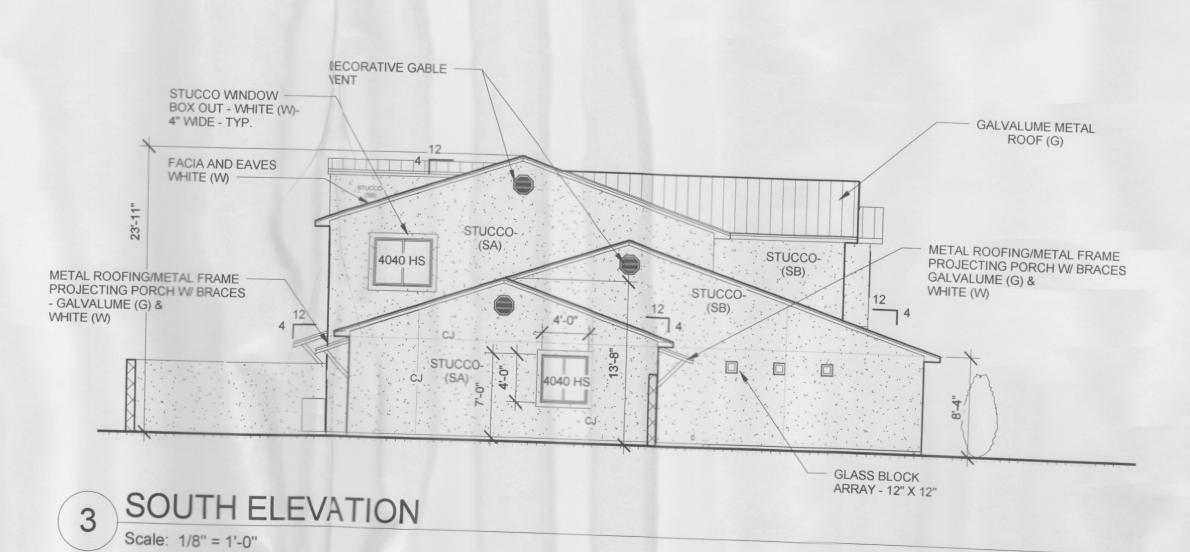

- METAL ROOFING/METAL FRAME PROJECTING PORCH W/ BRACES - TYP. OF (4) GALVALUME (G) & METAL FRAME - WHITE (W) STUCCO WINDOW BOX OUT - WHITE (W) GLASS BLOCK FACIA & EAVES WHITE (W) GALVALUME METAL ROOF (G) ARRAY - 12" X 12" STUCCO-STUCCO-ADDRESS ID WHERE APPLICABLE STUCCO-4040 HS 4040 HS HOODED DRIVEWAY
DUSK-DAWN LIGHT STUCCO-@ 7'6" AFF - TYPICAL -15070 OHD-9070 OHD_____ __9070 OHD__ -16070 OHD-STUCCO-STUCCO-(SA) EAST ELEVATION STUCCO-UNIT SIGNAGE (SA) ENTRY DOOR WHITE (W) UNIT SIGNAGE Scale: 1/8" = 1'-0"

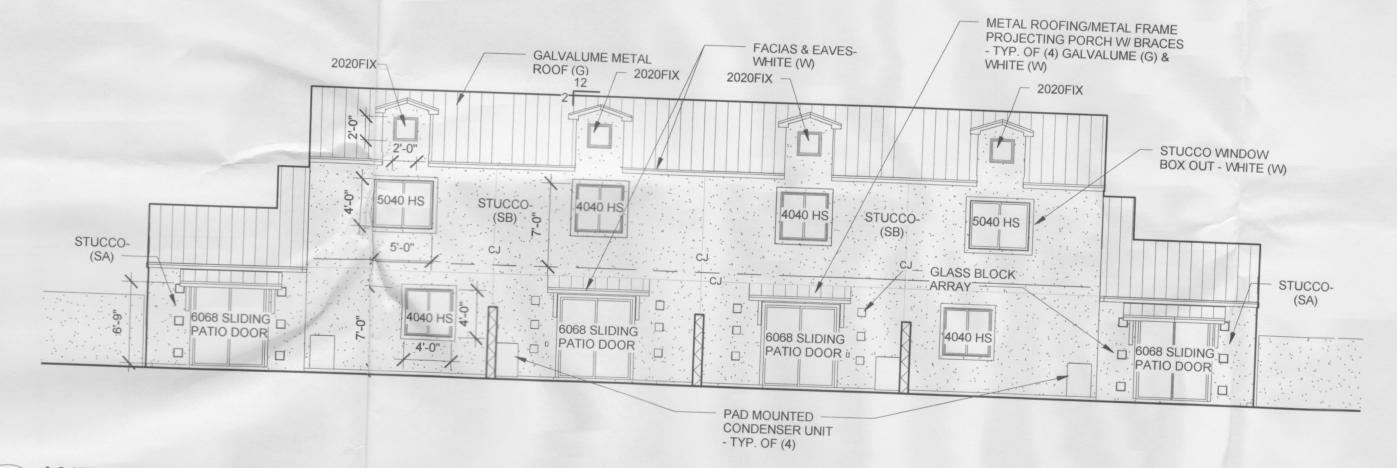

2 WEST ELEVATION
Scale: 1/8" = 1'-0"

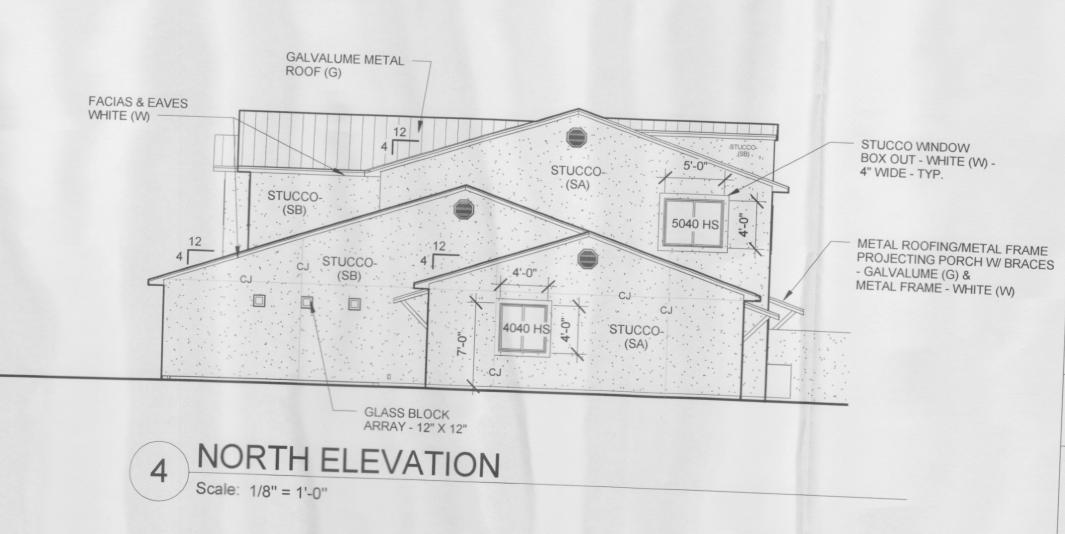

BUILDING AND FENCE COLORS

METAL ROOF: GALVALUME (G)

STUCCO COLORS:
STUCCO (SA) EL REY BUCKSKIN
STUCCO (SB) EL REY SANTA FE BROWN
PORCH METAL FRAME COLOR:

WHITE (W)

VINYL WINDOW W/ DIVIDERS COLOR:

VINYL WINDOW W/ DIVIDERS COLO WHITE (W)

ENTRY DOOR COLOR: WHITE (W)

STUCCO TRIM: (AT WINDOWS)
WHITE (W)



4 UNIT TOWNHOUSE DEV. FOR JASON BUCHANAN 1203 GRIEGOS ROAD N.W. ALBUQUERQUE, NEW MEXICO

DRAWING TITLE:
ELEVATIONS & DETAILS



DATE
JAN. 1, 2015

PROJECT NO.
BUCH 6D

DRAWING NO.

0