

DESIGN CRITERIA

CODES: 2009 IRC, 2009UMC, 2009 UPC, 2014NEC

PROJECT LOCATION: NORTHWEST CORNER OF NTERSECTION OF 12TH STREET AND GRIEGOS ROAD

1203 GRIEGOS ROAD N.W., ALBUQUERQUE, NM

LEGAL DESCRIPTION: LOTS 3A, BLOCK 2, SANDIA

TOTAL ACREAGE: .3519 ACRES

EXISTING ZONING: C-1

PROPOSED ZONING: SU-1 FOR RT

CONSTRUCTION TYPE: TYPE VB NON SPRINKLERED

MAXIMUM TOTAL DWELLING UNITS: 4 UNITS - 11 DU'S
PER ACRE

MAXIMUM BUILDING HEIGHT: 26'

REQUIRED PARKING:
TOWNHOUSE UNITS- 4 UNITS X 2 PARKING SPACES = **8 PARKING SPACES**

PROPOSED PARKING:
OFF STREET PARKING = 12 PARKING SPACES INCLUDING GARAGES COMPLIES

USABLE OPEN SPACE:

REQUIRED OPEN SPACE: 4 UNITS X 550 = 2200 SF UOS PROVIDED = 7,721 SF COMPLIES SEE SHEET 4 FOR UOS PLAN

LANDSCAPE CALCULATION:

SEE SHEET 4 TWO BEDROOM UNITS:

FLOOR AREA (EA. UNIT) LOWER LEVEL HEATED <u>UPPER LEVEL HEATED</u> TOTAL HEATED GARAGE 264 SF

TOTAL AREA

THREE BEDROOM UNITS:

FLOOR AREA (EA. UNIT) LOWER LEVEL HEATED

<u>UPPER LEVEL HEATED</u> TOTAL HEATED

1557 SF

1897 SF

1203 GRIEGOS RD. NW

TOTAL BUILDING AREA:

TOTAL AREA


BUILDING: (2) TWO BEDROOM UNITS

2 X 1293 = **2586 SF HEATED** 2 X 264 = **528 SF GARAGE**

2 X 1473 = **2946 SF HEATED** 2 X 424 = **848 SF GARAGE**

(2) THREE BEDROOM UNITS

TOTAL PROJECT HEATED = 5532 SF **TOTAL PROJECT GARAGE = 1376 SF**

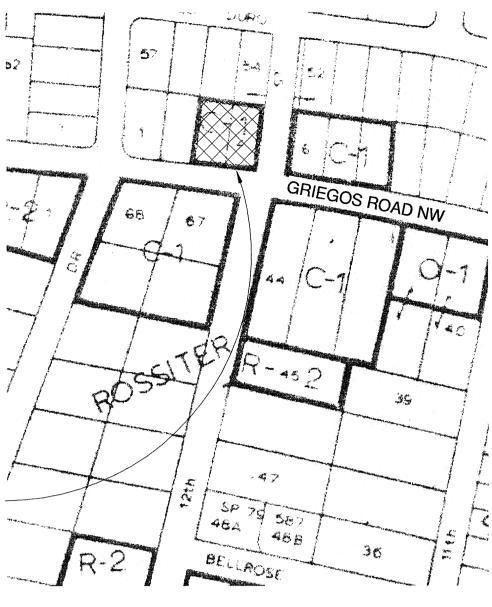

VICINITY MAP - ZA MAP F-14

INTRODUCTION

(8/28/41. BK. "P" MISC., PG. 111) THE SITE DEVELOPMENT PLAN FOR BUILDING PERMIT SUBMITTAL SHALL SERVE AS THE OWNER'S SUBMITTAL FOR A ZONE CHANGE TO THE PROPERTY LOCATED AT THE NORTHWEST CORNER OF 12TH STREET AND GRIEGOS ROAD N.W. 1203 GRIEGOS ROAD N.W.

> THE SUBJECT PROPERTY CONSISTS OF ONE REPLATTED UNIMPROVED PARCEL, ZONED C-1. WE RESPECTFULLY SEEK A CHANGE OF ZONE TO SU-1 FOR RT.

THE LOT IS UNDER CONTRACT TO MR. JASON BUCHANAN.

AFD PLANS CHECKING OFFICE

924-3611

Signalure à Date

PPROVED/BISAPPROVED

RESIDENTIAL ZONED SINGLE FAMILY RESIDENCES FRAME THE PROPOSED DEVELOPMENT ON THE WEST AND THE NORTH. COMMERCIAL ZONED IMPROVED USES ARE LOCATED TO THE SOUTH AND THE EAST ACROSS THE ABUTTING

THE FOUR UNIT TOWNHOUSE DEVELOPMENT IS PROPOSED FOR THE LOT PARCEL. THE TWO STORY TOWNHOUSE CONFIGURATION CONSISTS OF (2) THREE BEDROOM UNITS AND (2) TWO BEDROOM UNITS. THIS CONFIGURATION PROVIDES AN ACCEPTABLE DENSITY (FAR = .35) RESIDENTIAL USE AT THE INTERFACE BETWEEN THE NEIGHBORHOOD EDGE AND THE TWO LANE COLLECTOR STREET (GRIEGOS ROAD N.W.)

THE PROPOSED TOWNHOUSE UNIT GARAGE ENTRY DRIVEWAYS ARE SITUATED OFF OF A "T" SHAPED PRIVATE PARKING AREA. THE PROJECT'S FRONT SETBACK IS LOCATED OFF OF 12TH STREET, WHICH IS A LOCAL STREET NORTH OF GRIEGOS ROAD. VEHICULAR ACCESS IS PROVIDED VIA AN EXISTING CONCRETE DRIVEWAY. THE DRIVEWAY SHALL BE RETROFITTED TO ACCOMMODATE HANDICAP ACCESS ACROSS IT'S WIDTH. FOUR FOOT WIDE INTERNAL PEDESTRIAN WALKWAYS CONNECT THE UNITS FROM NORTH TO SOUTH. THE CITY OF ALBUQUERQUE BUS TRANSIT ROUTE ON 4TH STREET NW IS LOCATED ONE-HALF MILE FROM THE SITE: WELL WITHIN REACH VIA BICYCLE.

ALL PROPOSED TOWNHOUSES ARE TWO STORY WITH SINGLE STORY FEATURES. ALL VEHICULAR PARKING FRONTAGES ARE SINGLE STORY; THUS, A MORE GRADUAL BUILDING ELEVATION TRANSITION IS ACHIEVED FROM THE

LASTLY, THE TOWNHOUSES SHALL BE SET OFF FROM THE STREET FRONTAGES BY MEANDERING YARD WALLS, TREES AND SHRUBS. INTERIOR LOT UNIT DRIVEWAYS WILL BE SEPARATED BY LANDSCAPE AREAS WITH TREES. THREES SHALL REACH A 25' TO 35' SPREAD AT MATURITY. TREES ATOVERHEAD POWER LINES SHALL NOT EXCEED 25' IN HEIGHT AT

THE PROTOTYPICAL TOWNHOUSE UNIT PHOTO IS ATTACHED ON SHEET 5. THE TENTH AND CANDELARIA NW PROJECT PROVIDES AN ACCURATE PHOTOGRAPHIC RENDERING FOR BUILDING MASSING REFERENCE.

PROJECT NUMBER: #1010182 **APPLICATION NUMBERS:**

1" = 500'


SDP FOR BP: #15DRB-70024

Is an Infrastructure List required? () Yes () No If Yes, then a set of approved DRC plans with a work order is required for any construction within Public Right-of-Way or for construction of public improvements.

DRR SITE DEVELOPMENT PLAN APPROVAL

DRB SITE DEVELOPMENT PLAN APPROVAL:	
	02-18-15
Traffic Engineer, Transportation Division	Date
allen Ae	02/18/15 Date
Utilities Development	Date
Carol S. Dumont	<u>2-18-15</u> Date
Parks & Recreation Department	Date
Cento a colon	2-18-5
City Engineer	Date
$\mathcal{N}\mathcal{A}$	2-18-15
* Environmental Health Department (conditional)	Date
	2-12-15
Solid Waste Management	Date
Gal Clad	2-10-15
DRB Chairperson, Planning Department	Date

SITE PLAN LEGEND

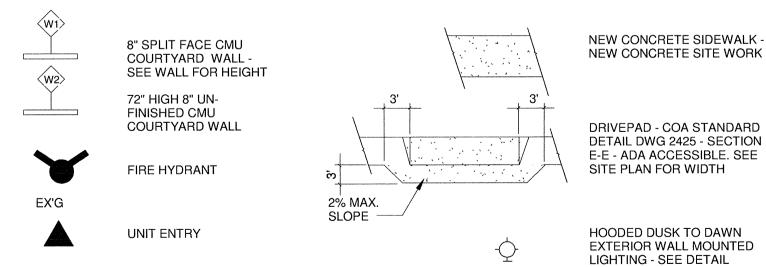

SHEET LIST

Sheet

Number **Sheet Name** SITE DEVELOPMENT PLAN FOR BUILDING PERMIT

SITE DRAINAGE & GRADING PLAN SITE UTILITY PLAN SITE LANDSCAPE PLAN **ELEVATIONS & DETAILS**

Roger Cinelli & Assoc. 2418 Manuel Torres Lane N.W. Albuquerque, New Mexico 87107 ARCHITECTS (505) 243-8211

4 UNIT TOWNHOUSE DEV. FOR JASON BUCHANAN 1203 GRIEGOS ROAD N.W. ALBUQUERQUE, NEW MEXICO

SITE DEVELOPMENT PLAN FOR **BUILDING PERMIT**



PROJECT NO. FEB. 12, 2015 BUCH 6E DRAWING NO.

2/12/15

NOTICE TO CONTRACTORS 1. AN EXCAVATION/CONSTRUCTION PERMIT WILL BE REQUIRED BEFORE BEGINNING ANY 2. ALL WORK DETAILED ON THESE PLANS TO BE PERFORMED, EXCEPT AS OTHERWISE STATED OR PROVIDED HEREON, SHALL BE CONSTRUCTED IN ACCORDANCE WITH CITY OF ALBUQUERQUE INTERIM STANDARD SPECIFICATIONS FOR PUBLIC WORKS CONSTRUCTION,

3. TWO WORKING DAYS PRIOR TO ANY EXCAVATION, CONTRACTOR MUST CONTACT NEW MEXICO ONE CALL FOR LOCATING SERVICE, 260-1990 OR "811", FOR LOCATION

4. PRIOR TO CONSTRUCTION, THE CONTRACTOR SHALL EXCAVATE AND VERIFY THE HORIZONTAL AND VERTICAL LOCATIONS OF ALL CONSTRUCTIONS. SHOULD A CONFLICT EXIST, THE CONTRACTOR SHALL NOTIFY THE ENGINEER SO THAT THE CONFLICT CAN BE RESOLVED WITH A MINIMUM AMOUNT OF DELAY.

5. BACKFILL COMPACTION SHALL BE ACCORDING TO TRAFFIC/STREET USE. 6. MAINTENANCE OF THESE FACILITIES SHALL BE THE RESPONSIBILITY OF THE OWNER OF THE PROPERTY SERVED.

7. WORK ON ARTERIAL STREETS SHALL BE PERFORMED ON A 24-HOUR BASIS.

APPROVALS	NAME	DATE
INSPECTOR		

Lots 3 and 4, Block 2, Sandia Plaza, contains +/- 0.3519 acres and is loated at 203 Griegos Rd. N.W. See attached portion of the Vicinity Map for exact location.

The purpose of this drainage report is to present a grading and drainage solution to replace existing improvements with this new

Existing Drainage Conditions

There is undeveloped. This site is fairly flat, and it drains to Griegos Road and 12th Street N.W. No offiste runoff enters the site. Based on the FIRM Map 35001C0119G (revised September 26, 2008) the site does not fall within a 100-year floodplain.

Proposed Conditions and On-Site Drainage Management Plan The runoff generated from this site will be retained on-site. Several Ponds (A through D) are designed to hold nearly twice the volume of the 100-yr/6-day volume under the proposed conditions minus 100-yr/6-day volume under the historical conditions. Then when the ponds exceed their capacity the runoff will overflow into the parking lot and then to public street via sidewalk culverts. The allowable discharge in the Valley is 2.75 cf/acre meaning a retention volume requirement of 0.50 inches times the area (638.74 cf). The 90th Percentile/First Flush ponding requirement is 0.34 inches times the impervious area (282.32 cf). Total retention volume provided (2,631.83 cf) far exceeds the ponding requirement in the Valley (638.741 cf) and First Flush (282.32 cf).

City of Albuquerque, Development Process Manuel, Section 22.2, Hydrology Section, was used for runoff calculations. See this plan for AHYMO input and Summary output files.

* ZONE 2

100-YEAR. 6-HR STORM (UNDER EXISITING CONDITIONS)

TYPE=1 RAIN QUARTER=0.0 IN RAINFALL

RAIN ONE=2.01 IN RAIN SIX=2.35 IN RAIN DAY=2.75 IN DT=0.03333 HR

* ON-SITE COMPUTE NM HYD ID=1 HYD NO=100.0 AREA=0.000550 SQ MI PER A=0.00 PER B=100.00 PER C=0.00 PER D=0.00

TP=0.1333 HR MASS RAINFALL=-1 10-YEAR, 6-HR STORM (UNDER EXISTING CONDITIONS)

START TIME=0.0

RAINFALL TYPE=1 RAIN QUARTER=0.0 IN RAIN ONE=1.34 IN RAIN SIX=1.57 IN

RAIN DAY=1.83 IN DT=0.03333 HR

* ON-SITE COMPUTE NM HYD ID=1 HYD NO=110.0 AREA=0.000550 SQ MI

PER A=0.00 PER B=100.00 PER C=0.00 PER D=0.00 TP=0.1333 HR MASS RAINFALL=-1

100-YEAR, 6-HR STORM (UNDER PROPOSED CONDITIONS)

TYPE=1 RAIN QUARTER=0.0 IN RAINFALL

RAIN ONE=2.01 IN RAIN SIX=2.35 IN RAIN DAY=2.75 IN DT=0.03333 HR

* ON-SITE ID=1 HYD NO=100.1 AREA=0.000550 SQ MI COMPUTE NM HYD

PER A=0.00 PER B=10.00 PER C=15.00 PER D=65.00 TP=0.1333 HR MASS RAINFALL=-1

10-YEAR, 6-HR STORM (UNDER PROPOSED CONDITIONS)

START

RAINFALL TYPE=1 RAIN QUARTER=0.0 IN

RAIN ONE=1.34 IN RAIN SIX=1.57 IN


RAIN DAY=1.83 IN DT=0.03333 HR * ON-SITE

ID=1 HYD NO=110.1 AREA=0.000550 SQ MI COMPUTE NM HYD PER A=0.00 PER B=10.00 PER C=15.00 PER D=65.00

TP=0.1333 HR MASS RAINFALL=-1 ************************************

FINISH

AHYMO PROGRAINPUT FILE = 1.		MARY TABLE	(AH)	YMO_97)	_	- V	ERSION: 199 ⁻		JN DATE (I R NO.= AH			
COMMAND		YDROGRAPH	FROM ID NO.	TO ID NO.	AREA (SQ MI)	PEAK DISCHARGE (CFS)	RUNOFF VOLUME (AC-FT)	RUNOFF (INCHES) (H	TIME TO PEAK IOURS)		PAGE NOTATIO	
START RAINFALL TYPE COMPUTE NM H START RAINFALL TYPE	YD	100.00	_	1	.00055	.81	.023	.77821	1.533	2.301 F	TIME= RAIN6= PER IMP= TIME= RAIN6=	.00 2.350 .00 .00 1.570
COMPUTE NM H START RAINFALL TYPE	YD	110.00		1	.00055	.33	.008	.27828	1.533	.945	PER IMP= TIME= RAIN6=	.00 .00 2.350
COMPUTE NM H START RAINFALL TYPE		100.10		1	.00055	1.48	.053	1.79770	1.500	4.216 F	PER IMP= TIME= RAIN6=	72.22 .00 1.570
COMPUTE NM H FINISH	YD	110.10		1	.00055	.93	.032	1.07842	1.500	2.650 F	PER IMP=	72.22

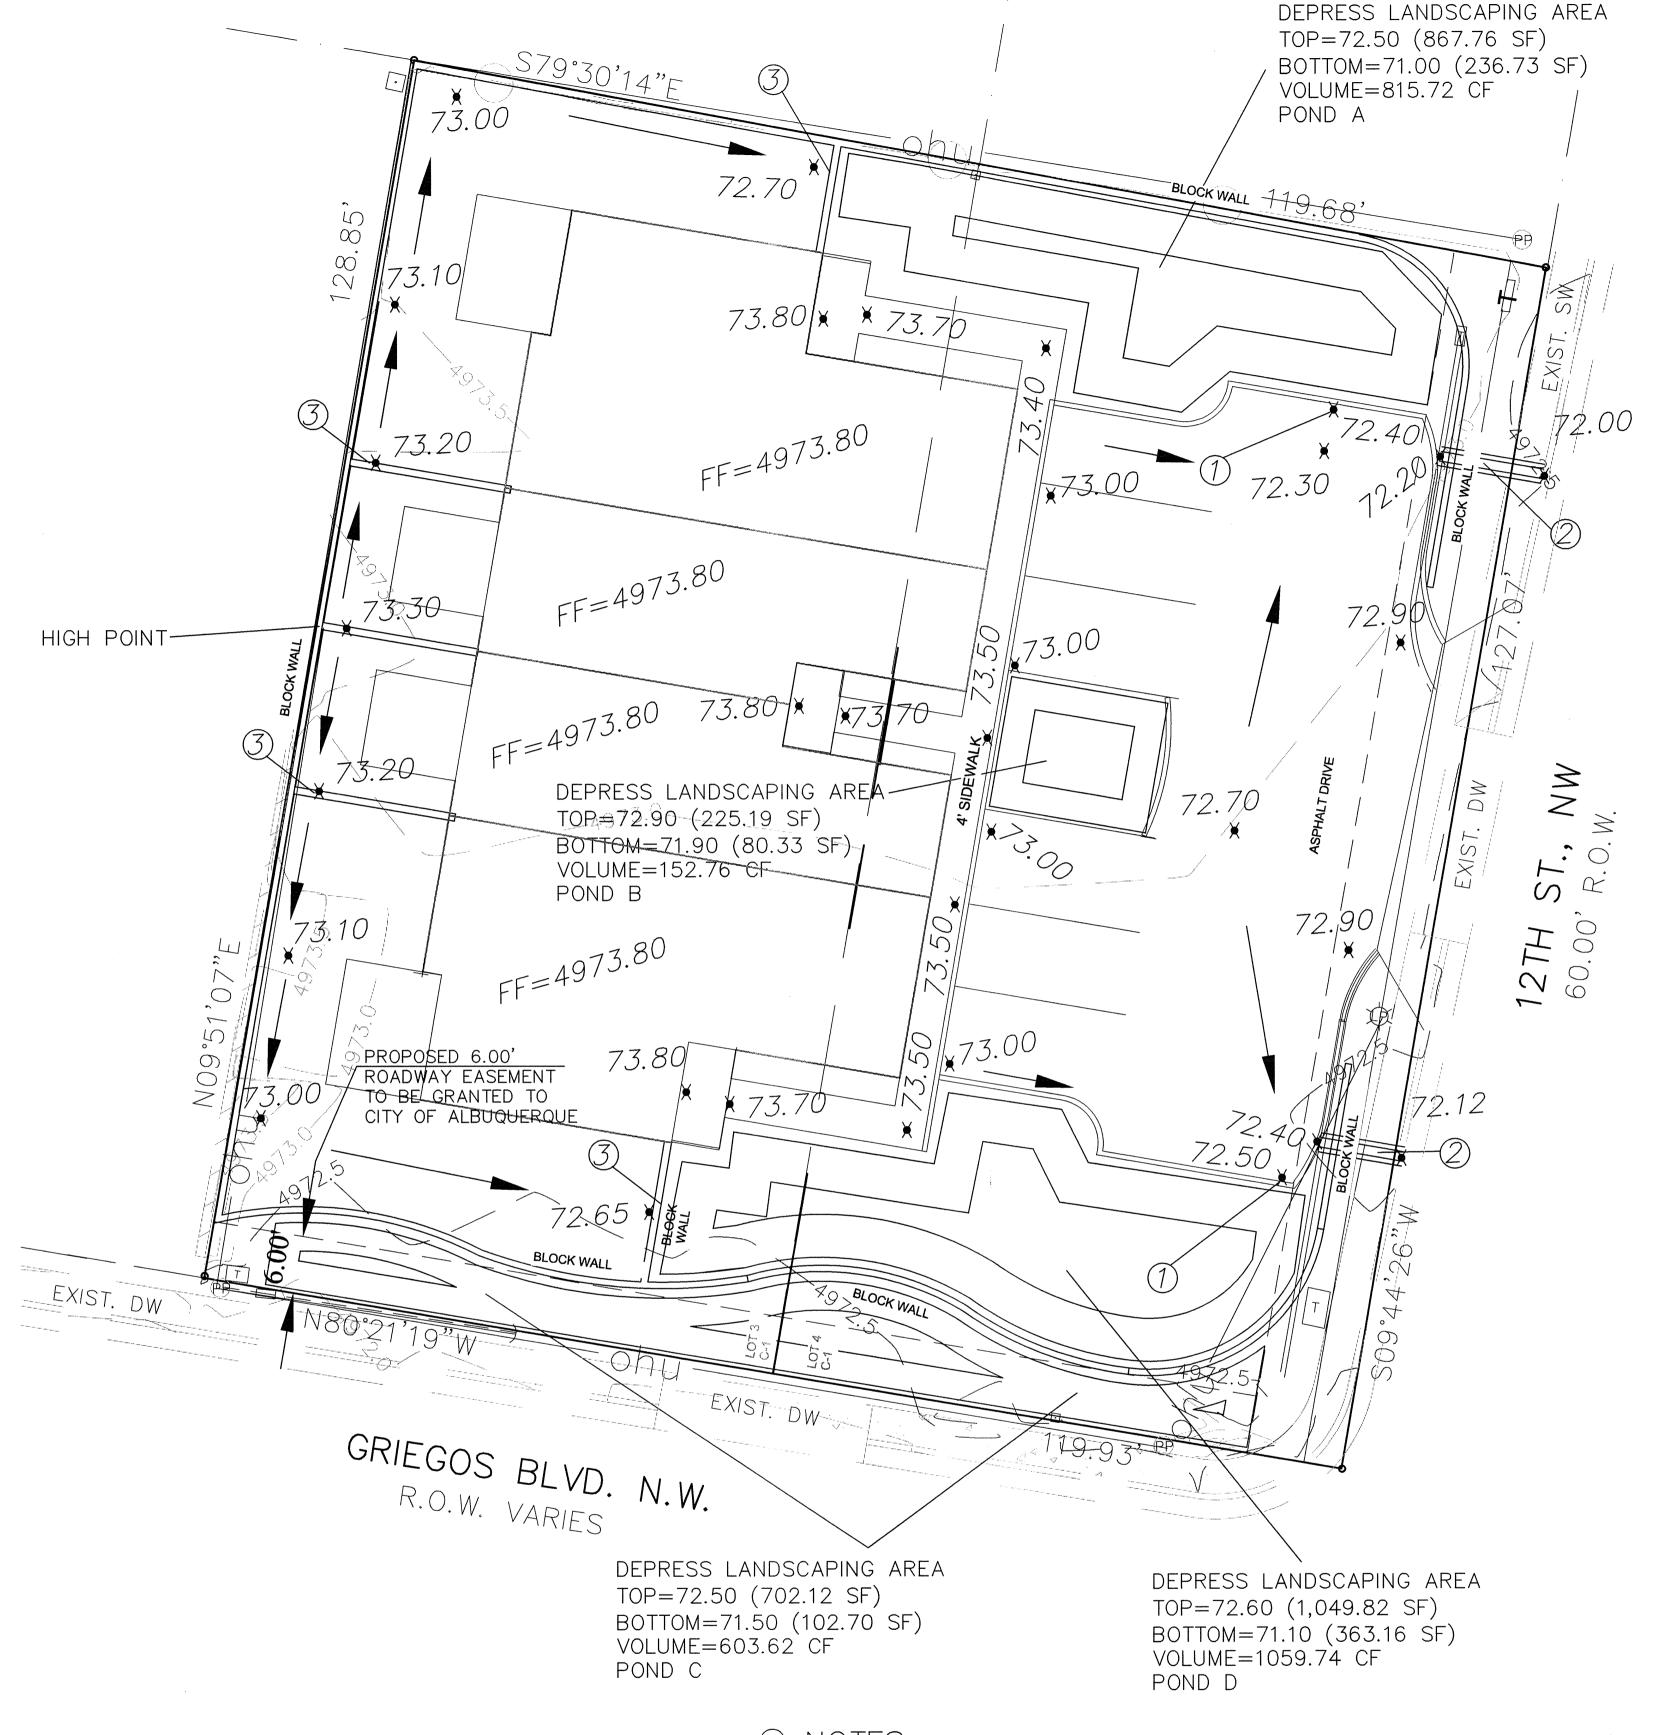




- 1. PROVIDE 12" CURB OPENING
- 2. 12" SIDEWALK CULRVET PER CITY STD DWG 2236 (TACK WELD PLATE AT THE BOLT)
- 3. 6" WALL OPENING (OR TURN TWO BLOCKS)

POND CALCULATION TOTAL POND AREA PROVIDED = POND A + B + C + D = 2,631.83 CF TOTAL PONDING VOLUME REQUIRED = VOL. PROPOSED CONDITIONS - VOL. EXISTING CONDITIONS = 0.053 - 0.023 = 0.03 AC-FT = 1,306.80 CF

TOTAL PONDING VOLUME REQUIRED (VALLEY)= 0.5 INCHES x AREA = $(0.5/12 \times 15,329.81) = 638.74$ CF TOTAL PONDING VOLUME REQUIRED (90TH PERCENTILE/FIRST FLUSH) = 0.34 IMCHES x IMPERVIOUS AREA = (0.34/12 x 9,964.38) = 282.32 CF

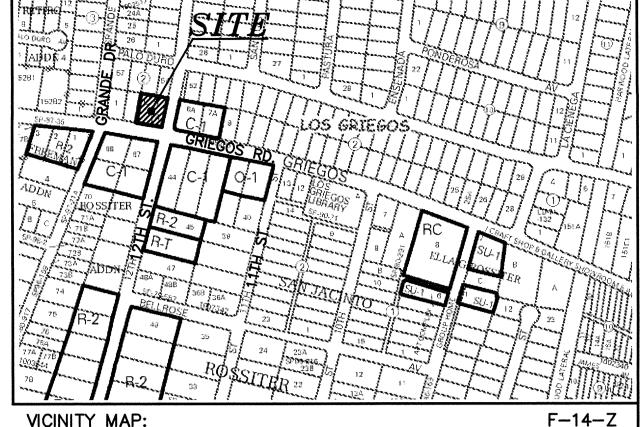

LEGAL DESCRIPTION: LOTS 3 AND 4, BLOCK 2, SANDIA PLAZA

CONTAINING 15,329.81 S.F. (0.3519 ACRE) **ZONING: C-1 USES**

ADDRESS: 1203 GRIEGOS ROAD N.W.

GENERAL NOTES:

- 1: CONTOUR INTERVAL IS HALF (0.50) FOOT.
- 2: ELEVATIONS ARE BASED ON CITY OF ALBUQUERQUE CONTROL STATION DOUGLAS, HAVING AN ELEVATION OF 4975.078 FEET ABOVE SEA LEVEL.
- 3: UTILITIES SHOWN HEREON ARE IN THEIR APPROXIMATE LOCATION BASED ONLY ON ABOVE GROUND EVIDENCE FOUND IN THE FIELD AND AS-BUILT INFORMATION PROVIDED BY THE CLIENT. UTILITIES SHOWN HEREON, WHETHER INDICATED AS ABANDONED OR NOT, SHALL BE VERIFIED BY OTHERS FOR EXACT LOCATION AND / OR DEPTH PRIOR TO EXCAVATION OR DESIGN CON-
- 4: THIS IS NOT A BOUNDARY SURVEY, BEARINGS ARE ASSUMED, DISTANCES
- AND FOUND PROPERTY CORNERS ARE FOR INFORMATIONAL PURPOSES ONLY. 5: SLOPES ARE AT 3:1 MAXIMUM.

NOTICE TO CONTRACTORS

- 1. AN EXCAVATION/CONSTRUCTION PERMIT WILL BE REQUIRED BEFORE BEGINNING ANY WORK WITHIN CITY RIGHT-OF-WAY.
- 2. ALL WORK DETAILED ON THESE PLANS TO BE PERFORMED, EXCEPT AS OTHERWISE STATED OR PROVIDED HEREON, SHALL BE CONSTRUCTED IN ACCORDANCE WITH CITY OF ALBUQUERQUE INTERIM STANDARD SPECIFICATIONS FOR PUBLIC WORKS CONSTRUCTION,
- 3. TWO WORKING DAYS PRIOR TO ANY EXCAVATION, CONTRACTOR MUST CONTACT LINE LOCATING SERVICE, 765-1234, FOR LOCATION OF EXISTING UTILITIES.
- 4. PRIOR TO CONSTRUCTION, THE CONTRACTOR SHALL EXCAVATE AND VERIFY THE HORIZONTAL AND VERTICAL LOCATIONS OF ALL CONSTRUCTIONS. SHOULD A CONFLICT EXIST, THE CONTRACTOR SHALL NOTIFY THE ENGINEER SO THAT THE CONFLICT CAN BE RESOLVED WITH A MINIMUM AMOUNT OF DELAY.
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LEGEND	
 5100	EXISTING CONTOUR (MAJOR)
5102	EXISTING CONTOUR (MINOR)
	BOUNDARY LINE
¥ <i>85.46</i>	PROPOSED SPOT ELEVATION
×5265.16	EXISTING GRADE
× 5284.43 FL	EXISTING FLOWLINE ELEVATION
	PROPOSED RETAINING WALL
BC=89.08	BOTTOM OF CHANEL
TRW=91.50	TOP OF RETAINING WALL
TF=88.00	TOP OF FOOTING
HP	HIGH POINT





GRAPHIC SCALE


SCALE: 1"=10'


SBS CONSTRUCTION AND ENGINEERING, LLC

10209 SNOWFLAKE CT., NW ALBUQUERQUE, NEW MEXICO 87114

4 UNIT TOWNHOUSE DEVELOPMENT GRADING AND DRAINAGE PLAN

DRAWN BY: SHEET# DRAWING: DATE: SH-B 12-22-2014 201418-GR.DWG

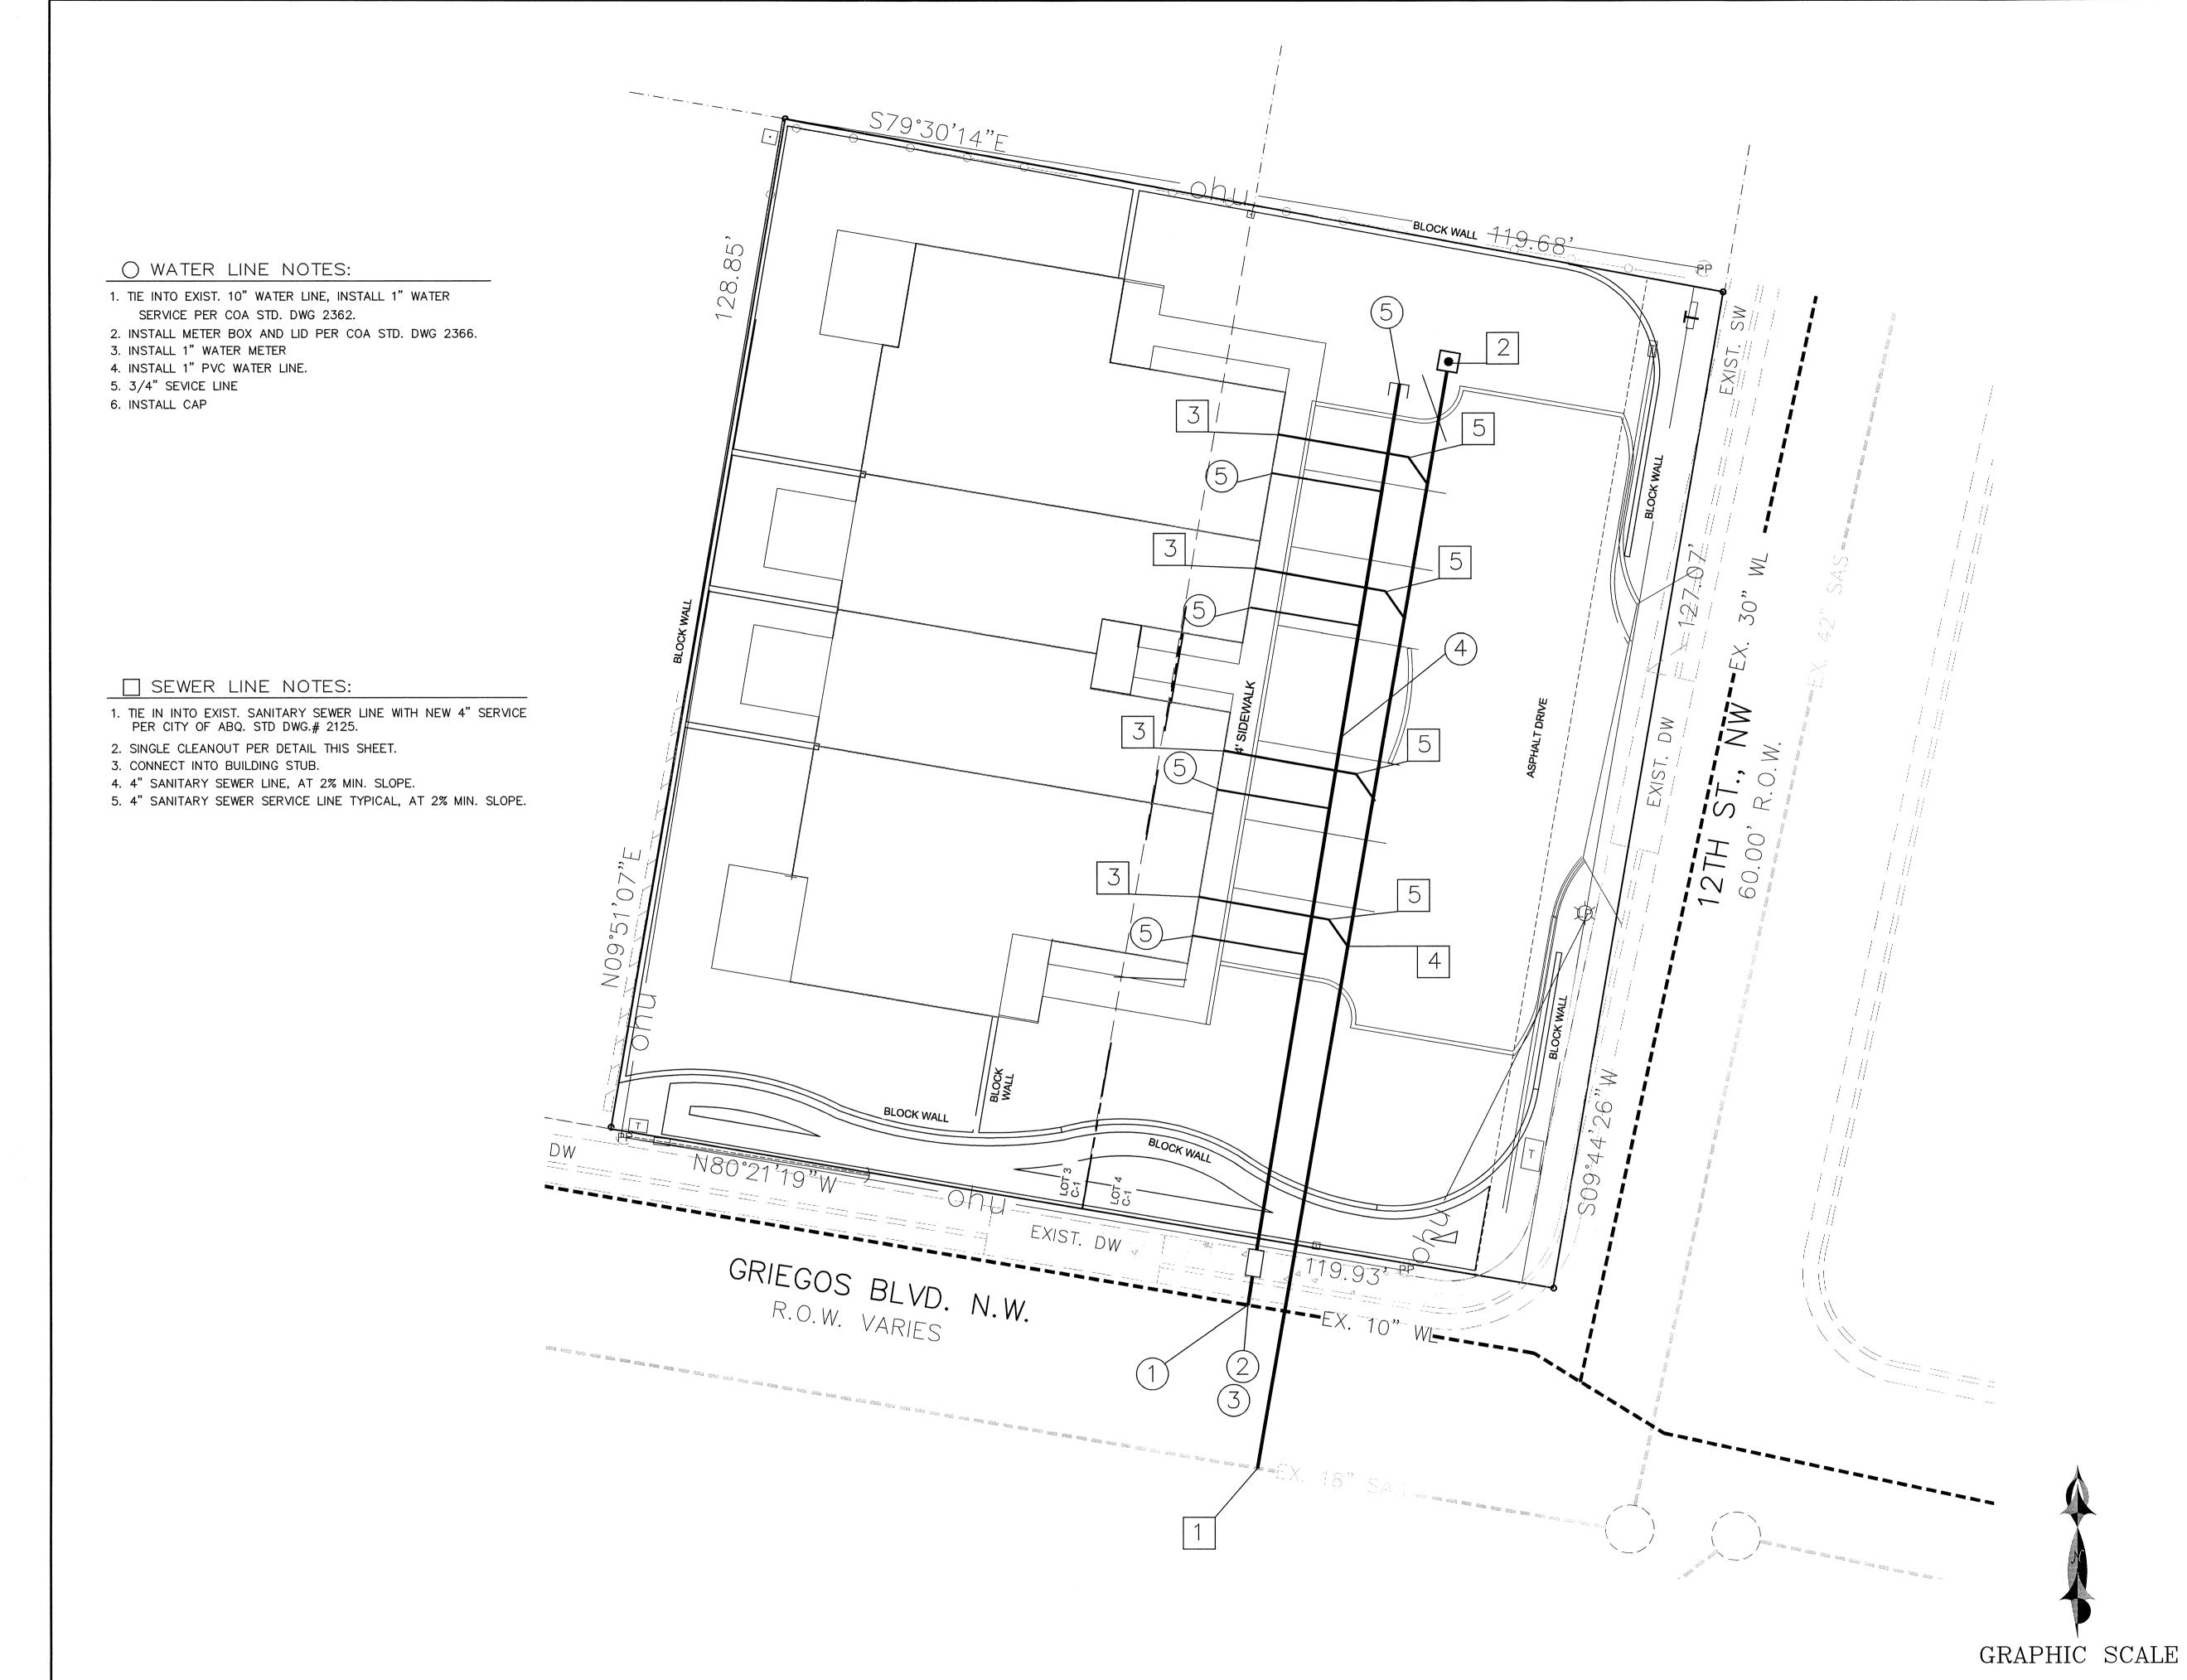

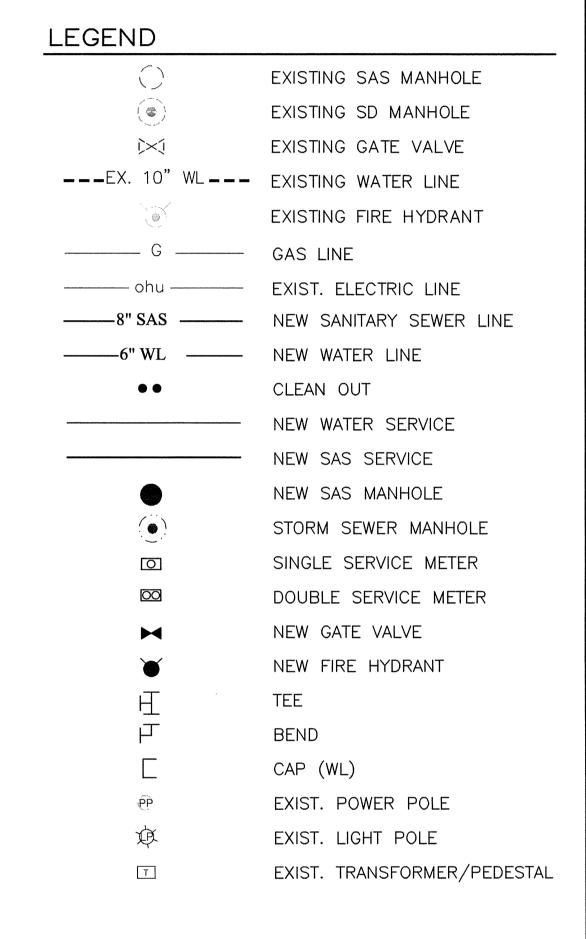




SCALE: 1"=10'

SBS CONSTRUCTION AND ENGINEERING, LLC


10209 SNOWFLAKE CT., NW ALBUQUERQUE, NEW MEXICO 87114 (505)899-5570


4 UNIT TOWNHOUSE DEVELOPMEN'	Γ
MASTER UTILITY PLAN	


WINDIER CHEITTER							
DRAWING:	DRAWN BY:	DATE:	SHEET#				
201418-MU-2.DWG	SH-B	07-27-2014	3 4				

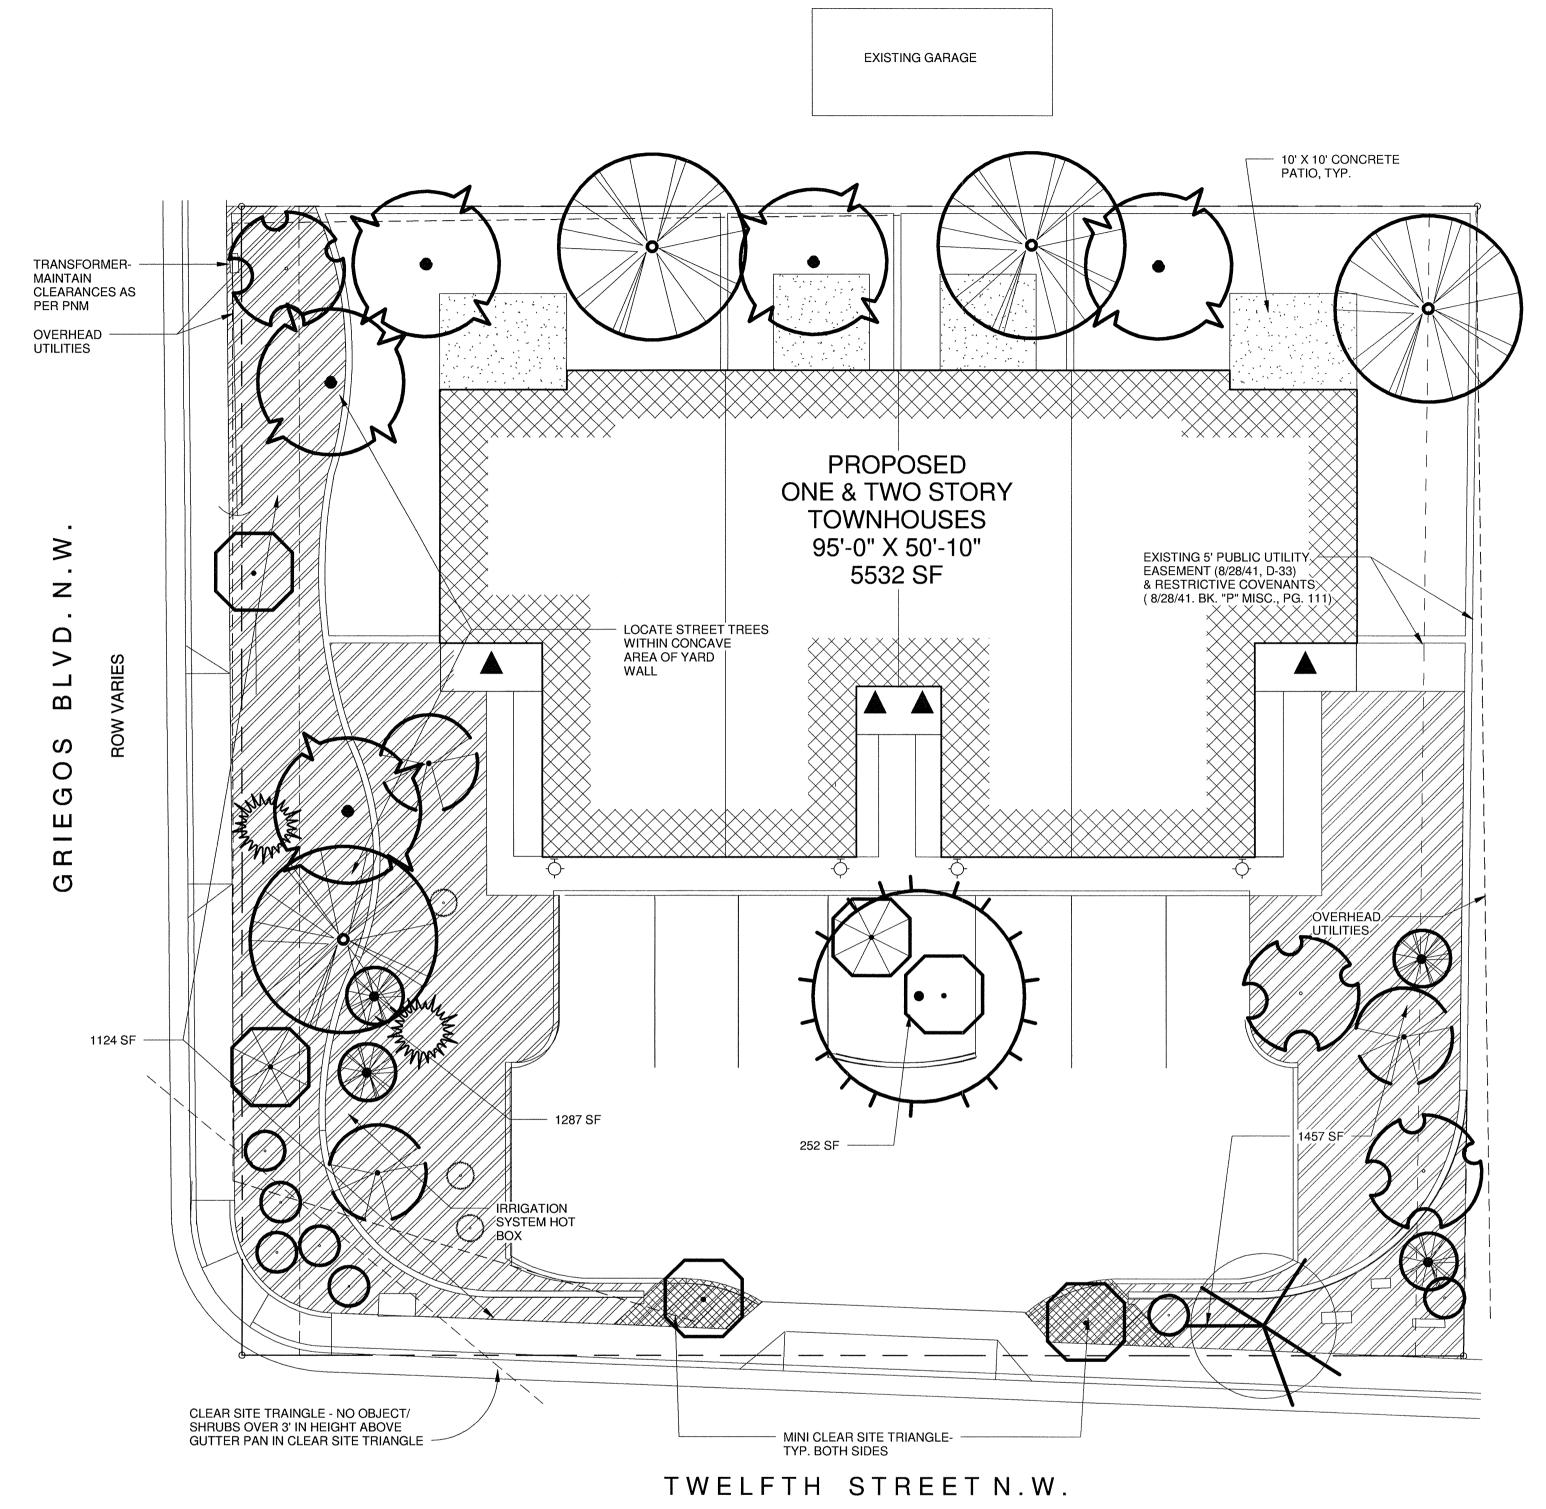

ROW VARIES

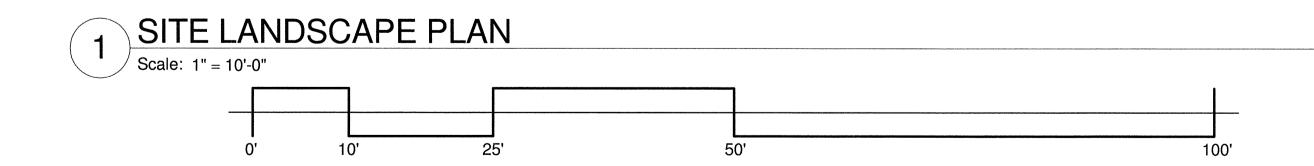

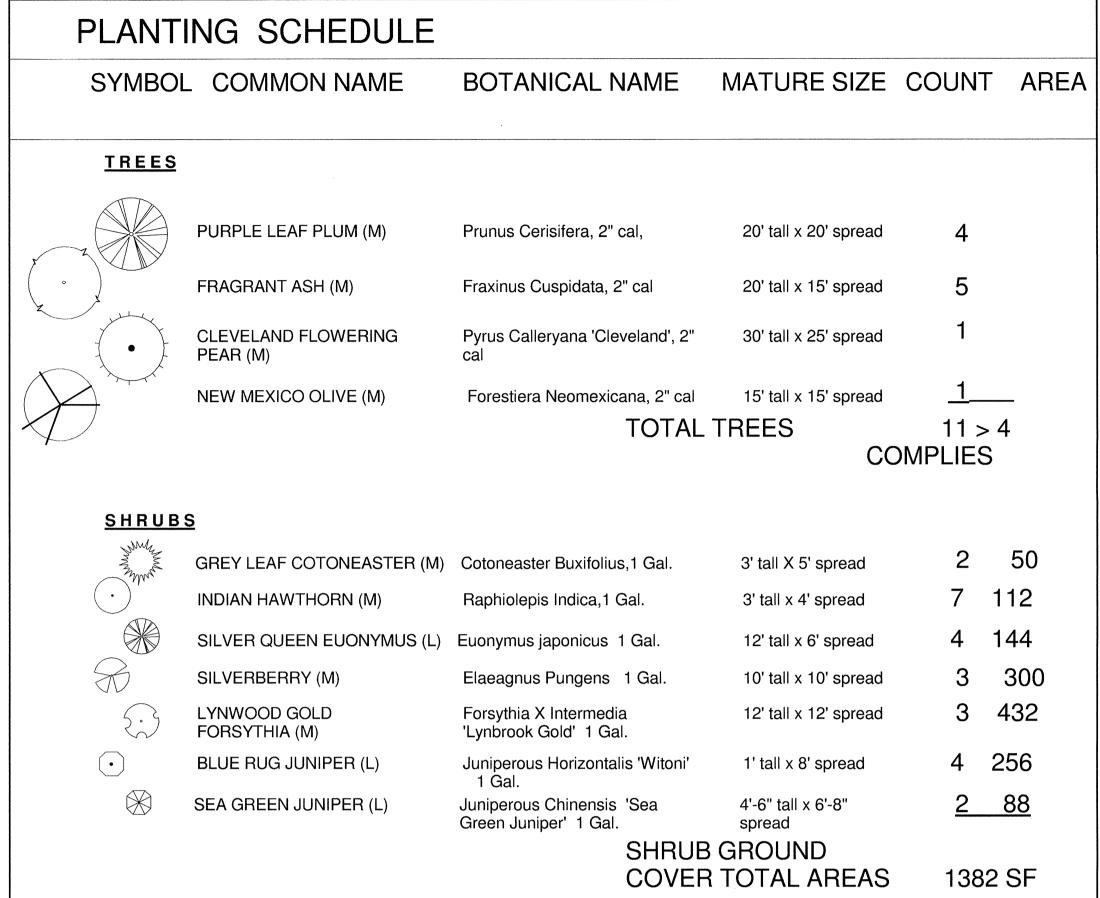

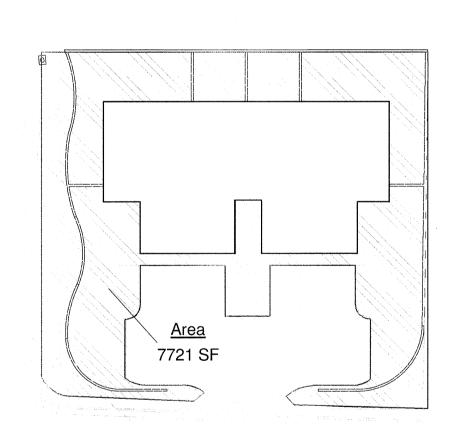


USABLE OPEN SPACE -1203 GRIEGOS RD. NW

HOT BOX INSULATED BACKFLOW


BACKFLOW PREVENTION DETAIL

DEVICE ENCLOSURE

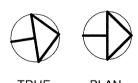


OPEN SPACE

USABLE OPEN SPACE: REQUIRED OPEN SPACE: 4 UNITS X 550 = 2,200 SF UOS PROVIDED = 7721 SF COMPLIES

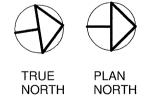

HATCH LEGEND

ACCEPTABLÈ IN THIS AREA.

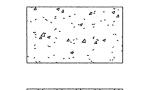

4" CONCRETE SIDEWALK, DRIVEWAY AND COMMONS AREA SLABS

LANDSCAPING

& NOTES

LOT: .3519A X 43560 = 15,329 SF

PLANT WATERING SHALL BE PROVIDED BY A DRIP IRRIGATION SYSTEM. CONTROLLERS SHALL BE PROVIDED IN THE NUMBER AND SPACING REQUIRED

LANDSCAPING AND SIGNING SHALL NOT INTERFERE WITH CLEAR SITE

REQUIREMENTS, THEREFORE SIGNS, TREES AND SHRUBS BETWEEN 3' AND 8' TALL (AS MEASURED FROM THE GUTTER PAN) SHALL NOT BE

THE PROJECT SHALL COMPLY WITH THE CITY OF ALBUQUERQUE ZONING ORDINANCE - 14-16-3-10, GENERAL LANDSCAPE REGULATIONS

ALL LANDSCAPING, INCLUDING LANDSCAPING IN THE RIGHT OF WAY, SHALL BE

BY ZONE SPECIFICATION AND LOCATION. CONTROLLERS SHALL BE

MAINTAINED AND REPLACED, IF NECESSARY, BY THE OWNER.

THE PROJECT SHALL COMPLY WITH THE "WATER CON-

SERVATION AND WATER WASTE ORDINANCE" - ARTICLE

4,097 SF)


LANDSCAPE CALCULATION:

4120 SF COMPLIES

.75 X 1685 SF = 1264 SF

INSTALLED ON OWNERS HOUSE ELECTRICAL



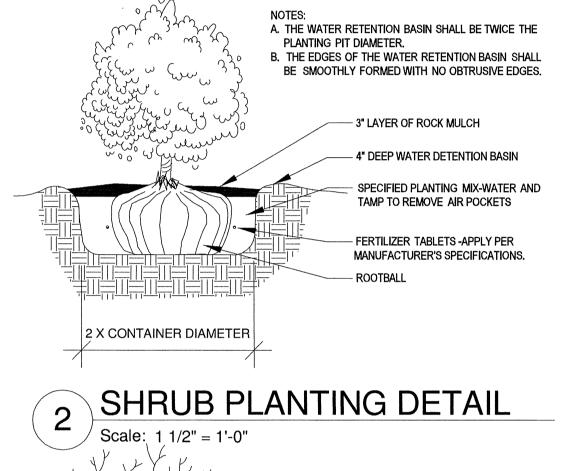

A. THE WATER RETENTION BASIN SHALL BE TWICE THE

B. THE EDGES OF THE WATER RETENTION BASIN SHALL BE SMOOTHLY FORMED WITH NO OBTRUSIVE EDGES. C. REMOVE ROPE AND BURLAP AFTER PLANTING.

PLANTING PIT DIAMETER.


3" LAYER OF ROCK MULCH CALCULATIONS 4" WATER RETENTION BASIN ORIGINAL GRADE OF SLOPE SPECIFIED PLANTING MIX -WATER & TAMP TO REMOVE AIR POCKETS FERTILIZER TABLETS AND H2O POLYMER CRYSTALS AS REQUIRED BY MFGR ROOTBALL REQUIRED LANDSCAPING: 11,232 X 15% = 1685 SF LANDSCAPING (HATCHED, EXCLUSIVE OF REAR YARDSPROVIDED: 2 X CONTAINER DIAMETER REQUIRED 75% VEGETATIVE GROUND COVER = TREE PLANTING WELL VEGETATIVE GROUND COVER PROVIDED: 1382 SF COMPLIES

Scale: 1 1/2" = 1'-0"

Roger Cinelli & Assoc 2418 Manuel Torres Lane N.W. Albuquerque, New Mexico 87107 ARCHITECTS (505) 243-8211


4 UNIT TOWNHOUSE DEV. FOR JASON BUCHANAN 1203 GRIEGOS ROAD N.W. ALBUQUERQUE, NEW MEXICO

DRAWING TITLE: SITE LANDSCAPE PLAN

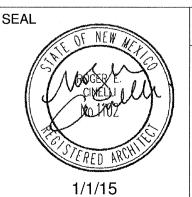


PROJECT NO. FEB. 12, 2015 BUCH 6E DRAWING NO.

GRAVEL AREAS @ UNIT ENTRY ALCOVES ARE NOT INCLUDED IN PROPOSED LANDSCAPE AREAS

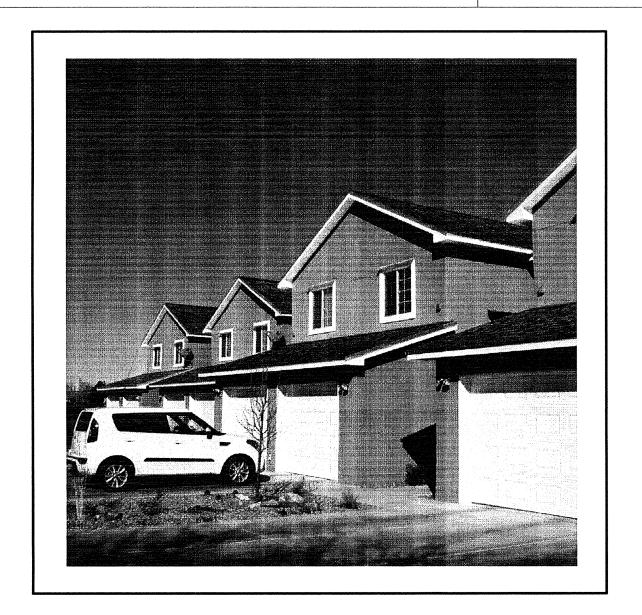


10 PERSPECTIVE - 10TH & CANDELARIA PROTOTYPE

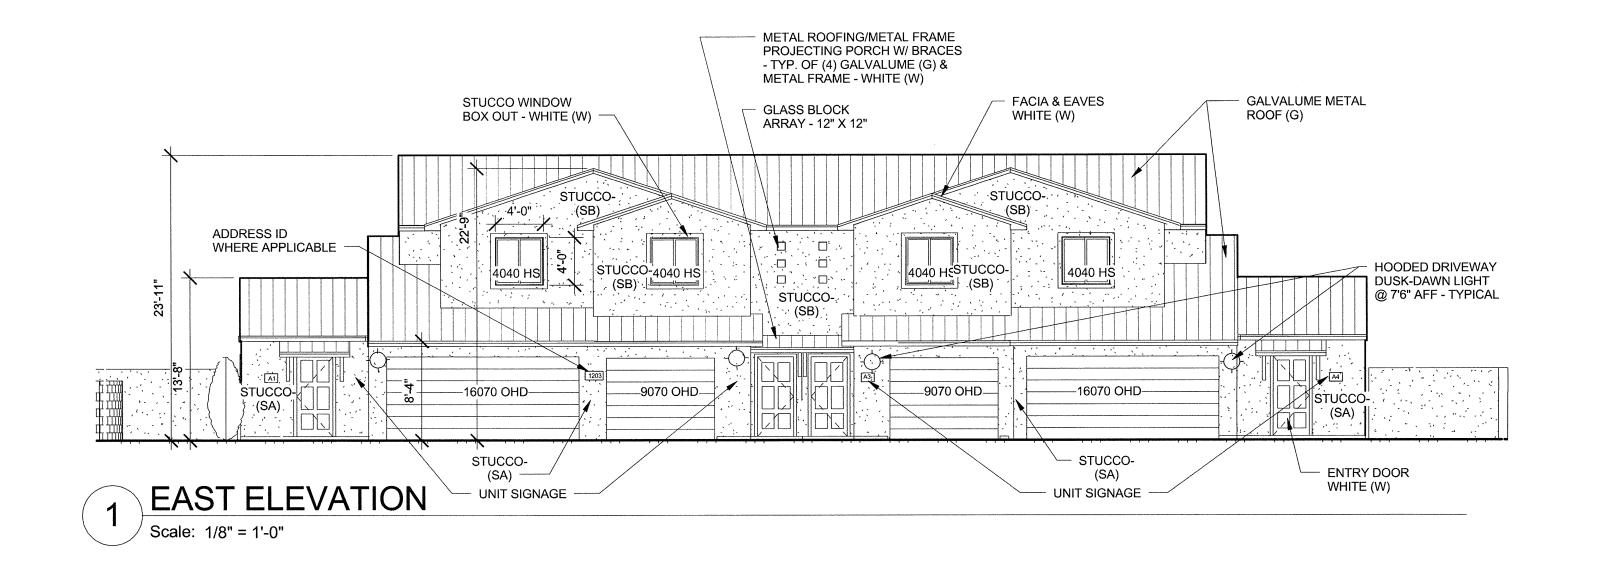





9 WALL MOUNTED DAWN TO DUSK LIGHT FIXTURE
NOT TO SCALE"

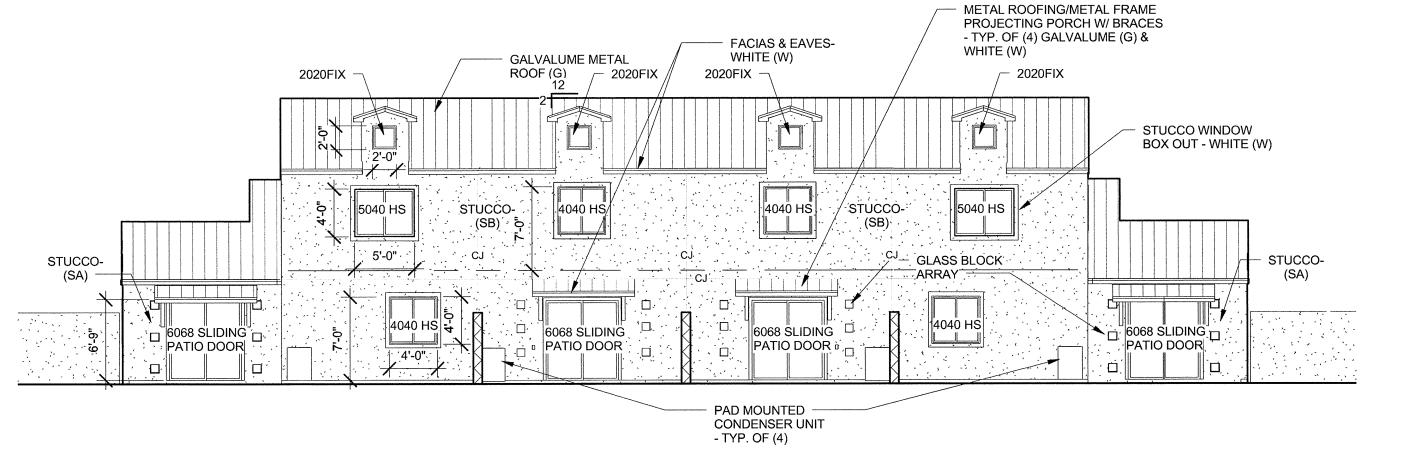

2 WEST ELEVATION
Scale: 1/8" = 1'-0"

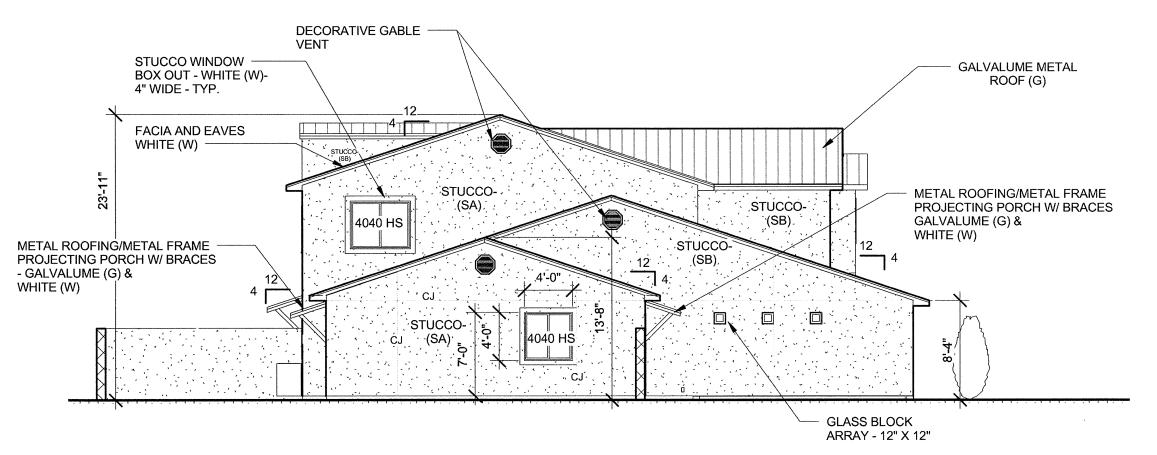

3 SOUTH ELEVATION
Scale: 1/8" = 1'-0"

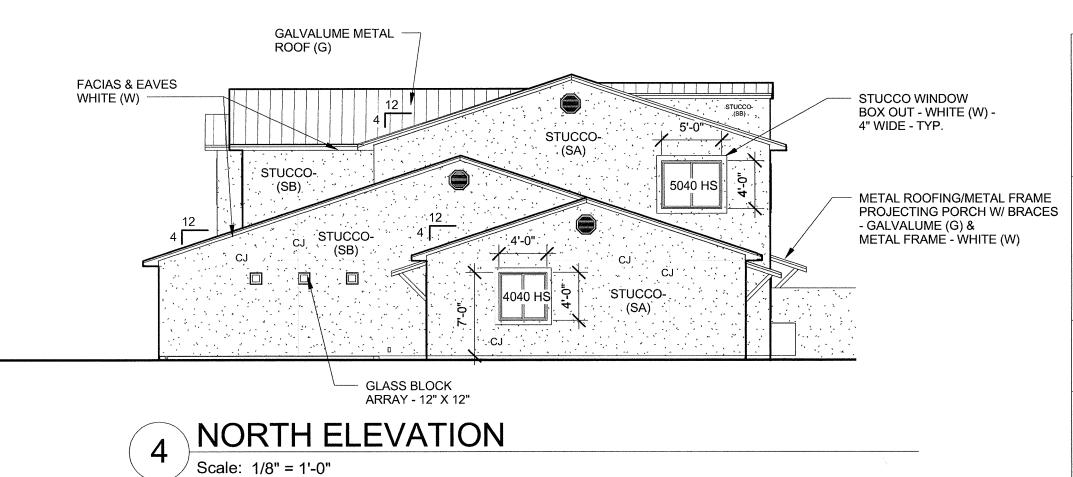

BUILDING AND FENCE COLORS

METAL ROOF: GALVALUME (G)

STUCCO COLORS:
STUCCO (SA) EL REY BUCKSKIN
STUCCO (SB) EL REY SANTA FE BROWN

PORCH METAL FRAME COLOR: WHITE (W)

VINYL WINDOW W/ DIVIDERS COLOR: WHITE (W)

ENTRY DOOR COLOR: WHITE (W)


STUCCO TRIM: (AT WINDOWS) WHITE (W)

Roger Cinelli & Assoc.
2418 Manuel Torres Lane N.W.
Albuquerque, New Mexico 87107
(505) 243-8211

PROJECT TITLE:

4 UNIT TOWNHOUSE DEV. FOR JASON BUCHANAN 1203 GRIEGOS ROAD N.W. ALBUQUERQUE, NEW MEXICO

DRAWING TITLE:
ELEVATIONS & DETAILS

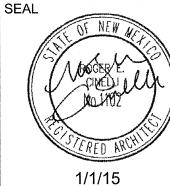

DATE
JAN. 1, 2015
DRAWING NO

DRAWING NO.

5

PROJECT NO.

BUCH 6D