



OVERALL PROPERTY MAP 1" = 100'

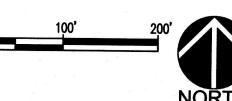


	VICINITY MAP (Zone Atlas Map No. K-20) N.T.S.	AS-BUILT INFORMATION CONTRACTOR WORK STAKED BY INSPECTOR'S ACCEPTANCE BY FIELD VERFICATION BY DRAWINGS CORRECTED BY MICRO-FILM INFORMATION RECORDED BY NO.
	SITE INFORMATION Site Area: 4.35 acres (approx.) Legal Description: Municipal Addition No. 2, Tract 3, Exc Nly 354' and Portions out to R/W Cont. Current Zoning: SU-1 National Guard Armory and PRD Existing Land Use: Public/Institutional Proposed Zoning: SU-1 Parks and Recreation Proposed Land Use: park, active and passive recreation Applicable Plans: none Pedestrian Ingress and Egress: See Sheet 2 Vehicular Ingress and Egress: See Sheet 2 Internal Circulation: See Sheet 2 Maximum Building Height: n/a Maximum Building Setback: n/a Maximum Floor Area Ratio (F.A.R.): n/a	BENCH MARKS
	 PARKING CALCULATIONS Standard Parking Spaces Required: Pursuant to 14.16.22(c), off-street parking shall be provided as required by Planning Commission in SU-1 zone. No specific off-street requirements for park facilities are included in zoning code. Standard Parking Spaces Provided: 9 Accessible Parking Spaces Required: 1 (1 per 25) Accessible Parking Spaces Provided: 4 (all Van Accessible) Motorcycle Spaces Required: 1 (1 per 25) Motorcycle Spaces Provided: 2 Bicycle Parking Required: 2 Bicycle Parking Provided: 5 	SURVEY INFORMATION FIELD NOTES NO. BY DATE
	1. Noise a. No park feature that may possibly be constructed in the future will exceed noise levels permitted by City Noise Ordinance. 2. Vending a. If farmers' market or food truck vending are proposed in the future, all vending will occur within Park boundaries proper with access from existing parking lot. 3. Hours of Operation a. Park will be open the standard hours of 6:00 am to 10:00 pm.	GRECORY MILLER GRECORY MILLER 17 GRECORY MILLER 17 GRECORY MILLER 17 GRECORY MILLER 17 18 19 19 19 19 19 19 19 19 19
	PROYECT: 1010-158 DATE: 8-12-15 APP: 15-70278	REVISIONS REMARKS DATE DATE X/X/XXXX DATE X/X/XXXX
PROJECT NUMBER: APPLICATION NUMBER: IS AN INFRASTRUCTURE LIST REQUIRED? () YES () NO IF YES, THEN A APPROVED DRC PLANS WITH A WORK ORDER IS REQUIRED FOR ANY CO WITHIN PUBLIC RIGHT-OF-WAY OR FOR CONSTRUCTION OF PUBLIC IMPEDRE SITE DEVELOPMENT PLAN APPROVAL:	ONSTRUCTION	1 5/22/15 EPC 2 8/4/15 DRB NO. DATE DESIGNED BY GM/AZ DRAWN BY AZ CHECKED BY GM
TRAFFIC ENGINEERING, TRANSPORTATION DIVISION ABCWUA	DATE DATE	QUE D DESIGN
PARKS AND RECREATION DEPARTMENT CITY ENGINEER	SOUTH LOS ALTOS CHILDREN' SITE PLAN FOR SUBDIVIS DATE Design Review Committee City Engineer Approval	'S PARK SION Mo./Day/Yr. Mo./Day/Yr.
*ENVIRONMENTAL HEALTH DEPARTMENT - (CONDITIONAL) SOLID WASTE MANAGEMENT DRB CHAIRPERSON, PLANNING DEPARTMENT	DATE DATE DATE City Project No. Zone Map No.	Sheet Of
		Sheet Of

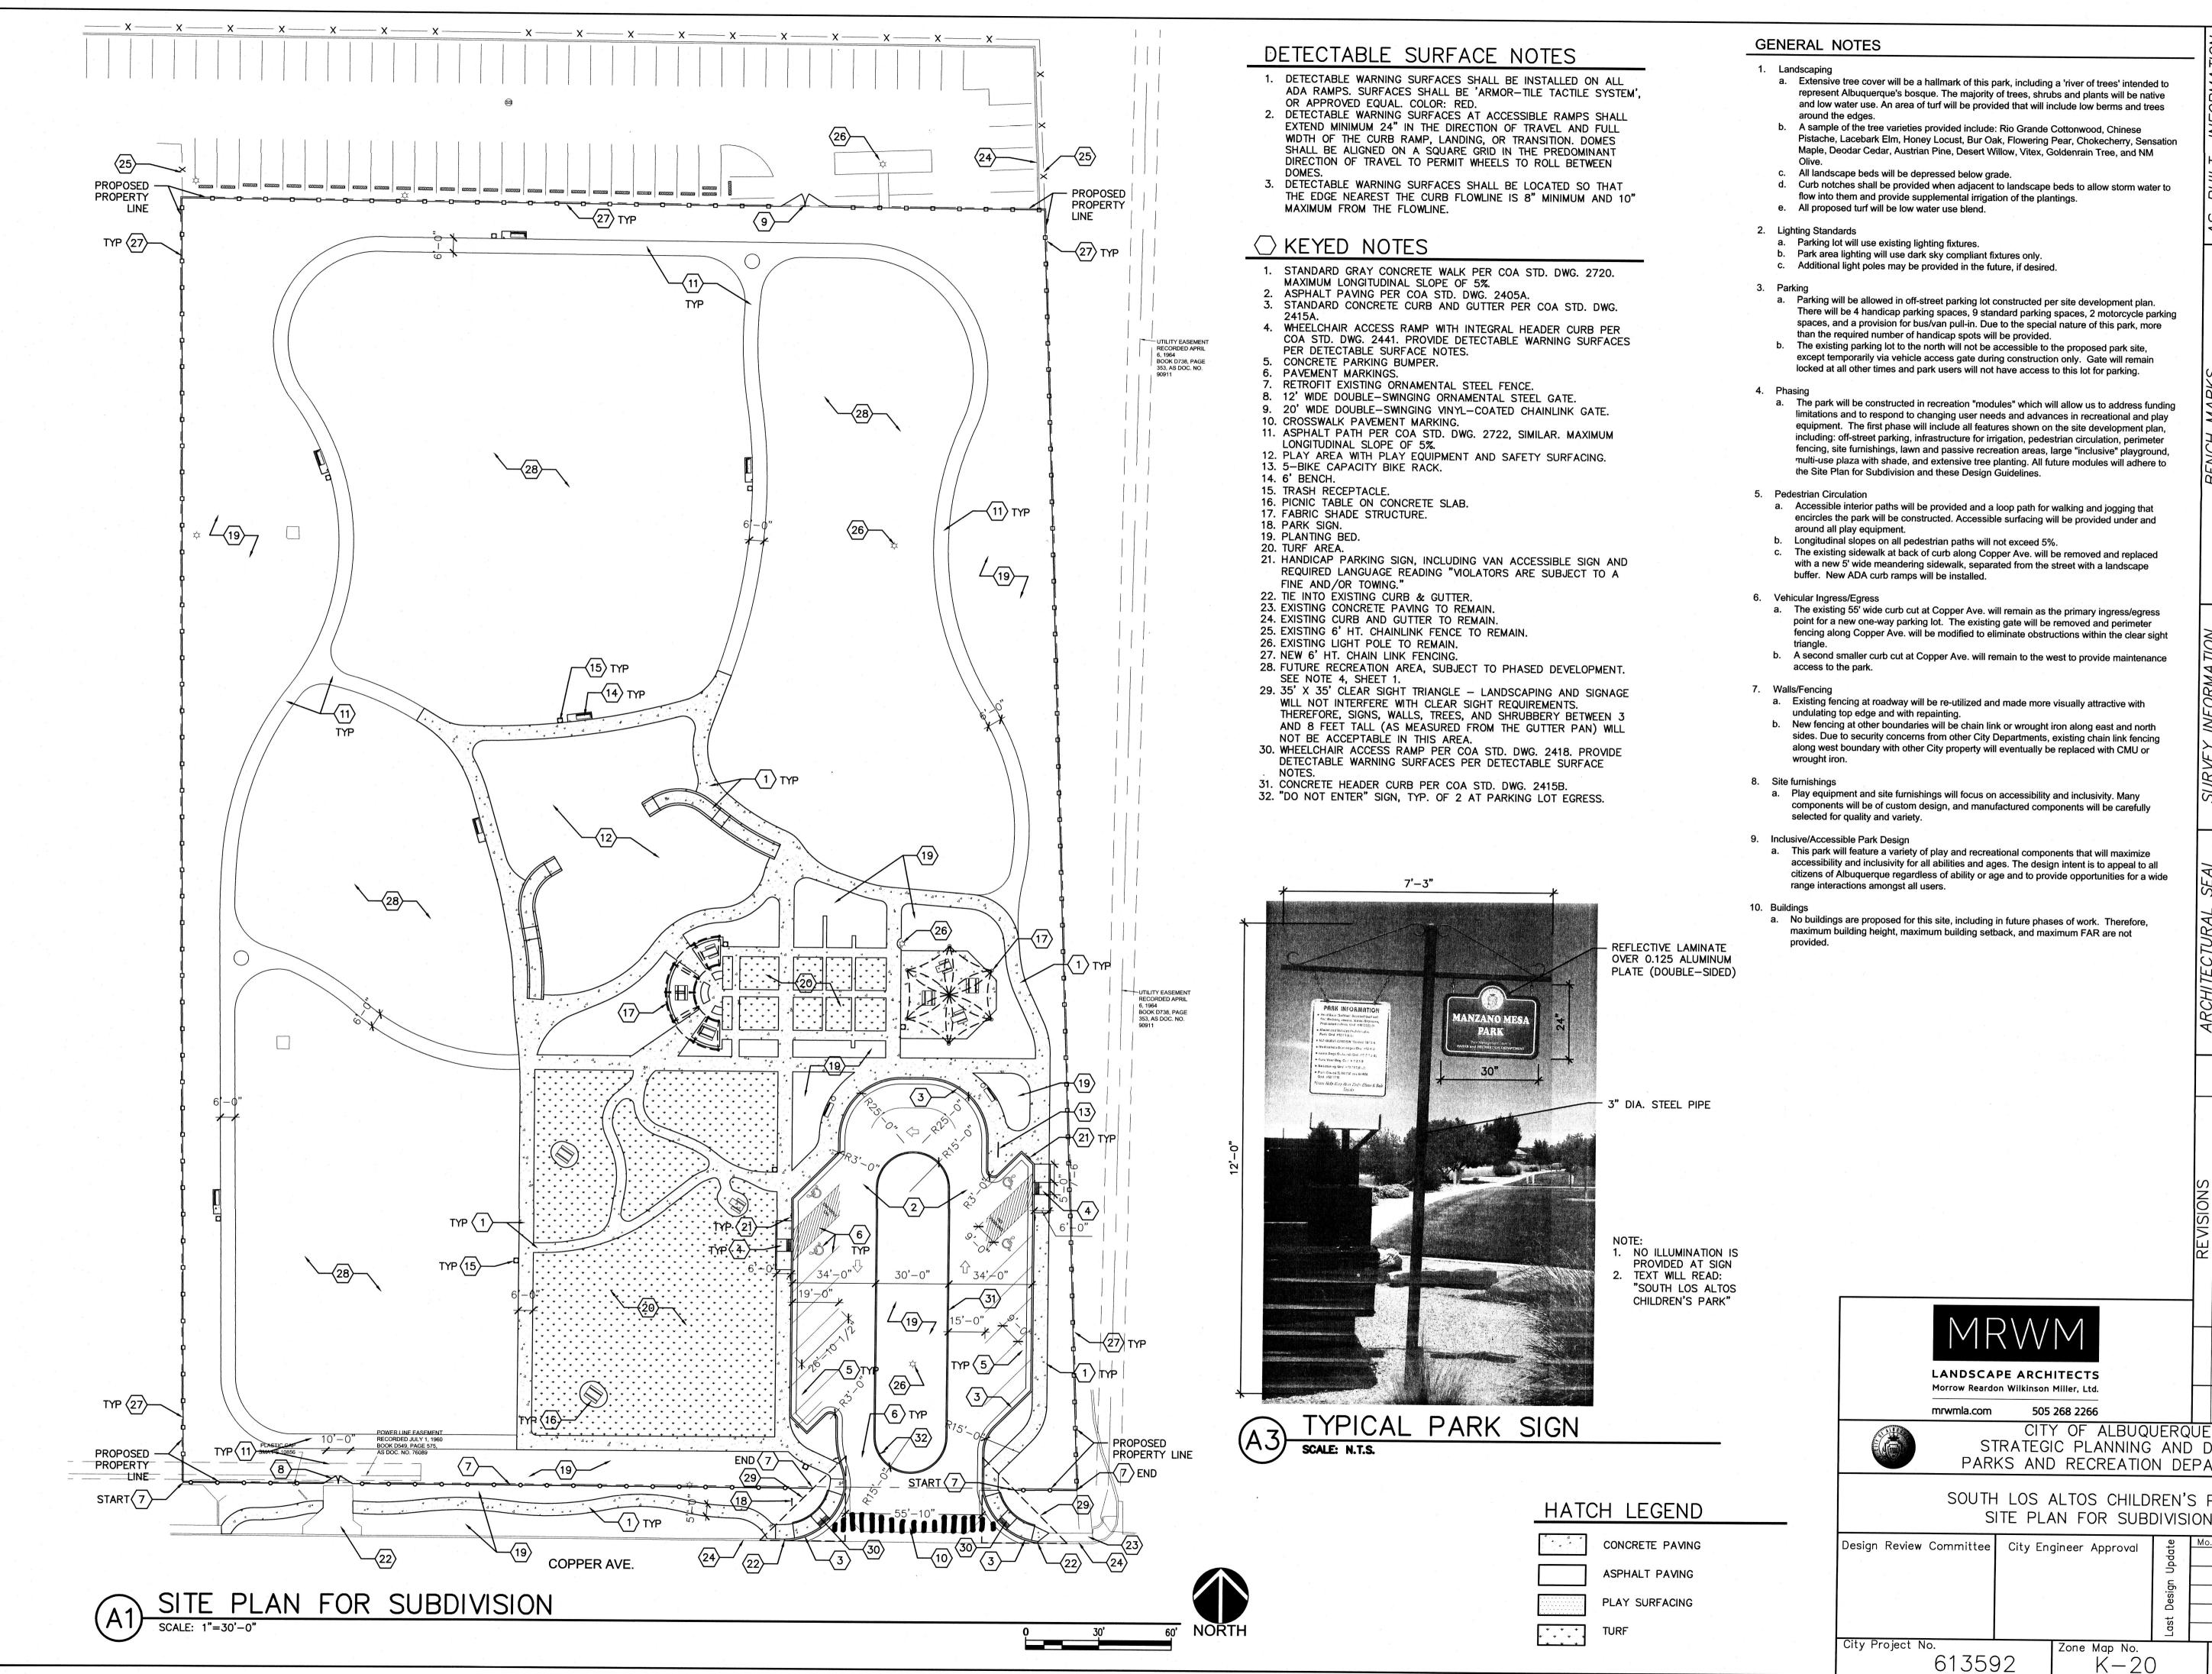

DATE MA a. Extensive tree cover will be a hallmark of this park, including a 'river of trees' intended to represent Albuquerque's bosque. The majority of trees, shrubs and plants will be native and low water use. An area of turf will be provided that will include low berms and trees b. A sample of the tree varieties provided include: Rio Grande Cottonwood, Chinese Pistache, Lacebark Elm, Honey Locust, Bur Oak, Flowering Pear, Chokecherry, Sensation Maple, Deodar Cedar, Austrian Pine, Desert Willow, Vitex, Goldenrain Tree, and NM d. Curb notches shall be provided when adjacent to landscape beds to allow storm water to a. Parking will be allowed in off-street parking lot constructed per site development plan. There will be 4 handicap parking spaces, 9 standard parking spaces, 2 motorcycle parking spaces, and a provision for bus/van pull-in. Due to the special nature of this park, more b. The existing parking lot to the north will not be accessible to the proposed park site, except temporarily via vehicle access gate during construction only. Gate will remain locked at all other times and park users will not have access to this lot for parking. a. The park will be constructed in recreation "modules" which will allow us to address funding limitations and to respond to changing user needs and advances in recreational and play equipment. The first phase will include all features shown on the site development plan, including: off-street parking, infrastructure for irrigation, pedestrian circulation, perimeter fencing, site furnishings, lawn and passive recreation areas, large "inclusive" playground, multi-use plaza with shade, and extensive tree planting. All future modules will adhere to a. Accessible interior paths will be provided and a loop path for walking and jogging that encircles the park will be constructed. Accessible surfacing will be provided under and c. The existing sidewalk at back of curb along Copper Ave. will be removed and replaced with a new 5' wide meandering sidewalk, separated from the street with a landscape a. The existing 55' wide curb cut at Copper Ave. will remain as the primary ingress/egress point for a new one-way parking lot. The existing gate will be removed and perimeter fencing along Copper Ave. will be modified to eliminate obstructions within the clear sight b. A second smaller curb cut at Copper Ave. will remain to the west to provide maintenance a. Existing fencing at roadway will be re-utilized and made more visually attractive with b. New fencing at other boundaries will be chain link or wrought iron along east and north sides. Due to security concerns from other City Departments, existing chain link fencing along west boundary with other City property will eventually be replaced with CMU or a. Play equipment and site furnishings will focus on accessibility and inclusivity. Many components will be of custom design, and manufactured components will be carefully a. This park will feature a variety of play and recreational components that will maximize accessibility and inclusivity for all abilities and ages. The design intent is to appeal to all citizens of Albuquerque regardless of ability or age and to provide opportunities for a wide a. No buildings are proposed for this site, including in future phases of work. Therefore, maximum building height, maximum building setback, and maximum FAR are not

> STRATEGIC PLANNING AND DESIGN PARKS AND RECREATION DEPARTMENT

SOUTH LOS ALTOS CHILDREN'S PARK SITE PLAN FOR SUBDIVISION

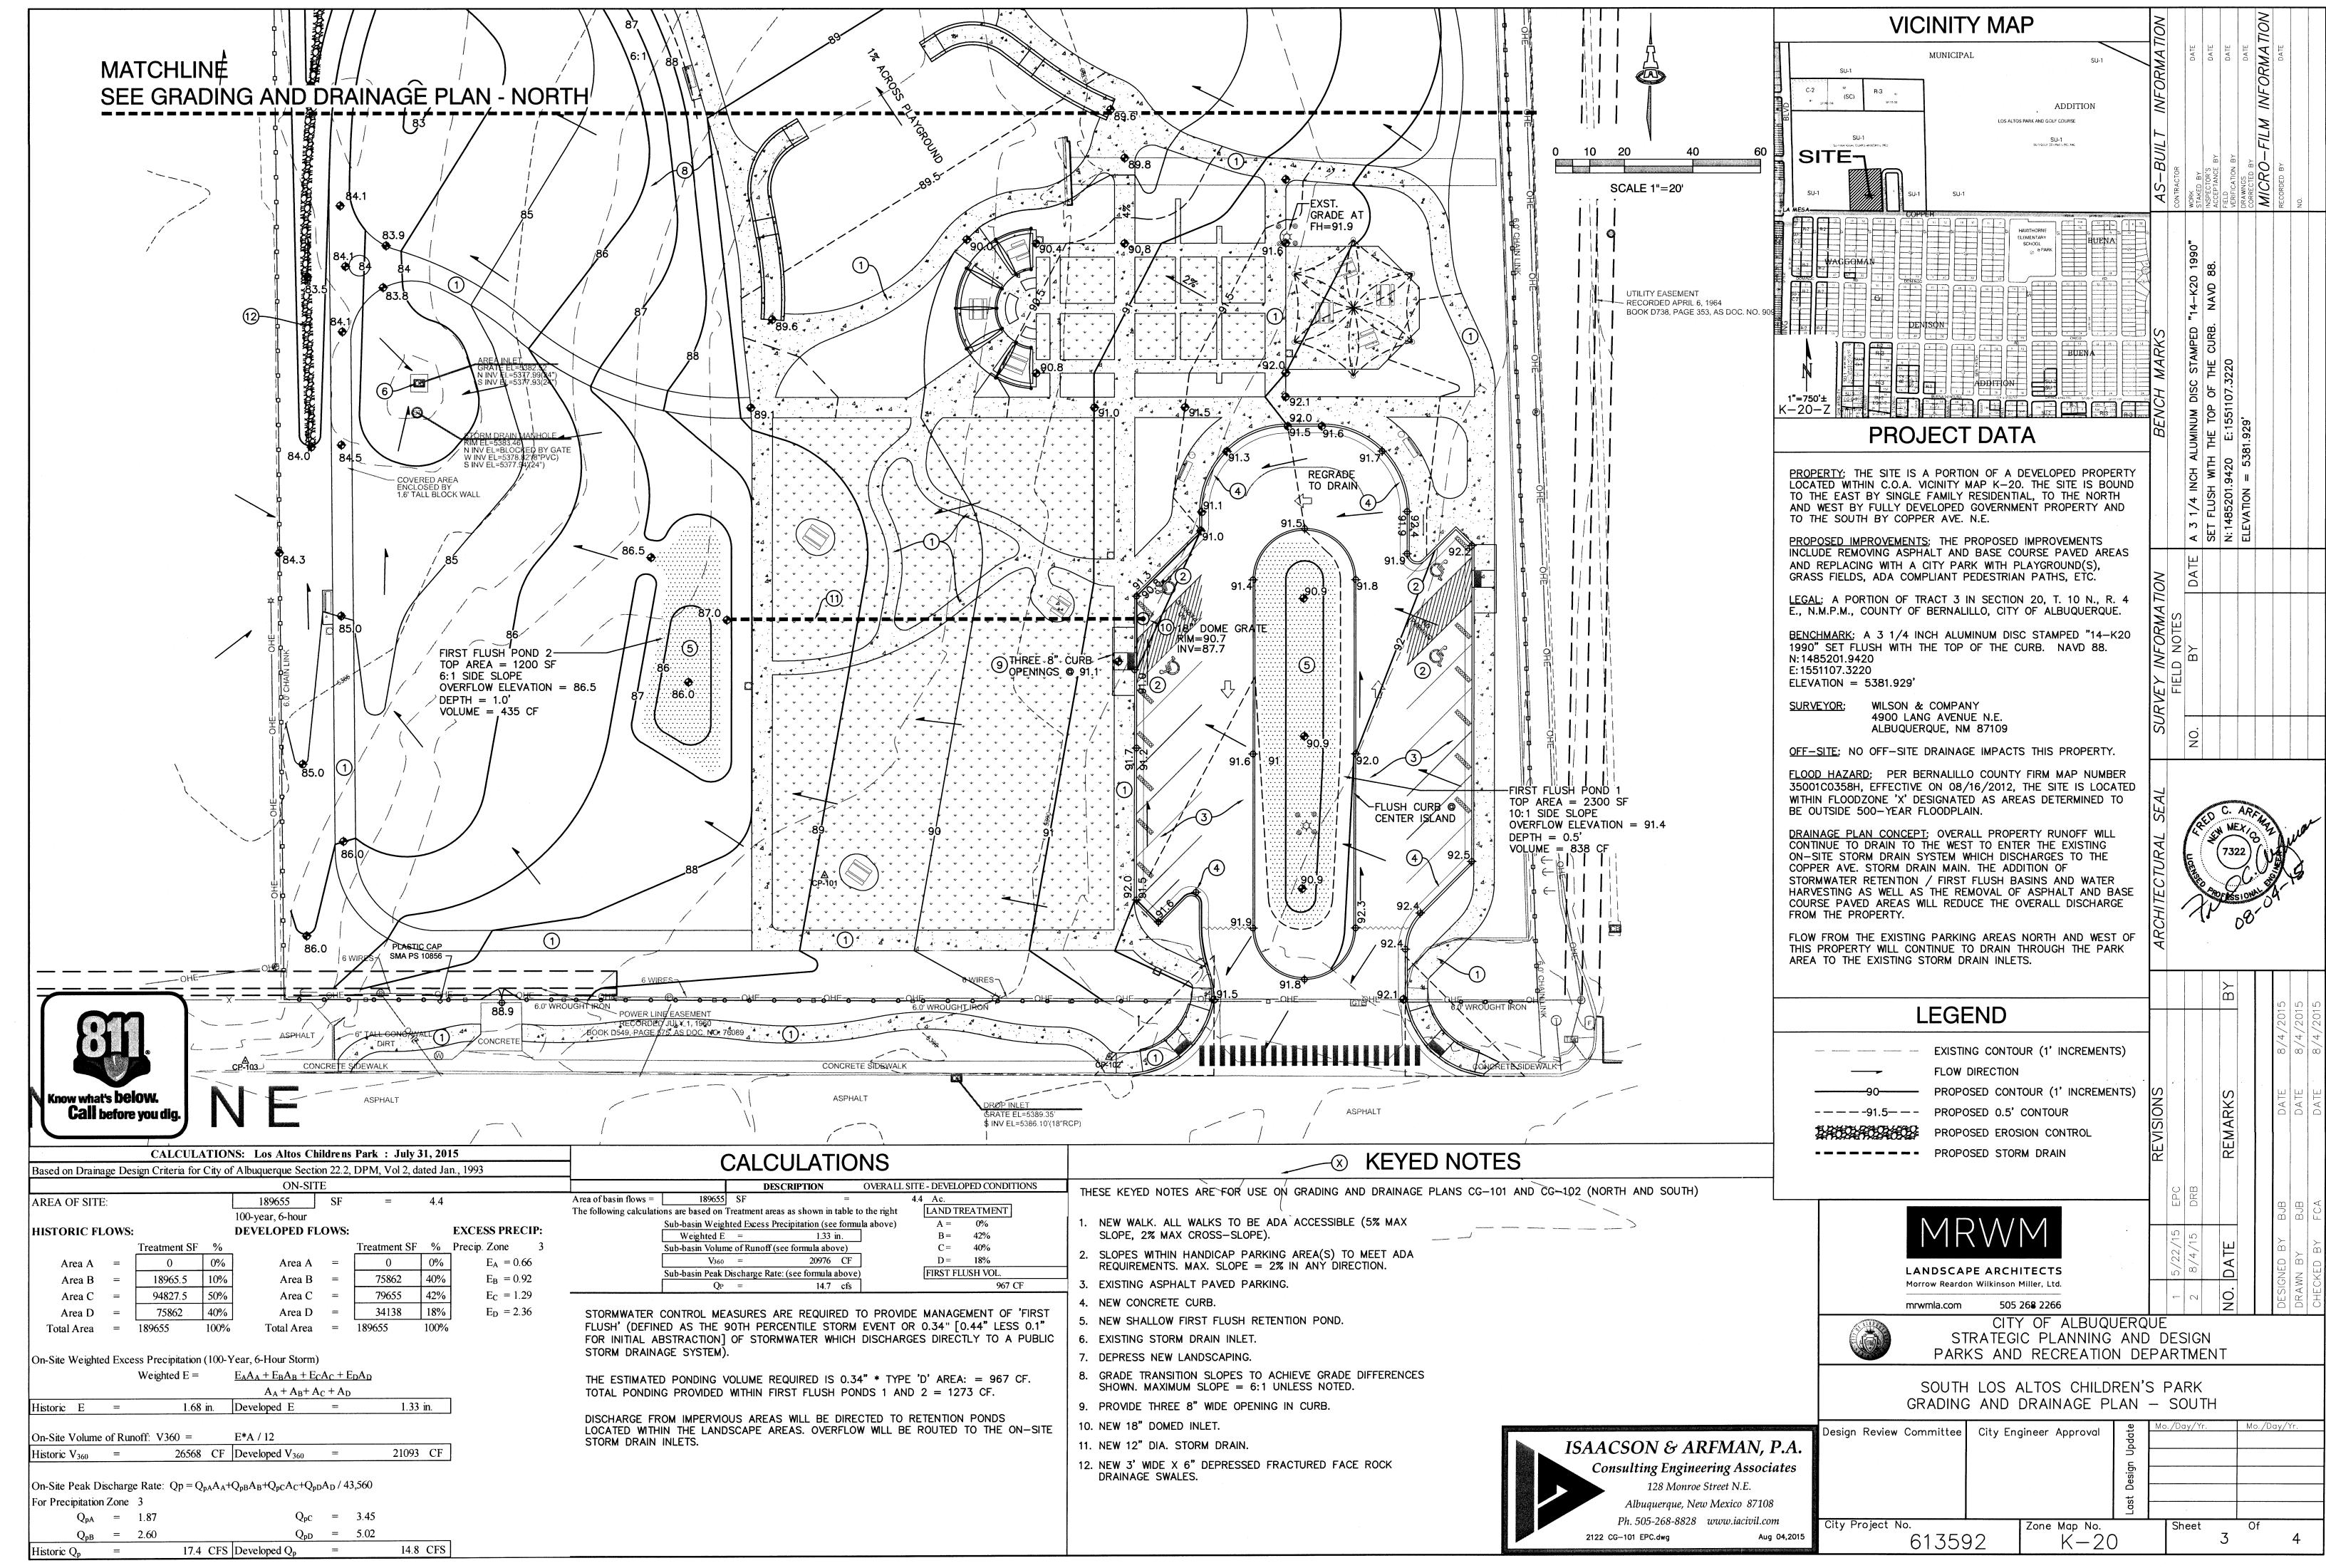

1

DΒ

0 SF

IION = 86.5

