

LEGEND

□ □ □ □ DENOTES PROPERTY LINE

1 BUILDING NUMBER

TYPE 2 BUILDING TYPE

DENOTES ACCESSIBLE PARKING AND ANSI TYPE 'A' DWELLING UNIT

DENOTES TRANSFORMER LOCATION

DENOTES WATER METER LOCATION

LIGHTING LEGEND

•□ LED POLE LIGHT. +15' T.O.F. TYPE AS SHOWN ON PLAN.

LED POST TOP LIGHT. +15' T.O.F. OR UNLESS NOTED OTHERWISE ON PLAN. TYPE AS SHOWN ON PLAN.

→ LED CARPORT LIGHT. TYPE 'CP'.

LED WALL MINI WALL PACK. +10' B.O.F. TYPE 'WP'.

LED WALL SCONCE. DECORATIVE. +6' B.O.F. TYPE 'WS'.

GENERAL NOTES

THE PROPOSED BUILDING TYPE IS A FLEX BUILDING. PER THE FLEX BUILDING REQUIREMENTS, THE MARRIOT SPRINGHILL SUITES WILL BE A STANDARD RECTANGULAR URBAN BUILDING FORM, AND ACCESS TO THE LEVELS ABOVE THE STRUCTURED PARKING WILL BE PROVIDED VIA A GROUND FLOOR LOBBY WITH DIRECT ACCESS TO THE STREET. PARKING WILL BE LOCATED UNDER THE PRINCIPAL BUILDING AND IN A COMMON ON-STREET PARKING AREA. THE GROUND LEVEL FRONTAGE FOR THE

BUILDING'S GROUND FLOOR LOBBY WILL BE GLASS STOREFRONT. ALL IMPROVEMENTS LOCATED IN THE RIGHT OF WAY MUST BE INCLUDED ON A WORK ORDER WITH DRC APPROVED PLANS.

PREVIOUS BUILDINGS WILL BE DEMOLISHED. ALL EXISTING DOORS, STRUCTURES, SIDEWALKS, CURBS, DRIVE PADS, WALL AND ANYTHING THAT INFLUENCES THE PARKING AND CIRCULATION ARE IDENTIFIED ON THE SITE PLAN.

LANDSCAPING, FENCING, AND SIGNING WILL NOT INTERFERE WITH CLEAR SIGHT REQUIREMENTS. THEREFORE, SIGNS, WALLS, TREES, AND SHRUBBERY BETWEEN 3 AND 8 FEET TALL (AS MEASURED FROM THE

GUTTER PAN) WILL NOT BE ACCEPTABLE IN THE CLEAR SIGHT TRIANGLE PROVIDE NEW CURB AND GUTTER WITH ON STREET PARKING ON ALL 4 SIDE PER STD DWG 2415A, 2418, 2406 AND ANY OTHER THAT MAY APPLY. ALL UNUSED CURB CUTS SHALL BE REPLACED WITH NEW CURB & GUTTER AND SIDEWALKS.

THE PROPOSED DEVELOPMENT WILL FEATURE AN APPROXIMATELY 15-FOOT-WIDE URBAN PEDESTRIAN REALM ALONG CENTRAL AVENUE AND MULBERRY STREET THAT WILL INTERACT WITH THE BUILDING FRONTAGE AND ADJACENT RIGHT-OF-WAY. THE PEDESTRIAN AREA WILL BE AN INVITING AND PLEASANT ENVIRONMENT FOR WALKERS, GUESTS, AND OTHER VISITORS. THIS AREA WILL FEATURE STREET TREES, PLANTERS, SPECIALTY PAVING, GLAZING, AND OTHER AMENITIES. THIS AREA IS CONSISTENT WITH THE FORM BASED CODE, WHICH SPECIFIES A "USABLE PEDESTRIAN REALM" THAT ACCOMMODATES STREET DESIGN AND

APPROPRIATE BUILDING PLACEMENT. ACCESSIBLE PARKING SPACES MUST HAVE A SIGN THAT INCLUDES THE INTERNATIONAL SYMBOL OF ACCESSIBILITY AND STATE "RESERVED PARKING." ACCESSIBLE VAN PARKING SPACES WILL STATE "VAN ACCESSIBLE". ACCESSIBLE SIGN WILL BE 12"WX18"H AND VAN ACCESSIBLE SIGN WILL BE 12"WX6"H. SYMBOL OF ACCESSIBILITY SHOULD BE 4"H. SIGNS WILL HAVE GREEN LETTERING AND BORDER ON A WHITE BACKGROUND. SIGNS SHOULD BE MOUNTED AT LEAST 60 INCHES ABOVE PARKING SURFACE.

8. THE ADA ACCESS AISLES SHALL HAVE THE WORDS "NO PARKING" IN CAPITAL LETTERS, EACH OF WHICH SHALL BE AT LEAST ONE FOOT HIGH AND AT LEAST TWO INCHES WIDE, PLACED AT THE REAR OF THE PARKING SPACE SO AS TO BE CLOSE TO WHERE AN ADJACENT VEHICLE'S REAR TIRE WOULD BE PLACED. (66-1-4.1.B NMSA 1978)

WILL BE PROVIDED FROM THE PUBLIC SIDEWALK TO THE BUILDING ENTRANCES. 10. WHEELCHAIR RAMPS REQUIRED BY ADA, WILL BE PROVIDED. WHEELCHAIR

RAMPS LOCATED WITHIN THE PUBLIC RIGHT OF WAY MUST HAVE DETECTABLE WARNING SURFACES, "CAST-IN-PLACE" TRUNCATED DOMES. 11. ALL CURB RAMPS WILL MEET THE 2010 ADA STANDARD REQUIREMENTS FOR NEWLY CONSTRUCTED OR ALTERED STREETS AND STREET-LEVEL

PEDESTRIAN WALKWAYS. 12. WORK WITHIN THE PUBLIC RIGHT OF WAY REQUIRES A WORK ORDER WITH DRC APPROVED PLANS.

13. LANDSCAPING AND SIGNAGE WILL NOT INTERFERE WITH CLEAR SIGHT REQUIREMENTS. THEREFORE, SIGNS, WALLS, TREES, AND SHRUBBERY BETWEEN 3 AND 8 FEET TALL (AS MEASURED FROM THE GUTTER PAN) WILL NOT BE ACCEPTABLE IN THE CLEAR SIGHT TRIANGLE. 14. REFER TO SHEET 7 OF 8 FOR PEDESTRIAN REALM DIAGRAMS.

15. 6 FT SIDEWALKS SURROUNDING BUILDING MUST BE KEPT FREE AND CLEAR WITHIN THE WALKING ZONE.

16. FUTURE CHANGES TO PROPOSED SIGNAGE CAN BE AMENDED

ADMINISTRATIVELY. SIGNAGE WILL COMPLY WITH 14-16-3-22(8)(3)(N) AND 14-16-3-22(C)(7) AND WILL REMAIN WITHIN THE PROPERTY LINE. 17. BUILDING MOUNTED LIGHTS SHALL BE BETWEEN 6' AND 14' ABOVE ADJACENT GRADE. SEE 14-16-3-22(C)(6) FOR DETAILS AND OTHER

REFERENCES. 18. EQUIPMENT SCREENING WILL COMPLY WITH SCREENING REQUIREMENTS IN SECTION 14-16-3-18(C)(6)(A) OF THE CITY OF ALBUQUERQUE ZONING

19. THE 20 PERCENT BUILDING HEIGHT MODIFICATION WILL COMPLY WITH SECTION 14-16-3-22(A)(6)(B)(1)(C) OF THE CITY OF ALBUQUERQUE ZONING CODE.

20. MULBERRY STREET AND COPPER AVENUE RIGHTS-OF-WAY HAVE BEEN VACATED. AN OFFICIAL NOTICE OF DECISION WAS ISSUED BY THE CITY PLANNING DEPARTMENT ON JANUARY 23, 2017 FOR PROJECT #1010879, 16DRB-70447. THE PLAT ASSOCIATED WITH THIS ACTION WAS RECORDED

ON JUNE 13, 2017 FOR PROJECT #1010879, 17DRB-70119. DETAIL TO BE PROVIDED IN BUILDING PERMIT SET FOR FIRE AND SOLID

KEYNOTES

9'x18' PARKING SPACE, TYPICAL.

4'x8' MOTORCYCLE PARKING SPACE.

8'x18' ACCESSIBLE PARKING SPACE. ACCESSIBLE GARAGE SPACE. BICYCLE PARKING. 5 SPACES PROVIDED.

ACCESSIBLE DRIVEWAY CROSSING PAINTED MARKING. TRASH ENCLOSURE WITH COMPACTOR SURROUNDED BY 8' CMU WALL WITH EIFS FINISH TO MATCH THE BUILDING. SEE SHEET 8 OF 8 FOR

TRASH ENCLOSURE PLANS AND ELEVATIONS. ENCLOSED STRUCTURED PARKING GARAGE. 6' SIDEWALK, GRAY CONCRETE COLOR.

25'x25' SIGHT VISIBILITY TRIANGLE AT STREET CORNER. ENHANCED PAVING AT MAIN ENTRY AUTO COURT.

11. AREA EAST OF SIDEWALK FOR RETAIL DEVELOPMENT BY OTHERS.



VICINITY MAP NOT TO SCALE

DEVELOPMENT DATA

NET SITE AREA:

1.23 ACRES (53,549 S.F.) **ZONING AND LAND USE:**

SU-2 FOR CMU (C-2)

PROPOSED: SU-2/SU-1 FOR MIXED USE (FORM BASED CODE) LAND USE: COMMERCIAL

BUILDING HEIGHT

SIDE (W) REAR (N) SIDE (E) FRONT (S) ALLOWED: 72 FEET* 72' 72' 72' 67**'** 67' *60 FEET, PLUS AN ADDITIONAL 20%. DUE TO LOCATION ALONG

TRANSIT CORRIDOR. REFER TO GENERAL NOTE #19.

BUILDING GSF

90,450 SF

SETBACKS REQUIRED:

SIDE (W) REAR (N) SIDE (E) FRONT (S) BUILDINGS 0 10'-0" 0

SETBACKS PROVIDED

SIDE (W) REAR (N) SIDE (E) FRONT (S) BUILDINGS 71'-1" 30'-1" 19'-1" 2'-8"

MINIMUM USABLE OPEN SPACE REQUIRED AND PROVIDED REQUIRED (10% OF SITE AREA) 5,355 SQ FT PROVIDED (INCLUDING LANDSCAPING AND PEDESTRIAN-ORIENTED HARDSCAPE) 11,784 SQ FT

PARKING SPA	ACE REQUIREMENTS	
PARKING RATIO REQU	UIRED - 1 SPACE PER 1,000 SF	PARKING
REDUCE E	BY 15% PER TRANSIT REDUCTION	SPACES
Total Pa	arking Spaces Required	73
	ON-STREET PARKING PROVIDED	39
	OFF-STREET PARKING PROVIDED	5
	Total Parking Provided	90
Acce	ssible Parking Required	5
	ON-STREET PARKING PROVIDED	;
	OFF-STREET PARKING PROVIDED	2
Total Acce	ssible Parking Provided	5
Total Motor	rcycle Parking Required	3
Total Moto	rcycle Parking Provided	3
Total B	Sicycle Parking Provided	5

GLAZING CALCULATIONS FOR STREET FACING FACADES (NORTH, WEST, AND SOUTH FACADES)

TOTAL GLAZING AREA AT GROUND FLOOR 403 SF TOTAL AVAILABLE STREET-FACING GROUND FLOOR FACADE AREA | 1,518 SF (EXCLUDES WALL ASSEMBLIES) PERCENTAGE OF GROUND FLOOR STREET FRONTAGE GLAZING TOTAL GLAZING AREA AT UPPER FLOORS | 5,358 SF TOTAL AVAILABLE STREET-FACING FACADE AREA AT UPPER FLOORS 18,574 SF

PERCENTAGE OF STREET FRONTAGE GLAZING AT UPPER FLOORS

(EXCLUDES FLOOR, WALL, AND ROOF ASSEMBLIES)

28.85%

PROJECT NUMBER: Application Number:

This Plan is consistent with the specific Site Development Plan approved by the Environmental Planning Commission (EPC), dated _ Findings and Conditions in the Official Notification of Decision are satisfied.

Is an Infrastructure List required? () Yes () No If yes, then a se of approved DRC plans with a work order is required for any construction within Public Right-of-Way or for construction of public improvements.

DRB SITE DEVELOPMENT PLAN SIGNOFF APPROVAL:

Traffic Engineering, Transportation Division	Date
ABCWUA	Date
Parks and Recreation Department	Date
City Engineer	Date
Solid Waste Management	Date
DRB Chairperson, Planning Department	Date

5G STUDIO COLLABORATIVE 800 JACKSON STREET | SUITE 500 DALLAS, TEXAS 75202 214.670.0050 CONTACT: CHRISTINE ROBBINS-ELROI

ARCHITECT

DRAWINGS AND SPECIFICATIONS AS INSTRUMENTS OF SERVICE ARE THE PROPERTY OF THE ARCHITECT. THEY SHALL NOT BE USED, TRANSFERRED, OR SOLD FOR USE EXCEPT BY AN AGREEMENT IN WRITING FROM THE ARCHITECT.

PRELIMINARY DOCUMENT

NOT FOR CONSTRUCTION

OWNER / DEVELOPER TITAN DEVELOPMENT

6300 RIVERSIDE PLAZA LANE NW, STE 20(ALBUQUERQUE, NEW MEXICO 87120 505.998.0163 CONTACT: JOSH ROGERS

OWNER'S CONSULTANT / OPERATOR INTERMOUNTAIN MANAGEMENT. LLC 2390 TOWER DRIVE MONROE, LOUISIANA 71201

318.812.7126 CONTACT: DAVE RAYMOND

BOHANNAN HUSTON 7500 JEFFERSON STREET NE ALBUQUERQUE, NEW MEXICO 87109 505.823.1000

CONTACT: MIKE BALASKOVITS

CONTACT: MALIK HAKIM

CONSENSUS PLANNING, INC. 302 EIGHTH STREET NW **ALBUQUERQUE, NEW MEXICO 87102** 505.764.9801

PROJECT SPRINGHILL SUITES®

> MARRIOTT **ALBUQUERQUE**

PROJECT ADDRESS **CENTRAL AVE. & MULBERRY ST. ALBUQUERQUE, NM 87106**


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IMM012 PROJECT NUMBER

SITE PLAN FOR **BUILDING PERMIT**


SHEET 1 OF 9

SHEET NUMBER

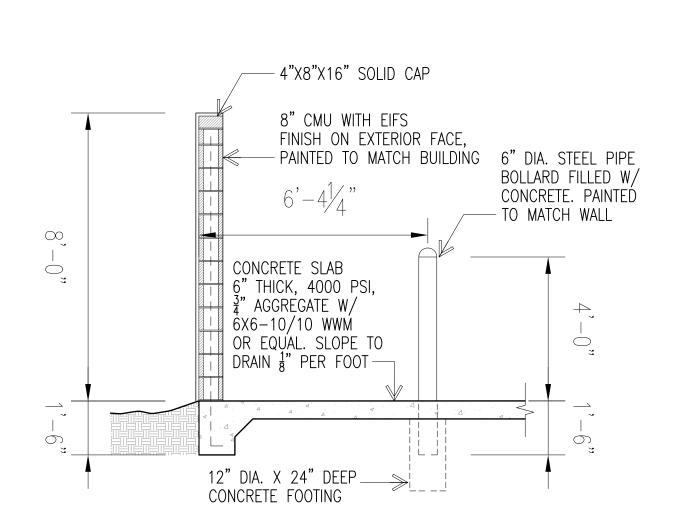

TRASH ENCLOSURE - WALL SECTION


SCALE: 3/8" = 1'-0"

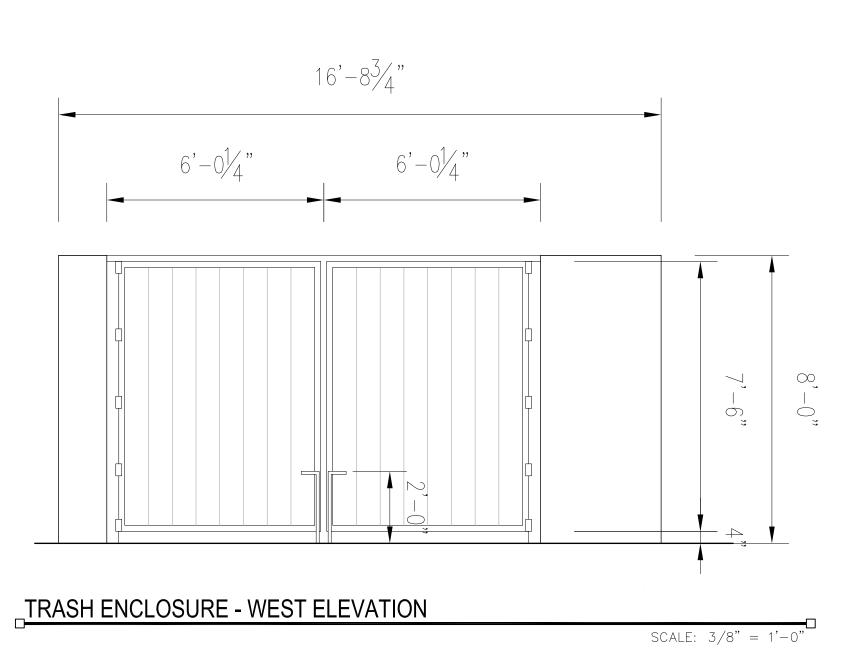

SITEL TUBE 20ST CONCOUNT SIAD CANAL WALL WALL BOTH CONCOUNT SIAD CONCOUN

TRASH ENCLOSURE - PLAN

SCALE: 3/8" = 1'-0"

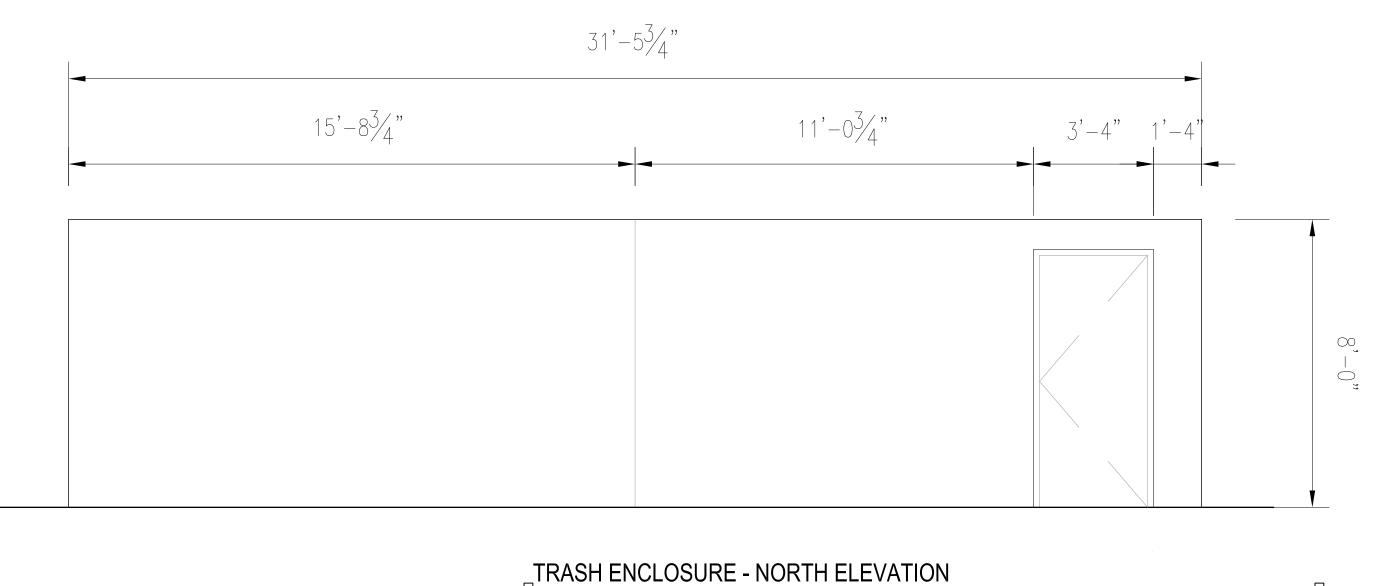

ARCHITECT

5G STUDIO COLLABORATIVE 800 JACKSON STREET | SUITE 500 DALLAS, TEXAS 75202 214.670.0050

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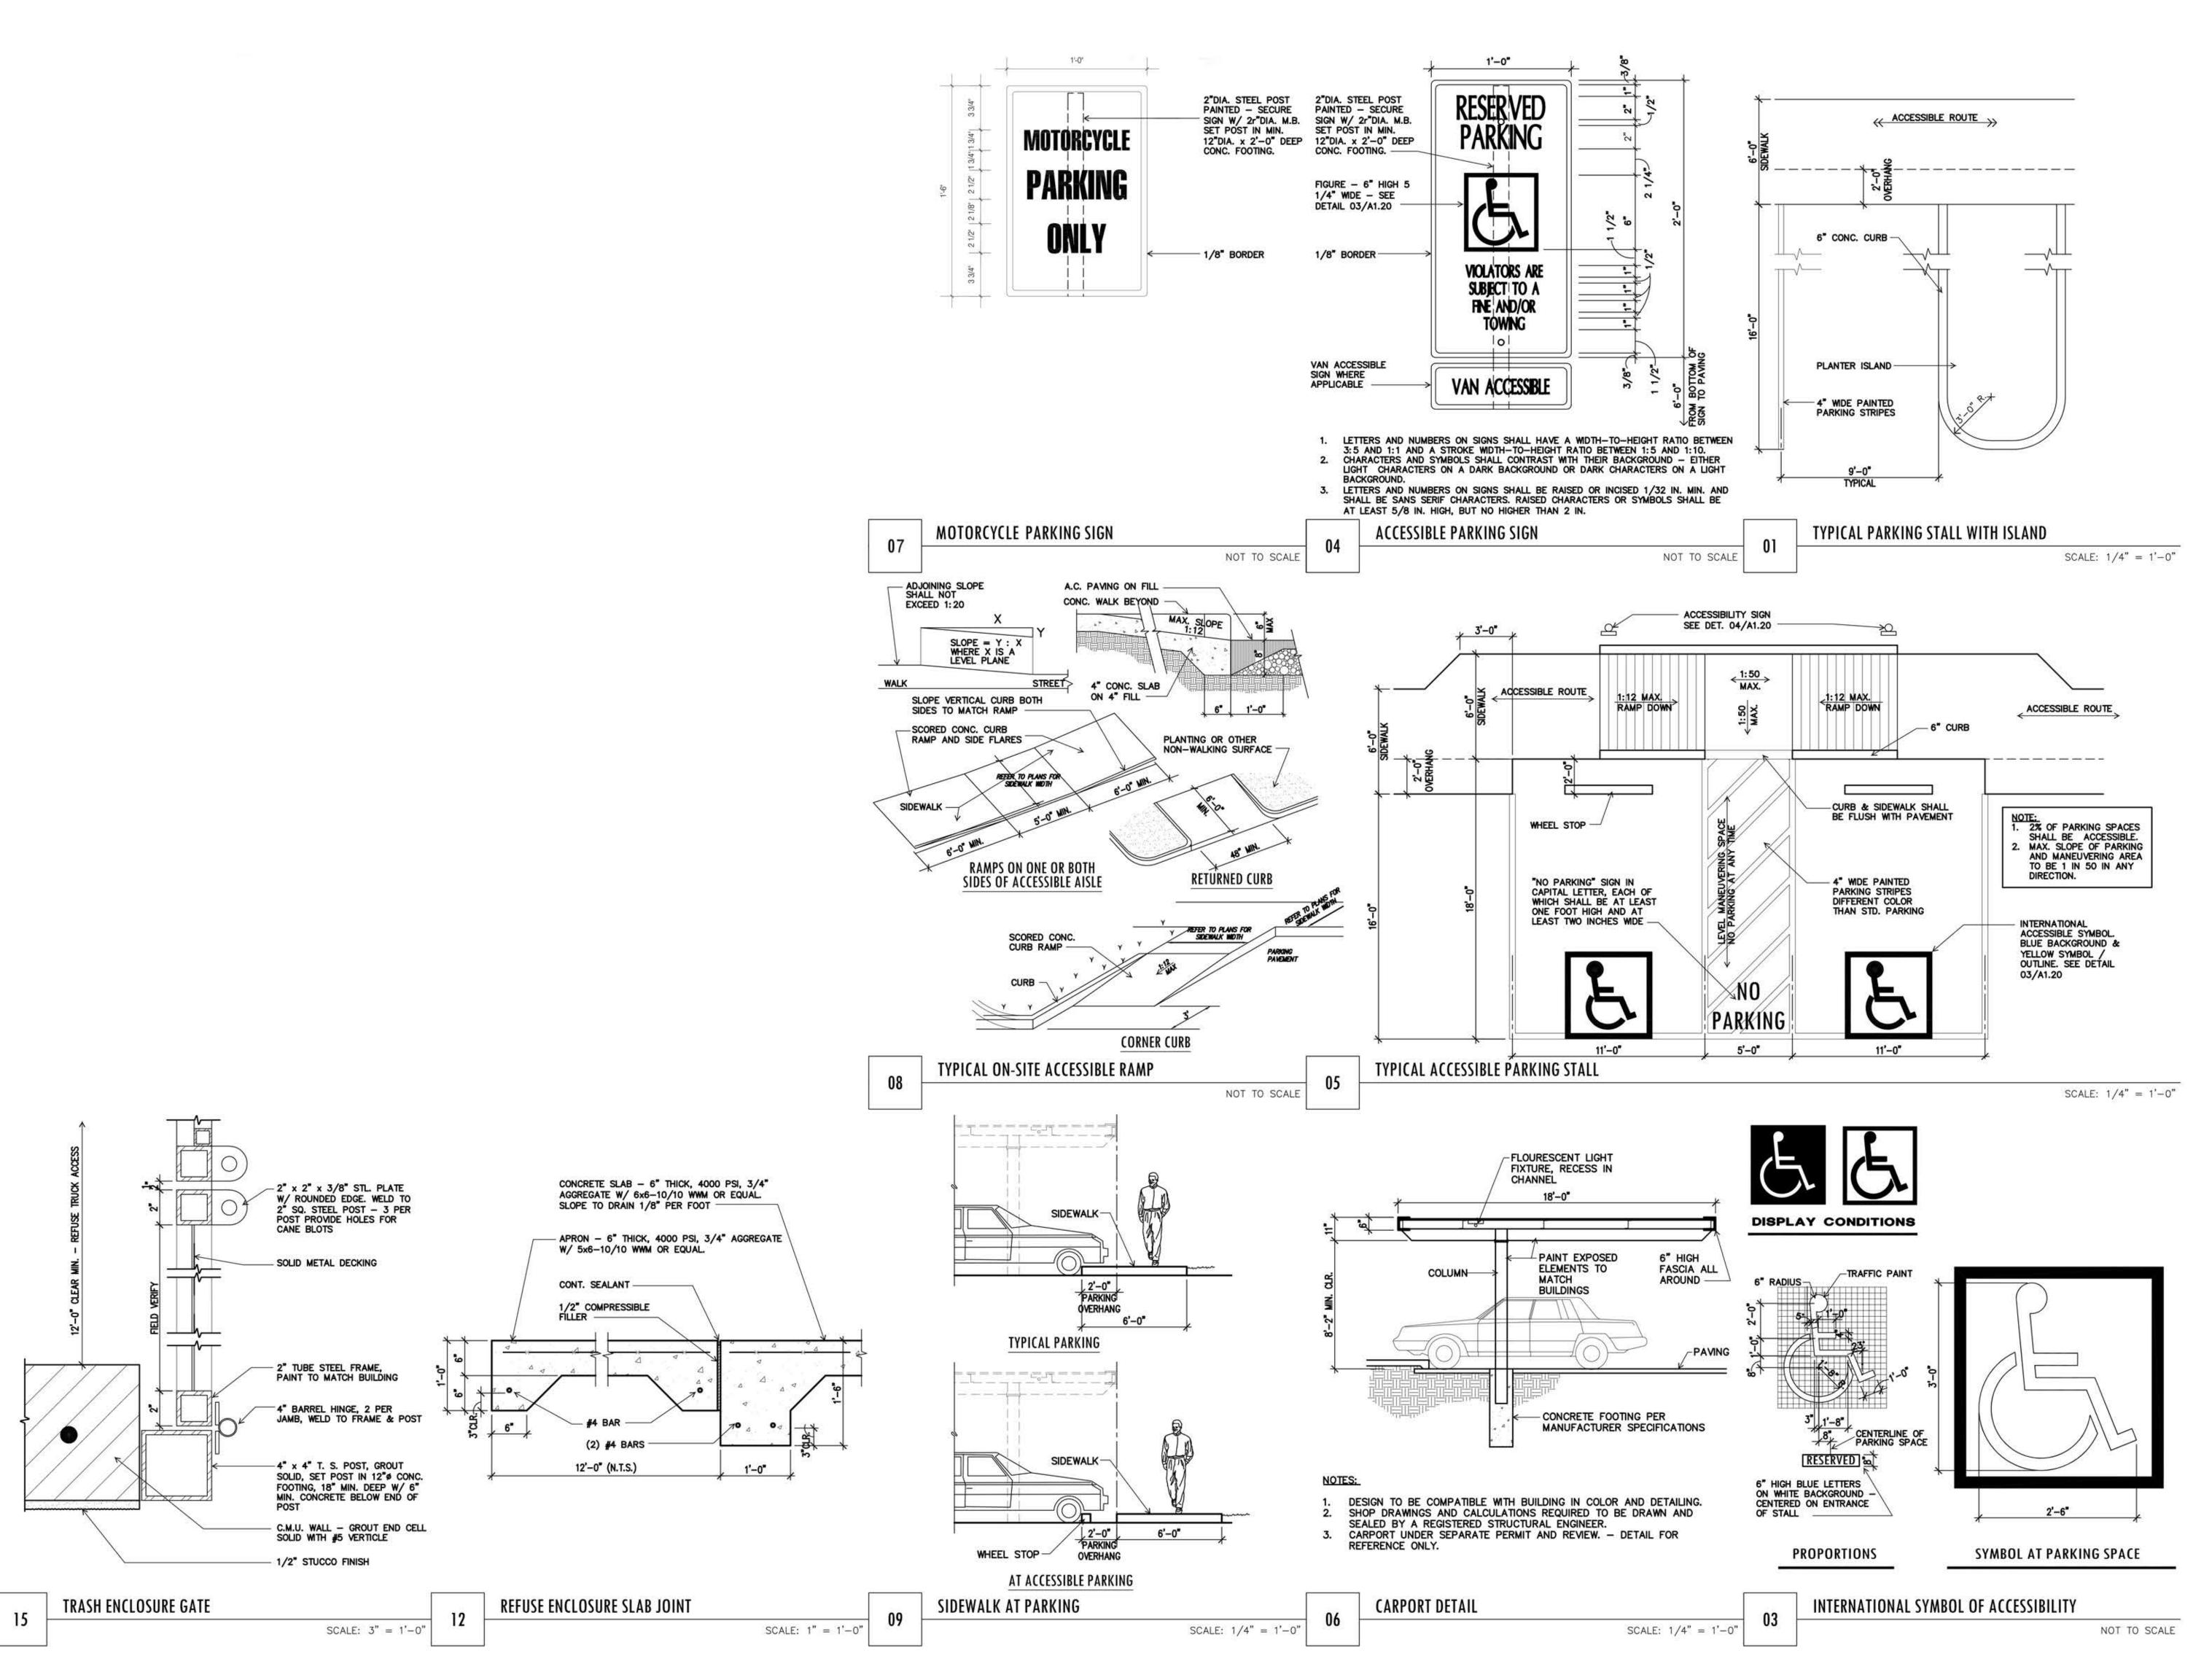
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PROJECT NUMBER

SITE DETAILS

SCALE: 3/8" = 1'-0"

SHEET 8 OF 9

OF 9 SHEET NUMBER



5G STUDIO COLLABORATIVE

800 JACKSON STREET | SUITE 500 DALLAS, TEXAS 75202 214.670.0050

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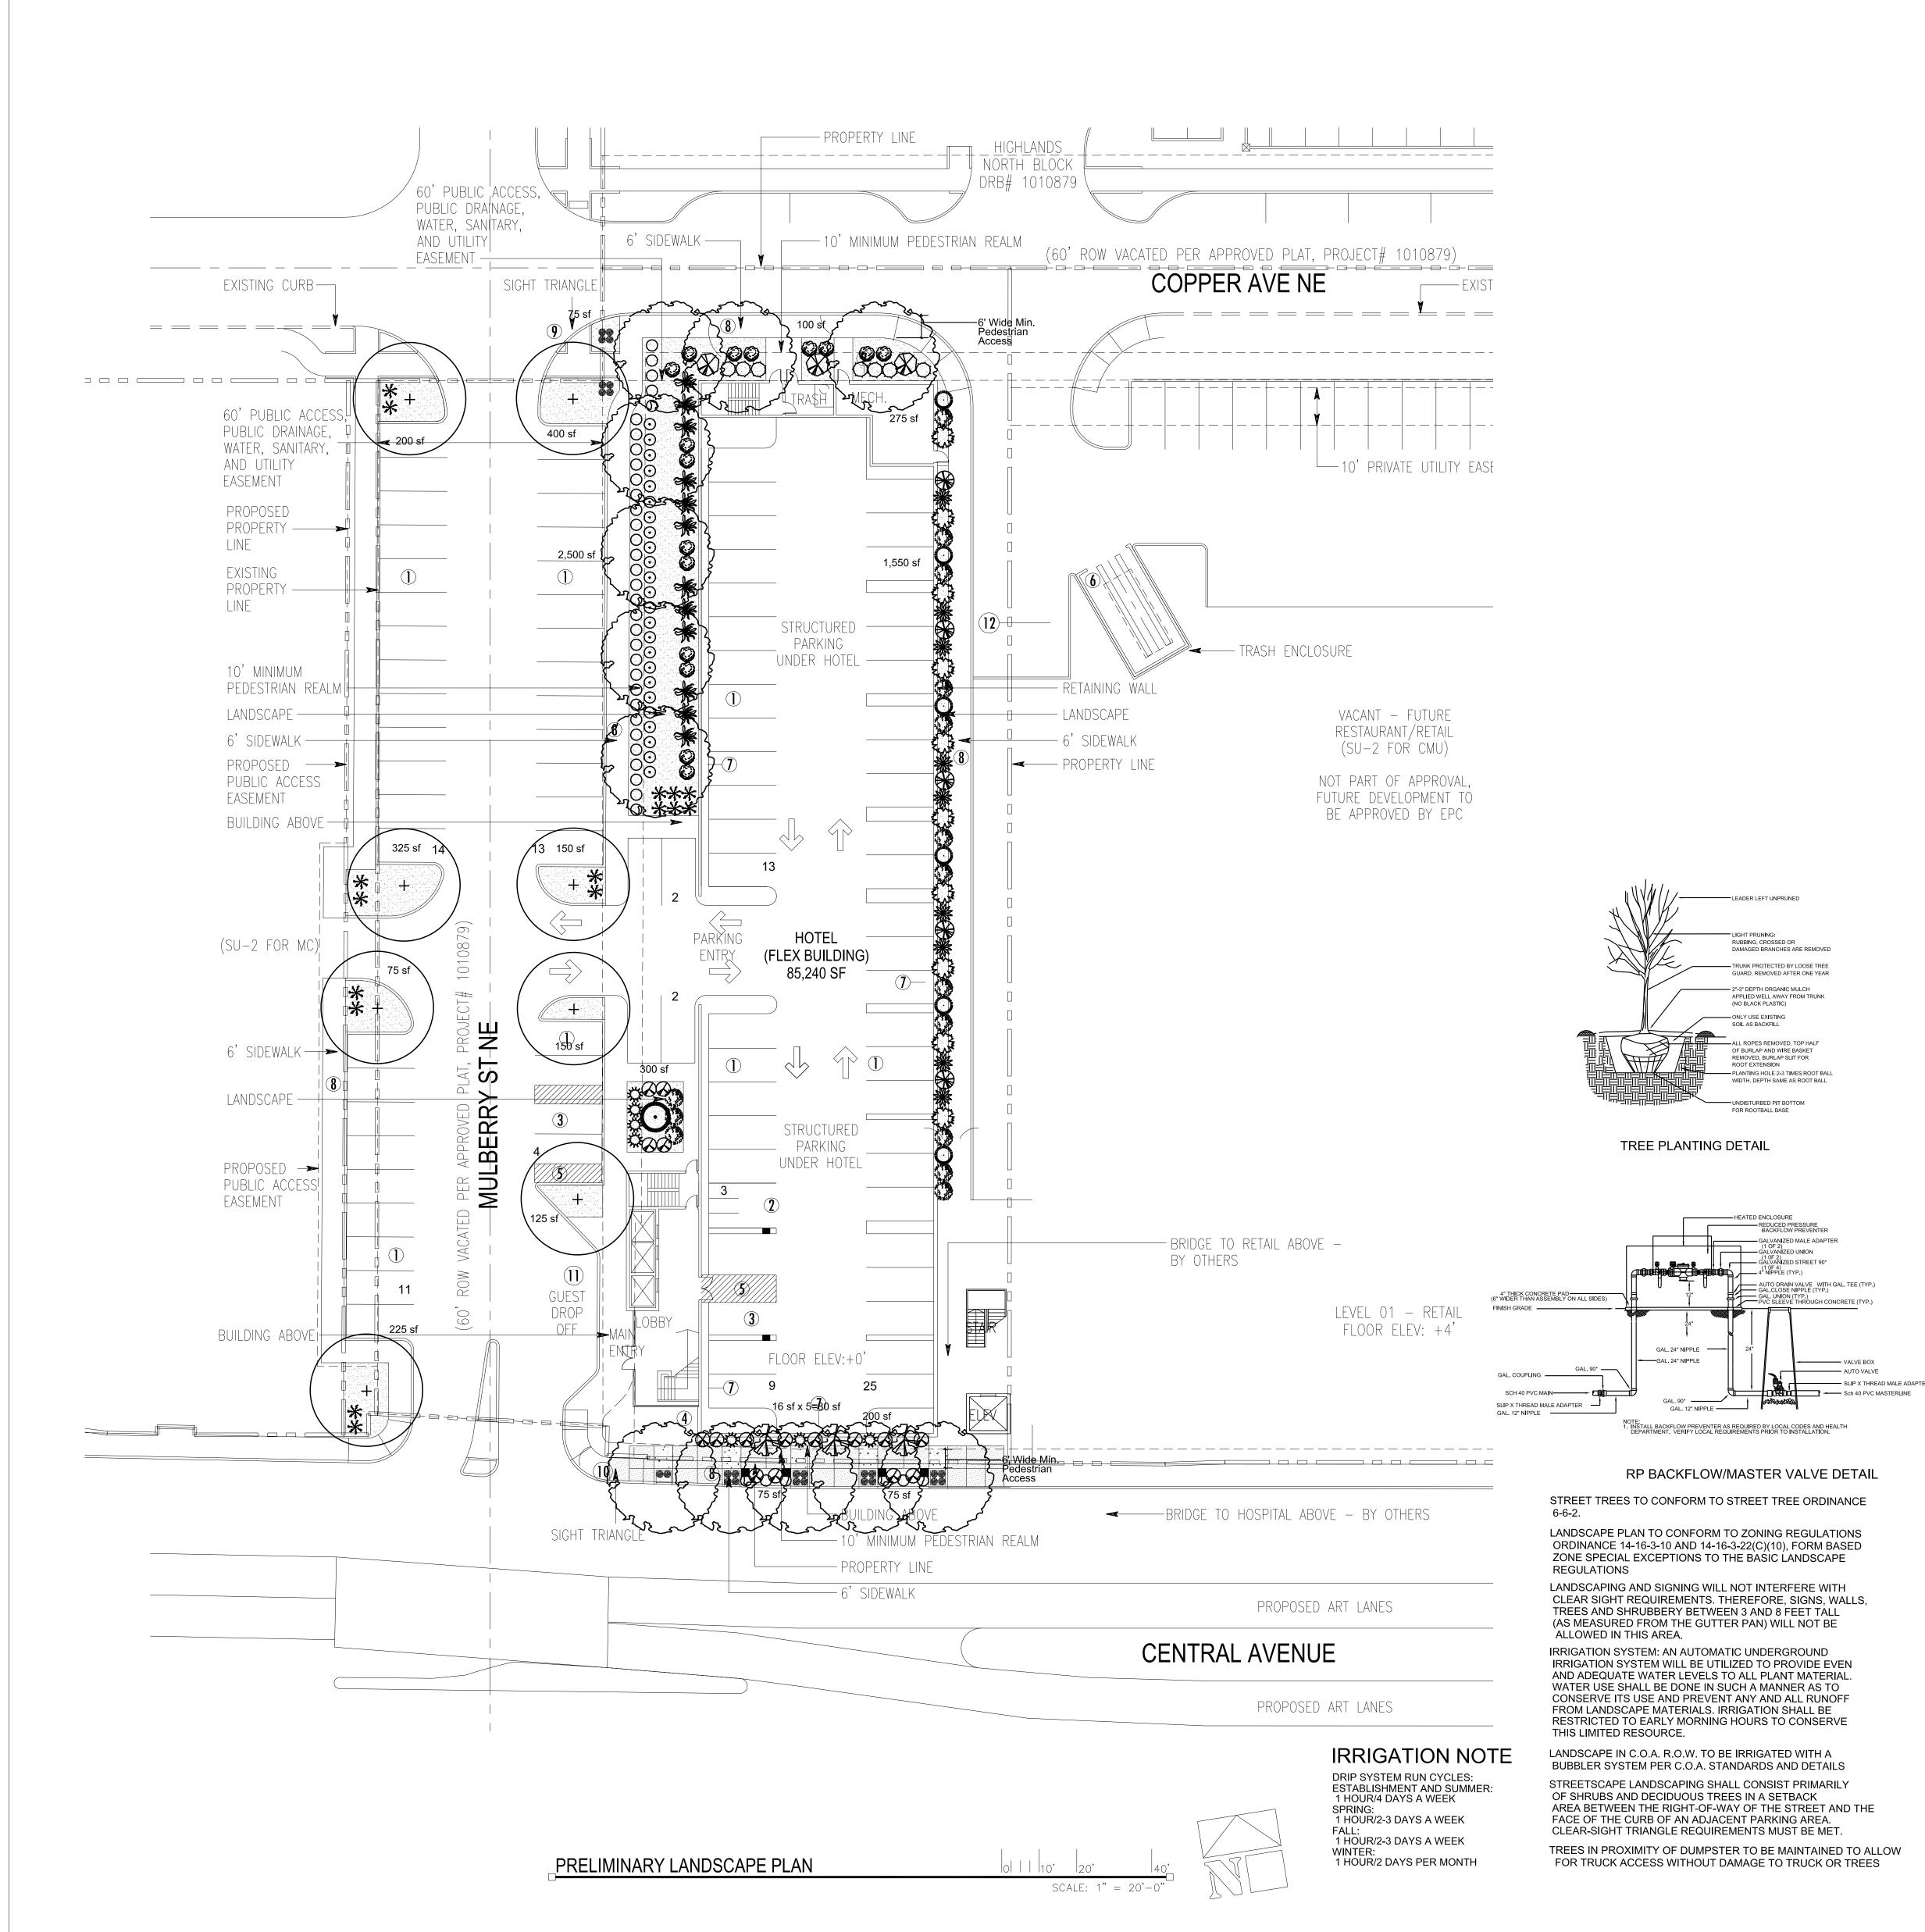
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IMM012 PROJECT NUMBER

SITE DETAILS

SHEET 9 OF 9

9 OF 9 SHEET NUMBER



PLANT LEGEND Scientific Name

Qty.	Symbol	Scientific Name Common Name	Installed	Mature	Landscape	Water	Drip
	Trees	Common Name			ead Coverage		mitters
12	\bigcirc	Fraxinus Raywood Ash	2" B&B	50'/30'	50 sf=600 sf	Medium	+6-2 gph
8	\odot	Platanus Sycamore	2" B&B	50'/40'	50 sf=400 sf	Medium	6-2 gph
10	EN ANT	Juniperus Skyrocket Juniper	15-Gal	20'/5'	50 sf=500 sf	Medium	6-2 gph
1	0	Pinus Bosnian Pine	6' HT.	15'/8'	50 sf=50 sf	Medium	6-2 gph
Shrubs	/Groundco	overs					
15	33,353 33,353 30,353 30,353	Caryopteris clandonensis Blue Mist	1-Gal	3'/3'	25 sf=375 sf	Medium	2-2 gph
5		Cytisus Lena Broom	5-Gal	3'/4'	25 sf=125 sf	Low	2-1 gph
7	\bigcirc	llex Dwarf Burford Holly	5-Gal	4'/4'	16 sf=112 sf	Medium+	2-1 gph
24	\odot	Salvia greggii Cherry Sage	1-Gal	3'/3'	15 sf=360 sf	Medium	2-1 gph
38	\circ	Lavandula Lavender	1-Gal	3'/3'	12 sf=456 sf	Medium	2-2 gph
16		Potentilla fruticosa Shrubby Cinquefoil	5-Gal	3'/3'	10 sf=160 sf	Medium+	2-2 gph
12		Rosmarinus officinalis Rosemary	5-Gal	6'/6'	36 sf=432 sf	Low +	2-2 gph
7	3ME	Rosa Knockout Rose	5-Gal	3'/3'	15 sf=105 sf	Medium+	2-2 gph
3		Lagerstroemia Crape Myrtle	5-Gal	15'/10'	100 sf=300 sf	Medium+	2-2 gph
16	\bigcirc	Rhaphiolepis India Hawthorn	5-Gal	3'/3'	15 sf=240 sf	Medium	2-2 gph
3	$\langle X \rangle$	Viburnum Burkwood Viburnum	5-Gal	6'/6'	36 sf=108 sf	Medium+	2-2 gph
6	0	Pinus mugo Mugho Pine	5-Gal	4'/4'	30 sf=180 sf	Medium	2-2 gph
9	*	Nandina Heavenly Bamboo	5-Gal	3'/3'	20 sf=180 sf	Medium+	2-2 gph
Grasse	S						
16	*	Muhlenbergia Deer Grass	1-Gal	4'/4'	20 sf=320 sf	Low+	2-2 gph
26	**	Pennisetum Hamlin Fountain Grass	1-Gal	3'/3'	9 sf=234 sf	Medium	2-2 gph
			Tota	al Landon	ane Coverage	E 227 CE	

MATERIALS LEGEND

BROWN CRUSHER FINES	4	CONCRETE COLOR 1
PAVERS		CONCRETE COLOR 2

Total Landscape Coverage=5,237 SF

	SITE DATA		
	GROSS/SITE LOT AREA	<u>51,564</u> \$	SF
	LESS BUILDING(S)	18,797 S	
	NET LOT AREA	<u>32,767</u> :	SF
	REQUIRED LANDSCAPE		
	10% OF NET LOT AREA	<u>3,276</u> ;	SF
	PROPOSED STREET LEVEL LANDSCAPE		
	PERCENT OF NET LOT AREA	20	%
	REQUIRED USABLE OPEN SPACE LANDS	SCAPE AREA	
	PROPOSED USABLE OPEN SPACE		SF
	REQUIRED USABLE OPEN SPACE LANDS		
	15% OF USABLE OPEN SPACE	1,767	
	PROPOSED USABLE OPEN SPACE LAND		
	PERCENT OF NET LOT AREA	20	%
	HIGH WATER USE TURF		
	MAX. 20% OF LANDSCAPE AREA	0;	
	PROPOSED HIGH WATER USE TURF	0;	
	PERCENT OF LANDSCAPE AREA	0 (%
	REQUIRED STREET TREES		
	1 PER 25 L.F. OF STREET FRONTAGE	1.	-
	PROVIDED STREET TREES	1	4
	REQUIRED PARKING LOT TREES 1 PER 8 SPACES		
	43 SPACES/8	6	
	PROVIDED PARKING LOT TREES	6	
R		O .	
	REQUIRED LANDSCAPE COVERAGE		
	75% LIVE VEGETATIVE MATERIAL	=0() = 10:	
	(6,880 SF PROPOSED LANDSCAPE X 75 PROVIDED GROUNDCOVER COVERAGE		SF MIN.
	PERCENT GROUNDCOVER COVERAGE		<i>i</i> 3F

NOTE

FROM A TREE.

MAINTENANCE OF LANDSCAPE (ONSITE AND WITHIN ROW)
TO BE MAINTAINED BY PROPERTY OWNER

PLANTINGS TO BE WATERED BY AUTO. DRIP IRRIGATION SYSTEM WITH REDUCED PRESSURE BACKFLOW PREVENTER PER CITY OF ALBUQUERQUE

76%

WATER MANAGEMENT IS THE SOLE RESPONSIBILITY OF THE PROPERTY OWNER

THIS PLAN IS TO COMPLY WITH C.O.A. LANDSCAPE AND WATER WASTE ORDINANCE 6-1-1. PLANTING RESTRICTIONS APPROACH

OF REQUIRED LANDSCAPE AREAS

IT IS THE INTENT OF THIS PLAN TO PROVIDE MIN. 75% LIVE GROUNDCOVER OF LANDSCAPE AREAS AT MATURITY PER ORDINANCE 14-16-3-10 (SEE CALCULATIONS PROVIDED ABOVE)

LANDSCAPE AREAS TO BE MULCHED WITH GRAVEL MULCH AT 2"-3" DEPTH

APPROVAL OF THE LANDSCAPE PLAN DOES NOT CONSTITUTE OR IMPLY COMPLIANCE WITH, OR EXEMPTION FROM, THE C.O.A LANDSCAPE AND WATER WASTE ORDINANCE 6-1-1.

NO PARKING SPACE SHALL BE MORE THEN 50'

1217 Main Street
Dallas, TX 75202
(214-670-0050 Christine Robbins-Elrod)
CIVIL ENGINEER

ARCHITECT

Bohannan Huston 7500 Jefferson Street NE Albuquerque, New Mexico 87109 (505-823-1000 Mike Balaskovits) LANDSCAPE

Heads Up Landscaping

7525 Second Street NW

5G Studio Collaborative, LLC..

Albuquerque, New Mexico 87107 (505-898-9615 John Braly)

STRUCTURAL ENGINEER

MK Engineers and Associates, Inc 400 Chisholm Place, Suite 106 Plano, TX 75075 (214-501-3354 Mohammad Kabir)

MEP Systems Design & Engineering, Inc. 918 Dragon Street, Suite 500 Dallas, TX 75207 (214-915-0929 Mark Portnoy)

OWNER/DEVELOPER

MEP ENGINEER

Titan Development 6300 Riverside Plaza Lane NW, Ste 200 Albuquerque, New Mexico 87120 (505-998-0163 Josh Rogers)

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design@hulc.com
www.headsuplandscape.com

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KEV.		ISSUE TITLE
	1.30.18	

ISSUE TITLE

DATE

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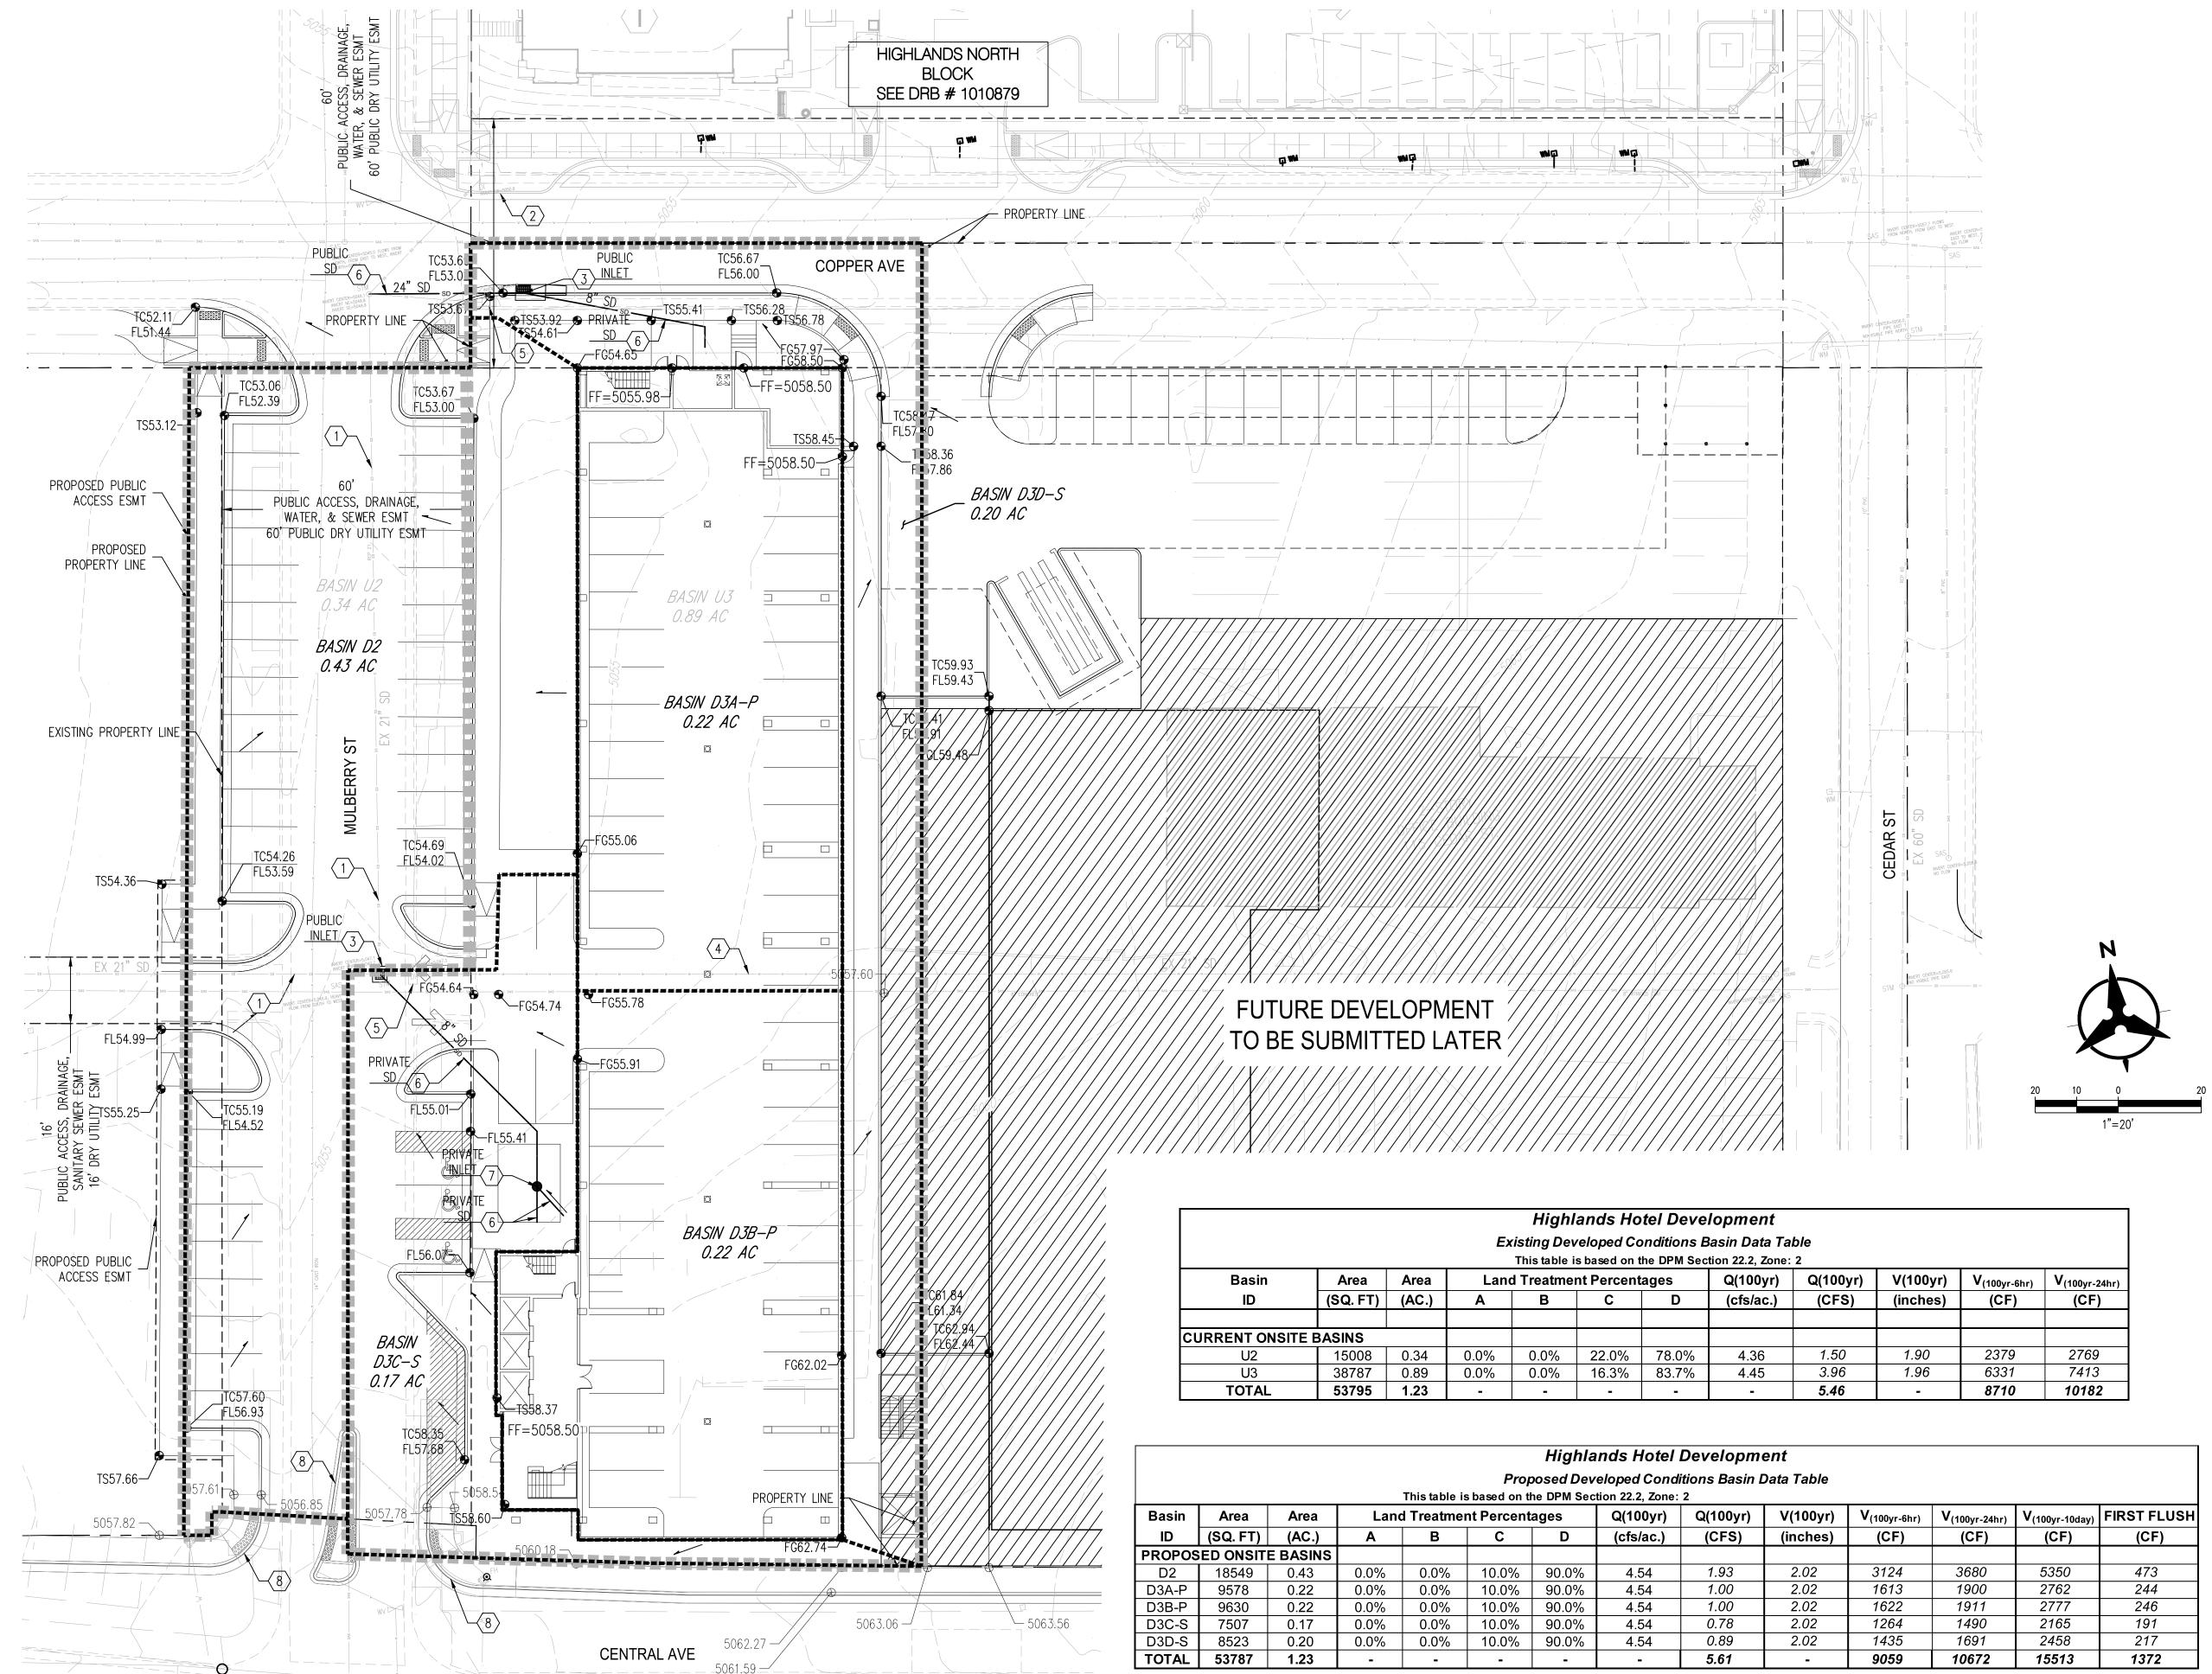
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SHEET NUMBER

L1.01

LANDSCAPE PLAN FOR BUILDING PERMIT

SHEET 1 OF 8



DRAINAGE NARRATIVE

EXISTING CONDITIONS

THIS SITE IS LOCATED AT THE NORTHEAST CORNER OF MULBERRY ST NE AND CENTRAL AVE NE. IT IS CURRENTLY DEVELOPED AND SLOPES FROM SOUTHEAST TO NORTHWEST. THE DRAINAGE ULTIMATELY OUTFALLS TO THE EXISTING PUBLIC STORM DRAIN SYSTEM LOCATED JUST WEST OFF THE SITE WITHIN MULBERRY. THIS SITE HAS HISTORICALLY BEEN FULLY DEVELOPED AS COMMERCIAL DEVELOPMENT.

THE SITE LIES WITHIN TWO EXISTING ONSITE BASINS, U2 & U3, BASIN U2 IS A PART OF A LARGER BASIN THAT SURFACE DRAINS TO AN INLET IN OAK ST. AND DRAINS TO A SYSTEM THAT ULTIMATELY HEADS WEST UNDERNEATH I-25. BASIN U3 IS ALSO A PART OF A LARGER BASIN THAT SURFACE DRAINS TO AN INLET IN COPPER AVE NORTH OF THIS SITE AND IS DISCHARGED INTO THE EXISTING 21" SD WITHIN MULBERRY ST.

THE TOTAL ONSITE EXISTING FLOW RATE FROM THE CURRENT DEVELOPMENT IS APPROXIMATELY 5.46 CFS.

PROPOSED CONDITIONS

THE HIGHLANDS HOTEL WILL INCLUDE A NEW HOTEL THAT SITS AT THE NORTHEAST INTERSECTION OF CENTRAL AVE AND MULBERRY ST. ON STREET PARKING WILL BE PROVIDED AS A RESULT OF THIS PROJECT. TWO EXISTING STORM DRAIN INLETS WILL BE REMOVED AND LOCATED AS A RESULT OF NEW CURB AND GUTTER IMPROVEMENTS. THIS IMPERVIOUS AREA OF THE SITE WILL INCREASE TO 90% D AND 10% C FOR DEVELOPED FLOWS. LANDSCAPED AREAS THROUGHOUT THE SITE WILL BE DEPRESSED WHERE APPLICABLE TO CAPTURE DRAINAGE IN AN ATTEMPT TO MEET THE FIRST FLUSH REQUIREMENTS, HOWEVER, ULTIMATELY THE CLIENT HAS

DECIDED TO PAY CASH-IN-LIEU FOR THE FIRST FLUSH REQUIREMENTS. THE DEVELOPED BASINS WILL ADHERE TO THE HISTORIC FLOW WITH FEW EXCEPTIONS. THE

FOLLOWING IS A DESCRIPTION OF HOW EACH BASIN WILL DRAIN. PLEASE REFER TO THE "PROPOSED DEVELOPED CONDITIONS BASIN DATA TABLE" FOR THE PROPOSED BASIN FLOWS. BASIN D2 INCLUDES A PORTIONS OF THE SITE'S PROPOSED PARKING IMPROVEMENTS AS WELL AS EXISTING MULBERRY ST. THIS AREA CONTINUES TO SHEET FLOW TO COPPER AVE AND INTO THE INLETS AT COPPER AVE AND OAK ST.

BASIN D3A-P INCLUDES ROOF DRAINAGE FROM THE HOTEL THAT WILL BE PIPED DIRECTLY INTO THE TOTAL ONSITE PROPOSED FLOW RATE FROM THE PROPOSED DEVELOPMENT IS THE COPPER AVE PROPOSED RELOCATED INLET WHICH ULTIMATELY TIES TO THE EXISTING 21" RCP LINE THAT RUNS IN MULBERRY ST.

BASIN D3B-P INCLUDES ROOF DRAINAGE FROM THE HOTEL THAT WILL BE PIPED INTO THE PROPOSED RELOCATED INLET WITHIN MULBERRY WHICH ULTIMATELY TIES TO THE EXISTING 21"

BASIN D3C-S INCLUDES A PORTION OF THE SITE'S HARDSCAPE, LANDSCAPE, PROPOSED PARKING IMPROVEMENTS, AS WELL AS A PORTION OF MULBERRY ST. THIS AREA CONTINUES TO


RCP LINE WHICH RUNS IN MULBERRY ST AND WEST THROUGH THE EXISTING ALLEY.

BASIN D3D-S INCLUDES A PORTION OF THE SITE'S HARDSCAPE AND LANDSCAPING FEATURES WHICH WILL CONTINUE TO SHEET FLOW INTO THE PROPOSED RELOCATED INLET WITHIN COPPER

APPROXIMATELY 5.61 CFS. COMPARISON OF THE FLOW BETWEEN EXISTING AND PROPOSED CONDITIONS WAS FOUND TO HAVE AN OVERALL INCREASE OF 0.2 CFS, OVERALL INDICATING THAT THE HISTORICAL DEVELOPED FLOWS ARE CLOSE TO THE SITE'S PROPOSED DEVELOPED CONDITIONS. THESE MINOR ADJUSTMENTS DEMONSTRATE THAT THE DRAINAGE ELEMENTS PROPOSED WITH THE PROJECT ARE CAPABLE OF SAFELY CONVEYING THE 100 YR, 6 HR STORM EVENT IN ACCORDANCE WITH THE DEVELOPMENT PROCESS MANUAL. WITH THIS SUBMITTAL, WE ARE REQUESTING COA HYDROLOGY APPROVAL IN SUPPORT OF SITE PLAN FOR BUILDING PERMIT



VICINITY MAP ZONE MAP K-15-Z

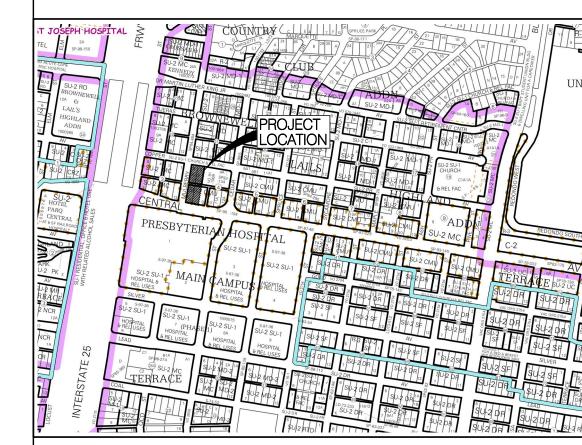



FEMA FIRM

MAP #: 35001C0334G


GRADING KEYNOTES

- 1. EXISTING STORM DRAIN TO REMAIN.
- 2. STORM DRAIN INLET AND IMPROVEMENTS TO BE CONSTRUCTED A PART OF PROJECT DRB #1010879.
- 3. EXISTING INLET TO BE REMOVED AND RELOCATED.
- 4. EXISTING STORM DRAIN TO BE REMOVED.
- 5. EXISTING STORM DRAIN INLET TO BE REMOVED.
- 6. PROPOSED NEW STORM DRAIN.
- 7. PROPOSED NEW STORM DRAIN INLET.
- 8. EXISTING ART CURB & GUTTER CONSTRUCTED WITH ART PROJECT.

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CONTACT: CHRISTINE ROBBINS-ELROD

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OWNER'S CONSULTANT / OPERATOR INTERMOUNTAIN MANAGEMENT, LLC 2390 TOWER DRIVE **MONROE, LOUISIANA 71201** 318.812.7126 CONTACT: DAVE RAYMOND

BOHANNAN HUSTON 7500 JEFFERSON STREET NE ALBUQUERQUE, NEW MEXICO 87109

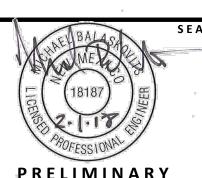505.823.1000 CONTACT: MIKE BALASKOVITS CONSENSUS PLANNING, INC.

302 EIGHTH STREET NW ALBUQUERQUE, NEW MEXICO 87102 CONTACT: SALVATOR PERDOMO

PROJECT

SPRINGHILL SUITES* MARRIOTT

ALBUQUERQUE

PROJECT ADDRESS **CENTRAL AVE. & MULBERRY ST ALBUQUERQUE, NM 87106**

		02.14.18	DRB SUBMITTAL
RB & GUTTER			
FLOW			
/GRADE			
ORM DRAIN			
ORM DRAIN			
			IN
ORM DRAIN			PROJECT N
	I		GF

REV. DATE ISSUE

MM012 NUMBER

& DRAINAGE PLAN

C-100 SHEET NUMBER

CRADING I ECENID

	LLGLIND		
	PROPERTY LINE		PROPOSED CURB & GU
	PROJECT LIMITS OF GRADING	S=2.0%	DIRECTION OF FLOW
— <i>-5025</i> - — -	EXISTING INDEX CONTOUR		WATER BLOCK/GRADE
— <i>-5024</i> — — –	EXISTING INTERMEDIATE	j	BREAK
	CONTOUR		PROPOSED STORM DRAI LINE
€ 5025.25	EXISTING GROUND SPOT ELEVATION	•	PROPOSED STORM DRAI MANHOLE
<i>5025</i>	PROPOSED INDEX CONTOUR		
5 <i>024</i>	PROPOSED INTERMEDIATE		PROPOSED STORM DRAI
	CONTOUR		PROPOSED RETAINING W

---- EASEMENT

PROPOSED BASIN BOUNDARY


PROPOSED FINISHED GRADE SPOT ELEVATION TC=TOP OF CURB, FL=FLOW LINE, EXISTING BASIN BOUNDARY TS=TOP OF SIDEWALK TG=TOP OF GRATE,

FGH=FINISH GROUND HIGH, FGL=FINISH GROUND LOW

BASIN DXX-S PROPOSED BASIN ID-SHEET

BAS/N UXX EXISTING BASIN ID BASIN DXX-P PROPOSED BASIN ID-PIPED

SHEET FLOW TO THE PROPOSED RELOCATED INLET WITHIN MULBERRY ST.

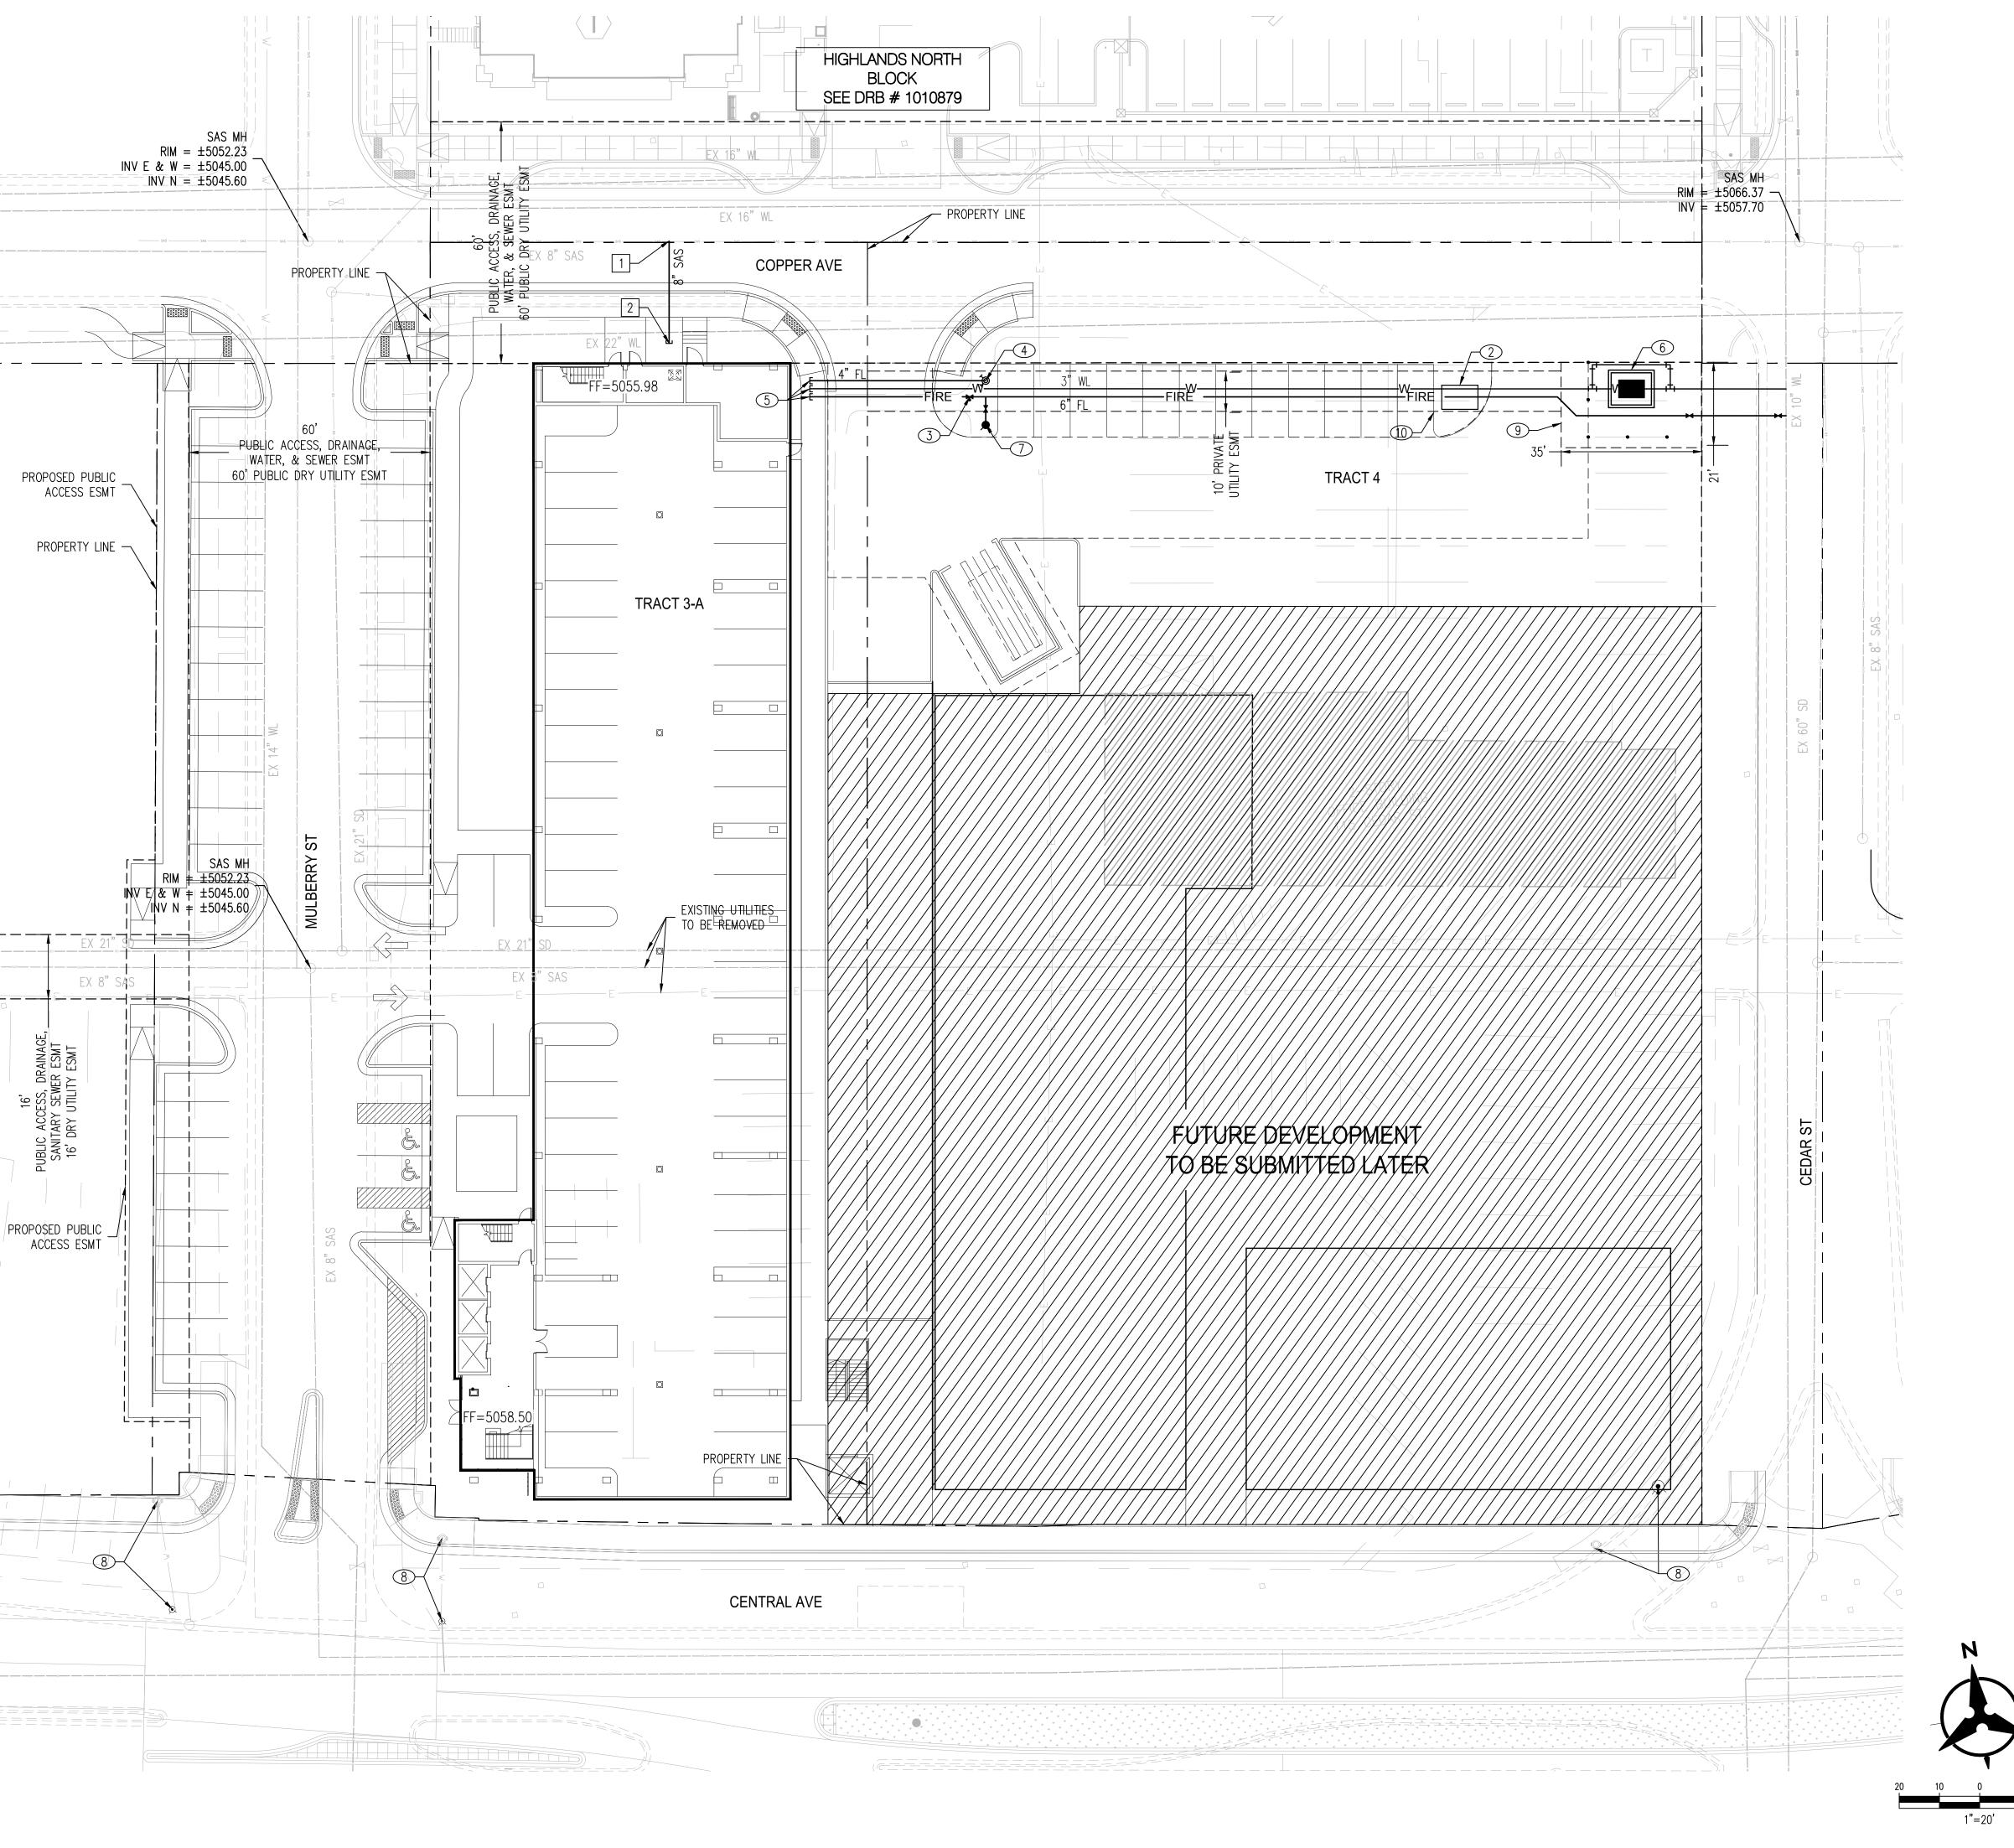

○ WATERLINE KEYNOTES

- CONNECT TO EXISTING WATER LINE. CONTRACTOR SHALL FIELD VERIFY EXISTING SIZE AND LOCATION AND NOTIFY ENGINEER WITH ANY DISCREPANCIES.
- 2. INSTALL DUAL FIRE AND DOMESTIC REDUCED PRESSURE BACKFLOW PREVENTION DEVICES WITHIN A HEATED ENCLOSURE. INSTALL PER MANUFACTURER SPECIFICATIONS. SEE ELECTRICAL PLANS FOR POWER.
- 3. INSTALL POST INDICATOR VALVE.
- 4. INSTALL REMOTE FIRE DEPARTMENT CONNECTION. SEE PLUMBING PLANS FOR CONTINUATION.
- 5. INSTALL STUB WITHIN 5' OF BUILDING. SEE PLUMBING PLANS FOR CONTINUATION.
- 6. INSTALL 3" WATER METER.
- 7. INSTALL PRIVATE FIRE HYDRANT.
- 8. RELOCATED PUBLIC FIRE HYDRANT (BY ART PROJECT).
- 9. NEW 35'X 21' PUBLIC WATER METER EASEMENT TO BE GRANTED TO ABCWUA.
- 10. NEW 10' PRIVATE UTILITY EASEMENT.

5G STUDIO COLLABORATIVE

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☐ SANITARY SEWER KEYNOTES

- CONNECT TO EXISTING SANITARY SEWER. CONTRACTOR SHALL FIELD VERIFY EXISTING INVERT ELEVATIONS AND NOTIFY ENGINEER WITH ANY DISCREPANCIES. SEE PUBLIC WORK ORDER (CPN #XXXXX).
- 2. INSTALL SANITARY SEWER SERVICE TO WITHIN 5' OF BUILDING. SEE PLAN FOR SIZE. SEE PLUMBING PLANS FOR CONTINUATION.

OWNER / DEVELOPER TITAN DEVELOPMENT

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OWNER'S CONSULTANT / OPERATOR INTERMOUNTAIN MANAGEMENT, LLC 2390 TOWER DRIVE MONROE, LOUISIANA 71201 318.812.7126 CONTACT: DAVE RAYMOND

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505.823.1000 CONTACT: MIKE BALASKOVITS CONSENSUS PLANNING, INC.

302 EIGHTH STREET NW ALBUQUERQUE, NEW MEXICO 87102 505.764.9801 CONTACT: SALVATOR PERDOMO

PROJECT

PROJECT ADDRESS

UTILITY LEGEND

PROPERTY LINE

---- EXISTING EASEMENT

_____WL____ EXISTING WATER LINE

EXISTING SANITARY

EXISTING WATER METER

EXISTING FIRE HYDRANT

EXISTING STORM DRAIN

EXISTING SANITARY SEWER MANHOLE

MANHOLE

EXISTING INLET

EXISTING CAP

EXISTING VALVE

SPRINGHILL SUITES* ————— PROPOSED EASEMENT MARRIOTT PROPOSED SANITARY SEWER LINE **ALBUQUERQUE**

PROPOSED SANITARY SEWER MANHOLE PROPOSED CLEANOUT **CENTRAL AVE. & MULBERRY ST.** ALBUQUERQUE, NM 87106 PROPOSED WATER LINI

REV. DATE ISSUE PROPOSED VALVE 02.14.18 DRB SUBMITTAL PROPOSED FIRE WATER PROPOSED HYDRANT


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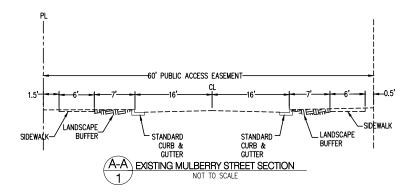
PROPOSED CAP PROPOSED WATER METER PROPOSED PIV REMOTE FIRE DEPARTMENT


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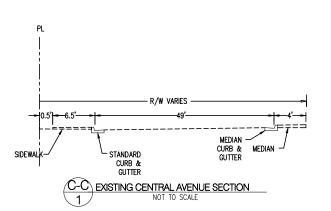
C-200 SHEET NUMBER

Bohannan A Huston





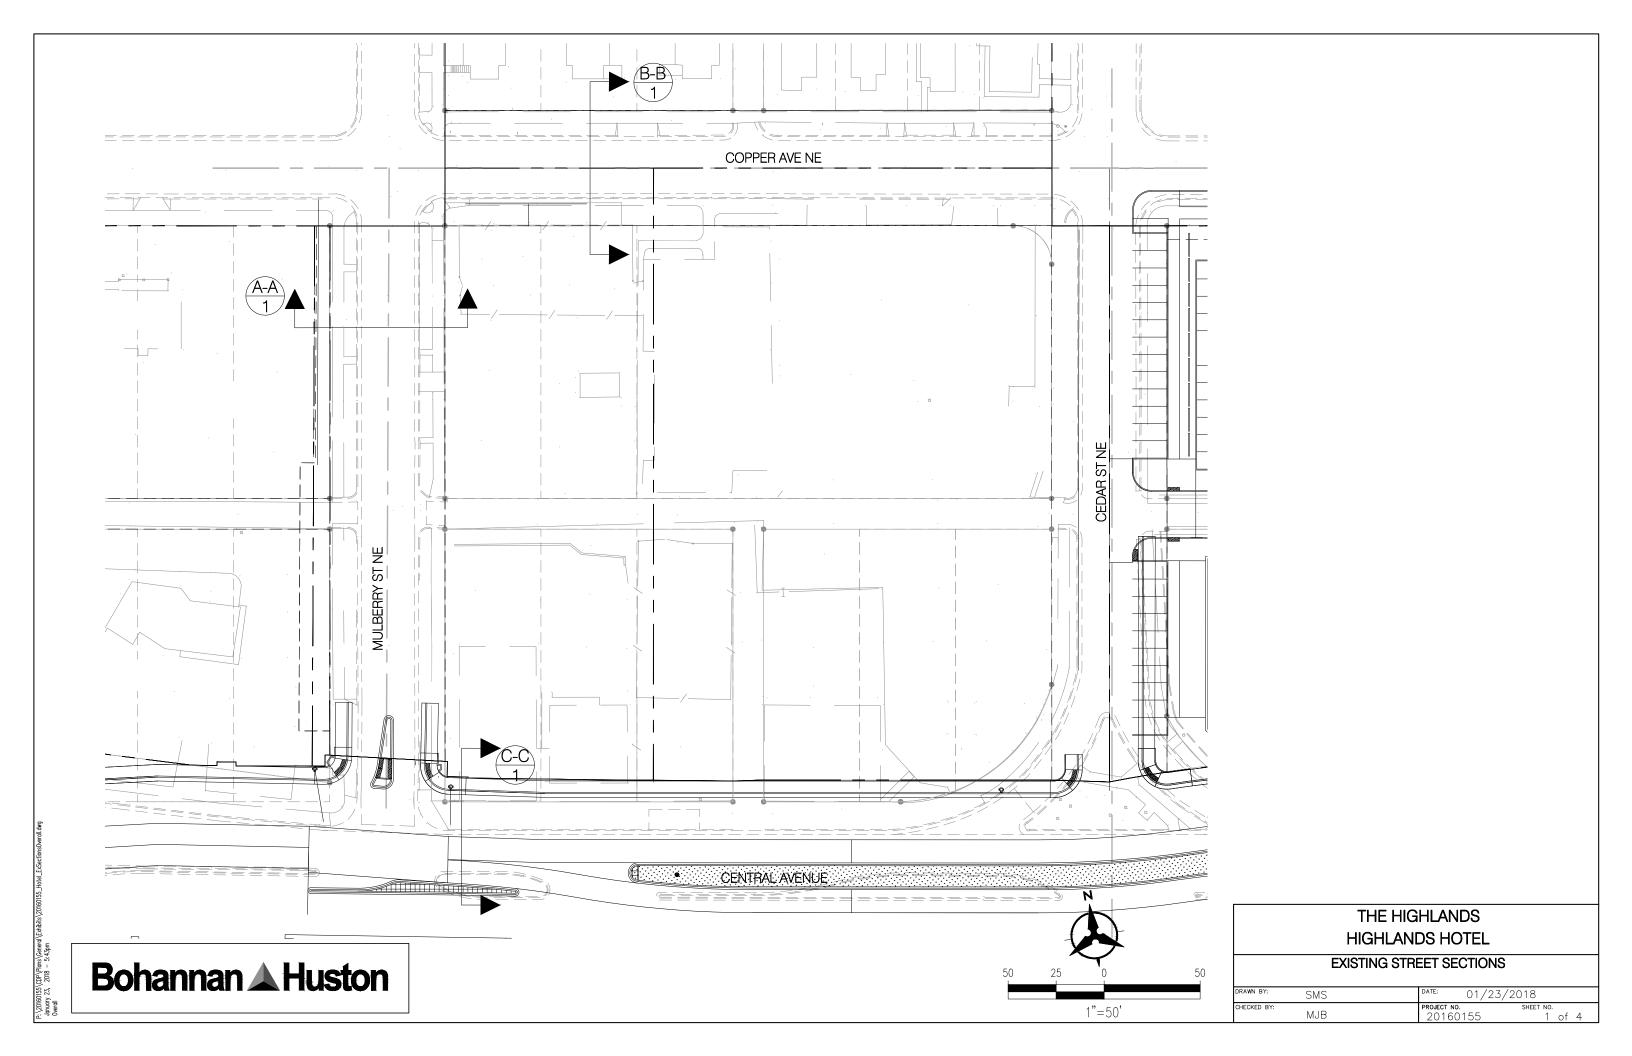


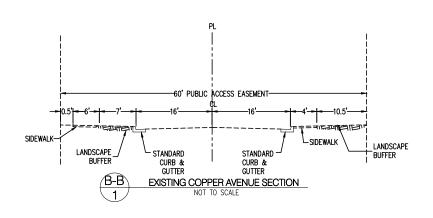



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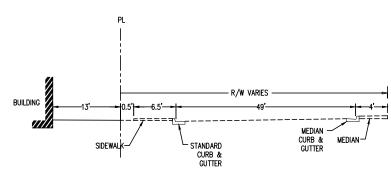
Bohannan ▲ **Huston**

	THE HIGHLANDS					
	HIGHLANDS HOTEL					
EXISTING STREET SECTIONS						
RAWN BY:	SMS	DATE: 01/23/2	018			
HECKED BY:	MJB	PROJECT NO. 20160155	sheet no. 2 of 4			



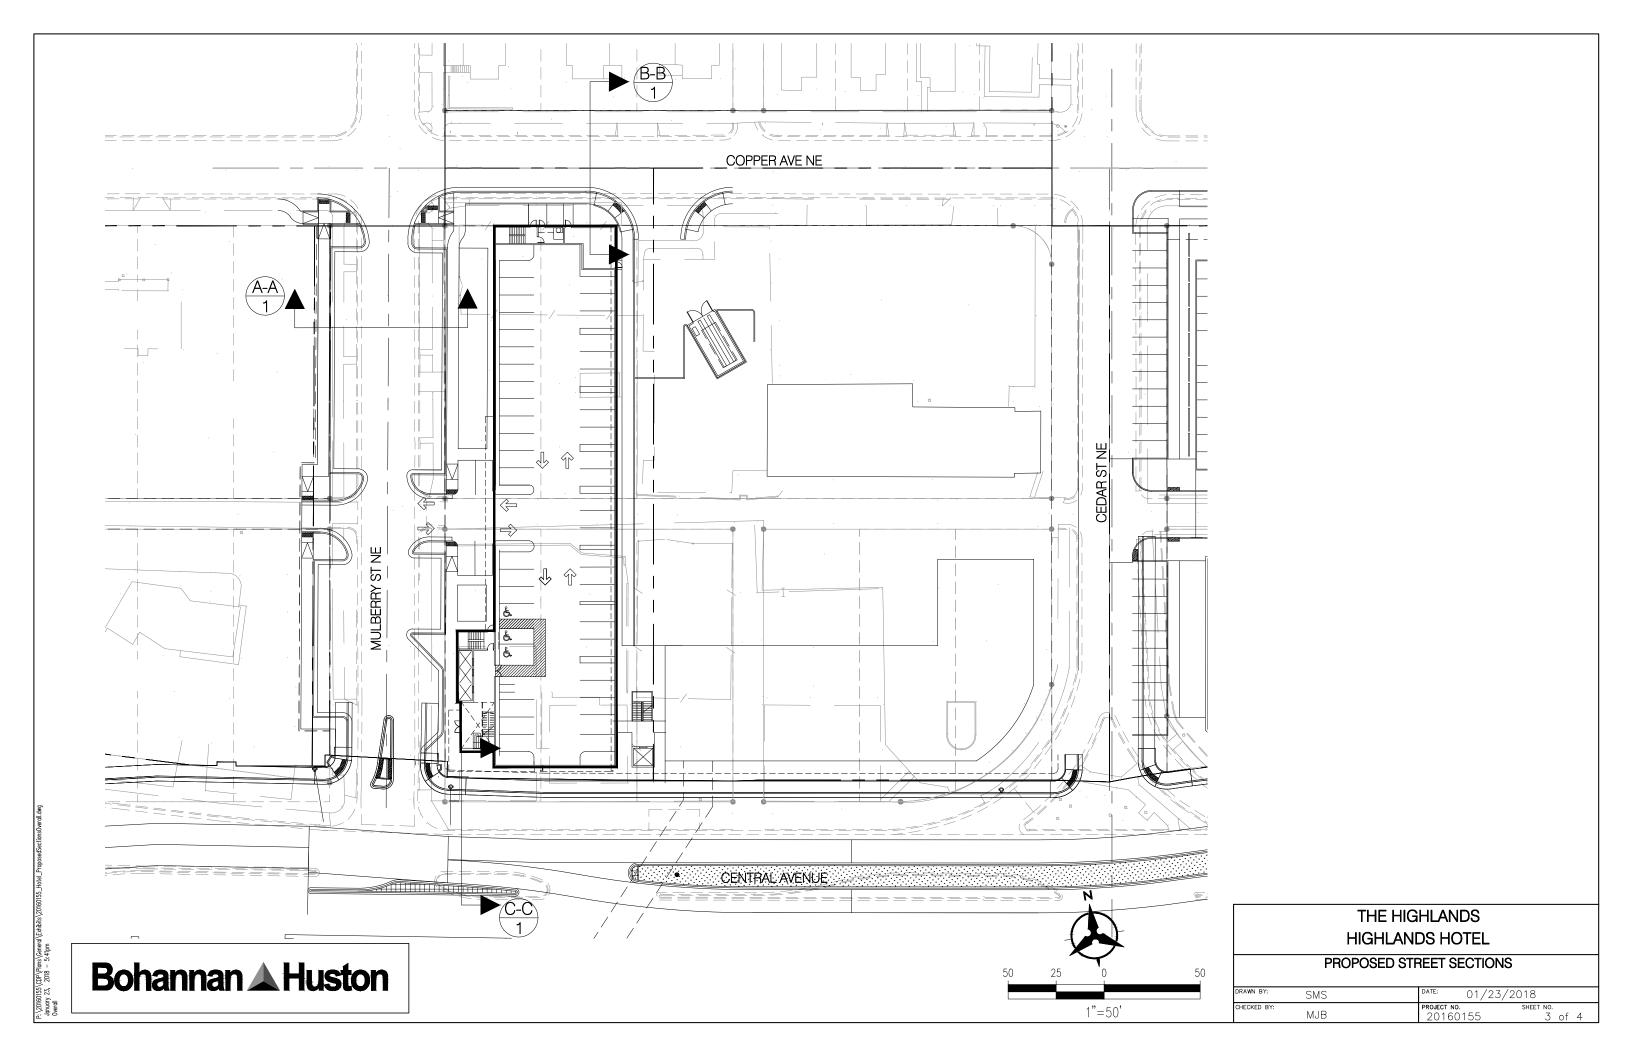

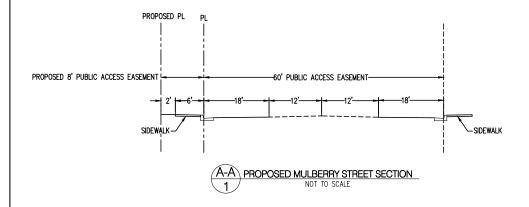

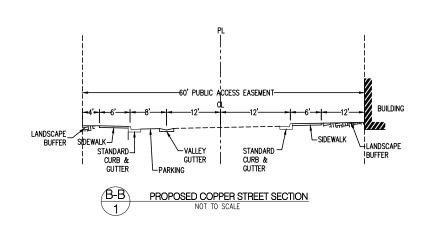

C-C PROPOSED CENTRAL AVENUE SECTION

NOT TO SCALE

THE HIGHLANDS HIGHLANDS HOTEL

PROPOSED STREET SECTIONS

DRAWN BY: SMS DATE: 01/23/2018

CHECKED BY: PROJECT NO. SHEET NO. 20160155 4 of 4

outss (whr yrians (veneral (Exminits (20100135)_ Hotel_ ry 23, 2018 — 11:46am Sections

Bohannan ▲ Huston

288'-1" 74'-5½" 109'-3½" 100'-5" EDGE OF 60' ROW LEVEL 6
56' - 9" LEVEL 4 36' - 3" LEVEL 3
26' - 0"

288'-1" 37'-3³⁄₄" 84'-2" 126'-8" 36'-0" EDGE OF 60' ROW — 4'-10½" 8" 4'-10½" SPRINGHILL SUITES MARRIOTT LEVEL 6
56' - 9" LEVEL 2 12' - 0" DRIVEWAY ENTRANCE TO LOBBY

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_EAST ELEVATION

WEST ELEVATION AT MULBERRY STREET

ARCHITECT


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EXTERIOR ELEVATIONS

SHEET NUMBER


SHEET 5 OF 9

SCALE: 3/32" = 1'-0"

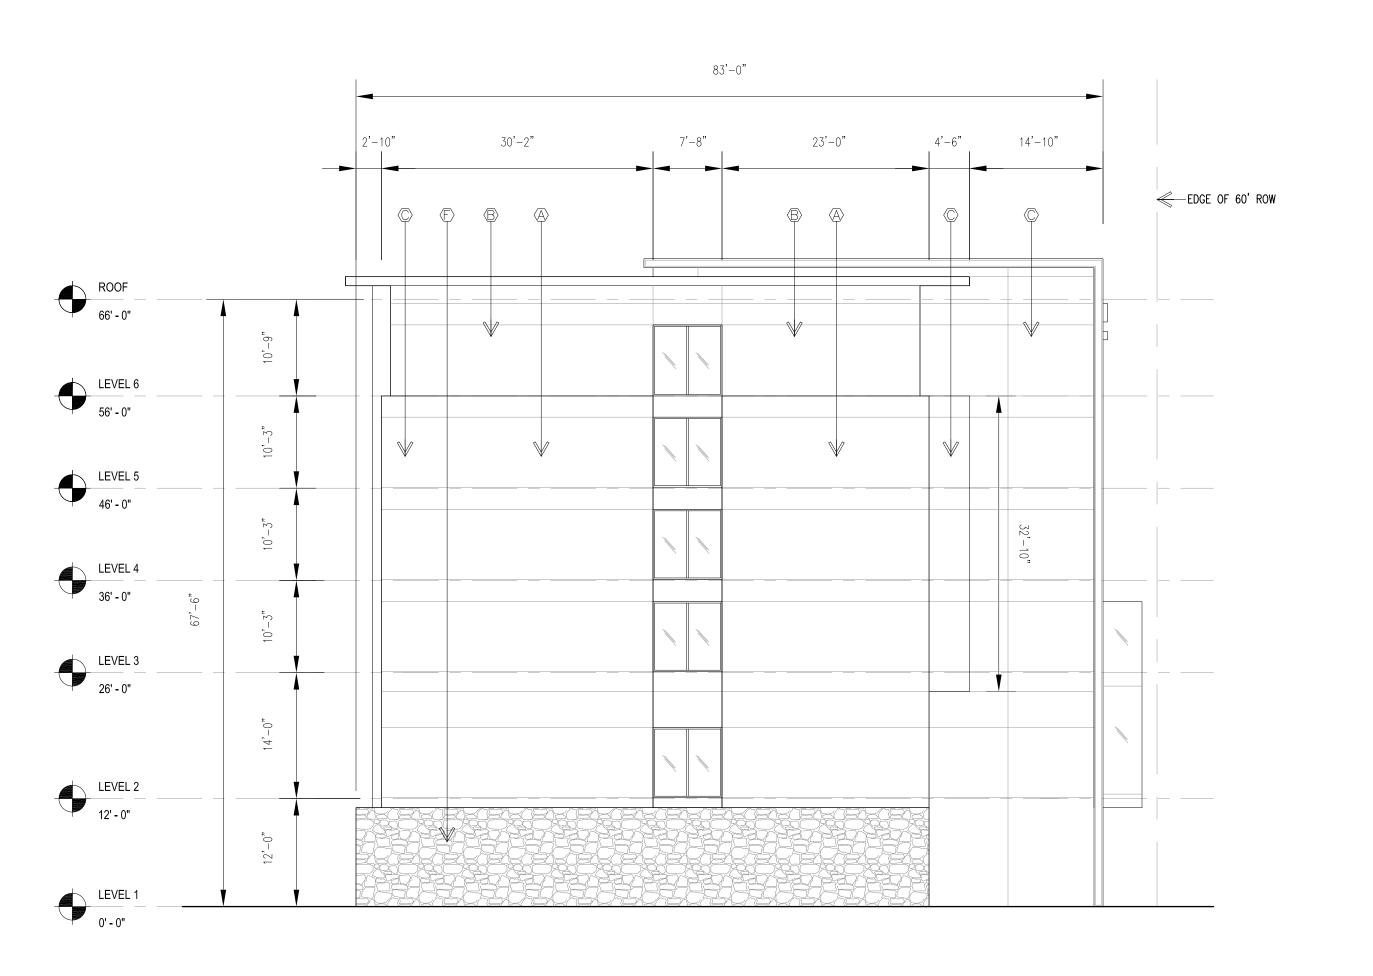

NORTH ELEVATION AT COPPER AVENUE

SCALE: 3/32" = 1'-0"

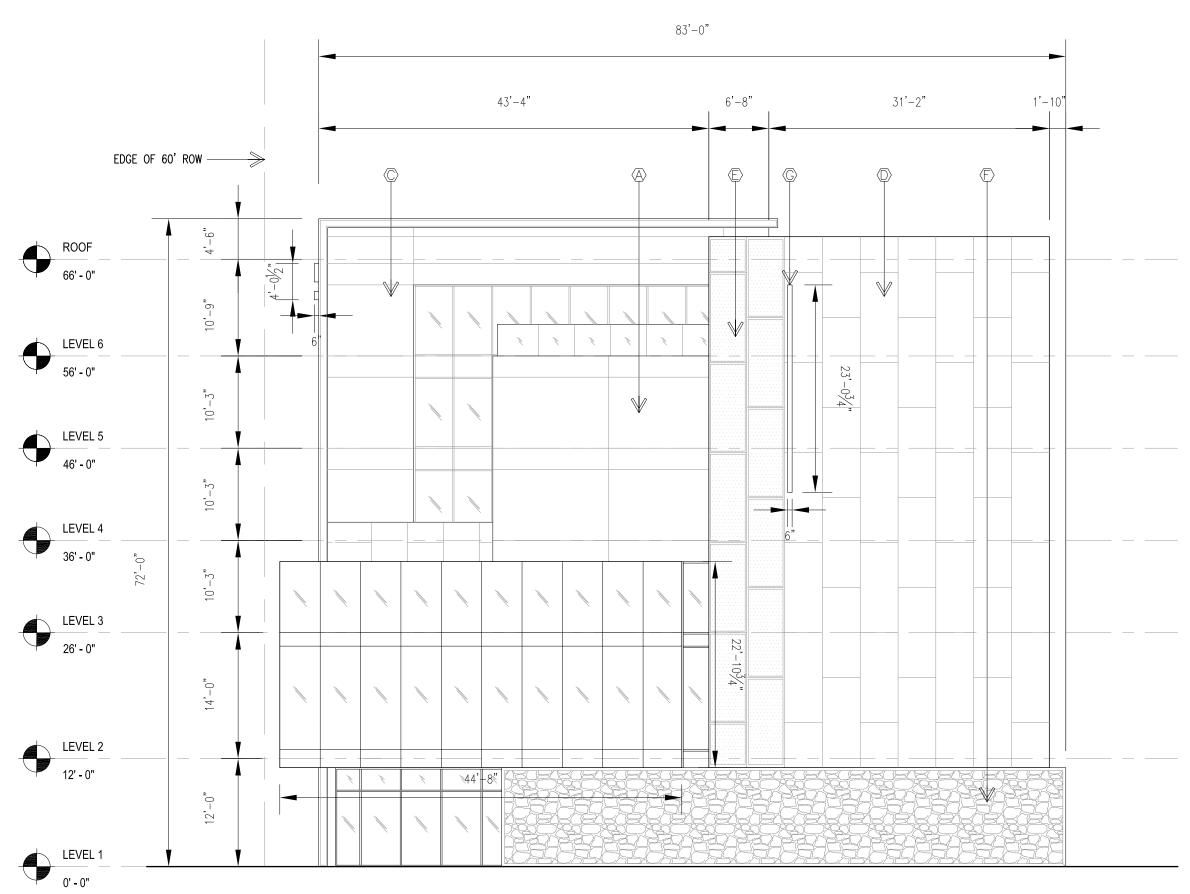

SOUTH ELEVATION AT CENTRAL AVENUE SCALE: 3/32" = 1'-0" ARCHITECT

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CIVIL ENGINEER

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CONTACT: MIKE BALASKOVITS PLANNER

CONSENSUS PLANNING, INC. 302 EIGHTH STREET NW ALBUQUERQUE, NEW MEXICO 87102 505.764.9801 CONTACT: MALIK HAKIM

MATERIAL LEGEND

_				
(A)	EIFS	FINISH	WHITE	

B EIFS FINISH LIGHT GRAY

EIFS FINISH MEDIUM GRAY

ACM PANEL

EXPANDED METAL MESH

F GABION WALL

NEON BLADE SIGN

PROJECT

SPRINGHILL SUITES®

MARRIOTT ALBUQUERQUE

PROJECT ADDRESS

CENTRAL AVE. & MULBERRY ST. ALBUQUERQUE, NM 87106

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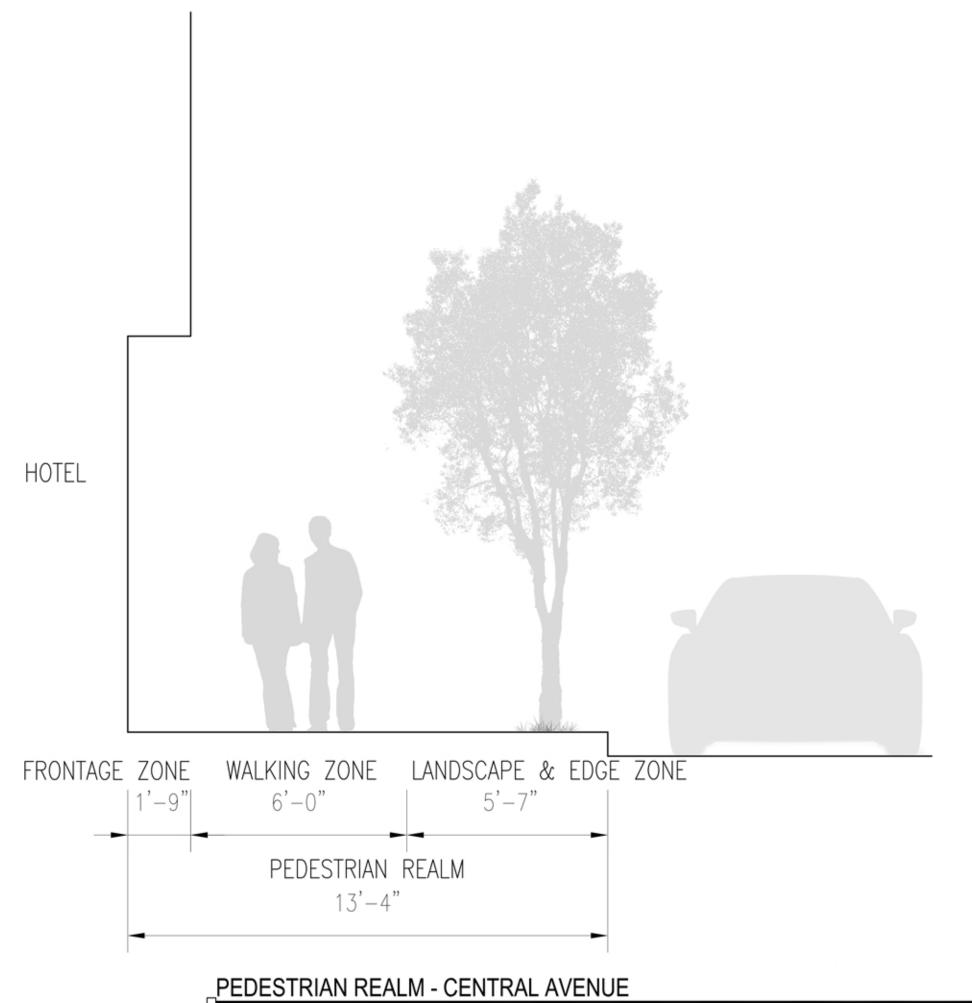
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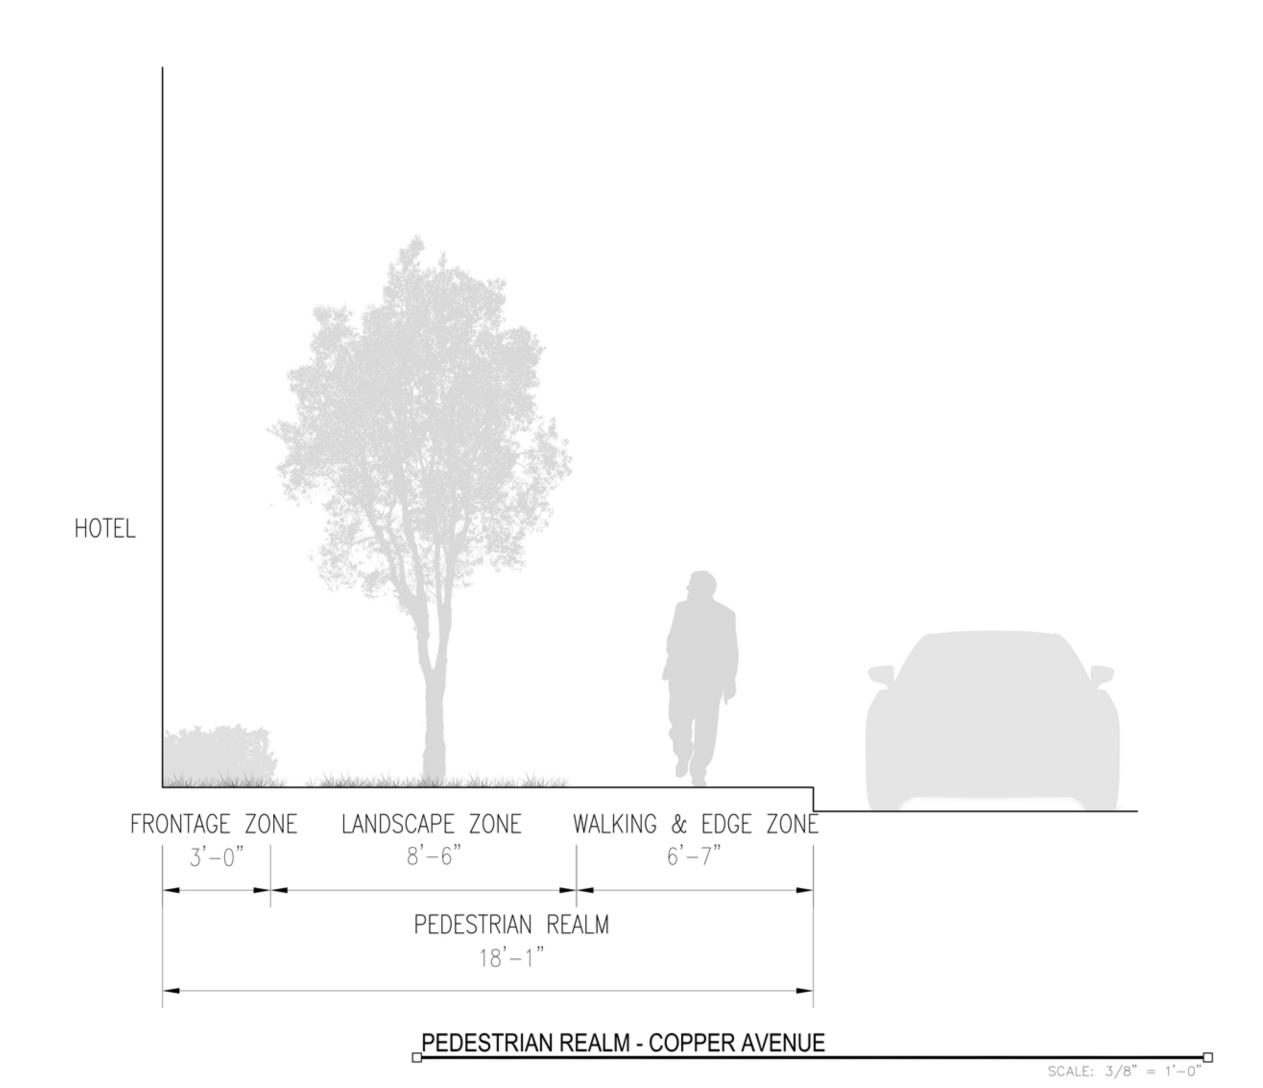
EXTERIOR ELEVATIONS


SHEET 6 OF 9

SHEET NUMBER



SCALE: 3/8" = 1'-0"



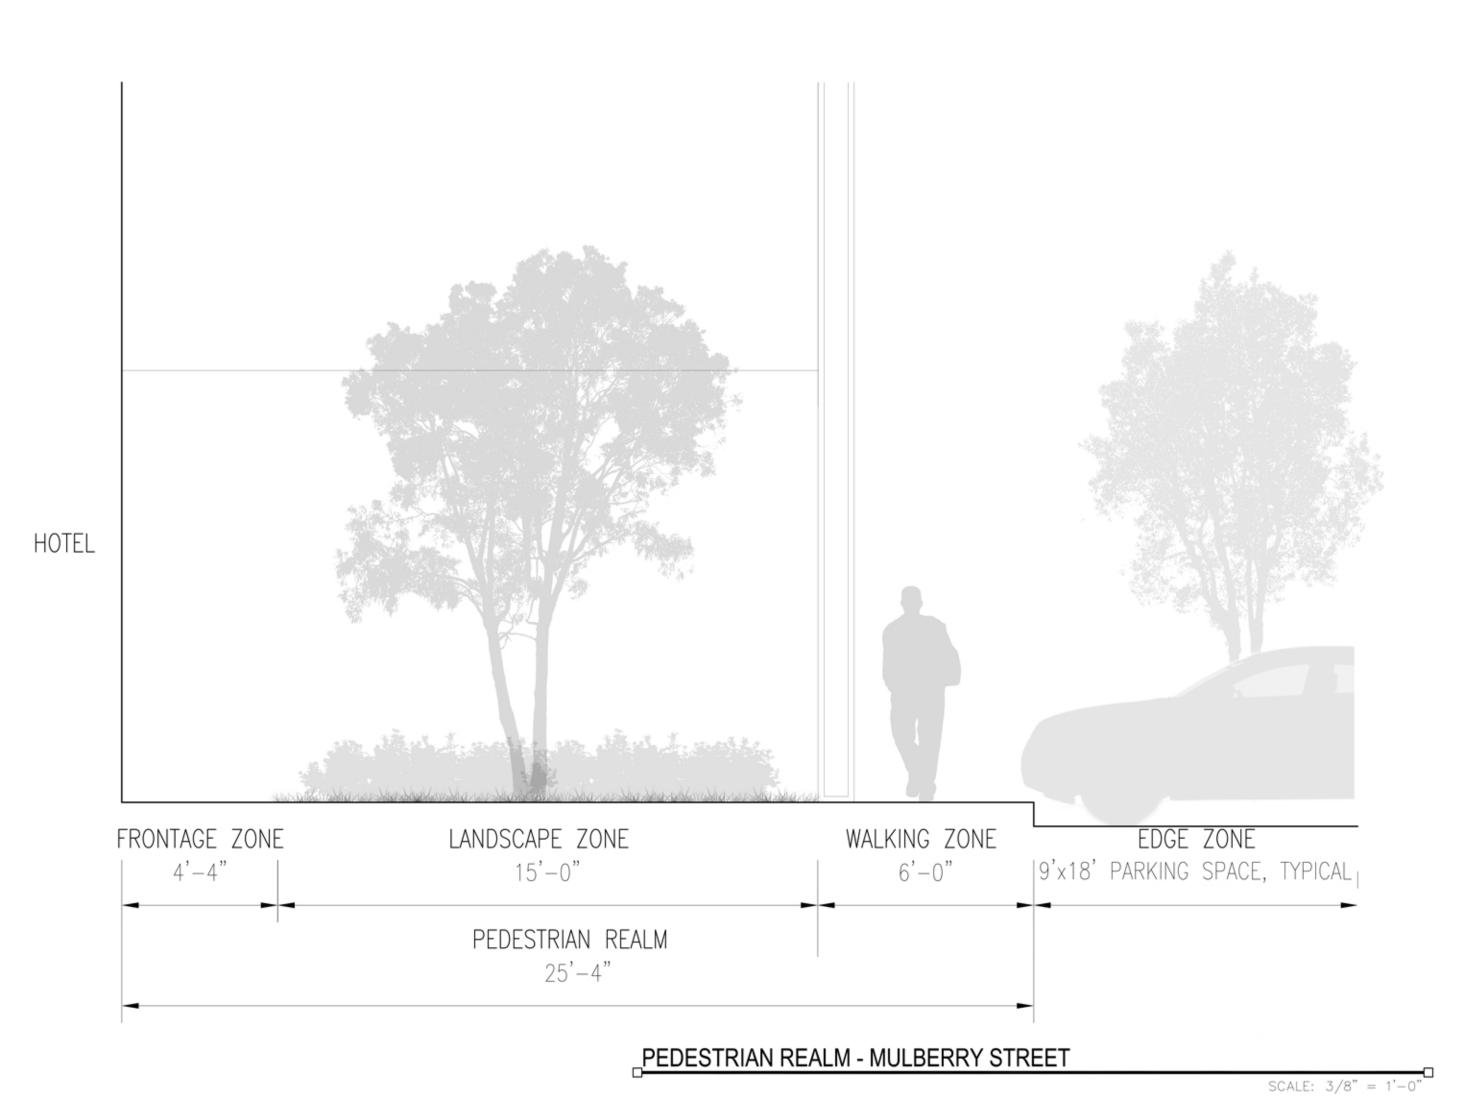

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505.764.9801 CONTACT: MALIK HAKIM

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PEDESTRIAN REALM

SHEET 7 OF 9

7 OF 9

SHEET NUMBER