



□ □ □ □ DENOTES PROPERTY LINE

BUILDING NUMBER

TYPE 2 BUILDING TYPE DENOTES ACCESSIBLE PARKING AND

ANSI TYPE 'A' DWELLING UNIT

DENOTES TRANSFORMER LOCATION

DENOTES WATER METER LOCATION

● FIRE HYDRAN?

LIGHTING LEGEND


- LED POLE LIGHT. +15' T.O.F. TYPE AS SHOWN ON PLAN
- LED POST TOP LIGHT. +15' T.O.F. OR UNLESS NOTED OTHERWISE ON PLAN. TYPE AS SHOWN ON PLAN.
- LED CARPORT LIGHT. TYPE 'CP'.
- LED WALL MINI WALL PACK. +10' B.O.F. TYPE 'WP'.
- ♦ LED WALL SCONCE. DECORATIVE. +6' B.O.F. TYPE 'WS'.

GENERAL NOTES

- THE PROPOSED BUILDING TYPE IS A FLEX BUILDING. PER THE FLEX BUILDING REQUIREMENTS, THE MARRIOT SPRINGHILL SUITES WILL BE A STANDARD RECTANGULAR URBAN BUILDING FORM, AND ACCESS TO THE LEVELS ABOVE THE STRUCTURED PARKING WILL BE PROVIDED VIA A GROUND FLOOR LOBBY WITH DIRECT ACCESS TO THE STREET. PARKING WILL BE LOCATED UNDER THE PRINCIPAL BUILDING AND IN A COMMON ON-STREET PARKING AREA. THE GROUND LEVEL FRONTAGE FOR THE BUILDING'S GROUND FLOOR LOBBY WILL BE GLASS STOREFRONT. ALL IMPROVEMENTS LOCATED IN THE RIGHT OF WAY MUST BE INCLUDED
- ON A WORK ORDER WITH DRC APPROVED PLANS. PREVIOUS BUILDINGS WILL BE DEMOLISHED. ALL EXISTING DOORS, STRUCTURES, SIDEWALKS, CURBS, DRIVE PADS, WALL AND ANYTHING
- THE SITE PLAN. LANDSCAPING, FENCING, AND SIGNING WILL NOT INTERFERE WITH CLEAR SIGHT REQUIREMENTS. THEREFORE, SIGNS, WALLS, TREES, AND SHRUBBERY BETWEEN 3 AND 8 FEET TALL (AS MEASURED FROM THE GUTTER PAN) WILL NOT BE ACCEPTABLE IN THE CLEAR SIGHT TRIANGLE PROVIDE NEW CURB AND GUTTER WITH ON STREET PARKING ON ALL 4 SIDE PER STD DWG 2415A, 2418, 2406 AND ANY OTHER THAT MAY
- THE PROPOSED DEVELOPMENT WILL FEATURE AN APPROXIMATELY. 15-FOOT-WIDE URBAN PEDESTRIAN REALM ALONG CENTRAL AVENUE AND MULBERRY STREET THAT WILL INTERACT WITH THE BUILDING FRONTAGE AND ADJACENT RIGHT-OF-WAY. THE PEDESTRIAN AREA WILL BE AN INVITING AND PLEASANT ENVIRONMENT FOR WALKERS, GUESTS, AND OTHER VISITORS. THIS AREA WILL FEATURE STREET TREES, PLANTERS, SPECIALTY PAVING, GLAZING, AND OTHER AMENITIES. THIS AREA IS CONSISTENT WITH THE FORM BASED CODE, WHICH SPECIFIES A "USABLE PEDESTRIAN REALM" THAT ACCOMMODATES STREET DESIGN AND APPROPRIATE BUILDING PLACEMENT.
- ACCESSIBLE PARKING SPACES MUST HAVE A SIGN THAT INCLUDES THE INTERNATIONAL SYMBOL OF ACCESSIBILITY AND STATE "RESERVED PARKING." ACCESSIBLE VAN PARKING SPACES WILL STATE "VAN ACCESSIBLE". ACCESSIBLE SIGN WILL BE 12"WX18"H AND VAN ACCESSIBLE SIGN WILL BE 12"WX6"H. SYMBOL OF ACCESSIBILITY SHOULD BE 4"H. SIGNS WILL HAVE GREEN LETTERING AND BORDER ON A WHITE BACKGROUND. SIGNS SHOULD BE MOUNTED AT LEAST 60 INCHES ABOVE PARKING SURFACE.
- 8. THE ADA ACCESS AISLES SHALL HAVE THE WORDS "NO PARKING" IN CAPITAL LETTERS, EACH OF WHICH SHALL BE AT LEAST ONE FOOT HIGH AND AT LEAST TWO INCHES WIDE, PLACED AT THE REAR OF THE PARKING SPACE SO AS TO BE CLOSE TO WHERE AN ADJACENT VEHICLE'S REAR TIRE WOULD BE PLACED. (66-1-4.1.B NMSA 1978) 9. PER ZONING CODE, A 6FT. WIDE ADA ACCESSIBLE PEDESTRIAN PATHWAY
- WILL BE PROVIDED FROM THE PUBLIC SIDEWALK TO THE BUILDING ENTRANCES. 10. WHEELCHAIR RAMPS REQUIRED BY ADA, WILL BE PROVIDED. WHEELCHAIR RAMPS LOCATED WITHIN THE PUBLIC RIGHT OF WAY MUST HAVE
- DETECTABLE WARNING SURFACES, "CAST-IN-PLACE" TRUNCATED DOMES. 11. ALL CURB RAMPS WILL MEET THE 2010 ADA STANDARD REQUIREMENTS FOR NEWLY CONSTRUCTED OR ALTERED STREETS AND STREET-LEVEL PEDESTRIAN WALKWAYS.
- 12. WORK WITHIN THE PUBLIC RIGHT OF WAY REQUIRES A WORK ORDER WITH DRC APPROVED PLANS.
- 13. LANDSCAPING AND SIGNAGE WILL NOT INTERFERE WITH CLEAR SIGHT REQUIREMENTS. THEREFORE, SIGNS, WALLS, TREES, AND SHRUBBERY BETWEEN 3 AND 8 FEET TALL (AS MEASURED FROM THE GUTTER PAN) WILL NOT BE ACCEPTABLE IN THE CLEAR SIGHT TRIANGLE. 14. REFER TO SHEET 7 OF 8 FOR PEDESTRIAN REALM DIAGRAMS.
- 15. 6 FT SIDEWALKS SURROUNDING BUILDING MUST BE KEPT FREE AND CLEAR WITHIN THE WALKING ZONE. 16. FUTURE CHANGES TO PROPOSED SIGNAGE CAN BE AMENDED
- ADMINISTRATIVELY. SIGNAGE WILL COMPLY WITH 14-16-3-22(8)(3)(N) AND 14-16-3-22(C)(7) AND WILL REMAIN WITHIN THE PROPERTY LINE. 17. BUILDING MOUNTED LIGHTS SHALL BE BETWEEN 6' AND 14' ABOVE
- ADJACENT GRADE. SEE 14-16-3-22(C)(6) FOR DETAILS AND OTHER REFERENCES. 18. EQUIPMENT SCREENING WILL COMPLY WITH SCREENING REQUIREMENTS IN SECTION 14-16-3-18(C)(6)(A) OF THE CITY OF ALBUQUERQUE ZONING
- 19. THE 20 PERCENT BUILDING HEIGHT MODIFICATION WILL COMPLY WITH SECTION 14-16-3-22(A)(6)(B)(1)(C) OF THE CITY OF ALBUQUERQUE
- 20. MULBERRY STREET AND COPPER AVENUE RIGHTS-OF-WAY HAVE BEEN VACATED. AN OFFICIAL NOTICE OF DECISION WAS ISSUED BY THE CITY PLANNING DEPARTMENT ON JANUARY 23, 2017 FOR PROJECT #1010879, 16DRB-70447. THE PLAT ASSOCIATED WITH THIS ACTION WAS RECORDED ON JUNE 13, 2017 FOR PROJECT #1010879, 17DRB-70119.
- 21. DETAIL TO BE PROVIDED IN BUILDING PERMIT SET FOR FIRE AND SOLID

KEYNOTES

- 9'x18' PARKING SPACE, TYPICAL.
- 4'x8' MOTORCYCLE PARKING SPACE.
- 8'x18' ACCESSIBLE PARKING SPACE. ACCESSIBLE GARAGE SPACE.
- BICYCLE PARKING. 5 SPACES PROVIDED.
- ACCESSIBLE DRIVEWAY CROSSING PAINTED MARKING. TRASH ENCLOSURE WITH COMPACTOR SURROUNDED BY 8' CMU WALL WITH EIFS FINISH TO MATCH THE BUILDING. SEE SHEET 8 OF 8 FOR
 - TRASH ENCLOSURE PLANS AND ELEVATIONS. ENCLOSED STRUCTURED PARKING GARAGE.
- 6' SIDEWALK, GRAY CONCRETE COLOR. 25'x25' SIGHT VISIBILITY TRIANGLE AT STREET CORNER.
- ENHANCED PAVING AT MAIN ENTRY AUTO COURT. AREA EAST OF SIDEWALK FOR RETAIL DEVELOPMENT BY OTHERS.

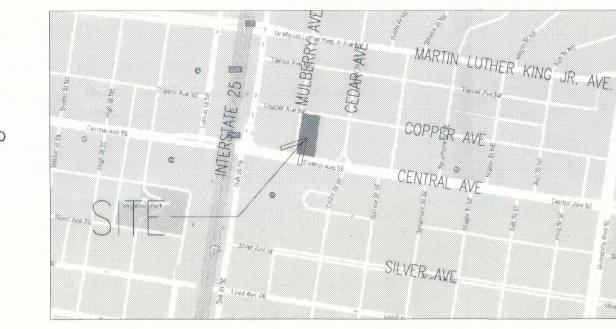

VICINITY MAP NOT TO SCALE

DEVELOPMENT DATA

NET SITE AREA

1.23 ACRES (53,549 S.F.)

ZONING AND LAND USE

SU-2 FOR CMU (C-2) CURRENT: PROPOSED: SU-2/SU-1 FOR MIXED USE (FORM BASED CODE)

LAND USE: COMMERCIAL

BUILDING HEIGHT

SIDE (W) REAR (N) SIDE (E) FRONT (S) ALLOWED: 72 FEET* 72' 72' 72' 72' 67' 67' *60 FEET, PLUS AN ADDITIONAL 20%. DUE TO LOCATION ALONG TRANSIT CORRIDOR. REFER TO GENERAL NOTE #19.

BUILDING GSF

90,450 SF

SETBACKS REQUIRED

SIDE (W) REAR (N) SIDE (E) FRONT (S) BUILDINGS 0 10'-0" 0 0

SETBACKS PROVIDED

SIDE (W) REAR (N) SIDE (E) FRONT (S) BUILDINGS 71'-1" 30'-1" 19'-1" 2'-8"

MINIMUM USABLE OPEN SPACE REQUIRED AND PROVIDED REQUIRED (10% OF SITE AREA) 5,355 SQ FT PROVIDED (INCLUDING LANDSCAPING AND PEDESTRIAN-ORIENTED HARDSCAPE) 11,784 SQ FT

PARKING SPACE REQUIREMENTS	
PARKING RATIO REQUIRED - 1 SPACE PER 1,000 SF	PARKING
REDUCE BY 15% PER TRANSIT REDUCTION	SPACES
Total Parking Spaces Required	73
ON-STREET PARKING PROVIDED	39
OFF-STREET PARKING PROVIDED	51
Total Parking Provided	90
Accessible Parking Required	5
ON-STREET PARKING PROVIDED	3
OFF-STREET PARKING PROVIDED	2
Total Accessible Parking Provided	5
Total Motorcycle Parking Required	3
Total Motorcycle Parking Provided	3
Total Bicycle Parking Provided	5

GLAZING CALCULATIONS FOR STREET FACING FACADES (NORTH, WEST, AND SOUTH FACADES)

TOTAL GLAZING AREA AT GROUND FLOOR 403 SF TOTAL AVAILABLE STREET-FACING GROUND FLOOR FACADE AREA | 1,518 SF (EXCLUDES WALL ASSEMBLIES) PERCENTAGE OF GROUND FLOOR STREET FRONTAGE GLAZING 26.55% TOTAL GLAZING AREA AT UPPER FLOORS 5,358 SF TOTAL AVAILABLE STREET-FACING FACADE AREA AT UPPER FLOORS 18,574 SF (EXCLUDES FLOOR, WALL, AND ROOF ASSEMBLIES)

PROJECT NUMBER: 1011099 Application Number: 18 PFB - 70011


This Plan is consistent with the specific Site Development Plan approved by the Environmental Planning Commission (EPC), dated Findings and Conditions in the Official Notification of Decision are satisfied.

PERCENTAGE OF STREET FRONTAGE GLAZING AT UPPER FLOORS

Is an Infrastructure List required? () Yes () No If yes, then a set of approved DRC plans with a work order is required for any construction within Public Right-of-Way or for construction of public improvements.

DRB SITE DEVELOPMENT PLAN SIGNOFF APPROVAL:

DRB Chairperson, Planning Department

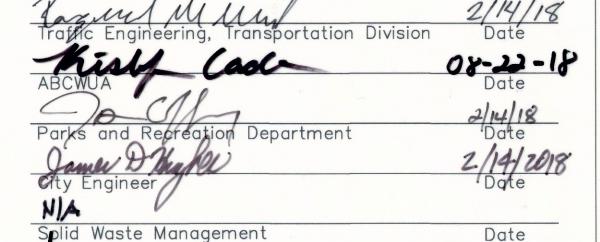

5G STUDIO COLLABORATIVE 800 JACKSON STREET | SUITE 500 DALLAS, TEXAS 75202 214.670.0050 **CONTACT: CHRISTINE ROBBINS-ELROD**

DRAWINGS AND SPECIFICATIONS AS INSTRUMENTS OF SERVICE ARE THE PROPERTY OF THE ARCHITECT. THEY SHALL NOT BE USED, TRANSFERRED, OR SOLD FOR **USE EXCEPT BY AN AGREEMENT IN WRITING**

FROM THE ARCHITECT.

ARCHITECT

PRELIMINARY DOCUMENT

NOT FOR CONSTRUCTION

OWNER / DEVELOPER

TITAN DEVELOPMENT 6300 RIVERSIDE PLAZA LANE NW. STE 20 **ALBUQUERQUE, NEW MEXICO 87120** 505.998.0163

CONTACT: JOSH ROGERS OWNER'S CONSULTANT / OPERATOR INTERMOUNTAIN MANAGEMENT, LLC 2390 TOWER DRIVE MONROE, LOUISIANA 71201 318.812.7126

CONTACT: DAVE RAYMOND **CIVIL ENGINEER BOHANNAN HUSTON**

7500 JEFFERSON STREET NE **ALBUQUERQUE, NEW MEXICO 87109** 505.823.1000 CONTACT: MIKE BALASKOVITS

CONSENSUS PLANNING, INC. 302 EIGHTH STREET NW ALBUQUERQUE, NEW MEXICO 87102 505.764.9801

CONTACT: MALIK HAKIM

PROJECT

SPRINGHILL SUITES MARRIOTT

ALBUQUERQUE

PROJECT ADDRESS **CENTRAL AVE. & MULBERRY ST. ALBUQUERQUE, NM 87106**

2.14.18 DRB SUBMITTAL

REV. DATE ISSUE


IMM012 PROJECT NUMBER SITE PLAN FOR

BUILDING PERMIT

SHEET 1 OF 9


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SHEET NUMBER

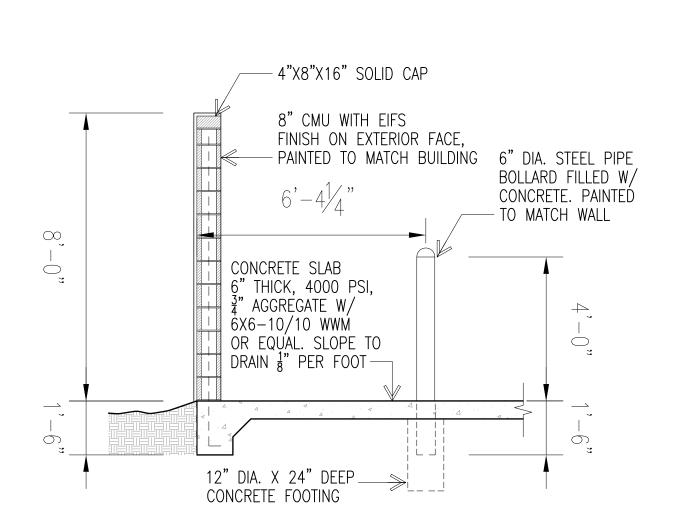

TRASH ENCLOSURE - WALL SECTION


SCALE: 3/8" = 1'-0"

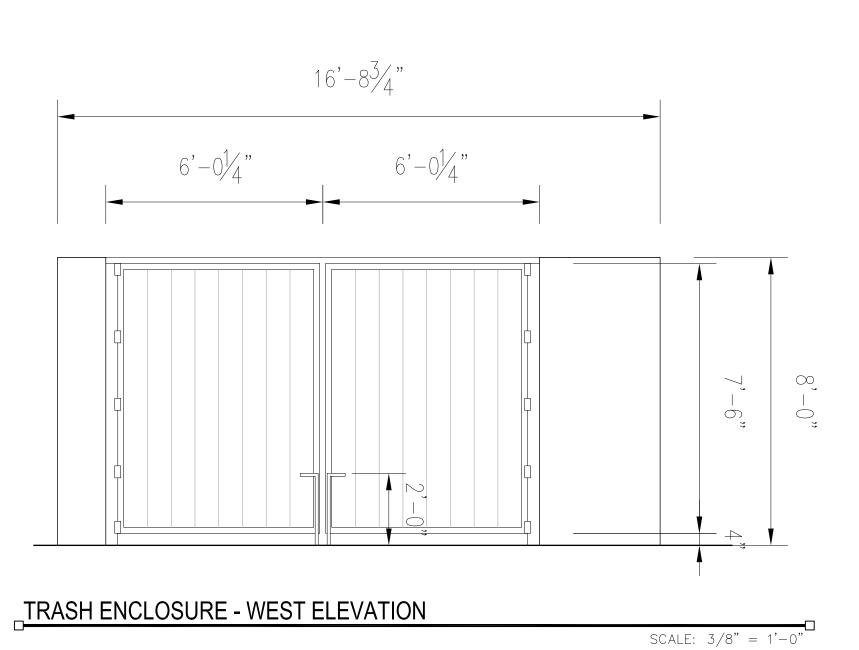

STEEL TURE POST CONDRETE SLAB CMU, WALL W/EISF FIRST

TRASH ENCLOSURE - PLAN

SCALE: 3/8" = 1'-0"

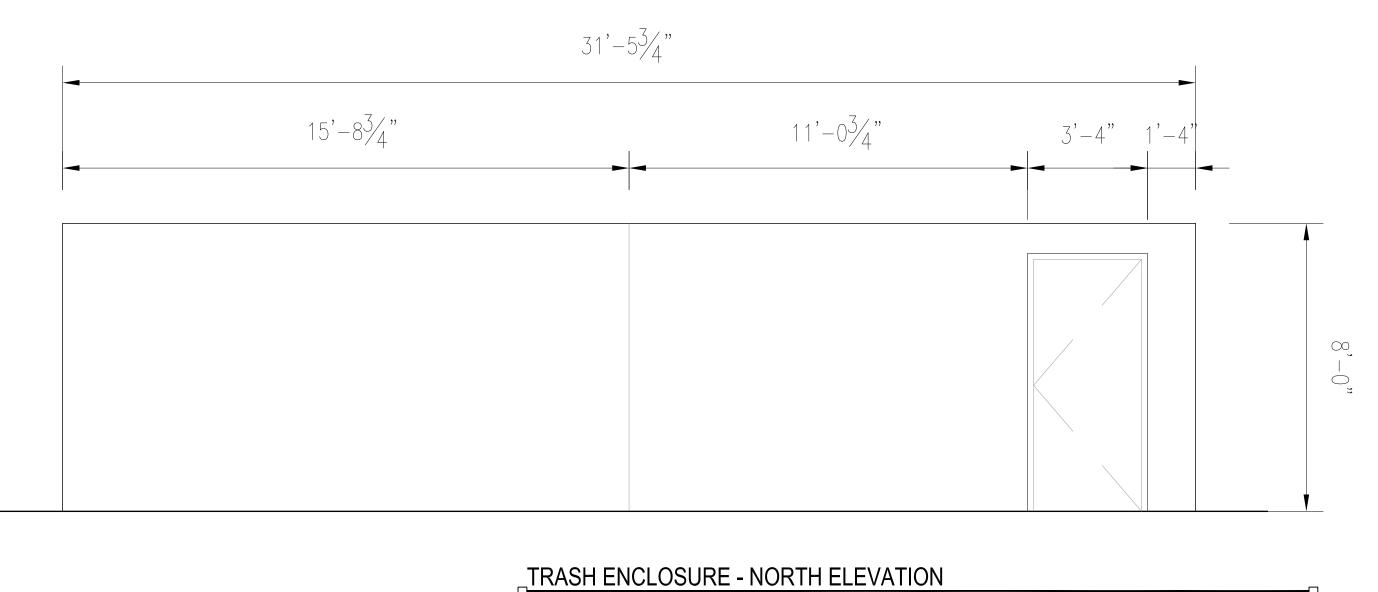

ARCHITECT

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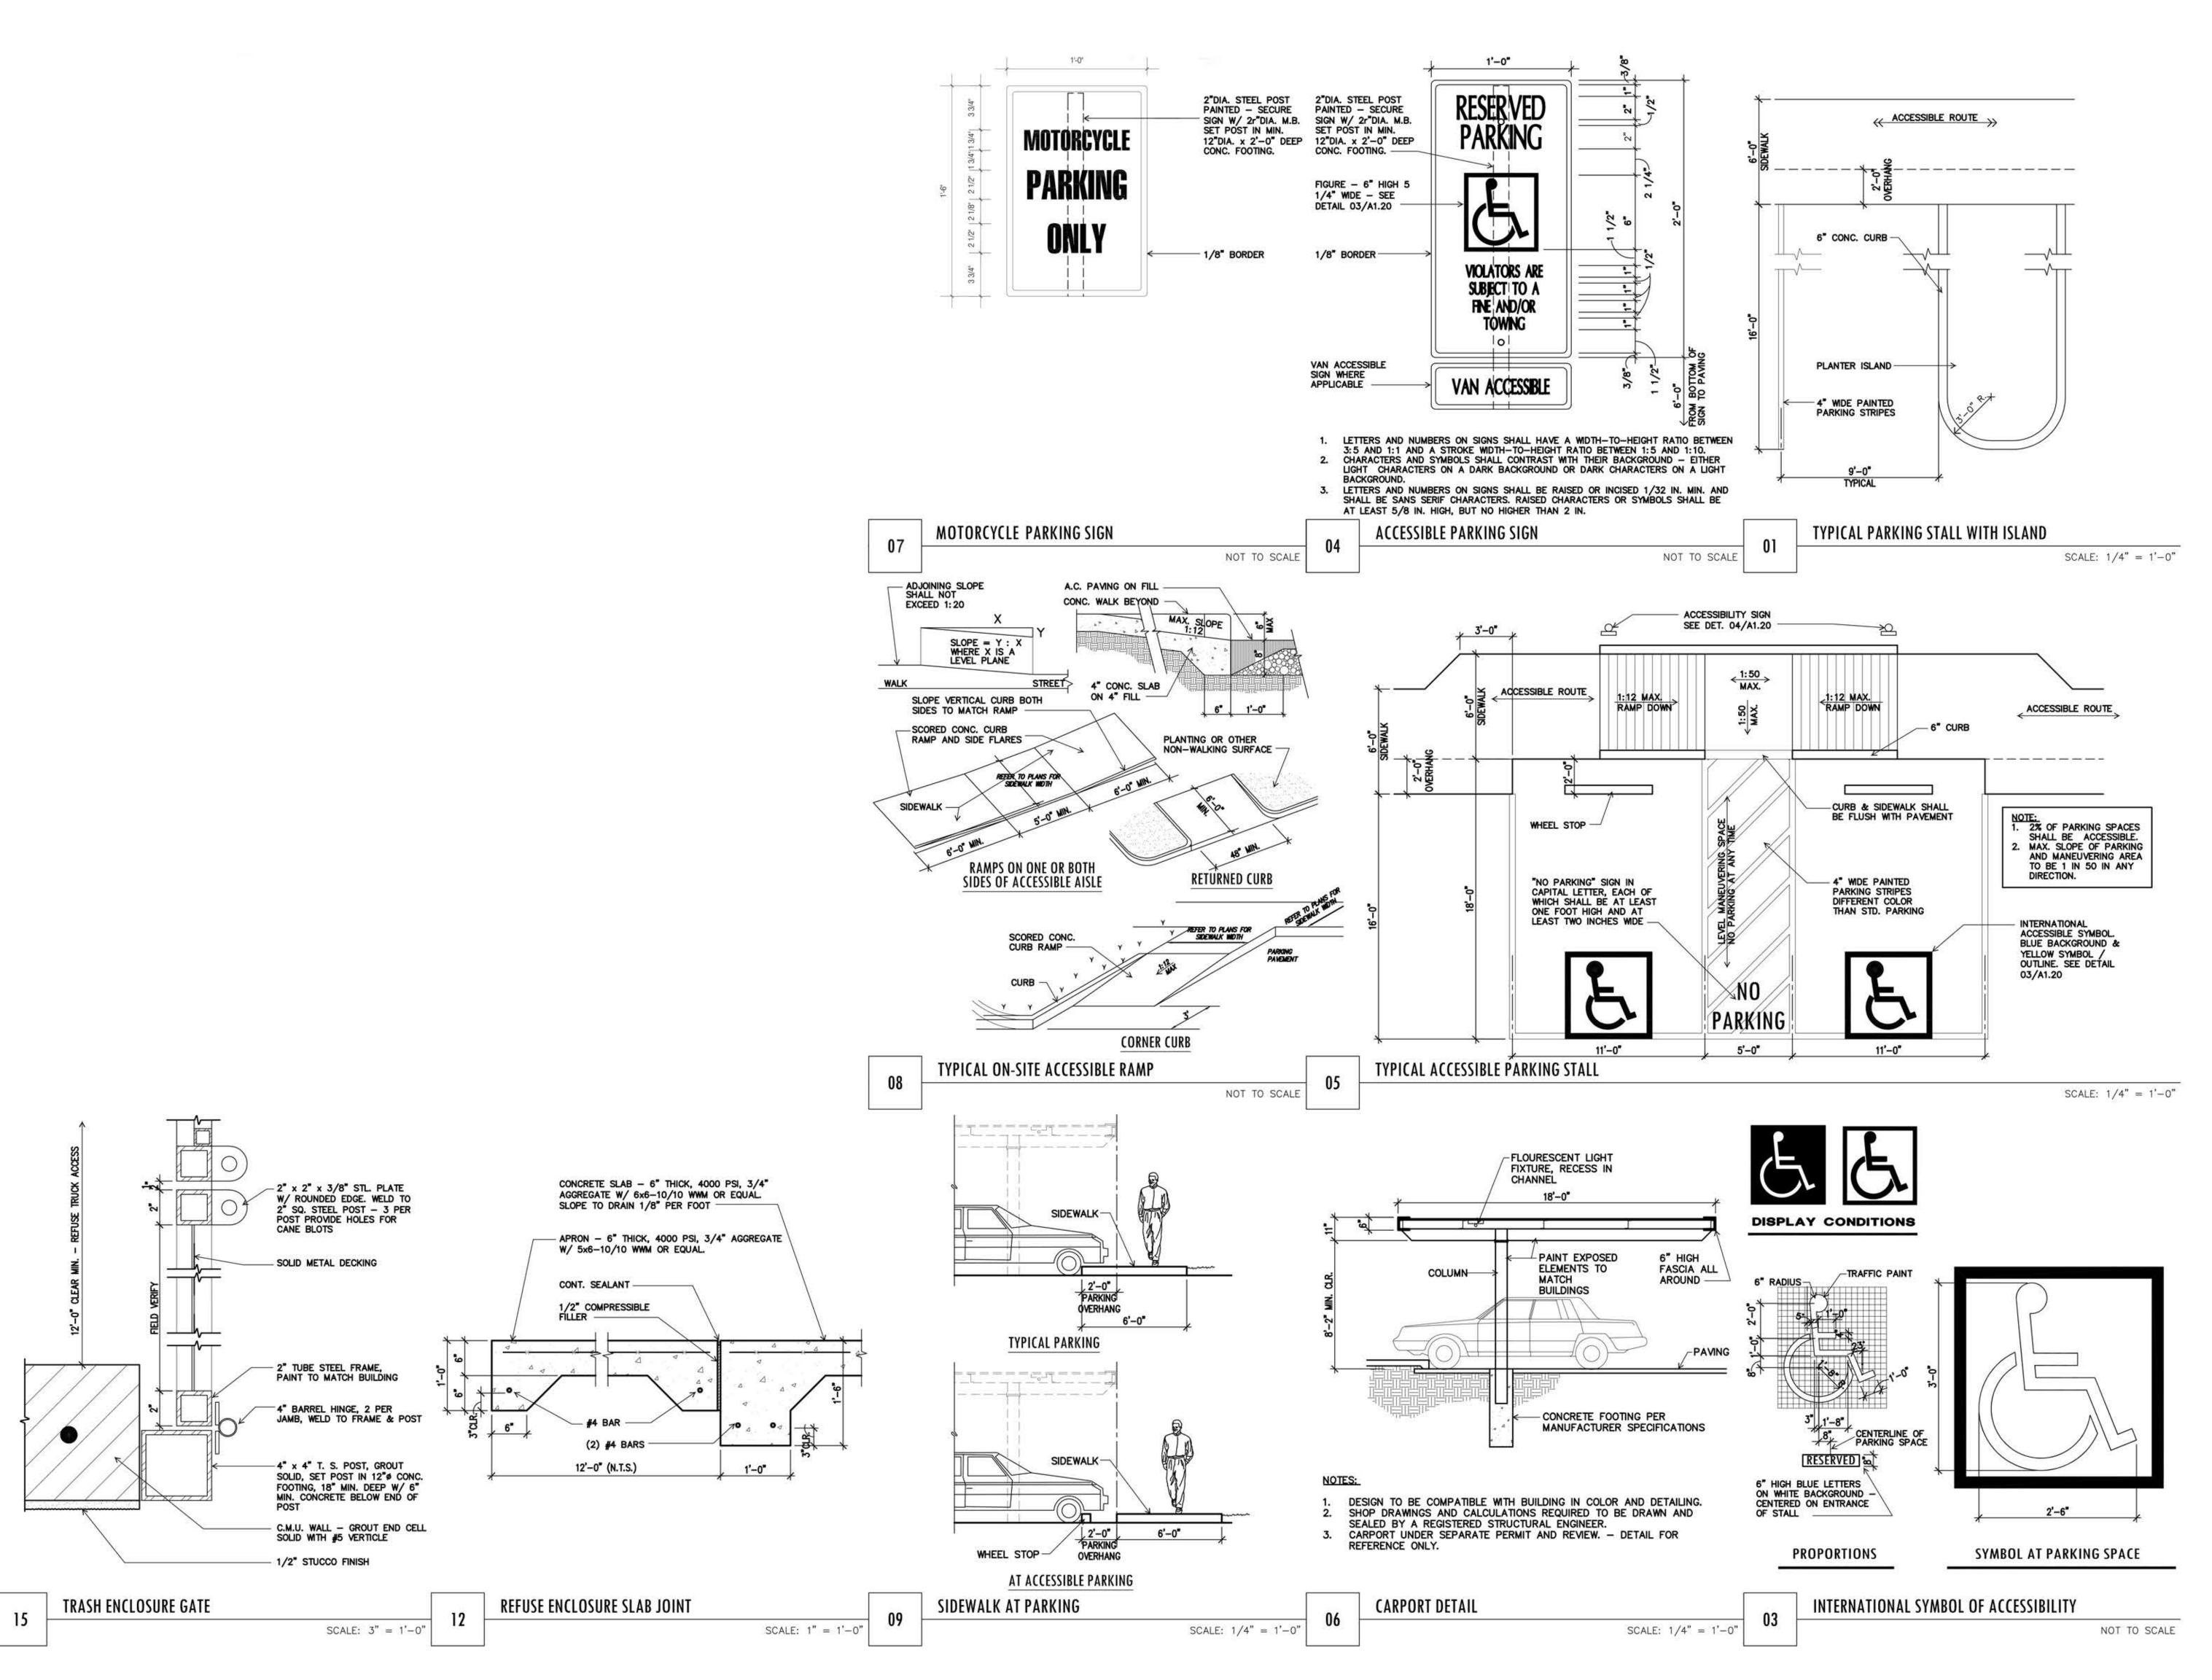
SITE DETAILS

SHEET 8 OF 9

SCALE: 3/8" = 1'-0"

8 OF 9

SHEET NUMBER



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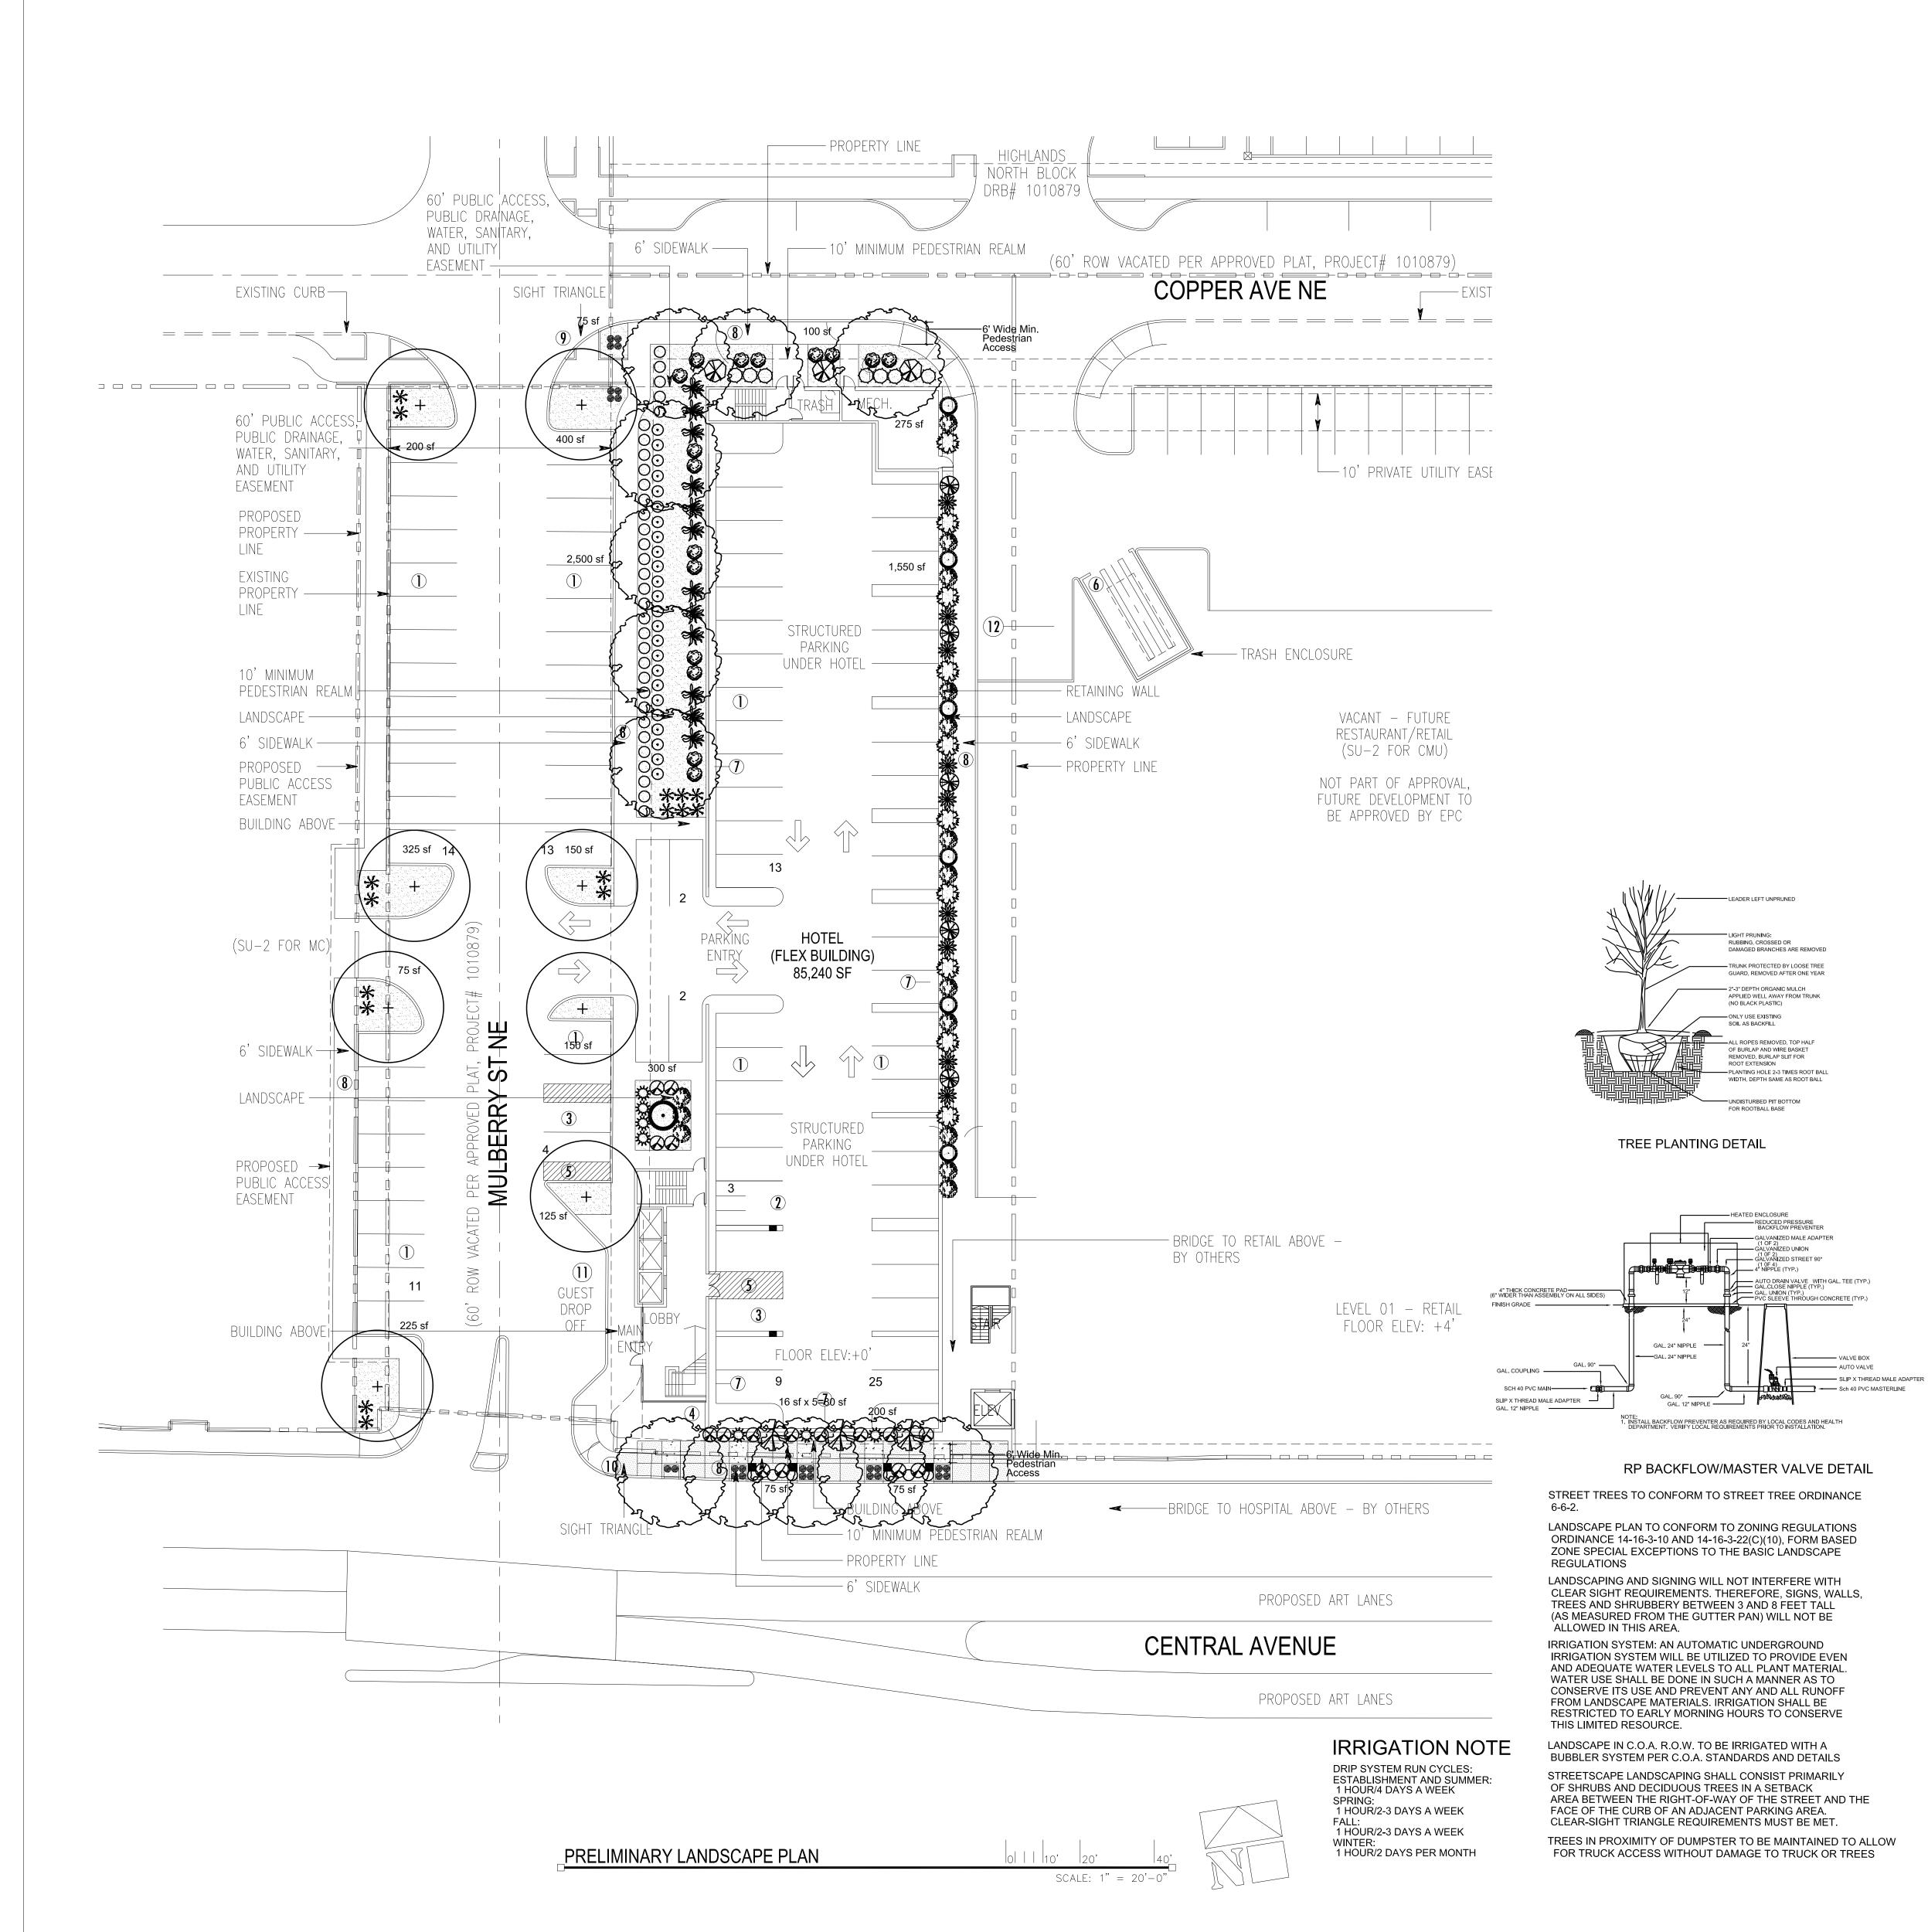
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IMM012 PROJECT NUMBER

SITE DETAILS

SHEET 9 OF 9

9 OF 9 SHEET NUMBER



PLANT LEGEND

Scientific Name

Qty.	Symbol	Scientific Name Common Name	Installed	Mature	Landscape	Water Drip
	Trees				ead Coverage	Use Emitters
12	\bigcirc	Fraxinus Raywood Ash	2" B&B	50'/30'	50 sf=600 sf	Medium +6-2 gph
8	\odot	Platanus Sycamore	2" B&B	50'/40'	50 sf=400 sf	Medium 6-2 gph
10	EXALE EXALE	Juniperus Skyrocket Juniper	15-Gal	20'/5'	50 sf=500 sf	Medium 6-2 gph
1	0	Pinus Bosnian Pine	6' HT.	15'/8'	50 sf=50 sf	Medium 6-2 gph
Shrubs	s/Groundco	overs				
	. 8.48					
15	77, 77, 77	Caryopteris clandonensis Blue Mist	1-Gal	3'/3'	25 sf=375 sf	Medium 2-2 gph
5		Cytisus Lena Broom	5-Gal	3'/4'	25 sf=125 sf	Low 2-1 gph
7	\bigcirc	llex Dwarf Burford Holly	5-Gal	4'/4'	16 sf=112 sf	Medium+ 2-1 gph
24	\odot	Salvia greggii Cherry Sage	1-Gal	3'/3'	15 sf=360 sf	Medium 2-1 gph
38	\circ	Lavandula Lavender	1-Gal	3'/3'	12 sf=456 sf	Medium 2-2 gph
16		Potentilla fruticosa Shrubby Cinquefoil	5-Gal	3'/3'	10 sf=160 sf	Medium+ 2-2 gph
12		Rosmarinus officinalis Rosemary	5-Gal	6'/6'	36 sf=432 sf	Low + 2-2 gph
7	3W	Rosa Knockout Rose	5-Gal	3'/3'	15 sf=105 sf	Medium+ 2-2 gph
3		Lagerstroemia Crape Myrtle	5-Gal	15'/10'	100 sf=300 sf	Medium+ 2-2 gph
16	$\overline{\Diamond}$	Rhaphiolepis India Hawthorn	5-Gal	3'/3'	15 sf=240 sf	Medium 2-2 gph
3	\otimes	Viburnum Burkwood Viburnum	5-Gal	6'/6'	36 sf=108 sf	Medium+ 2-2 gph
6	0	Pinus mugo Mugho Pine	5-Gal	4'/4'	30 sf=180 sf	Medium 2-2 gph
9	*	Nandina Heavenly Bamboo	5-Gal	3'/3'	20 sf=180 sf	Medium+ 2-2 gph
Grasse	s					
16	*	Muhlenbergia Deer Grass	1-Gal	4'/4'	20 sf=320 sf	Low+ 2-2 gph
26	**	Pennisetum Hamlin Fountain Grass	1-Gal	3'/3'	9 sf=234 sf	Medium 2-2 gph
			Tota	l Landsc	ape Coverage=	5,237 SF

MATERIALS LEGEND

BROWN CRUSHER FINES	4 44	CONCRETE COLOR 1
PAVERS		CONCRETE COLOR 2

SITE DATA ____<u>51,564</u> SF **GROSS/SITE LOT AREA** LESS BUILDING(S) <u>18,797</u> SF <u>32,767</u> SF NET LOT AREA REQUIRED LANDSCAPE 10% OF NET LOT AREA PROPOSED STREET LEVEL LANDSCAPE 6,880 SF PERCENT OF NET LOT AREA REQUIRED USABLE OPEN SPACE LANDSCAPE AREA PROPOSED USABLE OPEN SPACE REQUIRED USABLE OPEN SPACE LANDSCAPE 15% OF USABLE OPEN SPACE PROPOSED USABLE OPEN SPACE LAND. 6,880 SF PERCENT OF NET LOT AREA HIGH WATER USE TURF MAX. 20% OF LANDSCAPE AREA PROPOSED HIGH WATER USE TURF PERCENT OF LANDSCAPE AREA REQUIRED STREET TREES 1 PER 25 L.F. OF STREET FRONTAGE PROVIDED STREET TREES REQUIRED PARKING LOT TREES 1 PER 8 SPACES 43 SPACES/8 PROVIDED PARKING LOT TREES REQUIRED LANDSCAPE COVERAGE 75% LIVE VEGETATIVE MATERIAL (6,880 SF PROPOSED LANDSCAPE X 75%) 5,160 SF MIN. PROVIDED GROUNDCOVER COVERAGE PERCENT GROUNDCOVER COVERAGE 5,237 SF

NOTE

FROM A TREE.

MAINTENANCE OF LANDSCAPE (ONSITE AND WITHIN ROW)
TO BE MAINTAINED BY PROPERTY OWNER

PLANTINGS TO BE WATERED BY AUTO. DRIP IRRIGATION SYSTEM WITH REDUCED PRESSURE BACKFLOW PREVENTER PER CITY OF ALBUQUERQUE

76%

WATER MANAGEMENT IS THE SOLE RESPONSIBILITY OF THE PROPERTY OWNER

THIS PLAN IS TO COMPLY WITH C.O.A. LANDSCAPE AND WATER WASTE ORDINANCE 6-1-1. PLANTING RESTRICTIONS APPROACH

OF REQUIRED LANDSCAPE AREAS

IT IS THE INTENT OF THIS PLAN TO PROVIDE MIN. 75% LIVE GROUNDCOVER OF LANDSCAPE AREAS AT MATURITY PER ORDINANCE 14-16-3-10 (SEE CALCULATIONS PROVIDED ABOVE)

LANDSCAPE AREAS TO BE MULCHED WITH GRAVEL MULCH AT 2"-3" DEPTH

APPROVAL OF THE LANDSCAPE PLAN DOES NOT CONSTITUTE OR IMPLY COMPLIANCE WITH, OR EXEMPTION FROM, THE C.O.A LANDSCAPE AND WATER WASTE ORDINANCE 6-1-1.

NO PARKING SPACE SHALL BE MORE THEN 50'

1217 Main Street
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(214-670-0050 Christine Robbins-Elrod)
CIVIL ENGINEER
Bohannan Huston

7525 Second Street NW

MEP ENGINEER

5G Studio Collaborative, LLC..

ARCHITECT

7500 Jefferson Street NE
Albuquerque, New Mexico 87109
(505-823-1000 Mike Balaskovits)

LANDSCAPE
Heads Up Landscaping

(505-898-9615 John Braly)

STRUCTURAL ENGINEER

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400 Chisholm Place, Suite 106

Plano, TX 75075

(214-501-3354 Mohammad Kabir)

Albuquerque, New Mexico 87107

MEP Systems Design & Engineering, Inc. 918 Dragon Street, Suite 500 Dallas, TX 75207 (214-915-0929 Mark Portnoy)

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(505-998-0163 Josh Rogers)

OPERATOR
Intermoutain Management, LLC
2390 Tower Drive
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(318-812-7126 Dave Raymond)




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SPRINGHILL SUITES - ALBUQUERQUE CENTRAL AVE. & MULBERRY ST. ALBUQUERQUE, NM 87106

LANDSCAPE PLAN FOR BUILDING PERMIT

SHEET NUMBER



DRAINAGE NARRATIVE

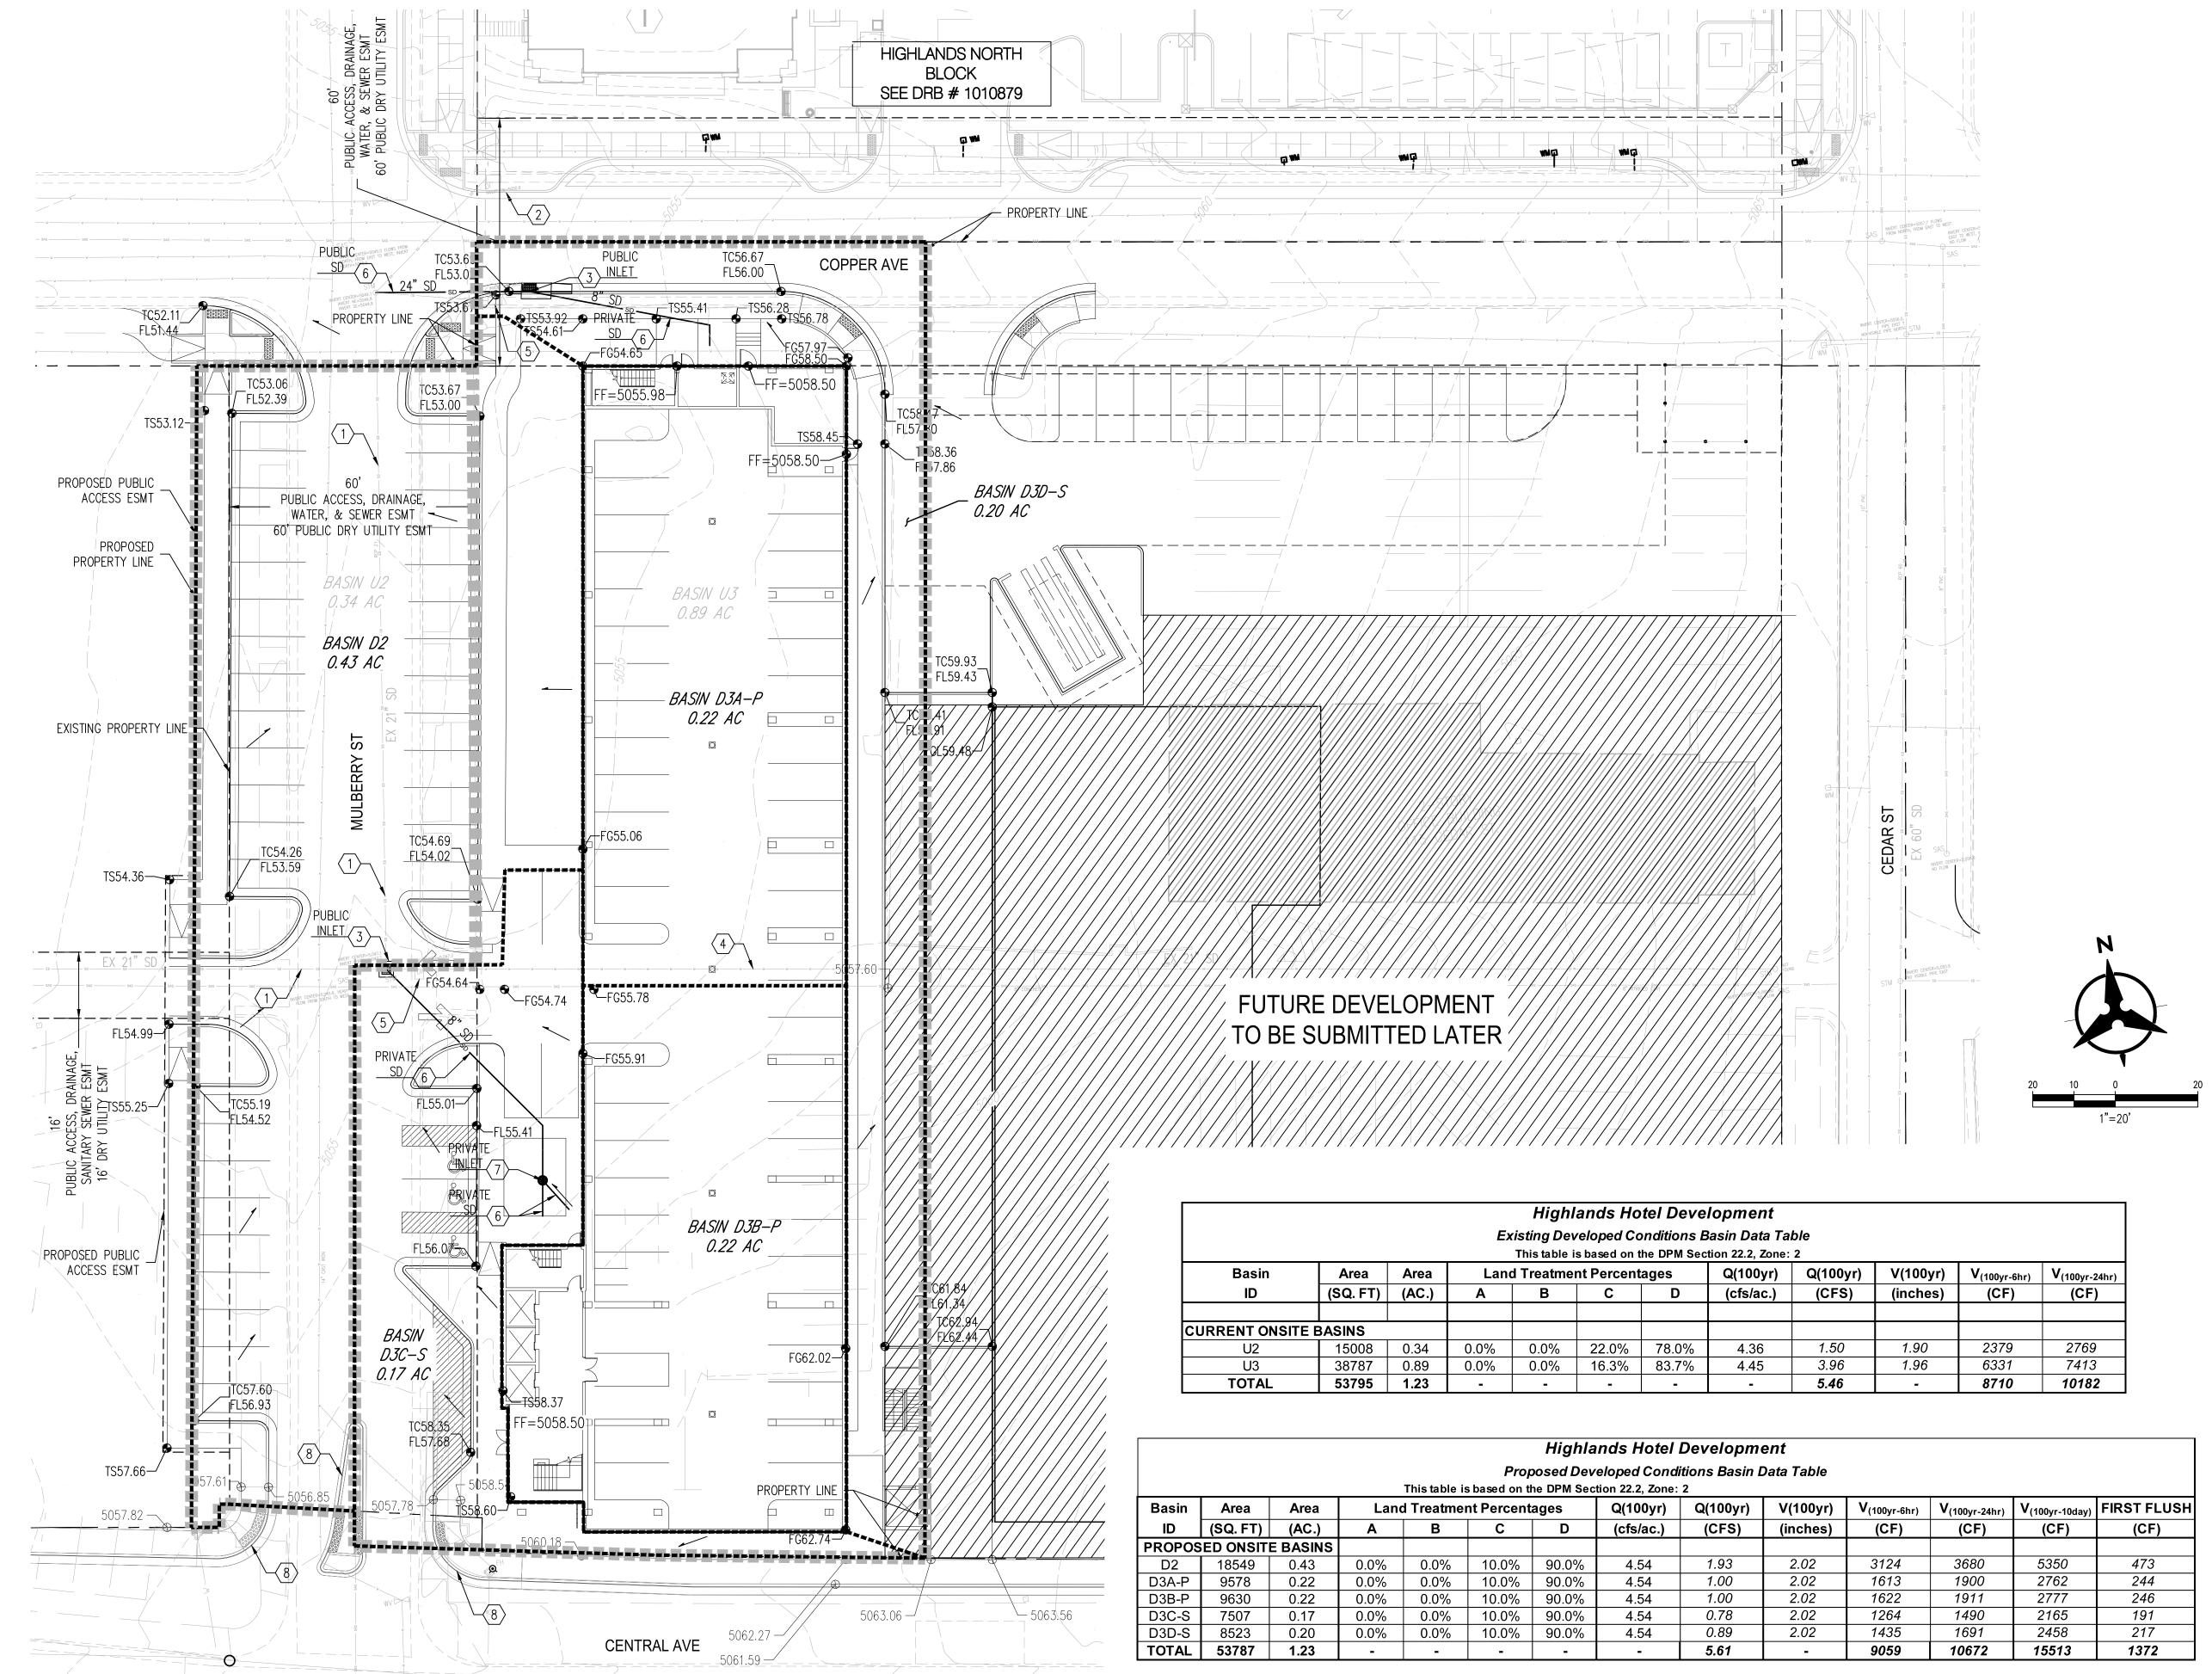EXISTING CONDITIONS

5.46 CFS.

THIS SITE IS LOCATED AT THE NORTHEAST CORNER OF MULBERRY ST NE AND CENTRAL AVE NE. IT IS CURRENTLY DEVELOPED AND SLOPES FROM SOUTHEAST TO NORTHWEST. THE DRAINAGE ULTIMATELY OUTFALLS TO THE EXISTING PUBLIC STORM DRAIN SYSTEM LOCATED JUST WEST OFF THE SITE WITHIN MULBERRY. THIS SITE HAS HISTORICALLY BEEN FULLY DEVELOPED AS COMMERCIAL DEVELOPMENT.

THE SITE LIES WITHIN TWO EXISTING ONSITE BASINS, U2 & U3, BASIN U2 IS A PART OF A LARGER BASIN THAT SURFACE DRAINS TO AN INLET IN OAK ST. AND DRAINS TO A SYSTEM THAT ULTIMATELY HEADS WEST UNDERNEATH I-25. BASIN U3 IS ALSO A PART OF A LARGER BASIN THAT SURFACE DRAINS TO AN INLET IN COPPER AVE NORTH OF THIS SITE AND IS DISCHARGED INTO THE EXISTING 21" SD WITHIN MULBERRY ST.

THE TOTAL ONSITE EXISTING FLOW RATE FROM THE CURRENT DEVELOPMENT IS APPROXIMATELY

PROPOSED CONDITIONS

THE HIGHLANDS HOTEL WILL INCLUDE A NEW HOTEL THAT SITS AT THE NORTHEAST INTERSECTION OF CENTRAL AVE AND MULBERRY ST. ON STREET PARKING WILL BE PROVIDED AS A RESULT OF THIS PROJECT. TWO EXISTING STORM DRAIN INLETS WILL BE REMOVED AND LOCATED AS A RESULT OF NEW CURB AND GUTTER IMPROVEMENTS. THIS IMPERVIOUS AREA OF THE SITE WILL INCREASE TO 90% D AND 10% C FOR DEVELOPED FLOWS. LANDSCAPED AREAS THROUGHOUT THE SITE WILL BE DEPRESSED WHERE APPLICABLE TO CAPTURE DRAINAGE IN AN ATTEMPT TO MEET THE FIRST FLUSH REQUIREMENTS, HOWEVER, ULTIMATELY THE CLIENT HAS

DECIDED TO PAY CASH-IN-LIEU FOR THE FIRST FLUSH REQUIREMENTS. THE DEVELOPED BASINS WILL ADHERE TO THE HISTORIC FLOW WITH FEW EXCEPTIONS. THE

FOLLOWING IS A DESCRIPTION OF HOW EACH BASIN WILL DRAIN. PLEASE REFER TO THE "PROPOSED DEVELOPED CONDITIONS BASIN DATA TABLE" FOR THE PROPOSED BASIN FLOWS. BASIN D2 INCLUDES A PORTIONS OF THE SITE'S PROPOSED PARKING IMPROVEMENTS AS WELL AS EXISTING MULBERRY ST. THIS AREA CONTINUES TO SHEET FLOW TO COPPER AVE AND INTO THE INLETS AT COPPER AVE AND OAK ST.

BASIN D3A-P INCLUDES ROOF DRAINAGE FROM THE HOTEL THAT WILL BE PIPED DIRECTLY INTO THE TOTAL ONSITE PROPOSED FLOW RATE FROM THE PROPOSED DEVELOPMENT IS THE COPPER AVE PROPOSED RELOCATED INLET WHICH ULTIMATELY TIES TO THE EXISTING 21"

RCP LINE THAT RUNS IN MULBERRY ST. BASIN D3B-P INCLUDES ROOF DRAINAGE FROM THE HOTEL THAT WILL BE PIPED INTO THE PROPOSED RELOCATED INLET WITHIN MULBERRY WHICH ULTIMATELY TIES TO THE EXISTING 21"

RCP LINE WHICH RUNS IN MULBERRY ST AND WEST THROUGH THE EXISTING ALLEY. BASIN D3C-S INCLUDES A PORTION OF THE SITE'S HARDSCAPE, LANDSCAPE, PROPOSED PARKING IMPROVEMENTS, AS WELL AS A PORTION OF MULBERRY ST. THIS AREA CONTINUES TO


SHEET FLOW TO THE PROPOSED RELOCATED INLET WITHIN MULBERRY ST.


BASIN D3D-S INCLUDES A PORTION OF THE SITE'S HARDSCAPE AND LANDSCAPING FEATURES WHICH WILL CONTINUE TO SHEET FLOW INTO THE PROPOSED RELOCATED INLET WITHIN COPPER

APPROXIMATELY 5.61 CFS. COMPARISON OF THE FLOW BETWEEN EXISTING AND PROPOSED CONDITIONS WAS FOUND TO HAVE AN OVERALL INCREASE OF 0.2 CFS, OVERALL INDICATING THAT THE HISTORICAL DEVELOPED FLOWS ARE CLOSE TO THE SITE'S PROPOSED DEVELOPED CONDITIONS. THESE MINOR ADJUSTMENTS DEMONSTRATE THAT THE DRAINAGE ELEMENTS PROPOSED WITH THE PROJECT ARE CAPABLE OF SAFELY CONVEYING THE 100 YR, 6 HR STORM EVENT IN ACCORDANCE WITH THE DEVELOPMENT PROCESS MANUAL. WITH THIS SUBMITTAL, WE ARE REQUESTING COA HYDROLOGY APPROVAL IN SUPPORT OF SITE PLAN FOR BUILDING PERMIT



VICINITY MAP ZONE MAP K-15-Z

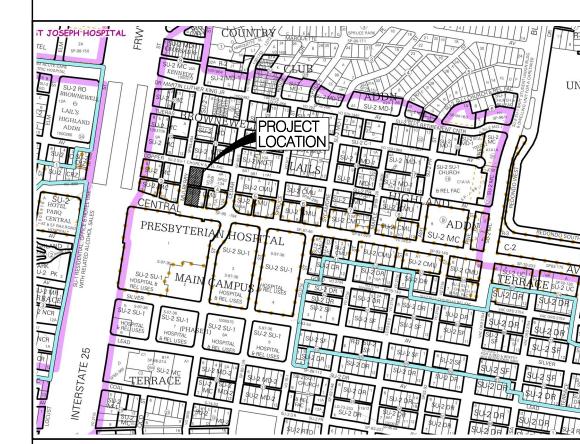

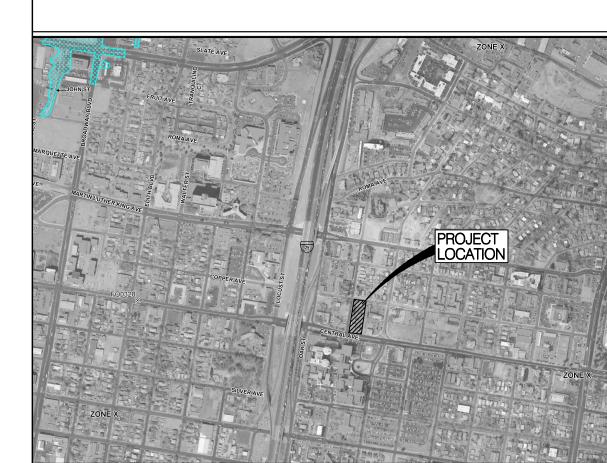

FEMA FIRM

MAP #: 35001C0334G

GRADING KEYNOTES


1. EXISTING STORM DRAIN TO REMAIN.

- 2. STORM DRAIN INLET AND IMPROVEMENTS TO BE CONSTRUCTED A PART OF PROJECT DRB #1010879.
- 3. EXISTING INLET TO BE REMOVED AND RELOCATED.
- 4. EXISTING STORM DRAIN TO BE REMOVED.
- 5. EXISTING STORM DRAIN INLET TO BE REMOVED.
- 6. PROPOSED NEW STORM DRAIN.
- 7. PROPOSED NEW STORM DRAIN INLET.
- 8. EXISTING ART CURB & GUTTER CONSTRUCTED WITH ART PROJECT.

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CONTACT: CHRISTINE ROBBINS-ELROD

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BOHANNAN HUSTON 7500 JEFFERSON STREET NE ALBUQUERQUE, NEW MEXICO 87109

CONTACT: MIKE BALASKOVITS CONSENSUS PLANNING, INC. 302 EIGHTH STREET NW

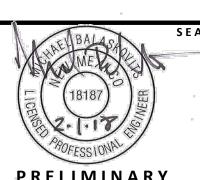ALBUQUERQUE, NEW MEXICO 87102 CONTACT: SALVATOR PERDOMO

505.823.1000

PROJECT

SPRINGHILL SUITES* MARRIOTT

ALBUQUERQUE

PROJECT ADDRESS **CENTRAL AVE. & MULBERRY ST ALBUQUERQUE, NM 87106**

	REV.	DATE	ISSUE
	_	02.14.18	DRB SUBMITTAL
D CURB & GUTTER			
N OF FLOW			
LOCK/GRADE			
D STORM DRAIN			
D STORM DRAIN			
D STORM DRAIN			IMM012 PROJECT NUMBER
			CDADING

NUMBER **GRADING** & DRAINAGE PLAN

C-100 SHEET NUMBER

TS=TOP OF SIDEWALK

FGH=FINISH GROUND HIGH,

FGL=FINISH GROUND LOW

TG=TOP OF GRATE,

BASIN DXX-S PROPOSED BASIN ID-SHEET


GRADING LEGEND					
	PROPERTY LINE		PROPOSED CURB & GUTTER		
	PROJECT LIMITS OF GRADING	S=2.0%	DIRECTION OF FLOW		
	EXISTING INDEX CONTOUR		WATER BLOCK/GRADE		
	EXISTING INTERMEDIATE CONTOUR		PROPOSED STORM DRAIN		
◆ 5025.25	EXISTING GROUND SPOT ELEVATION	•	PROPOSED STORM DRAIN MANHOLE		
5 <i>025</i>	PROPOSED INDEX CONTOUR				
5024	PROPOSED INTERMEDIATE CONTOUR		PROPOSED STORM DRAIN INLETS		
→ ^{26.75}	PROPOSED FINISHED GRADE SPOT ELEVATION TC=TOP OF CURB,		PROPOSED RETAINING WALL EASEMENT		
	FL=FLOW LINE,		EXISTING BASIN BOUNDARY		

PROPOSED BASIN BOUNDARY

BASIN UXX EXISTING BASIN ID

BASIN DXX-P PROPOSED BASIN ID-PIPED

Bohannan A Huston

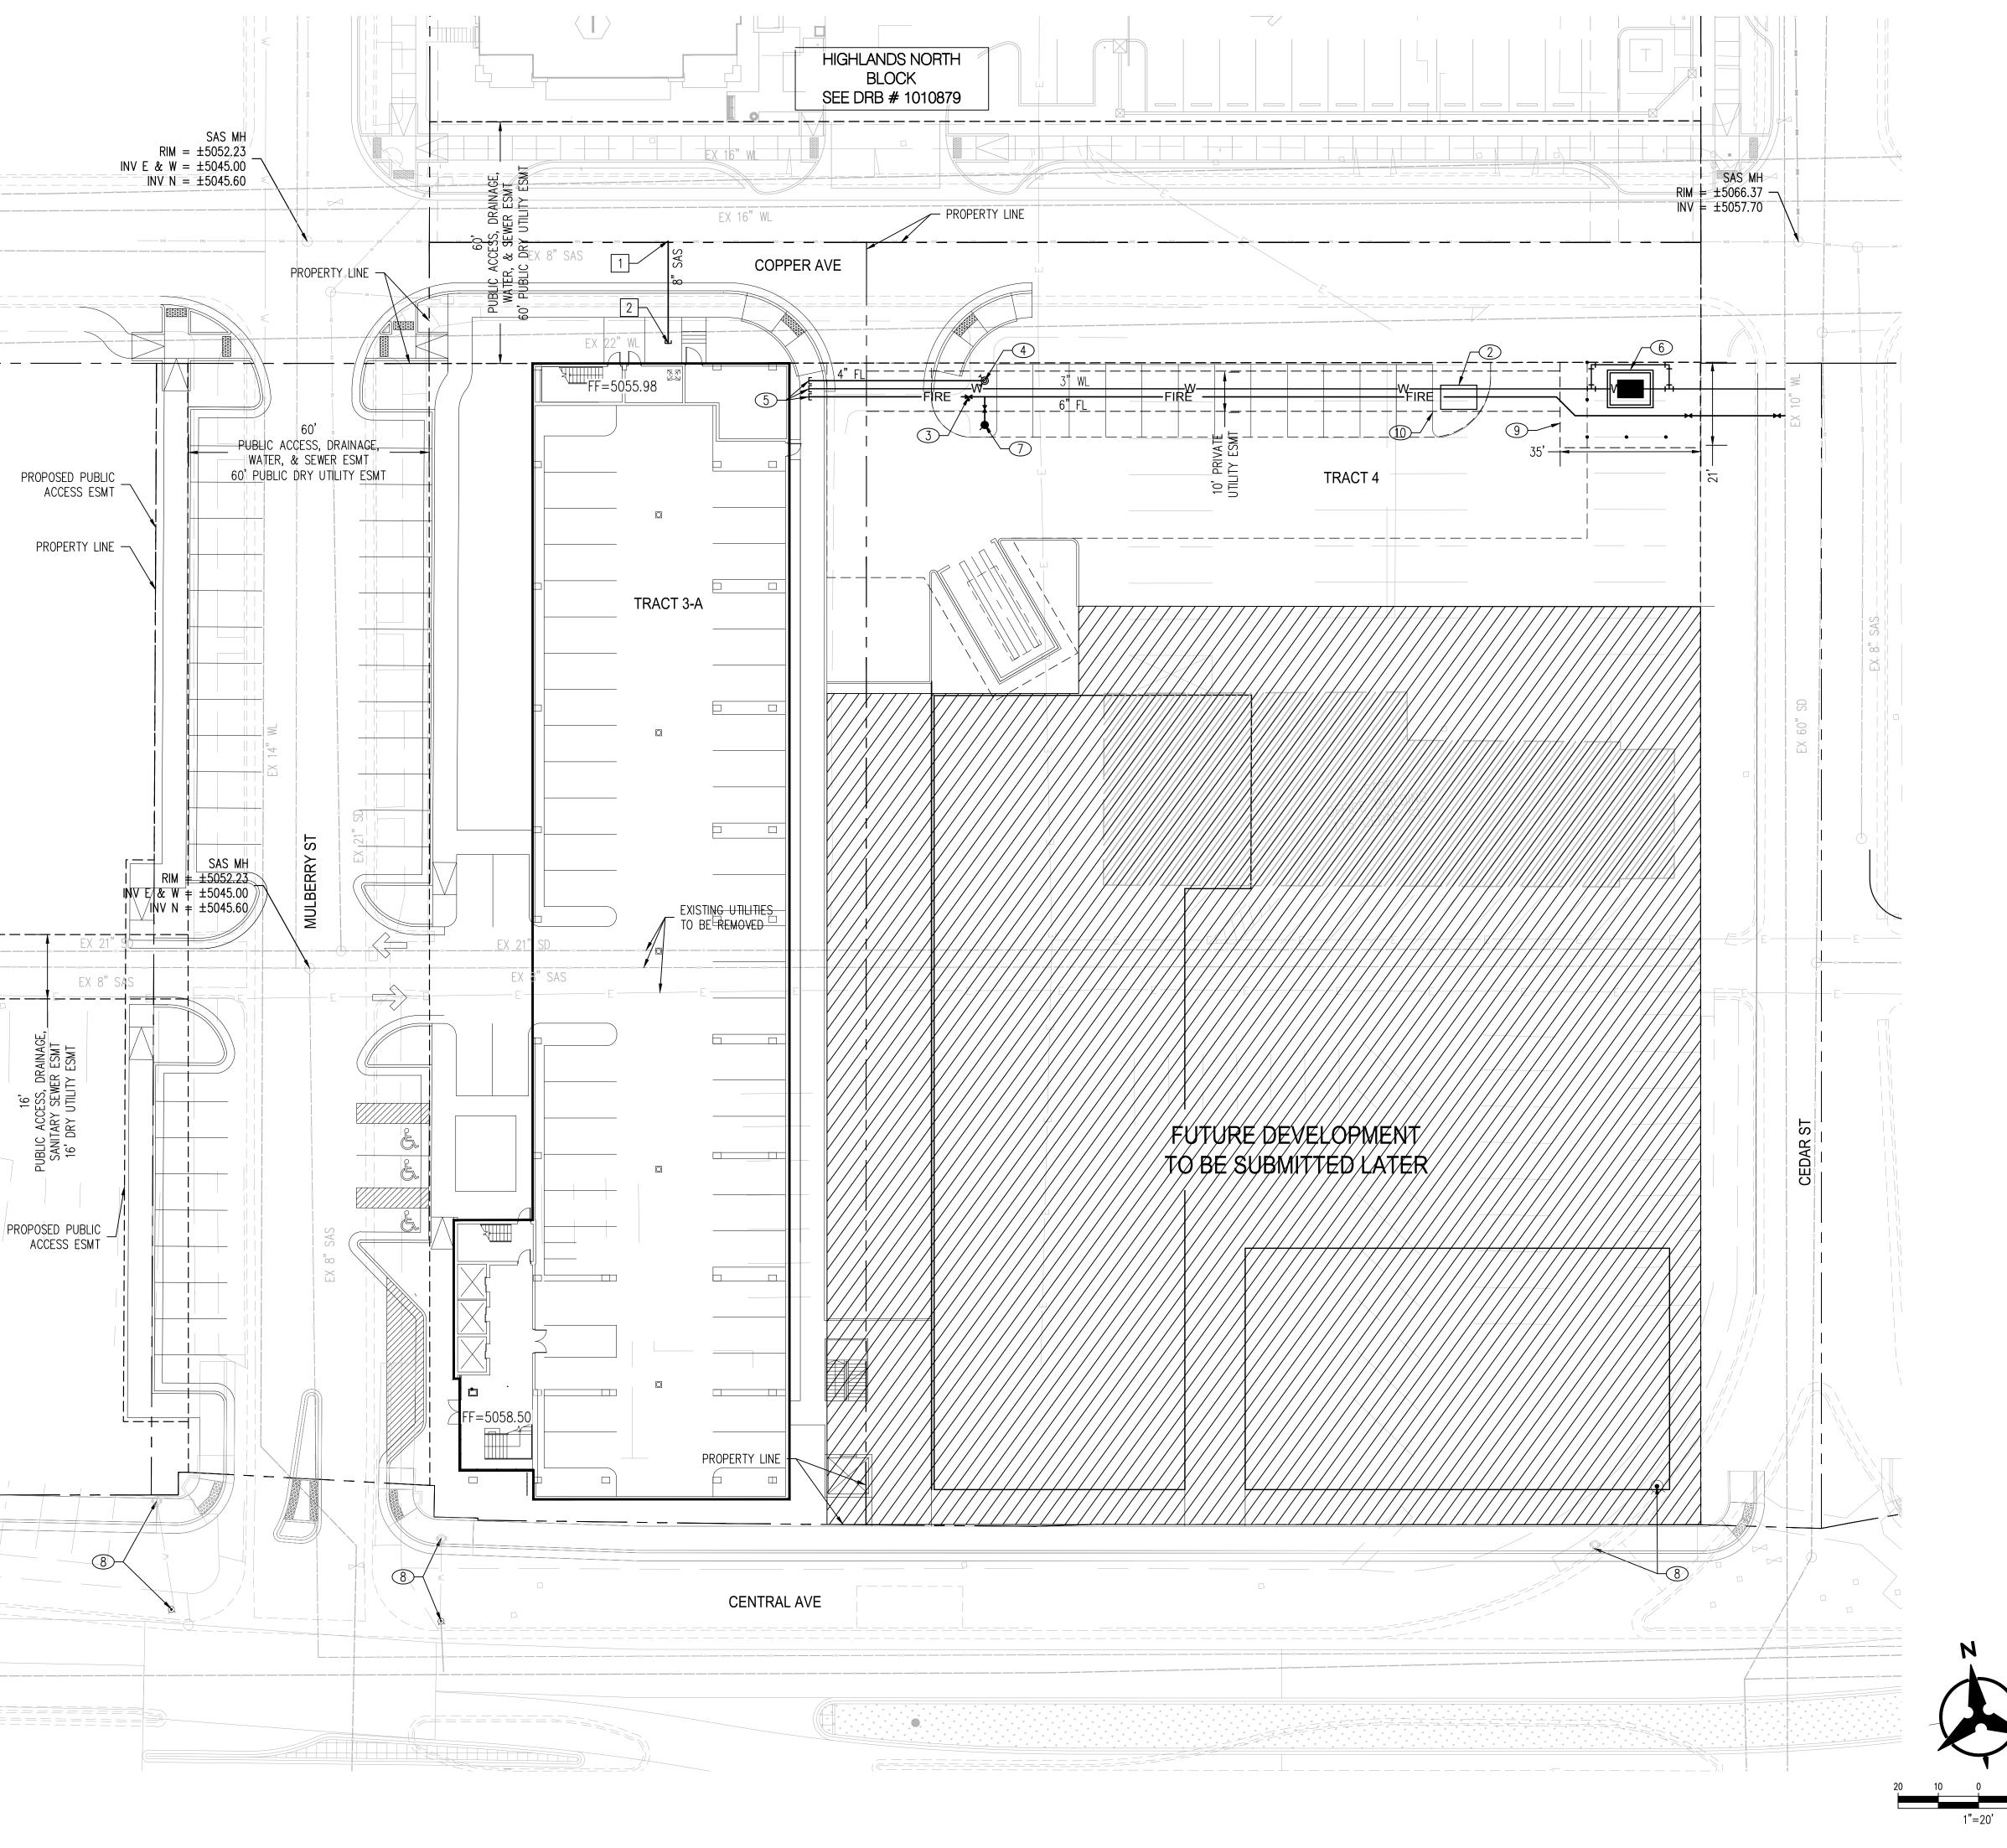



○ WATERLINE KEYNOTES

- CONNECT TO EXISTING WATER LINE. CONTRACTOR SHALL FIELD VERIFY EXISTING SIZE AND LOCATION AND NOTIFY ENGINEER WITH ANY DISCREPANCIES.
- 2. INSTALL DUAL FIRE AND DOMESTIC REDUCED PRESSURE BACKFLOW PREVENTION DEVICES WITHIN A HEATED ENCLOSURE. INSTALL PER MANUFACTURER SPECIFICATIONS. SEE ELECTRICAL PLANS FOR POWER.
- 3. INSTALL POST INDICATOR VALVE.
- 4. INSTALL REMOTE FIRE DEPARTMENT CONNECTION. SEE PLUMBING PLANS FOR CONTINUATION.
- 5. INSTALL STUB WITHIN 5' OF BUILDING. SEE PLUMBING PLANS FOR CONTINUATION.
- 6. INSTALL 3" WATER METER.
- 7. INSTALL PRIVATE FIRE HYDRANT.
- 8. RELOCATED PUBLIC FIRE HYDRANT (BY ART PROJECT).
- 9. NEW 35'X 21' PUBLIC WATER METER EASEMENT TO BE GRANTED TO ABCWUA.
- 10. NEW 10' PRIVATE UTILITY EASEMENT.

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☐ SANITARY SEWER KEYNOTES

- CONNECT TO EXISTING SANITARY SEWER. CONTRACTOR SHALL FIELD VERIFY EXISTING INVERT ELEVATIONS AND NOTIFY ENGINEER WITH ANY DISCREPANCIES. SEE PUBLIC WORK ORDER (CPN #XXXXX).
- 2. INSTALL SANITARY SEWER SERVICE TO WITHIN 5' OF BUILDING. SEE PLAN FOR SIZE. SEE PLUMBING PLANS FOR CONTINUATION.

OWNER / DEVELOPER TITAN DEVELOPMENT

6300 RIVERSIDE PLAZA LANE NW, STE 200 ALBUQUERQUE, NEW MEXICO 87120 505.998.0163 CONTACT: JOSH ROGERS

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CIVIL ENGINEER

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CONSENSUS PLANNING, INC. 302 EIGHTH STREET NW ALBUQUERQUE, NEW MEXICO 87102 505.764.9801 CONTACT: SALVATOR PERDOMO

UTILITY LEGEND

PROPERTY LINE

---- EXISTING EASEMENT

_____WL____ EXISTING WATER LINE

EXISTING SANITARY

EXISTING WATER METER

EXISTING FIRE HYDRANT

EXISTING STORM DRAIN

EXISTING SANITARY SEWER MANHOLE

MANHOLE

EXISTING INLET

EXISTING CAP

EXISTING VALVE

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PROJECT

PROPOSED SANITARY SEWER LINE **ALBUQUERQUE** PROPOSED SANITARY

REV. DATE ISSUE

————— PROPOSED EASEMENT

SEWER MANHOLE

PROPOSED CLEANOUT

PROPOSED WATER LINI

PROPOSED FIRE WATER

PROPOSED HYDRANT

PROPOSED CAP

PROPOSED PIV

REMOTE FIRE DEPARTMENT CONNECTION

PROPOSED VALVE

PROJECT ADDRESS


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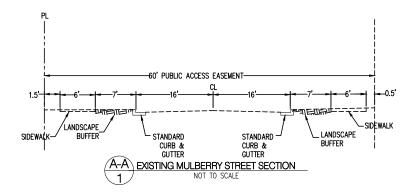
02.14.18 DRB SUBMITTAL PROPOSED WATER METER


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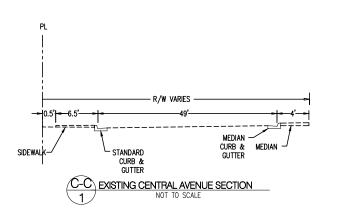
> > **C-200** SHEET NUMBER

UTILITY PLAN





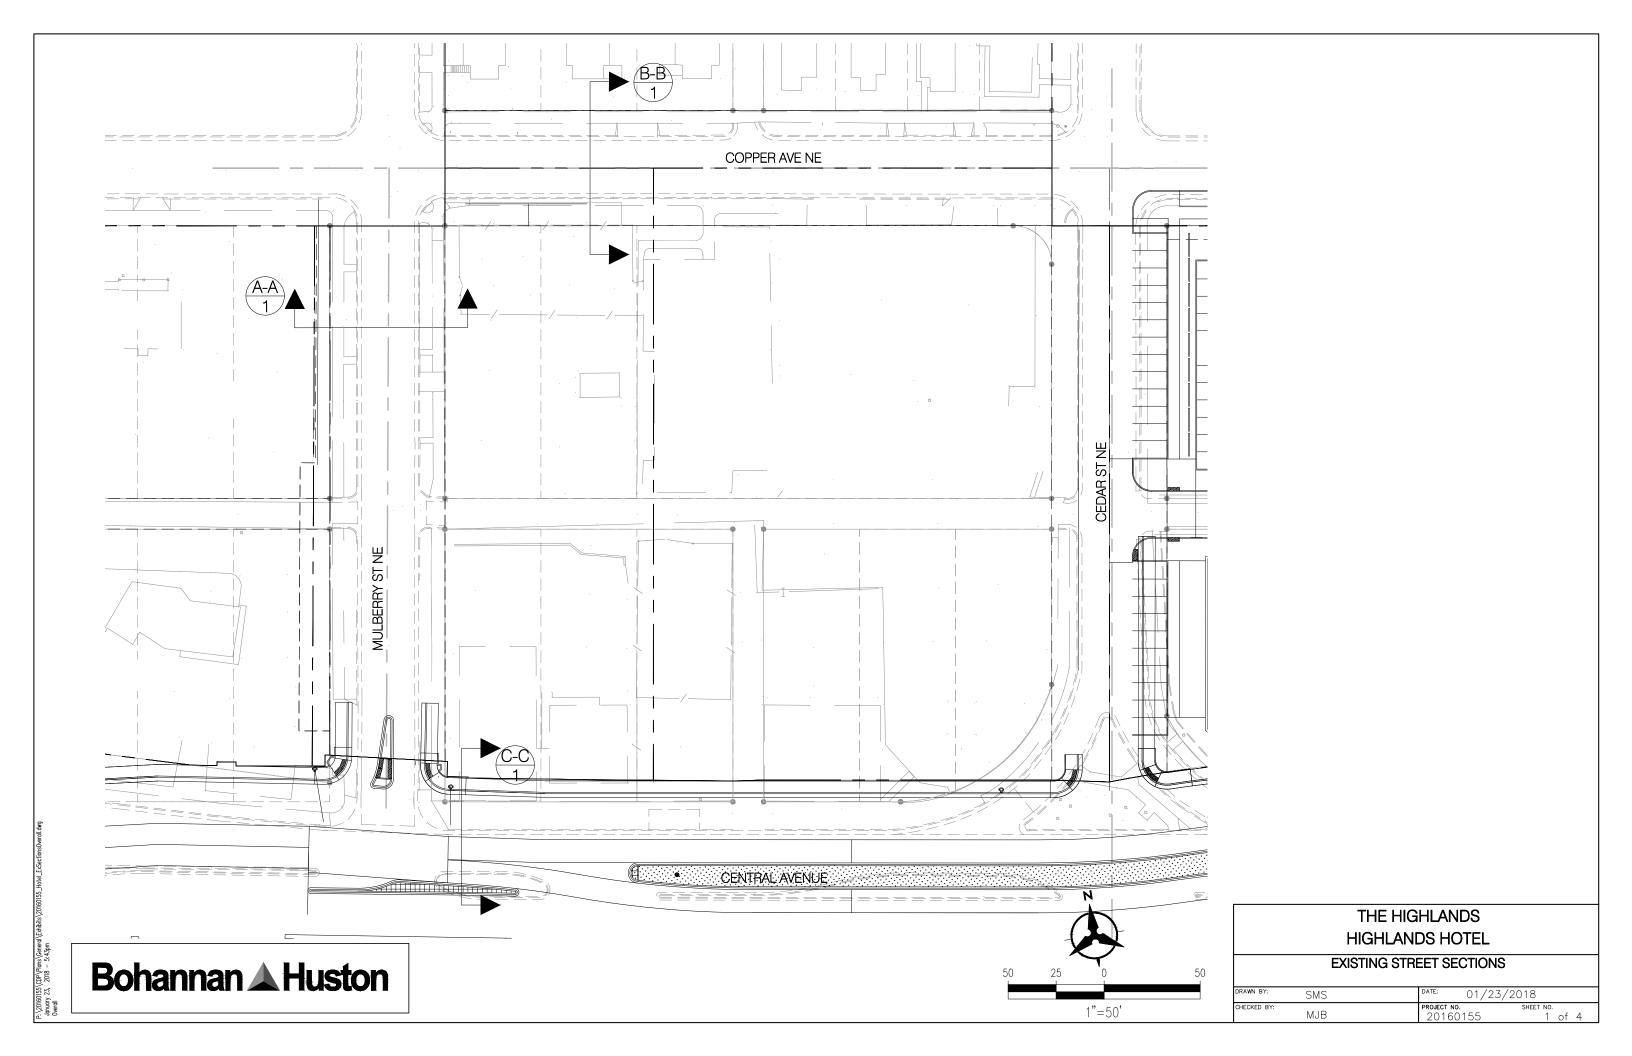


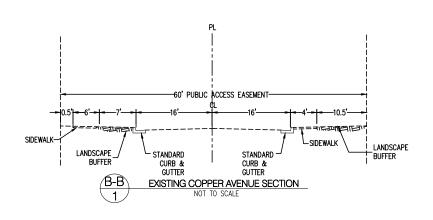



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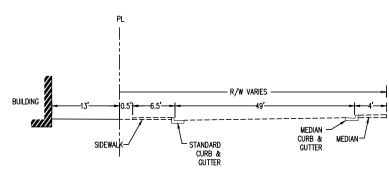
Bohannan ▲ Huston

	Th	IE HIGHLANDS
	HIG	HLANDS HOTEL
	EXISTII	NG STREET SECTIONS
RAWN BY:	SMS	DATE: 01/23/2018
HECKED BY:	MJB	PROJECT NO. SHEET NO. 20160155 2 of 4



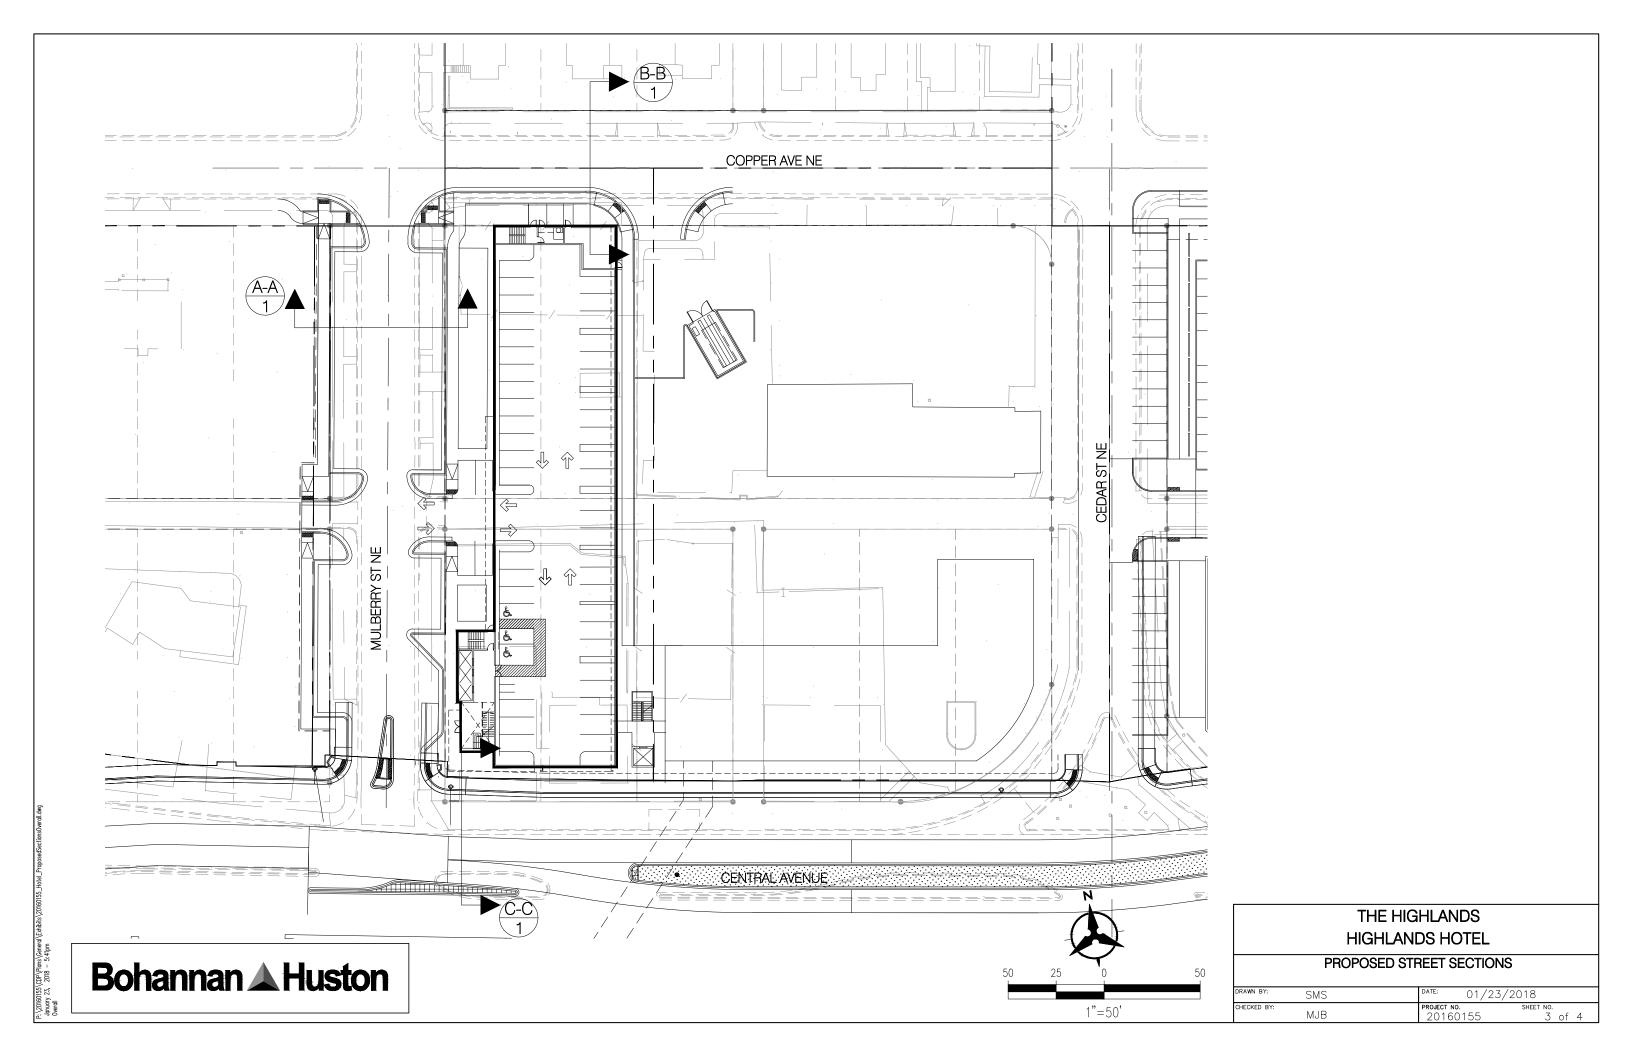

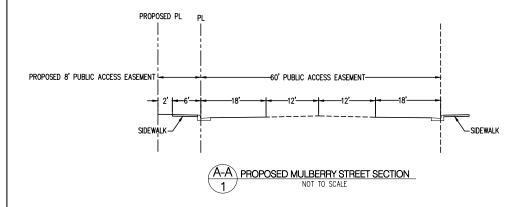

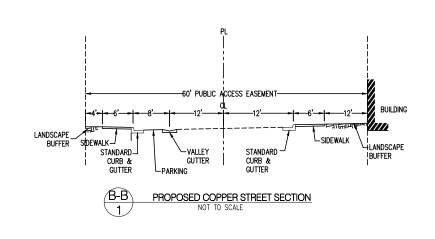

C-C PROPOSED CENTRAL AVENUE SECTION

NOT TO SCALE

THE HIGHLANDS HIGHLANDS HOTEL

PROPOSED STREET SECTIONS

DRAWN BY: SMS DATE: 01/23/2018

CHECKED BY: PROJECT NO. SHEET NO. 20160155 4 of 4

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_EAST ELEVATION

WEST ELEVATION AT MULBERRY STREET

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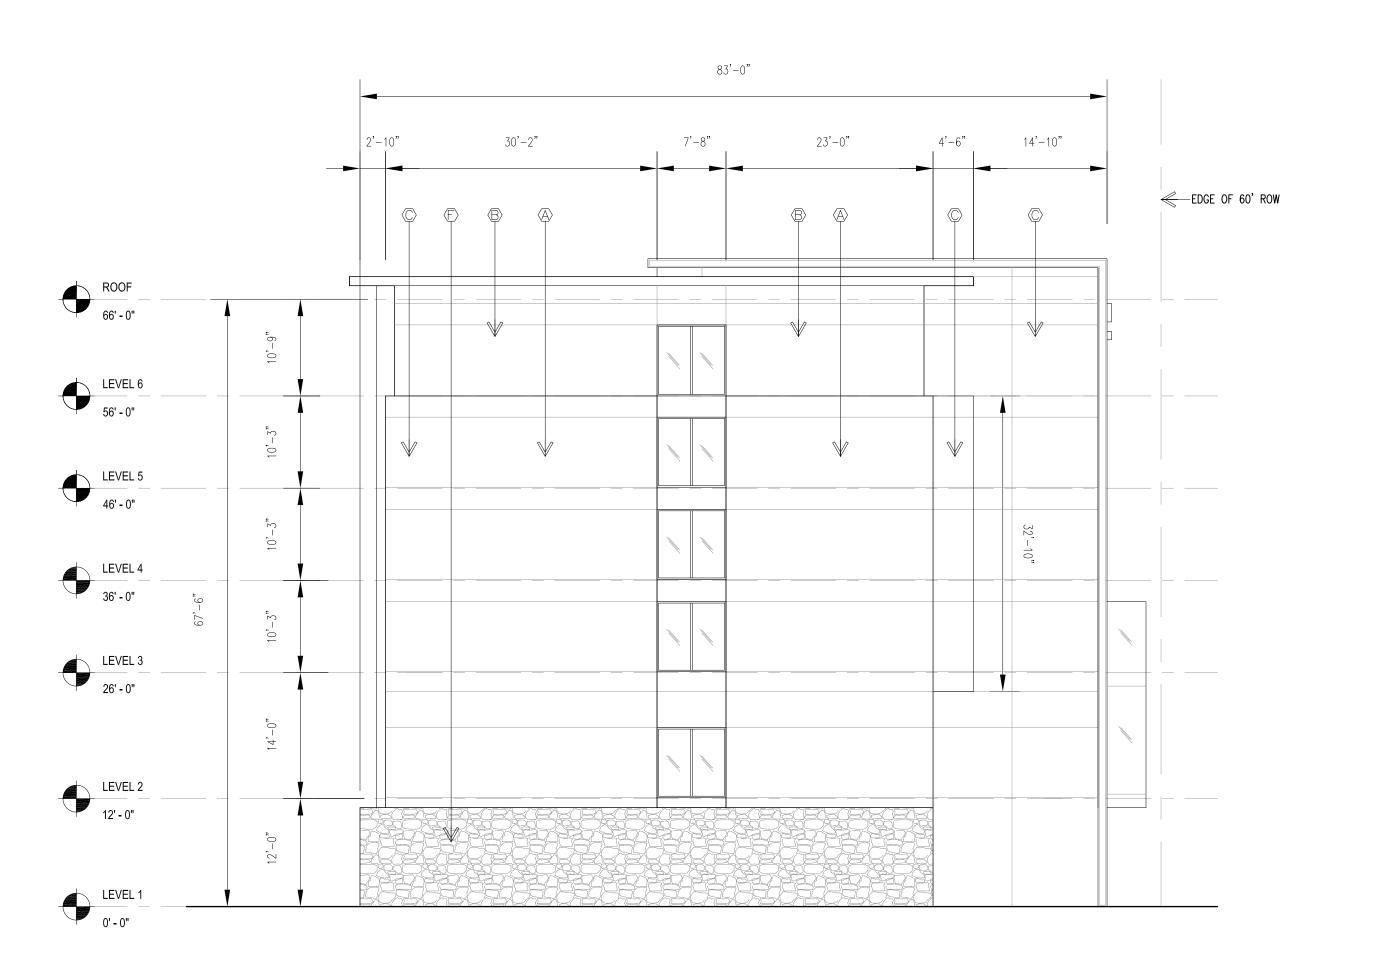
EXTERIOR ELEVATIONS

SHEET 5 OF 9

SCALE: 3/32" = 1'-0"


EI 5 OF 9

SHEET NUMBER



NORTH ELEVATION AT COPPER AVENUE

SCALE: 3/32" = 1'-0"

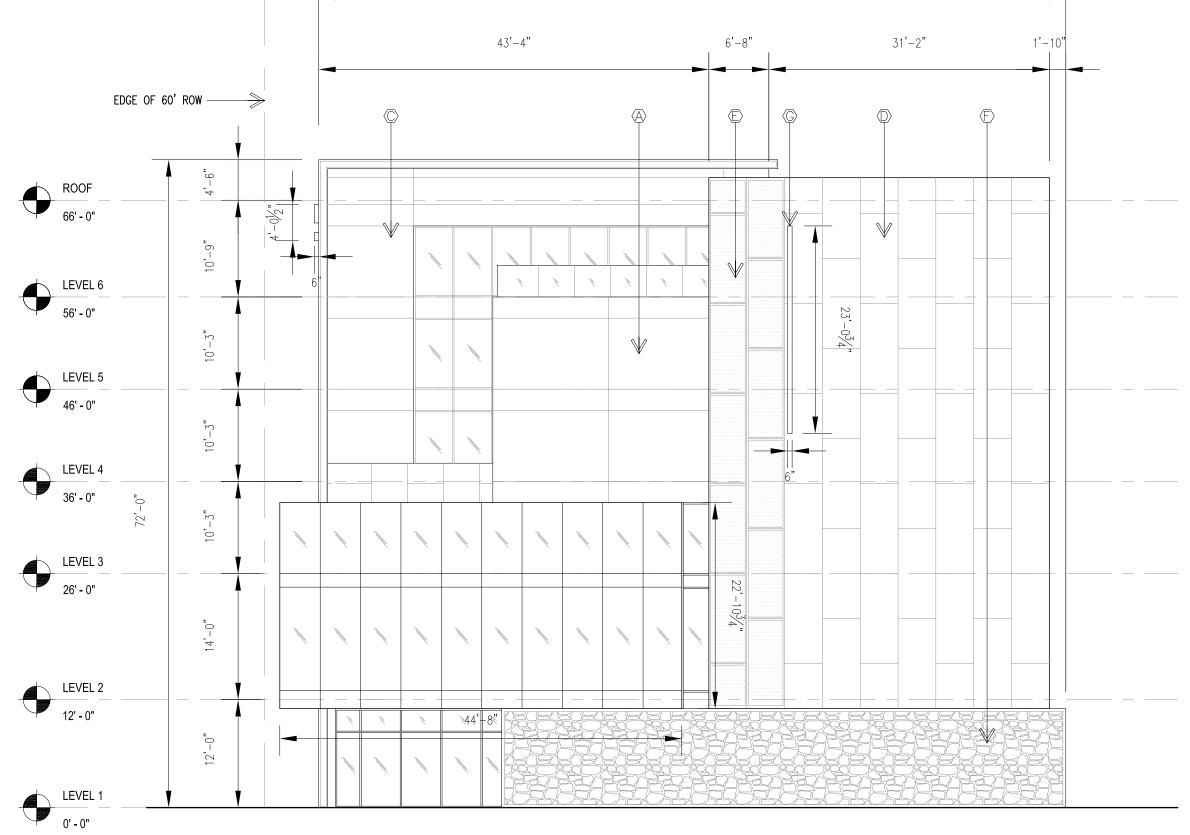

83'-0"

SOUTH ELEVATION AT CENTRAL AVENUE SCALE: 3/32" = 1'-0"

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CONSENSUS PLANNING, INC. 302 EIGHTH STREET NW ALBUQUERQUE, NEW MEXICO 87102 505.764.9801 CONTACT: MALIK HAKIM

MATERIAL LEGEND

$\langle \Delta \rangle$	EIFS	FINISH	WHITE	

B EIFS FINISH LIGHT GRAY EIFS FINISH MEDIUM GRAY

ACM PANEL

EXPANDED METAL MESH

F GABION WALL

NEON BLADE SIGN

PROJECT

SPRINGHILL SUITES® MARRIOTT

ALBUQUERQUE

PROJECT ADDRESS CENTRAL AVE. & MULBERRY ST. ALBUQUERQUE, NM 87106


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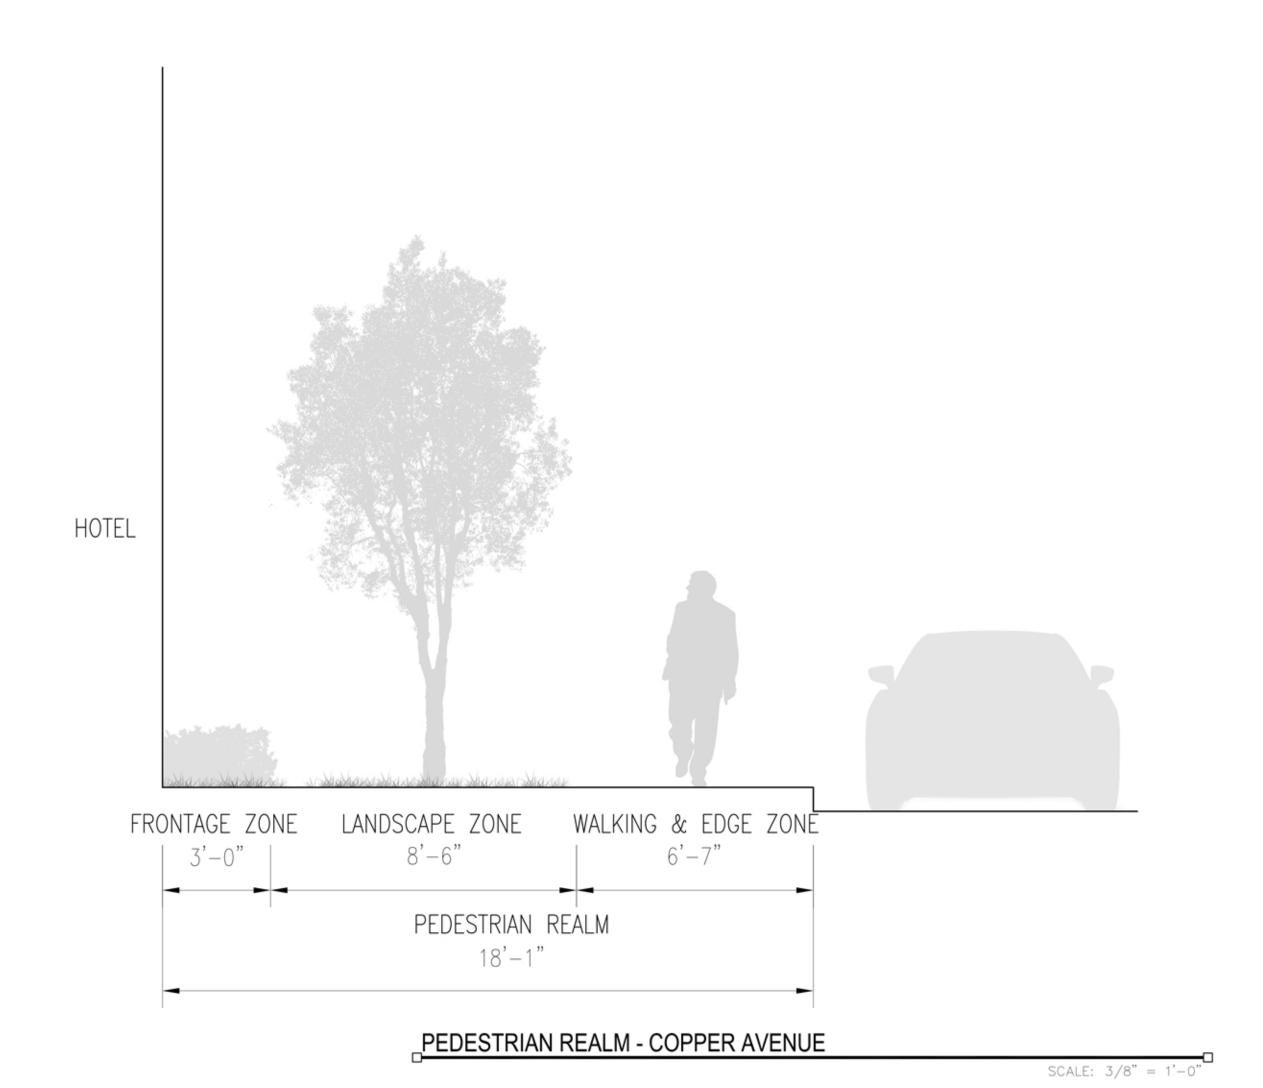
EXTERIOR ELEVATIONS


SHEET 6 OF 9

SHEET NUMBER



SCALE: 3/8" = 1'-0"

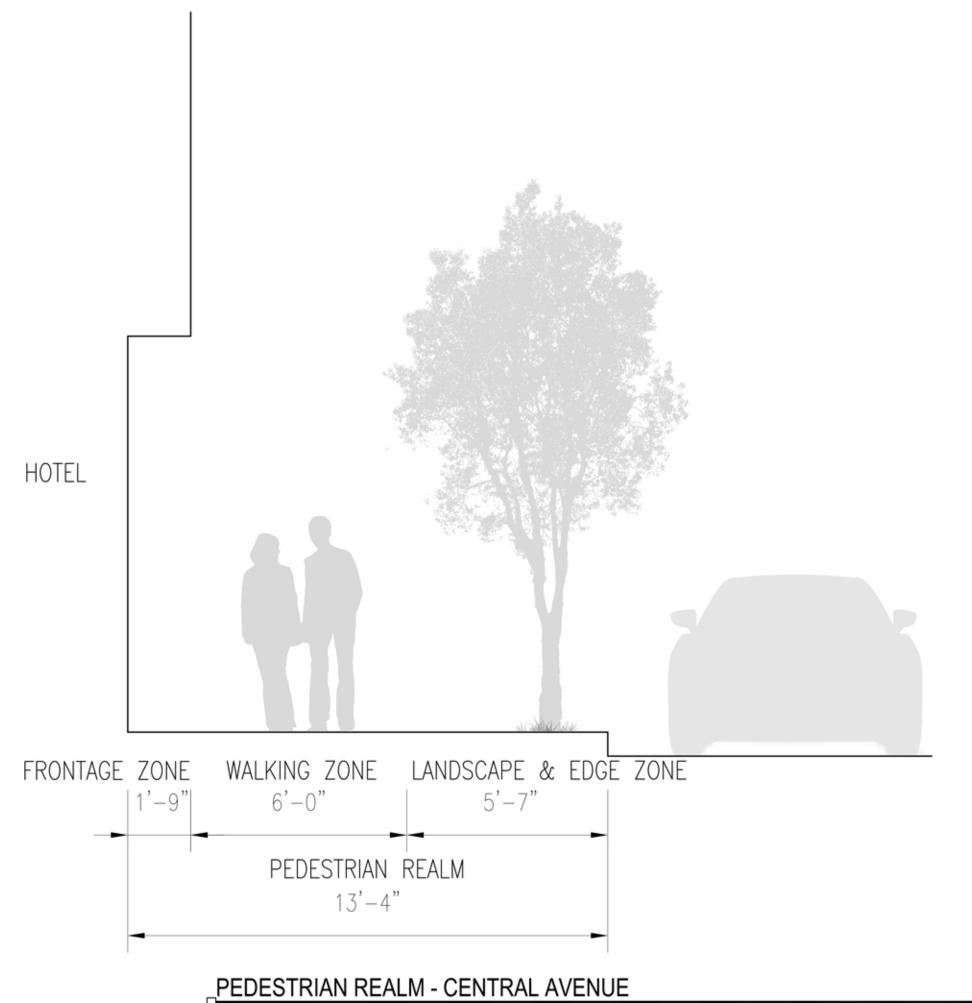

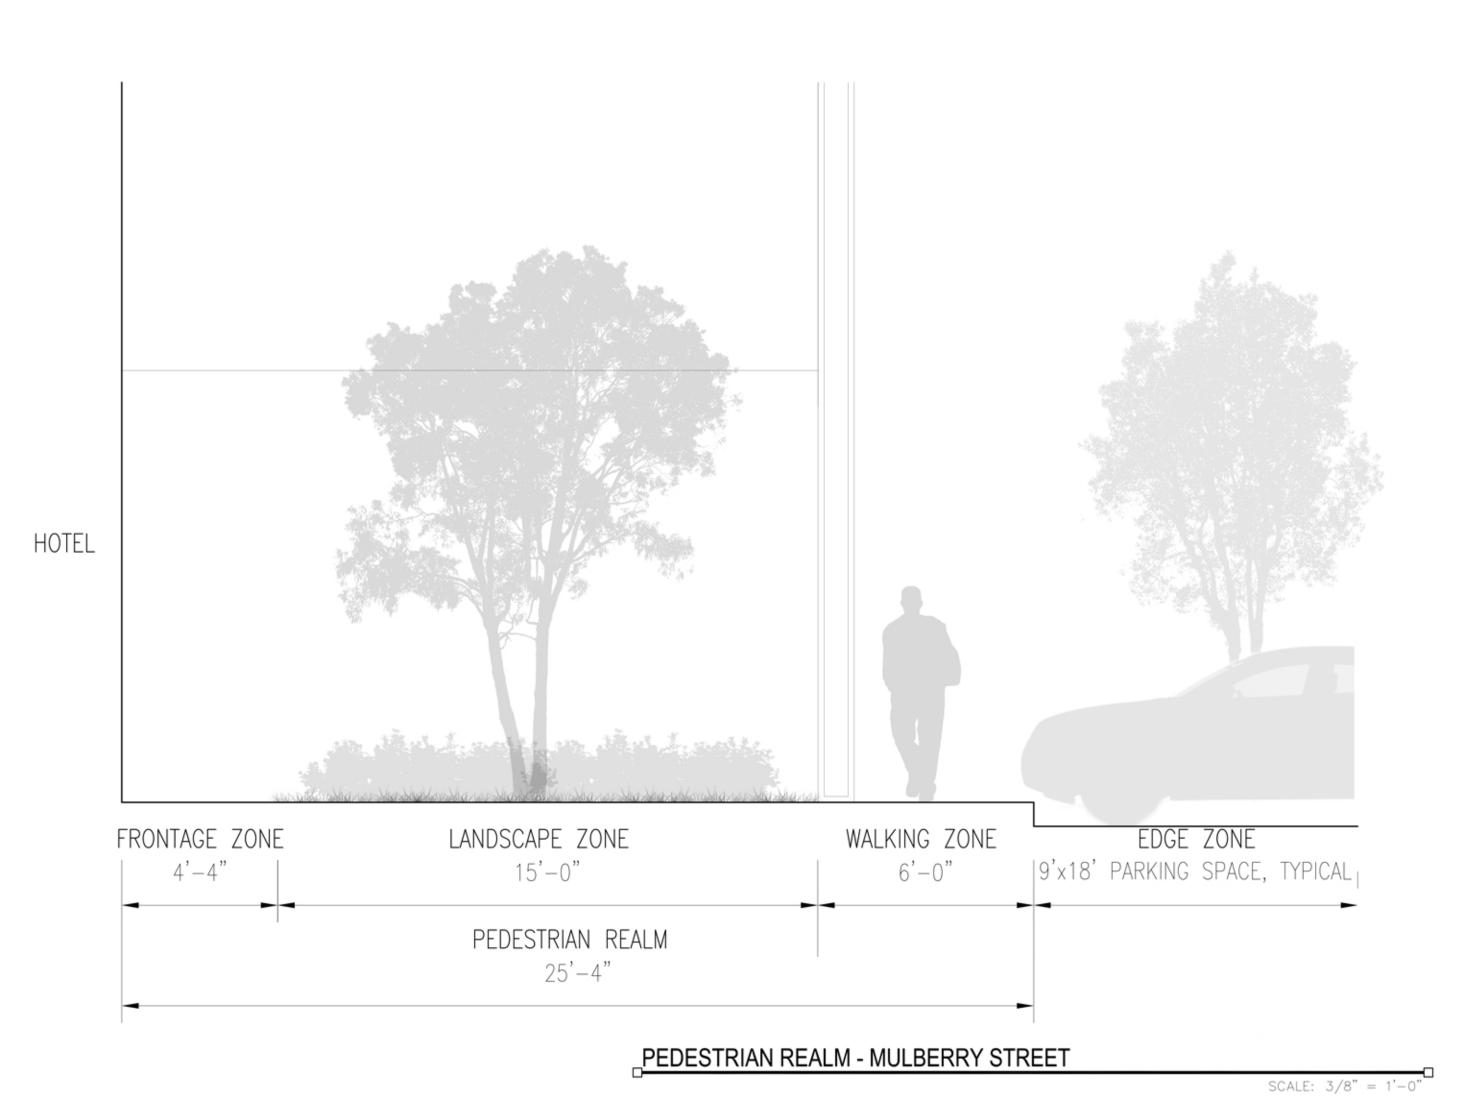

5G STUDIO COLLABORATIVE

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PEDESTRIAN REALM

SHEET 7 OF 9

7 OF 9

SHEET NUMBER