A City of Albuquerque



DEVELOPMENT/ PLAN REVIEW APPLICATION

Updated 1/12/18

	Supplemental F	form (SF)		
SUBDIVISION	S	Z ZONING	3 & PLANNING	
Major subdivision action Minor subdivision action			Annexation	
Vacation	٧		Zone Map Amendment (Establish	or Change
Variance (Non-Zoning)			Zoning, includes Zoning within Se Development Plans)	ctor
SITE DEVELOPMENT PLAN	P		Adoption of Rank 2 or 3 Plan or si	milar
for Subdivision	•		Text Amendment to Adopted Rank	k 1, 2 or 3
for Building Permit	/A A \		Plan(s), Zoning Code, or Subd. Re	agulations
Administrative Amendment Administrative Approval (D				
IP Master Development Pla	ın D		Street Name Change (Local & Co	llector)
Cert, of Appropriateness (L	ucc)	A APPEA	L / PROTEST of	
STORM DRAINAGE (Form D)	-Kara Man	**********	Decision by: DRB, EPC, LUCC, P Director, ZEO, ZHE, Board of App	lanning eals, other
Storm Drainage Cost Alloca				
PRINT OR TYPE IN BLACK INK ONLY Planning Department Development Serv	. The applicant or age ices Center, 600 2 nd St	ent must suon reet NW. Albi	nt the completed application in iduerque. NM 87102.	person to the
Fees must be paid at the time of applicat	ion. Refer to suppleme	ental forms fo	r submittal requirements.	
111				ailed to
PDF copy of the completed application a (PLNDRS@cabq.gov) prior to proces	ong with all the plans a	Zinned files	and files over 9 Megabytes Wi	ill not get
delivered via email, Therefore, PDF file	es must be provided	on a CD)	3770	,
4611-01-03-11-01-01-01-01-01-01-01-01-01-01-01-01-		······································		
APPLICATION INFORMATION:	/s	disclosion.	1-11	74 074
Professional/Agent (if any): DANIEL		ELCU/SA16A		ı
ADDRESS: 7601 XE FIFTSON A	te than		FAX: 505-	
CITY AL BUDIFLOWE	STATE NM	ZIP 87109	E-MAIL: DAWK-@ DOS!	X-9GN-OFG
APPLICANT: DURNAL CENTE	PRULLDION ASSOC	adits	PHONE: 403-773	
		,	FAX:	
ADDRESS: 1717 JEFFAISON <	27:10	Oratof		The Wall
CITY ALBUQUEOUS				
Proprietary interest in site:				
DESCRIPTION OF REQUEST: AMEND	SITE PLYN FOR &	GUILDING PO	PMT	······································
The second secon				
Is the applicant seeking incentives pursuant	to the Family Housing Deve	lopment Program	n? Yes. X No.	
SITE INFORMATION: ACCURACY OF THE EX				NECESSARY.
: / \$				
Lot or Tract No. 4AA-6A-1				
Subdiv/Addn/TBKA: <u>JOVO-NA-L</u> Cs				
Existing Zoning: 1 P	Proposed zonii	ng: <u>IP</u>	MRGCD Map N	10
Zone Atlas page(s): 0 -17	UPG Code:			
CASE HISTORY: List any current or prior case number that m	ay be relevant to your applic	cation (Proi., Apr	o., DRB-, AX_,Z_, V_, S_, etc.):	
List thing distributed in prior odds from the con-	m)			
	· · · · · · · · · · · · · · · · · · ·			,
CASE INFORMATION: Within city limits?	ithin 1000ET of a landfill?	٨١		
			e area (acres): 3.3	
LOCATION OF PROPERTY BY STREETS:	On or Near:	TUD NE	5	,,,,,,,,,,,,,,,,,,,,,,,,,,,,,,,,,,,,,
Between: JEFFGLSOU	and and	PAN AME	HCAN FWY	
Check if project was previously reviewed by	Sketch Plat/Plan ☐ or Pre-	-application Revi	ew Team(PRT) □. Review Date:	
SIGNATURE COROL			DATE 2/27	IB
(Print Name) MNIEL P. KEN	ME		Applicant: ☐ Age	nt; 🗆
ron.	OFFICIAL USE ON	II V		
			Action S.F. Fee	ae
☐ INTERNAL ROUTING ☐ All checklists are complete	Application case number 18088 700		* *** ********************************	00.60
All fees have been collected				20.00
☐ All case #s are assigned				
AGIS copy has been sent			71 W.	
☐ Case history #s are listed☐ Site is within 1000ft of a landfill	***************************************	·····		
☐ F.H.D.Ħ. density bonus		-	Tota	
☐ F.H.D.P. fee rebate	Hearing date Marc	h 7,201	8 19	00.00
√ \ \	00		" INITELLE	-
	27 - 1% ature & Date	Project	# 1011010	
Staff signa	ature & Date			

FO	RM P(3): SITE DEVELOPMENT PLAN REVIEW - D.R.B. MEETING (UNADVERTISED)
	SKETCH PLAT REVIEW AND COMMENT (DRB22) Scaled site sketch and related drawings showing proposed land use including structures, parking, Bldg. setbacks, adjacent rights-of-way and street improvements, etc. (folded to fit into an 8.5" by 14" pocket) 6 copies. Zone Atlas map with the entire property(les) clearly outlined Letter briefly describing, explaining, and justifying the request List any original and/or related file numbers on the cover application
	Meetings are approximately 8 DAYS after the Tuesday noon filing deadline. Your attendance is required. SITE DEVELOPMENT PLAN FOR SUBDIVISION (DRB18) 5 Acres or more & zoned SU-1, IP, SU-2, PC, or Shopping Center: Certificate of No Effect or Approval Scaled Site Plan and related drawings (folded to fit into an 8.5" by 14" pocket) 6 copies Zone Atlas map with the entire property(ies) clearly outlined Letter briefly describing, explaining, and justifying the request Letter of authorization from the property owner if application is submitted by an agent FORM DRWS Drainage Report, Water & Sewer availability statement filing information Copy of the document delegating approval authority to the DRB Completed Site Plan for Subdivision Checklist Infrastructure List, if relevant to the site plan Fee (see schedule) List any original and/or related file numbers on the cover application Grading and Drainage Plan/Drainage Report Submittal to Hydrology* Meetings are approximately 8 DAYS after the Tuesday noon filing deadline. Bring the original to the meeting. Your attendance is required.
	SITE DEVELOPMENT PLAN FOR BUILDING PERMIT (DRB17) Maximum Size: 24" x 36" 5 Acres or more & zoned SU-1, IP, SU-2, PC, or Shopping Center (SC): Certificate of No Effect or Approval Site Plan and related drawings (folded to fit into an 8.5" by 14" pocket) 6 copies Site Plan for Subdivision, if applicable, previously approved or simultaneously submitted. 6 copies Solid Waste Management Department signature on Site Plan Zone Atlas map with the entire property(ies) clearly outlined Letter briefly describing, explaining, and justifying the request Letter of authorization from the property owner if application is submitted by an agent FORM DRWS Drainage Report, Water & Sewer availability statement filling information Copy of the document delegating approval authority to the DRB Infrastructure List, if relevant to the site plan Completed Site Plan for Building Permit Checklist Copy of Site Plan with Fire Marshal's stamp Fee (see schedule) List any original and/or related file numbers on the cover application Grading and Drainage Plan/Drainage Report Submittal to Hydrology* Meetings are approximately 8 DAYS after the Tuesday noon filing deadline. Bring the original to the meeting.
	Your attendance is required. AMEND SITE DEVELOPMENT PLAN FOR BUILDING PERMIT (DRB01) Maximum Size: 24" x 36" AMEND SITE DEVELOPMENT PLAN FOR SUBDIVISION (DRB02) Maximum Size: 24" x 36" Proposed amended Site Plan (folded to fit into an 8.5" by 14" pocket) 6 copies DRB signed Site Plan being amended (folded to fit into an 8.5" by 14" pocket) 6 copies Zone Atlas map with the entire property(ies) clearly outlined Letter briefly describing, explaining, and justifying the request Letter of authorization from the property owner if application is submitted by an agent Infrastructure List, if relevant to the site plan Completed Site Plan for Building Permit Checklist (not required for amendment of SDP for Subdivision) Fee (see schedule) List any original and/or related file numbers on the cover application Meetings are approximately 8 DAYS after the Tuesday noon filing deadline. Bring the original to the meeting. Your attendance is required.
	FINAL SIGN-OFF, EPC-APPROVED SDP FOR BUILDING PERMIT (DRB05) Maximum Size: 24" x 36" FINAL SIGN-OFF, EPC-APPROVED SDP FOR SUBDIVISION (DRB06) Maximum Size: 24" x 36" Site Plan and related drawings (folded to fit into an 8.5" by 14" pocket) 6 copies Approved Grading and Drainage Plan (folded to fit into an 8.5" by 14" pocket) 6 copies Solid Waste Management Department signature on Site Plan for Building Permit Zone Atlas map with the entire property(ies) clearly outlined Letter carefully explaining how each EPC condition has been met and a copy of the EPC Notification of Decision FORM DRWS Drainage Report, Water & Sewer availability statement filing information Infrastructure List, if relevant to the site plan Copy of Site Plan with Fire Marshal's stamp (not required for SDP for Subdivision) List any original and/or related file numbers on the cover application Grading and Drainage Plan/Drainage Report Submitted to Hydrology *(Grading and Drainage Plan/Drainage Report must be submitted be to Hydrology prior to DRB application submittal. Grading and Drainage plans may have to be approved prior to DRB approval.) Meetings are approximately 8 DAYS after the Tuesday noon filing deadline. Bring the original to the meeting. Your attendance is required. I, the applicant, acknowledge that any
	information required but not submitted with this application will likely result in deferral of actions. Applicant signature / date Form revised January 2018
	☐ Checklists complete ☐ Fees collected ☐ Case #s assigned ☐ Related #s listed Application case numbers ☐ 15PRB - 70079 ☐ Planner signature / date ☐ Project # 10 / 154/5



February 15, 2018

To whom it may concern City of Albuquerque

RE:

Owner's Agent 5100 Masthead NE Albuquerque, NM 87109

To whom it may concern:

This letter is to confirm that Dekker/Perich/Sabatini, Ltd. is the authorized agent for the owner of 5100 Masthead NE, Albuquerque, NM 87109 as per the attached Exhibit A with regards to proposed renovations and additions to the existing structure.

Sincerely

Saniel P. Kemme, AIA, LEED AP

Principal

Acknowledged and Agreed

Owner: Journal Center Building Associates

a New Mexico general partnership

By.

Lowell Hare, Managing Partner


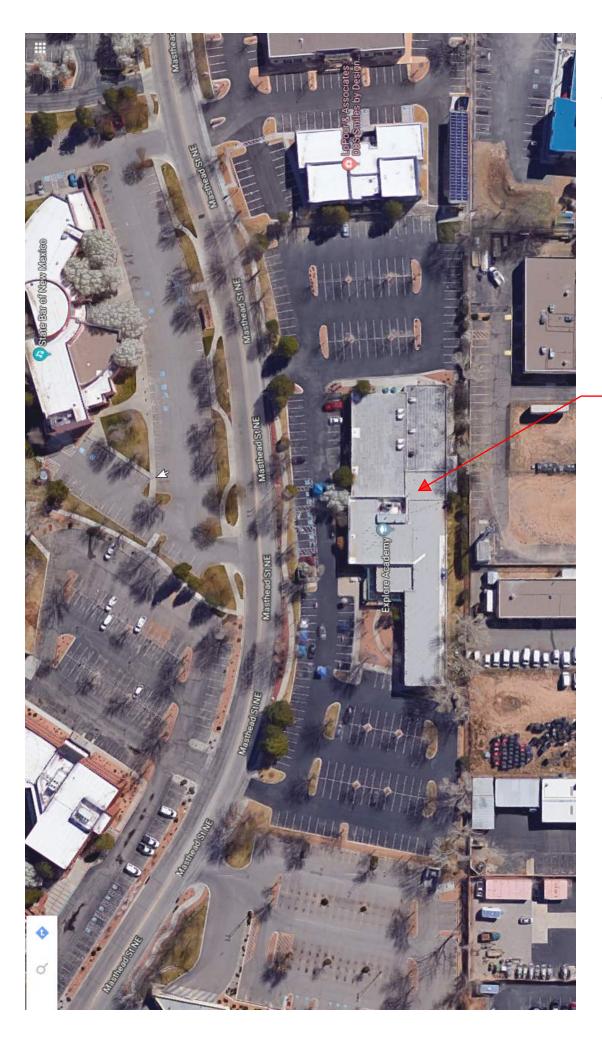


Exhibit A5100 Masthead NE
Albuquerque, NM 87109



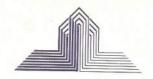

February 22, 2018

Mr. Justin Baiardo Explore Academy Board 5100 Masthead NE Albuquerque, NM 87109

RE: Journal Center - Explore Academy Renovations and Additions

Dear Justin:

The Journal Center Architectural Review Committee has reviewed and approved the draft Site Plan for DRB01 Amend Site Development Plan for Building Permit drawings submitted for the referenced project, which includes the proposed additions and site modifications to the Explore Academy Building on TR 4AA5A1 (REPL OF TR 4AA5A) Journal Center.

We understand this approval letter will be included in the DRB submittal for the site plan amendment for the property in preparation for building permit review.

Please do not hesitate to call our office if you have any questions as you move forward with the project.

Sincerely,

Lowell A. Hare
President and CEO



Explore Academy Renovations and Additions
Design Review Board Submittal
AMEND SITE DEVELOPMENT PLAN FOR BUILDING PERMIT (DRB01)

Project Summary

This project includes two additions to the existing Explore Academy charter school located at 5100 Masthead NE, in the Journal Center. In addition, the project includes renovations to existing classrooms and offices.

The school currently has capacity for 300 students, and serves high school grades. In the fall of 2018, however, they will be enrolling middle school students as well and require additional capacity for eventually as many as 580 students.

This project will add new classrooms, two new commons areas, a music classroom, science labs, and teacher's workroom. The new classrooms will be both within the additions as well as reconfiguration within the existing classroom spaces. In addition, the existing administrative office area will be renovated to accommodate more staff. Support spaces, particularly restrooms, are also being added for the additional student population.

The site layout is remaining as-is with the exception of the new additions. The addition to the east will occupy area that is currently parking, but even with the modest loss of parking stalls the site has more than are required for the occupancy. The west addition is located in a current landscaped area. The existing building area is 25,520 square feet, with the new additions totaling 9,948 square feet.

The exterior of the building is Exterior Insulation and Finish System (EIFS) with hollow metal windows and doors. The EIFS finish color will be to match the existing concrete shell system with a V-groove pattern similar to the original. An existing metal accent band will be matched in color with the EIFS system. A new guardrail/handrail at the west addition will be detailed and painted to match the existing rail system of the west steps. In coordination with the Journal Center Architectural Review Committee, the new rooftop mechanical units have been located as far to the south as possible to minimize visibility from the street.

SITE DEVELOPMENT PLAN FOR BUILDING PERMIT CHECKLIST

This checklist will be used to verify the completeness of site plans submitted for review by the Environmental Planning Commission and Development Review Board. Because development proposals vary in type and scale, there may be submittal requirements that are not specified here. Nonetheless, applicants are responsible for providing a complete submittal. Certification as specified below is required.

I CERTIFY THAT THE SUBMITTED SITE DEVELOPMENT PLAN IS COMPLETE AND ACCURATE, AND THAT ALL APPLICABLE
INFORMATION AS SPECIFIED IN THIS CHECKLIST IS PROVIDED. FURTHER, I UNDERSTAND THAT THIS APPLICATION IS
BEING ACCEPTED PROVISIONALLY AND THAT INACCURATE AND/OR INCOMPLETE INFORMATION MAY RESULT IN THE
SUBSEQUENT REJECTION OF THE APPLICATION OR IN
A DELAY OF ONE MONTH OR MORE IN THE DATE THE
APPLICATION IS SCHEDULED FOR PUBLIC HEARING.
Applicant or Agent Signature / Date

NOTE: MAXIMUM SIZE FOR SUBMITTAL IS 24" X 36".

Site development plan packets shall be composed of the following plan sheets (unless otherwise approved in writing prior to submittal by the Planning Department):

- 1. Site Plan (including utilities and easements)
- 2. Landscaping Plan
- **3. Preliminary Grading Plan** (A separate Grading Plan sheet is required for a sites 1 acre or more.)
- 4. Building and Structure Elevations
- 5. Conceptual Utility Plan
- 6. Previously approved Development Plan (if applicable)

Submitted plan packets must be organized in the above manner. The following checklist describes the minimum information necessary for each plan element. The Applicant must include all checklist items on their site plan drawings and confirm inclusion by checking off the items below. Non-applicable items must be labeled "N/A." Each non-applicable designation must be explained by notation on the Checklist.

Accompanying Material

- X A. 8-1/2" x 11" reduction for each plan sheet.
- X B. **Written project summary**. Each application must include a brief narrative description of the proposed project, its primary features and how compatibility with the surrounding context has been achieved.

SHEET #1 - SITE PLAN

A. General Information

<u> </u>	Date of drawing and/or last revision		
	Scale: 1.0 acre or less	1" = 10'	
	1.0 - 5.0 acres	1" = 20'	
	Over 5 acres	1" = 50'	
	Over 20 acres	1" = 100'	ſ

[Other scales as approved by staff]

- X 3. Bar scale
- X 4. North arrow
- X 5. Scaled vicinity map
- X 6. Property lines (clearly identify)
- X 7. Existing and proposed easements (identify each)
- NA 8. Phases of development including location and square footages of structures, circulation, parking and landscaping

	3	THE DEVELOPMENT PLAN FOR BUILDING PERMIT CHECKLIST
	Proposed Structura	Development (If supplemental Sheets are used please indicate sheet #)
	X B. X C. X D. NA E. NA F. NA G.	Location of existing & proposed structures (distinguish between existing & proposed, include phasing) Square footage of each structure Proposed use of each structure Temporary structures, signs and other improvements Walls, fences, and screening: indicate height, length, color and materials Dimensions of all principal site elements or typical dimensions thereof Loading facilities Site lighting (indicate height & fixture type) Indicate structures within 20 feet of site Elevation drawing of refuse container and enclosure, if applicable. Site amenities including patios, benches, tables, (indicating square footage of patios/ plazas).
2.	Parking a	nd Circulation
	<u>X</u> A.	Parking layout with spaces numbered per aisle and totaled.
		$\underline{\chi}$ 1. Location and typical dimensions , including handicapped spaces EXISTING
		X 2. Calculations: spaces required: 84 provided: 111
		Handicapped spaces (included in required total) required: 4 provided: 8 Motorcycle spaces (in addition to required total) required: 3 provided: 3
	<u>X</u> B.	Bicycle parking & facilities
		X 1. Bicycle racks, spaces required: 6 provided: 7
		NA 2. Bikeways and other bicycle facilities, if applicable
	NAC.	Public Transit

1. Bus facilities, including routes, bays and shelters existing or required X D. Pedestrian Circulation EXISTING TO REMAIN

X 1. Location and dimensions of all sidewalks and pedestrian paths

X 2. Location and dimension of drive aisle crossings, including paving treatment

X E. Vehicular Circulation (Refer to Chapter 23 of DPM)

NA 1. Ingress and egress locations, including width and curve radii dimensions NO NEW

X 2. Drive aisle locations, including width and curve radii dimensions

NA 3. End aisle locations, including width and curve radii dimensions NONE

NA 4. Location & orientation of refuse enclosure, with dimensions EXISTING, NO N EW

NA 5. Curb cut locations and dimensions EXISTING, NO NEW

NA 6. Existing and proposed street widths, right-of-way widths and curve radii NONE

Identify existing and proposed turn lanes, deceleration lanes and similar features <u>NA</u> 7. related to the functioning of the proposal, with dimensions NONE

Location of traffic signs and signals related to the functioning of the proposal NONE

Identify existing and proposed medians and median cuts EXISTING ONLY

SITE DEVELOPMENT PLAN FOR BUILDING PERMIT CHECKLIST

3. Phasing

NA A. Proposed phasing of improvements and provision for interim facilities. Indicate phasing plan, including location and square footage of structures and associated improvements including circulation, parking and landscaping. NO PHASING

SHEET #2 LANDSCAPING PLAN

Landscaping may be shown on sheet #1 with written approval from Planning Department staff.

X X X	1. 2. 3.	Scale - must be same as scale on sheet #1 - Site plan Bar Scale North Arrow Property Lines Existing and proposed easements
<u>X</u>	4. 5.	Property Lines Existing and proposed easements
		Identify nature of ground cover materials NEW SHOWN, MOSTLY EXISTING X A. Impervious areas (pavement, sidewalks, slope pavings, curb and gutters, etc.) X B. Pervious areas (planting beds, grass, ground cover vegetation, etc.) Y C. Ponding areas either for drainage or landscaping/recreational use
NA	7.	Identify type, location and size of plantings (common and/or botanical names).
NO NEV	V	 A. Existing, indicating whether it is to preserved or removed. B. Proposed, to be established for general landscaping. C. Proposed, to be established for screening/buffering.
NA NA	9. 10.	Describe irrigation system – Phase I & II EXISTING Backflow prevention detail EXISTING Planting Beds, indicating square footage of each bed EXISTING Turf Area - only 20% of landscaped area can be high water turf; provide square footage and percentage. EXISTING TO REMAIN, NO NEW
X 1 X 1 X 1 NA 1	3. 4. 5. 6.	Responsibility for Maintenance (statement) JOURNAL CENTER Statement of compliance with Water ConservationOrdinance, see article 6-1-1-1. Landscaped area requirement; square footage and percent (specify clearly on plan) Landscaped area provided; square footage and percent (specify clearly on plan) Planting or tree well detail Street Tree Plan as defined in the Street Tree Ord.

SHEET # 3 PRELIMINARY GRADING PLAN

The Preliminary Grading Plan provides the Planning Commission and staff with an understanding of site topography and how it relates to adjacent property. Planning staff may waive or allow adjustments to the Preliminary Grading Plan requirements for sites that are small, relatively flat and have no existing or proposed extraordinary drainage facilities. Waivers must be obtained in writing from the City Engineer prior to application submittal.

Grading information for sites that are under 1 acre can be included on Sheet #1 with written approval from the Planning Department Staff.

A. General Information

- X 1. Scale must be same as Sheet #1 Site Plan
 X 2. Bar Scale
 X 3. North Arrow
- X 4. Property Lines
- X 5. Existing and proposed easements

SITE DEVELOPMENT PLAN FOR BUILDING PERMIT CHECKLIST

- χ 6. Building footprints
- X 7. Location of Retaining walls

B. Grading Information

- _<u>χ</u> 1. On the plan sheet, provide a narrative description of existing site topography, proposed grading improvements and topography within 100 feet of the site.
- X 2. Indicate finished floor elevation and provide spot elevations for all corners of the site (existing and proposed) and points of maximum cut or fill exceeding 1 foot.
- X 3. Identify ponding areas
- NA 4. Cross Sections

Provide cross section for all perimeter property lines where the grade change is greater than 4 feet at the point of the greatest grade change. Provide one additional cross section in each direction within no more than 100 feet of the reference point.

SHEET #4 UTILITY PLAN

- X 1. Fire hydrant locations, existing and proposed.
- X 2. Distribution lines
- χ 3. Right-of-Way and easements, existing and proposed, on the property and adjacent to the boundaries, with identification of types and dimensions.
- χ 4. Existing water, sewer, storm drainage facilities (public and/or private).
- χ 5. Proposed water, sewer, storm drainage facilities (public and/or private)


SHEET #5 BUILDING AND STRUCTURE ELEVATIONS

A. General Information

- χ A. Scale (minimum of 1/8" or as approved by Planning Staff).
- χ B. Bar Scale
- X C. Detailed Building Elevations for each facade
 - X 1. Identify facade orientation (north, south, east, & west).
 - X 2. Facade dimensions including overall height and width
 - χ 3. Location, dimensions, materials, and colors of principle façade elements- windows, doors, etc.
 - X 4. For EPC and DRB submittals only Color renderings or similar (12 copies) illustrations
- NA E. Site Development Plans for single family residential projects with multiple units may require submittal of specific information on building features in lieu of elevation drawings for each building. Applicants are advised to discussed submittal requirements with Planning Department staff.

B. Signage

- NA 1. Site location(s) EXISTING TO REMAIN, NO NEW
- NA 2. Sign elevations to scale
- NA 3. Dimensions, including height and width
- _NA 4. Sign face area dimensions and square footage clearly indicated
- NA 5. Lighting
- NA 6. Materials and colors for sign face and structural elements.

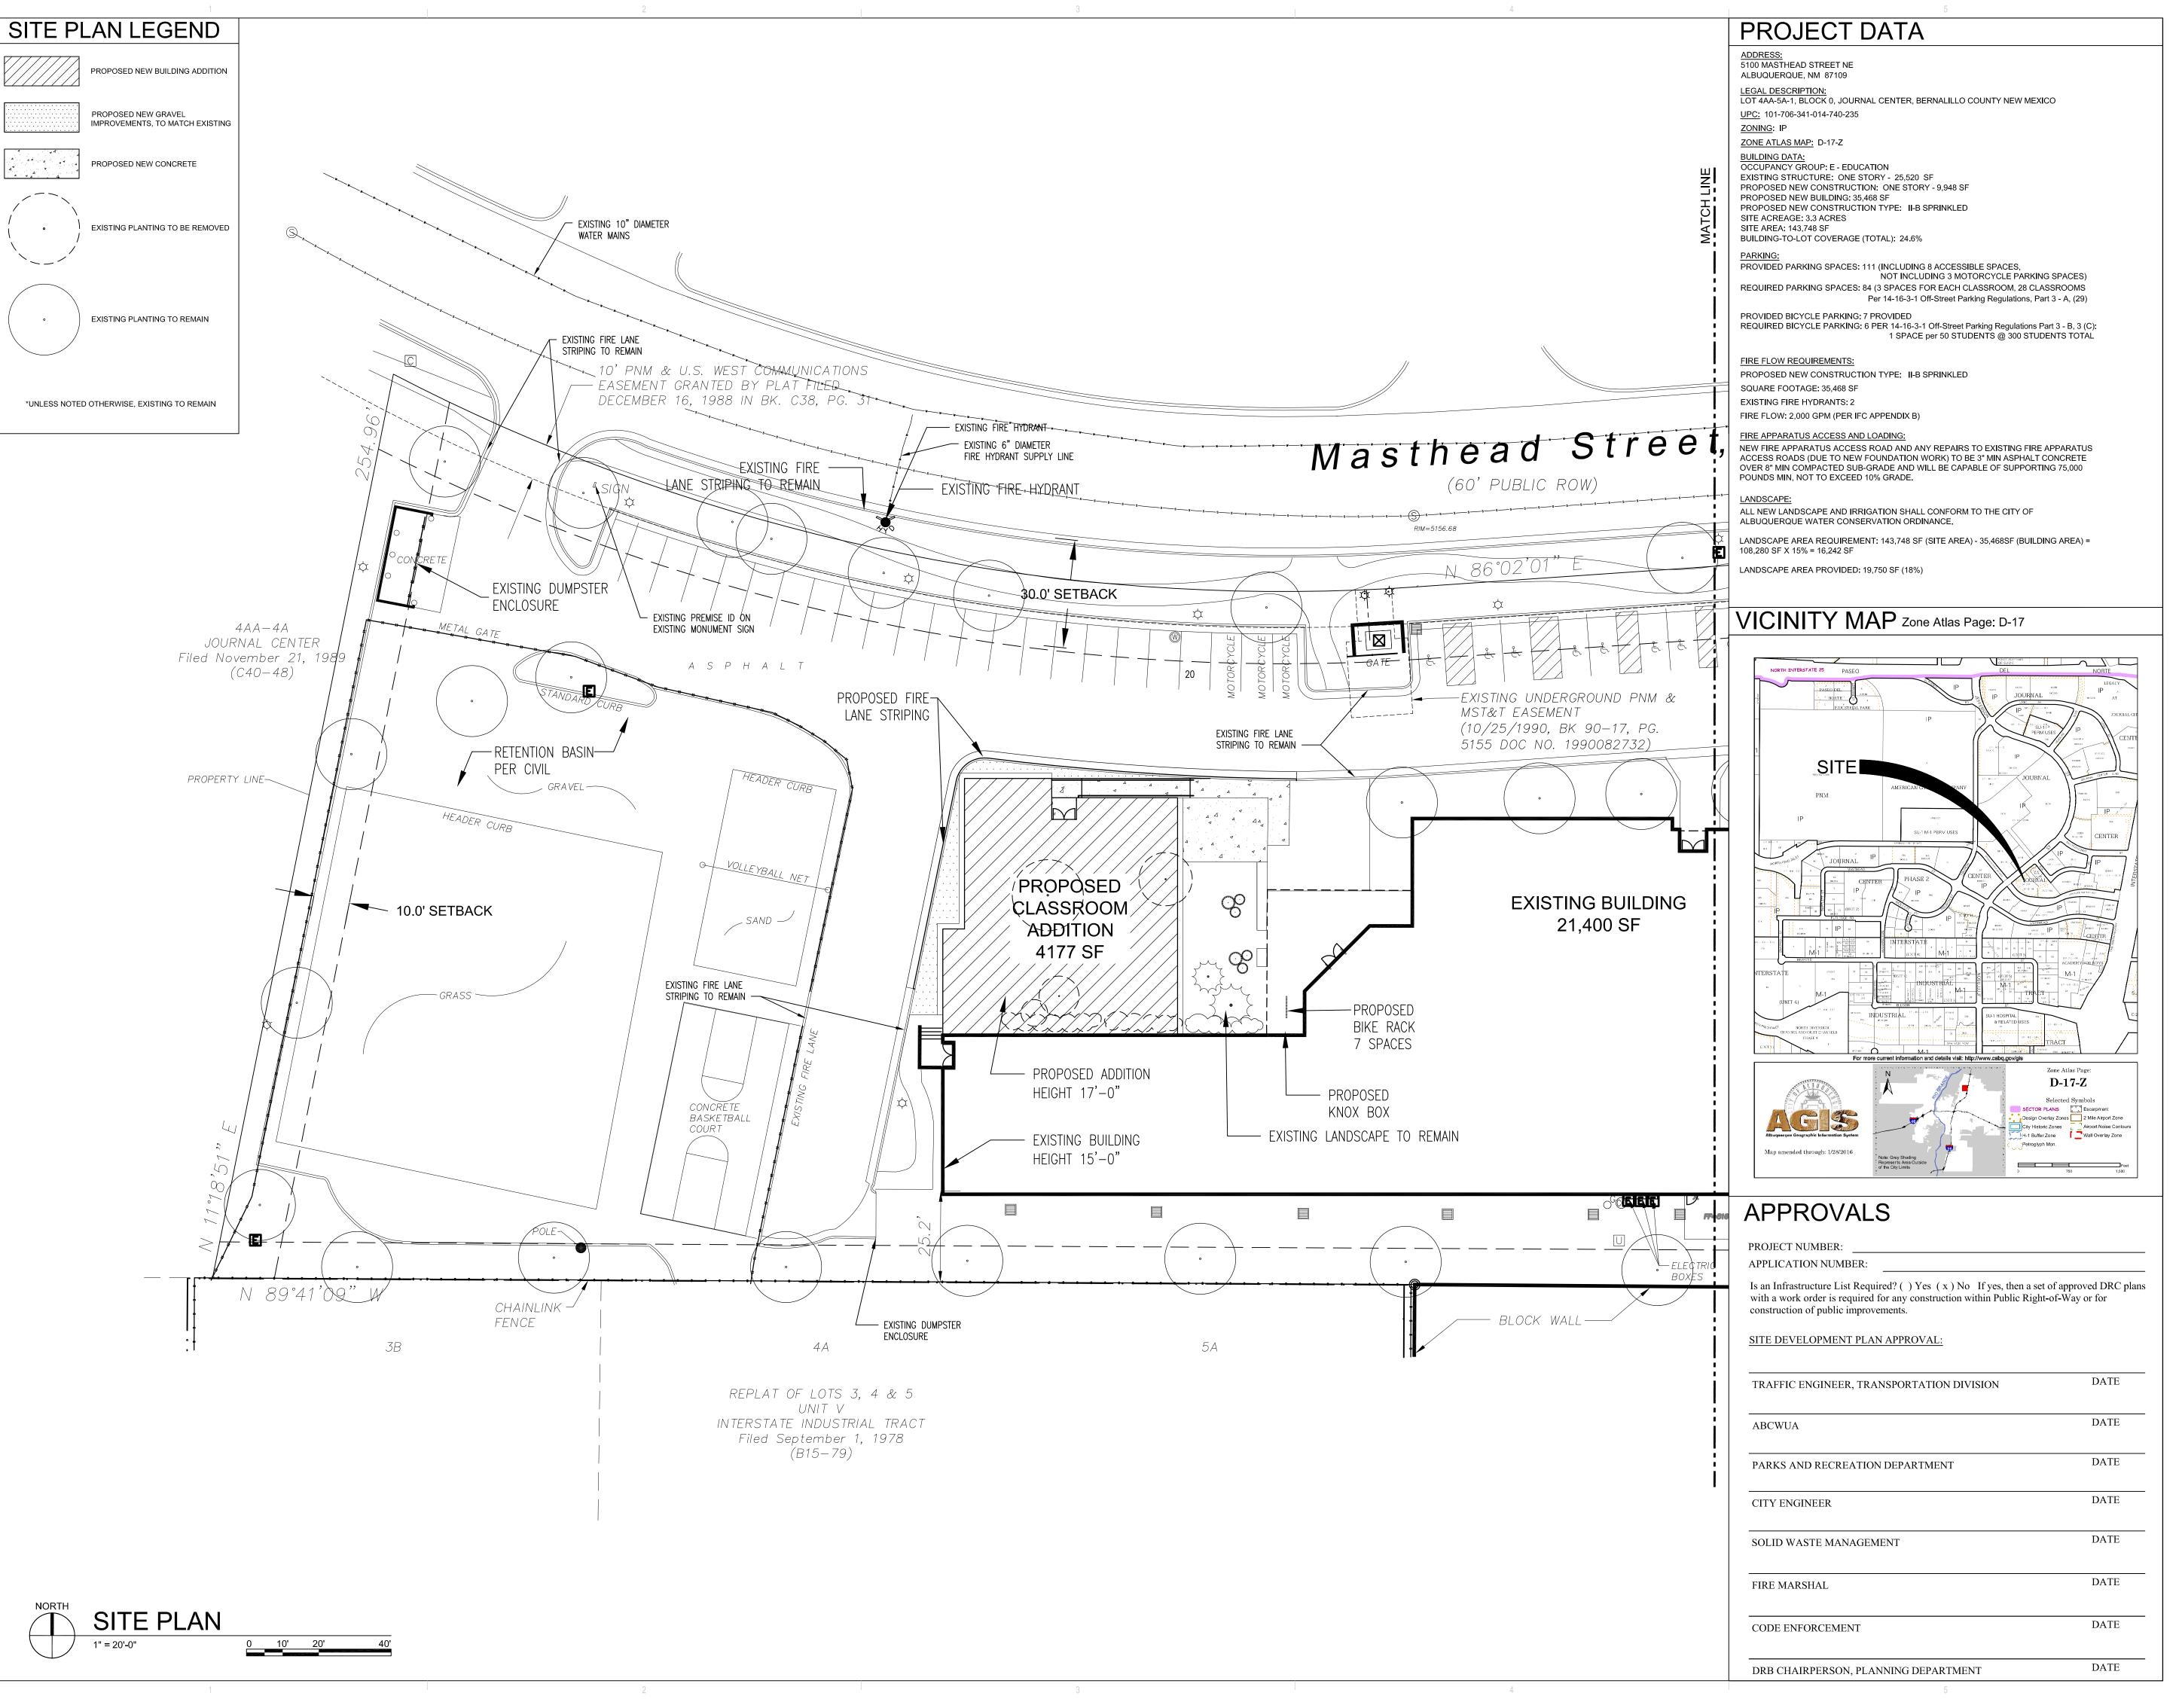

DEKKER PERICH SABATINI

7601 JEFFERSON NE, SUITE 100 ALBUQUERQUE, NM 87109

505.761.9700 / DPSDESIGN.ORG

ARCHITECT

-

ENGINEER

PROJECT

EXPLORE ACADEMY
RENOVATION/ADDITION
5100 MASTHEAD ST. NE
ALBUQUERQUE, NM 87109

REVISIONS

DRAWN BY

REVIEWED BY


DATE 02/26/2018

PROJECT NO. 16-0150.006

SITE

PLAN

DRB01A

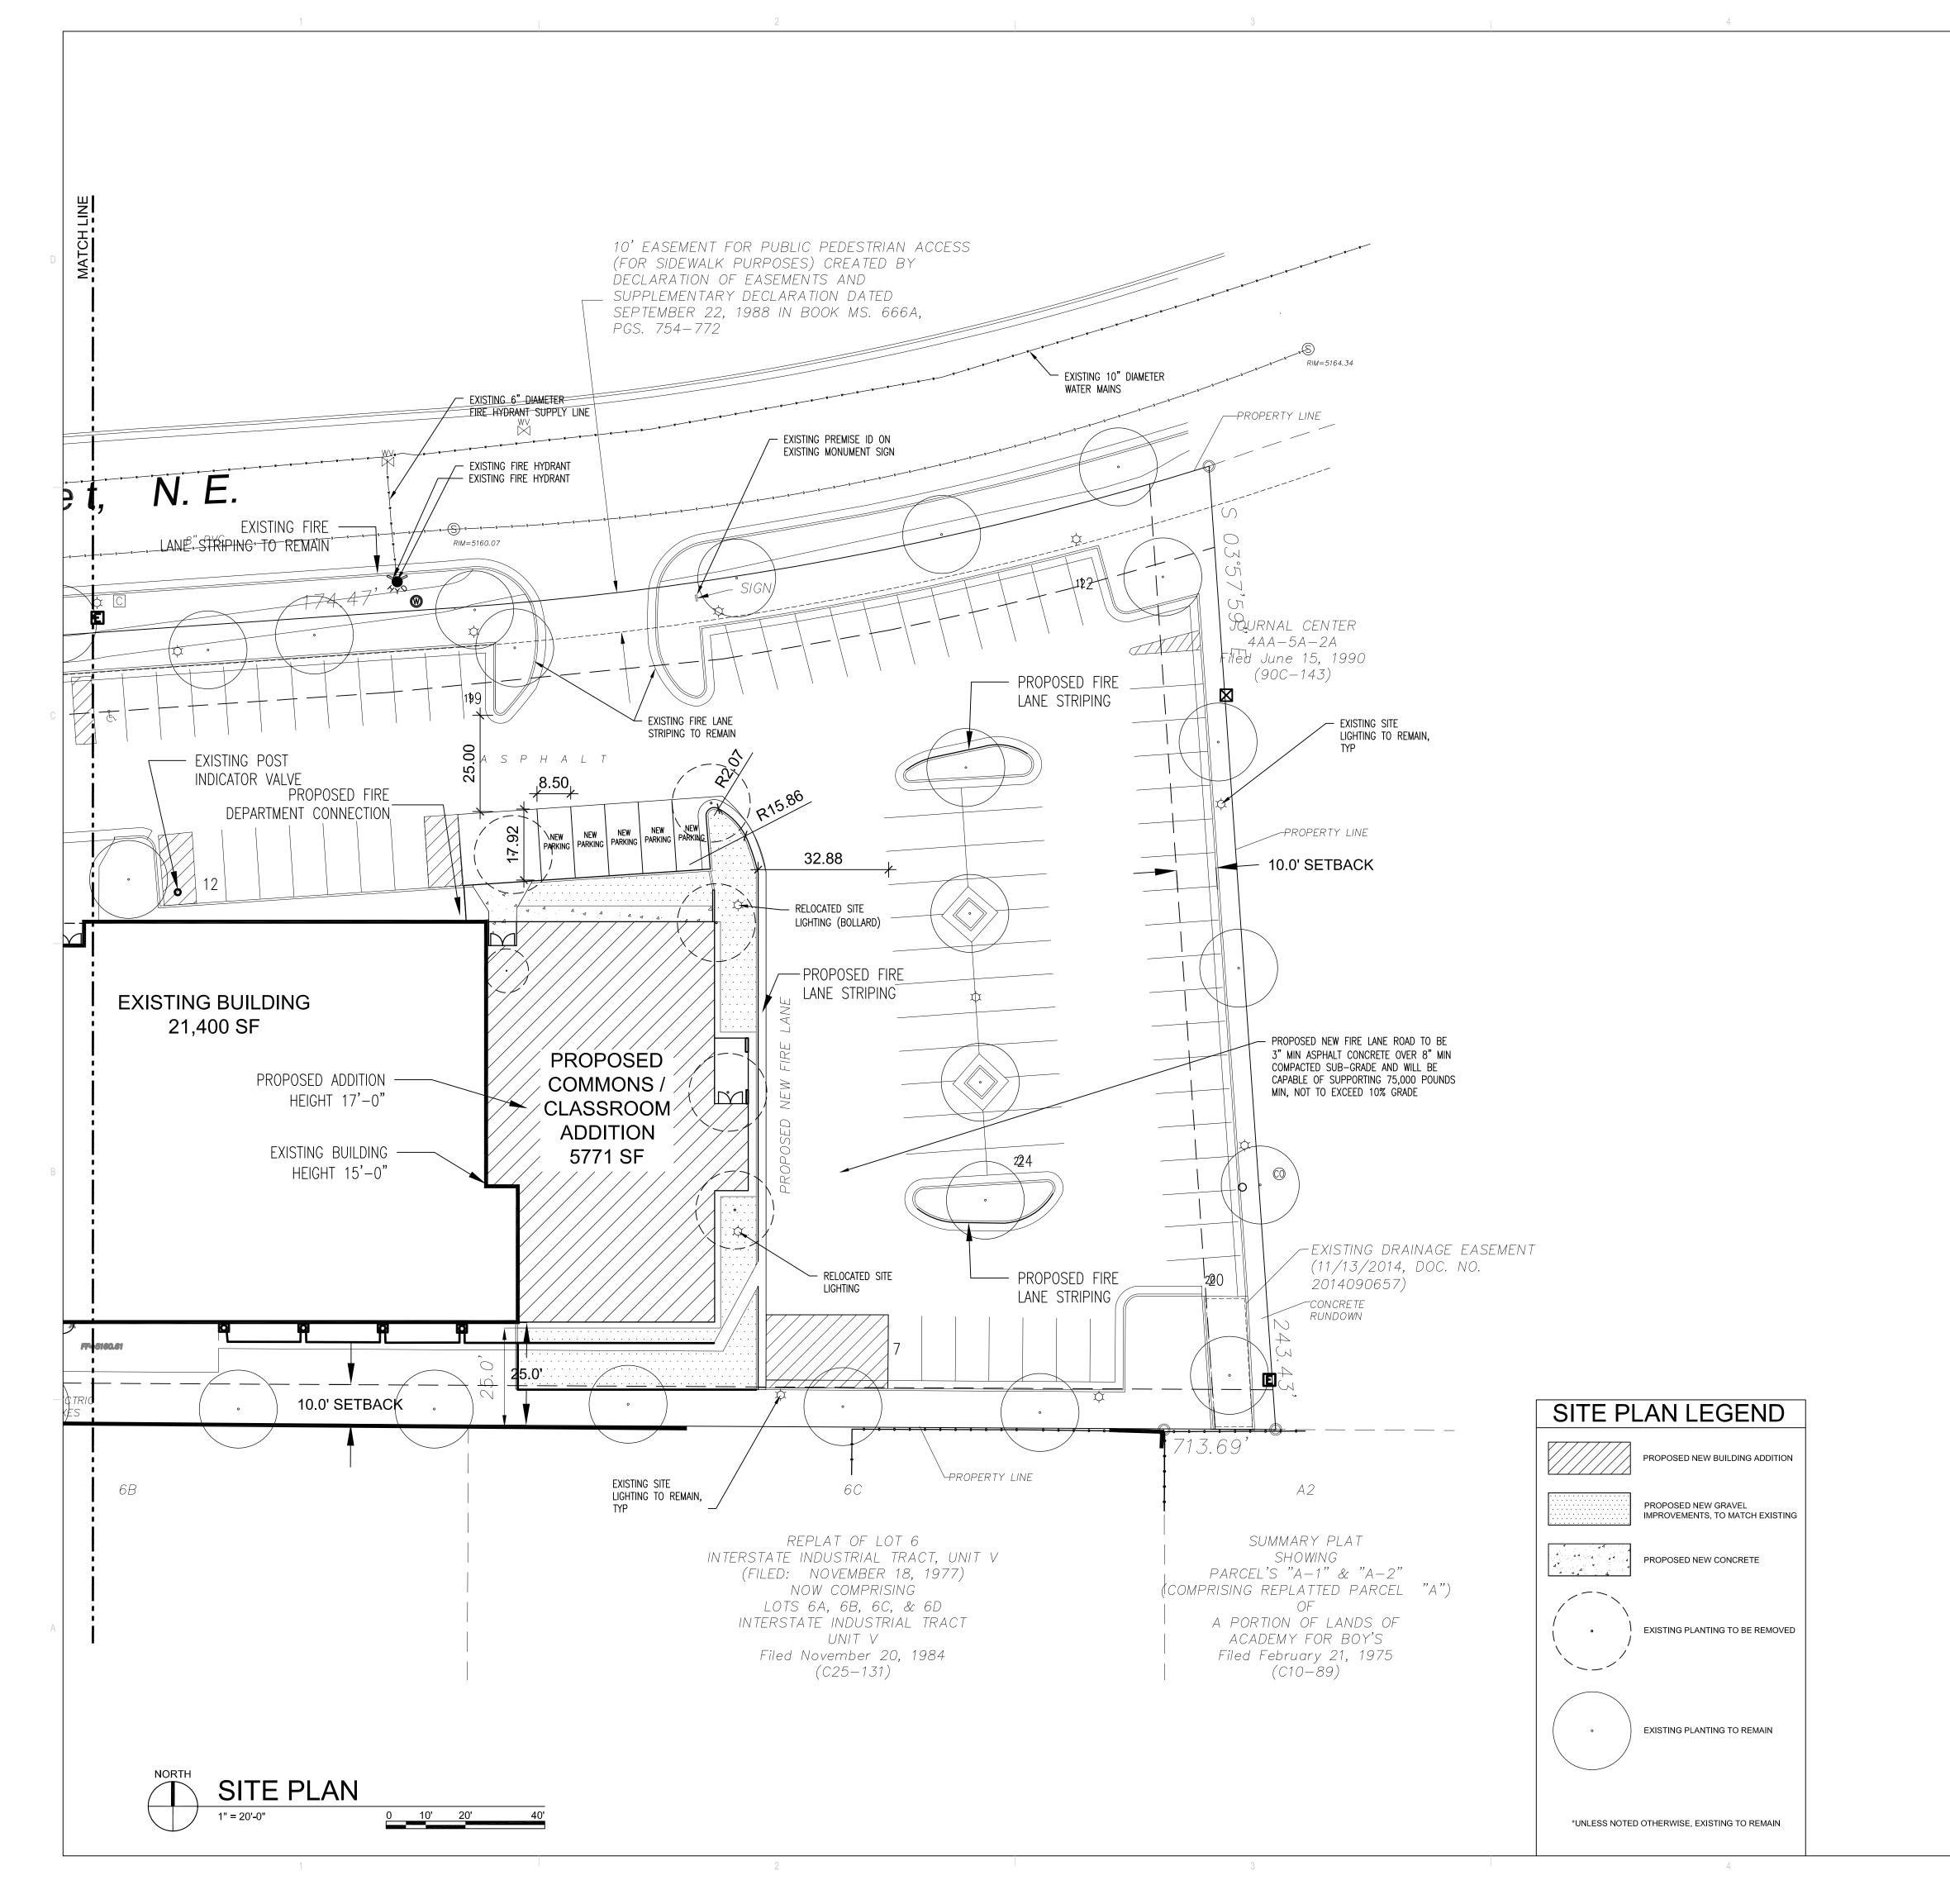

PROJECT DATA

ADDRESS: 5100 MASTHEAD STREET NE

ALBUQUERQUE, NM 87109

LEGAL DESCRIPTION: LOT 4AA-5A-1, BLOCK 0, JOURNAL CENTER, BERNALILLO COUNTY NEW MEXICO

<u>UPC:</u> 101-706-341-014-740-235

ZONING: IP

ZONE ATLAS MAP: D-17-Z BUILDING DATA:
OCCUPANCY GROUP: E - EDUCATION

EXISTING STRUCTURE: ONE STORY - 25,520 SF PROPOSED NEW CONSTRUCTION: ONE STORY - 9,948 SF

PROPOSED NEW BUILDING: 35,468 SF PROPOSED NEW CONSTRUCTION TYPE: II-B SPRINKLED SITE ACREAGE: 3.3 ACRES

SITE AREA: 143,748 SF BUILDING-TO-LOT COVERAGE (TOTAL): 24.6%

PROVIDED PARKING SPACES: 111 (INCLUDING 8 ACCESSIBLE SPACES, NOT INCLUDING 3 MOTORCYCLE PARKING SPACES) REQUIRED PARKING SPACES: 84 (3 SPACES FOR EACH CLASSROOM, 28 CLASSROOMS

Per 14-16-3-1 Off-Street Parking Regulations, Part 3 - A, (29)

PROVIDED BICYCLE PARKING: 7 PROVIDED REQUIRED BICYCLE PARKING: 6 PER 14-16-3-1 Off-Street Parking Regulations Part 3 - B, 3 (C):

1 SPACE per 50 STUDENTS @ 300 STUDENTS TOTAL

FIRE FLOW REQUIREMENTS: PROPOSED NEW CONSTRUCTION TYPE: II-B SPRINKLED

SQUARE FOOTAGE: 35,468 SF

EXISTING FIRE HYDRANTS: 2

FIRE FLOW: 2,000 GPM (PER IFC APPENDIX B)

FIRE APPARATUS ACCESS AND LOADING: NEW FIRE APPARATUS ACCESS ROAD AND ANY REPAIRS TO EXISTING FIRE APPARATUS ACCESS ROADS (DUE TO NEW FOUNDATION WORK) TO BE 3" MIN ASPHALT CONCRETE OVER 8" MIN COMPACTED SUB-GRADE AND WILL BE CAPABLE OF SUPPORTING 75,000

POUNDS MIN, NOT TO EXCEED 10% GRADE. LANDSCAPE:

ALL NEW LANDSCAPE AND IRRIGATION SHALL CONFORM TO THE CITY OF ALBUQUERQUE WATER CONSERVATION ORDINANCE.

LANDSCAPE AREA REQUIREMENT: 143,748 SF (SITE AREA) - 35,468SF (BUILDING AREA) = 108,280 SF X 15% = 16,242 SF

LANDSCAPE AREA PROVIDED: 19,750 SF (18%)

VICINITY MAP Zone Atlas Page: D-17



APPROVALS

PROJECT NUMBER: APPLICATION NUMBER:

Is an Infrastructure List Required? () Yes (x) No If yes, then a set of approved DRC plans with a work order is required for any construction within Public Right-of-Way or for construction of public improvements.

SITE DEVELOPMENT PLAN APPROVAL

DRB CHAIRPERSON, PLANNING DEPARTMENT

TRAFFIC ENGINEER, TRANSPORTATION DIVISION	DATE
ABCWUA	DATE
PARKS AND RECREATION DEPARTMENT	DATE
CITY ENGINEER	DATE
SOLID WASTE MANAGEMENT	DATE
FIRE MARSHAL	DATE
CODE ENFORCEMENT	DATE

ARCHITECTURE / DESIGN / INSPIRATION

DEKKER PERICH SABATINI

7601 JEFFERSON NE, SUITE 100 ALBUQUERQUE, NM 87109

505.761.9700 / DPSDESIGN.ORG

ARCHITECT

ENGINEER

PROJECT

ADE NM


REVISIONS

	DRAWN BY	
·	REVIEWED BY	
•	DATE	02/26/2018
·	PROJECT NO.	16-0150.006
	DRAWING NAME	

SITE PLAN

DATE

DRB01B

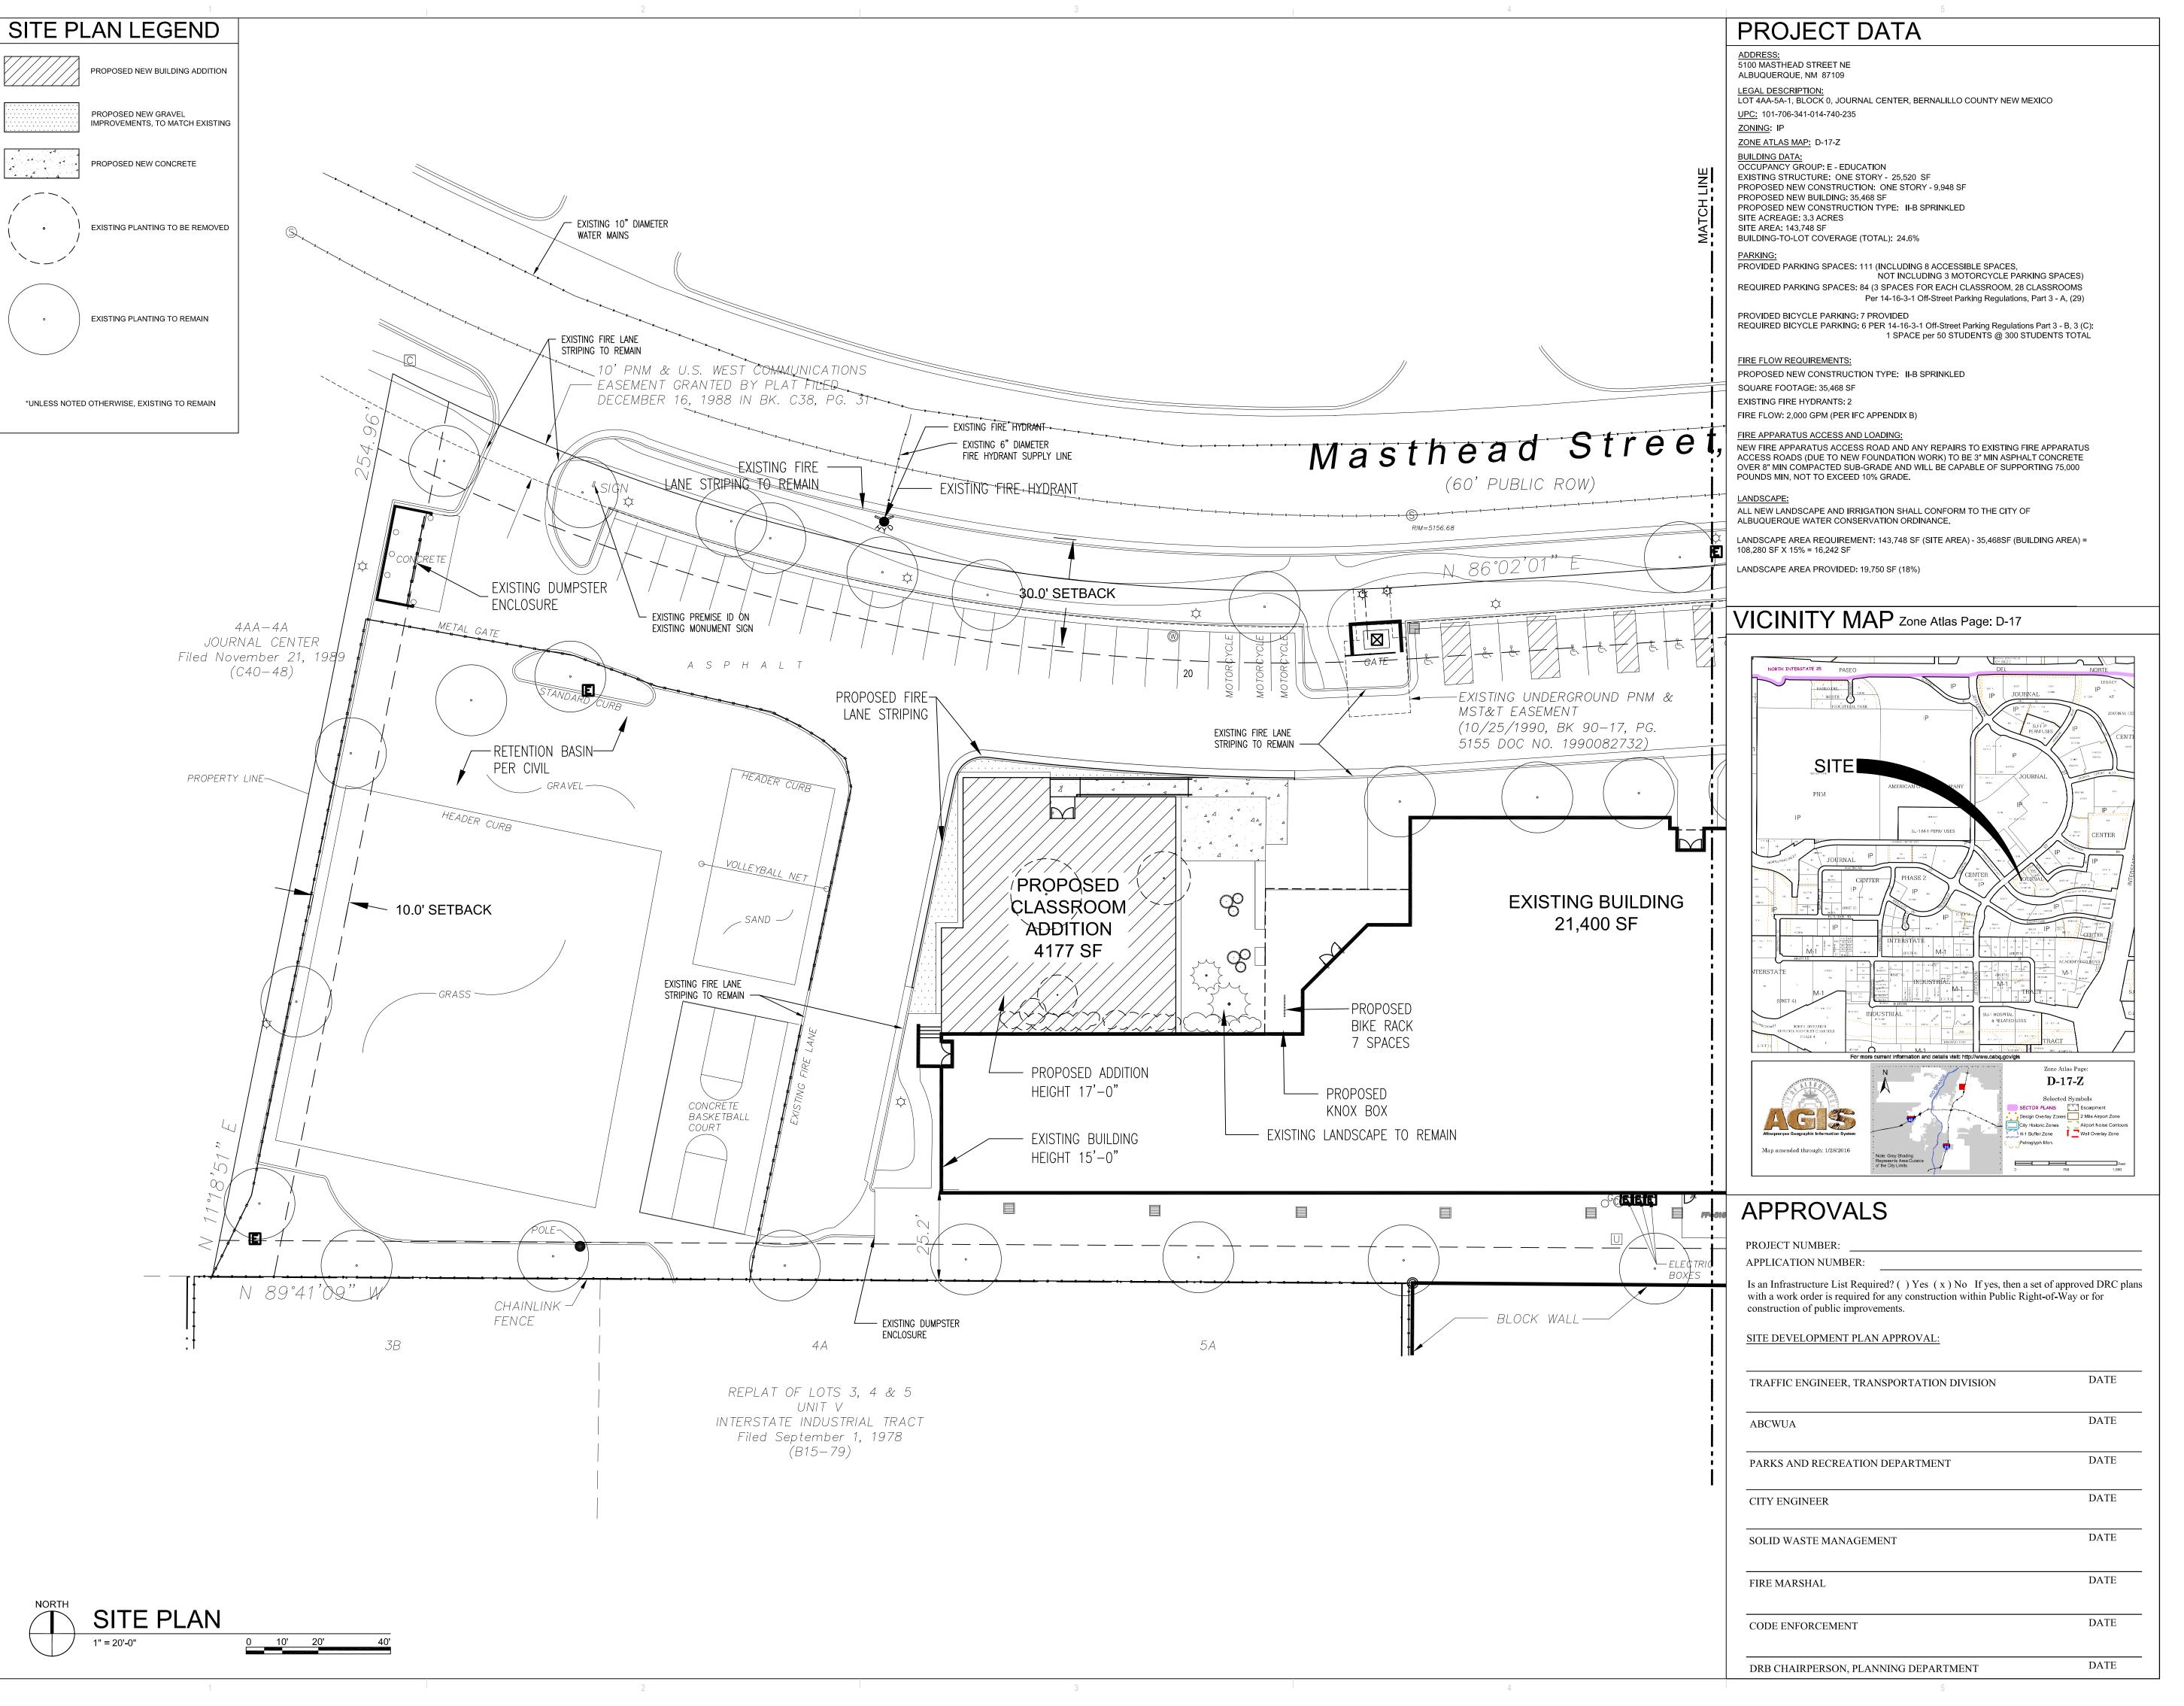

DEKKER PERICH SABATINI

7601 JEFFERSON NE, SUITE 100 ALBUQUERQUE, NM 87109

505.761.9700 / DPSDESIGN.ORG

ARCHITECT

ENGINEER

PROJECT

EXPLORE ACADEMY
RENOVATION/ADDITION
5100 MASTHEAD ST. NE
ALBUQUERQUE, NM 87109

REVISIONS

 \triangle

DRAWN BY

REVIEWED BY


DATE 02/26/2018

PROJECT NO. 16-0150.006

DRAWING NAME

LANDSCAPE PLAN

ET NO.

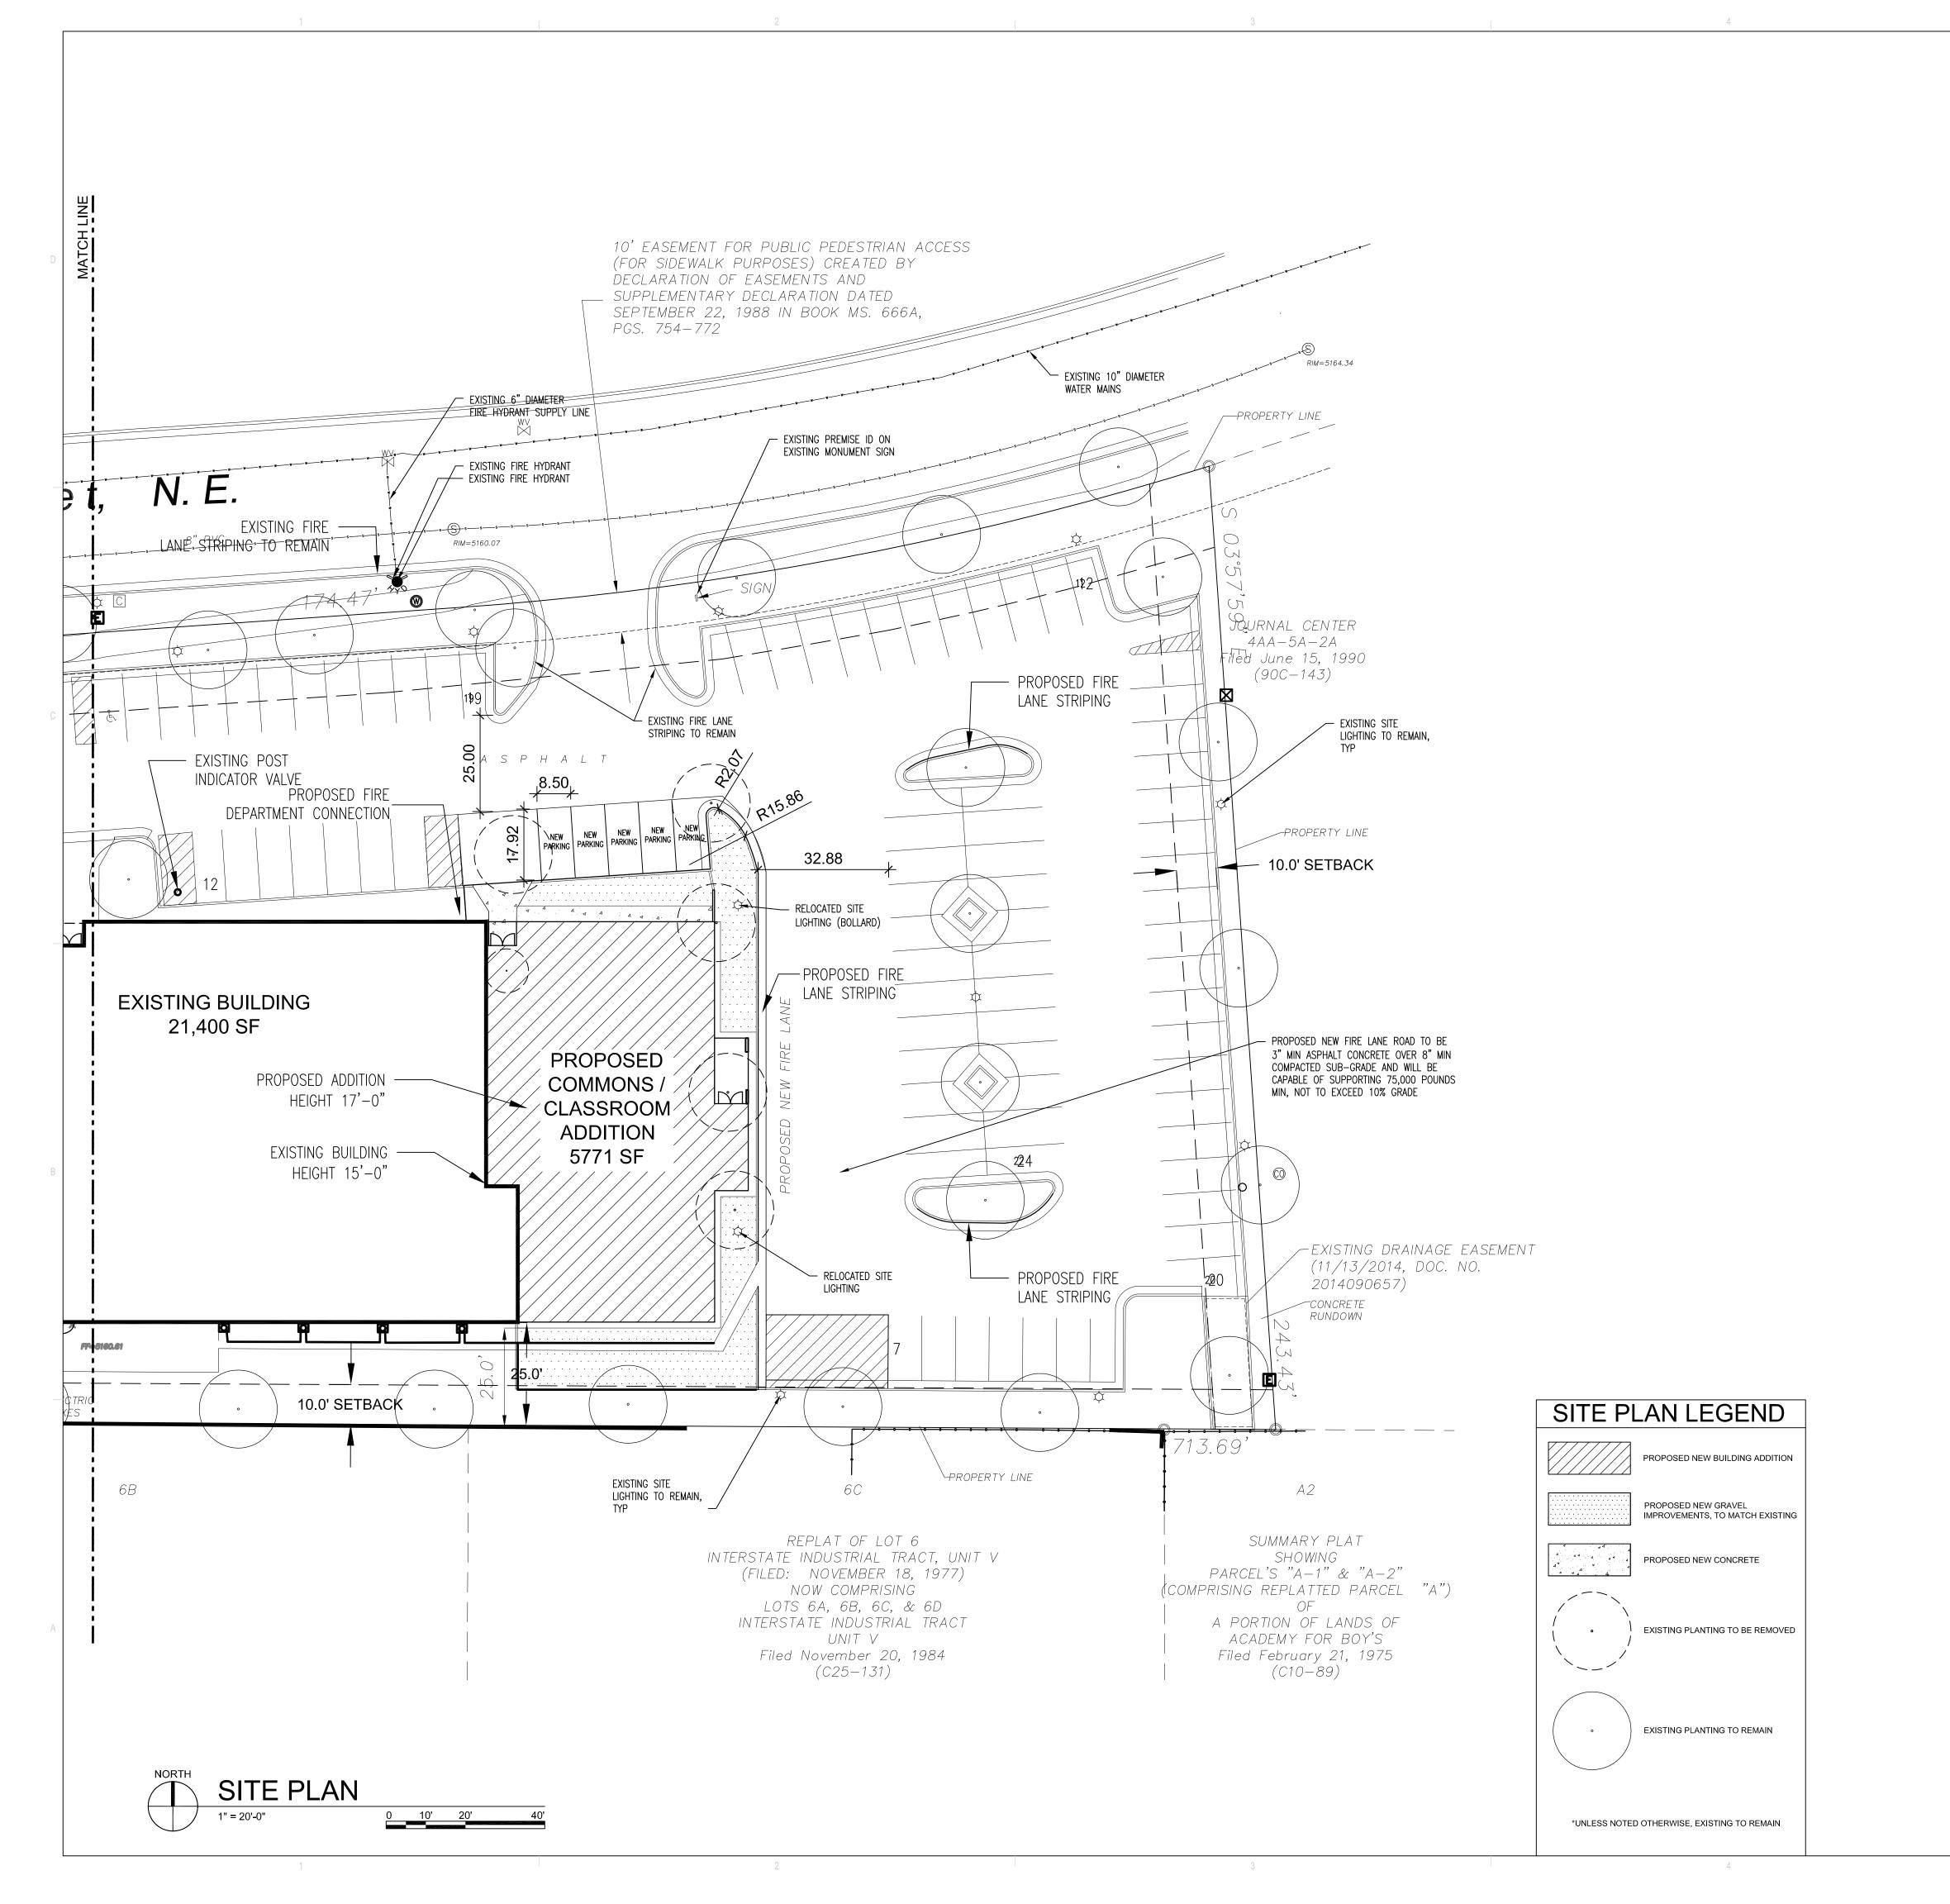

PROJECT DATA

ADDRESS: 5100 MASTHEAD STREET NE

ALBUQUERQUE, NM 87109

<u>LEGAL DESCRIPTION:</u> LOT 4AA-5A-1, BLOCK 0, JOURNAL CENTER, BERNALILLO COUNTY NEW MEXICO

<u>UPC:</u> 101-706-341-014-740-235

ZONING: IP ZONE ATLAS MAP: D-17-Z

BUILDING DATA:
OCCUPANCY GROUP: E - EDUCATION

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PROPOSED NEW BUILDING: 35,468 SF PROPOSED NEW CONSTRUCTION TYPE: II-B SPRINKLED SITE ACREAGE: 3.3 ACRES

SITE AREA: 143,748 SF BUILDING-TO-LOT COVERAGE (TOTAL): 24.6%

PROVIDED PARKING SPACES: 111 (INCLUDING 8 ACCESSIBLE SPACES, NOT INCLUDING 3 MOTORCYCLE PARKING SPACES) REQUIRED PARKING SPACES: 84 (3 SPACES FOR EACH CLASSROOM, 28 CLASSROOMS

PROVIDED BICYCLE PARKING: 7 PROVIDED REQUIRED BICYCLE PARKING: 6 PER 14-16-3-1 Off-Street Parking Regulations Part 3 - B, 3 (C):

1 SPACE per 50 STUDENTS @ 300 STUDENTS TOTAL

Per 14-16-3-1 Off-Street Parking Regulations, Part 3 - A, (29)

FIRE FLOW REQUIREMENTS: PROPOSED NEW CONSTRUCTION TYPE: II-B SPRINKLED

SQUARE FOOTAGE: 35,468 SF EXISTING FIRE HYDRANTS: 2

FIRE FLOW: 2,000 GPM (PER IFC APPENDIX B)

FIRE APPARATUS ACCESS AND LOADING:

NEW FIRE APPARATUS ACCESS ROAD AND ANY REPAIRS TO EXISTING FIRE APPARATUS ACCESS ROADS (DUE TO NEW FOUNDATION WORK) TO BE 3" MIN ASPHALT CONCRETE OVER 8" MIN COMPACTED SUB-GRADE AND WILL BE CAPABLE OF SUPPORTING 75,000 POUNDS MIN, NOT TO EXCEED 10% GRADE.


LANDSCAPE:

ALL NEW LANDSCAPE AND IRRIGATION SHALL CONFORM TO THE CITY OF ALBUQUERQUE WATER CONSERVATION ORDINANCE.

LANDSCAPE AREA REQUIREMENT: 143,748 SF (SITE AREA) - 35,468SF (BUILDING AREA) = 108,280 SF X 15% = 16,242 SF

LANDSCAPE AREA PROVIDED: 19,750 SF (18%)

VICINITY MAP Zone Atlas Page: D-17

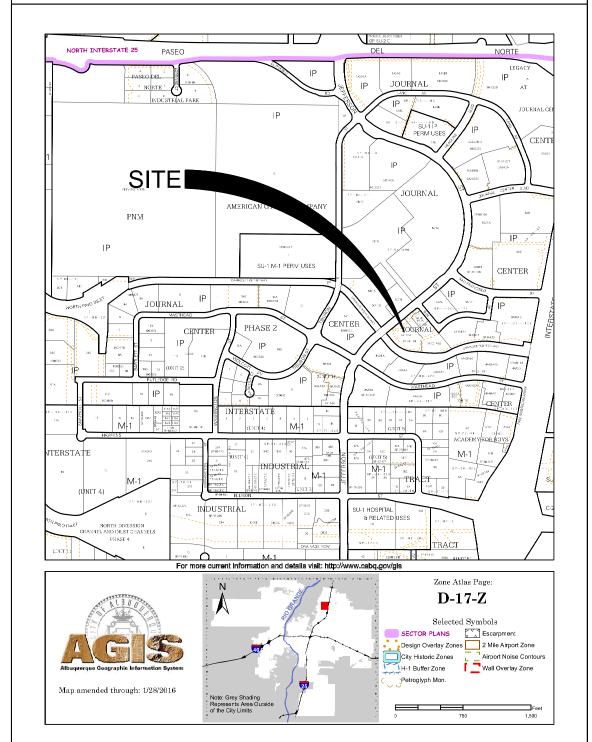

APPROVALS

PROJECT NUMBER:

APPLICATION NUMBER: Is an Infrastructure List Required? () Yes (x) No If yes, then a set of approved DRC plans with a work order is required for any construction within Public Right-of-Way or for

SITE DEVELOPMENT PLAN APPROVAL

construction of public improvements.

TRAFFIC ENGINEER, TRANSPORTATION DIVISION	DATE
ABCWUA	DATE
PARKS AND RECREATION DEPARTMENT	DATE
CITY ENGINEER	DATE
SOLID WASTE MANAGEMENT	DATE
FIRE MARSHAL	DATE
CODE ENFORCEMENT	DATE
CODE ENFORCEMENT	
DRB CHAIRPERSON, PLANNING DEPARTMENT	DATE

ARCHITECTURE / DESIGN / INSPIRATION

DEKKER PERICH SABATINI

7601 JEFFERSON NE, SUITE 100 ALBUQUERQUE, NM 87109

505.761.9700 / DPSDESIGN.ORG

ARCHITECT

ENGINEER

PROJECT


ADE NM

REVISIONS

DRAWN BY **REVIEWED BY** DATE 02/26/2018 PROJECT NO. 16-0150.006

DRAWING NAME LANDSCAPE PLAN

LAND01B

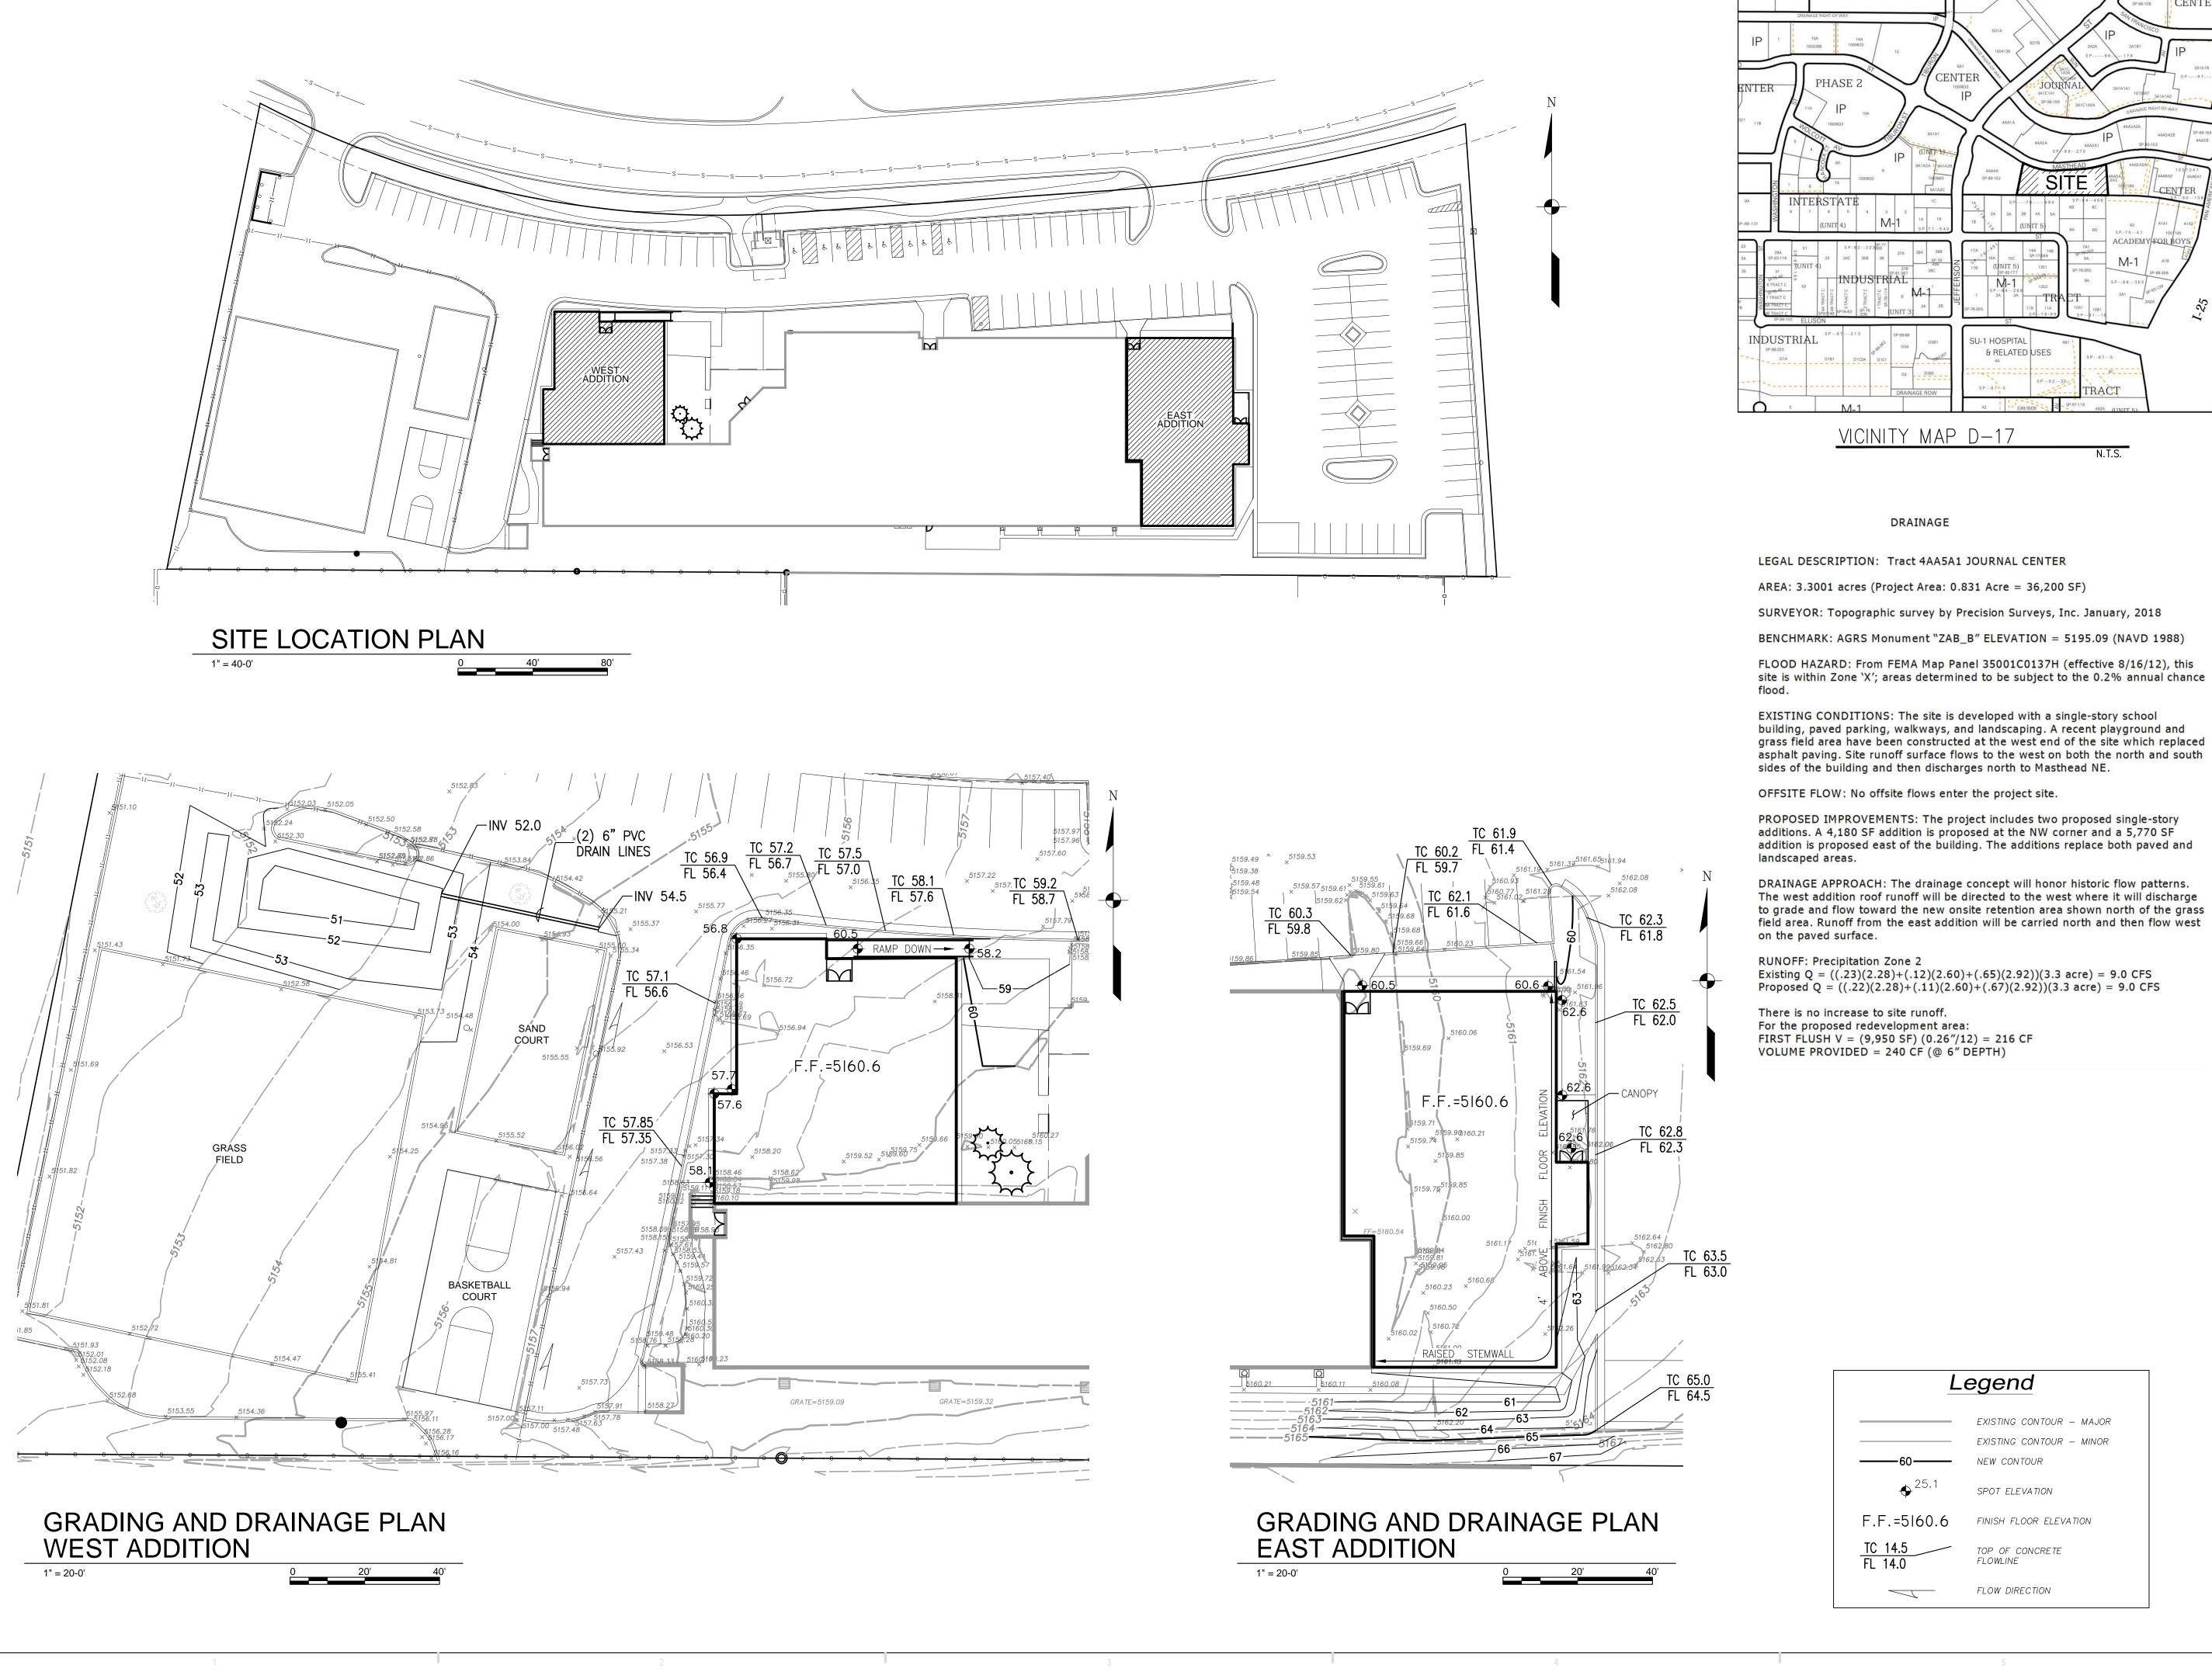


ARCHITECTURE / DESIGN / INSPIRATION DEKKER PERICH SABATINI

SU-1 M-1 PERM USES

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ENGINEER

EXPLORE ACADE RENOVATION/ADDITED ST. NASTHEAD ST. NALBUQUERQUE, NM 87

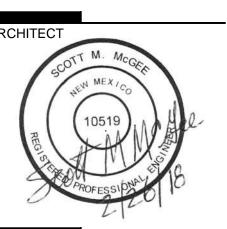REVISIONS

DRAWN BY EJS **REVIEWED BY** DATE 02/16/2018 16-0150.006


PROJECT NO. DRAWING NAME

PRELIMINARY

GRADING PLAN

SHEET NO.

C100

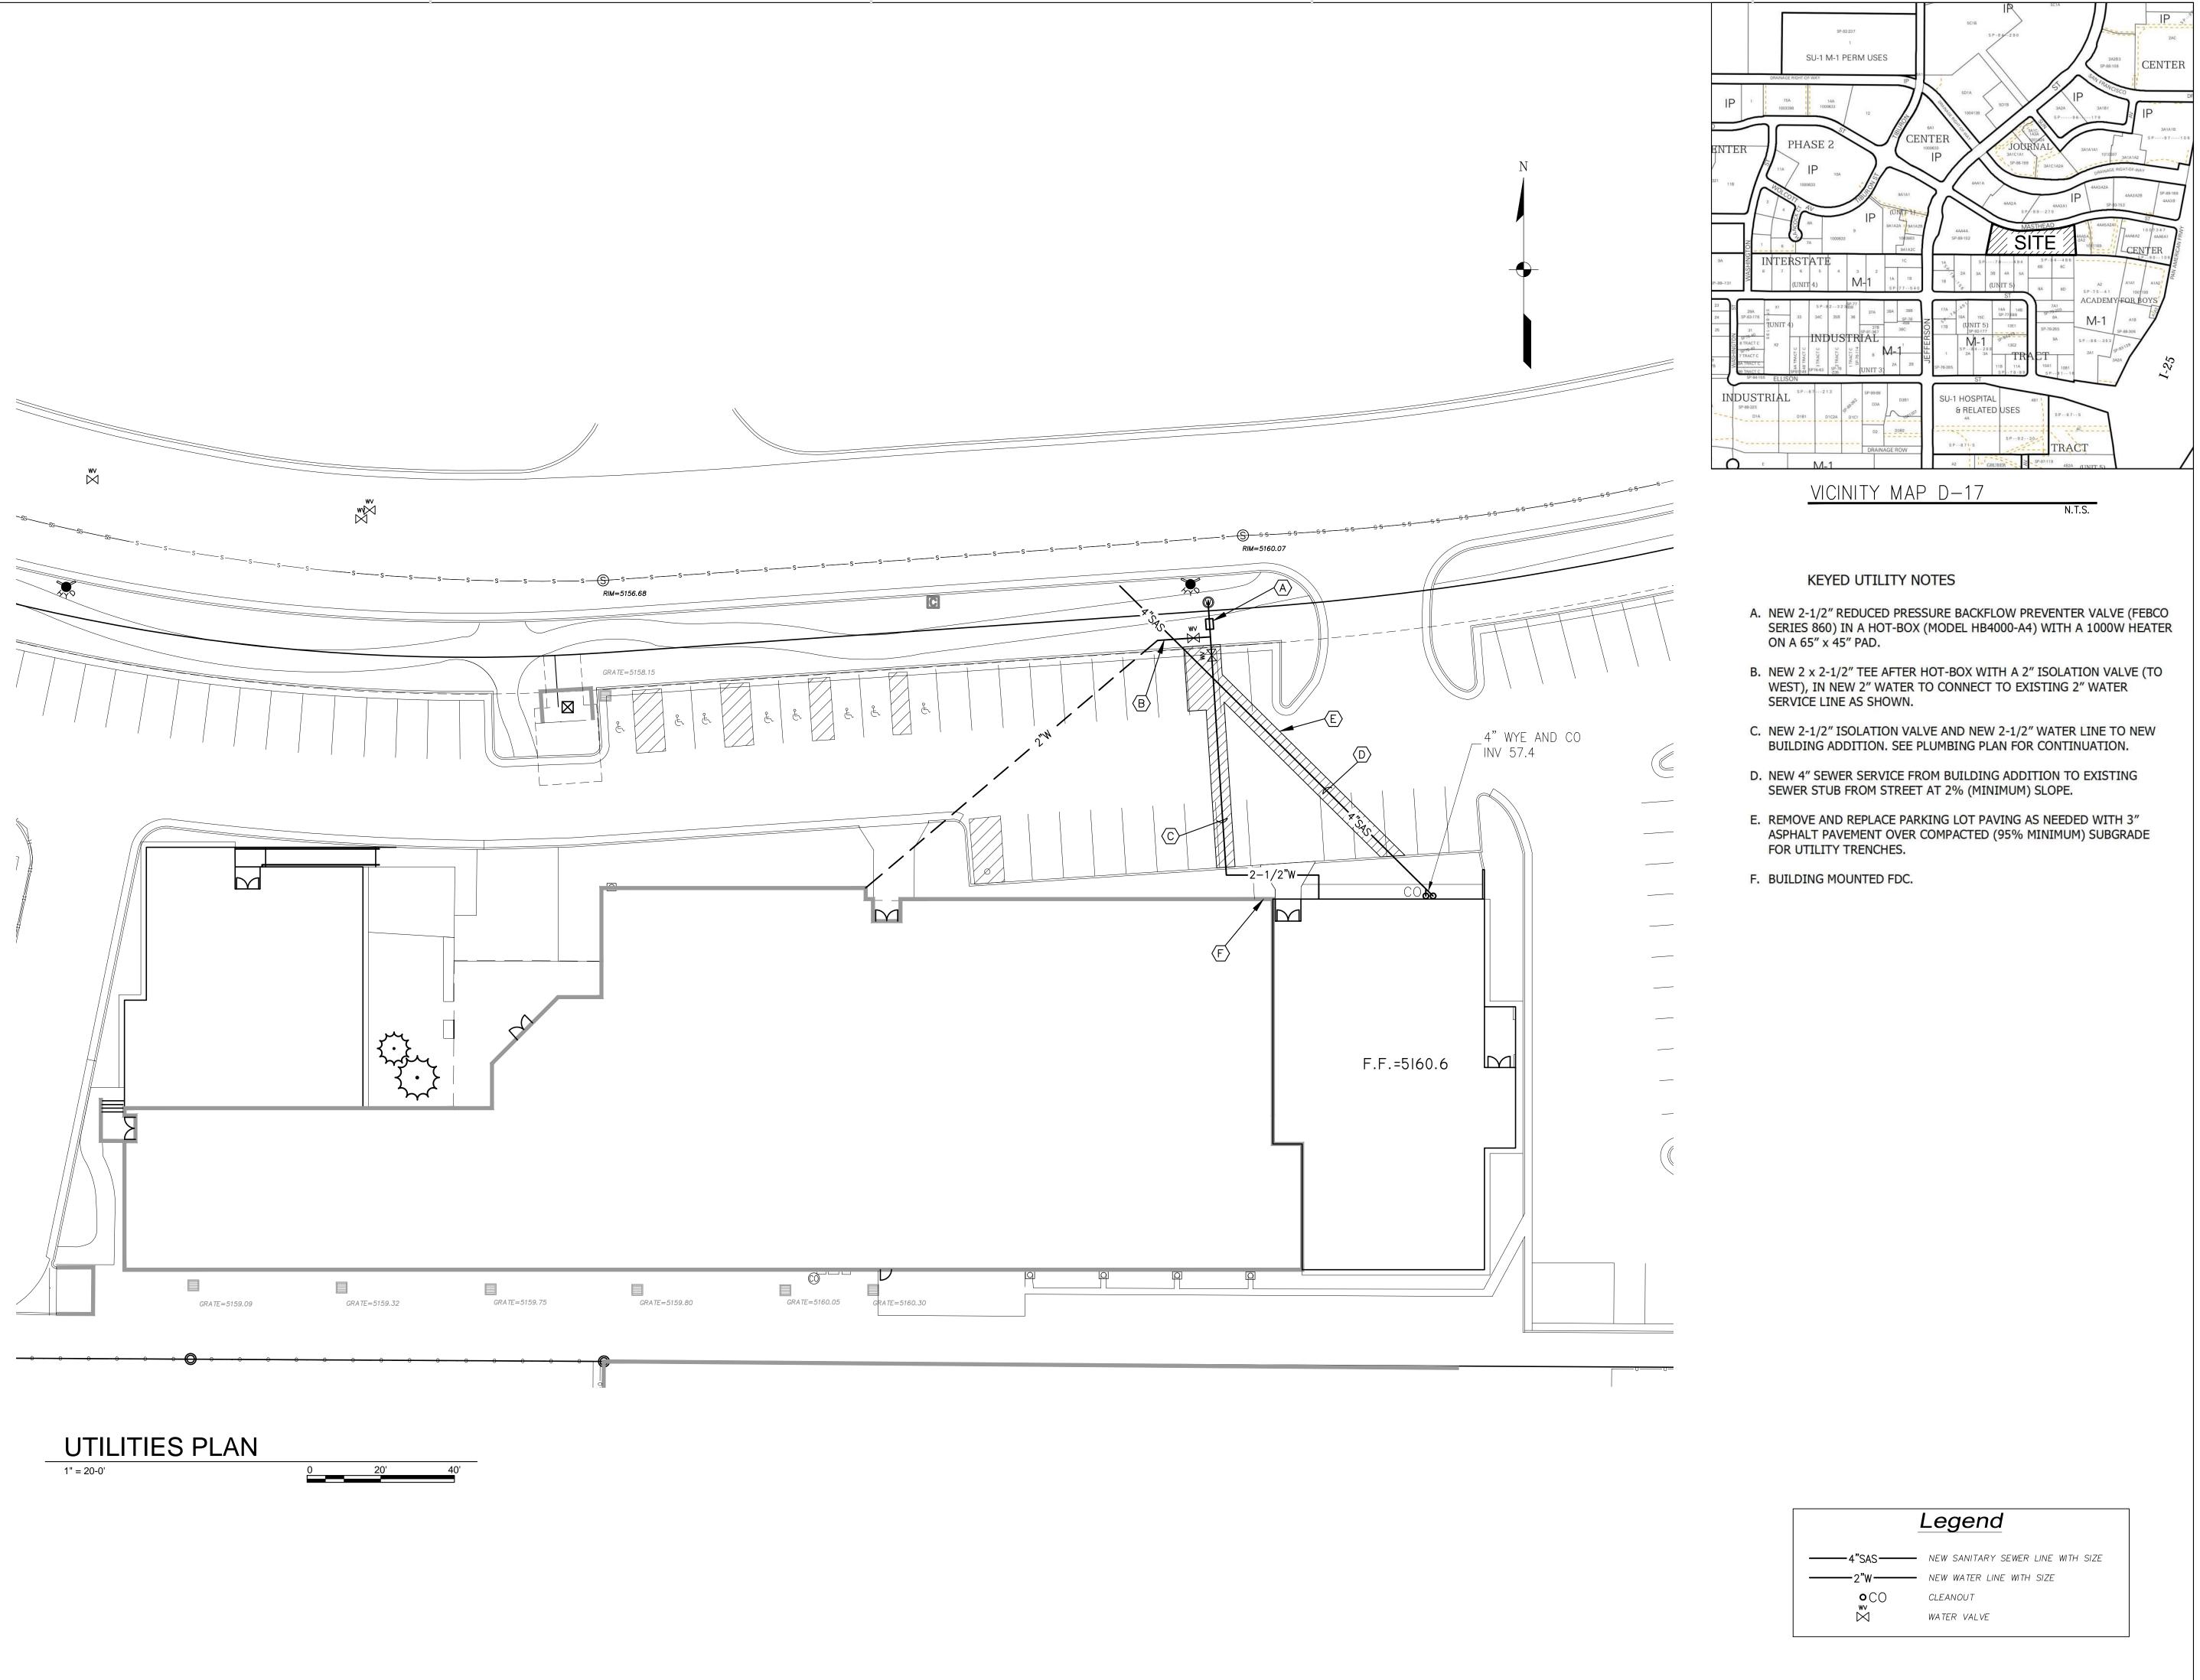

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ENGINEER

PROJECT

XPLORE ACADEMY
NOVATION/ADDITION
5100 MASTHEAD ST. NE
ALBUQUERQUE, NM 87109

DRAWN BY EJS

REVIEWED BY

DATE 02/16/2018


PROJECT NO. 16-0150.006

DRAWING NAME

UTILITIES

SHEET NO

C1001

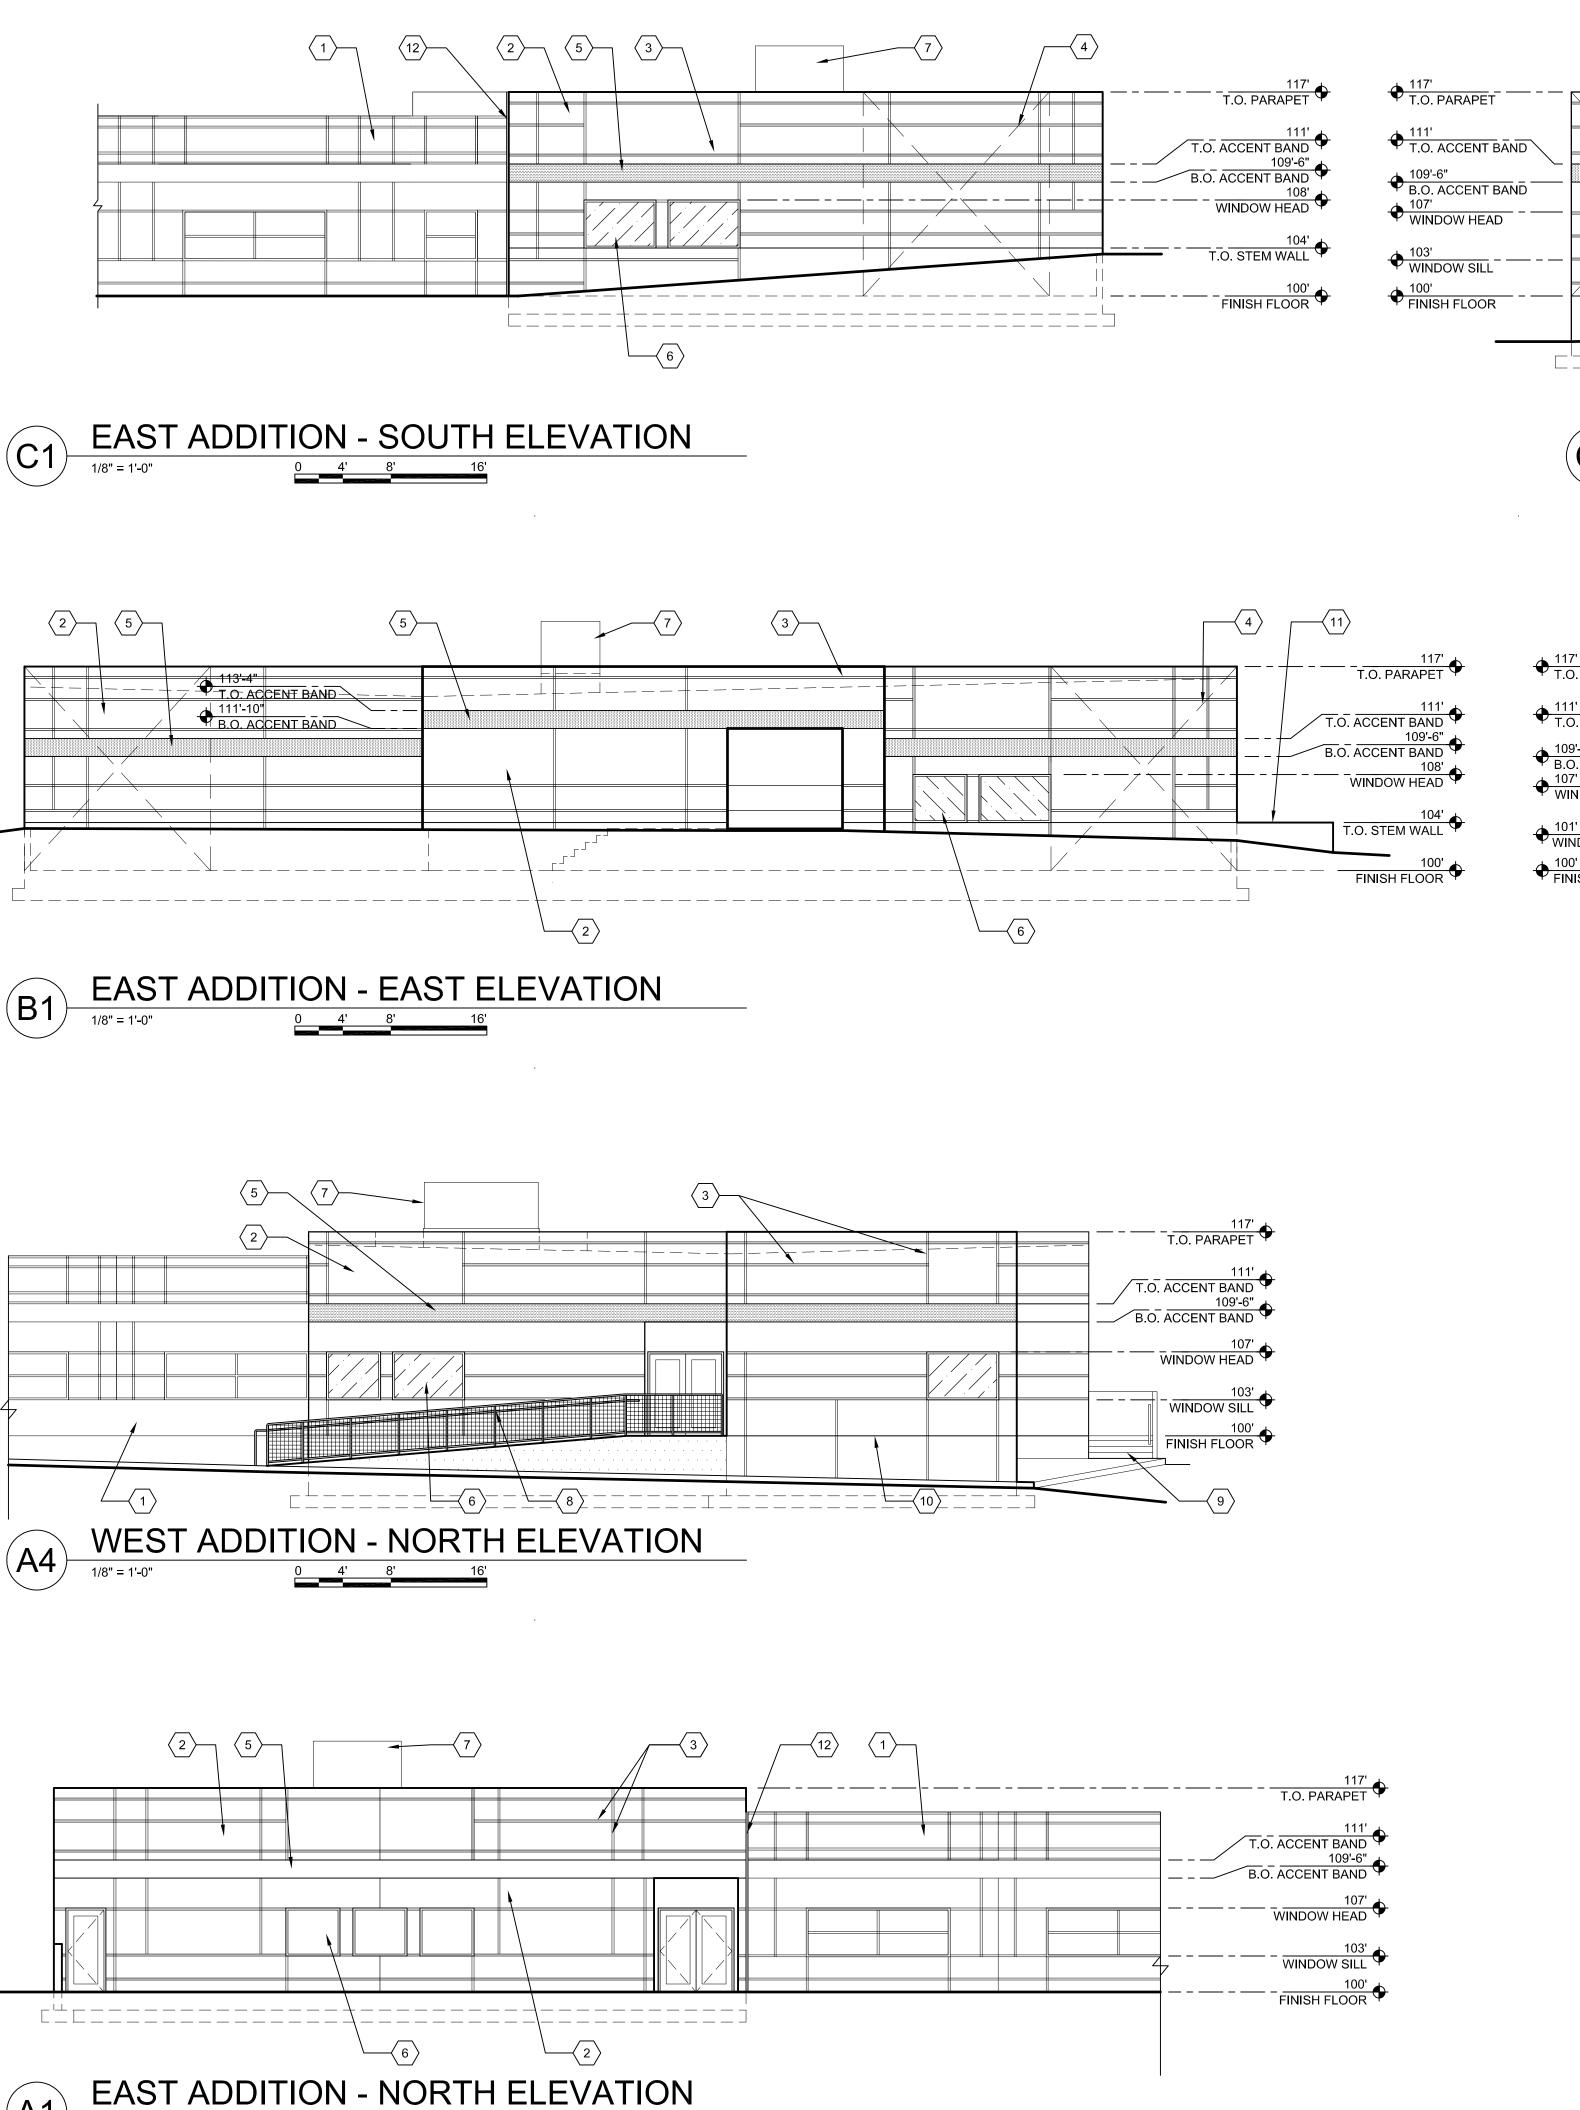

1/8" = 1'-0"

117
T.O. PARAPET

117
T.O. ACCENT BÂND

109-6"
B.O. ACCENT BAND

107
WINDOW SILL


103
WINDOW SILL

100
FINISH FLOOR

WEST ADDITION - WEST ELEVATION

1/8" = 1'-0"

0 4' 8' 16'

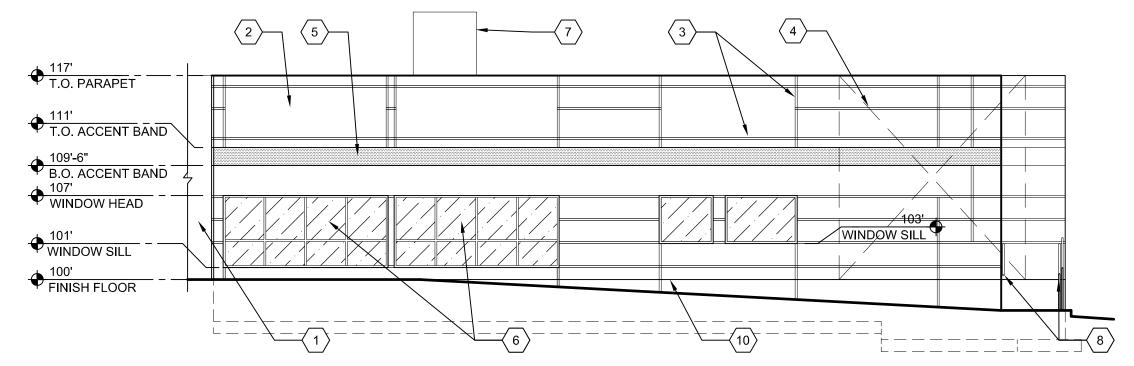

(B4) WEST ADDITION - EAST ELEVATION

1/8" = 1'-0"

0 4' 8' 16'


GENERAL SHEET NOTES

A. VERIFY ALL DIMENSIONS RELATIVE TO EXISTING STRUCTURE TO REMAIN B. HORIZONTAL BANDING OF NEW ELEVATIONS TO MATCH EXISTING U.N.O.

○ SHEET KEYED NOTES

- EXISTING BUILDING, PRECAST CONCRETE PANELS
- EXTERIOR INSULATION FINISH SYSTEM (EIFS) COLOR TO MATCH EXISTING CONCRETE PANELS
 V-GROOVE IN EIFS SYSTEM TO MATCH EXISTING GROOVE PROFILE
- 4. STRUCTURAL BRACE WITHIN WALL5. COLORED ACCENT BAND TO MATCH EXISTING
- 6. HOLLOW METAL WINDOW & FRAME, PAINT FRAME TO MATCH EXISTING7. ROOFTOP MECHANICAL UNIT
- 8. PAINTED METAL HANDRAIL AND GUARDRAIL. 4X4 WWF INFILL PANELS, TYP.9. NEW CONC. STEPS AND CHEEK WALL AT EXISTING CONC. LANDING
- 10. EIFS JOINT AT FLOOR LINE SEE WALL SECTION11. CONC. RETAINING WALL

12. 2" EXPANSION JOINT AND COVER

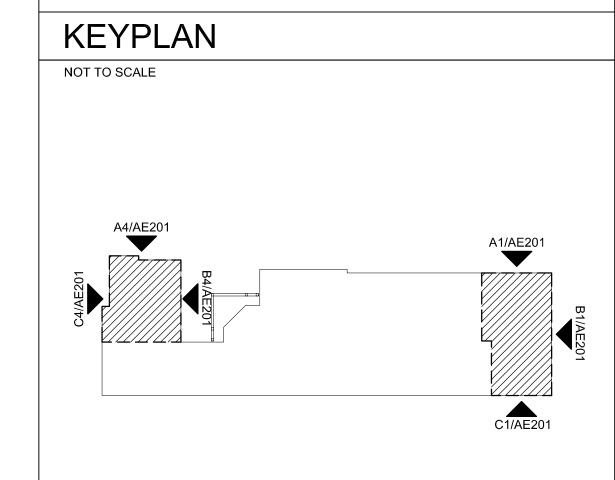

SHEET NO. ELEV

02/26/2018

16-0150.006

DEKKER
PERICH
SABATINI

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ARCHITECT

ENGINEER

PROJECT

EXPLORE ACADEMY
RENOVATION/ADDITION
5100 MASTHEAD ST. NE

REVISIONS

DRAWN BY

DATE

REVIEWED BY

PROJECT NO.

DRAWING NAME


ELEVATIONS



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EXPLORE ACADEMY RENOVATION / ADDITION RENDERED ELEVATIONS 02/26/2018



SCOPE:

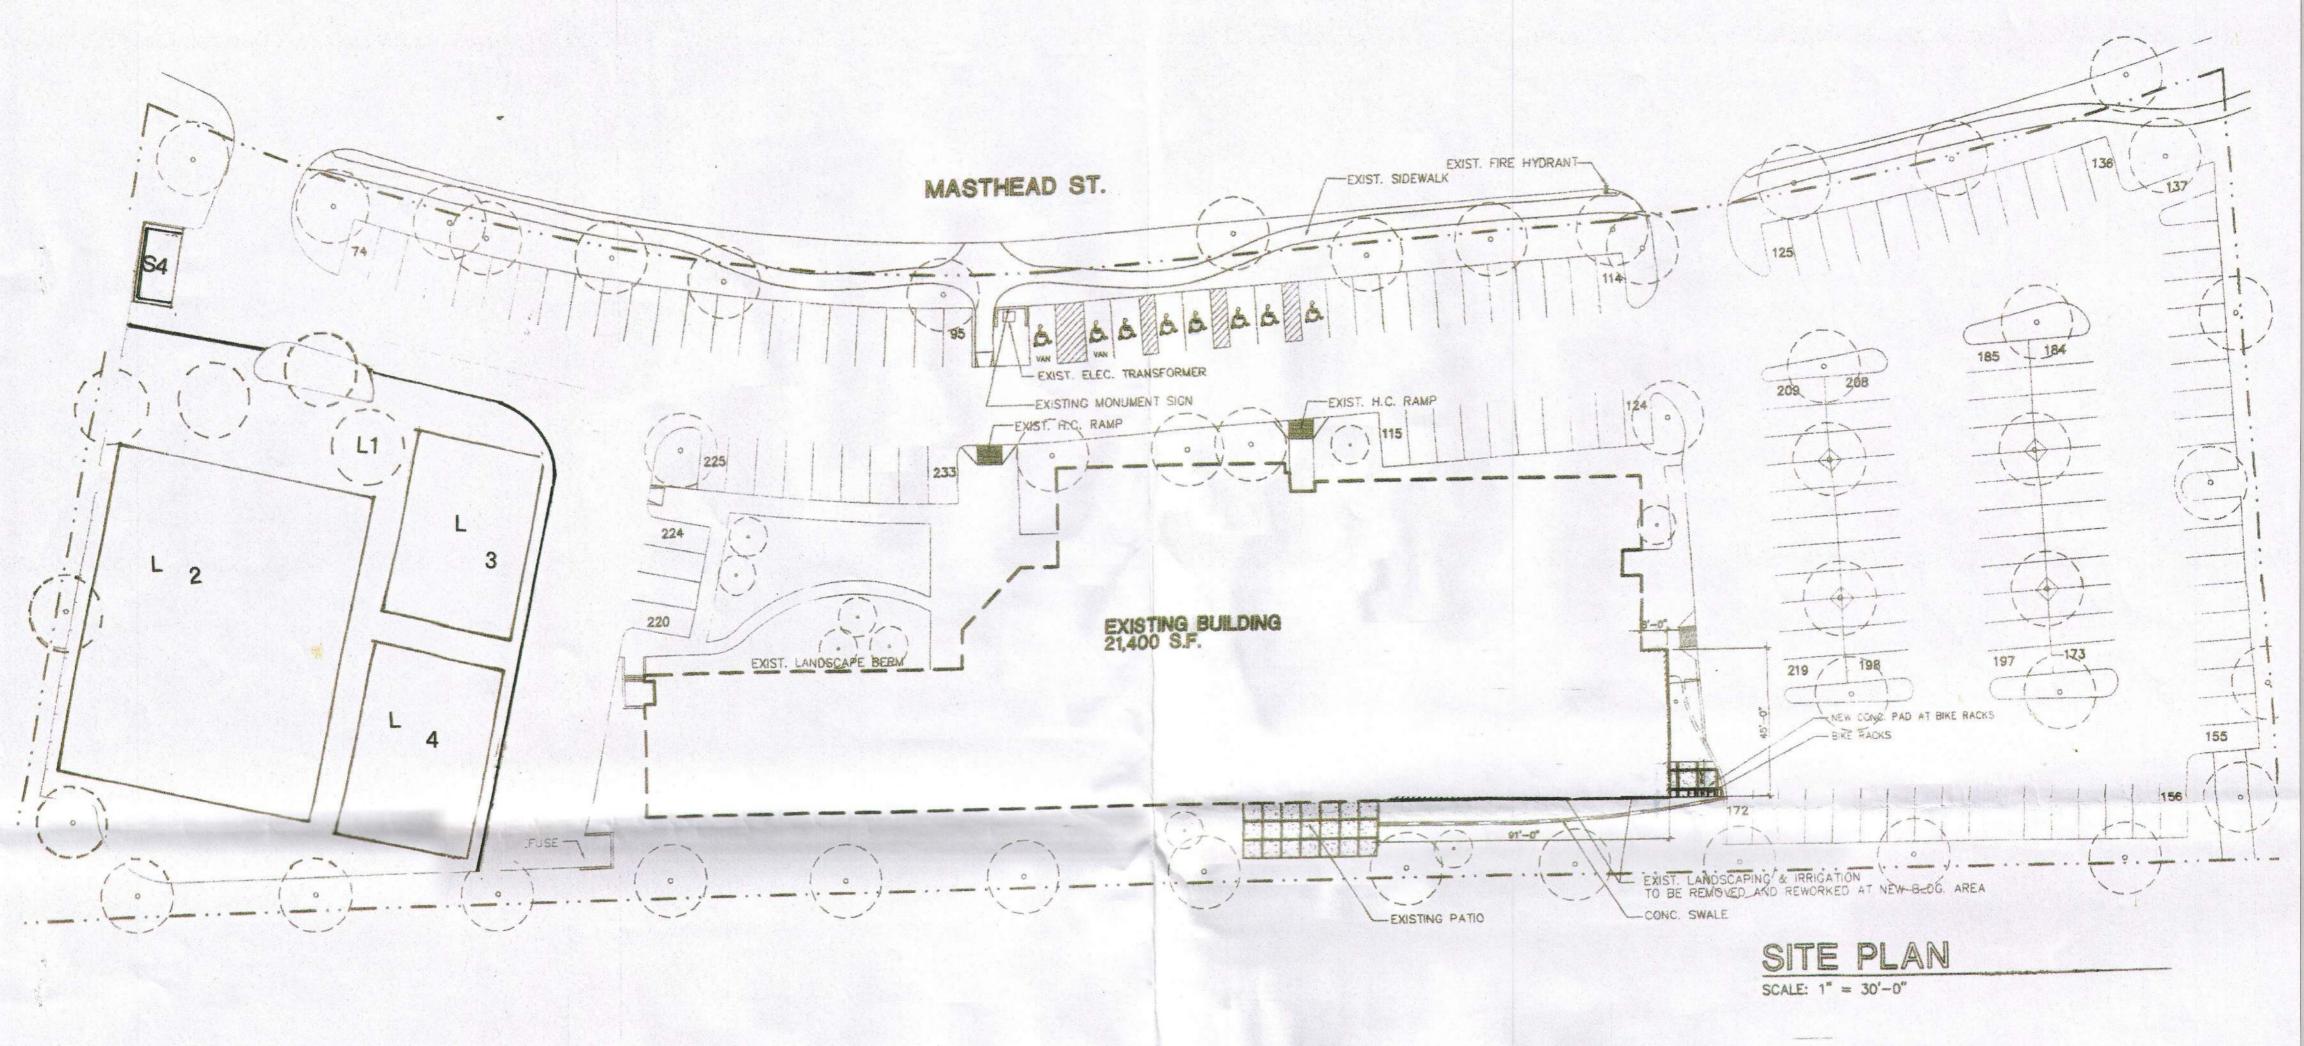- 1. Remove 22,250 square feet of existing parking lot areas outlined for outdoor use.
- 2. Install 160 lineal feet of 6 inch vertical curbing. New fire lane
- 3. Relocate Fire Lane to North South along East side of building 139.21 feet to curb dead end with a 25 foot opening and East to West along main drive with 30 foot opening. Verified in field.
- 4. Relocate dumpster to North West corner of lot, en-closer to be installed per city specifacations.
- 5. Install 446 lineal feet of 6 foot decorative fencing, with 12 foot access on the North side and 6 foot access on the East side.
- 7. Install 9,000 square foot turf area for outdoor activity.
- 8. Install 1,800 square foot basketball court.
- 9. Install 1,800 square foot volley ball court.


LANDSCAPE AND ACTIVITY


- 1. Raywood Ash Min. 2" caliper
- 2. 9,000 square foot turf area
- 3. 1,800 square foot Volley ball area.
- 4. 1,800 square foot Basketball area.


5975-17

APPROVALS:

AFD FIRE MARSHAL'S OFFICE

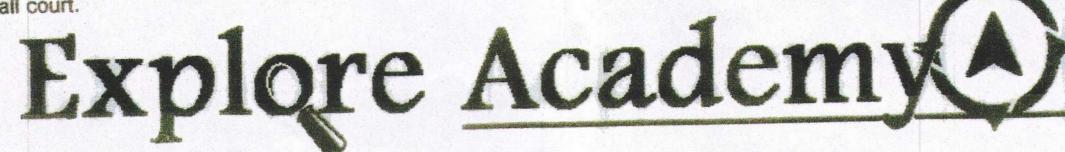


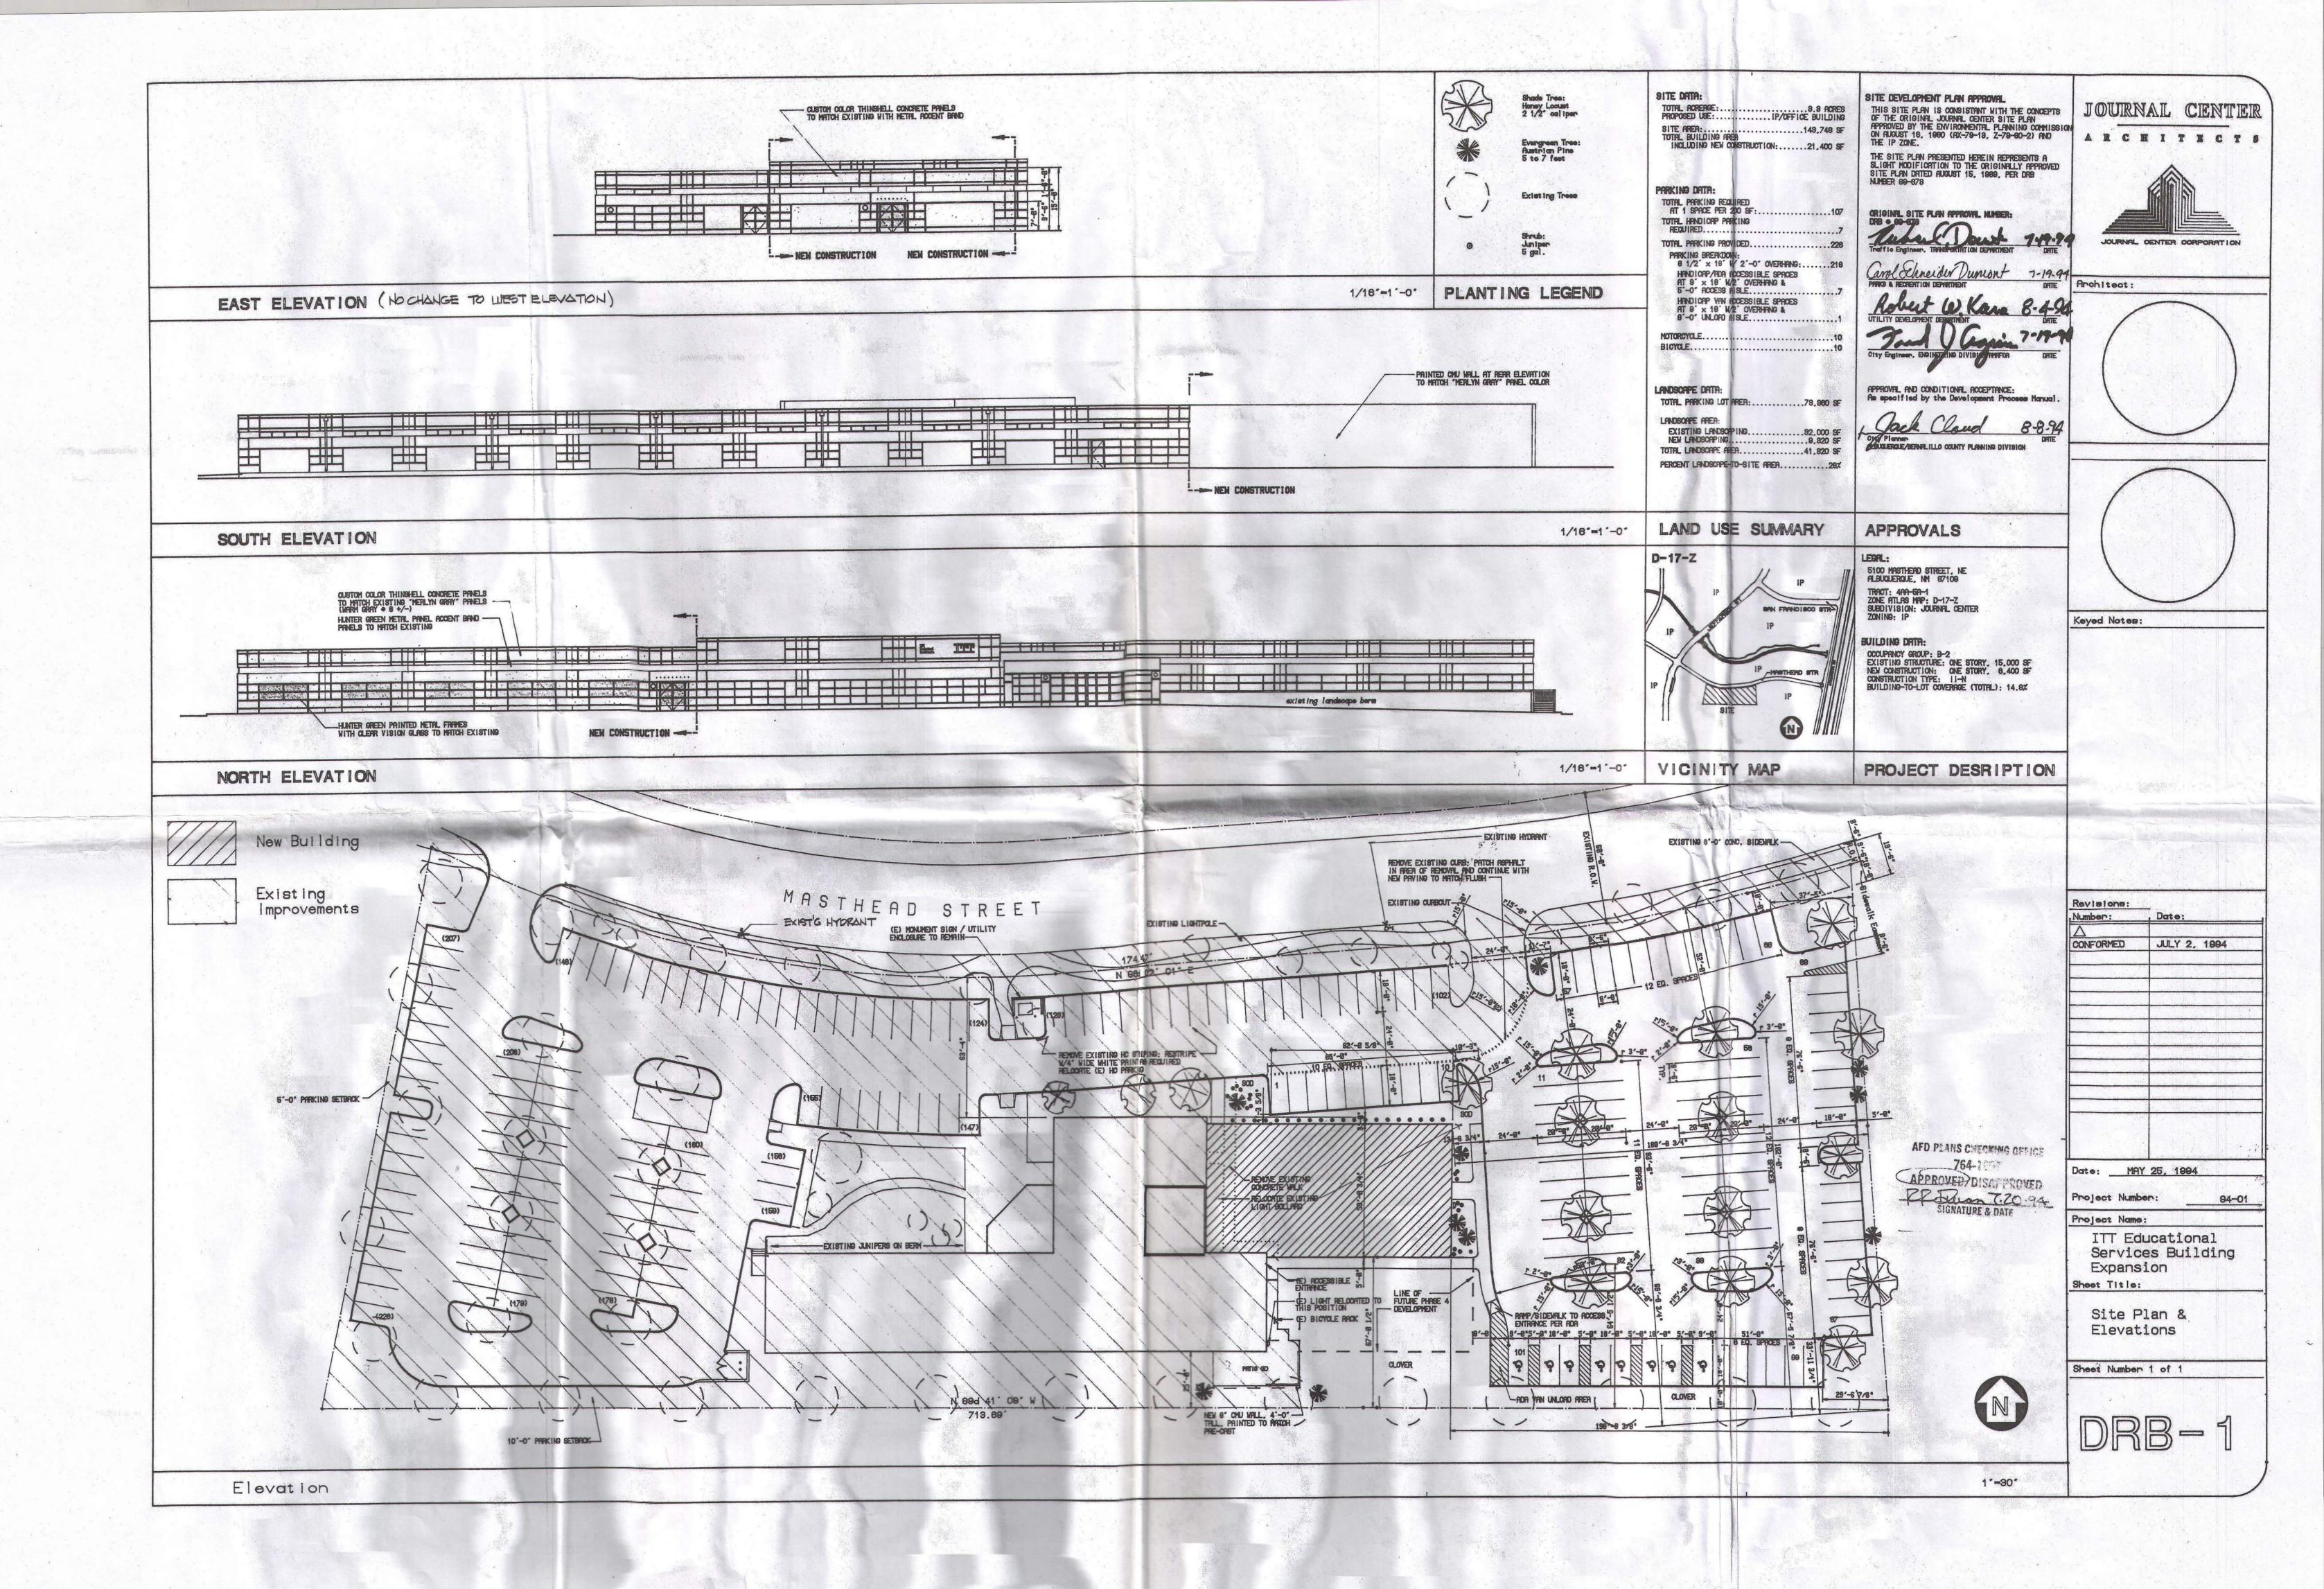

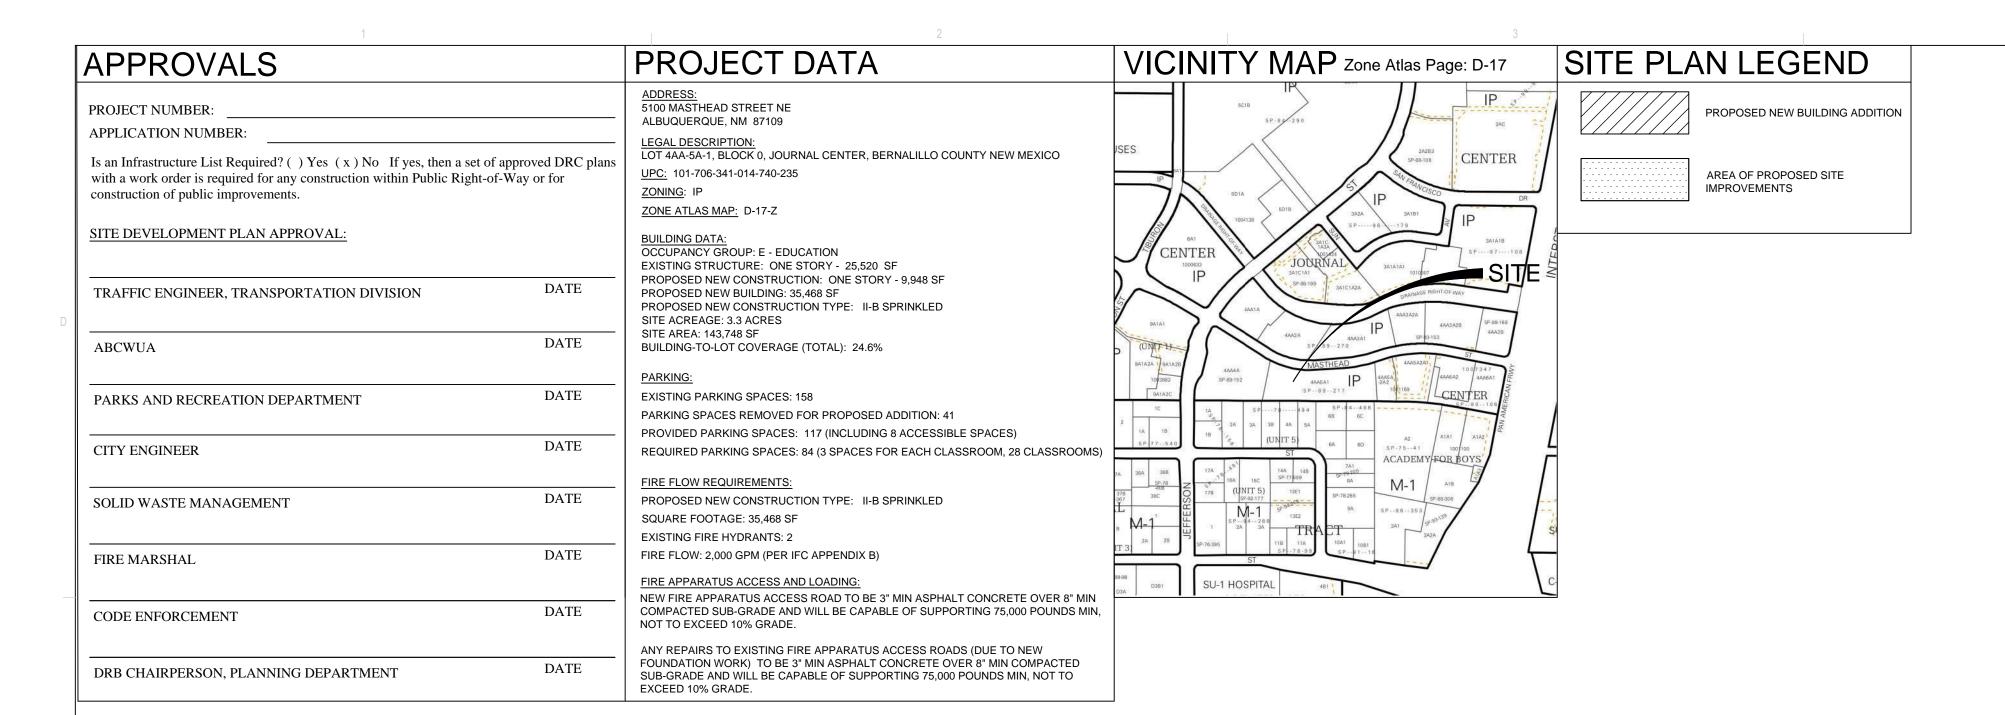

SITE

1" = 30'-0"

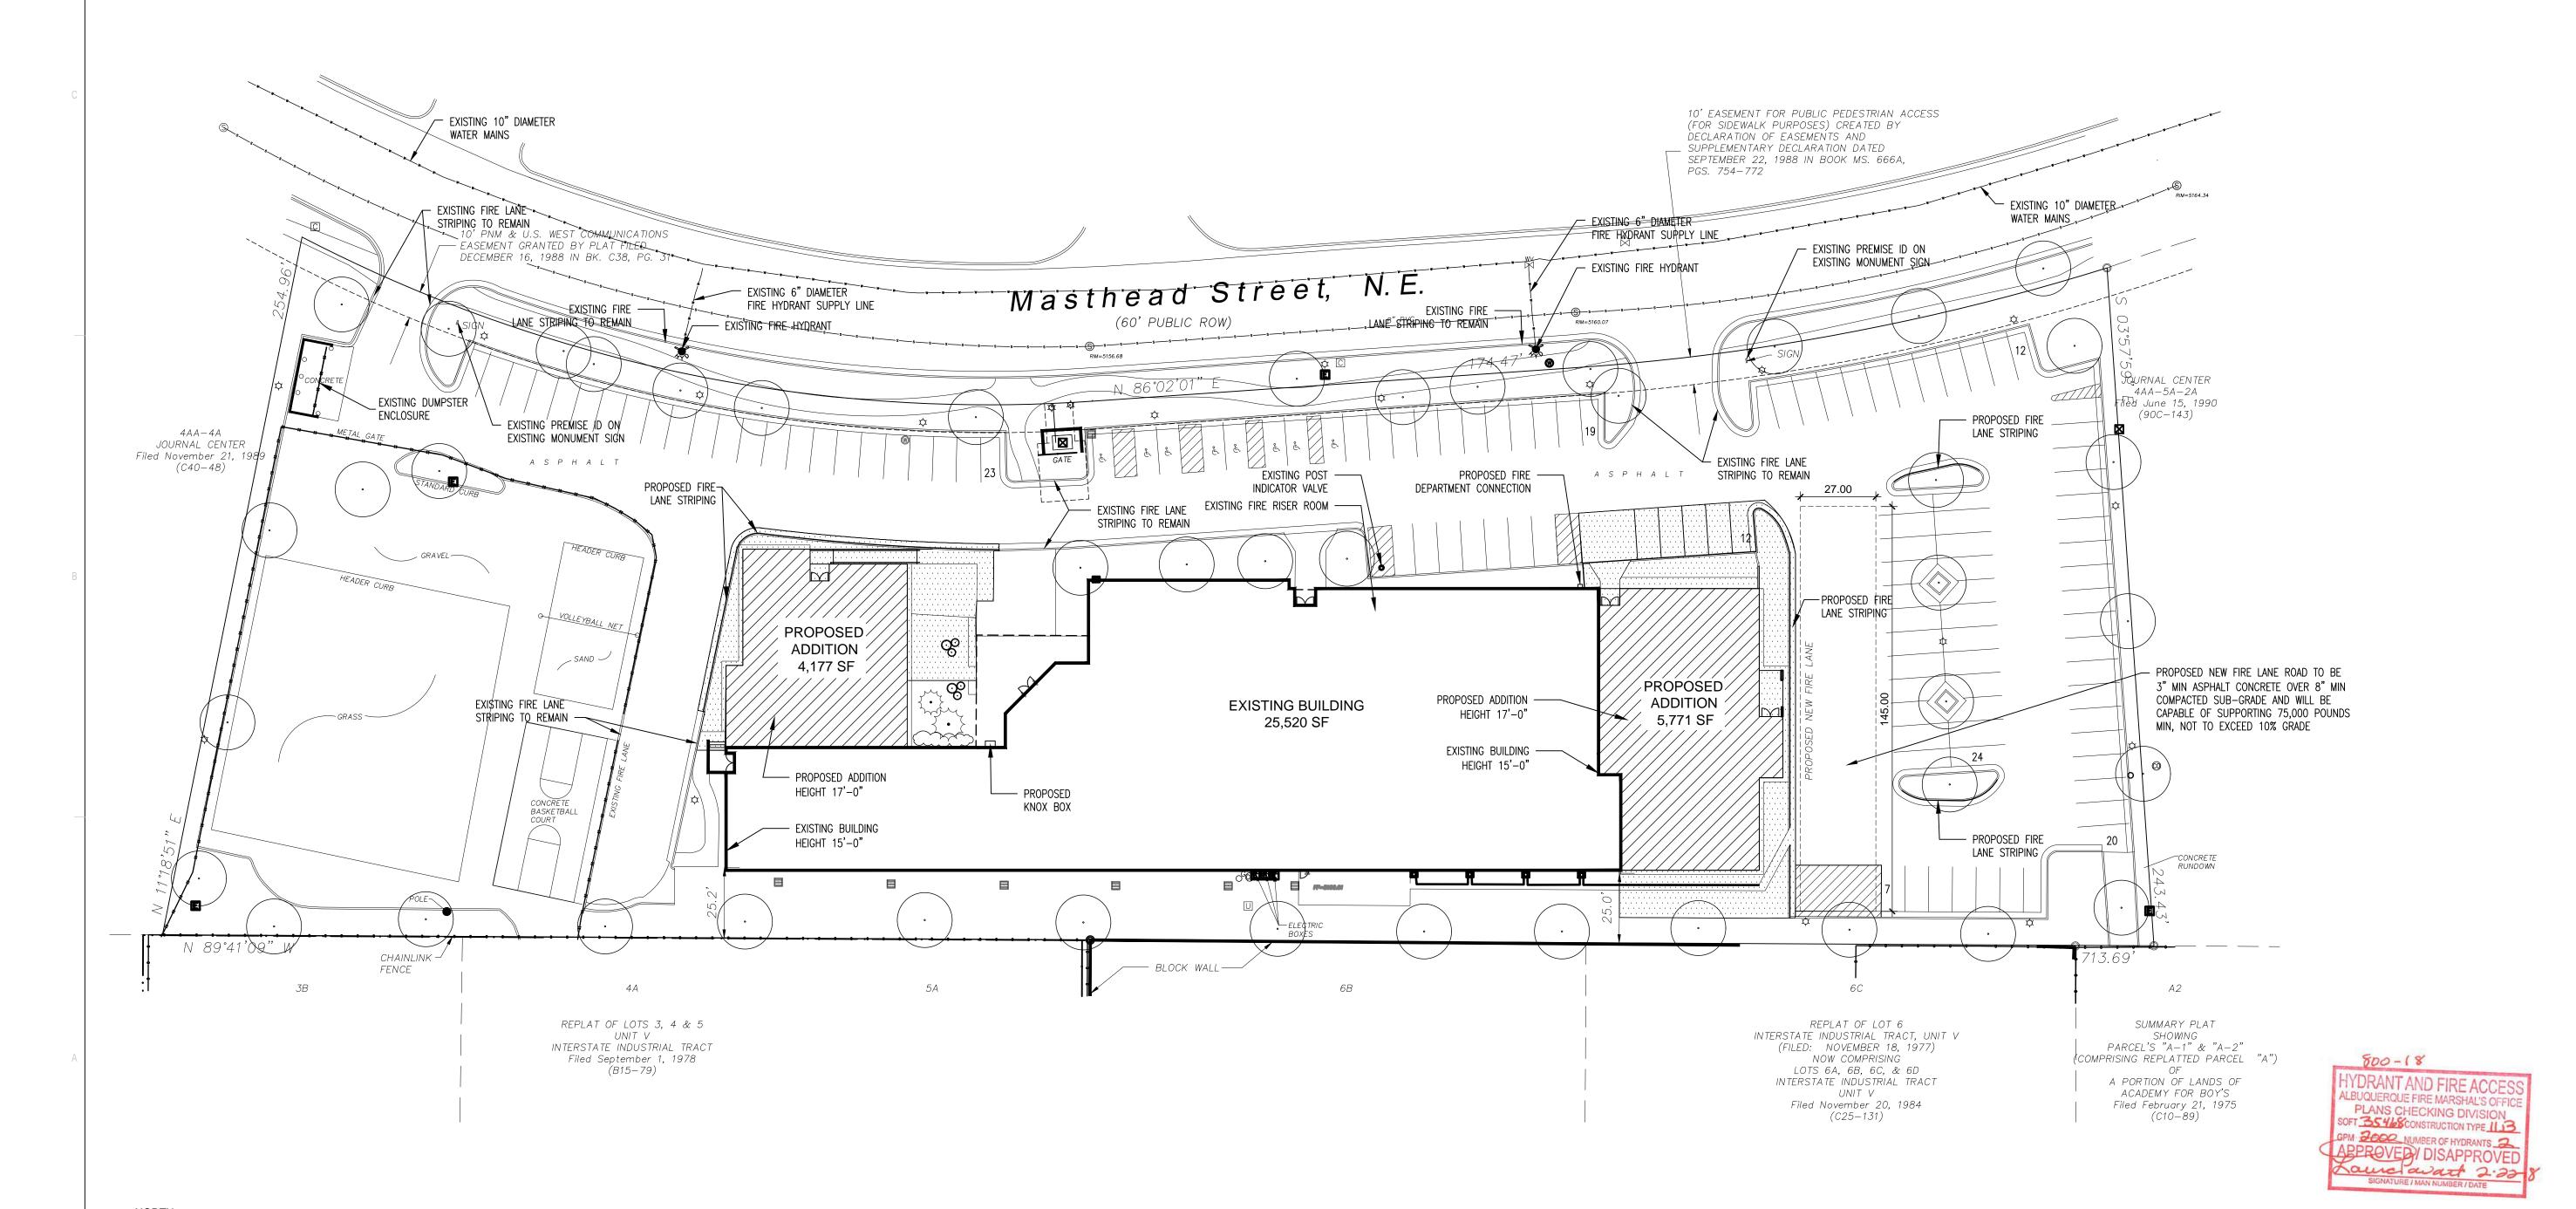

ARCHITECTURE / DESIGN / INSPIRATION

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ARCHITECT

ENGINEER

PROJEC

EXPLORE ACADEMY
RENOVATION/ADDITION
5100 MASTHEAD ST. NE
ALBUQUERQUE, NM 87109

DRAWN BY	DPS
REVIEWED BY	DPS
DATE	02/22/2018
PROJECT NO.	16-0150.006

DRAWING NAME

SITE PLAN FIRE 1

SHEET NO.

FIRE 1