

VICINITY MAP

LEGAL DESCRIPTION:

PROJECT NUMBER: PR-2018-001584 APPLICATION NUMBER: SI-2018-00151 is an infrastructure List required? ( ) Yes ( ) No if Yes, then a set of approved DRC plans with a work order is required for any construction within Public Right-of-Way or for construction of public improvements. DRB SITE DEVELOPMENT PLAN APPROVAL:

DEB SIE DEVELOPMENT FLAN AFFROYAL	
Traffic Engineer, Transportation Division	Date
ABCWUA	Date
Parks & Recreation Department	Date
City Engineer/Hydrology	Date
Code Enforcement	Date
*Environmental Health Department (conditional)	Date
Solid Waste Management	Date
DRB Chairperson, Planning Department	Date
* Environmental Health if pecensary	

KEYED NOTES:

CURB & GUTTER (SEE DETAIL SHEET C4) STRAIGHT HC RAMP (SEE DETAIL SHEET C4) (3) CURB RETURN HC RAMP (SEE DETAIL SHEET C4)

4 6 FT. SIDEWALK PER COA STD DWG #2430 5 6 FT. PAVED PEDESTRIAN CROSSING OF COLORED TEXTURED CONCRETE (SEE NOTE 11 THIS SHEET) O DUMPSTER ENCLOSURE RECYCLE & WASTE (SEE DETAIL SHEET C4)

7) BIKE RACK (SEE DETAIL SHEET C5)

ACCESSIBLE PARKING SPACE TYPICAL. SEE DETAIL SHEET C7 FOR ACCESSIBLE PARKING SPACE SIZE, SIGN AND SYMBOL ("VAN"—INDICATES VAN ACCESSIBLE SPACE). (SEE DETAIL SHEET C5) 8 9 PROPOSED MONUMENT SIGN (SEE ELEVATION SHEET C7 FOR DETAILS)

(10) ASPHALT PAVEMENT (REFER GEOTECH REPORT) (11) NOT USED

(12) ZERO CURB (SEE DETAIL SHEET C4) SIGHT TRIANGLE (SEE NOTE 9 THIS SHEET)

MOTOROYOLE PARKING SIGN (SEE BETAIL SHEET C5)

SWQV POND (SEE GRADING SHEET FOR DETAILS)

LEGEND

= CURB & GUTTER - BOUNDARY LINE ---- EASEMENT CENTERLINE RIGHT-OF-WAY - BUILDING SIDEWALK SCREEN WALL RETAINING WALL ά STREET LIGHTS - - - - LANE - STRIPING — — — — EXISTING CURB & GUTTER ----- EXISTING BOUNDARY LINE EXISTING SIDEWALK — — — — EXISTING LANE EXISTING STRIPING


### NOTES:

- 2. THE SITE IS WITHIN 300' OF BUS ROUTE #96, #790 AND #155 ON COORS BOULEVARD.
- 3. UOHT POLES SHALL BE A MAXIMAN OF 16' FETT WITH FULL OUT OFF LIGHT FIXTURES. LIGHT FIXTURES SHALL BE A MAXIMAN OF 16' WITH FULL OUT OFF SHEDS ON INTURESS SO THAT NO FINDING LIGHT SHALL ESCAPE ECONO HE PROPERTY LIVE THE LIGHT FIXTES SHALL BE TAX SHEDD WITH FIXTONIA LLAWS, LIGHT FIXES FOR THE SHED WITH SHORTONIA LAWS, LIGHT FIXES FOR THE SHED WITH SHED WITH LIGHT SHALL SHED WITH SHED WITH LIGHT FIXES FOR THE SHED WITH SHE SHED WITH SHE SHOULD BE DESIGNED AS DEBOT SHANDED LIGHT SHOULD BE DESIGNED AS DEBOT SHANDED LIGHT SHOULD BE DESIGNED.
- STRUCTURE HEIGHT UP SHALL BE PER R-3 ZONE WITHIN TRACT 3-A AND SHALL ADDITIONALLY COMPLY WITH COORS CORRIDOR PLAN HEIGHT RESTRICTIONS.
- 5. SETBACKS SHALL BE PER THE R-3 ZONE WITHIN TRACT 3-A.
- TRACT 3A SHALL ONLY BE OPERATED AS "HOUSING FOR OLDER PERSONS" AS THAT TERM IS DEFINED AT 42 U.S.C. SECTION 3607(8)(2), RESTRICTED TO RESIDENTS OF AGE 55 AND OLDER. THE FACILITY MAY PROVIDE SUPPORTIVE SERVICES SUCH AS MEALS, HOUSEKEEPING, SOCIAL ACTIVITIES, AND TRANSPORTATION.
- 7. BUILDING-MOUNTED LIGHTING SHALL BE PROVIDED AT ALL BUILDING ENTRANCES AND EXITS.
- 8. DUMPSTER ENCLOSURE SHALL BE PAINTED TO COMPLIMENT THE BUILDING.
- 9. MIN CLEAR SCHIT TRIMINGE MOTE: LANDSCHPING AND SCHAGE WILL NOT INTERFERE WITH CLEAR SCHIT RECOMERDANTS. THEREFORE, SONIS, WALLS, TREES, AND SAVESBERT RETWENT AND 6 FEET TALL (AS MEASURED FROM THE QUITTER PAN) WILL NOT BE ACCEPTABLE IN THE CLEAR SIGHT TRIANGLE (11'X11' PER DPAY 7-110').
- 10. ALL BROKEN OR CRACKED SIDEWALK MUST BE REPLACED WITH SIDEWALK, CURB AND GUTTER AS REQUIRED PER COA STD DWG 2430 AND 2415A.
- 11. PROPOSED DRIVE AISLE CROSSINGS TO BE ENHANCED INTEGRAL COLORED VEHICULAR CONCRETE PAVING WITH CONCRETE BANDS. SIDEWALKS TO BE CONCRETE.

SITE DATA **BUILDING DATA** SITE AREA: 6.57 ACRES BUILDING FOOTPRINTS: (Including Trash Enclousu 63,490 SF 22.2% ASSISTED LIWING
STUDIO 1
ONE BED 4
TWO BED 1
TOTAL: 7 SITE FURNITURE: (Signs, Gazebo, Garden Beds, Game BUILDING AREA 1ST FLOOR 2ND FLOOR PERVIOUS SURFACES 42,049 SF 143,906 SF IMPERVIOUS SURFACES 99,528 SF 34.7% (Road, Driveways, Parking, Sidewalks, Patios): 70TAL SITE AREA: 286,270 SF 100% | INDEPENDENT LIVING | ONE BED | 36 | TWO BED | 11 | TOTAL: 47 UP PARKING #SPACES
ACCESSIBLE SPACES 6

SEAL	TRACT 3A COORS VILLAGE	DRAWN BY RS
ON MEXICO Z	4500 OUAKER HEIGHTS ABO NM 87120	DATE
ON MEXICO Z	SITE PLAN FOR BUILDING	3/5/2020
(7868)	PERMIT	2019064_SP
THE SONAL ENGINE		SHEET #
3/6/2020	TIERRA WEST, LLC 5571 MIDWAY PARK PLACE NE ALBUQUERQUE, NM 87109	C1
RONALD R. BOHANNAN	(505) 858-3100 www.tierrawestllc.com	J08 <b>∦</b> 2019064

INDEX TO DRAWINGS
C1. SITE PLAN FOR BUILDING PERMIT
C2. GRADING AND DRAINAGE PLAN
C3. MASTER UTILITY PLAN
C4. CONSTRUCTIONS DETAILS
C5. CONSTRUCTIONS DETAILS
C6. CONSTRUCTIONS DETAILS
L1. LANDSCARRE PLANS
L1. BUILDING ELEVATIONS
L1. BUILDING ELEVATIONS

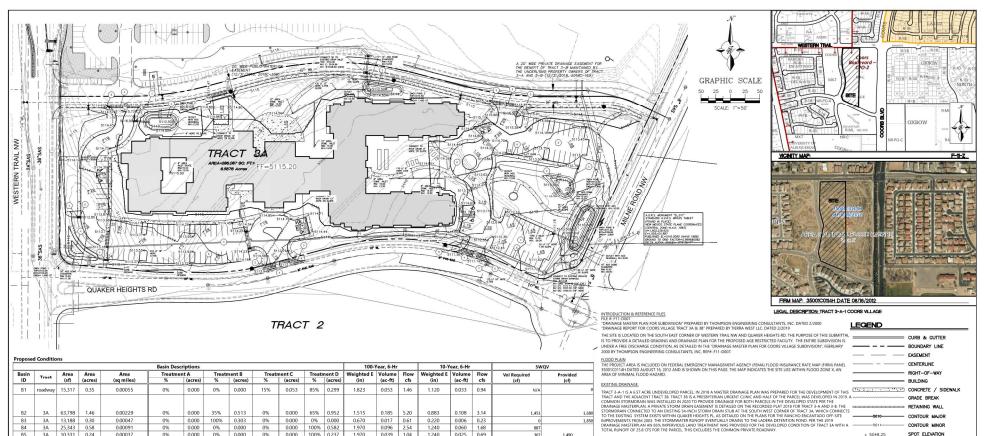

	besit descriptions							100-1601, 0-111		10-1	10-1641, 0-111		JWQV							
Basin	Tract	Area (sf)	Area (acres)	Area (sq miles)	Treatmer %	t A (acres)	Treatn	nent B	Treatr %	ment C (acres)	Treatr %	ment D	Weighted E	Volume (ac-ft)	Flow	Weighted E	Volume (ac-ft)	Flow	Vol Required	Provided
		(51)	(acres)	(sq inites)		(acres)	70	(acres)	/0	(acres)	//	(acres)	(111)	(ac-it)	CIS	(111)	(ac-it)	CIS	(cf)	(cf)
B1	roadway	15,317	0.35	0.00055	0%	0.000	0%	0.000	15%	0.053	85%	0.299	1.823	0.053	1.46	1.120	0.033	0.94	N/A	o
					l															
B2	3A	63,798	1.46	0.00229	0%	0.000	35%	0.513	0%	0.000	65%	0.952	1.515	0.185	5.20	0.883	0.108	3.14	1,451	1,680
B3	3A	13,188	0.30	0.00047	0%	0.000	100%	0.303	0%	0.000	0%	0.000	0.670	0.017	0.61	0.220	0.006	0.23	0	1,850
B4	3A	25,343	0.58	0.00091	0%	0.000	0%	0.000	0%	0.000	100%	0.582	1.970	0.096	2.54	1.240	0.060	1.68	887	
B5	3A	10,331	0.24	0.00037	0%	0.000	0%	0.000	0%	0.000	100%	0.237	1.970	0.039	1.04	1.240	0.025	0.69	362	1,490
B6	3A	26,911	0.62	0.00097	0%	0.000	82%	0.507	0%	0.000	18%	0.111	0.904	0.047	1.51	0.404	0.021	0.71	170	
B7	3A	15,135	0.35	0.00054	0%	0.000	0%	0.000	0%	0.000	100%	0.347	1.970	0.057	1.52	1.240	0.036	1.00	530	1,690
B8	3A	15,273	0.35	0.00055	0%	0.000	0%	0.000	0%	0.000	100%	0.351	1.970	0.058	1.53	1.240	0.036	1.01	535	
B9	3A	60,815	1.40	0.00218	0%	0.000	68%	0.949	0%	0.000	32%	0.447	1.086	0.126	3.88	0.546	0.064	2.01	681	
B10	3A	27,224	0.62	0.00098	0%	0.000	55%	0.344	0%	0.000	45%	0.281	1.255	0.065	1.93	0.679	0.035	1.07	429	2,800
B11	3A	12,752	0.29	0.00046	0%	0.000	92%	0.269	0%	0.000	8%	0.023	0.774	0.019	0.65	0.302	0.007	0.27	36	0
Total		286,087	6.57	0.01026		0.000		2.884		0.053		3.631		0.761	21.872		0.430	12.763	5,079	9,510

1,680

1,850 1,490

1,690

2,800

Equations: Weighted E = Ea\*Aa + Eb\*Ab + Ec\*Ac + Ed Volume = Weighted E \* Total Area Flow = Qa\*Aa + Qb\*Ab + Qc\*Ac + Qd\*Ad

D	Slope	Area	R	Q Provided	Velocity
(in)	(%)	(ft^2)		(cfs)	(ft/s)
12	0.50	0.79	0.250	2.53	3.22
12	1.00	0.79	0.250	3.57	4.55
12	1.70	0.79	0.250	4.66	5.93
18	0.75	1.77	0.375	9.12	5.16
18	2.00	1.77	0.375	14.90	8.43

Excess Precipitation, E (in.)					
Zone 1	Zone 1 100-Year				
Ea	0.44	0.08			
Eb	0.67	0.22			
Ec	0.99	0.44			
Ed	1.97	1.24			

EC	0.99	0.44		Qc	2.07	1.49			
Ed	1.97	1.24		Qd	4.37	2.89			
nwater Quality Volume									
Impervi	ous Area =		ΣArea	in "Treatm	ent D"				

Retainage depth = 0.42" Per DPM Pg. 272 0.035 Retention Volume =

=0.035 x area

Peak Discharge (cfs/acre)

0.24

Zone 1 100-Year 10-Year

Qb 2.03 0.76

Qa 1.29

## KEYED NOTES


- 1 2-FT CURB CUT AND 2-FT CONCRETE RUNDOWN W/ SIDEWALK CULVERT
- 3 SWQV POND SEE PLAN FOR NUMBER AND VOLUME THIS SHEET
- 3 ASPHALT PAVING (SEE GEOTECTH REPORT)
- BUILD NEW DRIVEWAY (CURB, GUTTER & SW) AND REPLACE WITH COA STD. CURB, GUTTER & SW. MATCH EXISTING FLAT GUTTER.
- (5) NEW HC RAMP PER COA STD. DETAIL
- 6 ONSITE CURB AND GUTTER
- (7) MODIFY EXISTING CURB INLET TO BE FLUSH WITH FLOWLINE OF DRIVEWAY
- 8 SURVEY PROVIDED BY PRECISION SURVEYS, INC. SEE SURVEY MONUMENT TIE THIS SHEET.
- A CROSS LOT DRAINAGE EASEMENT FOR THE BENEFIT OF TRACTS 3-A AND 3-B,
  TO BE MAINTAINED BY THE OWNERS OF EACH TRACT (12/31/2018, 2018C-169)


THE SITE WAS PREVIOUSLY APPROVED BY DRB AND HYDROLOGY FOR CONCEPTUAL GRADING & DRAINAGE WITH ENGINEERS STAMP DATE 08/22/18. AN ADMINISTRATIVE AMENDMENT TO THE PRIOR APPROVAL IS PROPOSED. THIS PLAN IS BISING SUBMITTED TO HYDROLOGY FOR APPROVAL FOR SITE PLAN FOR BUILDING PERMIT.

ENTITLEMENT PROCESS FOR THIS SITE

<	*DRAINAGE REPORT FOR COORS VILLAGE TRACT 3A & 3B* PREPARED BY TIERRA WEST LLC. DATED 2/2019	LEGEND	
,	THE STIE IS LOCATED ON THE SOUTH HAST CONNER OF WISSTERN TRAIL BY AND QUAKER HEIGHTS ON THE PURPOSE OF THIS SUBMITTAL IS OF PROVIDE A DEFAULD GRADING AND DRAINAGE PLAN FOR THE PROPOSED AGE SESTECTED FACILITY. THE BRITES SUBDIVISION'S UNDER A FREE DISCHARGE CONDITION, AS DETAILED IN THE "DRAINAGE MASTER PLAN FOR COOKS VILLAGE SURDIVISION", FEBRUARY 2000 BY THOMSPON KONKINERNS CONSULTANTS, INC. REFE +11-0007.		CURB & GUTTER BOUNDARY LINE EASEMENT
1	FLOOD PLAIN THE PRODECT AREA IS INCLUDED ON FEDERAL EMERGENCY MANAGEMENT AGENCY (FEMA) FLOOD INSURANCE RATE MAP (HIRM) PANEL 3500107114H DATED AUGUST 176, 2012 AND IS SHOWN ON THIS PAGE THE MAP INDICATES THE SITE LIES WITHIN FLOOD ZONE X, AN AREA OF MINIMAL INCODE MAZARD.		CENTERLINE RIGHT-OF-WAY
0	TRACT 3:A-1 IS A 6.57 A CRE UNDEVELOPED PARCEL. IN 2018 A MASTER DRAINAGE PLAN WAS PREPARED FOR THE DEVELOPMENT OF THIS TRACT AND THE ADJACENT TRACT 38 TRACT 3 IS 1 A PRESSYTEMAN URGENT CLINIC AND HALF OF THE PARCEL WAS DEVELOPED IN 2019. A COMMON STORMORAIN WAS INSTALLED IN 2020 TO PROVIDE DRAINAGE FOR BOTH PARCELS IN THE DEVELOPED STATE PER THE	5010 -5011	BUILDING CONCRETE / SIDEWALK GRADE BREAK RETAINING WALL CONTOUR MAJOR CONTOUR MINOR
+	PROPOSED DRAINAGE:	× 5048.25	SPOT ELEVATION FLOW ARROW
	THE WISHITED EMETHOD FROM THE CITY OF AUBIQUISQUE DEVICE/DRIFF PROCESS MANQUO VIOLINE!—DESIGN CRITERIA 2006 ENSIGNOT WAS LESTO CALCULATE THE MEDIA PROMISED AND FROM THE SITE. THE HEAD PROCESS THAT SEE A SHOWN ON THIS PACE. THE SITE WAS DIVIDED NOTO! IN BASIN WITH THE APPROPRIATE LAND TREATMENT DETERMINED AS SHOWN IN THE DRAINAGE FABLE. THE MANORITY OF THE SEE WILL SHEET FLOW AND BE DIRECTED TO CONCRETE MANDOWN ON BRILLY SIX VIOLENDAM ON GUTTER WHICH SHALL FIRM MET THE CHEMINATE SIX SHOWN THE SEE AND THE WIND PROPRIET THE MANDER THE THE THE CHEMINADAM CONCWEST BOUNDS FOR METCH BETTE STATE OF THE SECOND STATE THE SECOND STAT		EXISTING CURB & GUTTER EXISTING BOUNDARY LINE EXISTING CONTOUR MAJOR
l	INVEX OPECLOPMENT SITS ARE REQUIRED TO CAPTURE AND INFLITANT THE STORMWARTS QUALITY VOLUME FROM THE SOTH PERCENTIAL STORM. THE METHODOLOGY OF THE MEM PROPERTY ESTIMATION PROPERCY CONFIDENCE OF THE HEAD PROPERCY ASSESSMENT OF THE PROPERTY ASSESSMENT OF THE STORM PROPERTY ASSESSMENT OF THE STORM THE PROPERTY ASSESSMENT OF THE PROPERTY OF THE	× 5048.25	EXISTING CONTOUR MINOR EXISTING SPOT ELEVATION CURB INLET
	THE PEAK DISCHARGE FOR THE ENTIRE STE IS 21.8 CTS WHICH IS LESS THAN THE FLOWS CALCULATED IN THE APPROVED DRAINAGE MASTERPIAN. ONCE THE SWAY PONDS ARE FULL THEY WILL FLOW INTO THE EXSTINGS FOROMORDAIN VIA BULTS AND PIPE CONNECTING TO THE EXSTING BOARD MASKET IT HAS MINIMAL OPPORTUNITY TO ACHIEVE THE REQUIRES STOM WATER QUALITY FOULDING AND IS 8%	~~~~~	GRADE BREAK AT ENTRANCE

	TRACT 3A COORS VILLAGE	DRAWN BY RS
	4500 QUAKER HEIGHTS ABO NM 87120	DATE 2/19/2020
ž	GRADING & DRAINAGE PLAN	2/19/2020 2019064_GR
<i>5)</i>		SHEET #
020	TIETWIA WEST, LLC  5571 MIDWAY PARK PLACE NE ALBUQUERQUE, NM 87109	C2
INAN	(505) 858-3100 www.tierrawestlic.com	J08 <b>∦</b> 2019064

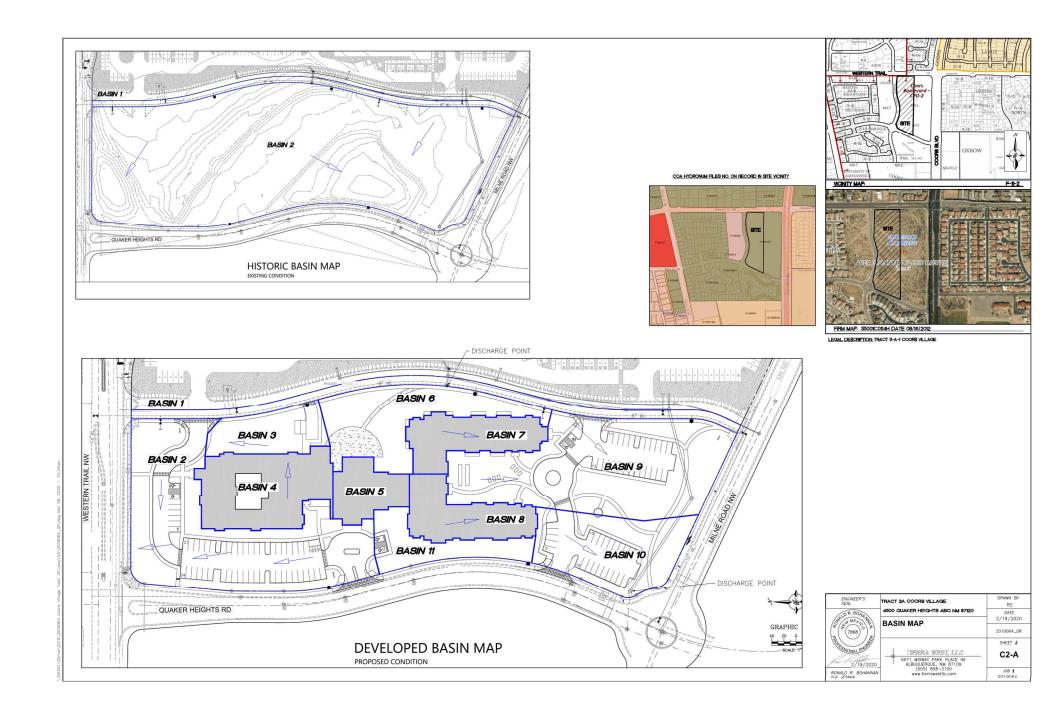

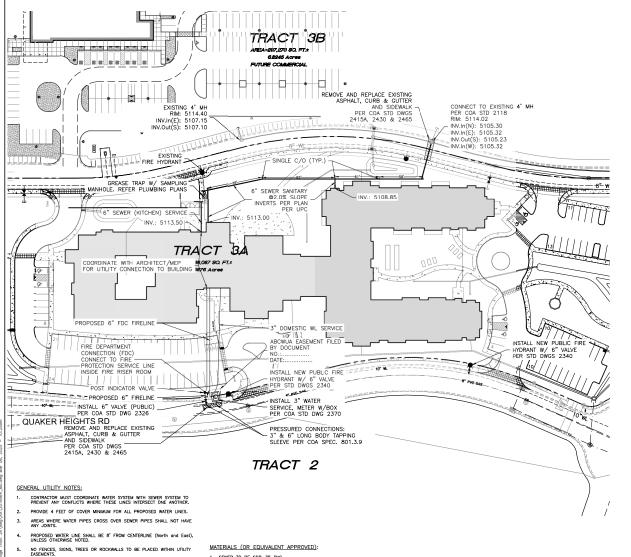



GRAPHIC SCALE

SCALE: 1"=40"

0 20

### MATERIALS (OR EQUIVALENT APPROVED):

1. SEWER TO BE SDR-35 PVC 2. WATER LINE TO BE C900-PVC DR18

## ARCWIJA NOTES:

CONTACT UTILITY COMPANIES FOR EXACT LOCATION OF UNDERGROUND UTILITIES IN THIS AREA BEFORE EXCAVATION. INSTALL A TRENCH SAFETY SYSTEM TO PROVIDE FOR THE SAFE EXCAVATION OF ALL TRENCHES EXCEEDING A DEPTH OF (5') FEET AS PER O.S.H.A. STANDARDS.

PROVIDE ADEQUATE CONCRETE THRUST BLOCKING AT THE FOLLOWING: TAPPING SLEEVES, TEES, BENDS, PLUGS AND ALL FITTINGS. P.V.C. PIPE SHALL BE PLACED WITH SELECT BEDDING MATERIAL ALL AROUND. CAUTION: VERIFY LOCATION & DEPTH OF EXISTING GAS MAIN IN THE AREA OF CONSTRUCTION, BEFORE INSTALLING WATER LINE. ABCWMA NOTES

THE CONTRACTOR SHALL COORDNATE WITH THE WATER AUTHORITY SEVEN (7) DAYS IN ADVANCE OF PERFORMING WORK THAT WILL AFFECT THE PUBLIC WATER OF SANIHARY SERVE INPRESTRUCTURE. MOKE REQUIRED SALDOFF OF ACALITIES AND ADVANCE. DAYS IN ADVANCE OF PERFORMING SUICH WORK, ONLY WATER AUTHORITY 14 DAYS IN ADVANCE OF PERFORMING SUICH WORK, ONLY WATER AUTHORITY CHESS ARE AUTHORITY OF THE MADE ONLY WATER AUTHORITY CHESS ARE AUTHORITY OF THE WATER ONLY WATER AUTHORITY CHESS ARE AUTHORITY THE VIOLENCE TO OPERATE PUBLIC VALVES. SHUTOFF HEIDELF MUST BE MADE ONLINE AT

## CAUTION:

CAUTORY

ALE EXSTINCTUTIES SHOWN WERE DISTANDS FROM
ALE EXECUTION TO THE SHOULD SHOW THE SHOWN REPORDED
BY OTHERS. IT SHALL BE THE SOLE RESPONSIBILITY OF THE
ONTRICTOR TO CONDUCT ALL NECESSARY FILED.
NESTIGATIONS PROBE TO AND INCLUDING ANY EXCANATION,
OTHER IMPROVEMENTS, PRIOR TO STARTING THE WORK. ANY
CHANGES FROM THIS PLAN SHALL BE COORDINATED WITH
AND APPROVED BY THE EXHIBITION.


### LEGEND


	CURB & GUTTER
	BOUNDARY LINE
	EASEMENT
	CENTERLINE
	RIGHT-OF-WAY
	BUILDING
(100-4) (100-100) (100-100 (100-100 (100-100 (100-100) (100-100 (100-100 (100-100) (100-100 (100-100) (100-100 (100-100) (100-100 (100-100) (100-100) (100-100) (100-100 (100-100)	SIDEWALK
***************************************	SCREEN WALL
	RETAINING WALL
	EXISTING CURB & GUTTER
	EXISTING BOUNDARY LINE
36" SD	STORM SEWER LINE
———8* SAS———	SANITARY SEWER LINE
8* WL	WATERLINE
•	SINGLE CLEAN OUT
∞	DOUBLE CLEAN OUT
Ø.	EXISTING SD MANHOLE
	EXISTING INLET
\$	EXISTING SAS MANHOLE
*	EXISTING FIRE HYDRANT
₽¥	EXISTING WATER VALVE
₩.	EXISTING WATER METER
- 1	EXISTING POWER POLE
ê.	EXISTING GAS VALVE
u	EXISTING OVERHEAD UTILITIES
	EXISTING UNDERGROUND UTILITIES
	EXISTING GAS
— —Ex. 8" SAS— —	EXISTING SANITARY SEWER LINE
EX. 10" WL	EXISTING WATER LINE
— · —EX. 18" RCP———	EXISTING STORM SEWER LINE


### WATER NOTES:


- CONTACT UTILITY COMPANIES FOR EXACT LOCATION FOR UNDERGROUND UTILITIES IN THE AREA.
- PROVIDE ADEQUATE CONCRETE THRUST BLOCKING AT THE FOLLOWING: TAPPING, SLEEVES, TEES, BENDS, PLUGS ALL FITTINGS. REFER TO ABOWUA STANDARD DETAIL DRAWING 2320
- INSTALL A TRENCH SAFETY SYSTEM TO PROVIDE FOR THE SAFE EXCAVATION OF ALL TRENCHES EXCEEDING A DEPTH OF (5') FIVE FEET AS PER O.S.H.A. STANDARDS.
- 4. ALL P.V.C. PIPE ON THIS PLAN SHALL BE ENCASED WITH SELECT BEDDING WHEN PLACED IN CITY ROW. IN SITU (ACCEPTABLE) MATERIAL CAN BE USED IN PRIVATE LINES.
- 5. ALL VALVES ON P.V.C. WATER MAINS SHALL BE ANCHORED IN CONCRETE
- 6. CITY PAVING CUT PERMIT REQUIRED BEFORE EXCAVATION.
- RECONNECTION OF EXISTING WATER LINE SYSTEM SHOWN ON THESE PLANS MUST BE MADE, SUCH THAT MINIMAL INTERRUPTION OF SERVICE TO CUSTOMER IS MADE.
- ALL EXISTING LINES CURRENTLY IN SERVICE MUST REMAIN IN SERVICE THROUGHOUT CONSTRUCTION. CONTRACTOR IS RESPONSIBLE FOR PROTECTION 6" SEVER LINES (INCLUDING SERVICES) FROM DAMAGE AS A RESULT OF CONSTRUCTION.
- CONTRACTOR SHALL VERIFY LOCATION OF SERVICES BEFORE CONSTRUCTION.
- CONTRACTOR SHALL COORDINATE WITH CITY & COUNTY CONSTRUCTION SEQUENCE AND TRAFFIC CONTROL PLANS.
- CONTRACTOR SHALL PROVIDE TEMPORARY SERVICE TO CUSTOMERS IF SERVICE WILL BE INTERRUPTED FOR MORE THAN (4) HOURS IN A 24-HOUR PERIOD.
- CONTRACTOR TO ADJUST WATER VALVES TO FINAL GRADE WHERE NECESSARY.

ENGINEER'S SEAL	TRACT 3A COORS VILLAGE	DRAWN BY RS
OR BONA MEXICO	4500 QUAKER HEIGHTS ABO NN 87120	DATE 3/5/2020
7888 2 2 7888 3 2 7888 3 76 72020 RONAL BUYANNAN P.E. \$7868	MASTER UTILITY PLAN	2019064_MU
	TIERRA WEST, LLC 5571 MIDWAY PARK PLACE NE ALBUQUERQUE, NM 87109	SHEET #
	(505) 858-3100 www.tierrawestllc.com	J08 <b>∦</b> 2019064

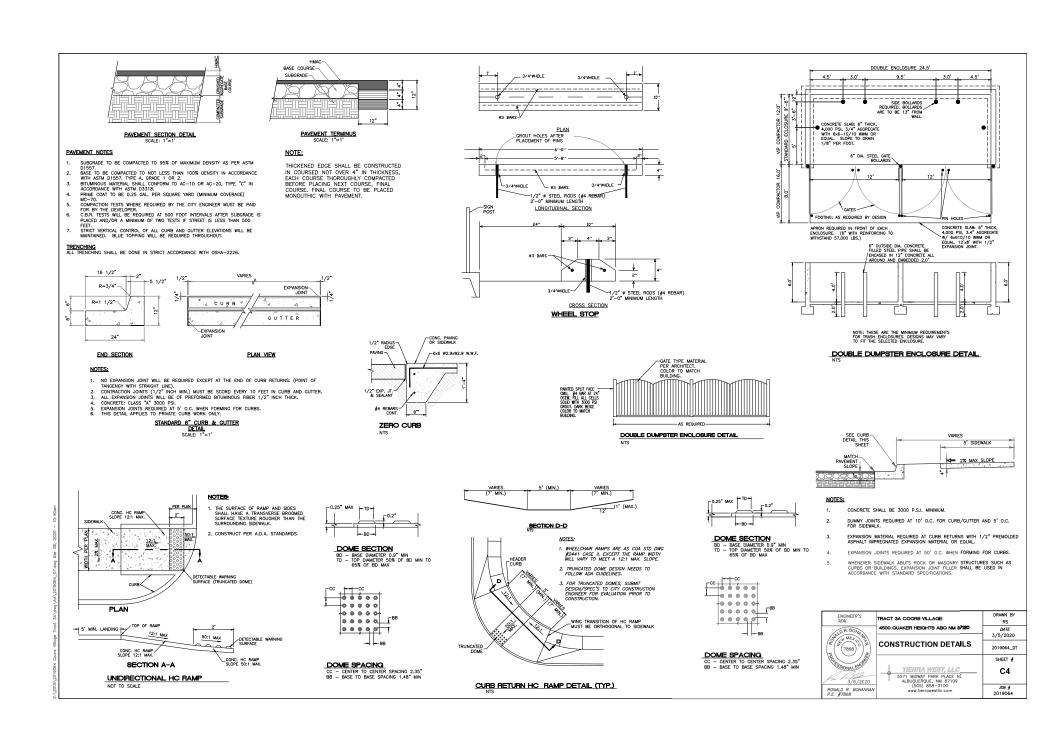


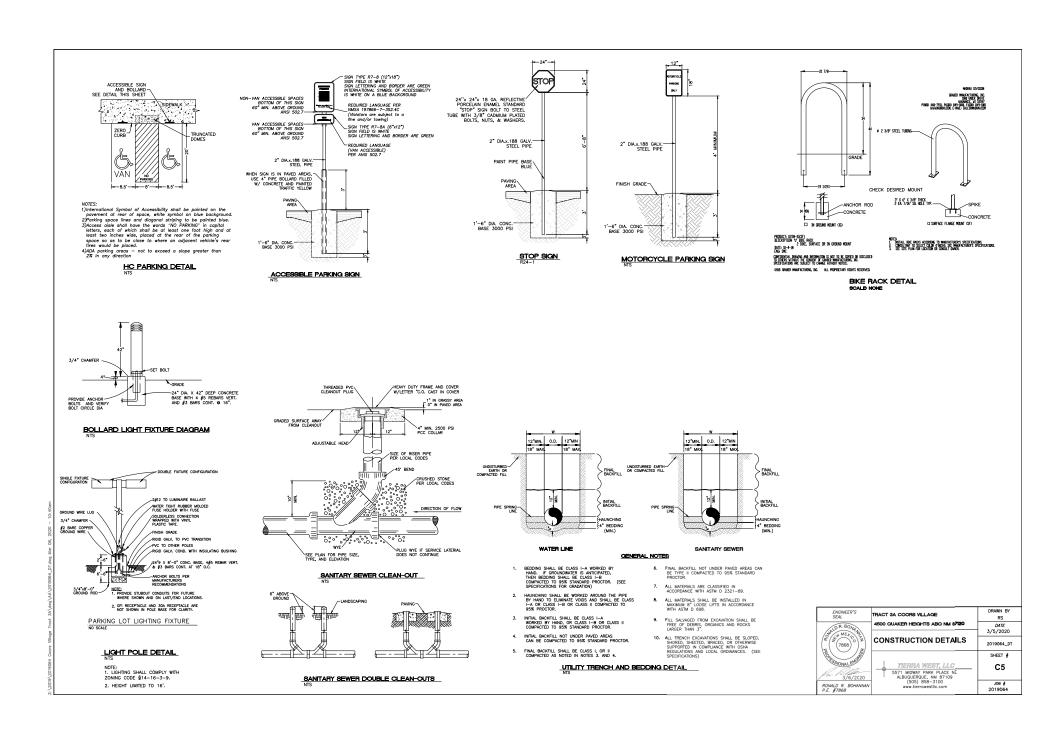

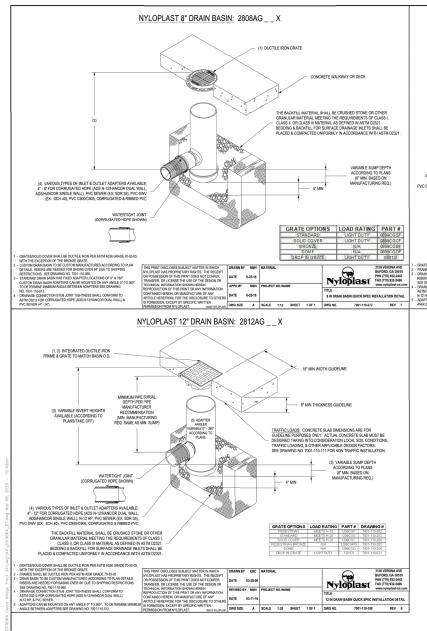


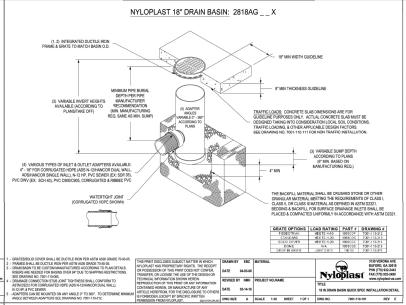



ENGINEER'S SEAL	TRACT 3A COORS VILLAGE	DRAWN BY RS
ROMAL BRANKANAN RESONAL BRANKANAN RESONAL BRANKAN RESONAL BRANKAN RESONAL BRANKAN RE. \$7868	4500 QUAKER HEIGHTS ABO NM 87120	DATE 3/5/2020
		2019064_DT
		SHEET #
	S571 MIDWAY PARK PLACE NE ALBUQUERQUE, NM 87109	C6
	(505) 858-3100 www.tierrowestllc.com	J0B # 2019064

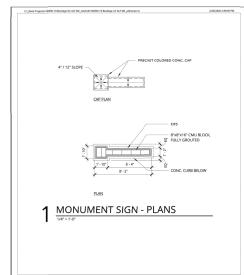


ALBUQUERQUE SENIOR LIVING
DATE:
PROJECT 8:
SCALE

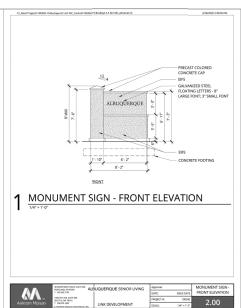

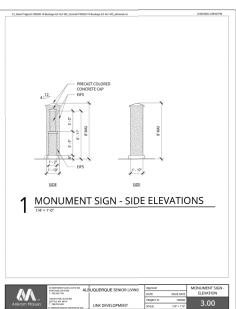


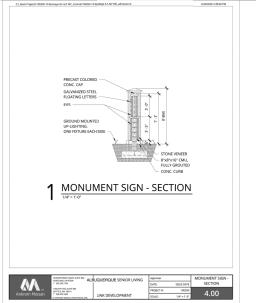

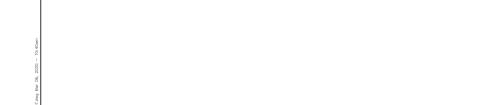


MONUMENT SIGN-PLAN 1.00

ENGINEER'S SEAL	TRACT 3A COORS VILLAGE	DRAWN BY RS
ON BONGALE	4500 QUAKER HEIGHTS ABQ NM 87120	DATE 3/5/2020
[ [7868] ] ]	MONUMENT SIGN	2019064_DT
THE SECONAL ENGINE		SHEET #
3/6/2020	5571 MIDWAY PARK PLACE NE ALBUQUERQUE, NM 87109	C7
RONALD R. BOHANNAN P.E. #7868	(505) 858-3100 www.tierrowestlic.com	JOB # 2019064

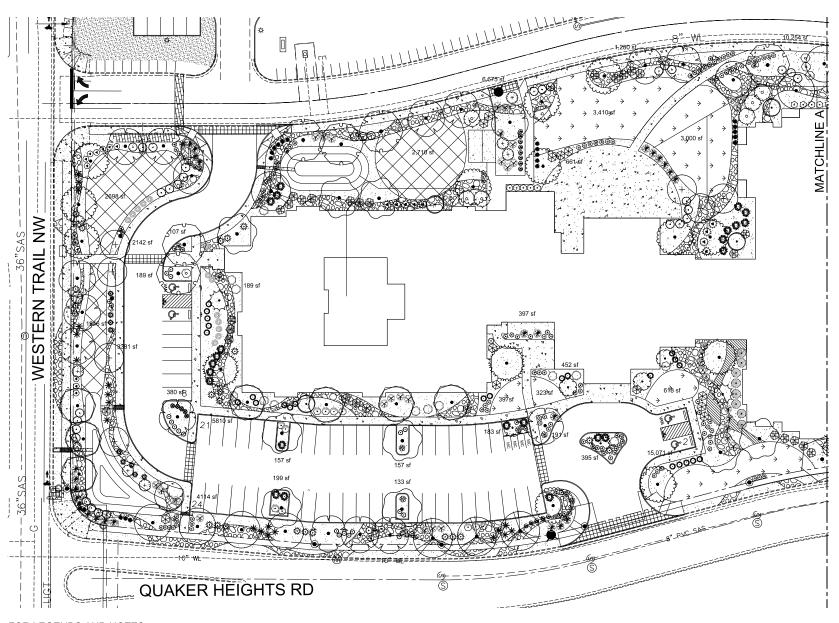

FOR LEGENDS AND NOTES, SEE SHEET LP-00



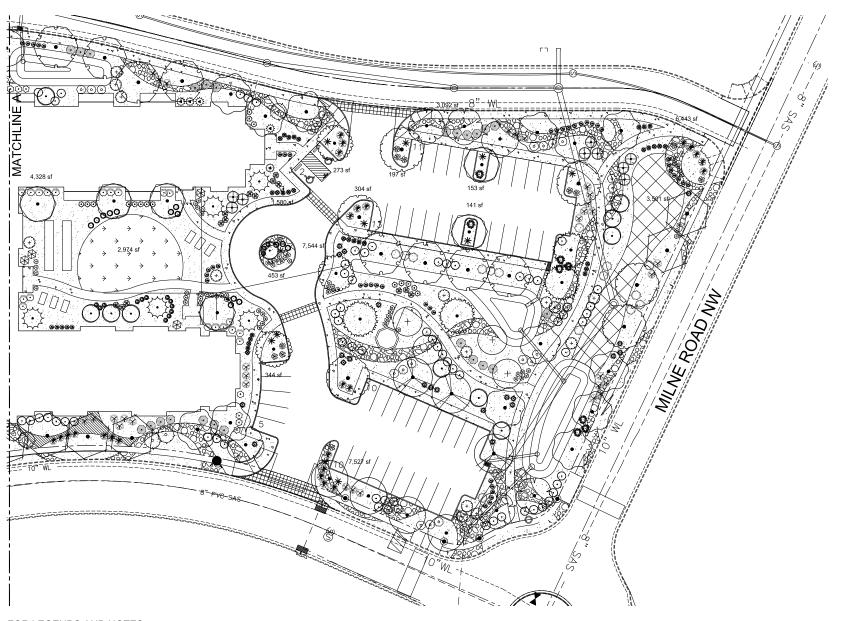

FOR LEGENDS AND NOTES, SEE SHEET LP-00



LANDSCAPE PLAN

Sheet Number:

LP-02

## PLANT SCHEDULE COORS VILLAGE

DECIDUOUS TREES	QTY	BOTANICAL / COMMON NAME	SIZE	WATER	ALLOWANCE	HXS
$\bigcirc$	14	Acer negundo 'Sensation' / Sensation Box Elder	2" B&B	Medium	35	40° X 30°
$\bigcirc$	6	Celtis occidentalis / Common Hackberry	2" B&B	Medium	35	40° X 40°
	5	Cercis reniformis 'Oklahoma' / Oklahoma Red Bud	2" B&B	Medium	30	15° x 12°
$(\cdot)$	14	Gleditsia triacanthos inermis / Thomless Common Honeylocust	2" B&B	Medium +	30	50° X 45°
$\odot$	13	Pistacia chinensis / Chinese Pistache	2" B&B	Medium	45	60. X 60.
(·)_	21	Quercus buckleyi / Texas Red Oak	2" B&B	Medium		40° X 40°
$(\cdot)$	12	Quercus gambelii / Gambel Oak	2" B&B	Medium	40	25° x 25°
	22	Quercus muehlenbergii / Chinkapin Oak	2" B&B	Medium	40	40° x 35°
$\cdot$	6	Ulmus parvifolia / Lacebark Elm	2" B&B	Medium	40	35° x 40°
	7	Ulmus x 'Frontier' / Frontier Hybrid Elm	2" B&B	Medium		30° x 30°
DESERT ACCENT TREES	QTY	BOTANICAL / COMMON NAME	SIZE	WATER	ALLOWANCE	HXS
+	12	Chilopsis linearis / Desert Willow	5 gal	RW	45	20. X 25.
$\bigcirc_{\mathbb{Z}_q}$	15	Forestiera neomexicana / New Mexican Olive	15 gal	Medium	30	15° X 15°
₹•}	7	Vitex agnus-castus / Chaste Tree	5 gal	Medium	35	20, X 20,
EVERGREEN TREES	QTY	BOTANICAL / COMMON NAME	SIZE	WATER	ALLOWANCE	HXS
$\odot$	7	Cedrus atlantica 'Glauca' / Blue Atlas Cedar	6" B&B	Medium +		75° X 50
DECIDUOUS SHRUBS	<u>QTY</u> 38	BOTANICAL / COMMON NAME  Buddleja davidii / Butterfly Bush	SIZE 1 gal	WATER Medium	ALLOWANCE 20	6, X 6, H X 2
<b>⊕</b>	22	Caesalpinia qilliesii / Yellow Bird of Paradise	1 gal	RW	40	10, X 10,
	13	Caryopteris x clandonensis / Blue Mist Spirea	1 gal	Medium	15	4' X 4'
•	14	Chamaebatiaria millefolium / Fernbush	5 gal	Low+	30	5' X 6'
$\stackrel{\sim}{\oplus}$	9	Lagerstroemia indica "Natchez" / Natchez White Crape Myrtle	5 gal	Medium+		15° X 10°
% %	16	Mirabilis multiflora / Desert Four O'Clock	1 gal	Low+	25	2° X 5°
*	24	Nepeta x faassenii 'Walkers Low' / Walkers Low Catmint	1 gal	Medium		1. X 3.
€	57	Perovskia atriplicifolia / Russian Sage	1 gal	Medium	20	5' X 5'
0	15	Potentilla fruticosa / Potentilla	1 gal	Medium+	10	3. X 3.
<u> </u>	26	Prunus x cistena / Purple Leaf Sand Cherry	5 gal	Medium		6, X 6,
_ ⊙	101	Rhus aromatica 'Gro-Low' / Gro-Low Fragrant Sumac	5 gal	Low+	30	2, X 9,
<b>⊕</b>	24	Rhus trilobata / Three Leaf Sumac	5 gal	Low+	30	6. X 6.
<b>⊕</b>	14	Rosa x 'Knockout' TM Pink / Knockout Rose Pink	5 gal	Medium+	20	3. X 3.
<b>②</b>	75	Salvia greggii / Autumn Sage Cherry	1 gal	Medium	15	3, X 3,
<b>\$</b>	36	Salvia greggii 'Ultraviolet' / Ultraviolet Autumn Sage	1 gal	Low+		3. X 3.
EVERGREEN SHRUBS	QTY	BOTANICAL / COMMON NAME	SIZE	WATER	ALLOWANCE	<u>H X S</u>
ⓒ	20	Artemisia filifolia / Sand Sagebrush	1 gal	RW	25	4° X 4°
<b>©</b>	17	Artemisia tridentata / Big Sagebrush	5 gal	Low		4° X 4°
<b>₩</b>	50	Baccharis x 'Starn' / Thompson Broom	5 gal	Low+	30	2. X 2.

## MATERIALS LEGEND


GRAY CRUSHER FINES 2"-4" COBBLESTONE PARK BLEND SOD LAWN


ACCENT BOULDER

### SITE DATA

SHEDATA	
LESS BUILDING(S) 66.	087 SF 575 SF 512 SF
	927 SF 130 SF 51 %
	504_SF _607SF _11_%
REQUIRED STREET TREES Required 1 PER 30 L.F. OF WESTERN TRAIL NW 8 PROVIDED STREET TREES	Provided 9
REQUIRED PARKING LOT TREES   1 PER 10 SPACES   94 SPACES   10   10   PROVIDED PARKING LOT TREES	15
REQUIRED DWELLING UNIT TREES ONE PER FIRST FLOOR UNIT ONE PER SECOND FLOOR UNIT PROVIDED DWELLING UNIT TREES Total 103	103
TOTAL TREES REQUIRED/PROVIDED 121 (2" call or 6" ht.)	127
REQUIRED LANDSCAPE COVERAGE 75% LIVE VEGETATIVE MATERIAL (87.498 SF PROPOSED LANDSCAPE X 75%) PROVIDED GROUNDCOVER COVERAGE (81%)	65,622 SF MII 70,852 SF
SOD LAWN/100 % COVERAGE NATIVE SEED	12,607 SF 6,755 SF

TOTAL PROVIDED GROUNDCOVER COVERAGE 90,214 SF

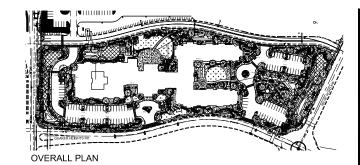

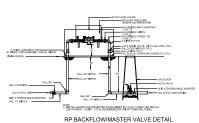



TREE PLANTING DETAIL

## IRRIGATION NOTE

DRIP SYSTEM RUN CYCLES: ESTABLISHMENT AND SUMMER: 1 HOUR/4 DAYS A WEEK SPRING; 1 HOUR/2-3 DAYS A WEEK FALL: 1 HOUR/2-3 DAYS A WEEK WINTER: 1 HOUR/2 DAYS PER MONTH

<b></b>						
$\odot$	13	Cercocarpus ledifolius / Curl-Leaf Mountain Mahogany	5 gal	Low+	35	15° X 15°
*	23	Dasylirion texanum / Texas Sotol	5 gal	RW	20	5° X 5°
<b>①</b>	42	Ephedra spp. / Mormon Tea	5 gal	RW	35	2° X 5°
0	22	Ericameria laricifolia / Turpentine Bush	5 gal	Low	25	3° X 4°
*	30	Hesperaloe parviflora / Red Yucca	5 gal	Low	20	3° X 4°
<b>③</b>	77	Lavandula angustifolia / English Lavender	1 gal	Medium		3, X 3,
0	38	Pinus mugo / Mugo Pine	5 gal	Medium	20	4° X 4°
₩	21	Rosmarinus officinalis / Rosemary	5 gal	Low+	30	6, X 6,
0	31	Rosmarinus officinalis 'Creeping' / Creeping Rosemary	5 gal	Low+	30	2° X 6°
*	31	Yucca baccata / Banana Yucca	1 gal	RW	30	4° X 5°
ORNAMENTAL GRASSES	QTY	BOTANICAL / COMMON NAME	SIZE	WATER	ALLOWANCE	HXS
⅌	62	Calamagrostis x acutiflora 'Karl Foerster' / Feather Reed Grass	5 gal	Medium	10	3. X 5.
<b>(</b>	40	Muhlenbergia capillaris 'Regal Mist' / Regal Mist Muhly	1 gal	Medium		3. X 3.
•	13	Muhlenbergia rigens / Deer Grass	1 gal	Low+		4° X 4°
<b>•</b>	32	Panicum virgatum 'Heavy Metal' / Heavy Metal Switch Grass	1 gal	Medium	15	8, X 6,

## NOTE

MAINTENANCE OF LANDSCAPE (ONSITE AND WITHIN ROW) TO BE MAINTAINED BY PROPERTY OWNER

PLANTINGS TO BE WATERED BY AUTO. DRIP IRRIGATION SYSTEM WITH REDUCED PRESSURE BACKFLOW PREVENTER PER CITY OF ALBUQUERQUE

WATER MANAGEMENT IS THE SOLE RESPONSIBILITY OF THE PROPERTY OWNER

THIS PLAN IS TO COMPLY WITH C.O.A. LANDSCAPE AND WATER WASTE ORDINANCE 6-1-1. PLANTING RESTRICTIONS APPROACH

IT IS THE INTENT OF THIS PLAN TO PROVIDE MIN.
75% LIVE GROUNDCOVER OF LANDSCAPE AREAS
AT MATURITY PER ORDINANCE 14-16-3-10
(SEE CALCULATIONS PROVIDED ABOVE)

LANDSCAPE AREAS TO BE MULCHED WITH GRAVEL MULCH AT 3" DEPTH OVER FILTER FABRIC

APPROVAL OF THE LANDSCAPE PLAN DOES NOT CONSTITUTE OR IMPLY COMPLIANCE WITH, OR EXEMPTION FROM, THE C.O.A LANDSCAPE AND WATER WASTE ORDINANCE 6-1-1.

NO PARKING SPACE SHALL BE MORE THEN 100' FROM A TREE.

STREET TREES TO CONFORM TO STREET TREE ORDINANCE 6-6-2.

4.0-32. ALL BOARD SET OF THE STATE OF THE ST

ITHIS LIMITED HEADWARD.

STREETSCAPE LANDSCAPING SHALL CONSIST PRIMARILY
OF SHRUBS AND DECIDIOUS TREES IN A SETBACK
AREA BETWEEN THE RIGHT-OF-WAY OF THE STREET AND THE
FACE OF THE CURB OF AN ADJACEST PARKING AREA.
CLEAR-SIGHT TRIANGLE REQUIREMENTS MUST BE MET.

TREES IN PROXIMITY TO DUMPSTER TO BE MAINTAINED TO ALLOW FOR TRUCK ACCESS WITHOUT DAMAGE TO TRUCK OR TREES

PO Box 10597 Albuquerque, NM 87184 5 0 5 . 8 9 8 . 9 6 1 5 design@yellowstonelandscape.com





03.05.2020

Drawn by: RMC Reviewed by: JB

 $\geq$ 8 COORS VILLAGE INDEPENDENT LIVING QUAKER HEIGHTS PL NW & MILNE ALBUQUERQUE, NM







Sheet Title:

**OVERALL PLAN** 


Sheet Number:

**LP-00** 




MAIN ENTRY

SCALE: 1/8" = 1'-0"

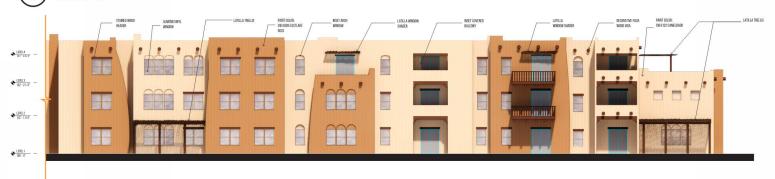

AL WING WEST SCALE: 1/8" = 1'-0"

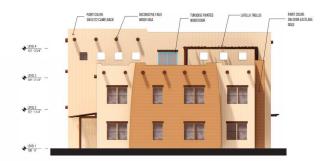


AL WING SOUTH

SCALE: 1/8" = 1'-0"



IL WING SOUTH
SCALE: 1/8" = 1'-0"

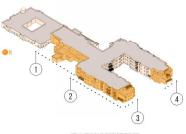



NOTE: ALL MECHANICAL EQUIPMENT SCREENED BY ROS BARRAGETS AND WILL NOT BE VISSBLE CROWN ORGANIA L







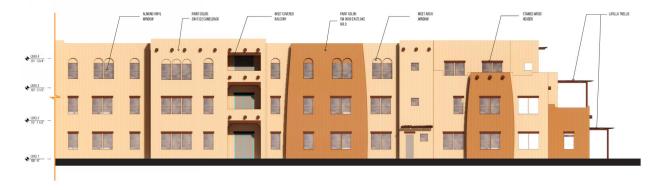

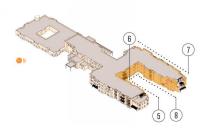


8 IL WING EAST SCALE: 1/8" = 1'-0'

NOTE: ALL MECHANICAL EQUIPMENT SCREENED BY ROOF Parapets and will not be visible from Ground Level.




MC WING EAST SCALE: 1/8" = 1'-0

NOTE: ALL MECHANICAL EQUIPMENT SCREENED BY ROOF PARAPETS AND WILL NOT BE VISIBLE FROM GROUND LEVEL

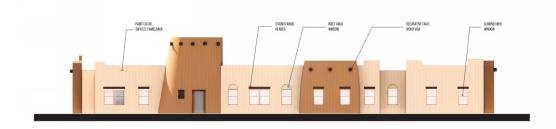


MC WING NORTH
SCALE: 1/8" = 1'-0

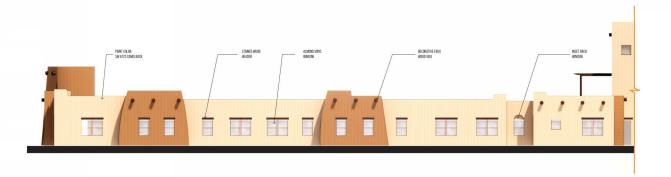



MC WING WEST

SCALE: 1/8" = 1'-0"

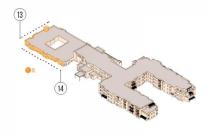

ITE: ALL MECHANICAL EQUIPMENT SCREENED BY ROOF BADETS AND WILL NOT BE VISIBLE COOM (BOYIND LEVE)

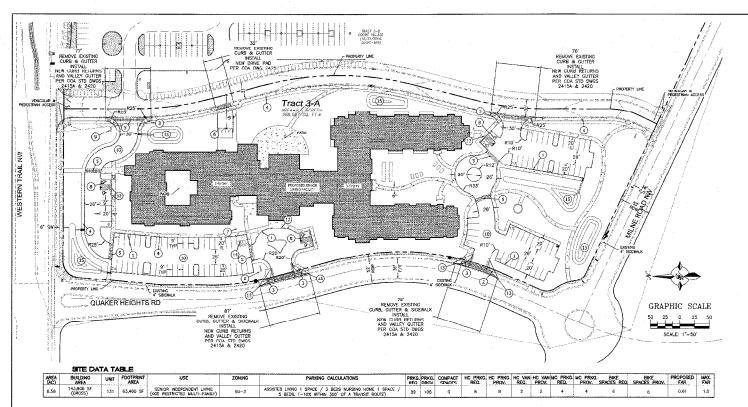

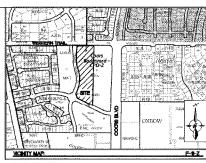

Legal DESCRIPTION: Lot 3-A Coors Village Albuquerque, Bernaliilo County, New Mexico January 2020

### PROJECT NUMBER: PR-2018-001584 APPLICATION NUMBER: SI-2018-00151 is an infrastructure List required? ( ) Yes ( ) No if Yes, then a set of approved DRC clans with a work order is required for any construction within Public Robert of Yes or for construction of making the construction of the c DRB SITE DEVELOPMENT PLAN APPROVAL-Traffic Engineer, Transportation Division Date ABCWUA Date Parks & Recreation Department Date City Engineer/Hydrology Date Code Enforcement Date Solid Waste Managemen 3/10/20 DRB Chairperson, Planning Department Date

nvironmental Fisath, if necessor

#### KEYED NOTES:

(1) CURB & GUTTER (SEE DETAIL SHEET CB) STRAIGHT HC RAMP (SEE DETAIL SHEET CB) (3) DURB RETURN HC RAMP (SEE DETAIL SHEET CO) 8 FT. SIDEWALK PER COA STD DWG #2430 6 FT. PAVED PEDESTRIAN CROSSING OF COLORED, REXTURED CONCRETE (SEE NOTE 8 THIS SHEET)

6 DUMPSTER ENCLOSURE RECYCLE & WASTE (SEE DETAIL SHEET CO) (7) BIKE RACK (SEE DETAIL SHEET CR)

B ACCESSBLE PARIONS SPACE TYPICAL. SEE DETAIL
SHEET CT FOR ACCESSBLE PARKING SPACE SZE,
SIGN AND SYMBOL ("YAN"-INDICATES VAN
ACCESSBLE SPACE), (SEE DETAIL SHEET CD) 9 PROPOSED MONUMENT SIGN (SEE ELEVATION SHEETS FOR DETAILS)

(1) ASPHALT PAVEMENT (REPER GEOTECH REPORT) NOT USED

ZERO CURR (SEE DETAIL SHEET CR) SIGHT TRIANGLE (SEE NOTE 8 THIS SHEET)

MOTORCYCLE PARKING SKIN (SEE DETAIL 5 SWQV POND (SEE GRADING SHEET FOR DETAILS)

LEGEND

CURR & GUTTER - - BOUNDARY UND - EASEMENT ---- CENTERLINE RIGHT-OF-WAY - BUILDING (The Street Street SIDEWALK RETAINING WALL ά STREET LIGHTS -- -- LANE STATE OF THE PROPERTY OF THE P PARTING SIDEWALK ---- EXISTING LANE EXISTING STRIPING

#### NOTES:

ROOF EQUIPMENT SHALL BE BELOW PARAPET HEIGHT AND SCREENED FROM WEW FROM THE PROPERTY LINES OF THIS SITE. ALL GROUND MOUNTED EQUIPMENT SHALL BE SCREENED BY SCREEN WALLS WITH TOP OF EQUIPMENT BELOW TOP OF SCREEN WALLS

THE SITE IS WITHIN 300' OF BUS ROUTE 490, 4790 AND 4155 ON COORS BOULEVARD

THE THOUGH SHALL SE A MANDAM OF THE TET WITH PAIL OUT OF FLOWT FINDINGS. LIGHT PIXTURES SHALL SE MANDAM OF 16 WITH FULL OUT OF SHELDS ON FINDINGS SO THAT NO FINDINGS LIGHT SHALL SECURE SERVING WHICH HAVE A SHALL SHAL

STRUCTURE HEIGHT UP SHALL BE PER R-3 ZONE WITHIN TRACT 3-A AND SHALL ADDITIONALLY COMPLY WITH COORS CORRIDOR PLAN HEIGHT RESTRICTIONS.

6. SETBAOKO SHALL DE PUR THE R-3 ZONE WITHIN TRAOT 3-A.

TRACT 3A SHALL ONLY BE OFERATED AS "HOUSING FOR OLDER PERSONS" AS THAT TERM IS DEFINED AT 42 U.S.C. SECTION 3607(9)(2). RESTRICTED TO RESIDENTS OF AGE 55 AND OLDER. THE FACILITY MAY POWIDE SUPPORTING SERMICE SUICH AS MEALS, HOUSINGERFINE, SOCIAL ACTIVITIES, AND TRANSPORTATION.

7. SUILDING-MOUNTED LIGHTING SHALL BE PROVIDED AT ALL BUILDING ENTRANCES AND EXITS.

8 CHAPSTER ENGINEERS SHALL BE PAINTED TO COMPLIMENT THE RIKLDING

MINI CLEAR SIGHT THUMPOLE HOTE: LONDSCAPING AND SIGNAGE WILL NOT INTERPRETE WITH CLEAR SIGHT
REQUIREMENTS. THEREFORE, SOOKS, WALLS, TREES, AND SHRUBBERY BETWEEN 3 AND 8 FEET TALL (AS
MEASURED FROM THE GUTTER PAN) WILL NOT BE ACCEPTABLE IN THE CLEAR SIGHT TRIANGLE (11'X11' PER
DPM 7-11(0)).

ALL BROKEN OR CRACKED SIDEWALK MUST BE REPLACED WITH SIDEWALK, CURB AND GUTTER AS REQUIRED PER COA STD DWG 2430 AND 2415A.

SITE DATA		BUILDING DATA		
STT ARRAY  BOILDING FOOTPRINES  BOILDING FOOTPRINES  STR FIRENTIAGE  Sign, Guebo, Cardon Bob, Gene  FERVOSS MERKAL  Lanchauge  BARHOOUS SURFACES  Naud, Directory Forting, Schedul  TOTAL STR BARK  PARKING  STRAINS  STRAI	22439.5F 99,528.50 5 Publish 196,270.5F	22,5% 0.3% 42,5% 34,7% 107%	CONSTRUCTION TYPE: 5A  MANAMENTA PRISENT: 3-STORM BODG PHINIST, 3-STORM BODG PHINIST, 3-STORM 1000 PHINIST, 3-	MACHINE CASE  SORGENATE AL 19815 1  SORGENATE AL 19816 2  SORGENAT

INDEX TO DRAWINGS
C1. SITE PLAN FOR BUILDING PERMIT
C2. GRADING AND DRAINAGE PLAN
C3. MASTER UTILITY PLAN
C4. CONSTRUCTIONS DETAILS
C5. CONSTRUCTIONS DETAILS
C6. CONSTRUCTIONS DETAILS
C6. CONSTRUCTIONS DETAILS
C6. CONSTRUCTIONS DETAILS

L1. LANDSCAPING PLANS B1. BUILDING ELEVATIONS

ENGINEER'S SEAL	TRACT 3A COORS VILLAGE	DRAWN BY RS		
	4500 QUAKER HEIGHTS ABO NM 87120 SITE PLAN FOR BUILDING	DATE 3/5/2020		
	PERMIT	2019064_SP		
		SHEET #		
DEFINA WEST, U.S. DEFINAT MAKE PLAUE NE ALBUQUERQUE, NM 87109	C1			
WALD R. BOHANNAN . \$7868	(505) 858-3100 www.tierrawestilc.com	J08 <b>#</b> - 2019064		